## HOUSE ON A HILL - PNL2021-00187-0360312800-CDR PLANS

APN: 036-031-280 10th Street Montara, California 94037



#### **ARCHITECTURAL**:

DAVID JAEHNING ARCHITECT **381 11TH STREET** SAN FRANCSICO, CA 94103 T: +1 415 272 9444

> **BUILDING/PLANNING CODE INFORMATION:**

APPLICABLE BUILDING CODE: 2016 CA BUILDING STANDARDS

#### STRUCTURAL/CIVIL:

**DESIGN EVEREST** 365 FLOWER LANE MOUNTAIN VIEW, CA 94043 T: +1 415 870 1101

CODE, CA CODE OF REGULATIONS TITLE 24, CA RESIDENTIAL CODE, CA PLUMBING CODE, CA MECHANICAL CODE, CA ENERGY CODE, CA FIRE CODE, CALIFORNIA ELECTRICAL CODE CITY ZONED: S-17 COASTAL DEVELOPMENT DISTRICT PARCEL SIZE: 5,995 SQ FT LOT COVERAGE: BUILDING: 1,576 SF

HARDSCAPE: 94 SF TOTAL: 1,670 SF (PERMEABLE PAVING): 752 SF

FLOOR AREA RATIO: GOVERNED BY 6300.2.5a

LANDSCAPE AREA (PLANTING): 3,157 SF

OCCUPANCY CLASSIFICATION: R-3

BUILDING AREA (GROSS): LEVEL 1:

DRIVEWAY AREA

LEVEL 2:

1,579 SF 1,322 SF TOTAL: 2,901 SF

ALLOWABLE AREA PER 6300.2.5a: (0.53)(5,995 SF) = 3,177 SF

GRADE ELEVATION: 198'-0" BUILDING HEIGHT: 27' - 11 1/2"

BUILDING LEVELS: 2

MECHANICAL, **ELECTRICAL**, & PLUMBING:

DESIGN/BUILD/PERMIT BY LICENSED CONTRACTOR

**BUILDING/PLANNING CODE** INFORMATION:

SEE SHEET A112 FOR ADD'L PARCEL COVERAGE CALCULATIONS

**TYPE OF CONSTRUCTION:** 

**ROOF CONSTRUCTION:** 

ALLOWABLE HEIGHT: BUILDABLE AREA:

OCCUPANT LOAD:

SMOKE DETECTOR **REQUIREMENTS:** 

EGRESS REQUIREMENTS:

PER SECTION 1006.2.1: IN GROUP-R-2 AND R-3 OCCUPANCIES, ONE MEANS OF EGRESS IS PERMITTED WITHIN AND FROM INDIVIDUAL DWELLING UNITS WITH A MAXIMUM OCCUPANT LOAD OF 20 WHERE THE DWELLING UNIT IS EQUIPPED THROUGHOUT WITH AN AUTOMATIC SPRINKLER SYSTEM IN ACCORDANCE WITH SECTION 903.1.1 OR 903.2.1.2 AND THE COMMON PATH OF EGRESS TRAVEL DOES NOT EXCEED 125 FEET SMOKE DETECTORS TO BE HARD-WIRED AND INTERCONNECTED WITH BATTERY BACKUP PER CBC.

#### CEC, PART 5, CBSC TITLE 24:

ENERGY CALC CO 45 MITCHELL BLVD SUITE 16 SAN RAFAEL, CA 94903 T: +1 415 457 0990

TYPE V-B

CLASS 'B' OR HIGHER PER CBC TABLE 1505.1

50'-0" PER TABLE 504.3 12,000 SF

2883 SF/ 200 GROSS = 14 PERSONS

STATE FIRE MARSHAL REGS. AND COASTSIDE FIRE ORDINANCE 2019-03. ONE DETECTOR MIN AT EACH FLOOR, ONE DETECTOR PER SLEEPING AREA, ONE CENTRALLY-LOCATED DETECTOR PER ACCESS AREA TO SLEEPING AREA.

1002	
A003	LOT COVERAGE DIAGRAM
CIVIL	
C001	COVER SHEET
C002	GRADING & DRAINAGE PLAN
C003	UTILITY PLAN
C004	CROSS SECTIONS
C005	CONSTRUCTION DETAILS
C006	CONSTRUCTION DETAILS
C007	CONSTRUCTION DETAILS
C008	<b>EROSION &amp; SEDIMENT CONTROL PLANS</b>
C009	<b>EROSION &amp; SEDIMENT CONTROL DETAILS</b>
SURVE	Y
SU-1	SITE - SURVEY
LANDS	CAPE
L001	LANDSCAPE DESIGN PLAN & SITE LIGHTING PLAN
L002	LANDSCAPE PLANTING PLAN
IRRIGA	ATION
IR-I1	IRRIGATION PLAN
IR-I2	IRRIGATION NOTES AND LEGEND
IR-I3	IRRIGATION DETAILS
IR-I4	IRRIGATION DETAILS
IR-15	IRRIGATION DETAILS
ARCHI	TECTURAL
A011	DEMOLITION SITE PLAN
A112	ARCHITECTURAL SITE PLAN
A113	ARCHITECTURAL SITE SECTIONS
1011	
A211	GROUND FLOOR PLAN

SHEET LIST-PLANNING

#

**GENERAL INFORMATION** 

A002 LIFE & FIRE SAFETY PLAN

A000 COVER SHEET

NAME

A212 SECOND FLOOR PLAN & ROOF PLAN A311 ELEVATIONS A312 ELEVATIONS

#### FIRE PROTECTION:

**BUILDING/PLANNING CODE** 

**INFORMATION:** 

**FIRE SPRINKLER** 

**REQUIREMENTS:** 

TBD

#### LANDSCAPE DESIGN:

TOMAS MCKAY: ARCHITECTURE-LANDSCAPE ARCHITECTURE 217 BONITA AVE, PIEDMONT CA 94611 T: +1 415 730 6649

AND GARAGE. ALL UNDERGROUND

**IRRIGATION:** 

RUSSELL D MITCHELL & ASSOCIATES 2760 CAMINO DIABLO, WALNUT CREEK CA 94597 T: +1 925 939 3985

**PROVIDE AUTOMATIC SPRINKLER** SYSTEM (INSTALLED UNDER SEPARATE PERMIT) AT DWELLING



#### **REVISION:**

DESCRIPTION

DESIGN REVIEW APPLICATION PLN2021-00187 CYCLE 2 PLN2021-00187 CYCLE 3 COASTSIDE DESIGN REVIEW

5/11/2021 8/5/2021

DATE

12/21/2021 02/16/2022

**FOR REVIEW & FILING NOT FOR CONSTRUCTION** 

STAMP:



ARCHITECT:

### **David Jaehning Architect**

381 11th Street, San Francisco, California 94103

CONSULTANT TEAM: STRUCTURAL/CIVIL: Design Everest, Inc. 365 Flower Lane, Mountain View, CA 94043

LANDSCAPE ARCHTECTURE Tomas McKay: Architecture-Landscape Architecture 217 Bonita Avenue, Piedmont, CA 94611

**IRRIGATION:** Russell D Mitchell & Associates, Inc. 2760 Camino Diablo, Walnut Creek, CA 94597

CLIENT:

#### Irene Chan-Jones and Bill Jones

100 Burlwood Drive, San Francisco, CA 94127

COUNTY APPROVAL STAMP

PROJECT NAME: PROJECT NO: 2101 House on a Hill APN: 036-031-280 PROJECT 10th Street ADDRESS: Montara, CA 94037 **PROJECT PHASE:** Construction Documents DRAWN: AG CHECKED Checker ISSUE DATE: 2/16/2022 9:03:01 PM DRAWING TITLE: COVER SHEET DRAWING NO: **A000** 

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#### SURVEYOR:

T: +1 650 212 1030

SHEET LIST-PLANNING

NAME

#

A313 ELEVATIONS

**BGT LAND SURVEYING** 871 WOODSIDE WAY SAN MATEO, CA 94401






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**REVISION:** NO. DESCRIPTION

PLN2021-00187 CYCLE 2 PLN2021-00187 CYCLE 3 DATE 8/5/2021 12/21/2021

#### **Fire Resistive Construction**

703A.2 Qualification by Testing

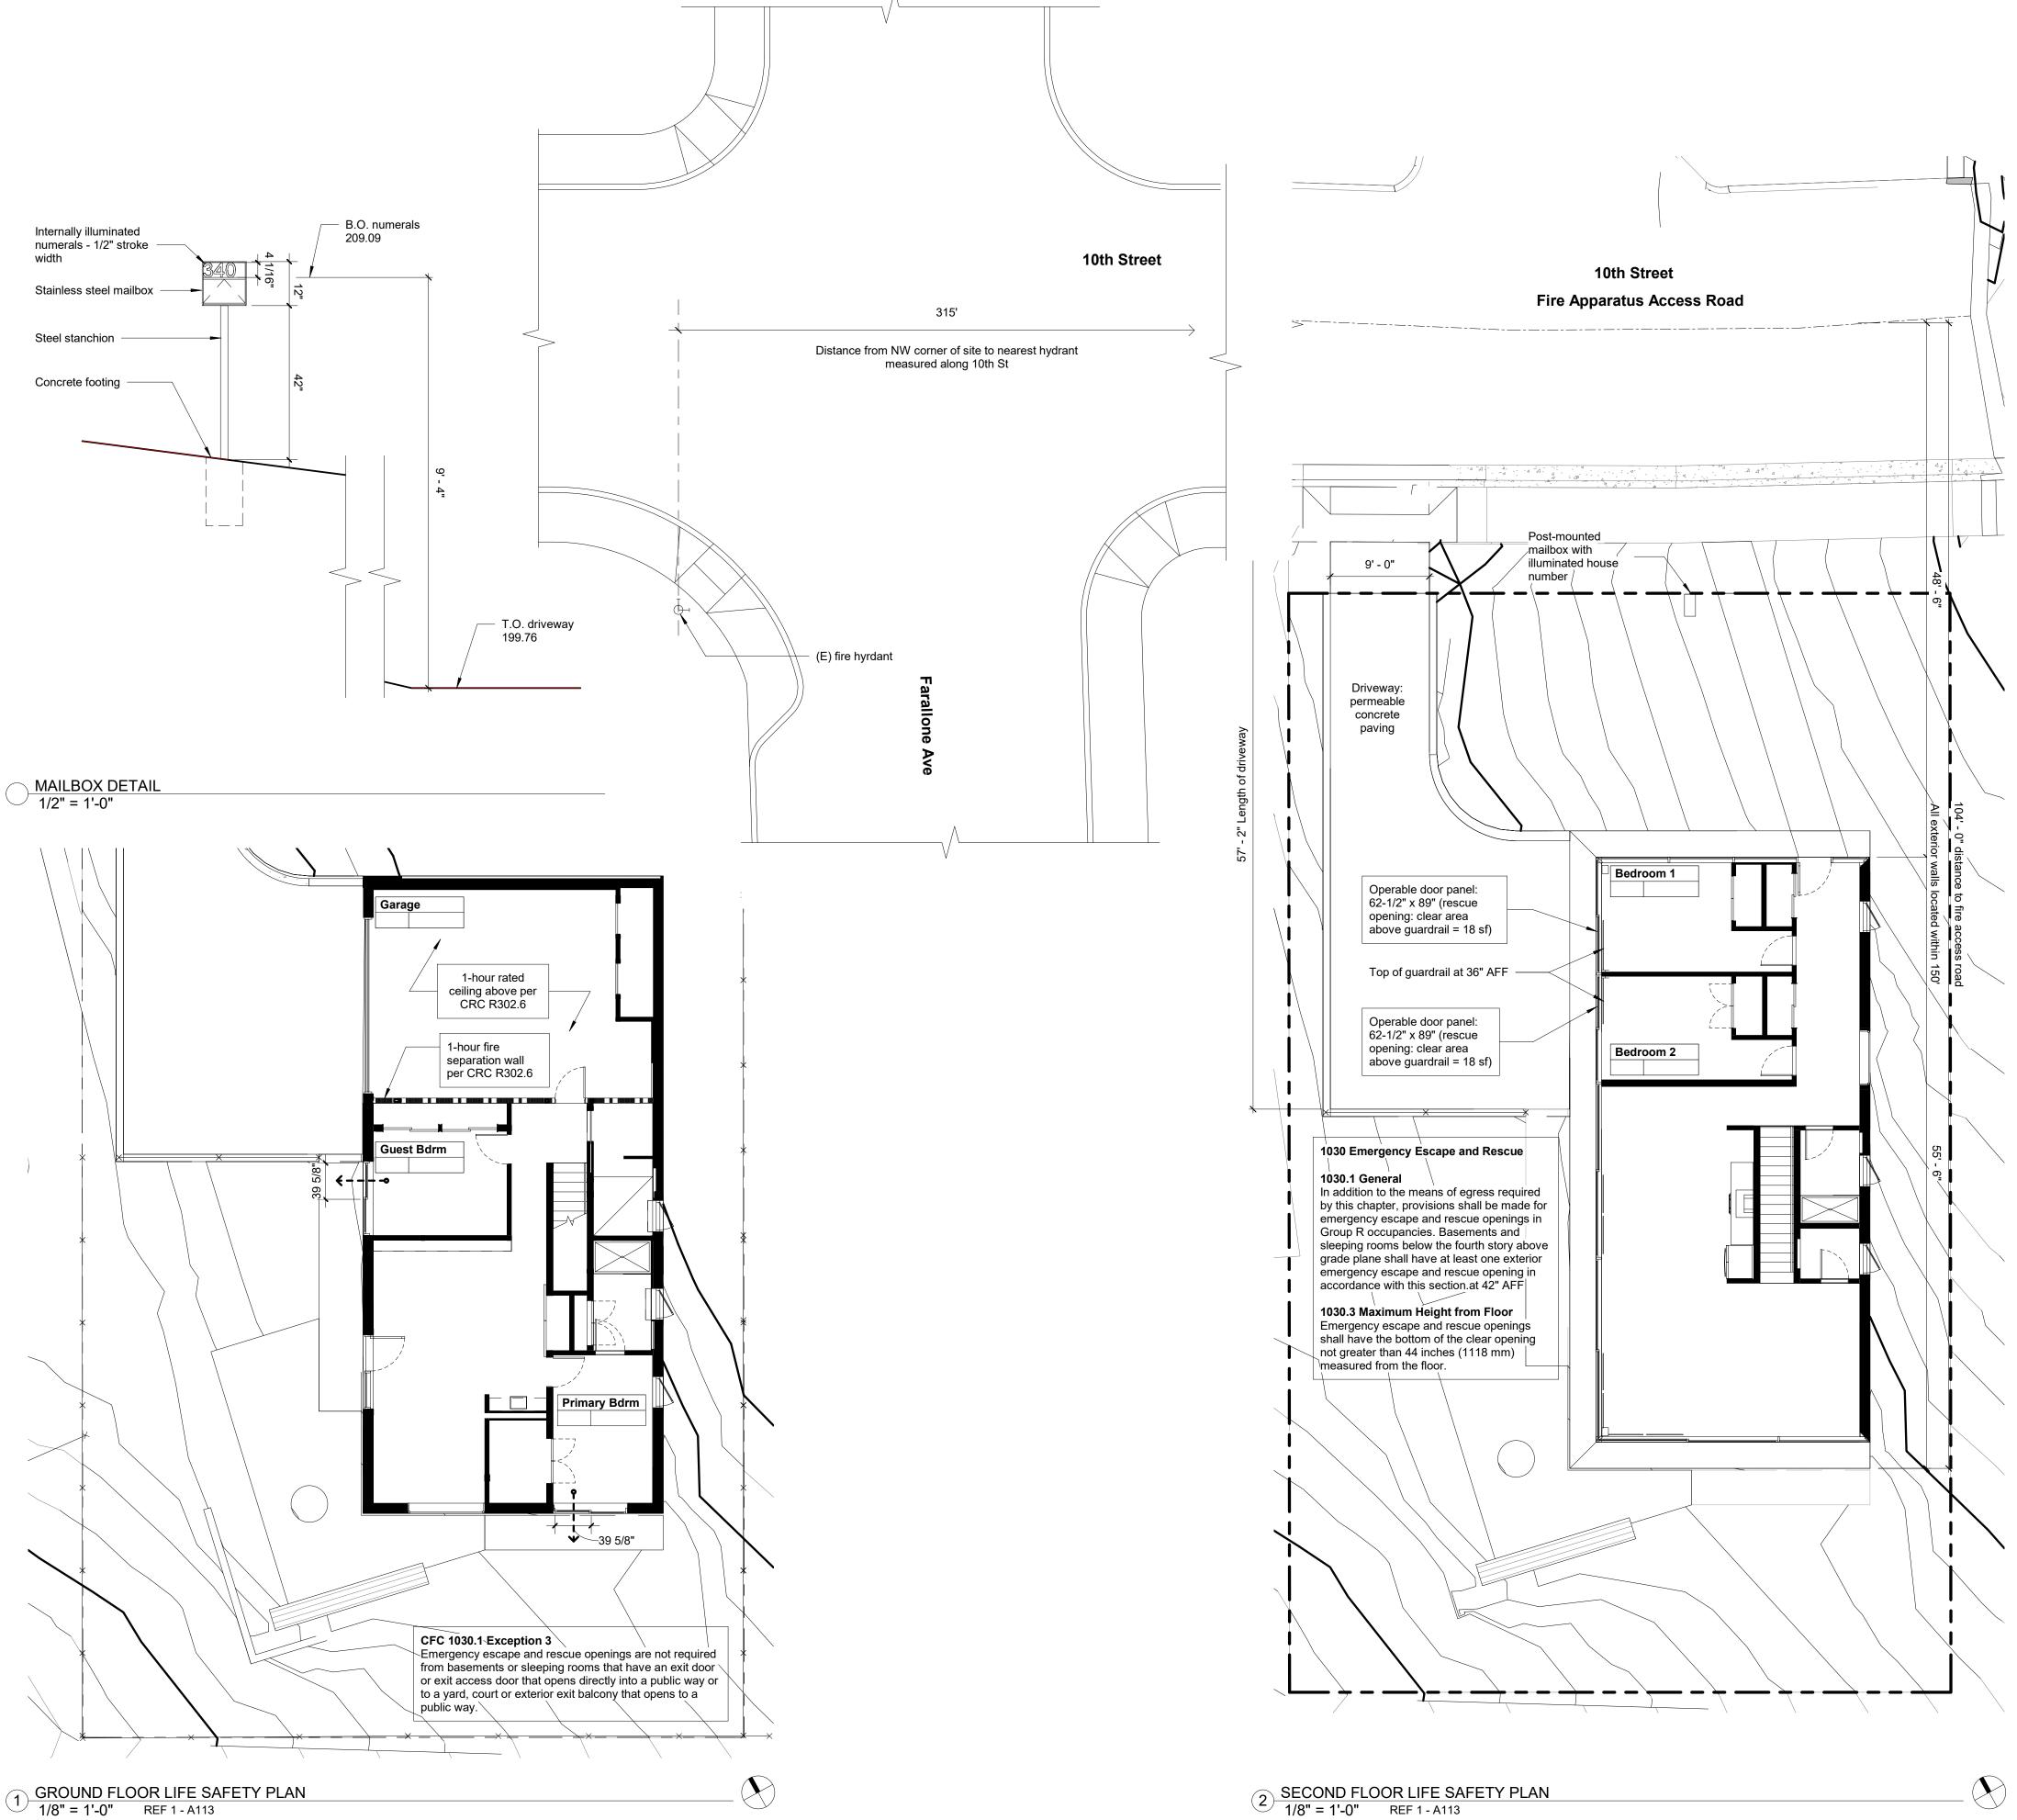Material and material assemblies tested in accordance with the requirements of Section 703A shall be accepted for use when the results and conditions of those tests are met. Product evaluation testing of material and material assemblies shall be approved or listed by the State Fire Marshal, or identified in a current report issued by an approved agency.

704A.4 Alternative Methods for Determining Ignition-Resistant Material

1. Noncombustible material. Material that complies with the definition for noncombustible materials in Section 202.

NONCOMBUSTIBLE. Material of which no part will ignite and burn when subjected to fire. Any material passing ASTM E136 shall be considered noncombustible.

#### 705A.2 Roof Coverings

Where the roof profile allows a space between the roof covering and roof decking, the spaces shall be constructed to resist the intrusion of flames and embers, be firestopped with approved materials or have one layer of minimum 72 pound (32.4 kg) mineral-surfaced nonperforated cap sheet complying with ASTM D3909 installed over the combustible decking.

#### 705A.4 Roof Gutters

Roof gutters shall be provided with the means to prevent the accumulation of leaves and debris in the gutter.

Exception: Any of the following shall be deemed to meet the assembly performance criteria and intent of this section:

#### 707A.3 Exterior Walls

1. One layer of 5/8-inch Type X gypsum sheathing applied behind the exterior covering or cladding on the exterior side of the framing

2. The exterior portion of a 1-hour fire resistive exterior wall assembly designed for exterior fire exposure including assemblies using the gypsum panel and sheathing products listed in the Gypsum Association Fire Resistance Design Manual

707A.5 Enclosed Roof Eaves and Roof Eave Soffits


The exposed underside of enclosed roof eaves having either a boxed-in roof eave soffit with a horizontal underside, or sloping rafter tails with an exterior covering applied to the under-side of the rafter tails, shall be protected by one of the following:

#### Noncombustible material Ignition-resistant material

Ŏne layer of 5/8-inch Type X gypsum sheathing applied behind an exterior covering on the underside of the rafter tails or soffit The exterior portion of a 1-hour fire resistive exterior wall assembly applied to the underside of the rafter tails or soffit including assemblies using the gypsum panel and sheathing products listed in the Gypsum Association Fire Resistance Design Manual

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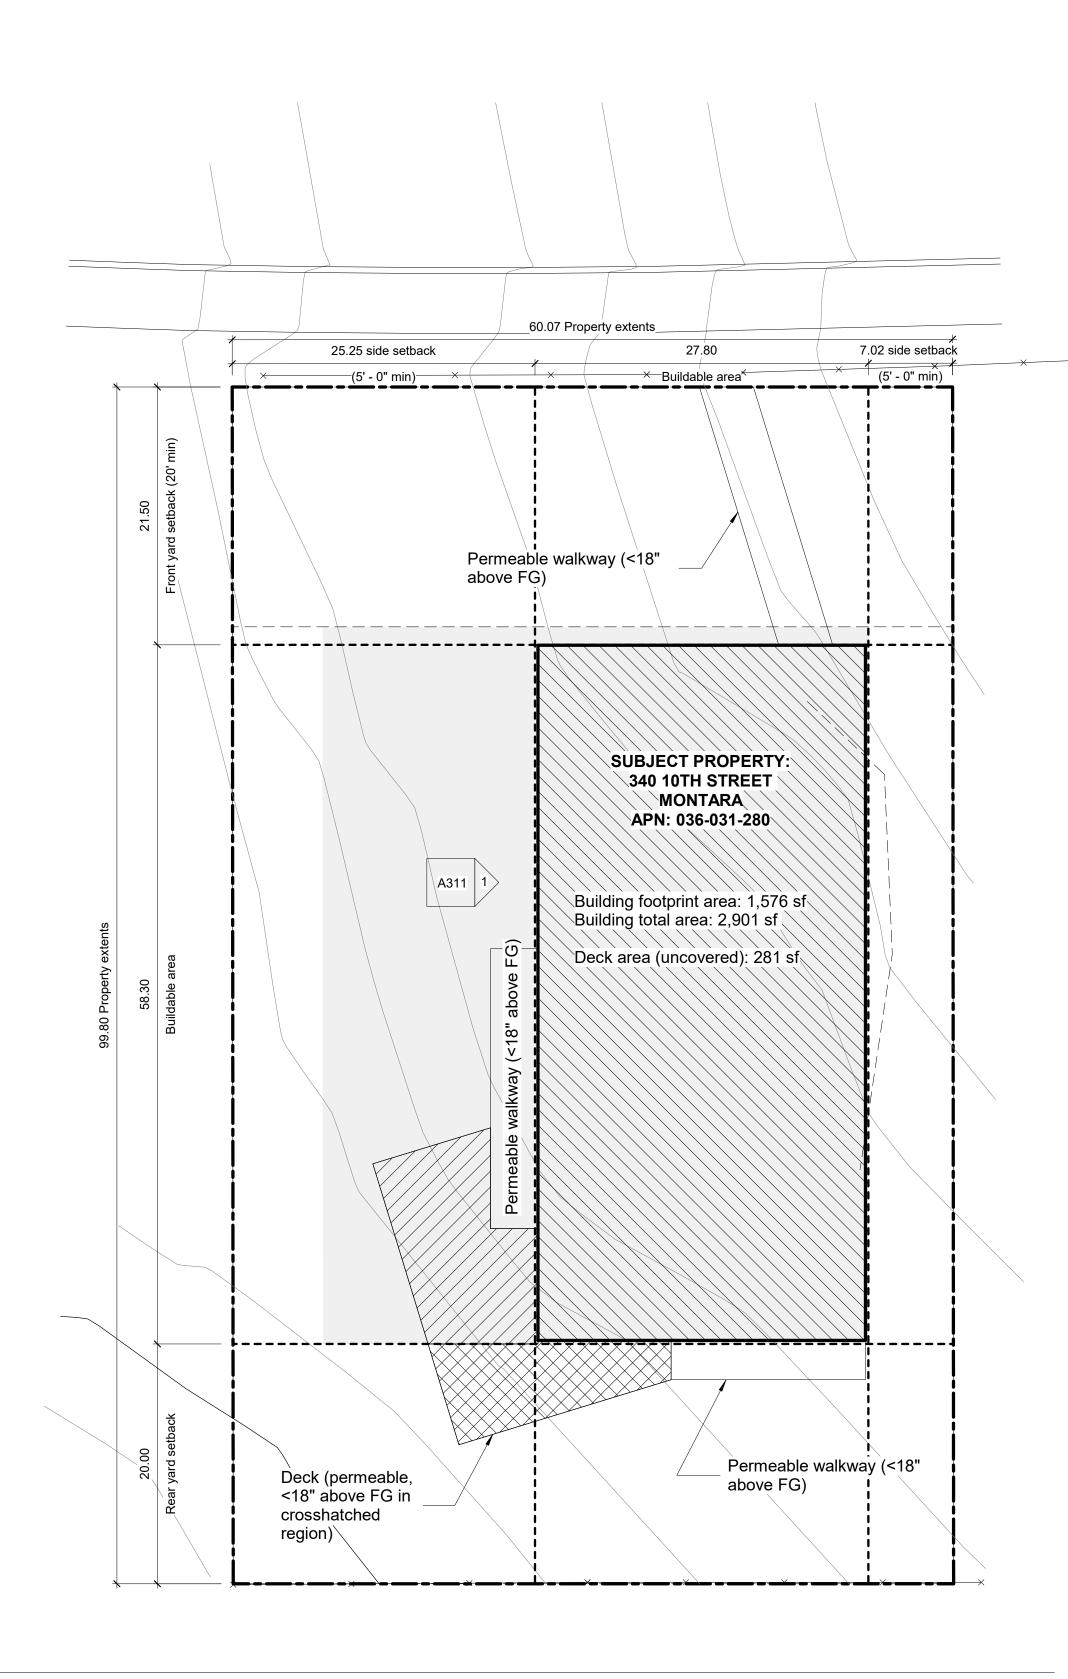
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100 Burlwood Drive, San Francisco, CA 94127

COUNTY APPROVAL STAMP

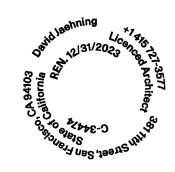PROJECT NO:	PROJECT NAME:				
2101	House o	n a Hill			
APN:	036-031-280				
PROJECT ADDRESS:					
PROJECT PHASE	PROJECT PHASE: Construction Documents				
DRAWN:	Author	CHECKED	Checker		
ISSUE DATE:	2/16/2022 9:03:03 F	PM			
DRAWING TITLE:	LIFE & FIRE SAF	ETY PLAN			
DRAWING NO:	A002				

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1 LOT COVERAGE DIAGRAM 1/8" = 1'-0"

### The following regulations shall apply in any single-family residential district with which the "S-17" District is combined.

#### Building Site Width

The minimum building site width shall be an average of 50 feet.

### Building site is 60.07' wide

**Building Site Area** The minimum building site area shall be 5,000 sq ft

#### Building site area is 5,995 sq ft ±

#### Building Setbacks

#### The minimum setbacks shall be:

Front setback: 20 ft Rear setback: 20 ft

### Side setback: 5 ft if 16 ft in height or less; For structures over 16 feet in height: combined total of 15 feet with a minimum of 5 feet on any side.

#### Proposed front yard setback: 20 ft Proposed rear yard setback: 20 ft

Proposed side yard setbacks: 25.25 ft (west) + 7.02 ft (east) = 32.27' total (>15')

In any area where the "S-17" District is combined with the "DR" District, the minimum side yard setback may be reduced to provide for creative design concepts such as "zero" side yard setbacks provided that: (1) the Design Review Committee approves, (2) the application involves joint development of two or more adjacent parcels, (3) the total side yard requirement is met and (4) a minimum side yard of 5 feet is maintained adjacent to any parcel not included

#### Parcel Coverage

with the application.

The maximum parcel coverage shall be:

a. For structures 16 feet in height or less: 50%.

b. For structures greater than 16 feet in height: 35%.

## Parcel coverage shall include all: (1) buildings, (2) accessory buildings, or (3) structures such as patios, decks, balconies, porches, bridges, and other similar uses which are eighteen (18) inches or more above the ground.

#### **Building Floor Area**

The maximum building floor area shall be established according to the parcel size: 5,000 - 11,968 sq ft = 0.53 of parcel size (or 3,177 SF)

### The maximum building floor area shall include the floor area of all stories of all buildings and accessory buildings on a building site. Maximum building floor area specifically includes:

(1) gross floor area of all stories,
(2) the area of all decks, porches, balconies or other areas covered by a waterproof roof, which extends four (4) or more feet from exterior walls,

(3) the area of all garages and carports.

#### Parcel Coverage:

Structures >16' in height:	1,576 SF = 26.22% (complies with 35% limit)
Structures <16' in height:	281  SF = 4.6% (complies with 50% limit)
Hardscape:	94 SF = 1.5% (complies with 10% limit)
Total:	1,670 SF (28%)

Driveway (pervious) area: **752 SF** 

REVISION:NO.DESCRIPTION2PLN2021-00187 CYCLE 23PLN2021-00187 CYCLE 3

DATE 8/5/2021 12/21/2021

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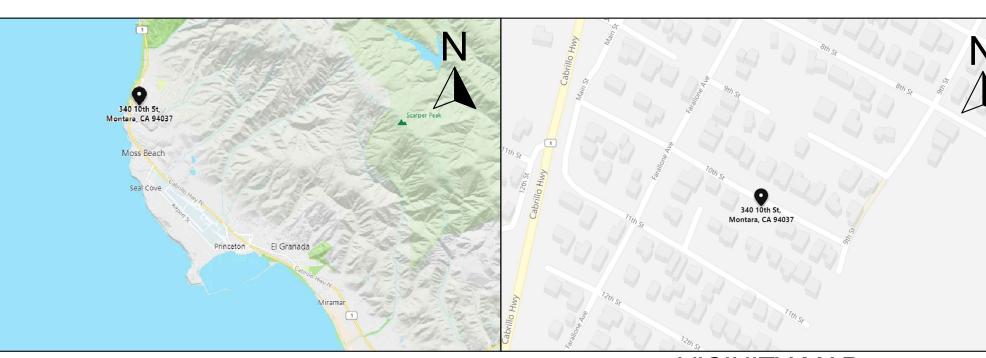
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DRAWN:	Author	CHECKED	Checker		
ISSUE DATE:	2/16/2022 9:03:04	PM			
DRAWING TITLE:	LOT COVERAGE	E DIAGRAM			
DRAWING NO:	A003				

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#### PROJECT LOCATION MAP

#### BASIS OF BEARINGS:

THE BEARING, SOUTH 61°17'53" EAST, OF THE CENTERLINE OF 10TH STREET, AS SHOWN ON THAT CERTAIN RECORD OF SURVEY WHICH WAS FILED FOR RECORD IN BOOK 23 OF LLS MAPS PAGE 87 ON JUNE 20, 2002, SAN MATEO COUNTY RECORDS., WAS USED AS THE BASIS OF BEARINGS FOR THIS SURVEY.

#### **BENCHMARK:**

ELEVATIONS SHOWN HEREON ARE BASED UPON NGVD 29 ("MEAN SEA LEVEL" DATUM. SITE BENCHMARK IS THE SANITARY SEWER MANHOLE LID WITH AN ELEVATION OF 200.75 FEET.

#### SURVEY NOTES:

BGT RELIED UPON A LAWYERS TITLE COMPANY PRELIMINARY TITLE REPORT, ORDER NO. 0051900303, AS TITLE REFERENCE. NO EASEMENTS WERE REFERENCED WITHIN SAID REPORT.

UTILITIES SHOWN HEREON TAKEN FROM VISUAL SURFACE EVIDENCE AND SHOULD BE CONSIDERED AS APPROXIMATE ONLY. ACTUAL LOCATIONS OF UTILITIES MAY VARY. TRUE LOCATION OF UTILITIES CAN ONLY BE OBTAINED BY EXPOSING THE UTILITY.

SURVEY PERFORMED BY: BGT LAND SURVEYING www.bgtsurveying.com

#### STATEMENT OF RESPONSIBILITY:

- 1. CONTRACTOR AGREES THAT HE SHALL ASSUME SOLE AND COMPLETE RESPONSIBILITY FOR JOB SITE CONDITIONS DURING THE COURSE OF CONSTRUCTION OF THIS PROJECT, INCLUDING SAFETY OF ALL PERSONS AND PROPERTY; THAT THIS REQUIREMENT SHALL APPLY CONTINUOUSLY AND NOT BE LIMITED TO NORMAL WORKING HOURS AND THAT THE CONTRACTOR SHALL DEFEND, INDEMNIFY AND HOLD THE OWNER AND THE ENGINEER HARMLESS FROM ANY AND ALL LIABILITY, REAL OR ALLEGED, IN CONNECTION WITH THE PERFORMANCE OR WORK ON THIS PROJECT.
- 2. PROTECT TREES TO REMAIN. UNLESS OTHERWISE NOTED. BOTH ON-SITE AND ADJACENT PROPERTIES.
- 3. PROTECT NEIGHBORING PROPERTIES FROM DAMAGE DURING CONSTRUCTION.
- 4. IT IS THE CONTRACTOR'S RESPONSIBILITY TO MAINTAIN AND PRESERVE THE EXISTING MONUMENTS OF RECORD. SHOULD THE CONTRACTOR DESTROY OR DISTURB ANY MONUMENTS OF RECORD, THE CONTRACTOR SHALL, AT ITS SOLE EXPENSE, RETAIN A CALIFORNIA LICENSED LAND SURVEYOR TO REPLACE SAID MONUMENTS AND FILE AN APPROPRIATE CORNER RECORD.
- 5. CONTRACTOR SHALL REPLACE OR REPAIR, AT HIS OWN EXPENSE, ALL DAMAGED, REMOVED OR OTHERWISE DISTURBED EXISTING UTILITIES. OR IMPROVEMENTS IN KIND.
- 6. THE CONTRACTOR SHALL COMPLY WITH ALL OSHA REQUIREMENTS RELATED TO SHORING OF EXCAVATIONS.
- 7. CONTRACTOR SHALL CLEAN STREETS TO REMOVE ACCUMULATION OF MUD AND DEBRIS RESULTING FORM CONSTRUCTION ACTIVITIES.
- 8. THE CONTRACTOR IS RESPONSIBLE FOR CONFORMING TO EXISTING PAVEMENT, ADJACENT LANDSCAPE AND OTHER IMPROVEMENTS WITH A SMOOTH TRANSITION IN PAVING, CURBS, GUTTERS, SIDEWALK, ETC. TO AVOID ABRUPT OR APPARENT CHANGES IN GRADES OR CROSS SLOPES, LOW SPOTS OR HAZARDOUS CONDITIONS
- 9. CONTRACTOR TO OBTAIN REQUIRED PERMITS FOR HAUL ROUTES PRIOR TO DEMOLITION AND CONSTRUCTION.
- 10. CONTRACTOR IS RESPONSIBLE FOR SCHEDULING ALL INSPECTIONS AS REQUIRED.
- 11. THE CONTRACTOR SHALL TAKE ALL NECESSARY PRECAUTIONS TO PRESERVE AND PROTECT THOSE TREES AND ANY FENCES WHICH MAY BE REQUIRED TO REMAIN BY THE OWNER.

### PERVIOUS CONCRETE REQUIREMENTS:

#### CONTRACTOR OR PERMITEE SHALL:

- . PROVIDE CERTIFICATION FROM THE CONCRETE MANUFACTURER THAT THE CONCRETE MEETS THE REQUIREMENTS OF THE C3 STORMWATER HANDBOOK FOR PERVIOUS CONCRETE. THIS INCLUDES, BUT IS NOT LIMITED TO, HAVING A MINIMUM SURFACE INFILTRATION RATE OF 100 INCHES PER HOUR WHEN TESTED IN ACCORDANCE WITH ASTM C1701
- 2. ONLY CONTRACTORS HOLDING CERTIFICATION OF COMPLETION FROM THE NATIONAL READY MIX CONCRETE ASSOCIATION (NRMA) SHALL INSTALL THE CONCRETE AND AT LEAST ONE FOREMAN WITH THIS CERTIFICATION MUST BE ON THE JOB SITE AT ALL TIMES DURING CONCRETE INSTALLATION.
- 3. PROTECT THE EXCAVATED AREA FROM EXCESSIVE COMPACTION DUE TO CONSTRUCTION TRAFFIC AND PROTECT THE FINISHED PAVEMENT FROM CONSTRUCTION TRAFFIC.

#### MAINTENANCE:

- 1. A MAINTENANCE PLAN SHALL BE PROVIDED 2. KEEP LANDSCAPED AREAS WELL MAINTAINED
- 3. PREVENT SOIL FROM WASHING ONTO THE PAVEMENT. PERVIOUS PAVEMENT SURFACE SHALL BE VACUUM CLEANED USING COMMERCIALLY AVAILABLE SWEEPING MACHINES AT FOLLOWING TIMES: --END OF WINTER (APRIL)
  - -MID-SUMMER (JULY / AUGUST)
  - -AFTER AUTUMN LEAF-FALL (NOVEMBER)
- 4. INSPECT OUTLETS YEARLY, PREFERABLY BEFORE WET SEASON. REMOVE ACCUMULATED TRASH/DEBRIS.
- 5. WHEN VACUUM CLEANING, INSPECT PERVIOUS PAVING FOR ANY SIGNS OF HYDRAULIC FAILURE.

#### AS NEEDED MAINTENANCE:

- 1. IF ROUTINE CLEANING DOES NOT RESTORE INFILTRATION RATES, THEN RECONSTRUCTION OF PART OF THE PERVIOUS SURFACE MAY BE REQUIRED.
- 2. THE SURFACE AREA AFFECTED BY HYDRAULIC FAILURE SHOULD BE LIFTED, IF POSSIBLE, FOR INSPECTION OF
- THE INTERNAL MATERIALS TO IDENTIFY THE LOCATION AND EXTENT OF BLOCKAGE. 3. LIFT AND REPLACE SURFACE MATERIALS AS NEEDED TO RESTORE INFILTRATION.
- GEOTEXTILES MAY NEED COMPLETE REPLACEMENT.
- 4. SUB-SURFACE LAYERS MAY NEED CLEANING AND REPLACING.
- 5. REMOVED SILTS MAY NEED TO BE DISPOSED OF AS CONTROLLED WASTE.

### VICINITY MAP

### EARTHWORK QUANTITIES


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#### SHEET INDEX:

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HEET NO.	DESCRIPTION
C001	COVER SHEET
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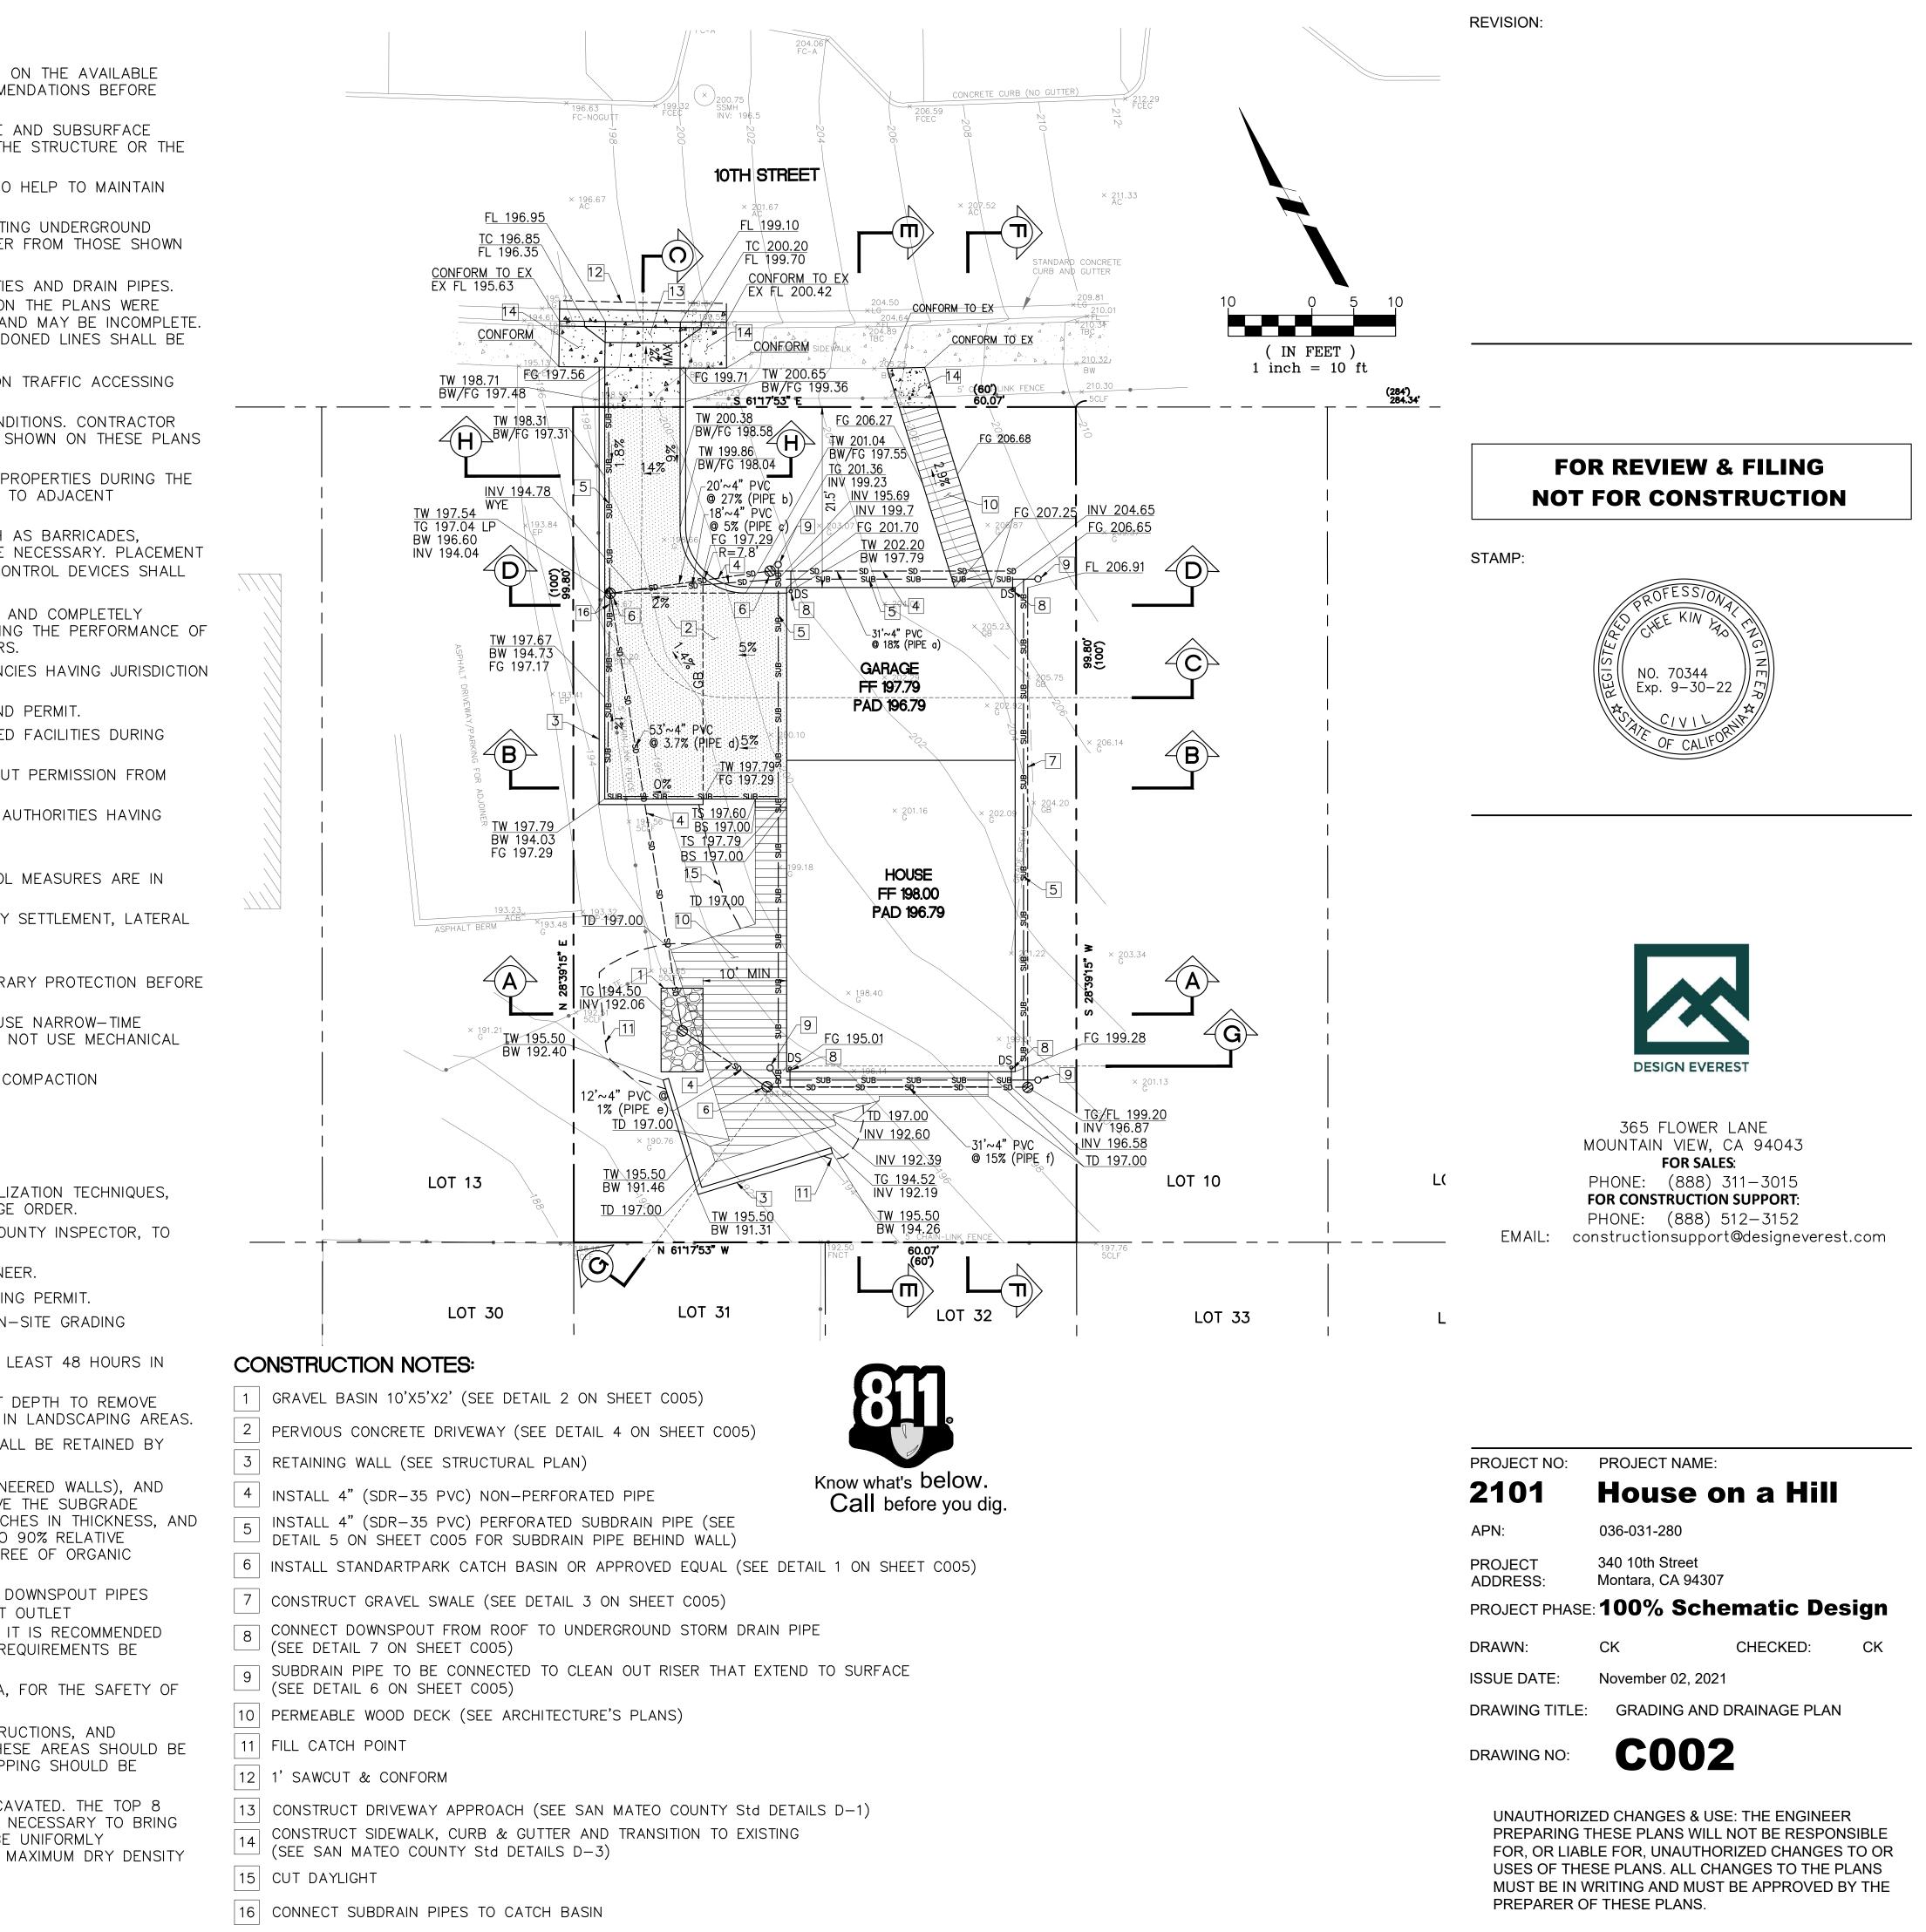
# SITE IMPROVEMENT PLAN



**REVISION:** 

#### **GRADING/DRAINAGE NOTES**:

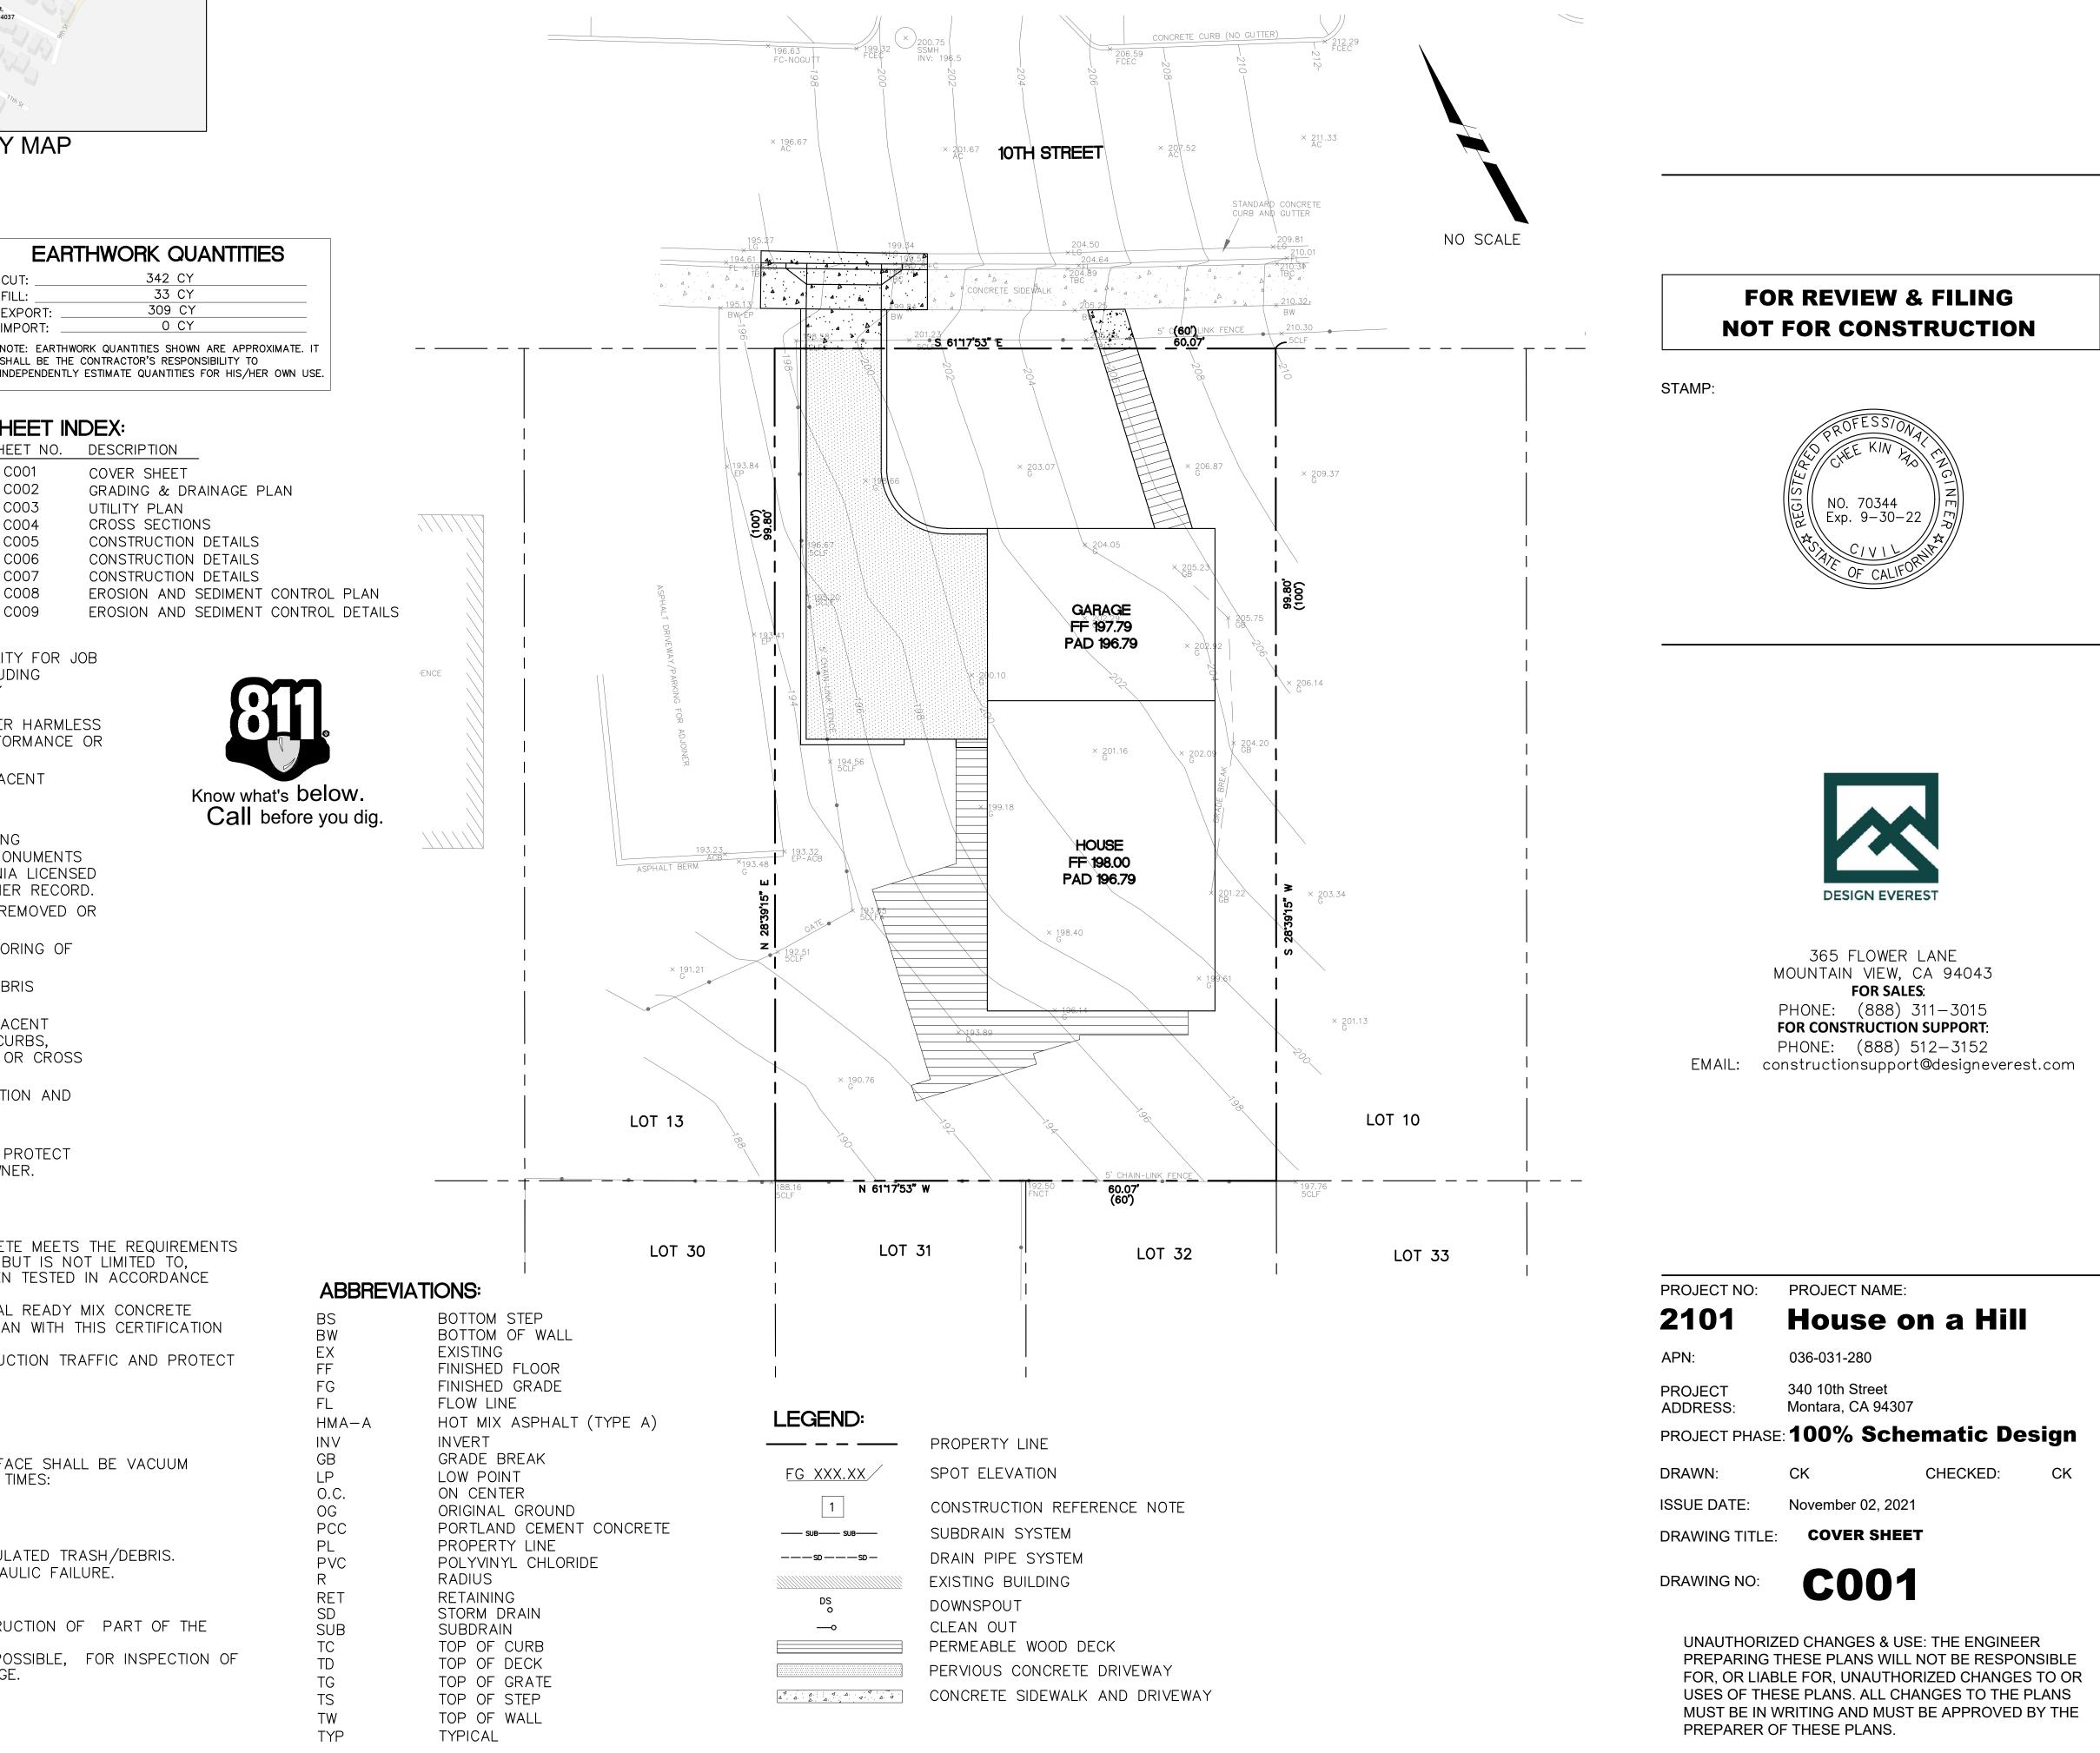
- 1. THE DESIGN AND LOCATIONS OF SUBDRAINAGE SYSTEMS AROUND THE FOUNDATION PERIMETER ARE DEPEND ON THE AVAILABLE INFORMATION DURING DESIGN PHASE. GEOTECHNICAL CONSULTANT SHALL REVIEW AND PROVIDE THE RECOMMENDATIONS BEFORE GRADING WORKS BEGIN.
- 2. IT IS EXTREMELY IMPORTANT THAT STRONG MEASURES BE TAKEN TO CONTROL AND CONDUCT ALL SURFACE AND SUBSURFACE WATERS AWAY FROM THE PROJECT SITE SO THAT THEY DO NOT ADVERSELY AFFECT THE FOUNDATION OF THE STRUCTURE OR THE STABILITY OF ADJACENT SLOPES, AND THAT ALL DRAINAGE FACILITIES BE DILIGENTLY MAINTAINED
- 3. PROTECTIVE NATURAL VEGETATION, AND EVEN PLANTING TREES AND SHRUBS ON BARREN SLOPES WILL ALSO HELP TO MAINTAIN SLOPE STABILITY AND LIMIT EROSION.
- 4. THE CONTRACTOR SHALL POTHOLE AND VERIFY LOCATIONS AND ELEVATIONS OF ALL CONNECTIONS TO EXISTING UNDERGROUND FACILITIES BEFORE ANY CONSTRUCTION. THE ENGINEER MUST BE NOTIFIED IMMEDIATELY IF CONDITIONS DIFFER FROM THOSE SHOWN ON THE PLANS SO THAT DESIGN CHANGES CAN BE MADE.
- 5. IT IS THE CONTRACTOR'S RESPONSIBILITY TO VERIFY THE LOCATIONS OF ALL EXISTING UNDERGROUND UTILITIES AND DRAIN PIPES. CALL USA (UNDERGROUND SERVICE ALERT) 2 WORKING DAYS BEFORE DIGGING AT 811. LOCATIONS SHOWN ON THE PLANS WERE TAKEN FROM AVAILABLE RECORDS AND ARE APPROXIMATE AND SHOWN FOR GENERAL INFORMATION ONLY, AND MAY BE INCOMPLETE RELOCATION OR REPAIR OF ANY DAMAGE TO UTILITIES OR PIPELINES AND PLUGGING OR REMOVAL OF ABANDONED LINES SHALL BE THE CONTRACTOR'S RESPONSIBILITY.
- 6. CONSTRUCTION ENTRANCES SHALL BE INSTALLED PRIOR TO COMMENCEMENT OF GRADING. ALL CONSTRUCTION TRAFFIC ACCESSING AND EXITING THE SITE MUST CROSS THE STABILIZED CONSTRUCTION ENTRANCE WAYS.
- 7. INFORMATION REGARDING EXISTING UTILITIES IS FROM RECORD DATA AND MAY NOT REPRESENT ACTUAL CONDITIONS. CONTRACTOR SHALL CONDUCT FIELD EVALUATION OF ALL EXISTING SUBSURFACE IMPROVEMENTS AND UTILITIES, WHETHER SHOWN ON THESE PLANS OR NOT. PRIOR TO THE COMMENCEMENT OF WORK
- 8. THE CONTRACTOR SHALL TAKE ALL PRECAUTIONS NECESSARY TO AVOID PROPERTY DAMAGE TO ADJACENT PROPERTIES DURING THE CONSTRUCTION PHASE OF THE PROJECT. THE CONTRACTOR WILL BE HELD RESPONSIBLE FOR ANY DAMAGES TO ADJACENT PROPERTIES OCCURRING DURING THE CONSTRUCTION PHASE OF THE PROJECT
- 9. THE CONTRACTOR WILL BE RESPONSIBLE FOR PROVIDING AND MAINTAINING TRAFFIC CONTROL DEVICES SUCH AS BARRICADES, WARNING SIGNS, DIRECTIONAL SIGNS, FLAGMEN AND LIGHTS TO CONTROL THE MOVEMENT OF TRAFFIC WHERE NECESSARY. PLACEMENT OF THESE DEVICES SHALL BE APPROVED BY THE COUNTY/CITY ENGINEER PRIOR TO PLACEMENT. TRAFFIC CONTROL DEVICES SHALL CONFORM TO THE APPROPRIATE CALIFORNIA MUTCD (MANUAL ON UNIFORM TRAFFIC CONTROL DEVICES)
- 10. IN ACCORDANCE WITH GENERALLY ACCEPTED CONSTRUCTION PRACTICES, THE CONTRACTOR WILL BE SOLELY AND COMPLETELY RESPONSIBLE FOR CONDITIONS ON THE JOB SITE, INCLUDING SAFETY OF ALL PERSONS AND PROPERTY DURING THE PERFORMANCE OF THE WORK. THIS REQUIREMENT WILL APPLY CONTINUOUSLY AND NOT BE LIMITED TO NORMAL WORKING HOURS.
- 11. THE CONTRACTOR SHALL BE REQUIRED TO OBTAIN ALL PERMITS FROM AUTHORITIES AND REGULATORY AGENCIES HAVING JURISDICTION OVER THE SITE, AS REQUIRED, PRIOR TO BEGINNING WORK.
- 12. BEFORE BEGINNING CONSTRUCTION, THE CONTRACTOR SHALL COMPLY WITH THE EROSION CONTROL PLAN AND PERMIT 13. MINIMIZE INTERFERENCE WITH ADJOINING ROADS. STREETS. WALKS. AND OTHER ADJACENT OCCUPIED OR USED FACILITIES DURING EARTH MOVING OPERATIONS.
- 14. DO NOT CLOSE OR OBSTRUCT STREETS, WALKS, OR OTHER ADJACENT OCCUPIED OR USED FACILITIES WITHOUT PERMISSION FROM OWNER AND AUTHORITIES HAVING JURISDICTION.
- 15. PROVIDE ALTERNATE ROUTES AROUND CLOSED OR OBSTRUCTED TRAFFIC WAYS IF REQUIRED BY OWNER OR AUTHORITIES HAVING JURISDICTION.
- 16. DO NOT CONDUCT WORK ON ADJOINING PROPERTY UNLESS DIRECTED BY ENGINEER.
- 17. DO NOT COMMENCE EARTH-MOVING OPERATIONS UNTIL TEMPORARY EROSION- AND SEDIMENTATION-CONTROL MEASURES ARE IN PLACE.
- 18. PROTECT STRUCTURES, UTILITIES, SIDEWALKS, PAVEMENTS, AND OTHER FACILITIES FROM DAMAGE CAUSED BY SETTLEMENT, LATERAL MOVEMENT, UNDERMINING, WASHOUT, AND OTHER HAZARDS CREATED BY EARTH MOVING OPERATION
- 19. PROTECT AND MAINTAIN EROSION AND SEDIMENTATION CONTROLS DURING EARTH MOVING OPERATIONS
- 20. PROTECT SUBGRADES AND FOUNDATION SOILS FROM FREEZING TEMPERATURES AND FROST. REMOVE TEMPORARY PROTECTION BEFORE PLACING SUBSEQUENT MATERIALS.
- 21. EXCAVATE BY HAND AROUND TREE TO INDICATED LINES, CROSS SECTIONS, ELEVATIONS, AND SUBGRADES. USE NARROW-TIME SPADING FORKS TO COMB SOIL AND EXPOSE ROOTS. DO NOT BREAK, TEAR, OR CHOP EXPOSED ROOTS. DO NOT USE MECHANICAL EQUIPMENT THAT RIPS, TEARS, OR PULLS ROOTS
- 22. UNIFORMLY GRADE AREAS TO A SMOOTH SURFACE, FREE OF IRREGULAR SURFACE CHANGES. COMPLY WITH COMPACTION REQUIREMENTS AND GRADE TO CROSS SECTIONS, LINES, AND ELEVATIONS INDICATED
- 23. PROVIDE A SMOOTH TRANSITION BETWEEN ADJACENT EXISTING GRADES AND NEW GRADES
- 24. CONTRACTOR SHALL GRADE EVENLY BETWEEN SPOT ELEVATIONS SHOWN.
- 25.NO CUT OR FILL SLOPES MAY BE STEEPER THAN 2:1 (H:V) MAXIMUM
- 26.IN THE EVENT ADVERSE BEDDING PLANES ARE DISCOVERED DURING CONSTRUCTION REQUIRING SLOPE STABILIZATION TECHNIQUES, SUCH WORK SHALL BE APPROVED BY THE COUNTY ENGINEER UNDER A REVISED GRADING PLAN AND CHANGE ORDER. 27. FINE GRADING AROUND STRUCTURES SHALL DRAIN AWAY FROM FOOTINGS, TO THE SATISFACTION OF THE COUNTY INSPECTOR, TO SWALES WITH 1% MINIMUM SLOPE TO APPROVED DRAINAGE POINTS OR NOTED OTHERWISE ON PLANS.
- 28. ANY CHANGES IN THE WORK SHOWN HEREON SHALL BE SUBJECT TO THE APPROVAL OF THE COUNTY ENGINEER. 29.NO STOCKPILING AND/OR IMPORT/EXPORT HAULING SHALL BE PERMITTED UNLESS APPROVED ON THE GRADING PERMIT. 30. THE PERMITTEE SHALL EMPLOY A REGISTERED CIVIL ENGINEER OR SOIL ENGINEER TO PROVIDE CONSTANT ON-SITE GRADING
- SUPERVISION TO ASSURE COMPLIANCE WITH THE APPROVED PLANS. 31. WHERE IMPORT MATERIALS ARE REQUIRED FOR USE ON SITE, THE SOILS ENGINEER SHOULD BE NOTIFIED AT LEAST 48 HOURS IN
- ADVANCE OF IMPORTING IN ORDER TO SAMPLE AND TEST MATERIALS FROM PROPOSED BORROW SITES. 32. AREAS TO RECEIVE FILL OR FLATWORK SHALL BE CLEARED OF VEGETATION AND STRIPPED TO A SUFFICIENT DEPTH TO REMOVE
- MAJOR ROOT SYSTEMS. THE STRIPPED ORGANIC TOP SOIL MATERIAL MAY BE STOCK PILED FOR LATER USE IN LANDSCAPING AREAS. 33. PERMANENT CUT SLOPES SHALL BE AT A MAXIMUM INCLINATION OF 2:1 (HORIZONTAL TO VERTICAL) OR SHALL BE RETAINED BY STRUCTURAL WALLS.
- 34. FILLS PLACED ON SLOPING GRADES SHALL BE KEYED INTO FIRM SOIL AT THE BASE (OR RETAINED BY ENGINEERED WALLS), AND PROGRESSIVELY STEP-BENCHED UP THE SLOPE. THE GEOTECHNICAL ENGINEER SHALL INSPECT AND APPROVE THE SUBGRADE PREPARATION PRIOR TO PLACEMENT OF FILL. FILLS SHALL BE PLACED IN LEVEL LIFTS NO MORE THAN 8 INCHES IN THICKNESS, AND SHALL BE COMPACTED TO 95% RELATIVE COMPACTION UNDER ALL BUILDING AND PAVEMENT AREAS, AND TO 90% RELATIVE COMPACTION UNDER ALL OTHER AREAS. EXISTING SITE SOILS ARE SUITABLE AS FILL PROVIDED THEY ARE FREE OF ORGANIC MATERIAL AND ROCKS OR RUBBLE OVER 6 INCHES IN DIAMETER
- 35. DRAINAGE SYSTEM REQUIRE REGULAR MAINTENANCE TO ENSURE PROPER FUNCTIONING. CATCH BASINS AND DOWNSPOUT PIPES SHOULD BE FLUSHED REGULARLY (DEPENDANT ON THE RATE OF FALLING LEAF LITTER). IT IS CRITICAL THAT OUTLET DISSIPATERS/DRAINAGE BASINS BE INSPECTED AND FLUSHED APPLICABLE FACILITIES ON A REGULAR BASIS. IT IS RECOMMENDED THAT AN ACCURATE AS-BUILT PLAN OF THE DRAINAGE SYSTEMS BE PREPARED, AND THAT MAINTENANCE REQUIREMENTS BE DISCLOSED TO ALL FUTURE BUYERS OF THE PROPERTY.
- 36.IT IS RECOMMENDED THAT A TEMPORARY SHORING SYSTEM BE CONSTRUCTED AROUND THE BASEMENT AREA, FOR THE SAFETY OF THE CONSTRUCTION WORKERS AND FOR THE PROTECTION OF THE NEIGHBORS' EXISTING STRUCTURES.
- 37. PRIOR TO GRADING, THE PROPOSED STRUCTURE AND PAVEMENT AREAS SHOULD BE CLEARED OF ALL OBSTRUCTIONS, AND DELETERIOUS MATERIALS. THE EXISTING FOUNDATION AND PIPES SHOULD BE REMOVED. AFTER CLEARING, THESE AREAS SHOULD BE STRIPPED OF ALL ORGANIC TOPSOIL. THE PREDOMINANTLY ORGANIC MATERIALS GENERATED FROM THE STRIPPING SHOULD BE REMOVED FROM THE SITE.
- 38. AFTER THE ORGANIC TOPSOIL HAS BEEN STRIPPED, THE PROPOSED PAD AND BASEMENT AREA CAN BE EXCAVATED. THE TOP 8 INCHES OF THE BASEMENT AND GARAGE SUBGRADE SOIL SHOULD BE SCARIFIED, WATERED OR AERATED AS NECESSARY TO BRING THE SOIL TO ABOUT 2 PERCENT ABOVE THE OPTIMUM MOISTURE CONTENT. THE SUBGRADE SHOULD THEN BE UNIFORMLY RECOMPACTED TO AT LEAST 90 PERCENT RELATIVE COMPACTION. RELATIVE COMPACTION IS BASED ON THE MAXIMUM DRY DENSITY AS DETERMINED BY ASTM D1557 LATEST VERSION LABORATORY TEST PROCEDURE.



PROJECT NO:	PROJECT NAME:		
2101	House o	n a Hill	
APN:	036-031-280		
PROJECT ADDRESS:	340 10th Street Montara, CA 94307		
PROJECT PHASE	100% Sche	ematic Des	ign
DRAWN:	СК	CHECKED:	СК
ISSUE DATE:	November 02, 202 <sup>-</sup>	1	
DRAWING TITLE:	GRADING AND	DRAINAGE PLAN	
DRAWING NO:	<b>C</b> 002	2	

#### CONSTRUCTION NOTES:

- 1 TIE INTO EXISTING SEWER MAIN (SEE MWSD TYPICAL SIDE SEWER DETAIL SD-5)
- 2 TIE INTO EXISTING WATER MAIN (SEE MWSD 1" METERED SERVICE
- INSTALLATION DETAIL SD-01)
- 3 4" SEWER LATERAL PVC Sch 80 (MINIMUM 18" COVER, SEE PROFILE)
- 4 UNDERGROUND JOINT UTILITY LINE (FOR INFORMATION ONLY, SEE UTILITY COMPANIES PLANS)
- 5 DOMESTIC SERVICE POINT OF ENTRY
- 6 JOINT UTILITY LINE POINT OF ENTRY
- 7 SEWER LATERAL POINT OF ENTRY
- 8 TYPE K COPPER TUBING 1" DOMESTIC WATER LINE (MINIMUM 36" COVER)
- INSTALL 1" WATER METER (SEE MWSD 1" METERED SERVICE INSTALLATION DETAIL SD-01)
- 10 INSTALL TYPE "A" BACKWATER PREVENTION DEVISE (SEE MWSD STANDARD  $\sim$  CLEANOUT & BACKWATER PREVENTION DEVICE STANDARD DETAIL SD-6)

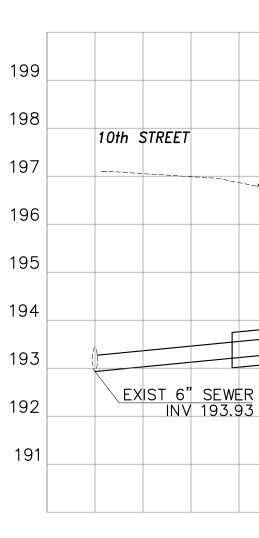

#### PROPOSED SEWER LATERAL

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#### SANITARY SEWER SYSTEMS CONSTRUCTION NOTES:

1. IT IS THE RESPONSIBILITY OF THE PROPERTY OWNER OR HIS CONTRACTOR TO LOCATE AND UNCOVER THE LATERAL STUB OR WYE INSTALLED TO SERVE THE PROPERTY. WHEN THE LATERAL STUB OR WYE CANNOT BE LOCATED, EVEN THOUGH THE DISTRICT'S RECORDS INDICATE SUCH A CONNECTION EXISTS, THE LATERAL SEWER MUST BE CONNECTED TO THE MAIN SEWER AT A LOCATION DESIGNATED BY THE DISTRICT AT THE EXPENSE OF THE PROPERTY OWNER AS REQUIRED IN SECTION 3-10 OF THIS SPECIFICATION. THE DISTRICT DOES NOT GUARANTEE THE PRESENCE OR LOCATION OF LATERAL STUBS OR WYES

2. LATERAL SEWERS MUST BE LAID BY THE SHORTEST ROUTE FROM THE BUILDING PLUMBING OUTLET TO CONNECT TO THE MAIN SEWER AND MUST BE PERPENDICULAR TO THE PUBLIC RIGHT-OFWAY WHEN POSSIBLE. ALL PIPES MUST BE LAID TO LINE AND GRADE. EACH LENGTH OF PIPE MUST BE LAID ON A FIRM BED AS DETAILED IN STANDARD DRAWING SD-4 AND MUST HAVE FULL BEARING FOR ITS ENTIRE LENGTH BETWEEN BELLS. WHEN APPLICABLE, AN ADEQUATE BELL HOLE MUST BE DUG AT THE END OF EACH PIPE LENGTH FOR MAKING THE JOINT. BLOCKING UNDER THE LATERAL SEWER WILL NOT BE PERMITTED. THE INSIDE EDGE OF ANY CUT PIPE MUST BE BEVELED, AND BOTH BELL AND SPIGOT MUST BE MARKED FOR PROPER INSPECTION AND CLEANED BEFORE THE JOINT IS MADE. CARE MUST BE TAKEN TO PREVENT FOREIGN MATERIALS FROM ENTERING THE PIPE. WATER MUST BE PUMPED FROM THE TRENCH WHILE THE PIPES ARE LAID AND THE JOINTS MADE. BACKFILL MUST BE CAREFULLY AND UNIFORMLY PLACED AROUND THE PIPE, WITH NO ROCKS OR CLODS TOUCHING THE PIPE. IN ROCKY AREAS, IMPORTED BEDDING MATERIAL MAY BE REQUIRED. PIPE MUST NOT BE COVERED UNTIL INSPECTED BY A DISTRICT REPRESENTATIVE.

3. PRIOR TO BACKFILLING, LATERAL SEWER INSTALLATIONS AND MODIFICATIONS MUST BE INSPECTED BY A DISTRICT REPRESENTATIVE OR ENGINEER (REPRESENTATIVE). WHEN REQUIRED, TESTS FOR WATERTIGHTNESS MUST BE DONE IN THE PRESENCE OF A DISTRICT REPRESENTATIVE. CONNECTIONS TO THE MAIN SEWER MUST BE DONE IN THE PRESENCE OF A DISTRICT REPRESENTATIVE. INSPECTIONS MUST BE SCHEDULED WITH THE DISTRICT GIVING THREE WORKING DAYS ADVANCE NOTICE. INSPECTIONS ARE NOT MADE ON SATURDAYS, SUNDAYS, OR HOLIDAYS.

4. EXCAVATION AND BACKFILLING. TRENCHES FOR LATERAL SEWERS WITHIN PUBLIC STREETS MUST BE EXCAVATED AND BACKFILLED AND THE PAVEMENT RESTORED IN STRICT ACCORDANCE WITH THE LAWS, ORDINANCES, AND REGULATIONS OF THE STATE OF CALIFORNIA, SAN MATEO COUNTY AND/OR AGENCY HAVING JURISDICTION OVER SAID STREET. THE DISTRICT, CITY AND/OR COUNTY RESERVES THE RIGHT TO REQUIRE COMPACTION TESTS ON TRENCH BACKFILL BY A SOILS ENGINEER. THE COST OF COMPACTION TESTS MUST BE PAID BY THE CONTRACTOR OR PROPERTY OWNER.

5. IMPERVIOUS CLAY TRENCH PLUGS MUST BE CONSTRUCTED IN THE PIPE ZONE BACKFILL AT INTERVALS OF APPROXIMATELY FIFTY (50) FEET, OR AS OTHERWISE DIRECTED BY A DISTRICT. IMPERVIOUS CLAY TRENCH PLUGS MUST: A) CONSIST OF DENSE CLAY MATERIAL FREE OF ROCKS AND VEGETATION, AND B) BE MOISTURE-CONDITIONED AND MECHANICALLY COMPACTED TO THE SAME DENSITY AS THE ADJOINING BACKFILL MATERIAL.

6. TRENCHES IN GROUND SLOPING GREATER THAN FIFTY PERCENT (50%) FROM THE HORIZONTAL MUST BE PROTECTED FROM EROSION BY PLACING RIP-RAP IN CEMENT MORTAR OR CONCRETE LAID FLUSH WITH THE SLOPE OVER THE BACKFILLED TRENCH, OR OTHER PROTECTIVE MEASURES MUST BE TAKEN AS DIRECTED BY A SOILS ENGINEER AND APPROVED BY THE DISTRICT. DRAINS WHICH ARE TWO INCHES IN DIAMETER MUST BE INSTALLED IN THE CONCRETE COVERING AT FIVE-FOOT INTERVALS ALONG THE TRENCH LINE. FOR TRENCHES IN SLOPES LESS THAN FIFTY PERCENT (50%) THE DISTRICT MAY REQUIRE THE USE OF REDWOOD TRENCH DAMS OR OTHER TYPES OF EROSION CONTROL.


7. UNLESS OTHERWISE DIRECTED BY THE DISTRICT, LATERAL SEWERS MUST BE TESTED BY PLUGGING AND FILLING WITH EITHER WATER OR COMPRESSED AIR TO FOUR (4) PSI, IN ACCORDANCE WITH THE DISTRICT STANDARD SEWER SPECIFICATIONS. FOR WATER TESTS, LEAKAGE MUST NOT EXCEED 20 GALLONS PER DAY PER INCH OF INTERNAL DIAMETER PER MILE OF SEWER LINE BEING TESTED (0.07 GALLONS PER HOUR PER 100 FEET OF 4-INCH DIAMETER PIPE). FOR AIR TESTS, THE PRESSURE MUST NOT DROP MORE THAN ONE PSI OVER A THREE-MINUTE PERIOD. TESTS MUST BE PERFORMED IN THE PRESENCE OF A DISTRICT REPRESENTATIVE.

8. PRESSURE SEWERS MUST BE TESTED UNDER A PRESSURE OF NOT LESS THAN 50 PSI WITHOUT LEAKAGE FOR A PERIOD OF FIFTEEN MINUTES. AIR TESTING IS NOT ALLOWED.

9. WHEN ENCOUNTERING SPECIAL CONDITIONS WHICH ARE NOT COVERED BY THE SPECIFICATIONS HEREIN OR THE DISTRICT STANDARD SPECIFICATIONS AND/OR CODE, A DISTRICT REPRESENTATIVE AND/OR THE DISTRICT ENGINEER WILL DIRECT THE CONTRACTOR OR PROPERTY OWNER IN THE REQUIRED PROCEDURES.

#### UTILITY NOTES:

- 1. UTILITY INFORMATION FROM PLANS AND MARKINGS WAS COMBINED WITH OBSERVED EVIDENCE OF UTILITIES FROM THE FIELD AND COUNTY/DISTRICT RECORDS TO DEVELOP A VIEW OF THE UNDERGROUND UTILITIES SHOWN HEREIN.
- 2. CONTRACTOR SHALL PROTECT EXISTING UTILITIES NOT DEEMED FOR REMOVAL. 3. ALL UTILITIES SHALL BE FURNISHED AND INSTALLED PER THE REQUIREMENTS OF THE SPECIFICATIONS, AND STANDARD DETAILS FROM MONTARA WATER AND SANITRAY
- DISTRICT (MWSD). 4. ALL UTILITY PIPE BEDDING SHALL BE CONSTRUCTED PER THE REQUIREMENTS OF THE MONTARA WATER AND SANITARY DISTRICT (MWSD) STANDARD SPECIFICATIONS AND DETAILS.
- 5. ALL CONNECTIONS TO EXISTING UTILITIES SHALL BE PERFORMED PER THE REQUIREMENTS OF THE UTILITY DISTRICT. THE MONTARA WATER AND SANITARY DISTRICT
- ENGINEER MUST BE NOTIFIED AT LEASE 48 HOURS PRIOR TO ANY UTILITY WORK. 6. 24 HOURS NOTICE SHALL BE GIVEN TO THE UTILITY COMPANIES, AND THE DISTRICT, BEFORE THE BEGINNING OF ANY OPERATION INVOLVING THEIR FACILITIES OR SYSTEMS.
- 7. CONTRACTOR SHALL NOTIFY AND COORDINATE WITH THE APPROPRIATE UTILITY COMPANIES PRIOR TO THE REMOVAL OF INDICATED UTILITIES ON SITE. CONTRACTOR SHALL BE RESPONSIBLE FOR OBTAINING ANY PERMITS REQUIRED FOR DEMOLITION AND HAUL OFF FROM THE APPROPRIATE AUTHORITIES.
- 8. BUILDING CONTRACTOR SHALL BE RESPONSIBLE FOR COORDINATION WITH THE POWER COMPANY FOR THE INSTALLATION OF ELECTRICAL CONDUIT AND CONNECTION TO EXISTING POWER SOURCE. 9. ALL SURPLUS EXCAVATED MATERIAL FROM THE TRENCH SHALL BE DISPOSED OFF THE SITE BY CONTRACTOR.
- 10. COORDINATE EXACT TRENCHING, ROUTING, AND POINT OF TERMINATION WITH ALL UTILITY COMPANIES.
- 11. CONTRACTOR SHALL COORDINATE ANY DISRUPTIONS TO EXISTING UTILITY SERVICES WITH ADJACENT PROPERTY OWNERS. 12. ALL ELECTRIC, TV CABLE AND TELEPHONE SERVICE LINES SHALL BE INSTALLED ACCORDING TO THE APPROPRIATE UTILITY COMPANIES SPECIFICATIONS AS APPLICABLE.
- ALL UTILITY DISCONNECTIONS SHALL BE COORDINATED WITH THE DESIGNATED UTILITY COMPANIES. 13. ALL TRENCH BACKFILL TO BE COMPACTED TO A MINIMUM OF 95 PERCENT OR AS INDICATED IN MWSD SPECIFICATIONS. 14. THE CONTRACTOR WILL BE RESPONSIBLE FOR PROVIDING AND MAINTAINING TRAFFIC CONTROL DEVICES SUCH AS BARRICADES, WARNING SIGNS, DIRECTIONAL SIGNS,
- FLAGMEN AND LIGHTS TO CONTROL THE MOVEMENT OF TRAFFIC WHERE NECESSARY. PLACEMENT OF THESE DEVICES SHALL BE APPROVED BY THE COUNTY ENGINEER PRIOR TO PLACEMENT. TRAFFIC CONTROL DEVICES SHALL CONFORM TO THE APPROPRIATE CALIFORNIA MUTCD (MANUAL ON UNIFORM TRAFFIC CONTROL DEVICES). 15. PRIOR TO INSTALLATION OF STORM OR SANITARY SEWER, WATER LATERAL OR ANY OTHER UTILITIES, THE CONTRACTOR SHALL EXCAVATE, VERIFY, AND DETERMINE ALL POINTS OF CONNECTION AND ALL UTILITY CROSSINGS AND INFORM THE OWNER AND THE ENGINEER OF ANY CONFLICTS OR REQUIRED DEVIATIONS FROM THE PLAN PRIOR TO CONSTRUCTION. NOTIFICATION SHALL BE MADE A MINIMUM OF 72 HOURS PRIOR TO CONSTRUCTION, THE ENGINEER AND ITS CLIENTS SHALL BE HELD
- HARMLESS IN THE EVENT THAT THE CONTRACTOR FAILS TO MAKE SUCH NOTIFICATION. 16. SEE UTILITY COMPANIES PLANS FOR ADDITIONAL INFORMATION.
- 17. NOTIFY UNDERGROUND SERVICE ALERT (USA) AT LEAST 48 HOURS PRIOR TO SITE WORK TO IDENTIFY LOCATION OF UNDERGROUND UTILITIES.

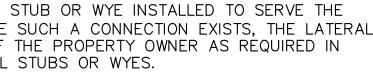

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SCALE:

H: 1"=10'

V: 1"=2'

FG


4" PVC Sch 80 @ 2%

SEE MWSD SEWER PIPE CASING

STANDARD DETAIL SD 10.1


EXIST WATER

(FIELD VERIFY)

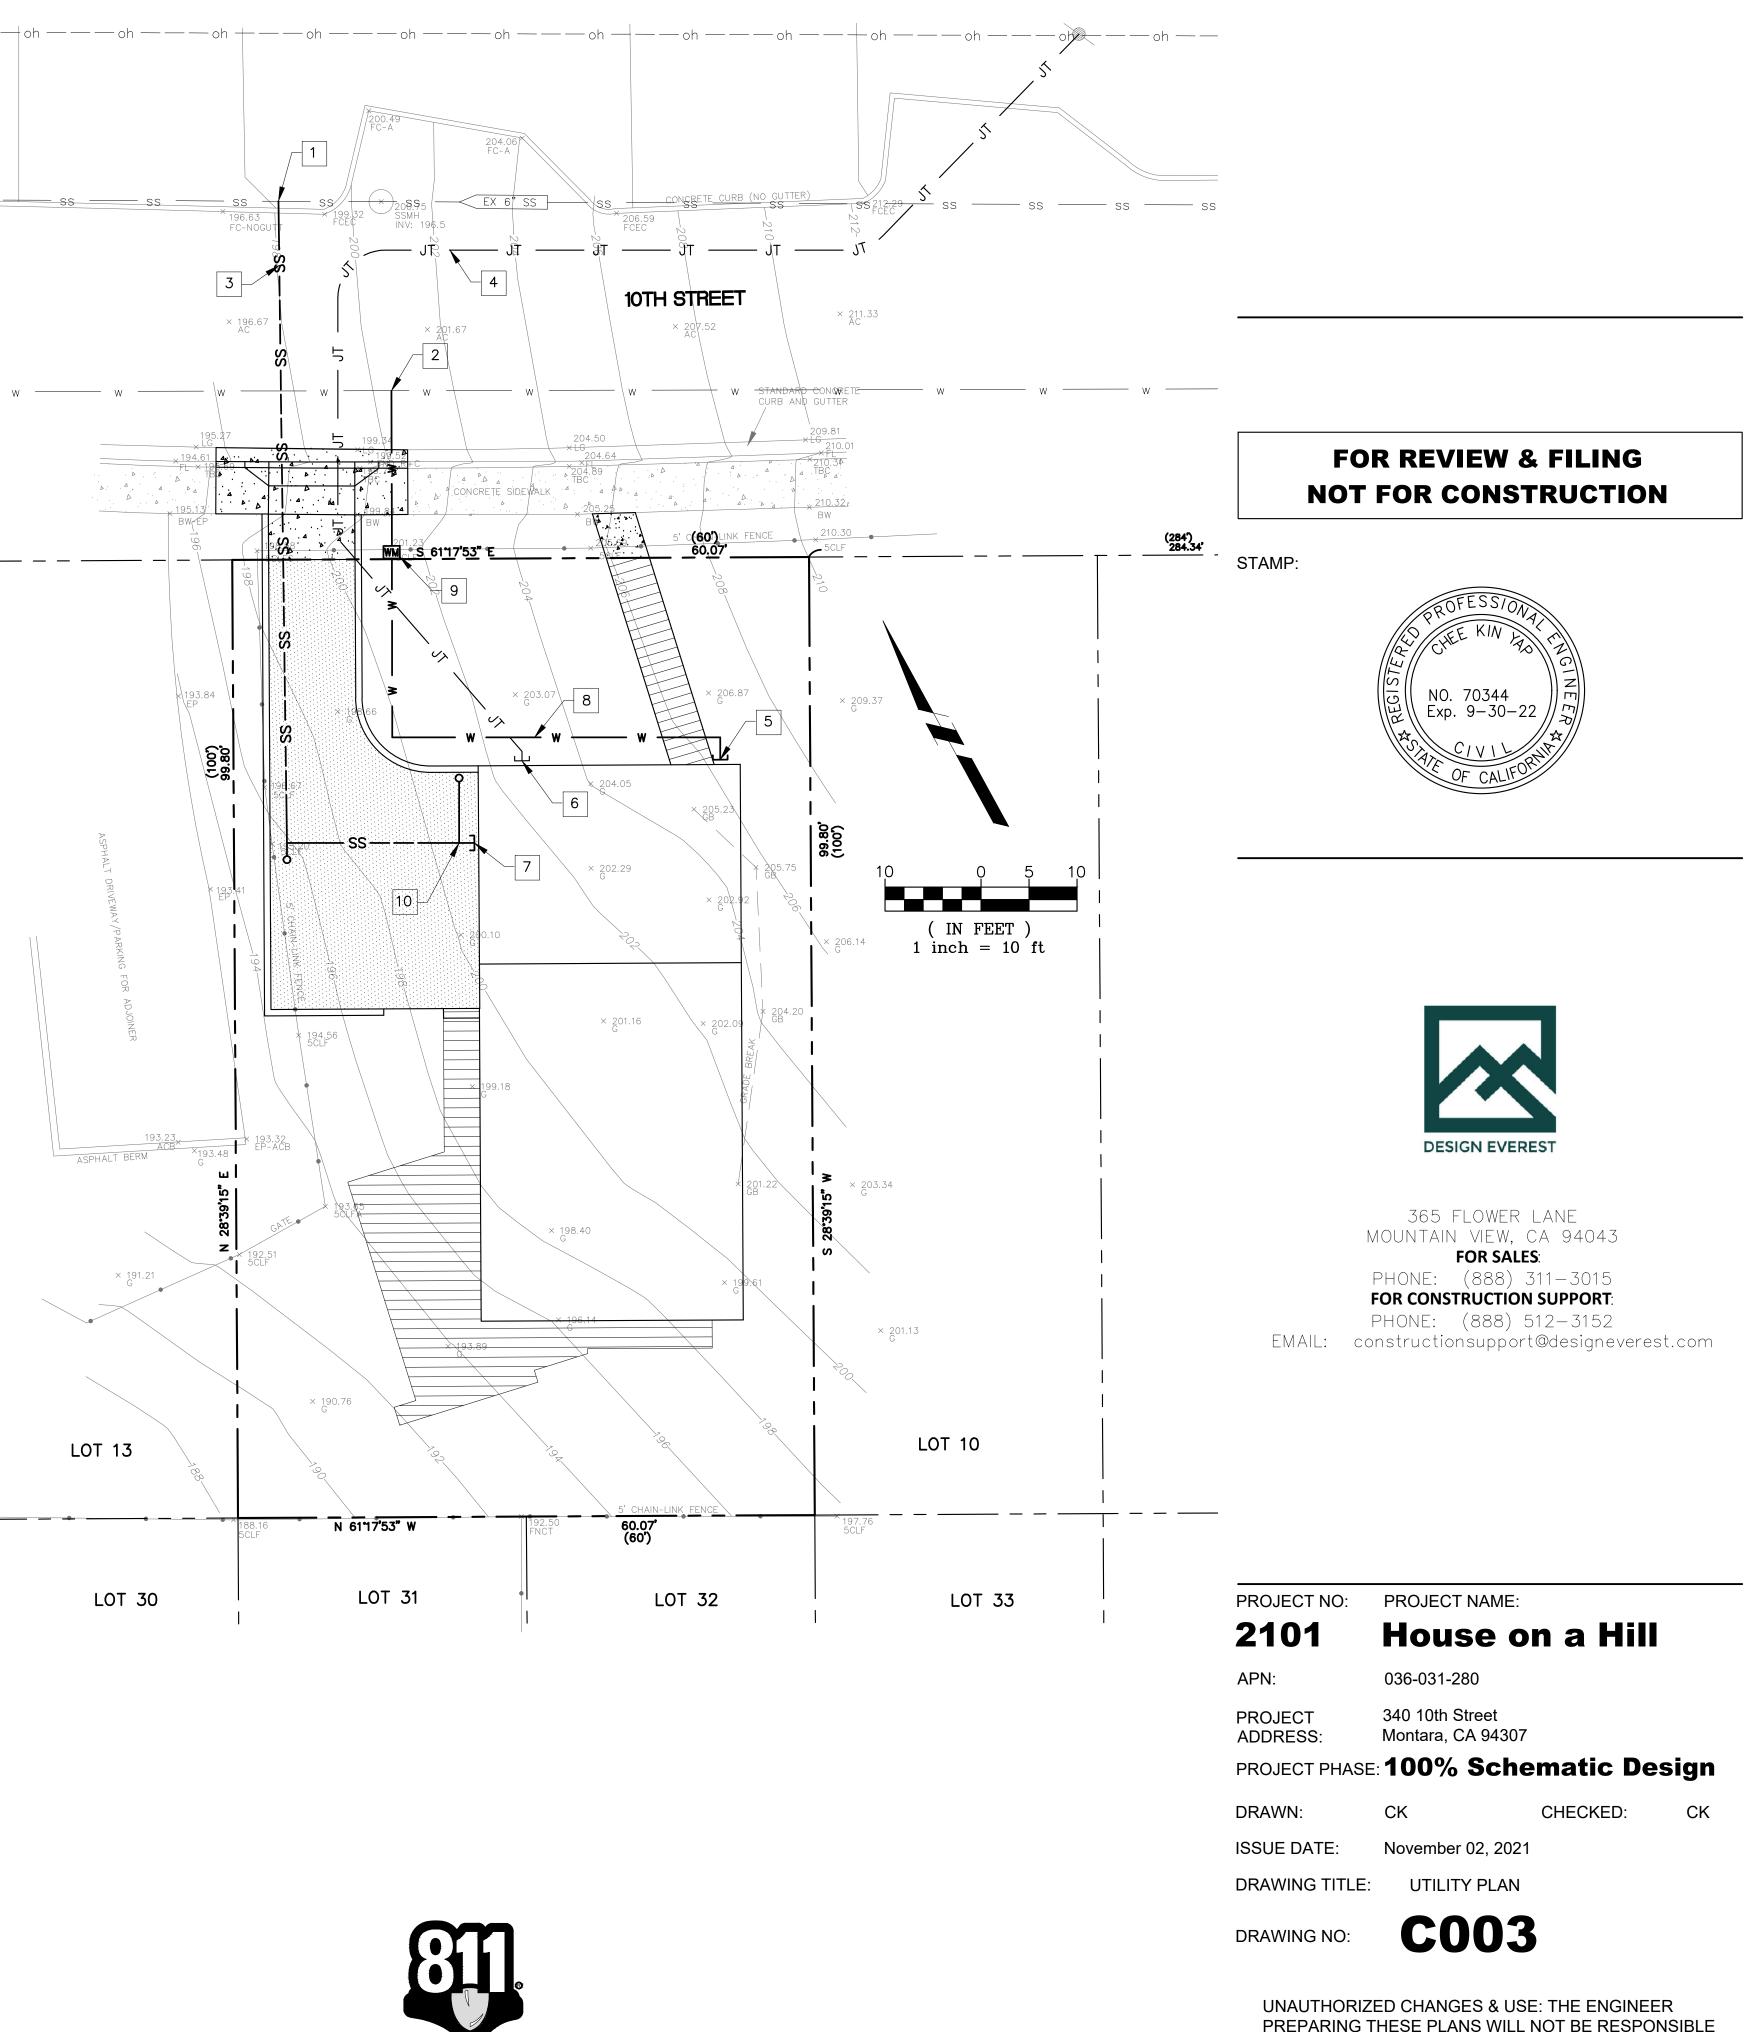





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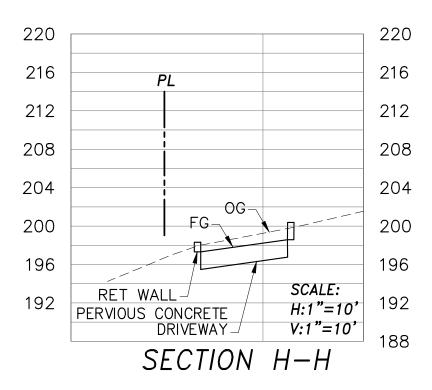


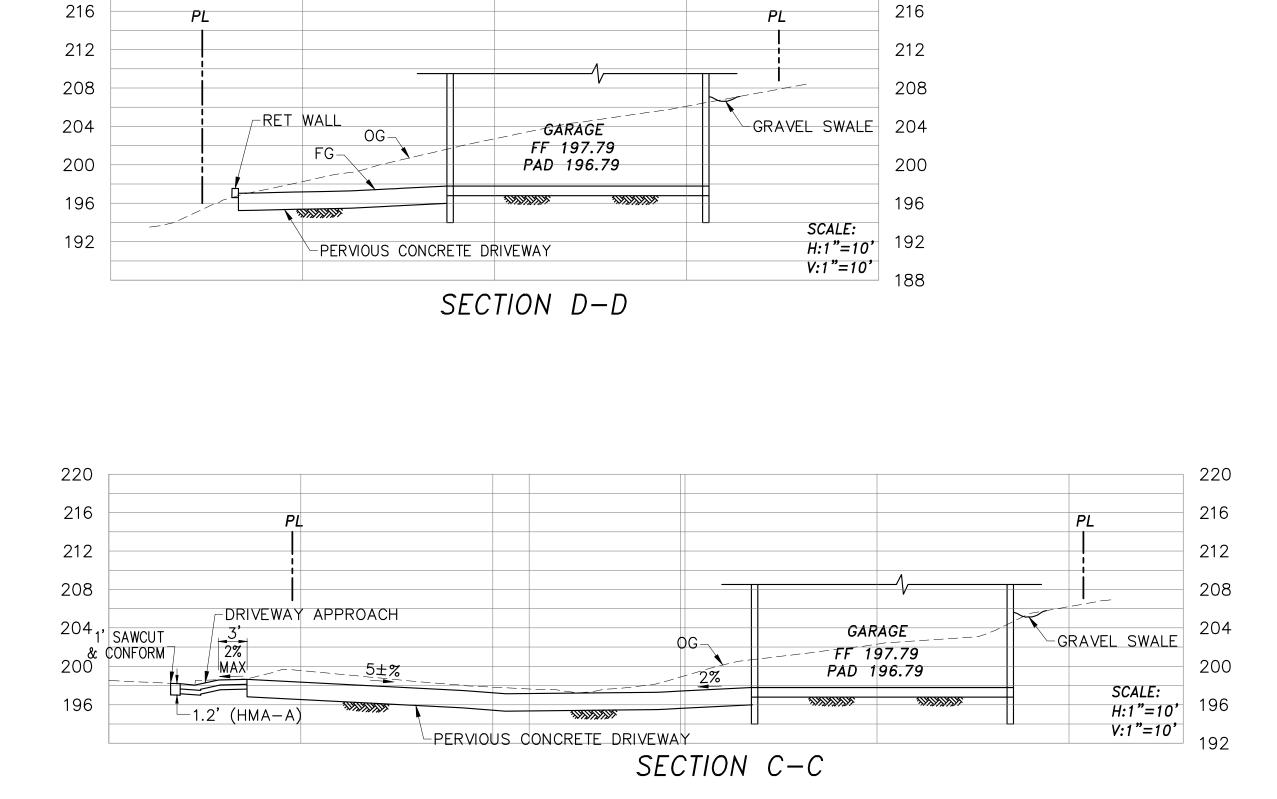
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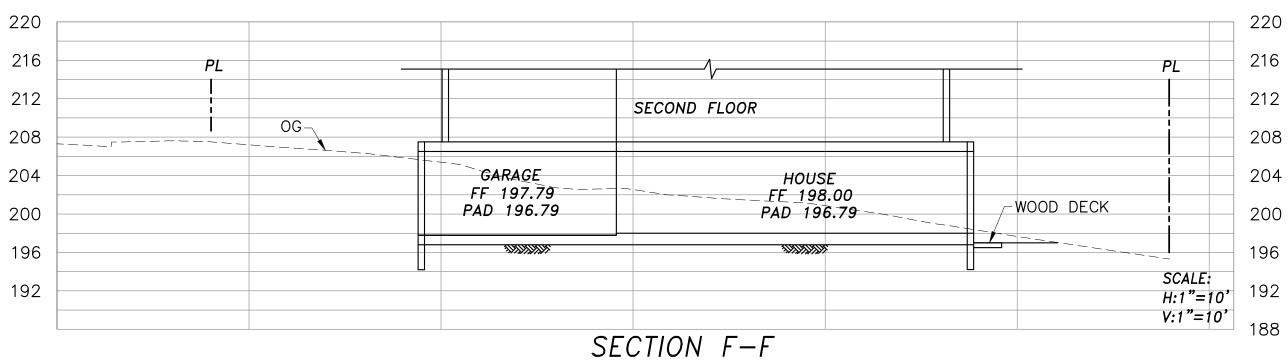
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SCALE: H:1"=10'	188
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Know what's below.

PROJECT NO:	PROJECT NAME:		
2101	House o	n a Hill	
APN:	036-031-280		
PROJECT ADDRESS:	340 10th Street Montara, CA 94307		
PROJECT PHASE	:100% Sche	ematic De	sign
DRAWN:	СК	CHECKED:	СК
ISSUE DATE:	November 02, 2021	I	
DRAWING TITLE:	CROSS SECTIO	NS	
DRAWING NO:	<b>C004</b>		

UNAUTHORIZED CHANGES & USE: THE ENGINEER PREPARING THESE PLANS WILL NOT BE RESPONSIBLE FOR, OR LIABLE FOR, UNAUTHORIZED CHANGES TO OR USES OF THESE PLANS. ALL CHANGES TO THE PLANS MUST BE IN WRITING AND MUST BE APPROVED BY THE PREPARER OF THESE PLANS.

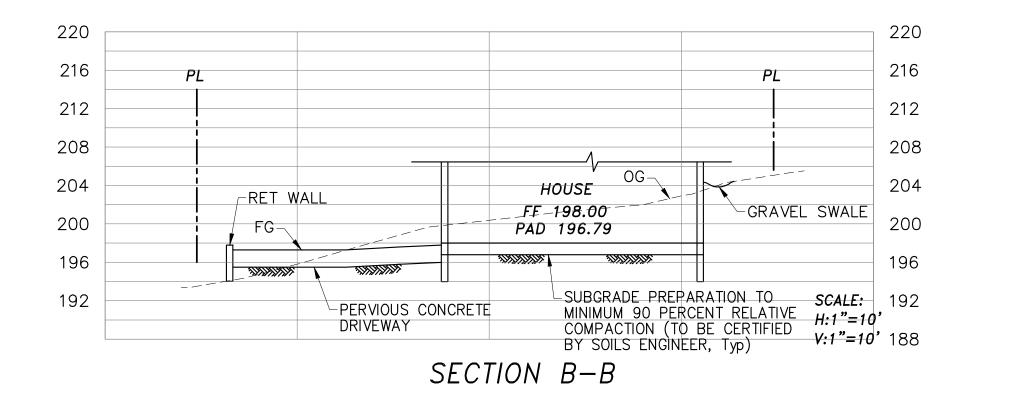

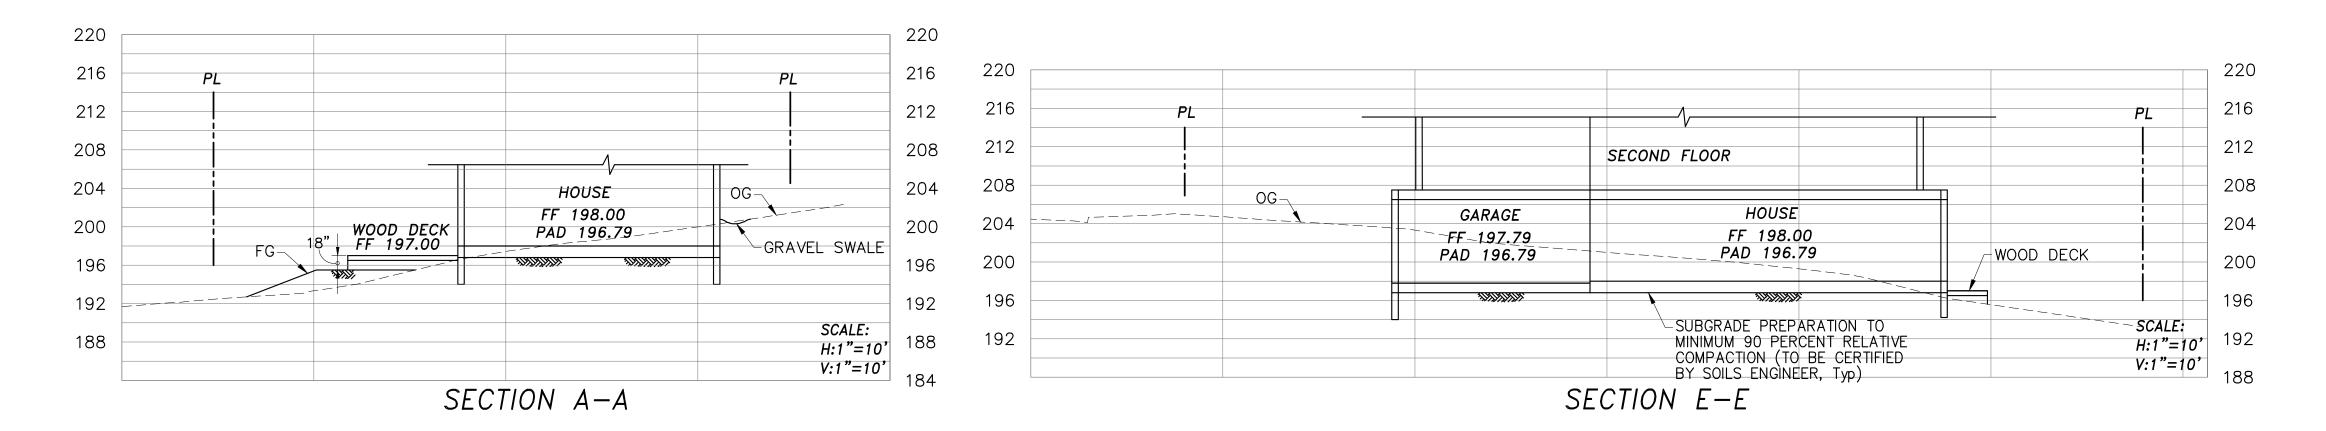
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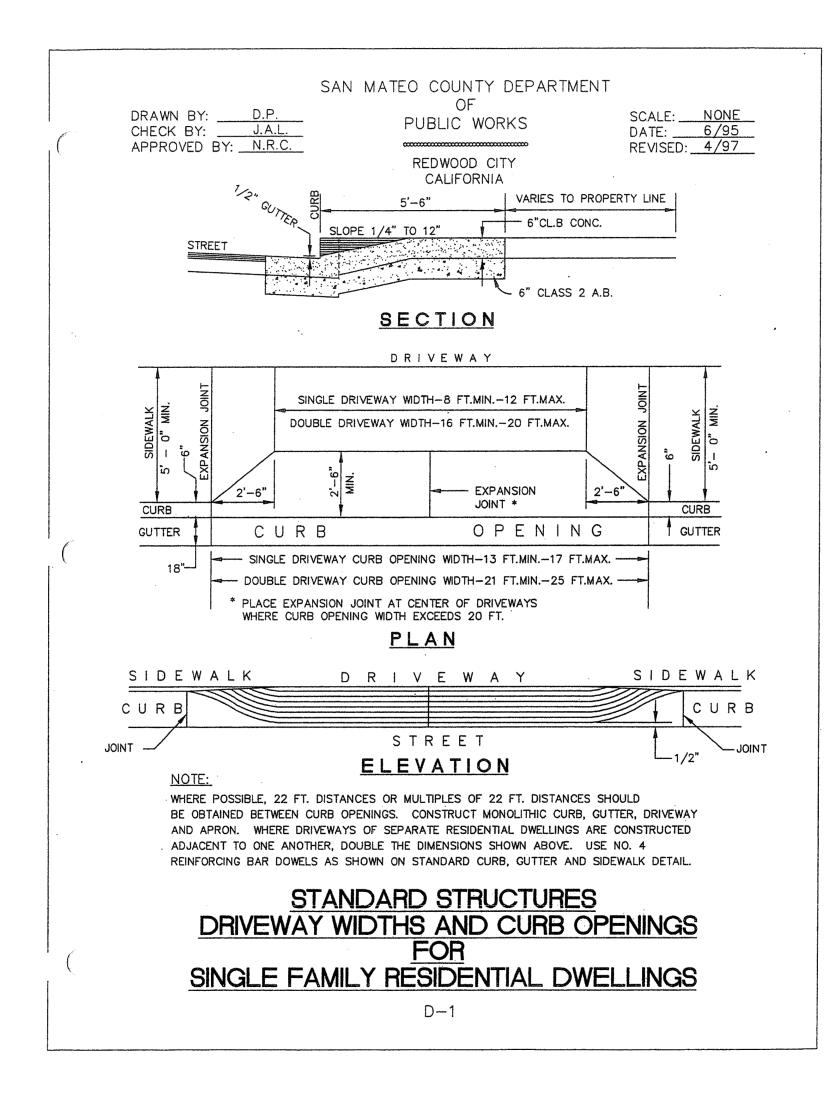
### **FOR REVIEW & FILING NOT FOR CONSTRUCTION**

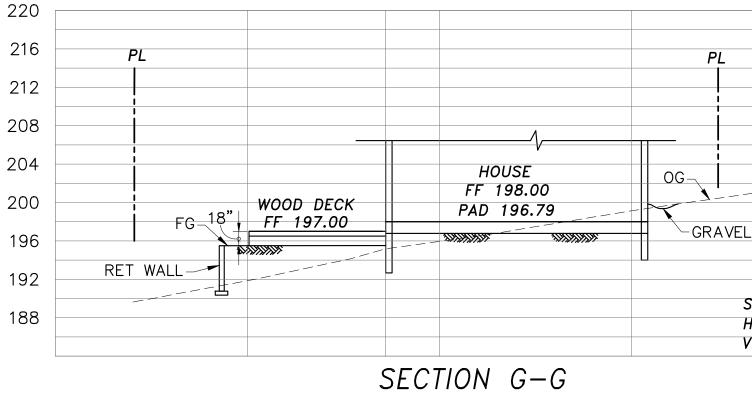


**REVISION**:

PROJECT NO:	PROJECT NAME:		
2101	House o	n a Hill	
APN:	036-031-280		
PROJECT ADDRESS:	340 10th Street Montara, CA 94307		
PROJECT PHASE	:100% Sche	ematic Des	ign
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ISSUE DATE:	November 02, 2021		
DRAWING TITLE:	CONSTRUCTION	I DETAILS	

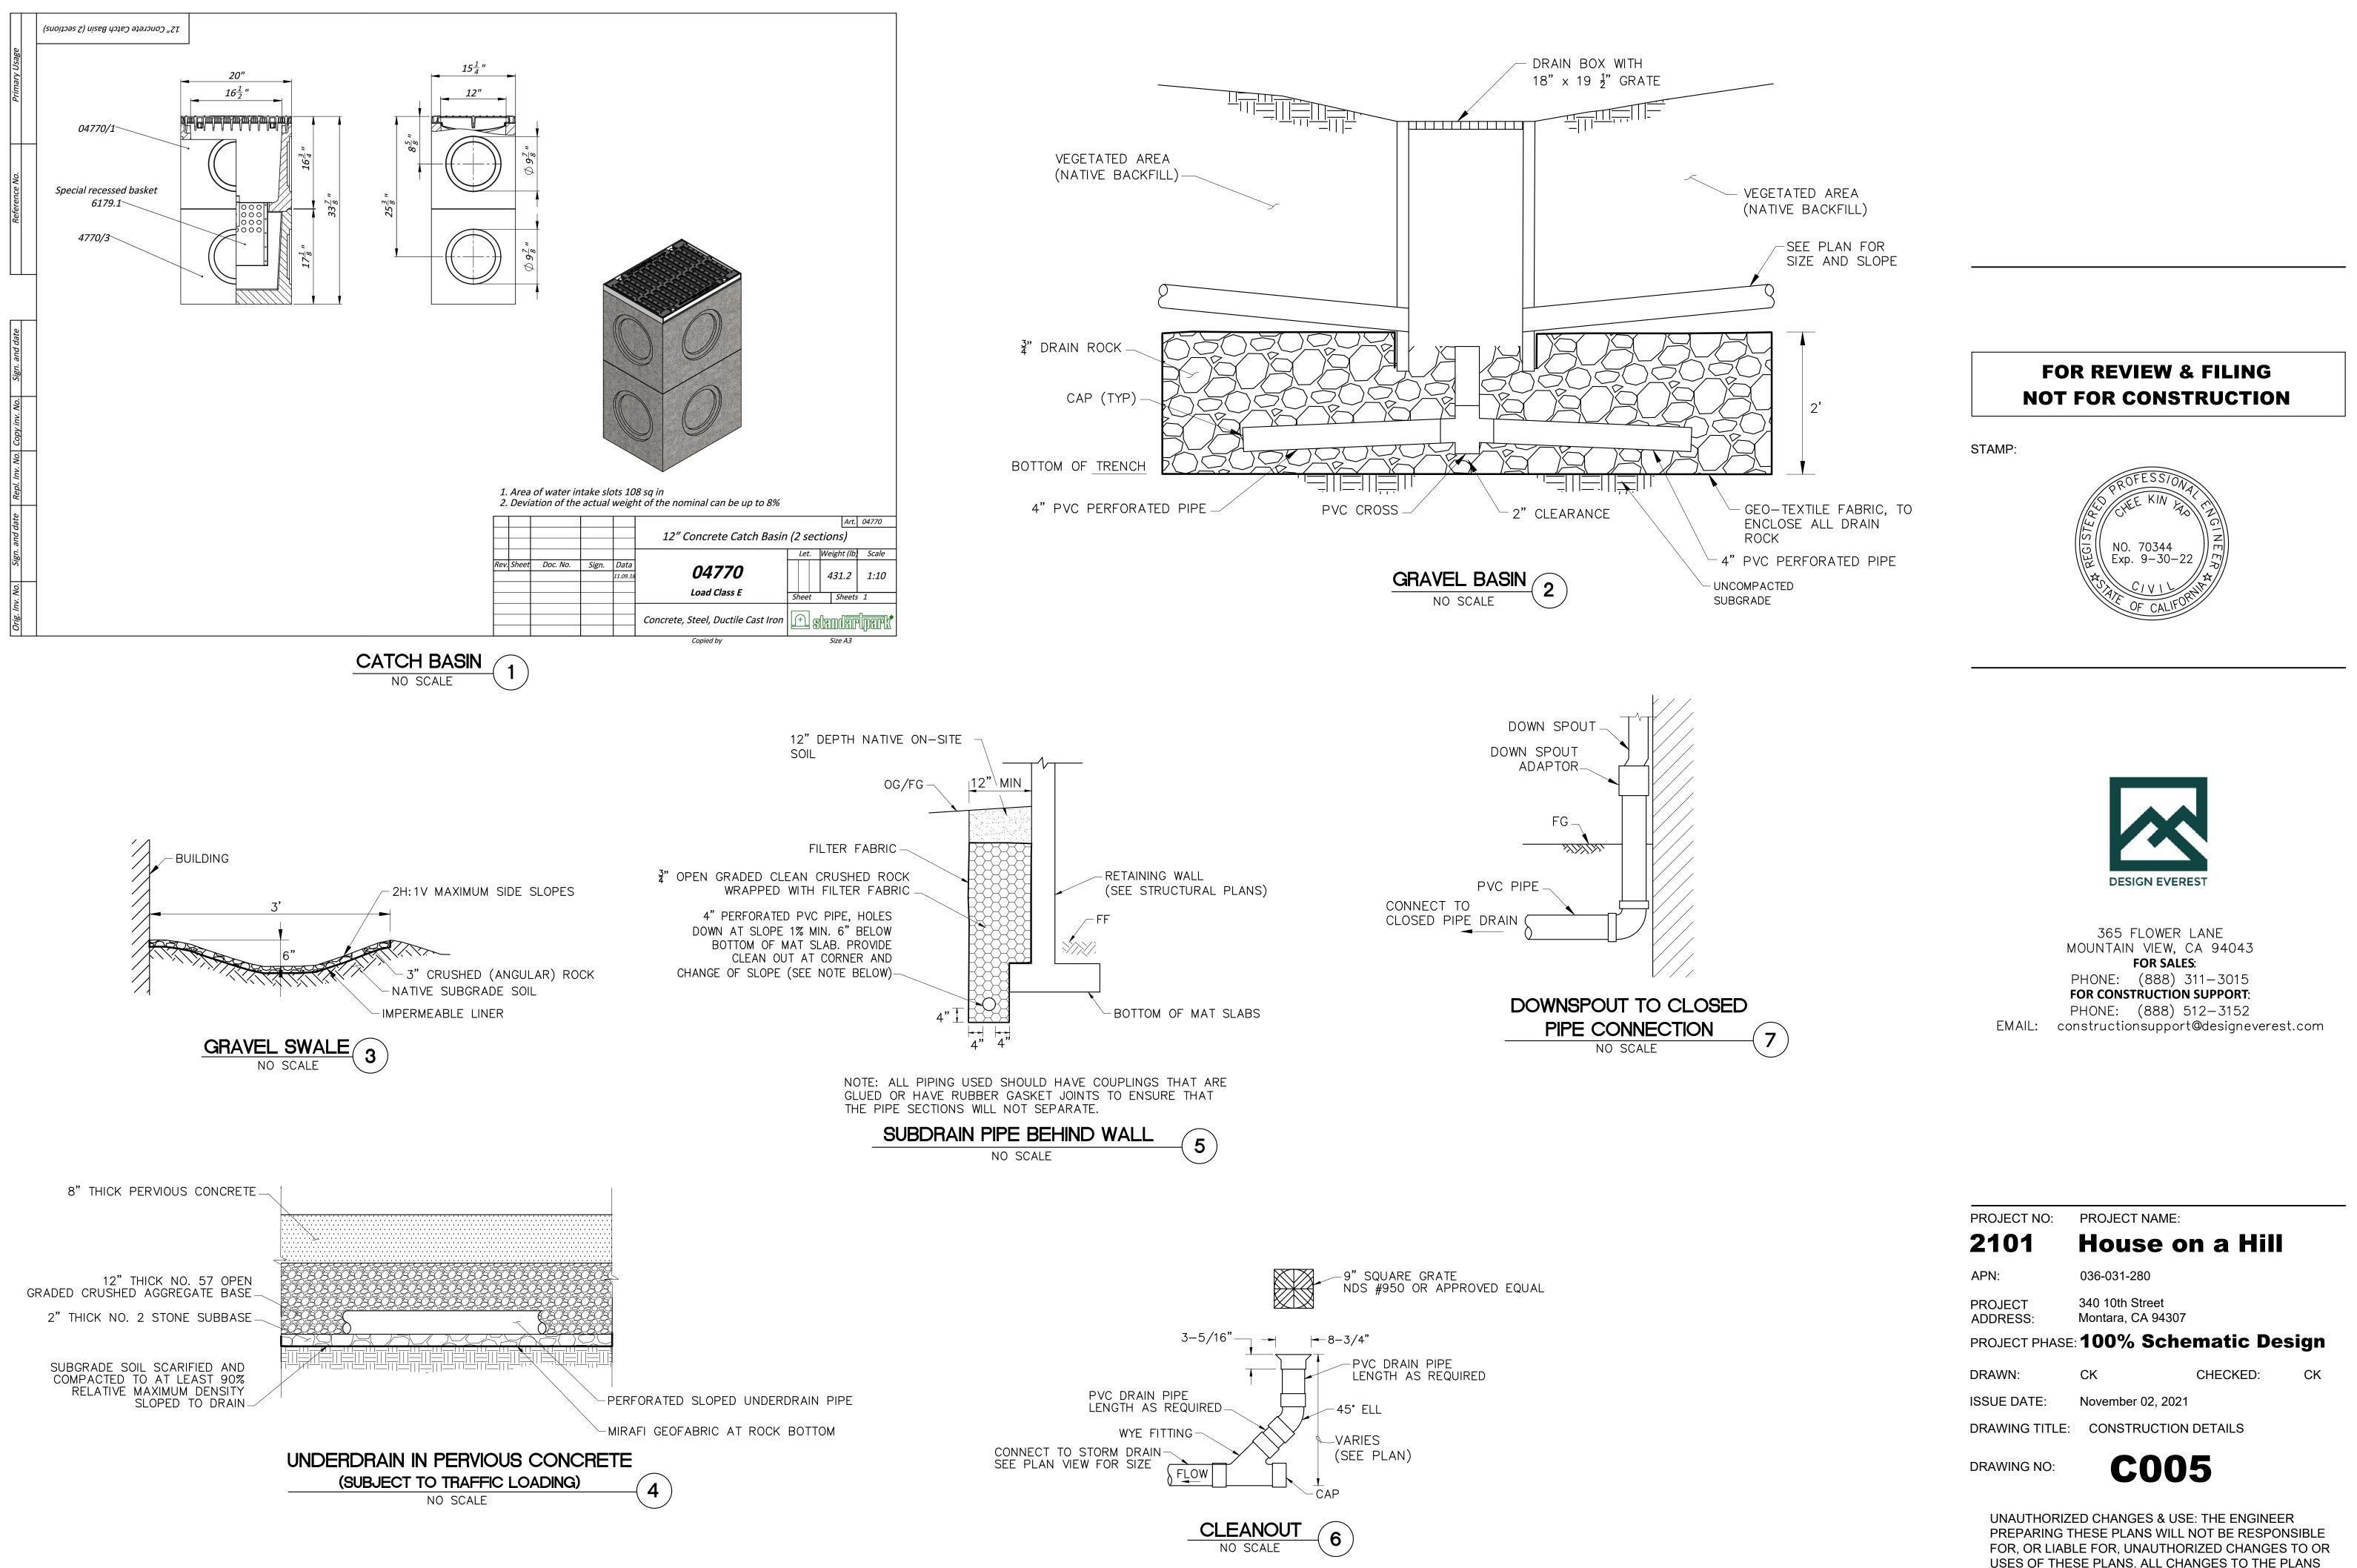
USES OF THESE PLANS. ALL CHANGES TO THE PLANS MUST BE IN WRITING AND MUST BE APPROVED BY THE PREPARER OF THESE PLANS.




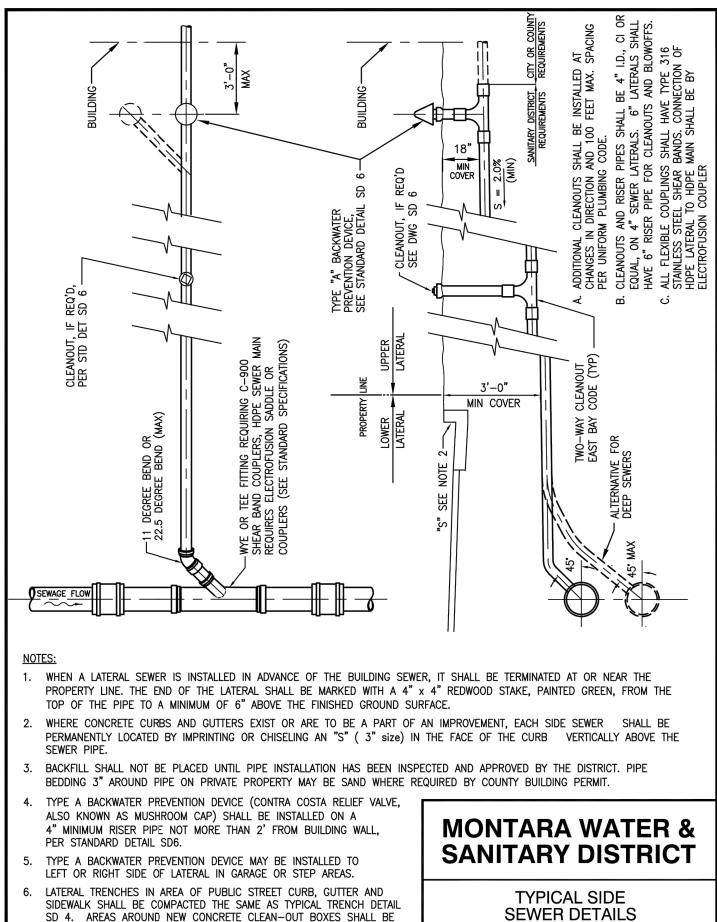

SOILS TESTED TO 90% COMPACTED. CONTRACTOR IS TO USE WHATEVER MEANS NECESSARY TO ACHIEVE 90% COMPACTION. 2017


SD 5

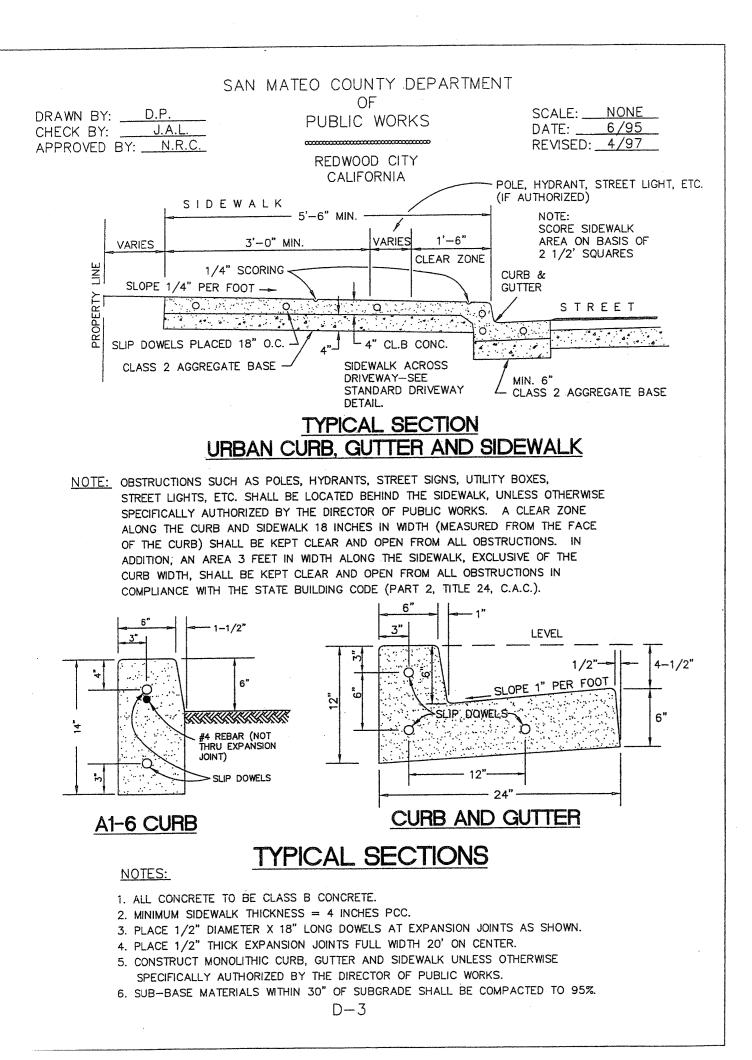

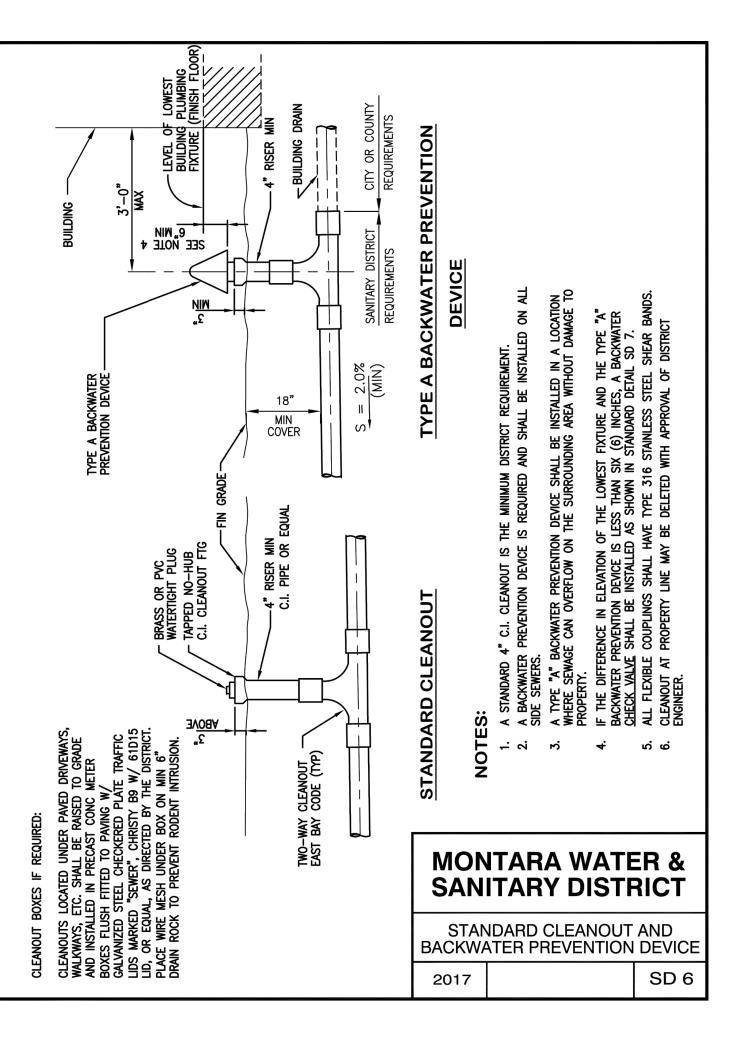

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# **FOR REVIEW & FILING NOT FOR CONSTRUCTION**

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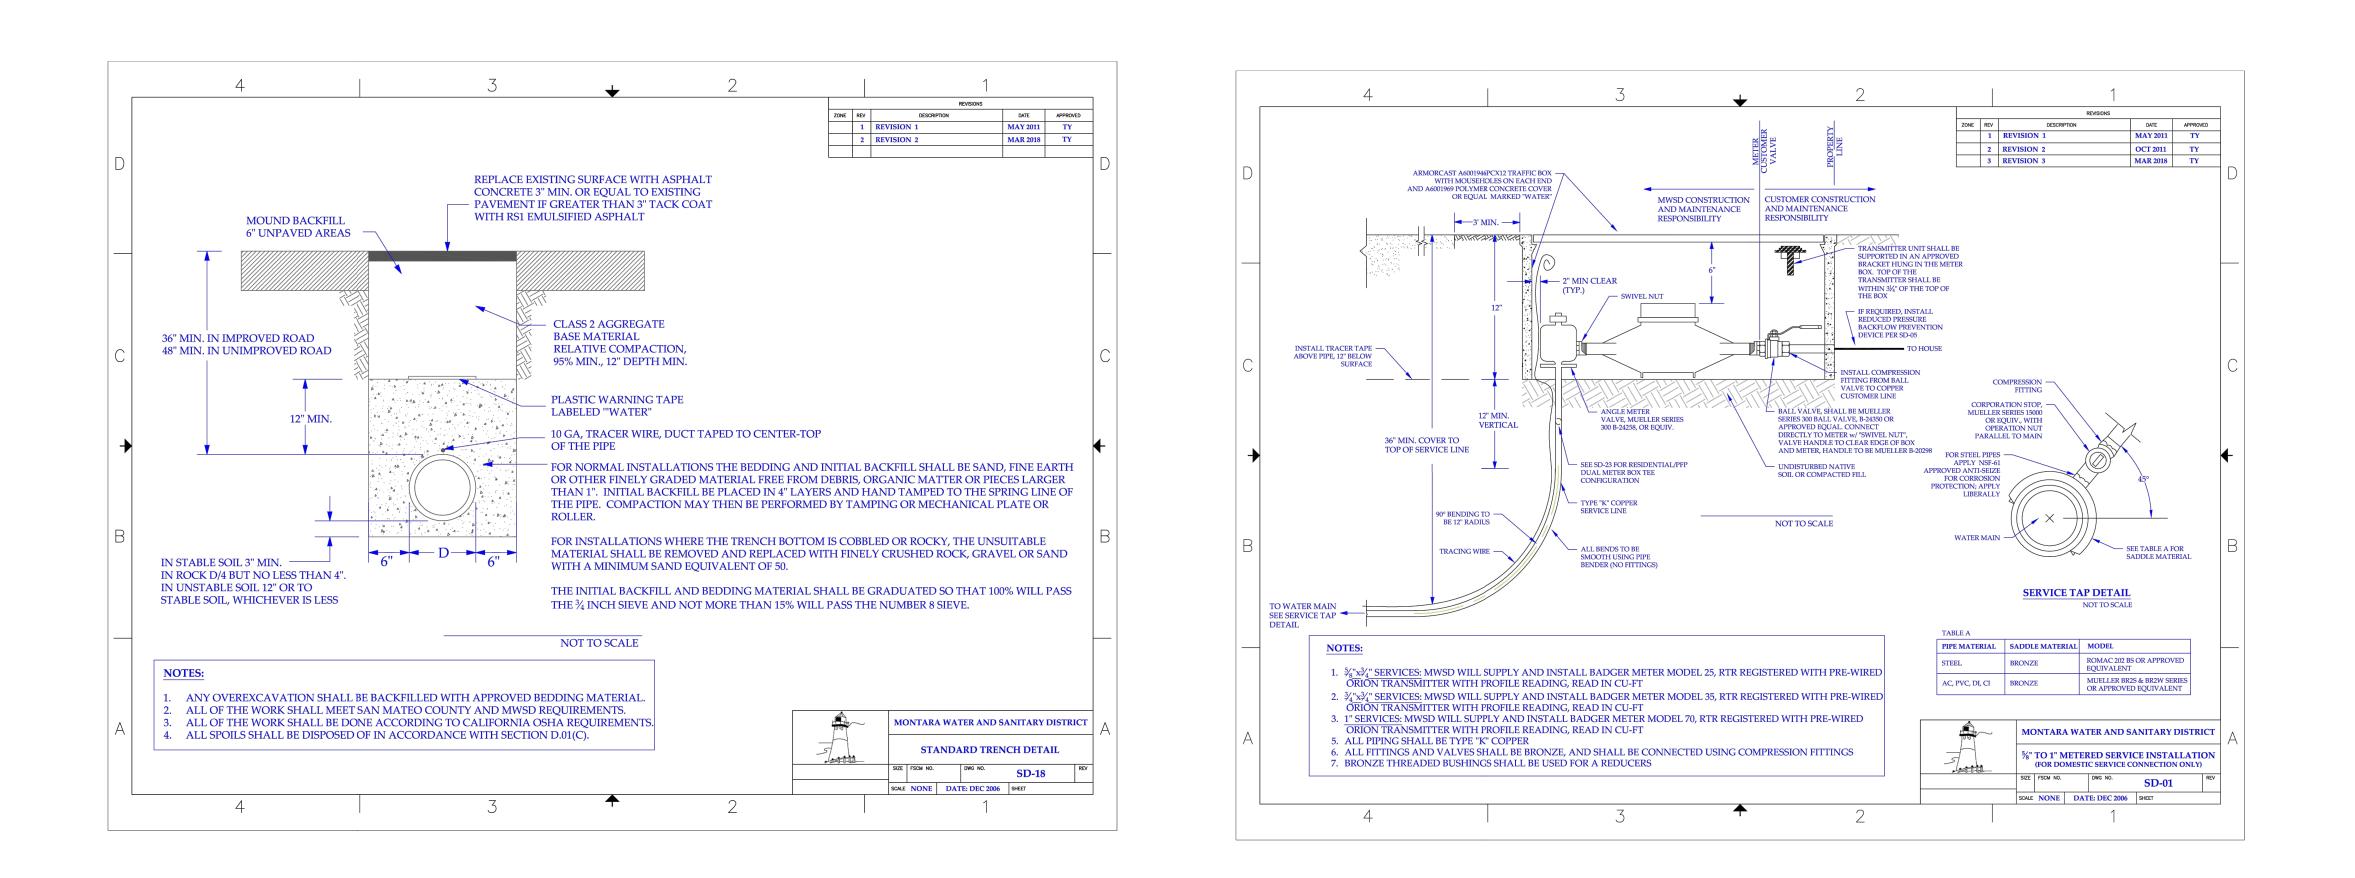


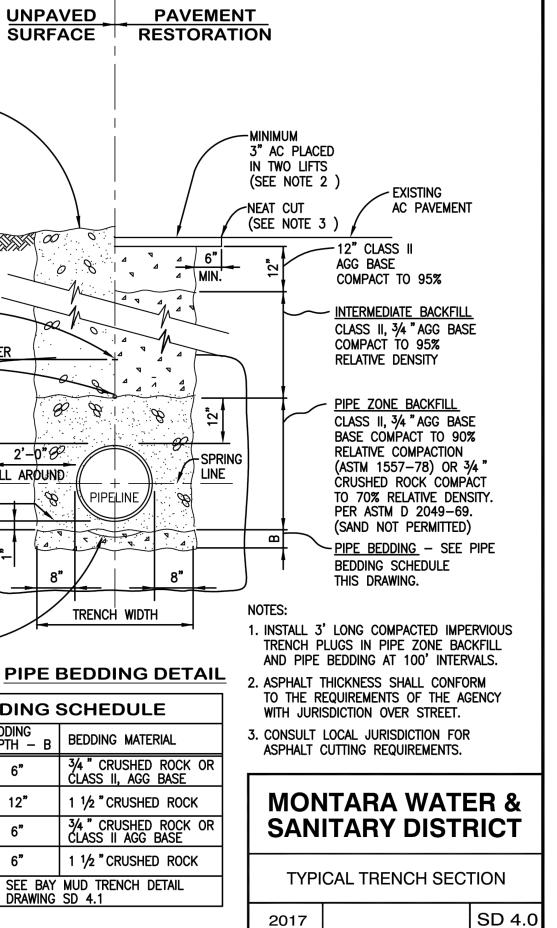
365 FLOWER LANE MOUNTAIN VIEW, CA 94043 FOR SALES: PHONE: (888) 311-3015 FOR CONSTRUCTION SUPPORT: PHONE: (888) 512-3152 EMAIL: constructionsupport@designeverest.com

PROJECT NO:	PROJECT NAME:		
2101	House o	n a Hill	
APN:	036-031-280		
PROJECT ADDRESS:	340 10th Street Montara, CA 94307		
PROJECT PHAS	⊧:100% Sche	ematic De	sign
DRAWN:	СК	CHECKED:	СК
ISSUE DATE:	November 02, 202 <sup>2</sup>	1	
DRAWING TITLE	: CONSTRUCTION	I DETAILS	

DRAWING NO:





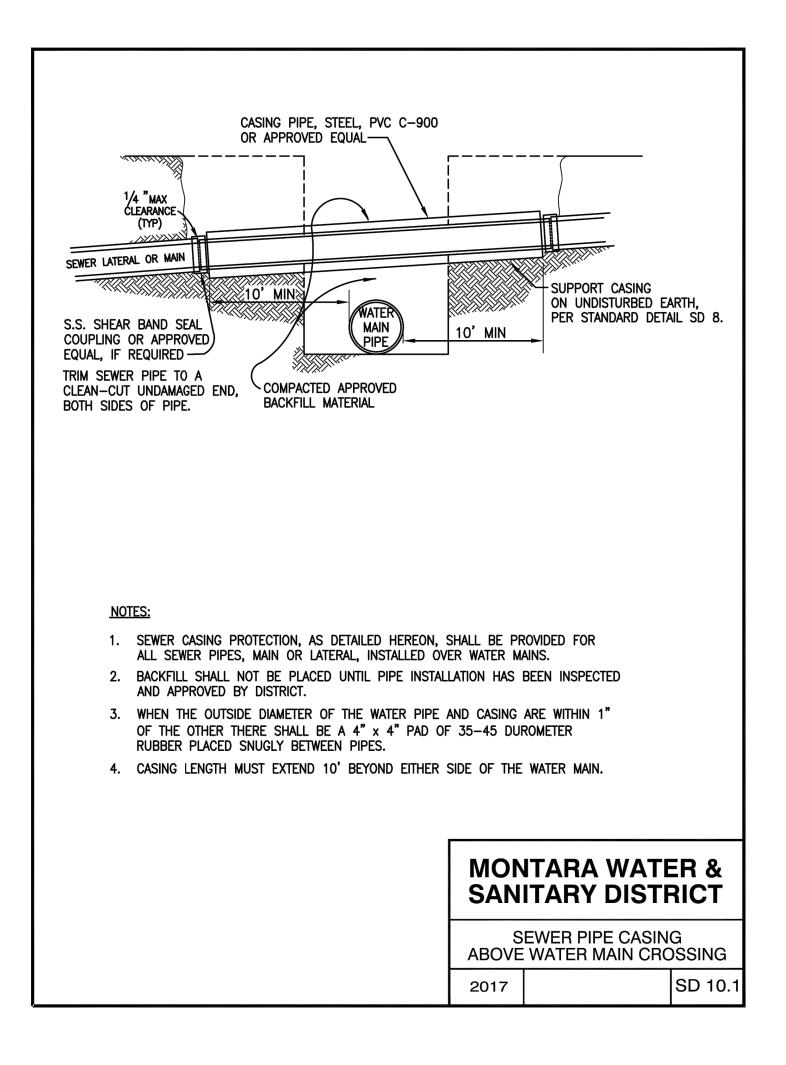

NO. 70344

STAMP:



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2101	House o	n a Hill	
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DRAWING TITLE:	CONSTRUCTION	I DETAILS	
DRAWING NO:	<b>C00</b>	7	

#### **EROSION CONTROL NOTES:**

- A. ALL GRADING, EROSION AND SEDIMENT CONTROL AND RELATED WORK UNDERTAKEN ON THIS SITE IS SUBJECT TO ALL TERMS AND CONDITIONS OF THE CITY GRADING ORDINANCE AND MADE A PART HEREOF BY REFERENCE.
- B. THE CONTRACTOR WILL BE LIABLE FOR ANY AND ALL DAMAGES TO ANY PUBLICLY OWNED AND MAINTAINED ROAD CAUSED BY THE AFORESAID CONTRACTOR'S GRADING ACTIVITIES, AND SHALL BE RESPONSIBLE FOR THE CLEANUP OF ANY MATERIAL SPILLED ON ANY PUBLIC ROAD ON THE HAUL ROUTE
- C. THE EROSION CONTROL MEASURES ARE TO BE OPERABLE DURING THE RAINY SEASON, OCTOBER FIRST TO APRIL FIFTEENTH. EROSION CONTROL PLANTING IS TO BE COMPLETED BY OCTOBER FIRST. NO GRADING OR UTILITY TRENCHING SHALL OCCUR BETWEEN OCTOBER FIRST AND APRIL FIFTEENTH UNLESS AUTHORIZED BY THE COUNTY ENGINEER.
- D. ALL EROSION CONTROL MEASURES SHALL BE MAINTAINED UNTIL DISTURBED AREAS ARE STABILIZED AND CHANGES TO THIS EROSION AND SEDIMENT CONTROL PLAN SHALL BE MADE TO MEET FIELD CONDITIONS ONLY WITH THE APPROVAL OF OR AT THE DIRECTION OF THE SOILS ENGINEER.
- E. ALL EROSION CONTROL FACILITIES MUST BE INSPECTED AND REPAIRED AT THE END OF EACH WORKING DAY DURING THE RAINY SEASON.
- F. A CONSTRUCTION ENTRANCE SHALL BE PROVIDED AT ANY POINT OF EGRESS FROM THE SITE TO ROADWAY. A CONSTRUCTION ENTRANCE SHOULD BE COMPOSED OF COARSE DRAIN ROCK (2" TO 3") MINIMUM DIAMETER AT LEAST EIGHT INCHES THICK BY FIFTY (50) FEET LONG BY TWENTY (20) FEET WIDE UNLESS SHOWN OTHERWISE ON PLAN AND SHALL BE MAINTAINED UNTIL THE SITE IS PAVED.
- G. WATER UTILIZED IN THE STABILIZATION MATERIAL SHALL BE OF SUCH QUALITY THAT IT WILL PROMOTE GERMINATION AND STIMULATE GROWTH OF PLANTS. IT SHALL BE FREE OF POLLUTANT MATERIALS AND WEED SEED.
- STABILIZATION MATERIALS SHALL BE APPLIED AS SOON AS PRACTICABLE AFTER COMPLETION OF GRADING OPERATIONS AND PRIOR TO THE ONSET OF WINTER RAINS, OR AT SUCH OTHER TIME AS DIRECTED BY THE CITY ENGINEER. THE MATERIAL SHALL BE APPLIED BEFORE INSTALLATION OF OTHER LANDSCAPING MATERIALS SUCH AS TREES, SHRUBS AND GROUND COVERS.
- THE STABILIZATION MATERIAL SHALL BE APPLIED WITHIN 4-HOURS AFTER MIXING. MIXED MATERIAL NOT USED WITHIN 4-HOURS SHALL BE REMOVED FROM THE SITE.
- J. THE CONTRACTOR SHALL MAINTAIN THE SOIL STABILIZATION MATERIAL AFTER PLACEMENT. THE CITY ENGINEER MAY REQUIRE SPRAY APPLICATION OF WATER OF OTHER MAINTENANCE ACTIVITIES TO ASSURE THE EFFECTIVENESS OF THE STABILIZATION PROCESS. APPLICATION OF WATER SHALL BE ACCOMPLISHED USING NOZZLES THAT PRODUCE A SPRAY THAT DOES NOT CONCENTRATE OR WASH AWAY THE STABILIZATION MATERIALS.
- K. THE FACILITIES SHOWN ON THIS PLAN ARE DESIGNED TO CONTROL EROSION AND SEDIMENT DURING THE RAINY SEASON. GRADING OPERATIONS DURING RAINY SEASON, WHICH LEAVE DENUDED SLOPES SHALL BE PROTECTED WITH EROSION CONTROL MEASURES IMMEDIATELY FOLLOWING GRADING OF THE SLOPES.
- CONSTRUCTION ENTRANCES SHALL BE INSTALLED PRIOR TOO COMMENCEMENT OF GRADING. ALL CONSTRUCTION TRAFFIC ENTERING ONTO THE PAVED ROADS MUST CROSS THE STABILIZED CONSTRUCTION ENTRANCEWAYS
- M. CONTRACTOR SHALL MAINTAIN STABILIZED ENTRANCE AT EACH VEHICLE ACCESS POINT TO EXISTING PAVED STREETS. ANY MUD OR DEBRIS TRACKED ONTO PUBLIC STREETS SHALL BE REMOVED DAILY AND AS REQUIRED BY THE COUNTY.
- N. WHEN NECESSARY, WHEELS SHALL BE CLEANED TO REMOVE SEDIMENT PRIOR TO ENTRANCE ONTO PUBLIC RIGHT-OF-WAY. WHEN WASHING IS REQUIRED, IT SHALL BE DONE ON AN AREA STABILIZED WITH CRUSHED STONE WHICH DRAINS INTO AN APPROVED SEDIMENT TRAP OR SEDIMENT BASIN. ALL SEDIMENT SHALL BE PREVENTED FROM ENTERING ANY STORM DRAIN, DITCH OR WATERCOURSE THROUGH USE OF SAND BAGS, GRAVEL, BOARDS, OR OTHER APPROVED METHODS.
- O. STRAW MULCH OR FIBER MATTE SHALL BE SUFFICIENTLY AVAILABLE ON-SITE DURING THE GRADING PERIOD READY TO BE INSTALLED ON FRESH SLOPES THAT MAY BE ERODED DURING STORMY WEATHER.
- P. INLET PROTECTION SHALL BE INSTALLED AT OPEN INLETS TO PREVENT SEDIMENT FROM ENTERING THE STORM DRAIN SYSTEM. INLETS NOT USED IN CONJUNCTION WITH EROSION CONTROL ARE TO BE BLOCKED TO PREVENT ENTRY OF SEDIMENT.
- Q. THIS EROSION AND SEDIMENT CONTROL PLAN MAY NOT COVER ALL THE SITUATIONS THAT MAY ARISE DURING CONSTRUCTION DUE TO UNANTICIPATED FIELD CONDITIONS. VARIATIONS AND ADDITIONS MAY BE MADE TO THIS PLAN IN THE FIELD. NOTIFY THE COUNTY REPRESENTATIVE OF ANY FIELD CHANGES.
- R. CLEANOUT THE CONCRETE DITCH AT COMPLETION OF THE PROJECT.
- SITE CLEARING AND EARTH-MOVING ACTIVITIES ARE ONLY ALLOWED DURING DRY WEATHER. EROSION AND SEDIMENTS CONTROL PRACTICES SHALL BE INSTALLED AND IMPLEMENTED PRIOR TO EARTH-MOVING ACTIVITIES AND CONSTRUCTION.

#### MAINTENANCE NOTES:


- 1. REPAIR DAMAGES CAUSED BY SOIL EROSION OR CONSTRUCTION AT THE END OF EACH WORKING DAY.
- 2. SWALES SHALL BE INSPECTED PERIODICALLY AND MAINTAINED AS NEEDED.
- 3. SEDIMENT TRAPS, BERMS, AND SWALES ARE TO BE INSPECTED AFTER EACH STORM AND REPAIRS MADE AS NEEDED. 4. SEDIMENT SHALL BE REMOVED AND SEDIMENT TRAPS RESTORED TO ITS ORIGINAL DIMENSIONS WHEN SEDIMENT HAS ACCUMULATED TO A DEPTH OF ONE FOOT.
- 5. SEDIMENT REMOVED FROM TRAP SHALL BE DEPOSITED IN A SUITABLE AREA AND IN SUCH A MANNER THAT IT WILL NOT ERODE.
- 6. RILLS AND GULLIES MUST BE REPAIRED.

#### NON-STORM WATER MANAGEMENT

- 1. CONTRACTOR SHALL IMPLEMENT MEASURES TO CONTROL ALL NON-STORM WATER DISCHARGES DURING CONSTRUCTION.
- 2.CONTRACTOR SHALL WASH VEHICLES IN SUCH A MANNER AS TO PREVENT NON-STORM WATER
- DISCHARGES TO SURFACE WATERS OR MS4 DRAINAGE SYSTEM.
- 3. CONTRACTOR SHALL CLEAN STREETS IN SUCH A MANNER AS TO PREVENT UNAUTHORIZED NON-STORM WATER DISCHARGES FROM REACHING SURFACE WATER OR MS4 DRAINAGE SYSTEMS.

#### DUST CONTROL


- 1. THE CONSTRUCTION ACTIVITIES WILL GENERATE DUST AND PARTICULATE MATTER. PRIOR TO THE ISSUANCE OF A GRADING PERMIT, A DUST MITIGATION PLAN SHALL BE SUBMITTED TO THE CITY FOR REVIEW AND APPROVAL. THE PLAN SHALL SPECIFY THE METHODS OF CONTROL THAT WILL BE UTILIZED, DEMONSTRATE THE AVAILABILITY OF NEEDED EQUIPMENT AND PERSONNEL, AND IDENTIFY A RESPONSIBLE INDIVIDUAL WHO CAN AUTHORIZE THE IMPLEMENTATION OF ADDITIONAL MEASURES, IF NEEDED. THE CONSTRUCTION DUST MITIGATION PLAN SHALL, AT MINIMUM, INCLUDE THE FOLLOWING:
- A. THE PROVISION OF EQUIPMENT AND STAFFING FOR WATERING OF ALL EXPOSED OR DISTURBED SOIL SURFACES AT LEAST TWICE DAILY, INCLUDING WEEKENDS AND HOLIDAYS. AN APPROPRIATE DUST PALLIATIVE OR SUPPRESSANT ADDED TO WATER BEFORE THE APPLICATION SHOULD BE UTILIZED.
- B.WATERING OR COVERING OF STOCKPILES OF DEBRIS, SOIL, SAND OR OTHER MATERIALS THAT CAN BE BLOWN BY THE WIND.
- C.THE REGULAR SWEEPING OF CONSTRUCTION AREAS AND ADJACENT STREETS OF ALL MUD AND DEBRIS, SINCE THIS MATERIAL CAN BE PULVERIZED AND LATER RE-SUSPENDED BY VEHICLE TRAFFIC.
- D.THE ENFORCEMENT OF A SPEED LIMIT OF 15 MILES PER HOUR FOR ALL CONSTRUCTION VEHICLES WHEN OFF-PAVEMENT.
- E.ALL MATERIALS TRANSPORTED BY TRUCK WILL BE COVERED OR WETTED DOWN.
- F.ALL INACTIVE PORTIONS OF THE SITE WILL BE WATERED WITH AN APPROPRIATE DUST SUPPRESSANT, COVERED OR SEEDED.
- G.SUSPENSION OF EARTHMOVING OR OTHER DUST-PRODUCING ACTIVITIES DURING PERIODS OF HIGH WINDS WHEN DUST CONTROL MEASURES ARE UNABLE TO AVOID VISIBLE DUST PLUMES.
- 2. COUNTY INSPECTOR MAY ADD/MODIFY EROSION CONTROL MEASURES AS REQUIRED.

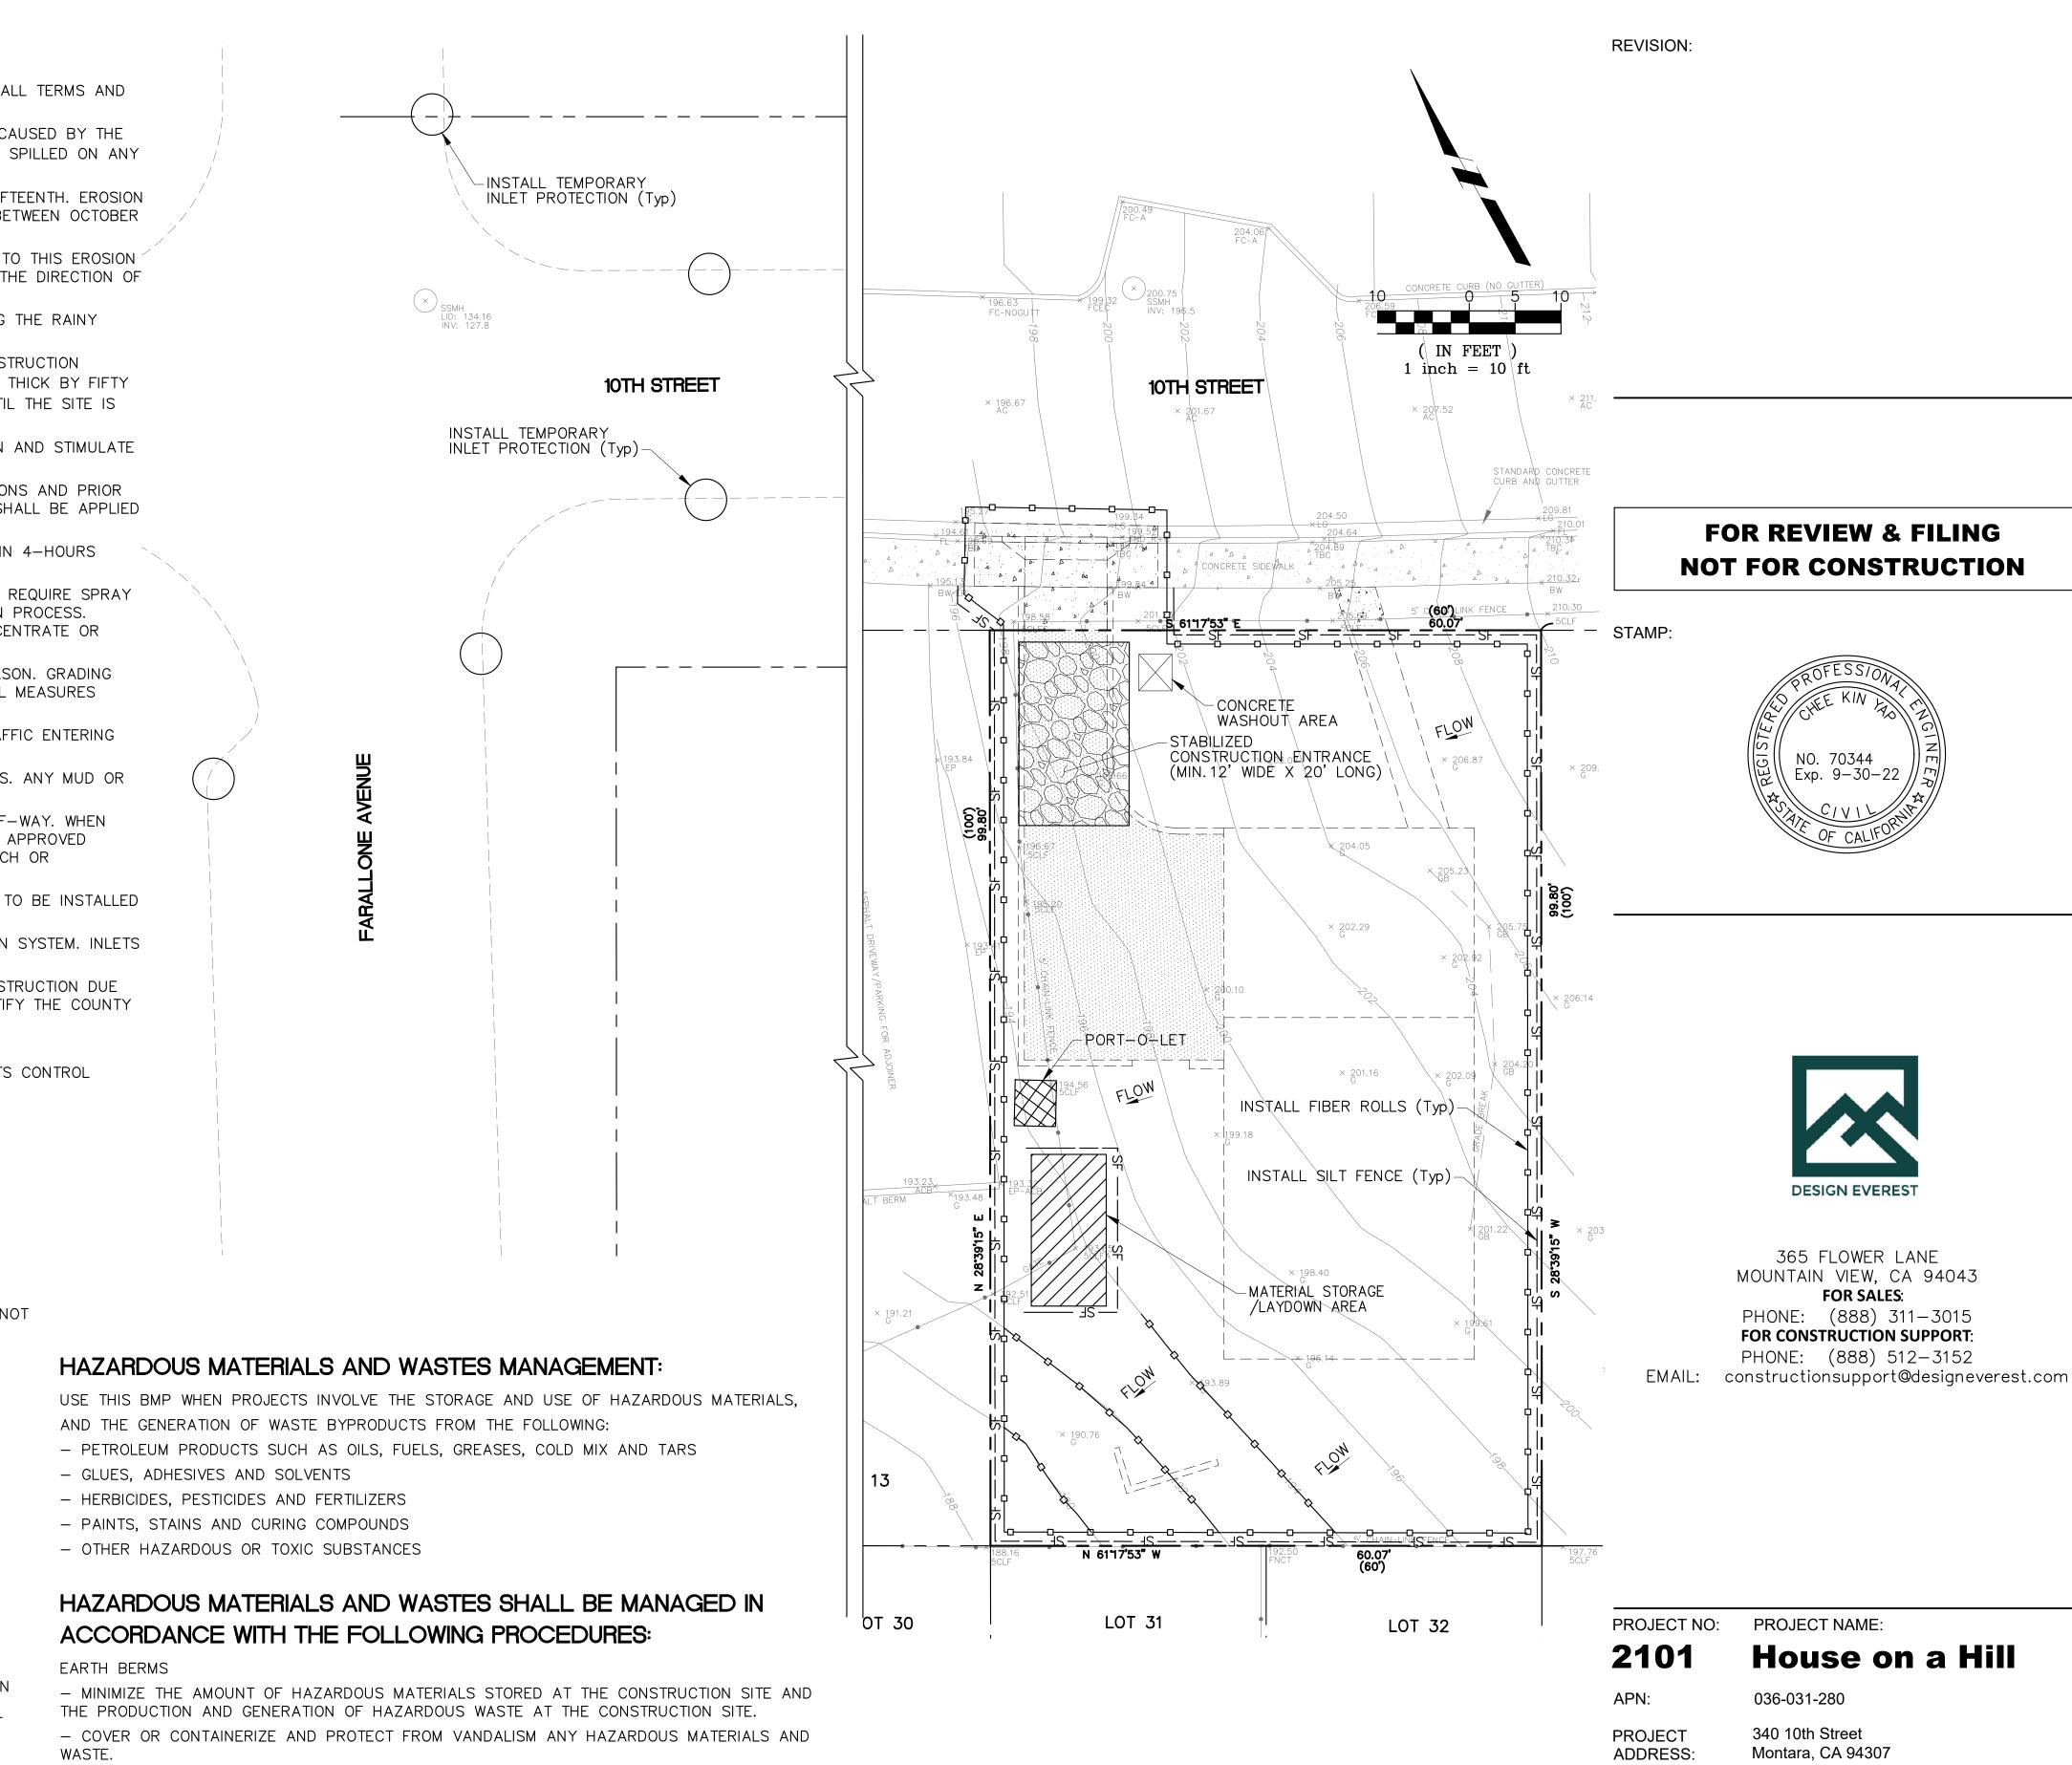

- CLEARLY MARK ALL HAZARDOUS MATERIALS AND WASTE. PLACE HAZARDOUS WASTE CONTAINERS IN SECONDARY CONTAINMENT SYSTEMS IF STORED AT THE CONSTRUCTION SITE. - STOCKPILED COLD MIX SHOULD BE PLACED ON AND COVERED WITH PLASTIC.
- -DO NOT MIX WASTE MATERIALS, BECAUSE THIS COMPLICATES OR INHIBITS DISPOSAL AND RECYCLING OPTIONS AND CAN RESULT IN DANGEROUS CHEMICAL REACTIONS.
- STORM WATER THAT COLLECTS WITHIN SECONDARY CONTAINMENT STRUCTURES MUST BE INSPECTED PRIOR TO BEING DISCHARGED TO ENSURE NO POLLUTANTS ARE PRESENT. CONTAMINATED STORM WATER IS NOT ALLOWED TO BE DISCHARGED AND SHOULD BE DISPOSED OF IN ACCORDANCE WITH ALL APPLICABLE LAWS AND REGULATIONS.
- -SPILLS CONNOT BE DISCHARGED FROM A SECONDARY CONTAINMENT SYSTEM. -HAZARDOUS WASTE MUST BE SEGREGATED FROM OTHER SOLID WASTE AND DISPOSED OF PROPERLY.
- -IN ADDITION TO FOLLOWING THIS BMP, EMPLOYEES AND CONTRACTORS ARE RESPONSIBLE FOR COMPLIANCE WITH FEDERAL, STATE, AND LOCAL LAWS REGARDING STORAGE, HANDLING, TRANSPORTATION, AND DISPOSAL OF HAZARDOUS WASTE.



Know what's **below**. Call before you dig.

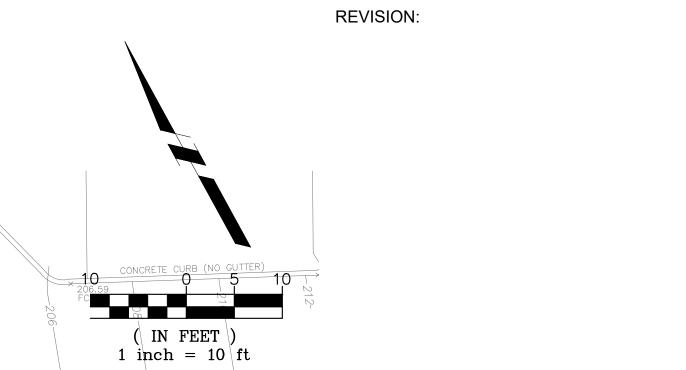

DRAWN: CK CHECKED: CK

ISSUE DATE: November 02, 2021 EROSION AND SEDIMENT CONTROL PLAN DRAWING TITLE:


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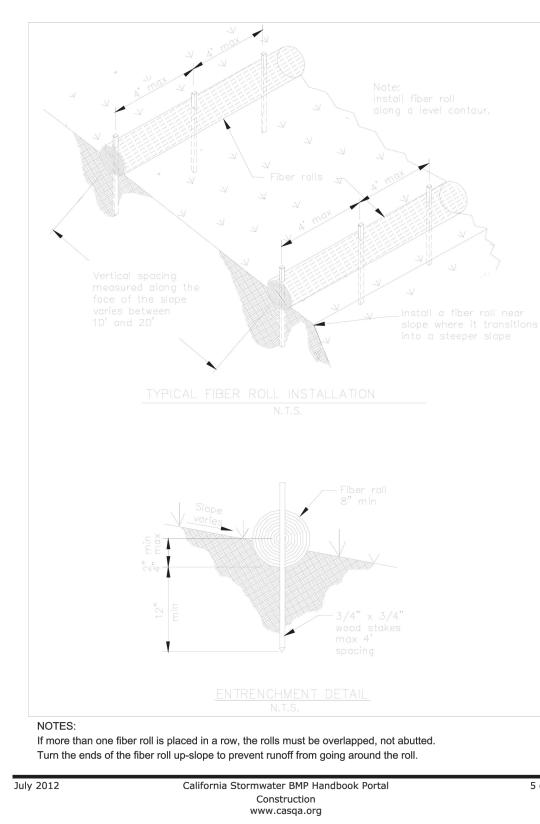


#### **Concrete Waste Management**


**WM-8** 


#### **Fiber Rolls**




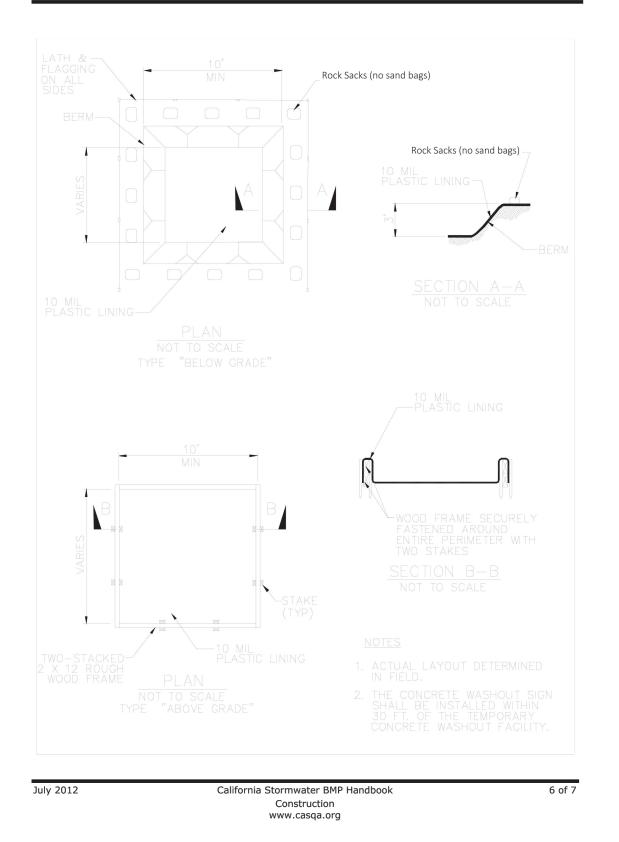



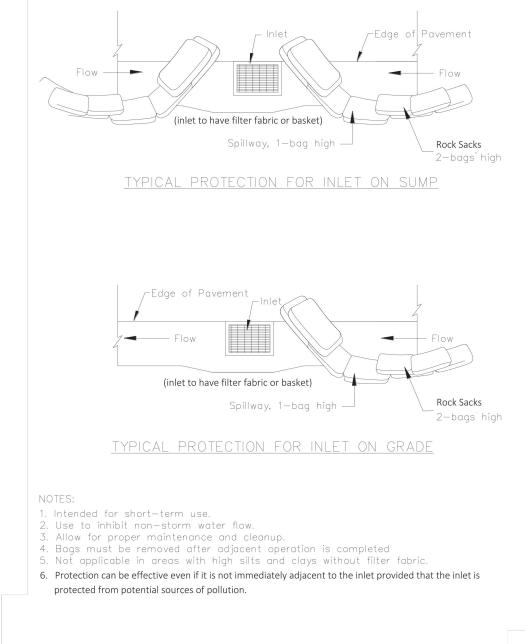

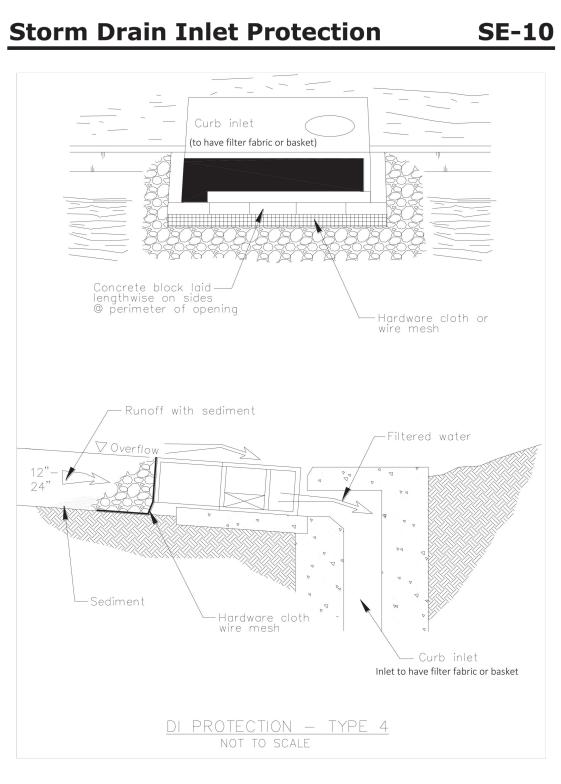

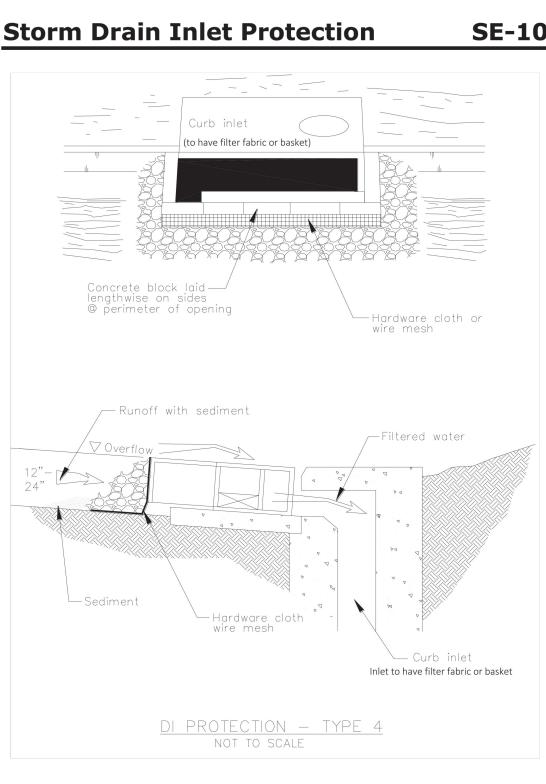


California Stormwater BMP Handbook

Construction

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10 of 10

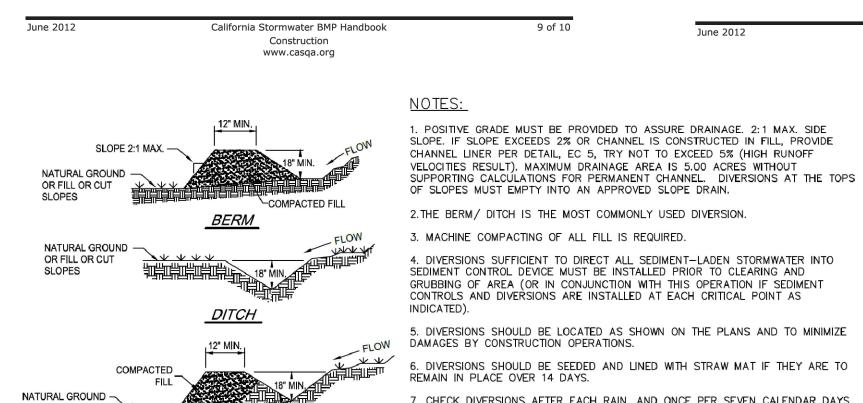

-CUT SLOPE

BERM / DITCH

OR FILL OR CUT

SLOPES

6. DIVERSIONS SHOULD BE SEEDED AND LINED WITH STRAW MAT IF THEY ARE TO REMAIN IN PLACE OVER 14 DAYS.

June 2012

7. CHECK DIVERSIONS AFTER EACH RAIN, AND ONCE PER SEVEN CALENDAR DAYS TO MAINTAIN FUNCTION.

**TEMPORARY DIVERSION BERM / DITCH** 

OR MORE FREQUENTLY IF REQUIRED BY REGULATORY AGENCY. REPAIR AS NEEDED


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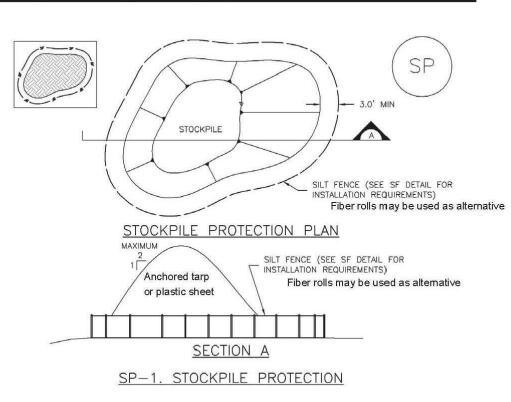
SE-5

### **Stabilized Construction Entrance/Exit TC-1**


#### **Stockpile Management (SP)**

5 of 5




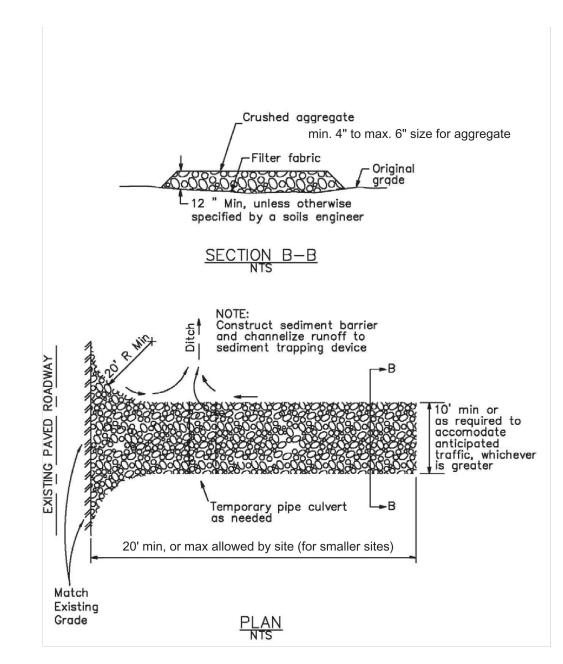



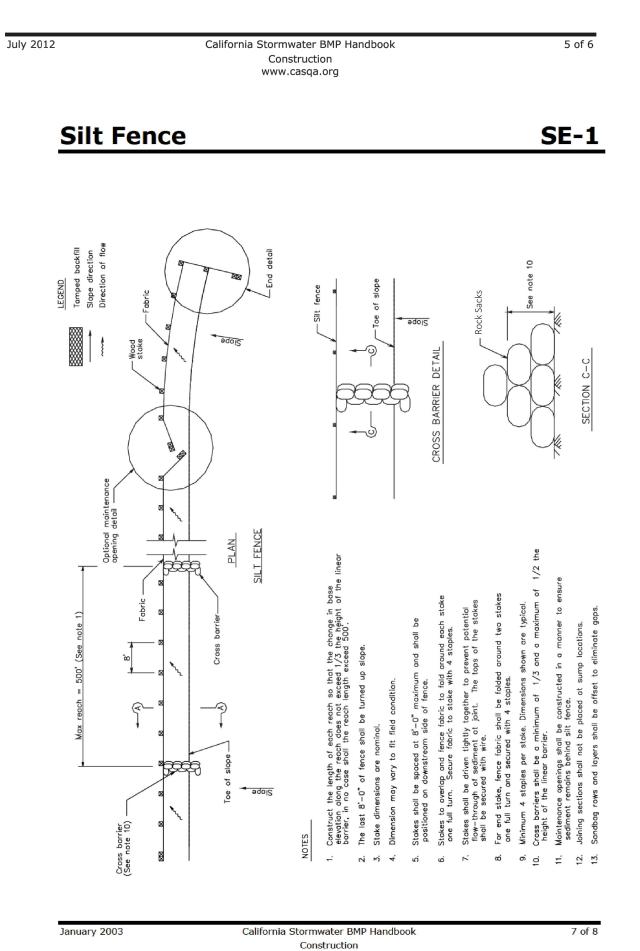

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8 of 8

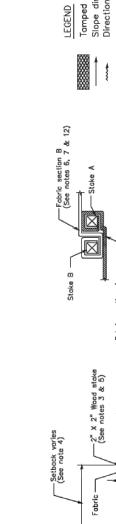
**REVISION**:

### FOR REVIEW & FILING **NOT FOR CONSTRUCTION**

STAMP:

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Construction

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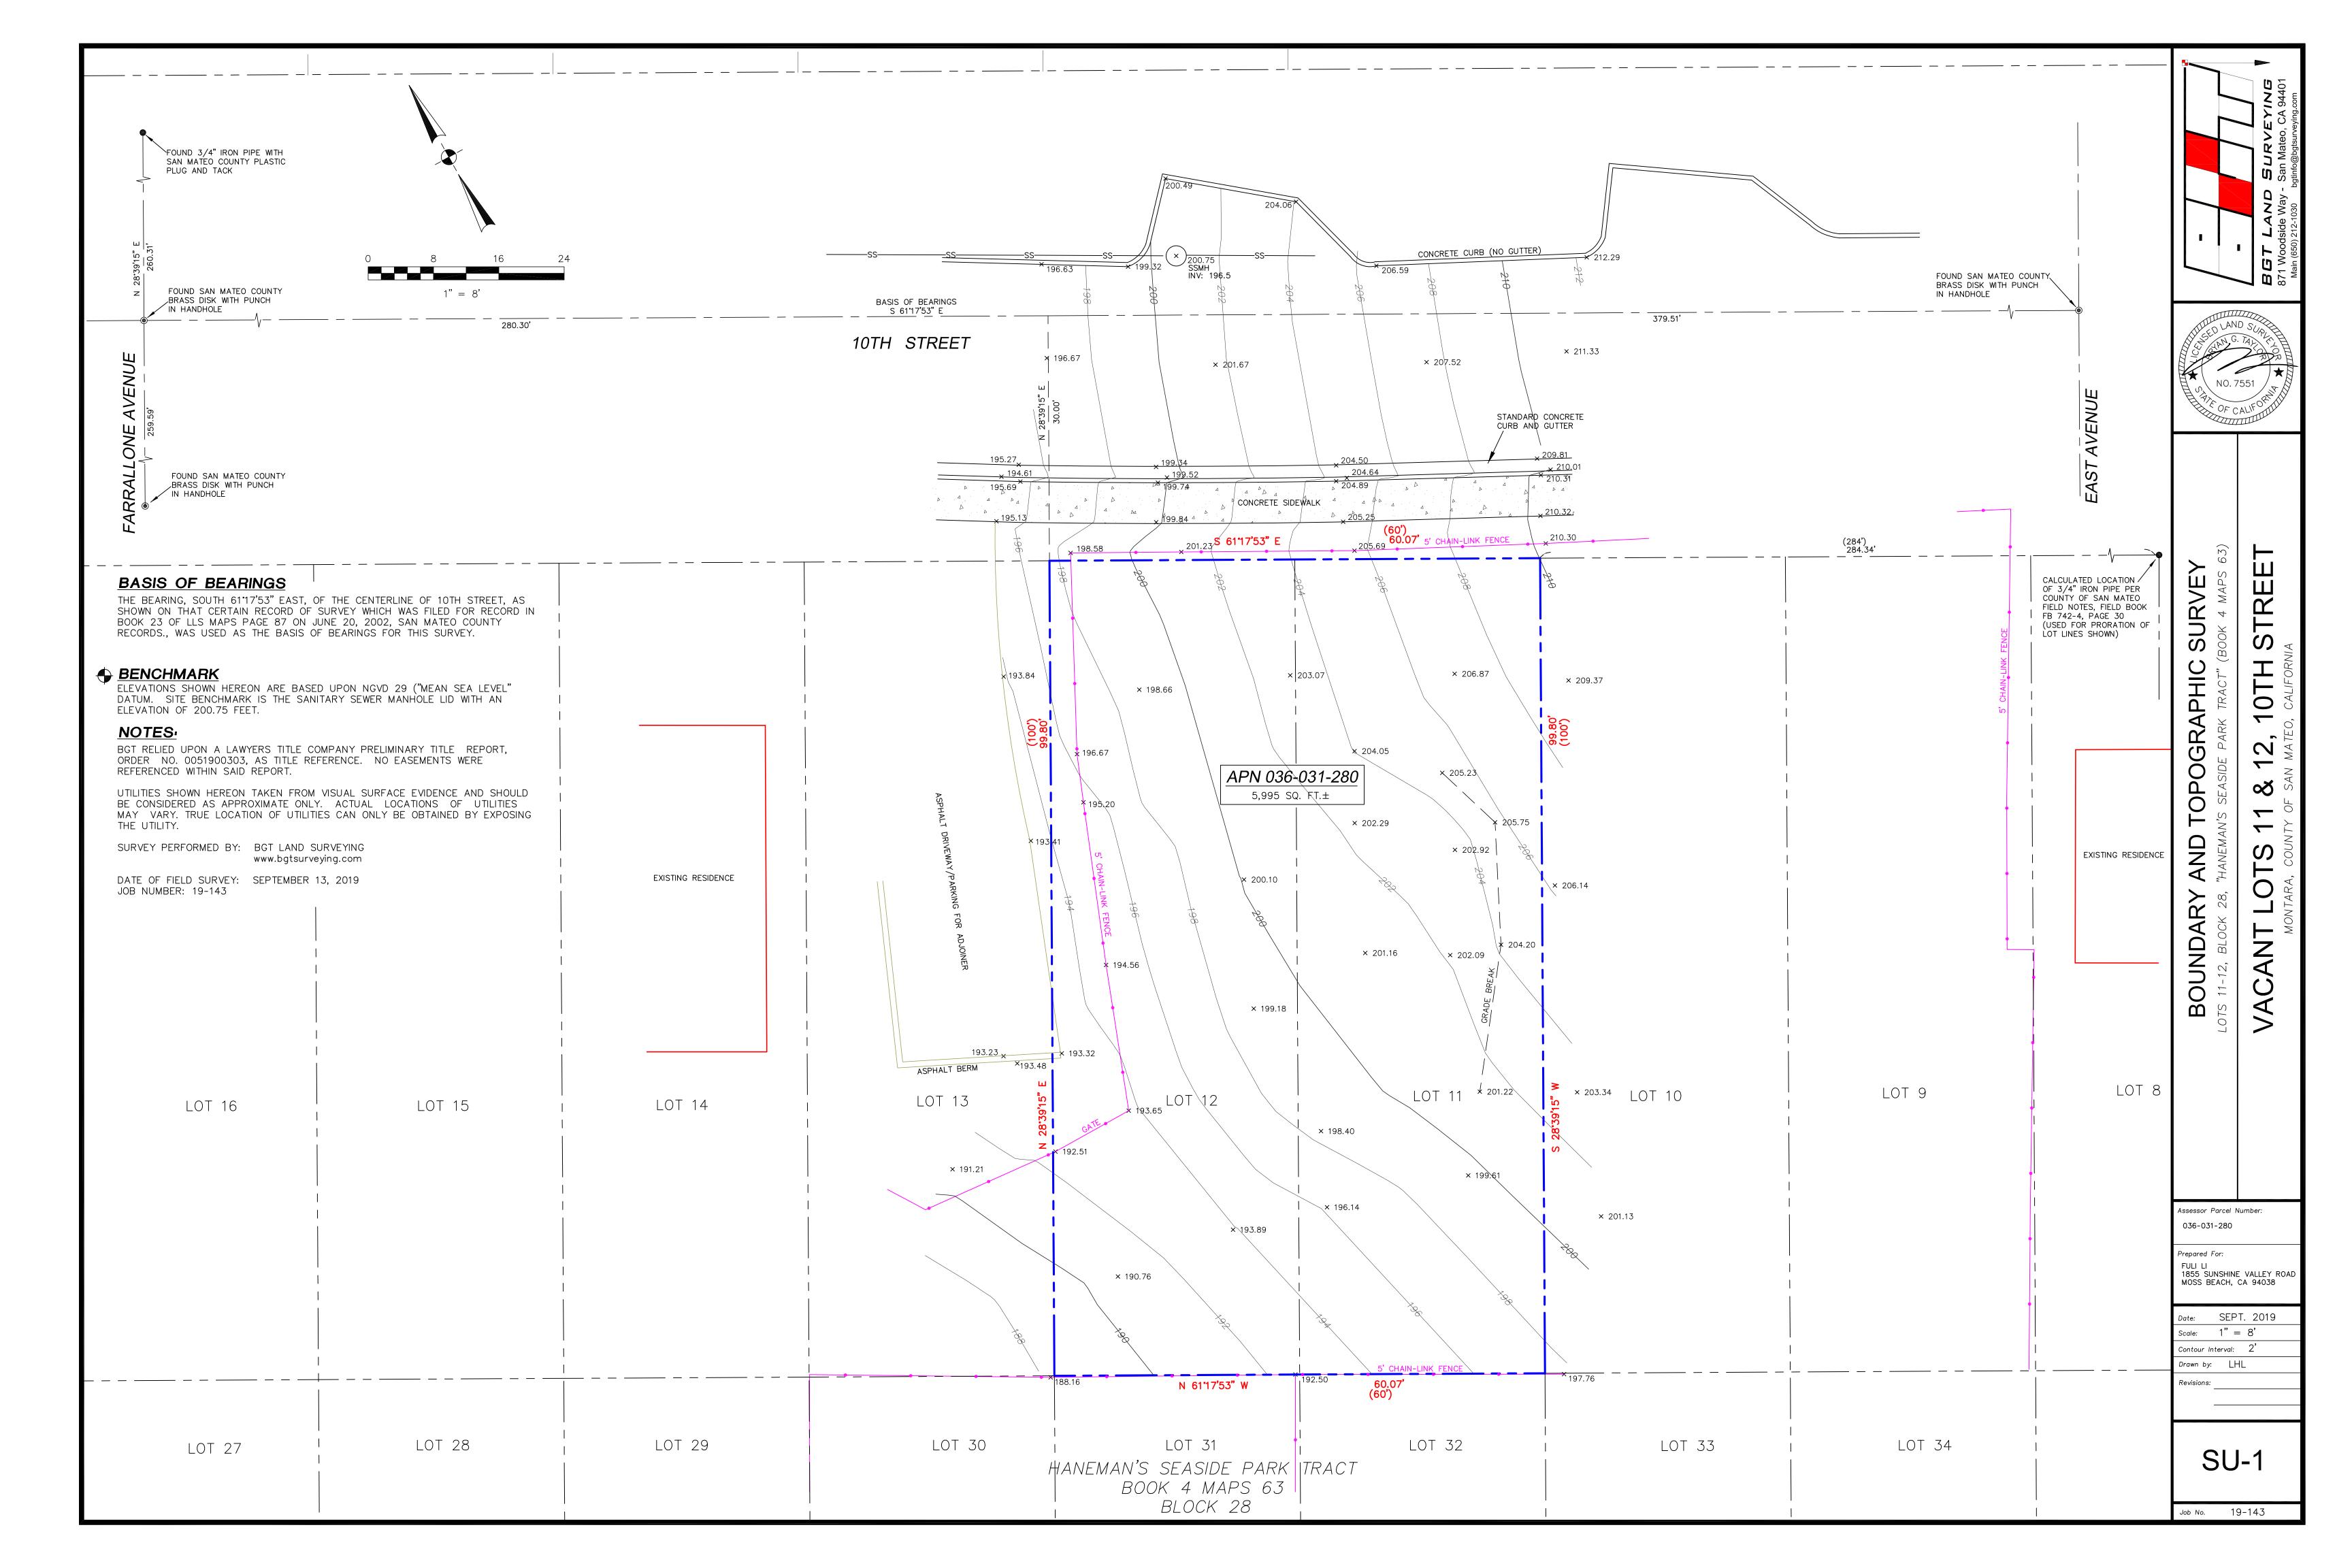


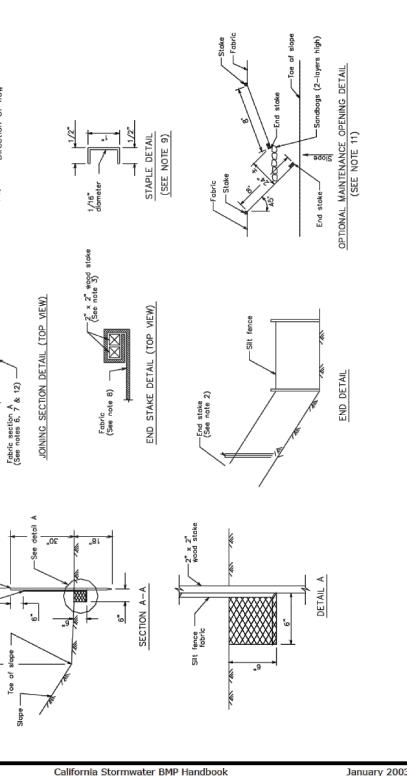
365 FLOWER LANE MOUNTAIN VIEW, CA 94043 FOR SALES: PHONE: (888) 311-3015 FOR CONSTRUCTION SUPPORT: PHONE: (888) 512-3152 EMAIL: constructionsupport@designeverest.com


PROJECT NO:	PROJECT NAME:		
2101	House o	n a Hill	
APN:	036-031-280		
PROJECT ADDRESS:	340 10th Street Montara, CA 94307		
PROJECT PHASE	:100% Sche	ematic Des	sign
DRAWN:	СК	CHECKED:	СК
ISSUE DATE:	November 02, 2021		
DRAWING TITLE:	EROSION AND SED	IMENT CONTROL D	DETAILS

DRAWING NO:





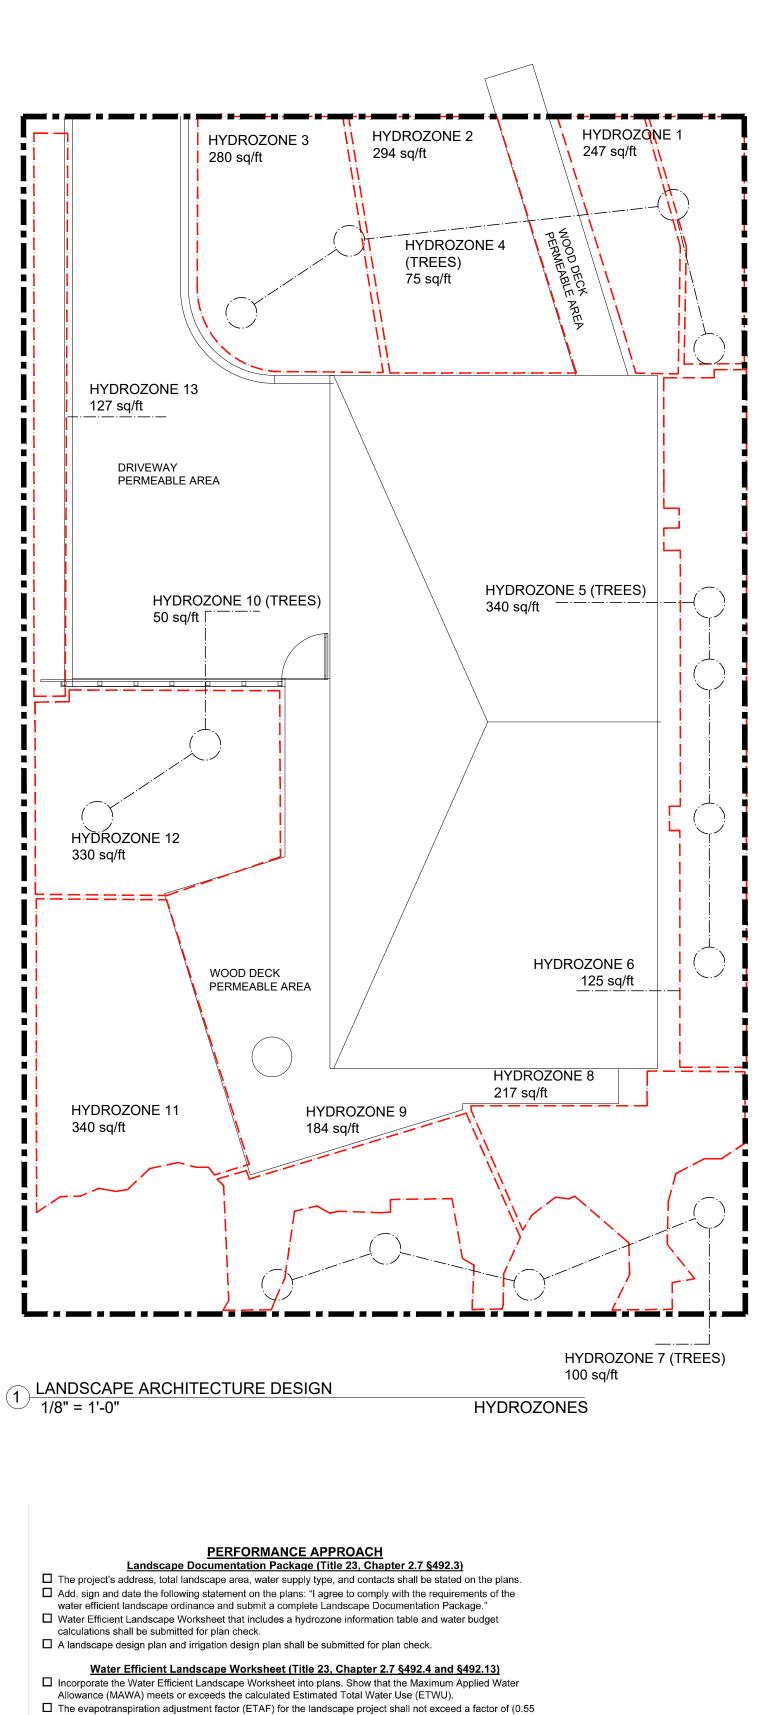

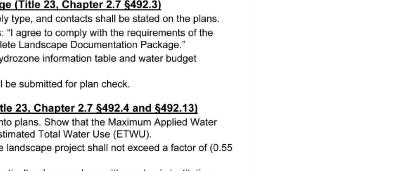

- for residential areas) (0.45 for non-residential areas). The plant factor used shall be from WUCOLS or from horticultural researchers with academic institutions.
- WUCOLS plants database can be found on-line at: http://ucanr.edu/sites/WUCOLS/ All water features shall be included in the high water use hydrozone. All temporary irrigated areas shall be
- included in the low water use hydrozone. All Special Landscape areas shall be identified on the plans. The ETAF for new and existing (non-
- rehabilitated) Special Landscape Areas shall not exceed 1.0. □ For the purpose of calculating ETWU, the irrigation efficiency is assumed to be 0.75 for overhead spray
- devices and 0.81 for drip system devices.

#### Landscape Design Plan (Title 23, Chapter 2.7 §492.6) The landscape design plans, at a minimum, shall:


- Delineate and label each hydrozone by number, letter, or other methods. □ Identify each hydrozone as low, moderate, high water, or mixed water use. D Identify recreational areas, areas solely dedicated to edible plants, areas irrigated with recycled water,
- type and surface area of water features, impermeable and permeable hardscape, and any infiltration systems. □ For hydrozone with a mix of both low and moderate water use plants or both moderate and high water use
- plants, the higher plant factor or the plant factor based on the proportions of the respective plant water uses shall be used. Hydrozones containing a mix of low and high water use plants is not permitted. Turf is not allowed on slopes greater than 25% where the toe of the slope is adjacent to an impermeable hardscape.
- Add note to plans: "Recirculating water systems shall be used for water features" Add note to plans: "A minimum 3-inch layer of mulch shall be applied on all exposed soil surfaces of planting
- areas except turf areas, creeping or rooting groundcovers, or direct seeding applications where mulch is contraindicated."
- Add note to plans: "For soils less than 6% organic matter in the top 6 inches of soil, compost at a rate of a minimum of four cubic yards per 1,000 square feet of permeable area shall be incorporated to a depth of six inches into the soil"




L4 RECESSED LIGHT FIXTURE


FLOS. USA 110 York Street Brooklyn, NY 11201 (718).875.3472

For more information contact your representative or go to FlosUSA.com.

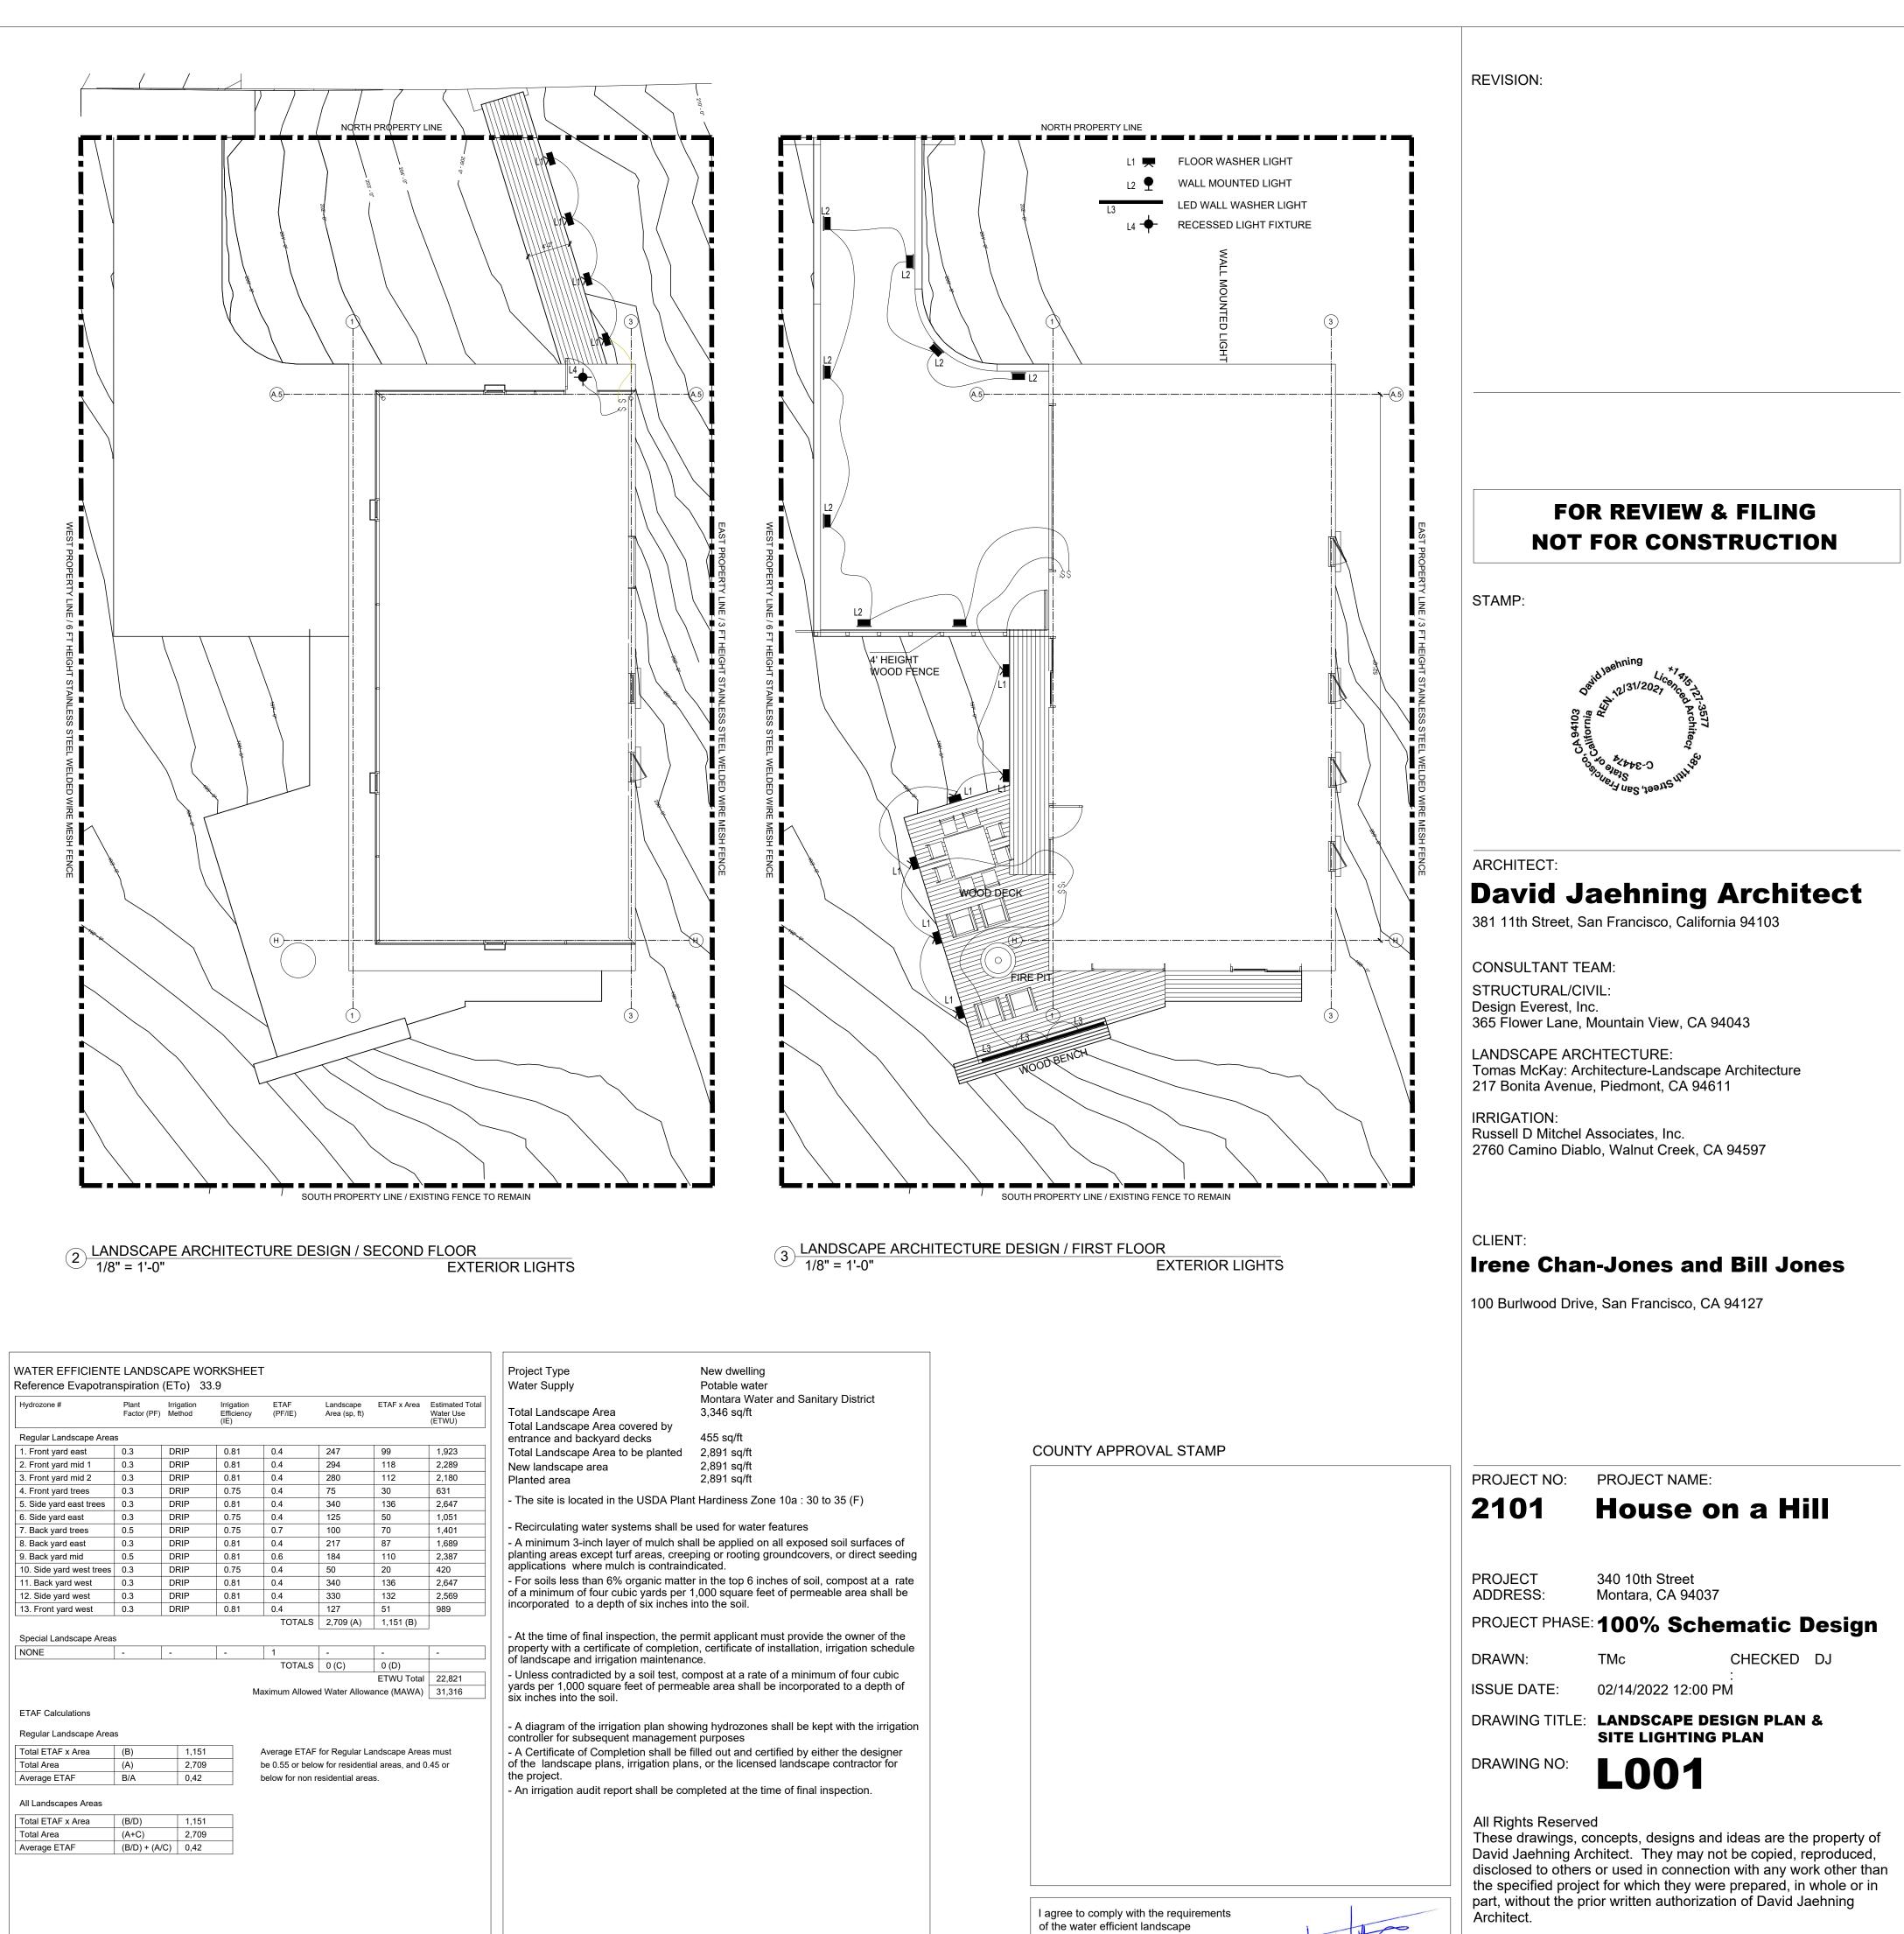

ordinance and submit a complete Landscape Documentation Package

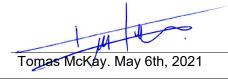

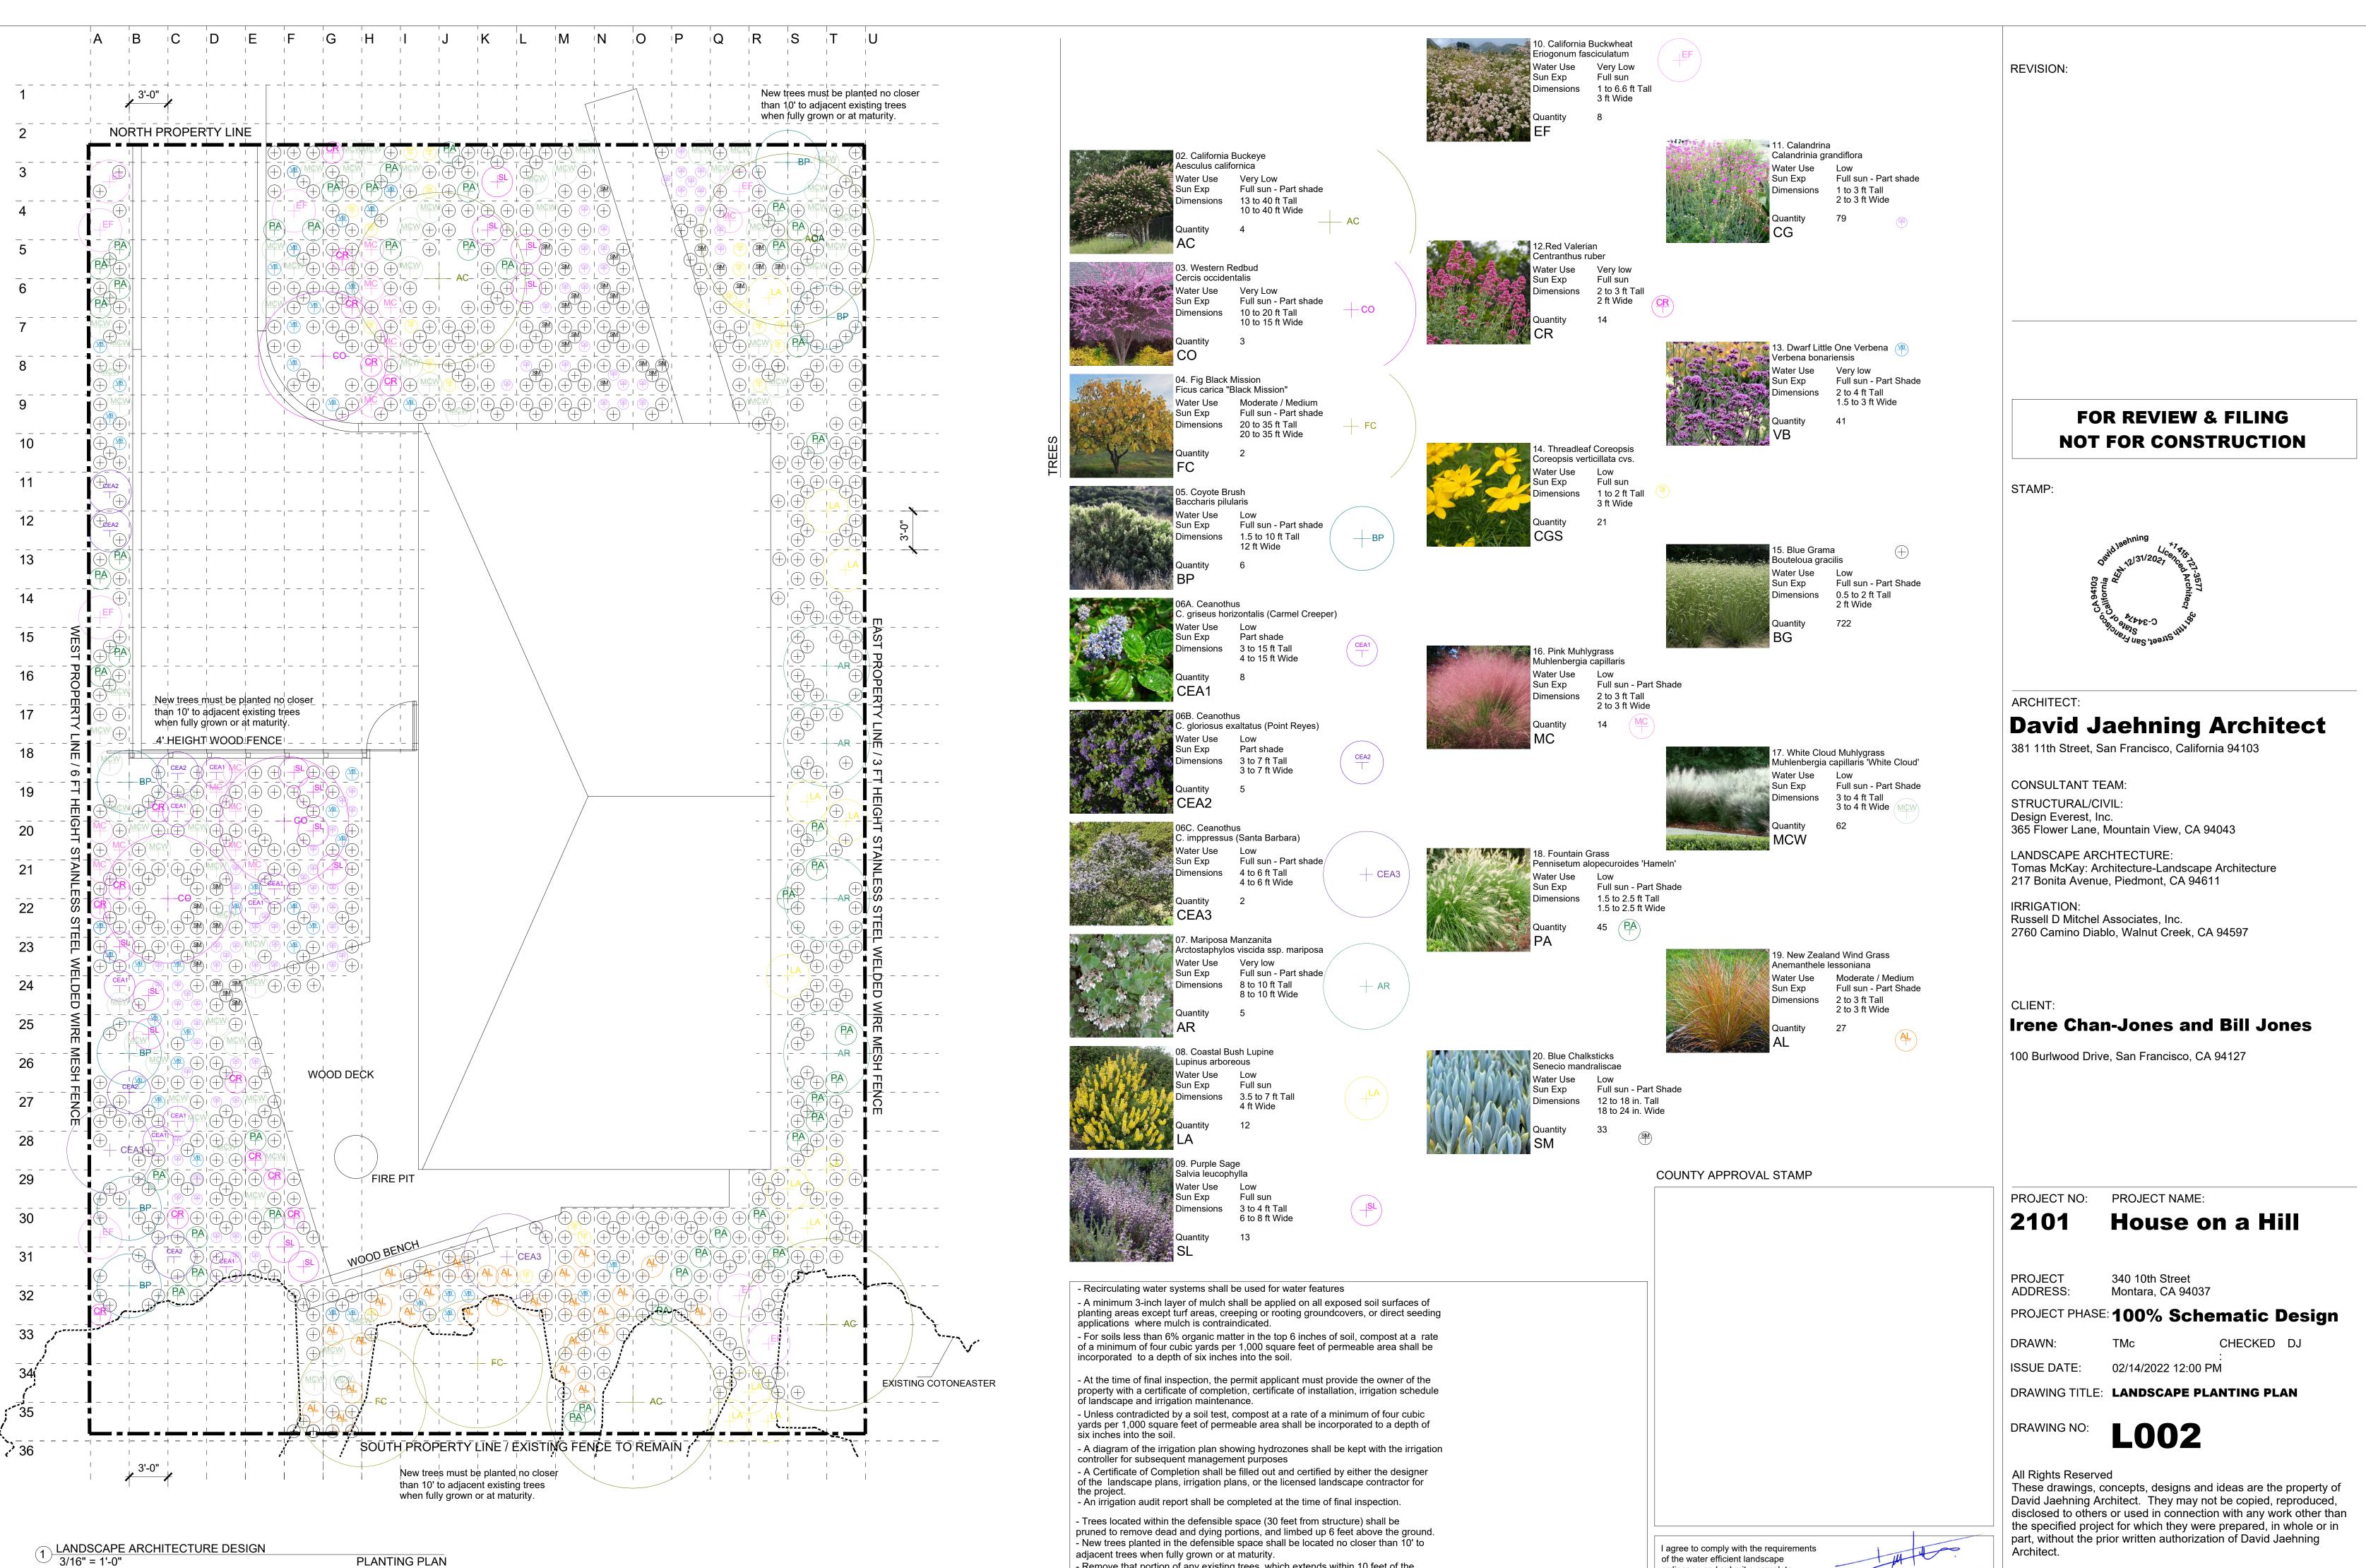

adjacent trees when fully grown or at maturity.

- Remove that portion of any existing trees, which extends within 10 feet of the outlet of a chimney or stovepipe or is within 5' of any structure. Maintain any tree adjacent to or overhanging a building free of dead or dying wood.

of the water efficient landscape ordinance and submit a complete Landscape Documentation Package



### IRRIGATION NOTES

- THESE IRRIGATION DRAWINGS ARE DIAGRAMMATIC AND INDICATIVE OF THE WORK TO BE INSTALLED. ALL PIPING, VALVES, AND OTHER IRRIGATION COMPONENTS MAY BE SHOWN WITHIN PAVED AREAS FOR GRAPHIC CLARITY ONLY AND ARE TO BE INSTALLED WITHIN PLANTING AREAS. DUE TO THE SCALE OF THE DRAWINGS, IT IS NOT POSSIBLE TO INDICATE ALL OFFSETS, FITTINGS, SLEEVES, CONDUIT, AND OTHER ITEMS WHICH MAY BE REQUIRED. INVESTIGATE THE STRUCTURAL AND FINISHED CONDITION AFFECTING THE CONTRACT WORK INCLUDING OBSTRUCTIONS, GRADE DIFFERENCES OR AREA DIMENSIONAL DIFFERENCES. IN THE EVENT OF FIELD DISCREPANCY WITH CONTRACT DOCUMENTS, PLAN THE INSTALLATION WORK ACCORDINGLY BY NOTIFICATION AND APPROVAL OF THE OWNER'S AUTHORIZED REPRESENTATIVE AND ACCORDING TO THE CONTRACT SPECIFICATIONS. NOTIFY AND COORDINATE IRRIGATION CONTRACT WORK WITH APPLICABLE CONTRACTORS FOR THE LOCATION AND INSTALLATION OF PIPE, CONDUIT OR SLEEVES THROUGH OR UNDER WALLS, ROADWAYS, PAVING AND STRUCTURES BEFORE CONSTRUCTION. IN THE EVENT THESE NOTIFICATIONS ARE NOT PERFORMED, THE CONTRACTOR ASSUMES FULL RESPONSIBILITY FOR REQUIRED REVISIONS.
- 2. THE CONTRACTOR SHALL COMPLY WITH ALL APPLICABLE CODES, STANDARDS, AND REGULATIONS. ALL WORK AND MATERIALS SHALL BE IN FULL ACCORDANCE WITH THE LATEST RULES AND **REGULATIONS OF THE NATIONAL ELECTRIC CODE; THE UNIFORM** PLUMBING CODE, PUBLISHED BY THE WESTERN PLUMBING OFFICIALS ASSOCIATION; AND OTHER STATE OR LOCAL LAWS OR REGULATIONS. NOTHING IN THESE DRAWINGS IS TO BE CONSTRUED TO PERMIT WORK NOT CONFORMING TO THESE CODES OR REGULATIONS. THE CONTRACTOR SHALL FURNISH WITHOUT ANY EXTRA CHARGE, ANY ADDITIONAL MATERIAL AND LABOR WHEN REQUIRED BY THE COMPLIANCE WITH THESE CODES AND REGULATIONS.
- 3. THE CONTRACTOR SHALL COORDINATE INSTALLATION OF IRRIGATION SYSTEM WITH LAYOUT AND INSTALLATION OF THE PLANT MATERIALS TO INSURE THAT THERE WILL BE COMPLETE AND UNIFORM IRRIGATION COVERAGE OF PLANTING IN ACCORDANCE WITH THESE DRAWINGS, AND CONTRACT DOCUMENTS. THE IRRIGATION LAYOUT SHALL BE CHECKED BY THE CONTRACTOR AND OWNER'S AUTHORIZED REPRESENTATIVE PRIOR TO CONSTRUCTION TO DETERMINE IF ANY CHANGES, DELETIONS, OR ADDITIONS ARE REQUIRED. IRRIGATION SYSTEM SHALL BE INSTALLED AND TESTED PRIOR TO INSTALLATION OF PLANT MATERIAL.
- 4. THE INTENT OF THIS IRRIGATION SYSTEM IS TO PROVIDE THE MINIMUM AMOUNT OF WATER REQUIRED TO SUSTAIN GOOD PLANT HEALTH.
- 5. IT IS THE RESPONSIBILITY OF THE MAINTENANCE CONTRACTOR AND/OR OWNER TO PROGRAM THE IRRIGATION CONTROLLER(S) TO PROVIDE THE MINIMUM AMOUNT OF WATER NEEDED TO SUSTAIN GOOD PLANT HEALTH. THIS INCLUDES MAKING ADJUSTMENTS TO THE PROGRAM FOR SEASONAL WEATHER CHANGES, PLANT MATERIAL, WATER REQUIREMENTS, MOUNDS, SLOPES, SUN, SHADE AND WIND EXPOSURE.
- 6. IT IS THE RESPONSIBILITY OF A LICENSED ELECTRICAL CONTRACTOR TO PROVIDE 120 VOLT A.C. (2.5 AMP DEMAND PER CONTROLLER) ELECTRICAL SERVICE TO THE CONTROLLER LOCATION(S). IT IS THE **RESPONSIBILITY OF THE IRRIGATION CONTRACTOR TO** COORDINATE THE ELECTRICAL SERVICE STUB-OUT TO THE CONTROLLER(S). PROVIDE PROPER GROUNDING PER CONTROLLER MANUFACTURER'S INSTRUCTIONS AND IN ACCORDANCE WITH LOCAL CODES.
- SCHEDULE A MEETING WHICH INCLUDES REPRESENTATIVES OF THE IRRIGATION CONTROLLER MANUFACTURER. THE MAINTENANCE CONTRACTOR, THE OWNER AND THE IRRIGATION CONTRACTOR AT THE SITE FOR INSTRUCTION ON THE PROPER PROGRAMMING AND OPERATION OF THE IRRIGATION CONTROLLER.
- 8. INSTALL 3" DETECTABLE TAPE ABOVE ALL PRESSURIZED MAIN LINES AS DETAILED. USE CHRISTY MODEL #TA-DT-3-BIRR FOR POTABLE IRRIGATION SYSTEMS OR #TA-DT-3-PRW FOR RECYCLED IRRIGATION WATER SYSTEMS.
- 9. PROVIDE EACH IRRIGATION CONTROLLER WITH ITS OWN INDEPENDENT LOW VOLTAGE COMMON GROUND WIRE.
- 10. IRRIGATION CONTROL WIRES: SOLID COPPER WITH U.L. APPROVAL FOR DIRECT BURIAL IN GROUND. COMMON GROUND WIRE: SIZE #12-1 WIRE WITH A WHITE INSULATING JACKET. CONTROL WIRE SERVICING REMOTE CONTROL VALVES: SIZE #14-1 WIRE WITH INSULATING JACKET OF COLOR OTHER THAN WHITE. SPLICES SHALL BE MADE WITH 3M-DBY SEAL PACKS OR APPROVED EQUAL.
- 11. SPLICING OF LOW VOLTAGE WIRES IS PERMITTED IN VALVE BOXES ONLY. LEAVE A 36" LONG, 1" DIAMETER COIL OF EXCESS WIRE AT EACH SPLICE AND A 36" LONG EXPANSION LOOP EVERY 100 FEET ALONG WIRE RUN. TAPE WIRES TOGETHER EVERY TEN FEET. DO NOT TAPE WIRES TOGETHER WHERE CONTAINED WITHIN SLEEVING OR CONDUIT.
- 12. INSTALL BLACK PLASTIC VALVE BOXES WITH BOLT DOWN, NON HINGED COVER MARKED "IRRIGATION CONTROL VALVE". BOX BODY SHALL HAVE KNOCK OUTS. ACCEPTABLE VALVE BOX MANUFACTURER'S INCLUDE NDS, CARSON OR APPROVED EQUAL.

- 13. THE CONTRACTOR SHALL LABEL CONTROL LINE WIRE REMOTE CONTROL VALVE WITH A 2 1/4" X 2 3/4" PC I.D. TAG, INDICATING IDENTIFICATION NUMBER OF VA (CONTROLLER AND STATION NUMBER). ATTACH LABEL CONTROL WIRE. THE CONTRACTOR SHALL PERMANEN ALL VALVE BOX LIDS WITH APPROPRIATE IDENTIFICATI NOTED IN CONSTRUCTION DETAILS.
- 14. FLUSH AND ADJUST IRRIGATION OUTLETS AND NOZZI OPTIMUM PERFORMANCE AND TO PREVENT OVER SPI WALKS, ROADWAYS, AND/OR BUILDINGS. SELECT TH DEGREE OF THE ARC AND RADIUS TO FIT THE EXISTING CONDITIONS AND THROTTLE THE FLOW CONTROL AT TO OBTAIN THE OPTIMUM OPERATING PRESSURE FOR CONTROL ZONE.
- 15. WHERE IT IS NECESSARY TO EXCAVATE ADJACENT TO TREES, USE CAUTION TO AVOID INJURY TO TREES AND ROOTS. EXCAVATE BY HAND IN AREAS WHERE TWO ( LARGER ROOTS OCCUR. BACK FILL TRENCHES ADJACE WITHIN TWENTY-FOUR (24) HOURS. WHERE THIS IS N SHADE THE SIDE OF THE TRENCH ADJACENT TO THE TR BURLAP OR CANVAS.
- 16. THE IRRIGATION SYSTEM DESIGN IS BASED ON THE MI OPERATING PRESSURE SHOWN ON THE IRRIGATION I VERIFY WATER PRESSURE PRIOR TO CONSTRUCTION. DIFFERENCE BETWEEN THE WATER PRESSURE INDICATI DRAWINGS AND THE ACTUAL PRESSURE READING AT IRRIGATION POINT OF CONNECTION TO THE OWNER AUTHORIZED REPRESENTATIVE.
- 17. IRRIGATION DEMAND: REFER TO PLANS.
- 18. THE EXISTING MAIN LINE SHOWN ON THE DRAWINGS DIAGRAMMATIC. VERIFY AND LOCATE EXISTING MAIN REPORT TO ARCHITECT IN WRITING ANY DEVIATION O MAIN LINE LOCATION FROM THAT SHOWN ON THE D
- 19. PIPE THREAD SEALANT COMPOUND SHALL BE RECTOR
- 20. THE LANDSCAPE CONTRACTOR SHALL BE RESPONSIBL CHANGES IN THE IRRIGATION LAYOUT DUE TO OBSTR NOT SHOWN ON THE IRRIGATION DRAWINGS SUCH FIRE HYDRANTS, SIGNS, ELECTRICAL ENCLOSURES, ETC
- 21. WHEN WORK OF THIS SECTION HAS BEEN COMPLETE OTHER TIMES AS MAY BE DIRECTED, REMOVE ALL TRAS SURPLUS MATERIALS AND EQUIPMENT FROM SITE.
- 22. CONTRACTOR SHALL BE RESPONSIBLE FOR SUPPLEMENT WATERING OF ALL PLANT MATERIAL WITHIN DRIPLINE THE PLANTS ARE SUFFICIENTLY ESTABLISHED.
- 33. CONTRACTOR SHALL PROVIDE COMPLETE CONTROLL HYDROZONES CHARTS AND PLACE WITHIN CONTRO ENCLOSURE AFTER AS-BUILT DRAWINGS HAVE BEEN REVIEWED AND APPROVED BY THE CITY LANDSCAPE A
- 34. A CERTIFICATE OF COMPLETION SHALL BE FILLED OUT CERTIFIED BY EITHER LA, DESIGNER, OF THE PLANTING LICENSED LANDSCAPE CONTRACTOR FOR THE PROJECT
- 35. AT THE TIME OF FINAL INSPECTION, THE PERMIT APPLIC PROVIDE THE OWNER OF THE PROPERTY WITH A CERT COMPLETION, CERTIFICATE OF INSTALLATION, IRRIGAT SCHEDULE OF LANDSCAPE AND IRRIGATION MAINTEN THESES SHALL BE COMPLETED BY LANDSCAPE CONTRA

"A Landscape Irrigation Audit is require. This Audit must be completed by a Certified Landscape Irrigation Auditor, not the designer or installer. The Audit must be submitted to the Building Department, with Certificate of Completion (Appendix C) as required by the Department of Water Resources, prior to scheduling a Final Inspection of the Water Efficient Landscape permit."

WA⊺	TER CONSERVATION STATEMENT
	RUSSELL D MITCHELL AND ASSOCIATES, INC.
	WITH THE CRITERIA OF THE MODEL WATER EF
	ORDINANCE AND APPLIED THEM ACCORDINGLY
	USE OF WATER IN THE LANDSCAPE DESIGN P
	And
	Jorgan
	JOSE L. CRUZ
	IRRIGATION CONSULTANT-PROJECT MANAGER

### IRRIGATION LEGEND

AT EACH	SYMBOL	NUMBER	DESCRIPTION	NOZZLE GPM	OPERATING PSI	OPERATING RADIUS (FEET)
DLYURETHANE	$\sim$	DB-04-PC-CV	TORO BUBBLE (SHRUB) MIN. 1 PER SHRUB	0.066	30	TRICKLE
O TLY STAMP DN AS	3	HDL-04-CV	ON GRADE HUNTER HDL DRIP RING FOR TREES (3 RINGS PEF TREE) SEE DETAIL	0.10	30	TRICKLE
	•	ICV-100	HUNTER REMOTE CONTROL VAL	VE		
S FOR AY ONTO		ICZ-101	HUNTER REMOTE CONTROL VAL	.VE DRIPZONE K	IT	
BEST	•+	PLD-BV	HUNTER MANUAL FLUSH VALVE			
SITE		ECO-ID	HUNTER ECO-INDICATOR			
EACH VALVE EACH	M	T-580-A-1.25"	NIBCO BRASS BALL VALVE			
	(M)	ICV-101G	HUNTER MASTER VALVE (NORM	ALLY CLOSED)		
XISTING	FS	HC-100-FLOW	HUNTER FLOW METER-PRIVATE	METER		
TREE		975XLSEU-1"	WILKINS REDUCED PRESSURE	BACKFLOW ASSE	MBLY	
) INCH AND IT TO TREE		PHC-600i	HUNTER PRO-HC (6–24) STA ENCLOSURE.	TION CONTROLL	ER IN A PLAST	C WALL MOUNTED
DT POSSIBLE, E WITH WET	R	WR-CLIK	HUNTER WIRELESS RAIN-CLIK S AS SOON AS IT STARTS RAININ		ATICALLY SHUTS	THE SYSTEM OFF
	ĆV	KC OR KSC	NDS KSC SERIES CHECK VALVE SPRING CHECK VALVE FOR DOM			
NMUM RAWINGS. EPORT ANY			- CONTROLLER AND STATION NU	MBER		
ON THE HE		/	- REMOTE CONTROL VALVE SIZE	(IN INCHES)		
	•	• •	- FLOW (GPM)			
		•	- WATER USE CLASSIFICATION OF			
			- APPLICATION RATE (IN/HR) or - AREA (SQ. FT.)	DRIPLINE SPACI	NG	
LINE IN FIELD. F EXISTING RAWINGS.	••••••••••••••••••••••••••••••••••••••					
EAL #5.			18" COVER. LATERAL LINE: 3/4" AND LAF			
FOR MINOR			SCHEDULE 40	PVC PLASTIC F PVC SOLVENT		
CTIONS .S LIGHTS,			12" COVER. DRIPLINE 3/4" AND LAF	RGER:		
			LATERAL LINE: 1120-SCHEDU SCHEDULE 40			
) AND SUCH 1, DEBRIS,			INDICATED IN	PVC PLASTIC P SPECIFICATIONS PTH OF COVER.		
TAL HAND		<b>Ģ</b>	DRIPLINE REMOTE CONTROL V	ALVE		
REAS UNTIL	PVC LATERAL		DRIP ZONE: HUNTER HDL SERIES DRIPLINE	WITH BUILT IN	PRESSURE CC	MPENSATION
			AND CHECK VALVE, PART #HE TO BE INSTALLED 4" BELOW	)L-06-12-250-	-CV. USE PLD	FITTINGS. TUBING
ER	SUP	PLY EXHAUST	DETAILS. SIZE EXHAUST H	HEADERS AS	FOLLOWS:	1": 0-10
COMPLETED, CCHITECT.		DER HEADER	GPM, 1.25": 11−20 GF BE 1" SCH 40 PVC OF			
ND			SCH. 40 PVC SOLVENT HEADERS TO THE ENDS	WELD FITTING OF ALL DR	NGS. EXTEN RIP ZONES	) PVC O BALANCE
THE			FLOW IF REQUIRED. SE	e details f	UK FUKIHE	7
		-				
ANT MUST FICATE OF	PVC LATERA		DRIPLIN	E REMOTE CONT	ROL VALVE	
ON				IMATE CONNECTI		
NCE, ALL CTOR.			3 GPM NEEDED	AND NO PVC SU	UPPLY/EXHUST PLINE TUBING	ZONE IS LESS THAN HEADERS ARE CONNECTION DETAIL

(RMA) HAVE COMPLIED FICIENT LANDSCAPE FOR THE EFFICIENT PLAN.

> Irrigation Consultant: Russell D. Mitchell Associates, Inc. 2760 Camino Diablo Walnut Creek, CA 94597 tel 925.939.3985 ♦ fax 925.932.5671 www.rmairrigation.com

#### COUNTY APPROVAL STAMP

FOR REVIEW & FILING	
NOT FOR CONSTRUCTION	

ARCHITECT:

### **David Jaehning Architect**

381 11th Street, San Francisco, California 94103

CONSULTANT TEAM: STRUCTURAL/CIVIL Design Everest, Inc. 365 Flower Lane, Mountain View, CA 94043

LANDSCAPE ARCHTECTURE: Tomas McKay: Architecture-Landscape Architecture 217 Bonita Avenue, Piedmont, CA 94611

**IRRIGATION:** Russell D Mitchell & Associates. Inc. 2760 Camino Diablo, Walnut Creek, CA 94597

#### CLIENT:

#### Irene Chan-Jones and Bill Jones

100 Burlwood Drive, San Francisco, CA 94127

#### PROJECT NO: 2101

PROJECT NAME:

### House on a Hill

APN:

10th St Montara, CA 94037

PROJECT ADDRESS:

### PROJECT PHASE: 100% Schematic Design

6/30/2021

LEGEND

036-031-280

DRAWN: Jose Cruz

CHECKED:


**ISSUE DATE:** 

DRAWING TITLE: IRRIGATION NOTES AND


DRAWING NO:

**IR-12** 

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		ED SCH 80 PVC O	R BRASS, AS REQ				9 • • • • • •	) <del>}////////////////////////////////////</del>	5 (	2 ()	)	5	7
-12			ļ L			_1.					4	)	_ ر.
		3					• •						
										<u>FLO</u>			
PVC MALE ADAPTER-2 TOTAL.					\$6565656565 <u>808080808</u>		10	) x PIPE DIA			6		52
SUPPORT BLOCK.		(1) MASTER	R VALVE						·	M (SEE L	_egend an	ľ	
RRIGATION LEGEND. E TO IRRIGATION SYSTEM.		2 VALVE					$\bigcirc$	TWO WIRE	S TO FLOW	V SENSOR	R TERMINAL	S AT CON	1T
3XL DOUBLE UNION REDUCING VALVE. SET		(4) HUNTER	R HC FLOW METER		UNION CONNECTION	NS		mm) SHIE	elded wire	e with dif	FFERENT C	OLOR FRO	
PRESSURE AS INDICATED (MATCH SIZE OF		-	0 PVC FEMALE AD NGULAR VALVE BO>				$\mathbb{O}$	FINISH	GRADE		CONNEC R (SEE L		١
INSTALL IF NEED.		LINE TO	O PROPER DEPTH		S) TO LOWER MAIN GER MAIN LINE AS		Ō	СОММО	N BRICK		cm) DE		)
BACKFLOW ASSEMBLY.		NEEDEL (8) SCH 80 LINE TO		E ELBOW (S X S	S) TO LOWER MAIN			OIVWLL		0 (10	0117 2-	1	
LOW ASSEMBLY. THIS MAY		_	IA. (40 mm) MAIN		& OUTLET								
SEMBLY	3			METER &	MASTER VALV	/e insta	ALLA <sup>.</sup>	TION					
	$\bigcirc$	Scale: NONE Det:											
PART #329-011)													
0 DRIP IRRIGATION													
DTE CONTROL													
R MODEL. O BUBBLER OR													
	J												

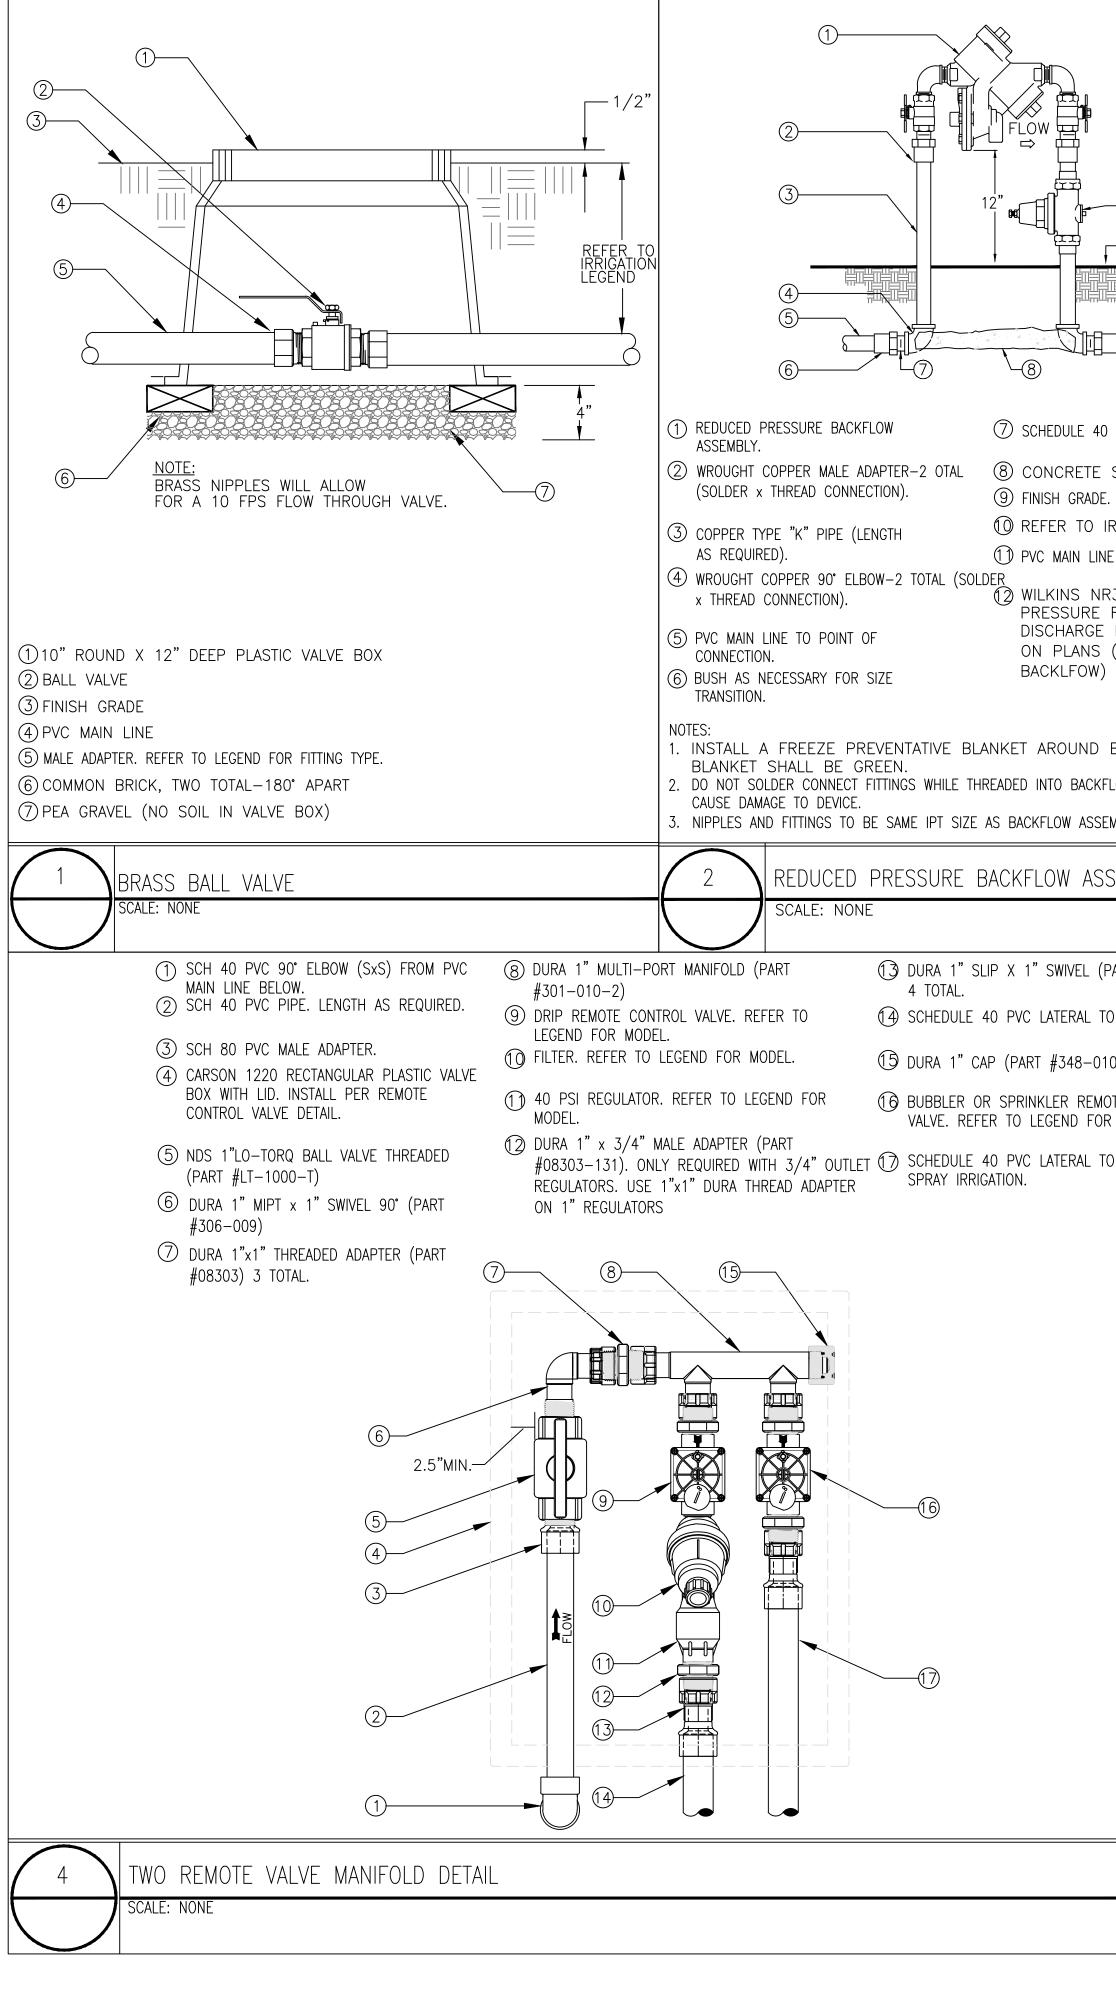

FOR TYPE AND SIZE)

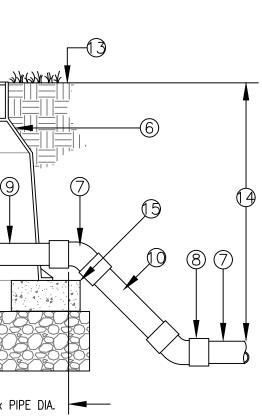NTROLLER. MIN. 18 AWG-UF (2.08 DM CONTROL/COMMON WIRE.

### FOR REVIEW & FILING NOT FOR CONSTRUCTION

ARCHITECT:

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IRRIGATION: Russell D Mitchell & Associates, Inc. 2760 Camino Diablo, Walnut Creek, CA 94597

CLIENT:

100 Burlwood Drive, San Francisco, CA 94127

COUNTY APPROVAL STAMP

PROJECT NO:PROJECT NAME:APN:036-031-280PROJECT<br/>ADDRESS:10th St Montara, CA 94037PROJECT PHASE:10th St Montara, CA 94037DRAWN:Jose CruzJose CruzCHECKED:ISSUE DATE:6/30/2021DRAWING TITLE:IRRIGATION DETAILSDRAWING NO:IRAUING NO:


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- BOX WITH LID. INSTALL PER REMOTE CONTROL VALVE DETAIL.

- (1) SCH 40 PVC 90° ELBOW (SxS) FROM PVC (7) DURA 1" MULTI-PORT MANIFOLD (PART #301-010-4)
  - LEGEND FOR MODEL.

  - MODEL.
  - 3/4" OUTLET REGULATORS. USE 1"x1" DURA THREAD ADAPTER ON 1" REGULATORS
- (12) DURA 1" SLIP X 1" SWIVEL (PART #329–011) 4 TOTAL.

- SPRAY IRRIGATION.

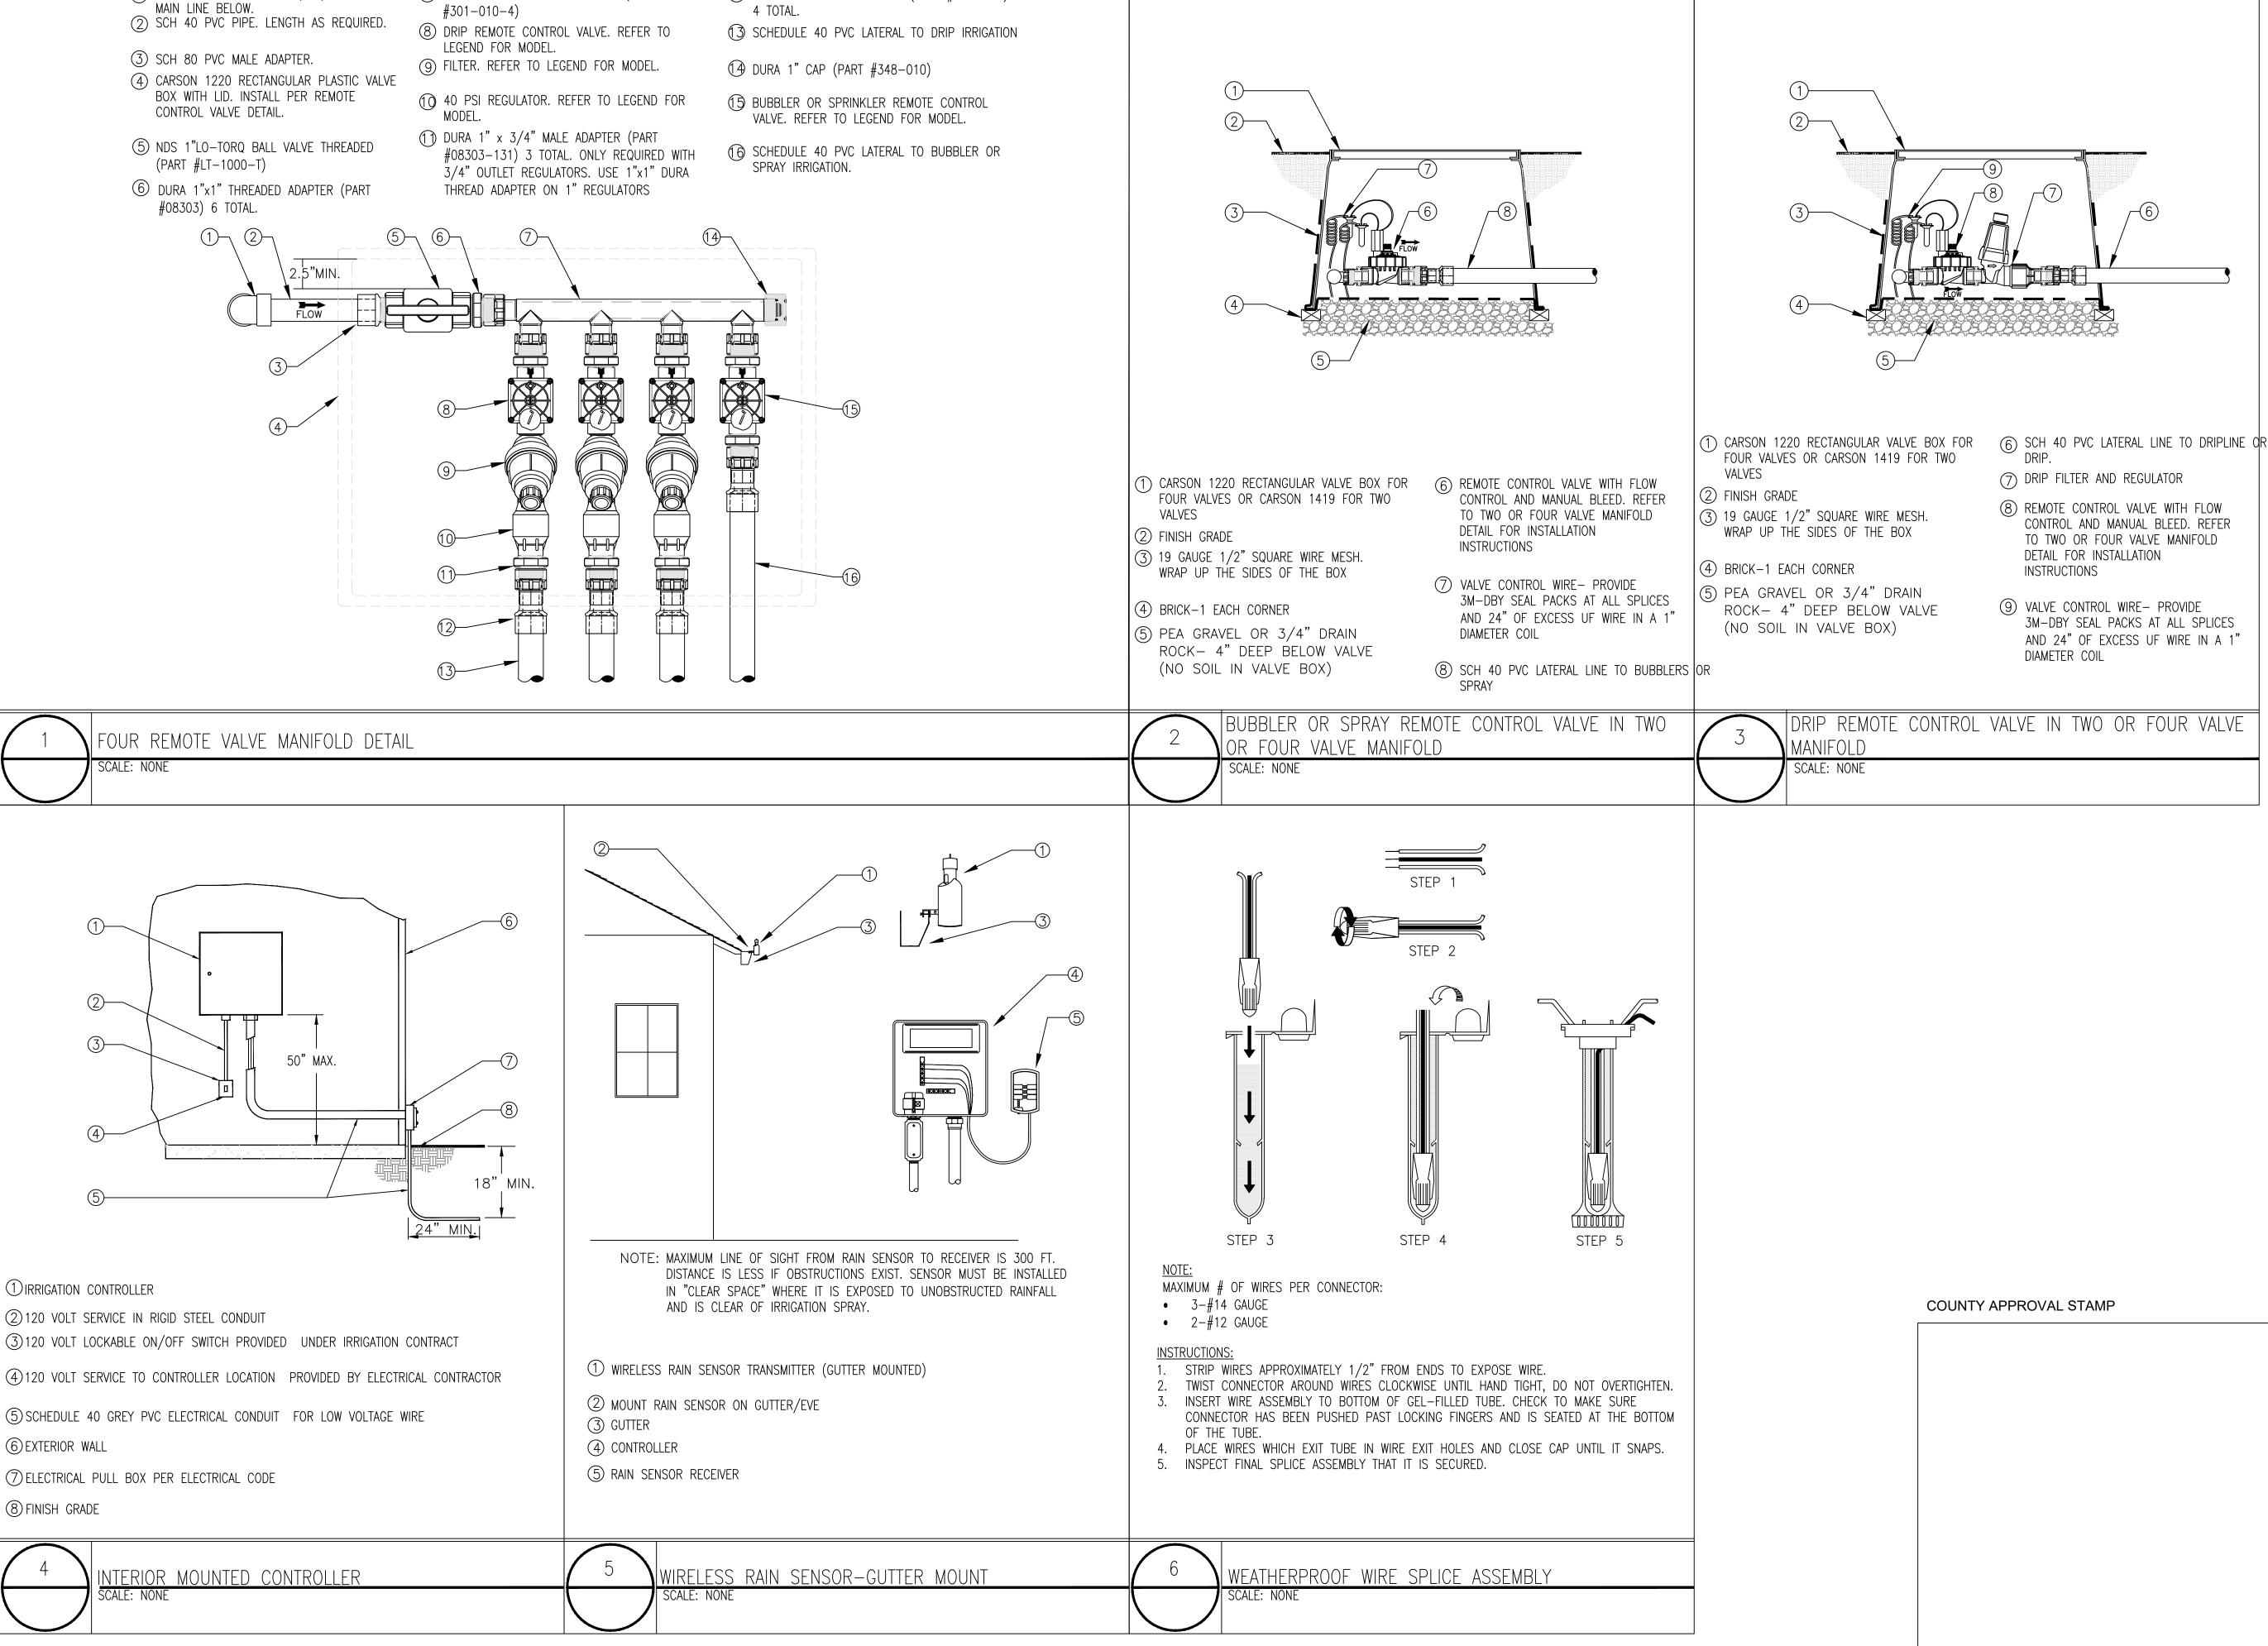

ARCHITECT:

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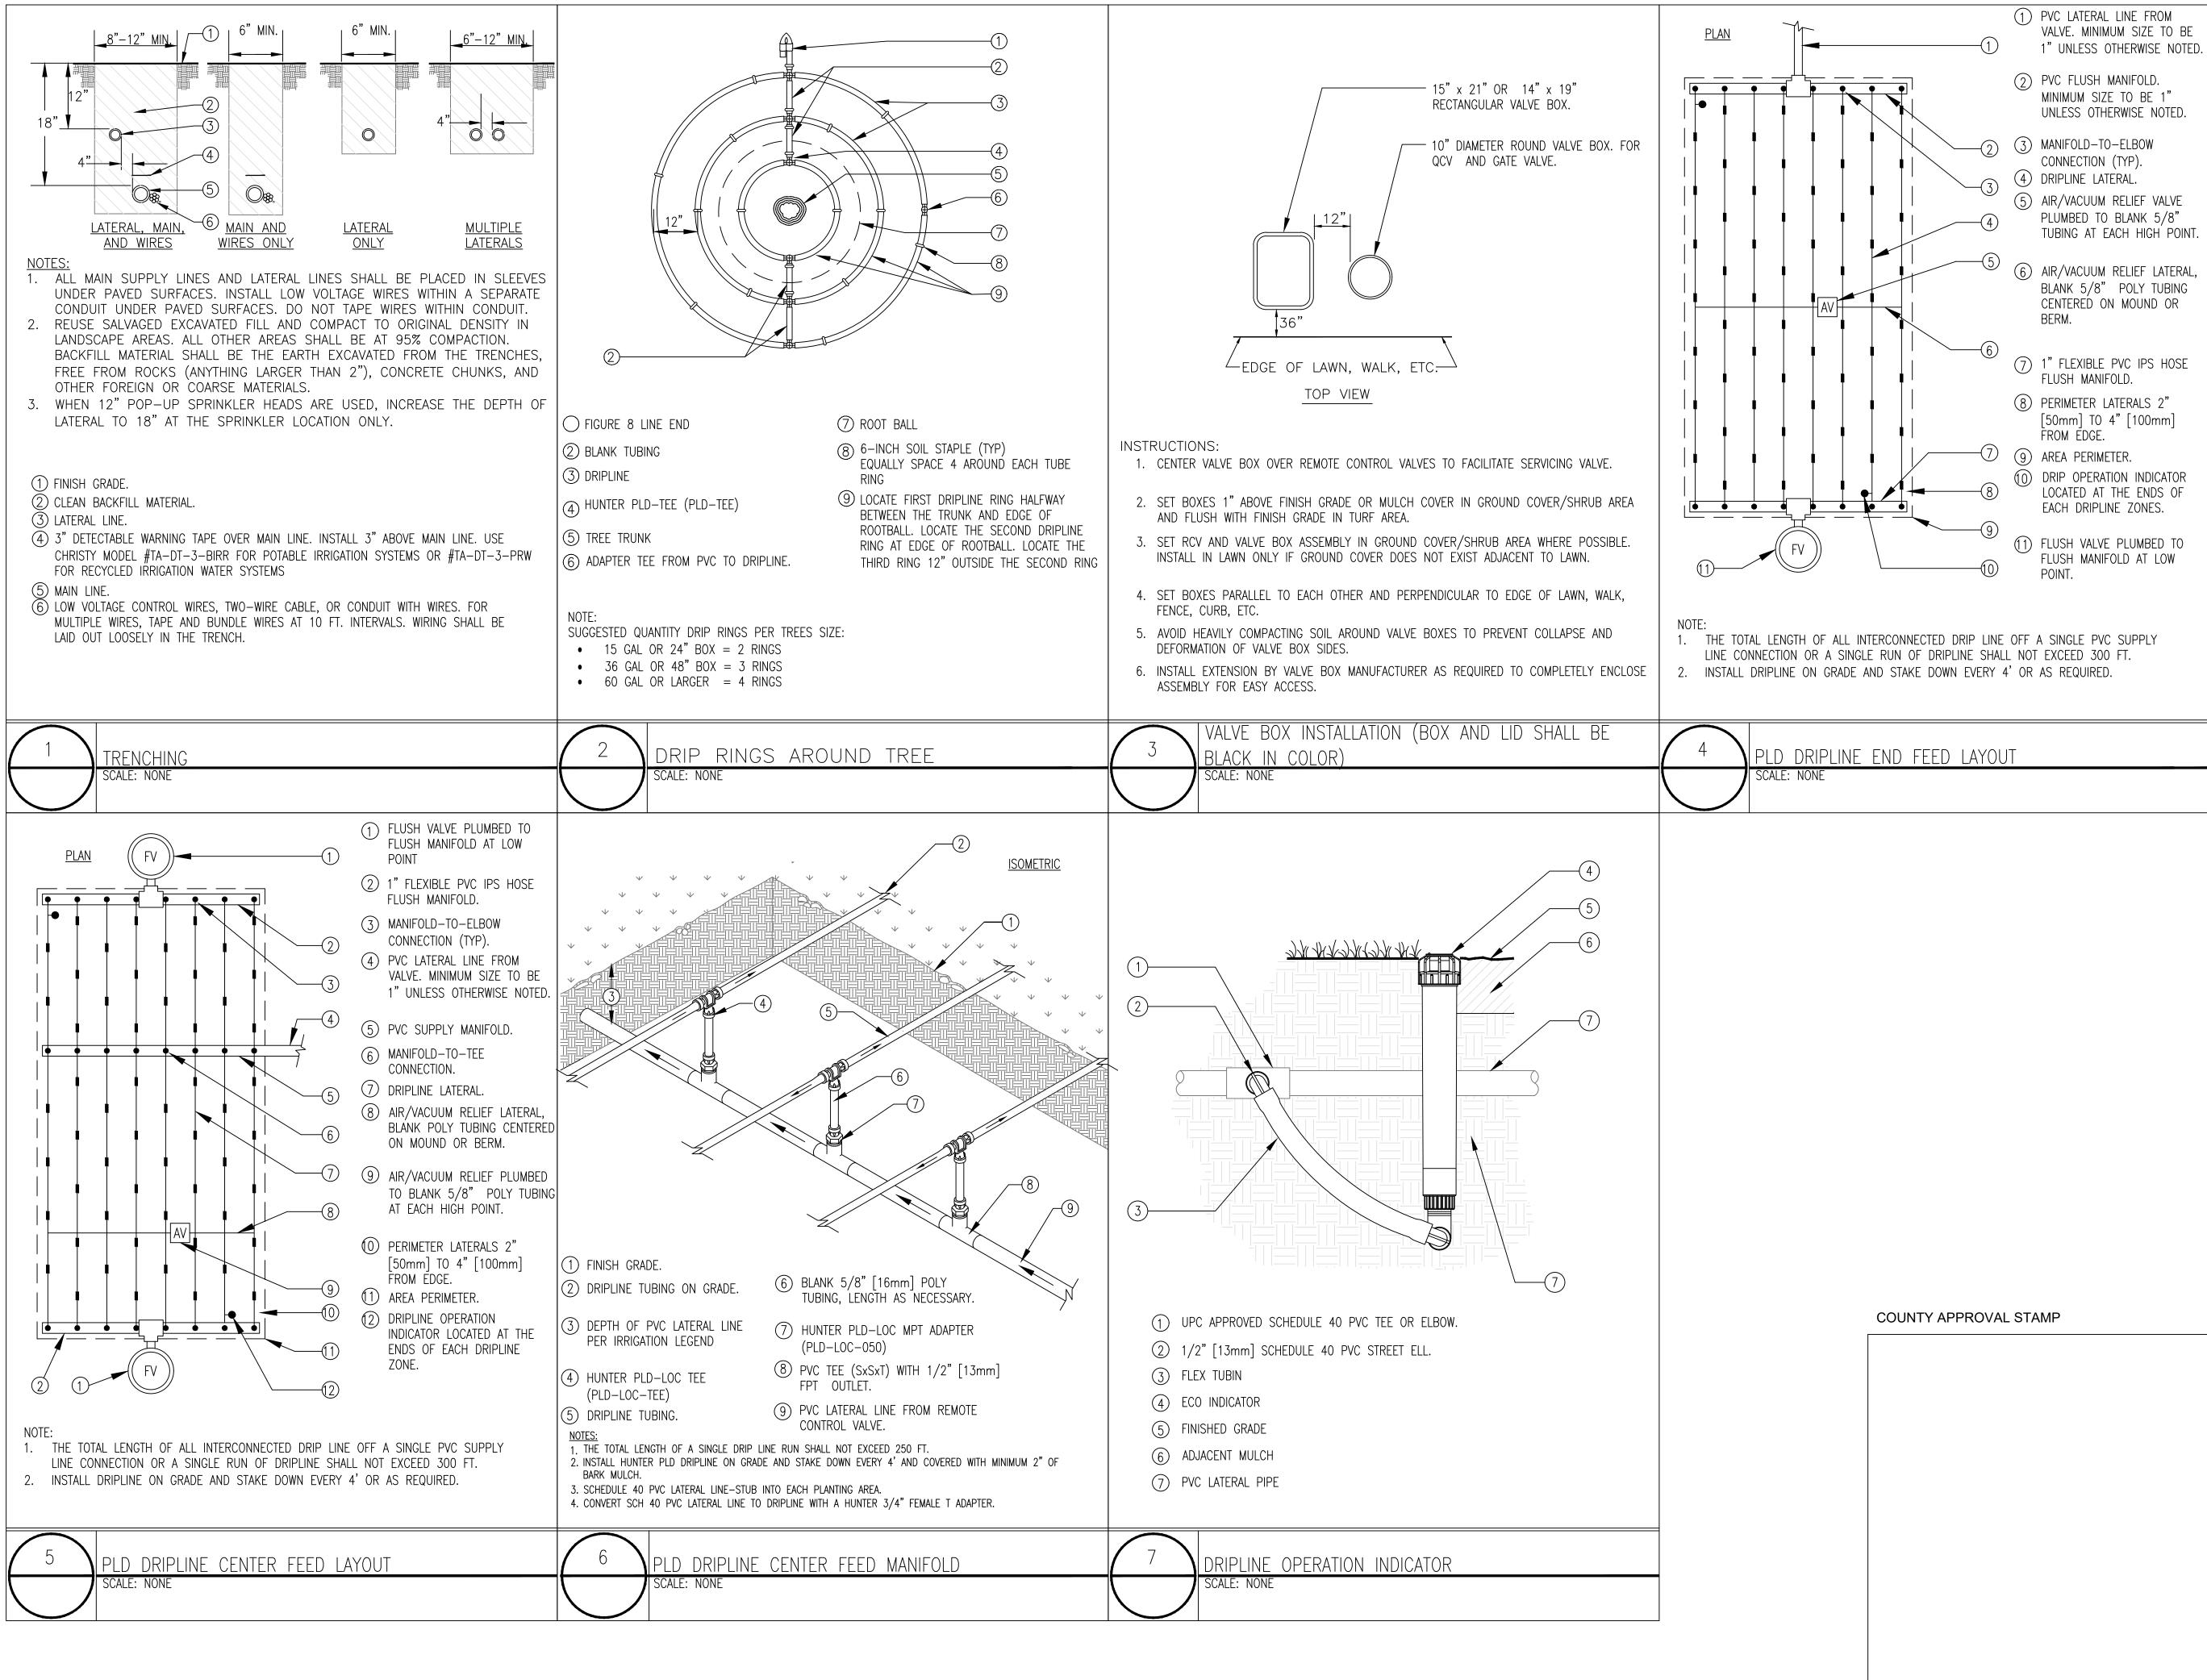
**IRRIGATION:** Russell D Mitchell & Associates, Inc. 2760 Camino Diablo, Walnut Creek, CA 94597

CLIENT:

100 Burlwood Drive, San Francisco, CA 94127

PROJECT NO: PROJECT NAME: APN: 036-031-280 PROJECT 10th St Montara, CA 94037 ADDRESS: PROJECT PHASE: 100% Schematic Design Jose Cruz DRAWN: CHECKED: 6/30/2021 **ISSUE DATE:** DRAWING TITLE: IRRIGATION DETAILS DRAWING NO: **IR-14** 

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#### ARCHITECT:

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CONSULTANT TEAM: STRUCTURAL/CIVIL: Design Everest, Inc. 365 Flower Lane, Mountain View, CA 94043

LANDSCAPE ARCHTECTURE: Tomas McKay: Architecture-Landscape Architecture 217 Bonita Avenue, Piedmont, CA 94611

**IRRIGATION:** Russell D Mitchell & Associates, Inc. 2760 Camino Diablo, Walnut Creek, CA 94597


CLIENT:

100 Burlwood Drive, San Francisco, CA 94127

PROJECT NO:	PROJECT NAME:	
APN:	036-031-280	
PROJECT ADDRESS:	10th St Montara, C/	A 94037
PROJECT PHASE	: 100% Sche	ematic Design
DRAWN:	Jose Cruz	CHECKED:
ISSUE DATE:	6/30/2021	
DRAWING TITLE:	IRRIGATION DE	ETAILS
DRAWING NO:	IR-15	

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NOTE: ALLOW A 12" MINIMUM OF PVC HOSE IN VALVE BOX IN ORDER TO DIRECT FLUSHED WATER OUTSIDE VALVE BOX.	
<ol> <li>FINISH GRADE</li> <li>1/2" SCH 40 THREADED BALL VALVE.</li> </ol>	SECTION/ELEVATION NOTE: USE ONE AIR/RELIEF VALVE FOR EVERY 7 LOCATE AT HIGH POINTS.
<ul> <li>3 1/2" SCH 40 MALE ADAPTER.</li> <li>4 6" ROUND PLASTIC VALVE BOX.</li> <li>5 1" IPS PVC HOSE FROM EXHAUST HEADER OR BLANK DRIP TUBING.</li> <li>6 PEA GRAVEL SUMP (6" DEEP).</li> <li>7 BRICK (1 OF 2)</li> </ul>	<ul> <li>1 1" ABOVE FINISH GRADE.</li> <li>FINISH GRADE.</li> <li>FINISH GRADE.</li> <li>6 PLD T</li> <li>7 PEA GR</li> <li>6 ROUND PLASTIC VALVE BOX. HEAT BRAND "AR" ON LID IN 1" HIGH CHARACTERS.</li> <li>HUNTER AIR/VACUUM RELIEF VALVE PLD-AVR.</li> <li>HUNTER 17mm BARB TEE X 3/4" ADAPTER (PLD-075-TBTEE)</li> </ul>
1 DRIPLINE-FLUSH POINT SCALE: NONE	2 AIR VACUUM RELIEF VALVE IN E SCALE: NONE



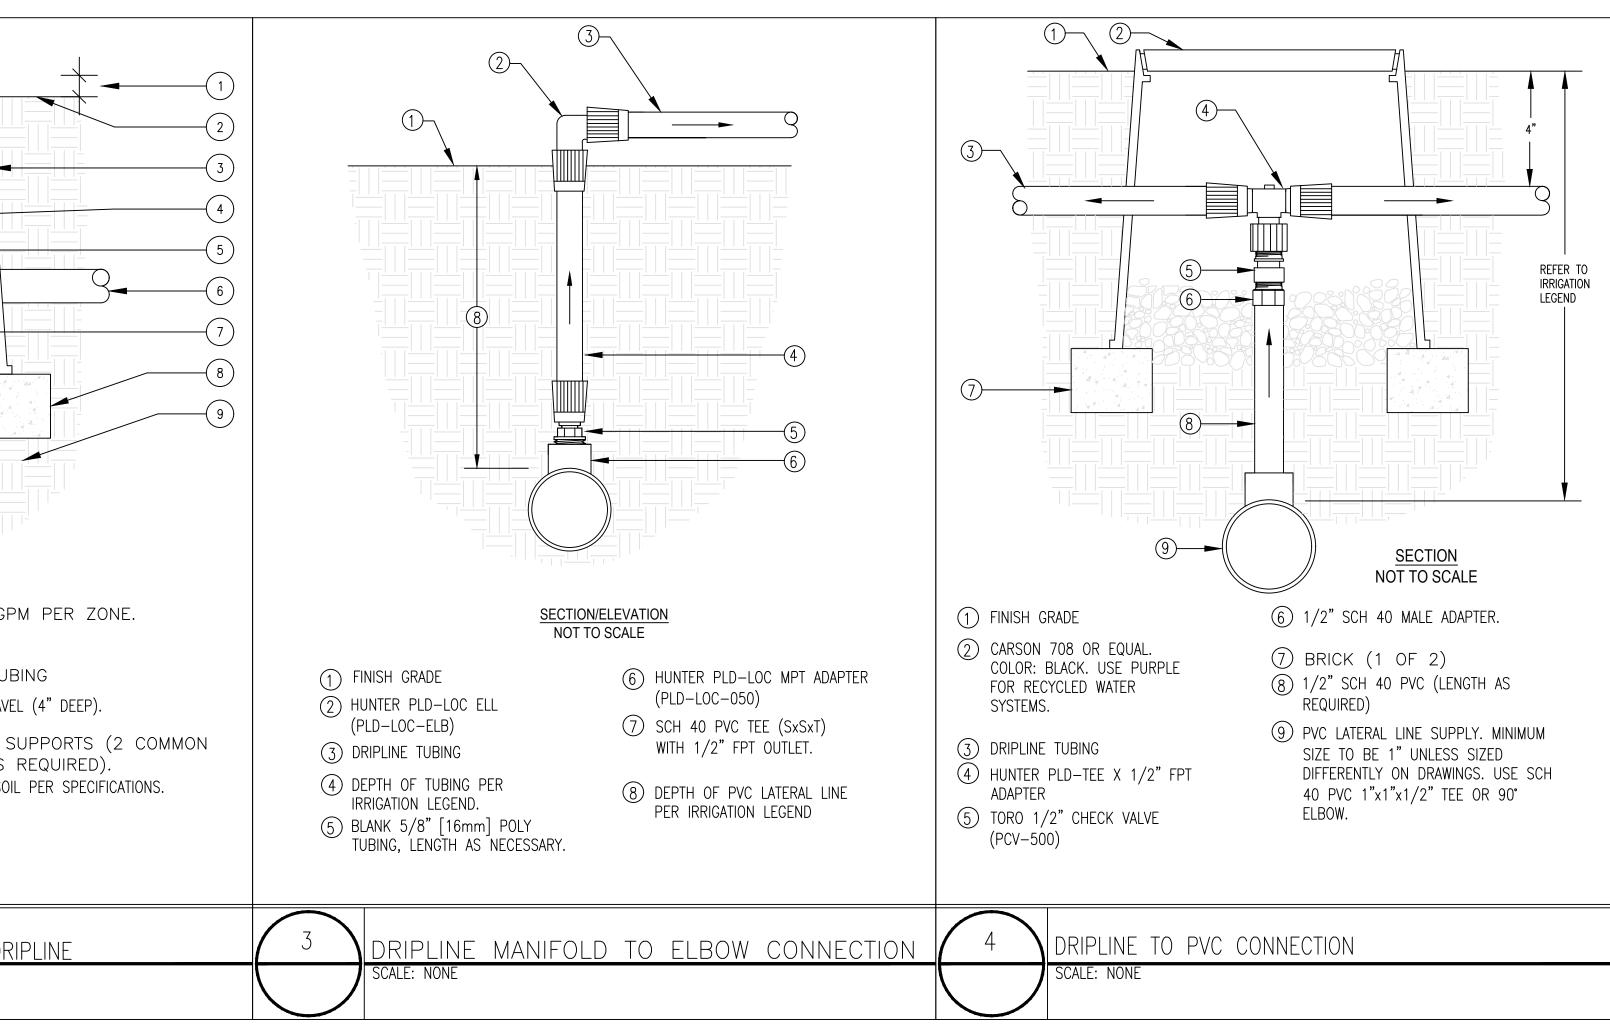

## **David Jaehning Architect**

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LANDSCAPE ARCHTECTURE: Tomas McKay: Architecture-Landscape Architecture 217 Bonita Avenue, Piedmont, CA 94611

IRRIGATION: Russell D Mitchell & Associates, Inc. 2760 Camino Diablo, Walnut Creek, CA 94597


CLIENT:

100 Burlwood Drive, San Francisco, CA 94127

COUNTY APPROVAL STAMP

PROJECT NO:	PROJECT NAME:	
APN:	036-031-280	
PROJECT ADDRESS:	10th St Montara, C	A 94037
PROJECT PHASE	:100% Sche	ematic Design
DRAWN:	Jose Cruz	CHECKED:
ISSUE DATE:	6/30/2021	
DRAWING TITLE:	IRRIGATION DE	ETAILS
DRAWING NO:	IR-16	
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REVISION: NO.

DESCRIPTION

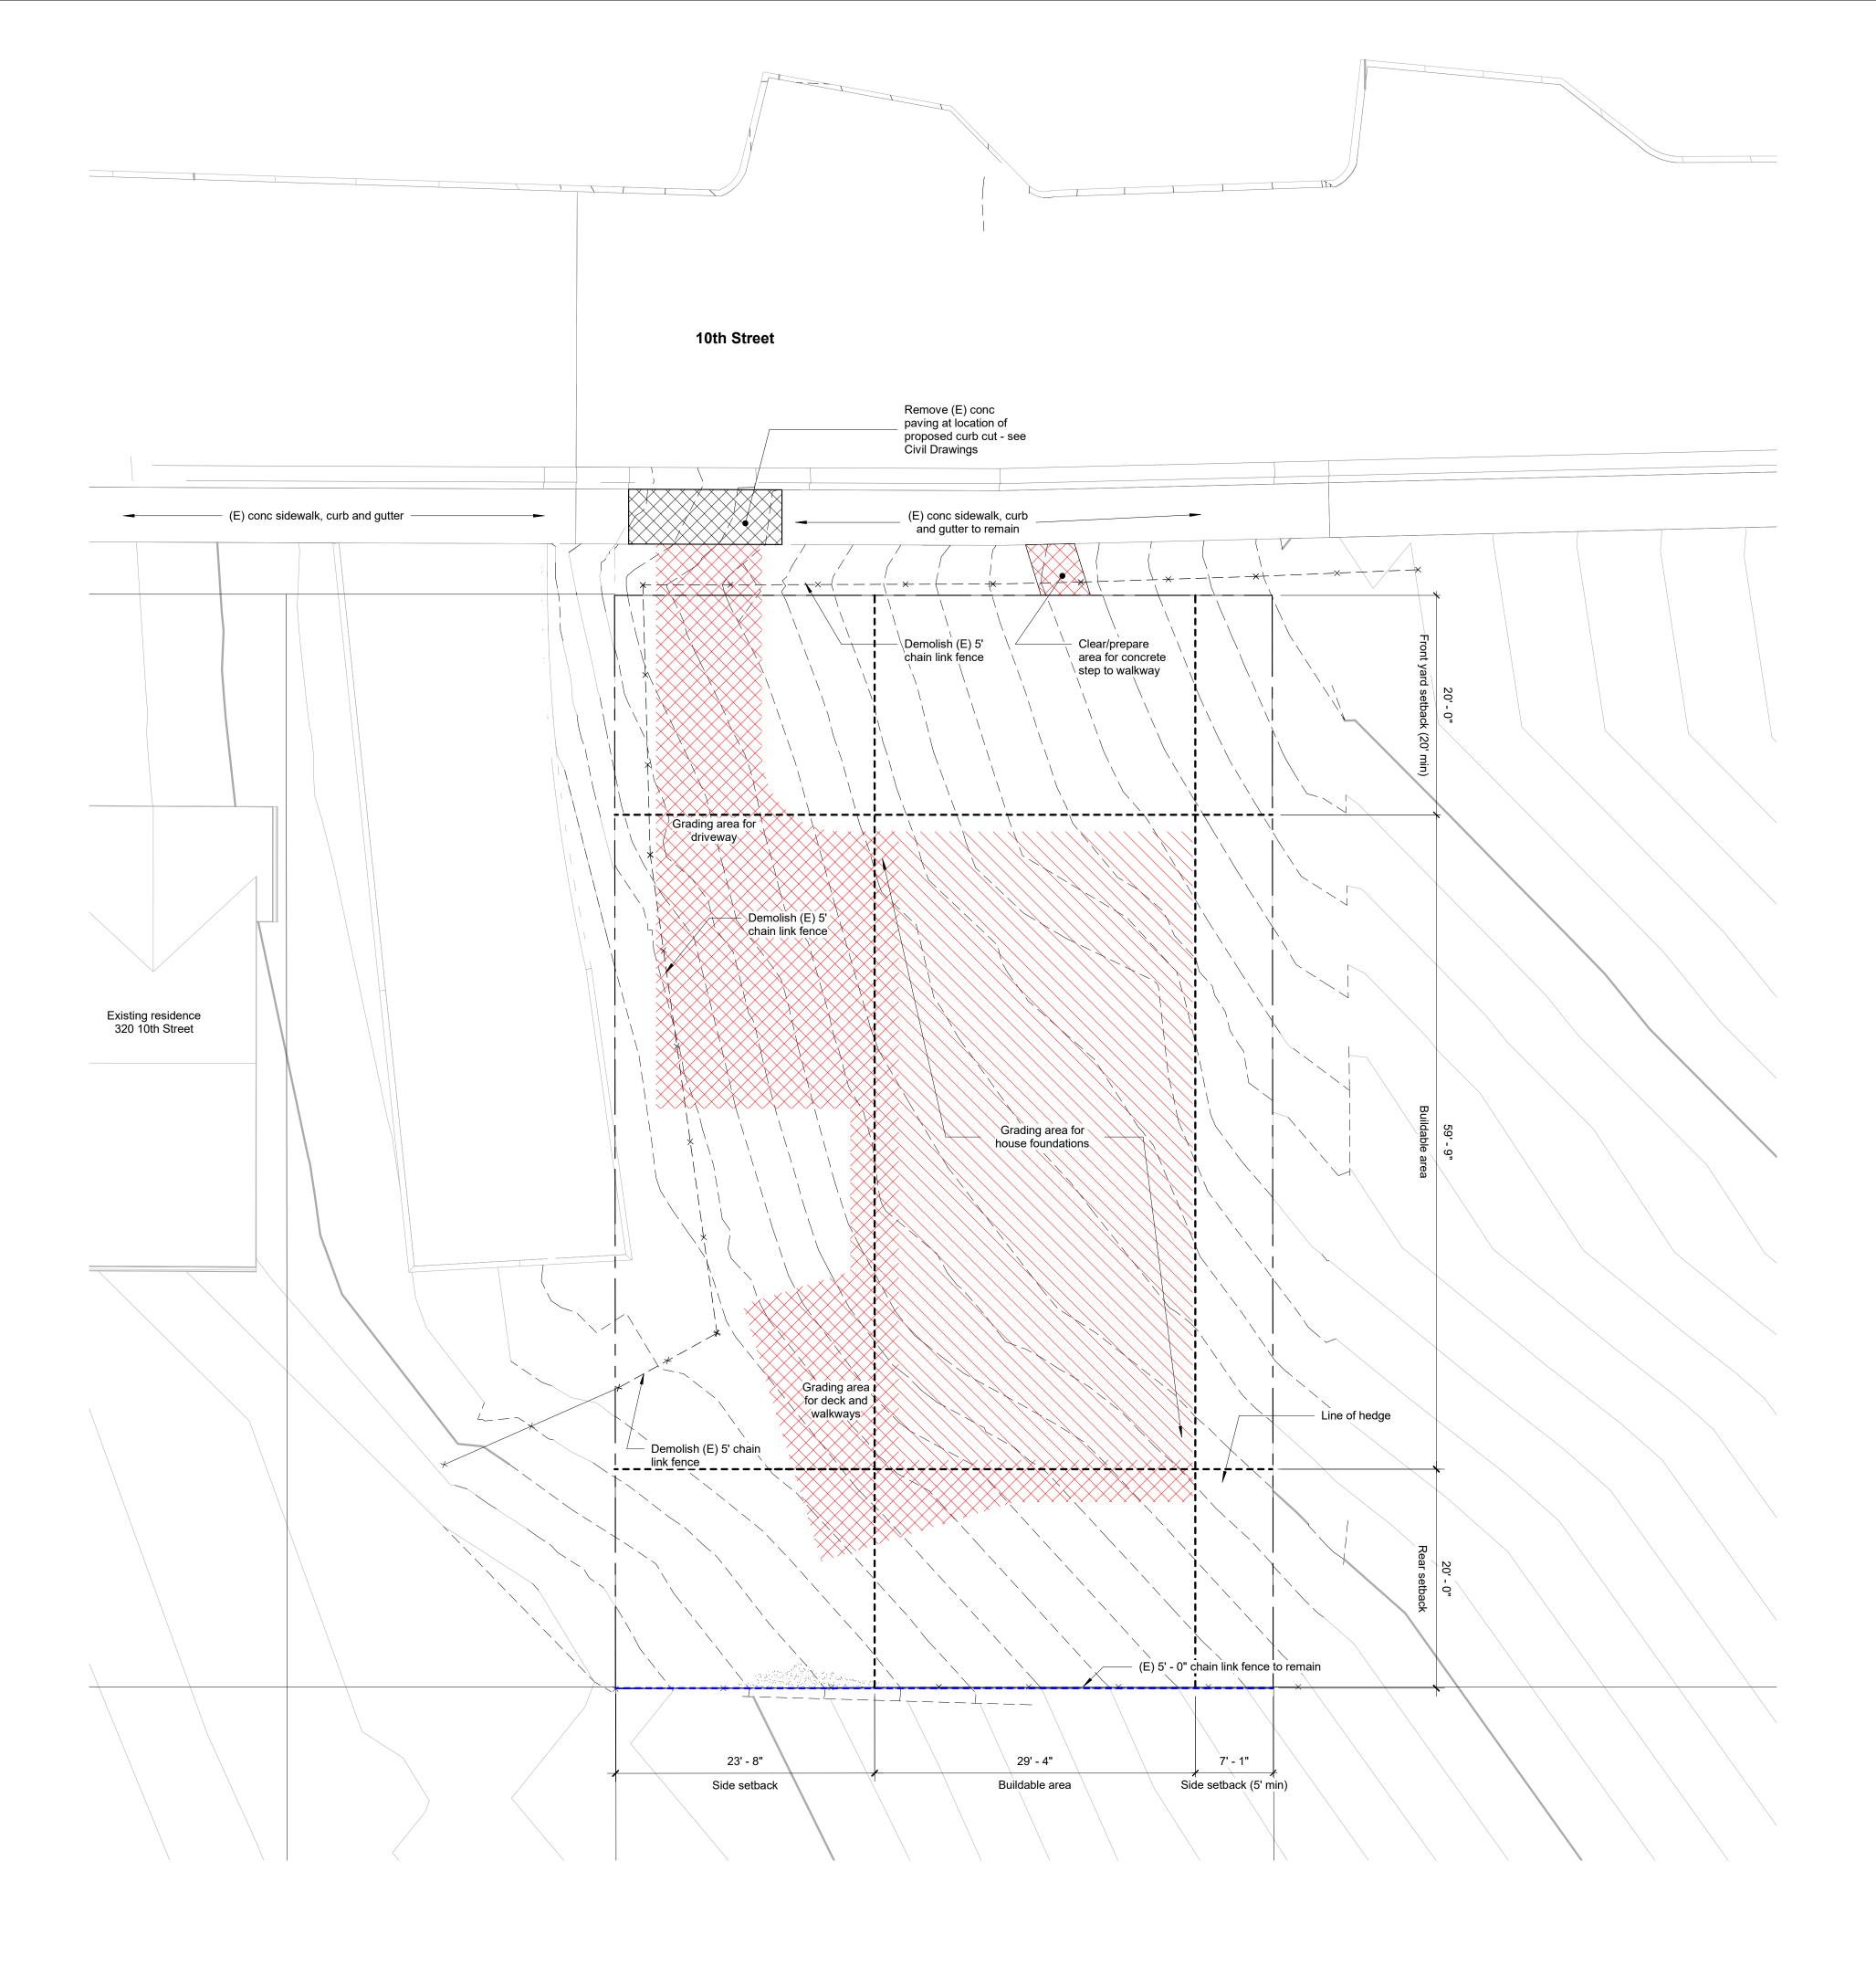DESIGN REVIEW APPLICATION PLN2021-00187 CYCLE 2 PLN2021-00187 CYCLE 3 DATE

5/11/2021 8/5/2021 12/21/2021

FOR REVIEW & FILING NOT FOR CONSTRUCTION

STAMP:



ARCHITECT:

### **David Jaehning Architect**

381 11th Street, San Francisco, California 94103

CONSULTANT TEAM: STRUCTURAL/CIVIL: Design Everest, Inc. 365 Flower Lane, Mountain View, CA 94043

LANDSCAPE ARCHTECTURE: Tomas McKay: Architecture-Landscape Architecture 217 Bonita Avenue, Piedmont, CA 94611

IRRIGATION: Russell D Mitchell & Associates, Inc. 2760 Camino Diablo, Walnut Creek, CA 94597

CLIENT:

#### Irene Chan-Jones and Bill Jones

100 Burlwood Drive, San Francisco, CA 94127

COUNTY APPROVAL STAMP

PROJECT NAME: PROJECT NO: 2101 House on a Hill 036-031-280 APN: 10th Street PROJECT Montara, CA 94037 ADDRESS: PROJECT PHASE: Construction Documents DRAWN: CHECKED AG Checker 2/16/2022 9:03:05 PM ISSUE DATE: DRAWING TITLE: **DEMOLITION SITE PLAN** DRAWING NO: A011

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#### **ELEMENT KEYNOTES**

VALUE DESCRIPTION

**REVISION:** 

NO.

2

3

DESCRIPTION

DATE

5/11/2021 8/5/2021 12/21/2021

Section 6300.2 Regulations for "S-17" Combining District (Midcoast)

The following regulations shall apply in any single-family residential district with which the "S-17" District is combined.

#### Building Site Width

The minimum building site width shall be an average of 50 feet. Building site is 60.07' wide

#### Building Site Area

The minimum building site area shall be 5,000 sq ft

Building site area is 5,995 sq ft ±

#### Building Setbacks

The minimum setbacks shall be: Front setback: 20 ft

Rear setback: 20 ft

Side setback: 5 ft if 16 ft in height or less; combined 15 ft if over 16 ft in height with

a minimum of 5 ft on any side

In any area where the "S-17" District is combined with the "DR" District, the minimum side yard setback may be reduced to provide for creative design concepts such as "zero" side yard setbacks provided that: (1) the Design Review Committee approves, (2) the application involves joint development of two or more adjacent parcels, (3) the total side yard requirement is met and (4) a minimum side yard of 5 feet is maintained adjacent to any parcel not included with the application.

#### Parcel Coverage

a. For structures 16 feet in height or less: 50%.

b. For structures greater than 16 feet in height: 35%.

Parcel coverage shall include all: (1) buildings, (2) accessory buildings, or (3) structures such as patios, decks, balconies, porches, bridges, and other similar uses which are eighteen (18) inches or more above the ground.

#### Building Floor Area

The maximum building floor area shall be established according to the parcel size: 5,000 - 11,968 sq ft = 0.53 of parcel size (or **3,177 sq ft**)

The maximum building floor area shall include the floor area of all stories of all buildings and accessory buildings on a building site. Maximum building floor area specifically includes:

(1) gross floor area of all stories, (2) the area of all decks, porches, balconies or other areas covered by a waterproof roof, which extends four (4) or more feet from exterior walls, (3) the area of all garages and carports.

#### Building floor area:

Ground floor (gross enclosed floor area, incl garage): 1,579 sf Second floor (gross enclosed floor area): 1,322 sf

Second floor unoccupied exterior setback area (269 sf) extends 2' - 6" (>4' - 0")

#### from the line of the exterior wall.

Total building floor area: **2,901 sf** (< 3,177 sf)

#### Impervious Surface Area.

The amount of parcel area covered by impervious structures less than eighteen inches (18") in height is limited to ten percent (10%) parcel size (not to exceed 1,170 sq. ft. for residential uses). Impervious structures include, but are not limited to, non-porous driveways, decks, patios, walkways and swimming pools.

Parcel size: 5,995 SF

Structures >16' in height: 1,576 SF= 26.22% (complies with 35% limit) 94 SF = 1.5% (complies with 10% limit) Hardscape: 1,670 SF (28%)

Driveway (pervious) area: 752 SF

COUNTY APPROVAL STAMP

FOR REVIEW & FILING **NOT FOR CONSTRUCTION** 

STAMP:



ARCHITECT:

### **David Jaehning Architect**

381 11th Street, San Francisco, California 94103

CONSULTANT TEAM: STRUCTURAL/CIVIL: Design Everest, Inc. 365 Flower Lane, Mountain View, CA 94043

LANDSCAPE ARCHTECTURE: Tomas McKay: Architecture-Landscape Architecture 217 Bonita Avenue, Piedmont, CA 94611

**IRRIGATION:** Russell D Mitchell & Associates, Inc. 2760 Camino Diablo, Walnut Creek, CA 94597

#### CLIENT:

#### Irene Chan-Jones and Bill Jones

100 Burlwood Drive, San Francisco, CA 94127

PROJECT NO:	PROJECT NAME	Ξ:
2101	House	on a Hill
APN:	036-031-280	
PROJECT ADDRESS:	10th Street Montara, CA 940	37
PROJECT PHASE	E Construc	tion Documents
DRAWN:	AG	CHECKED
ISSUE DATE:	2/16/2022 9:03:1	: 5 PM
DRAWING TITLE		RAL SITE PLAN
DRAWING NO:	A112	

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Section 6300.2 Regulations for "S-17" Combining District (Midcoast)

### **Building Height** The maximum building height shall be established, as follows:

a. Up to 30% Slope. Where the average slope of the parcel area covered by the main residence is less than 30%, maximum building

height is 28 feet. The average slope on the subject property is less than 30% - project is

governed by this height limit. b. 30% Slope or Greater. Where the average slope of the parcel area covered by the main residence is 30% or greater, maximum building height is 28 feet, unless increased by the Design Review Committee.


The Design Review Committee may increase the maximum building height to 33 feet for either: (1) The center 40% of the house, or

(2) The downslope wall. Where the downslope wall height limit is increased to 33 feet, maximum building height for the house shall be the plane formed by connecting the maximum upslope wall height (28 feet) with the maximum downslope wall height (33 feet).


Finished grade, measured at the outside face of exterior perimeter walls, shall not significantly deviate from the natural grade, to the satisfaction of the Design Review Committee.



### 1 E-W SITE SECTION AT HIGH RIDGE 1/8" = 1'-0" REF 4 - A251

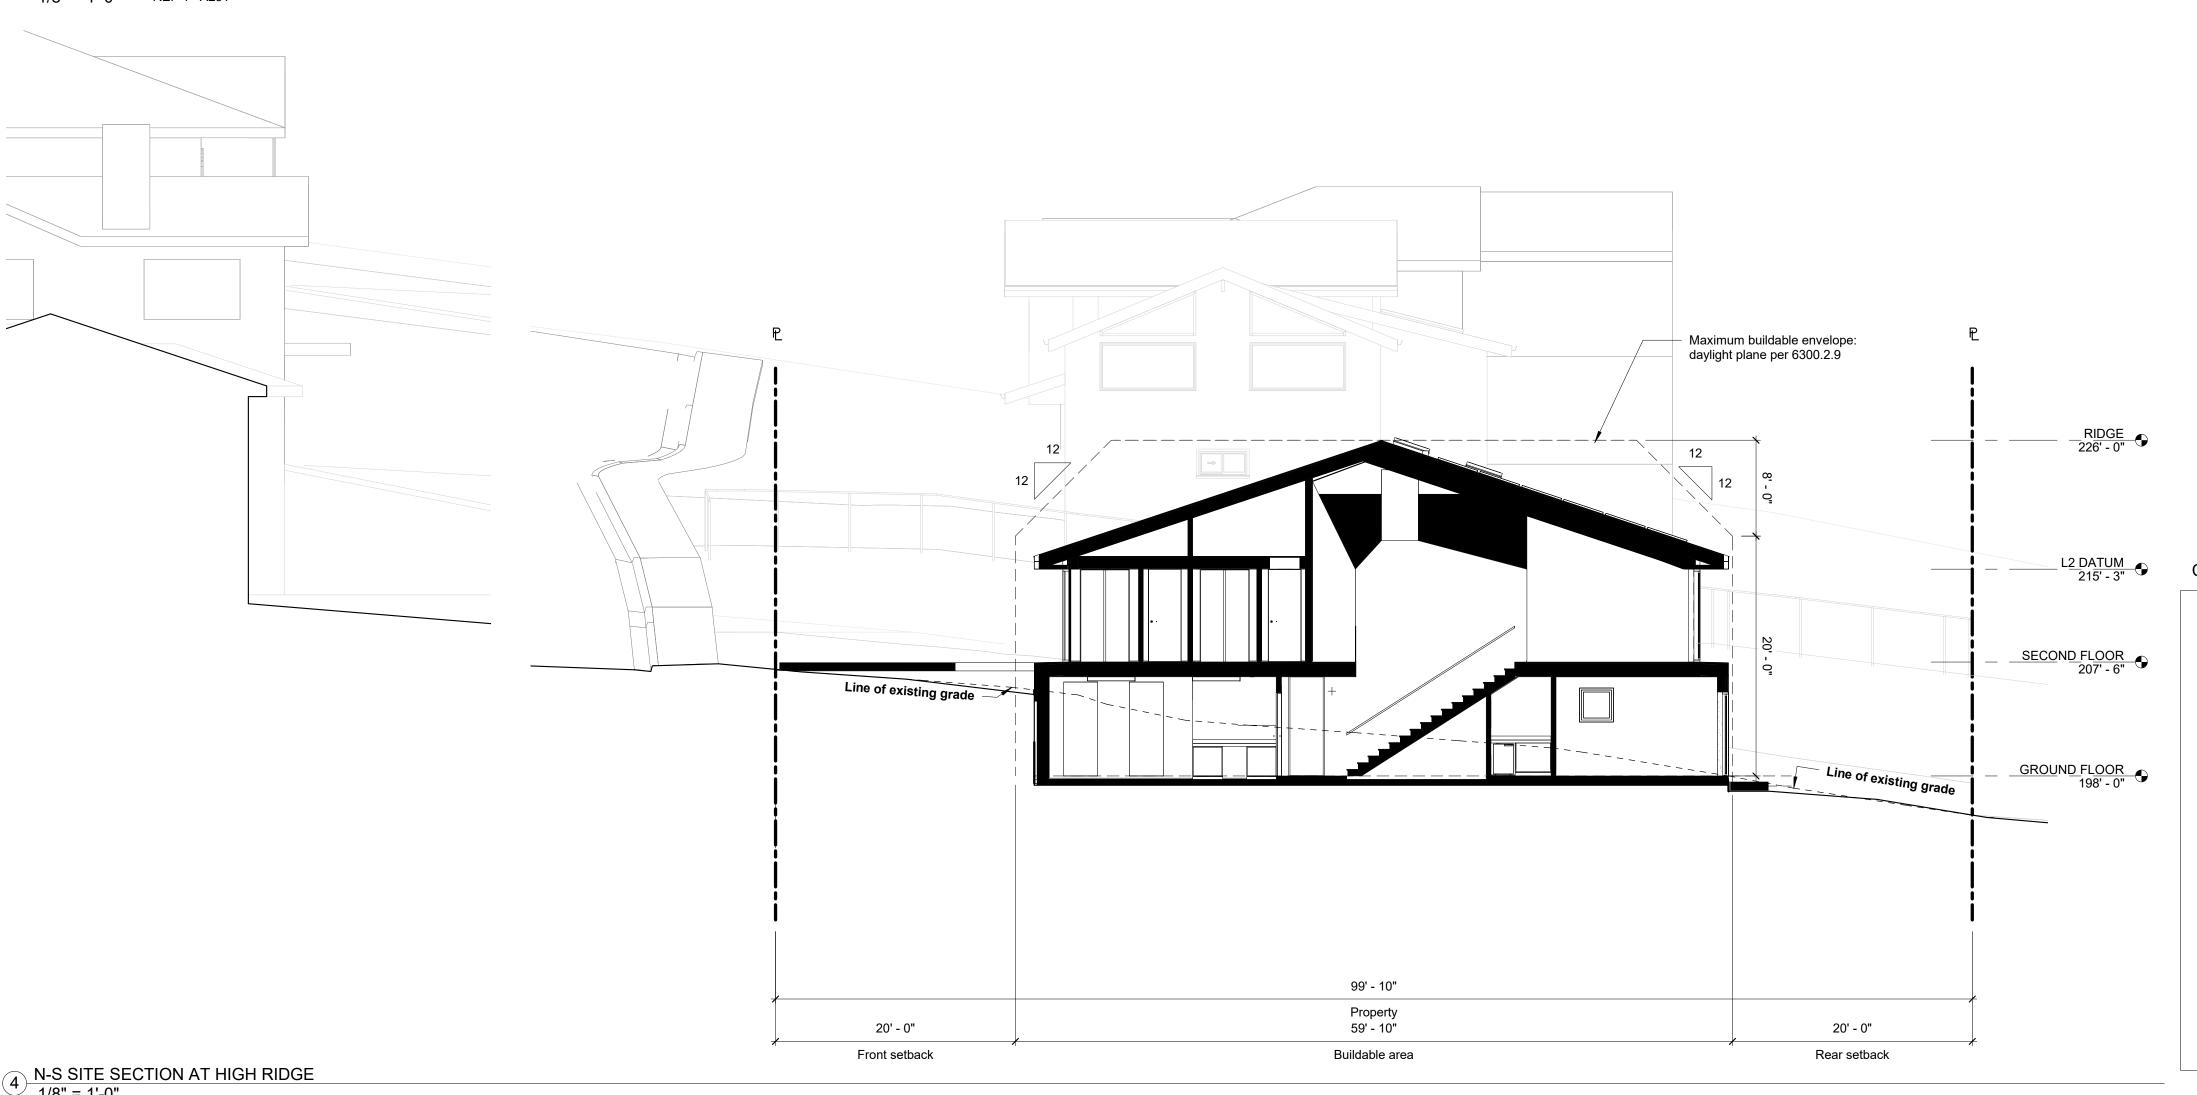

2 SECTION AT ENTRY WALKWAY 3/16" = 1'-0" REF 1 - A211

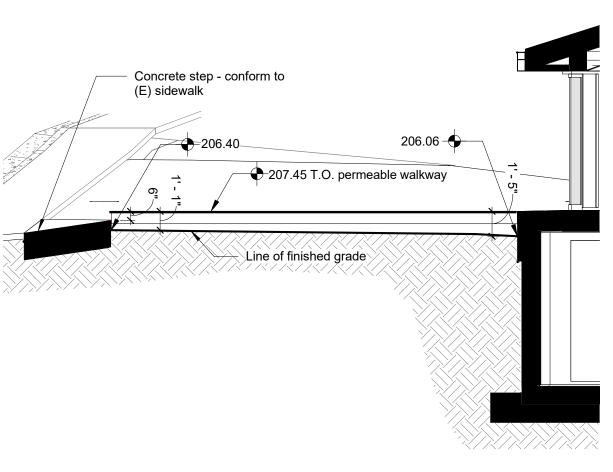

Building height shall be measured as the vertical distance from any point on the natural grade to the topmost point of the building immediately above.

### **REVISION**:

NO.	DESCRIPTION
1	DESIGN REVIEV
2	PLN2021-00187

DESIGN REVIEW APPLICATION PLN2021-00187 CYCLE 2 PLN2021-00187 CYCLE 3 COASTSIDE DESIGN REVIEW

DATE

5/11/2021 8/5/2021 12/21/2021 02/16/2022

### FOR REVIEW & FILING **NOT FOR CONSTRUCTION**

STAMP:



ARCHITECT:

### **David Jaehning Architect**

381 11th Street, San Francisco, California 94103

CONSULTANT TEAM: STRUCTURAL/CIVIL: Design Everest, Inc. 365 Flower Lane, Mountain View, CA 94043

LANDSCAPE ARCHTECTURE: Tomas McKay: Architecture-Landscape Architecture 217 Bonita Avenue, Piedmont, CA 94611

**IRRIGATION:** Russell D Mitchell & Associates, Inc. 2760 Camino Diablo, Walnut Creek, CA 94597

CLIENT:


#### **Irene Chan-Jones and Bill Jones**


100 Burlwood Drive, San Francisco, CA 94127

COUNTY APPROVAL STAMP

PROJECT NO:	PROJECT NAME	Ξ:			
2101	House	on a Hill	l		
APN:	036-031-280				
PROJECT ADDRESS:	10th Street Montara, CA 940	037			
PROJECT PHAS	PROJECT PHASE: Construction Documents				
DRAWN:	AG	CHECKED	Checker		
ISSUE DATE:	2/16/2022 9:03:1	7 PM			
DRAWING TITLE		RAL SITE SECTI	ONS		
DRAWING NO:	A113	8			
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#### ELEMENT KEYNOTES

- VALUE DESCRIPTION
- 12" CAST-IN-PLACE CONCRETE MAT SLAB 12" CAST-IN-PLACE CONCRETE WALL
- WATER HEATER
- 23 83 00.A1 WALL-MOUNTED HYDRONIC HEATING MODULE
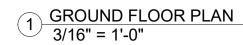
#### **REVISION**:

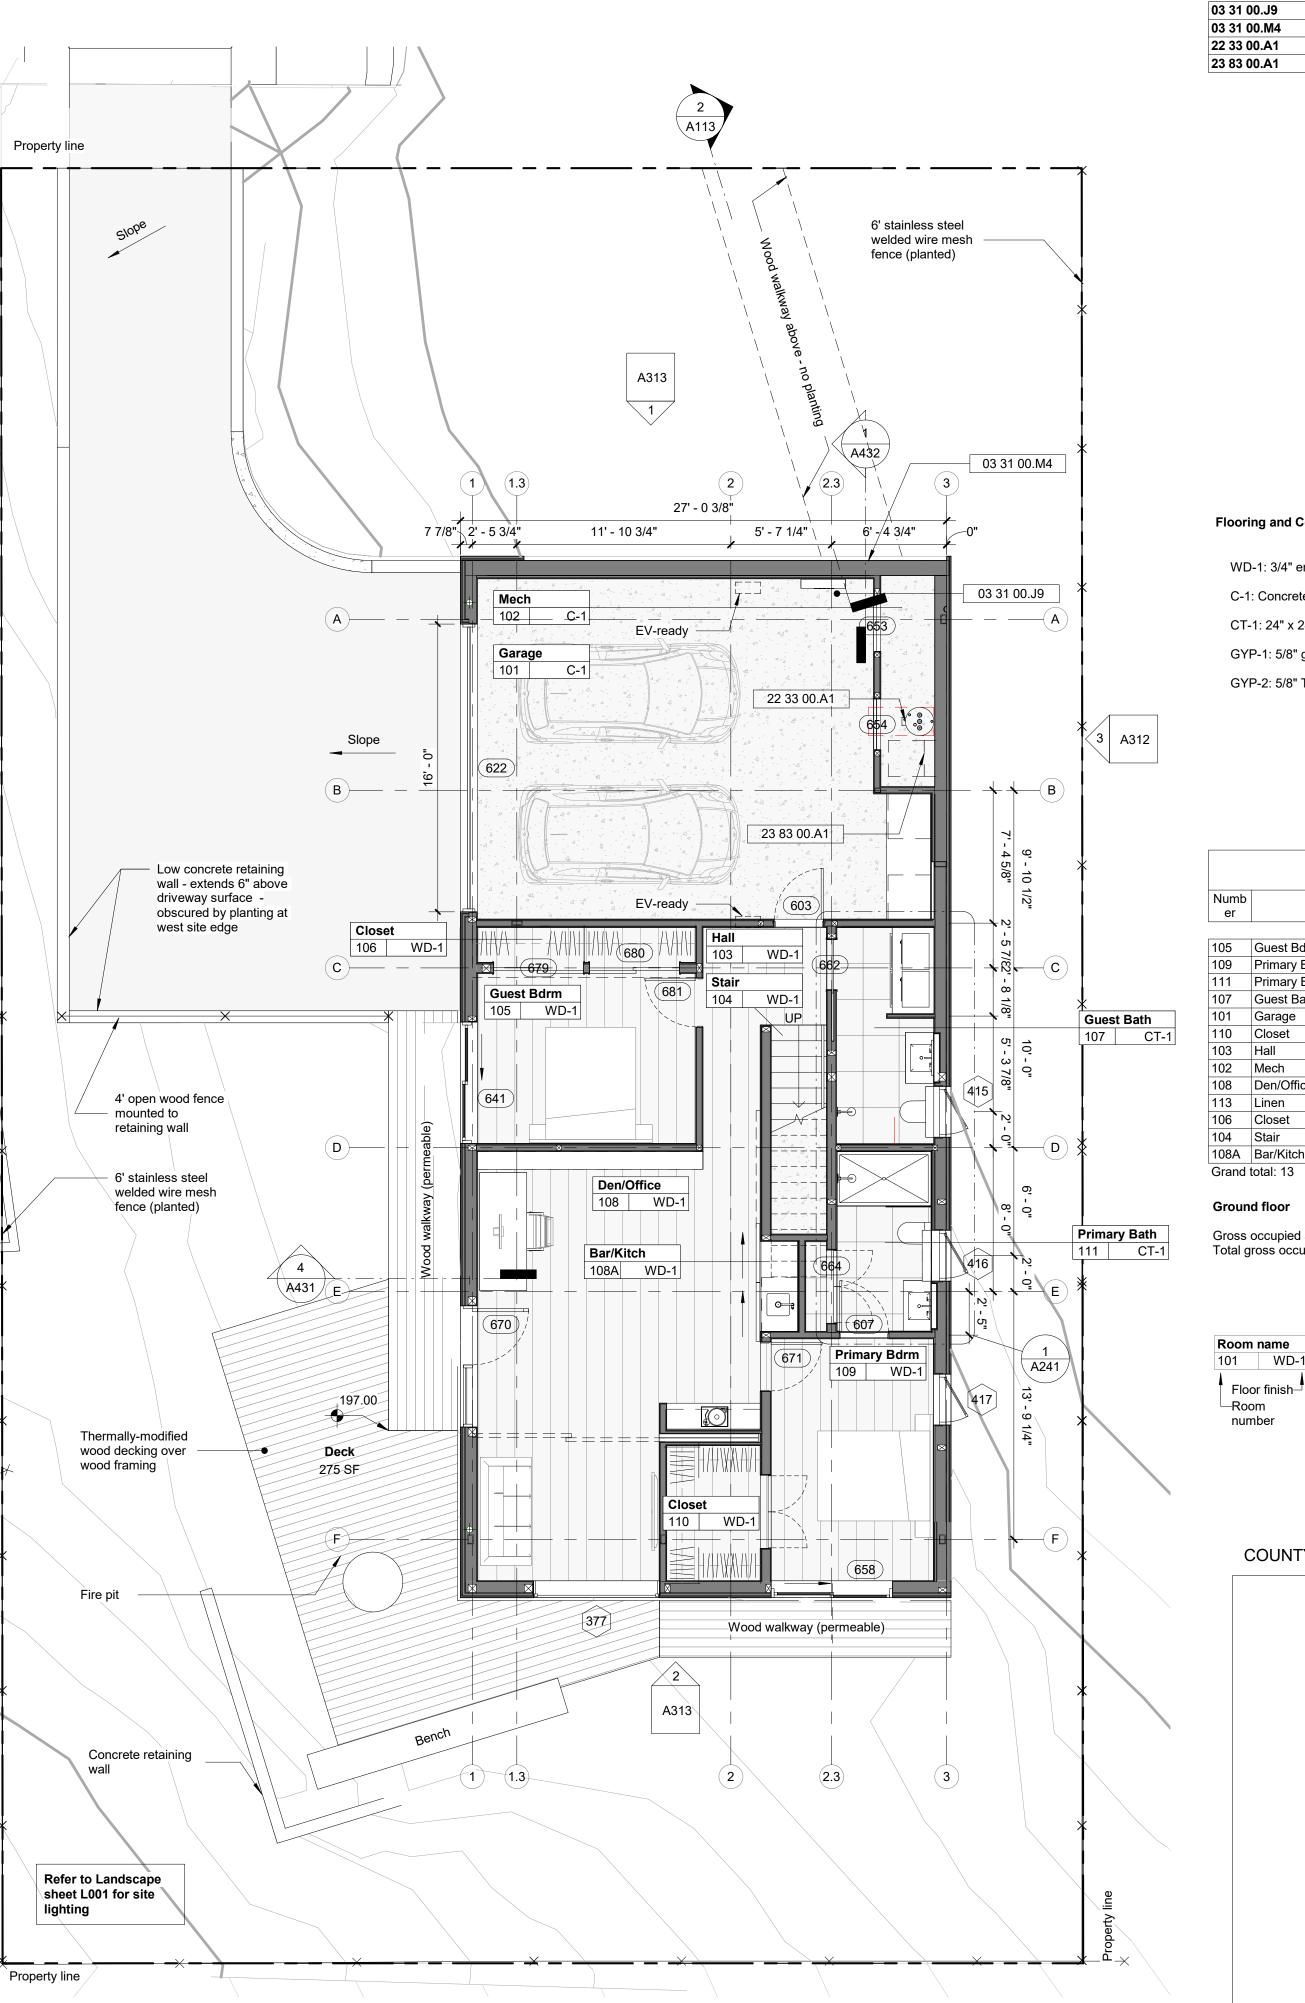NO.

2

3

DESCRIPTION

DESIGN REVIEW APPLICATION PLN2021-00187 CYCLE 2 PLN2021-00187 CYCLE 3

DATE

5/11/2021 8/5/2021 12/21/2021

#### Flooring and Ceiling Type Legend

WD-1: 3/4" engineered wide-plank oak flooring

C-1: Concrete slab-on-grade

CT-1: 24" x 24" ceramic tile

GYP-1: 5/8" gypsum board

GYP-2: 5/8" Type 'X' gypsum board

Area
128 SF
133 SF
55 SF
74 SF
460 SF
46 SF
68 SF
44 SF
353 SF
9 SF
32 SF
43 SF
12 SF
1457 SF


Gross occupied area: 1,579 sf Total gross occupied area (both floors): 2,901 sf

101 WD-1 Floor finish-

COUNTY APPROVAL STAMP

FOR REVIEW & FILING **NOT FOR CONSTRUCTION** 

STAMP:

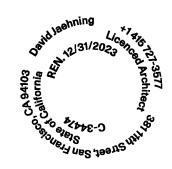

ARCHITECT:

### **David Jaehning Architect**

381 11th Street, San Francisco, California 94103

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LANDSCAPE ARCHTECTURE: Tomas McKay: Architecture-Landscape Architecture 217 Bonita Avenue, Piedmont, CA 94611


**IRRIGATION:** Russell D Mitchell & Associates, Inc. 2760 Camino Diablo, Walnut Creek, CA 94597


CLIENT:

#### Irene Chan-Jones and Bill Jones

100 Burlwood Drive, San Francisco, CA 94127

PROJECT NO:	PROJECT NAME	E	
2101	House	on a Hill	l
APN:	036-031-280		
PROJECT ADDRESS:	10th Street Montara, CA 940	37	
PROJECT PHAS	E: Construc	tion Docun	nents
DRAWN:	AG	CHECKED	Checker
ISSUE DATE:	2/16/2022 9:03:2	0 PM	
DRAWING TITLE	: GROUND FLO	OR PLAN	
DRAWING NO:	A211		
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#### ELEMENT KEYNOTES

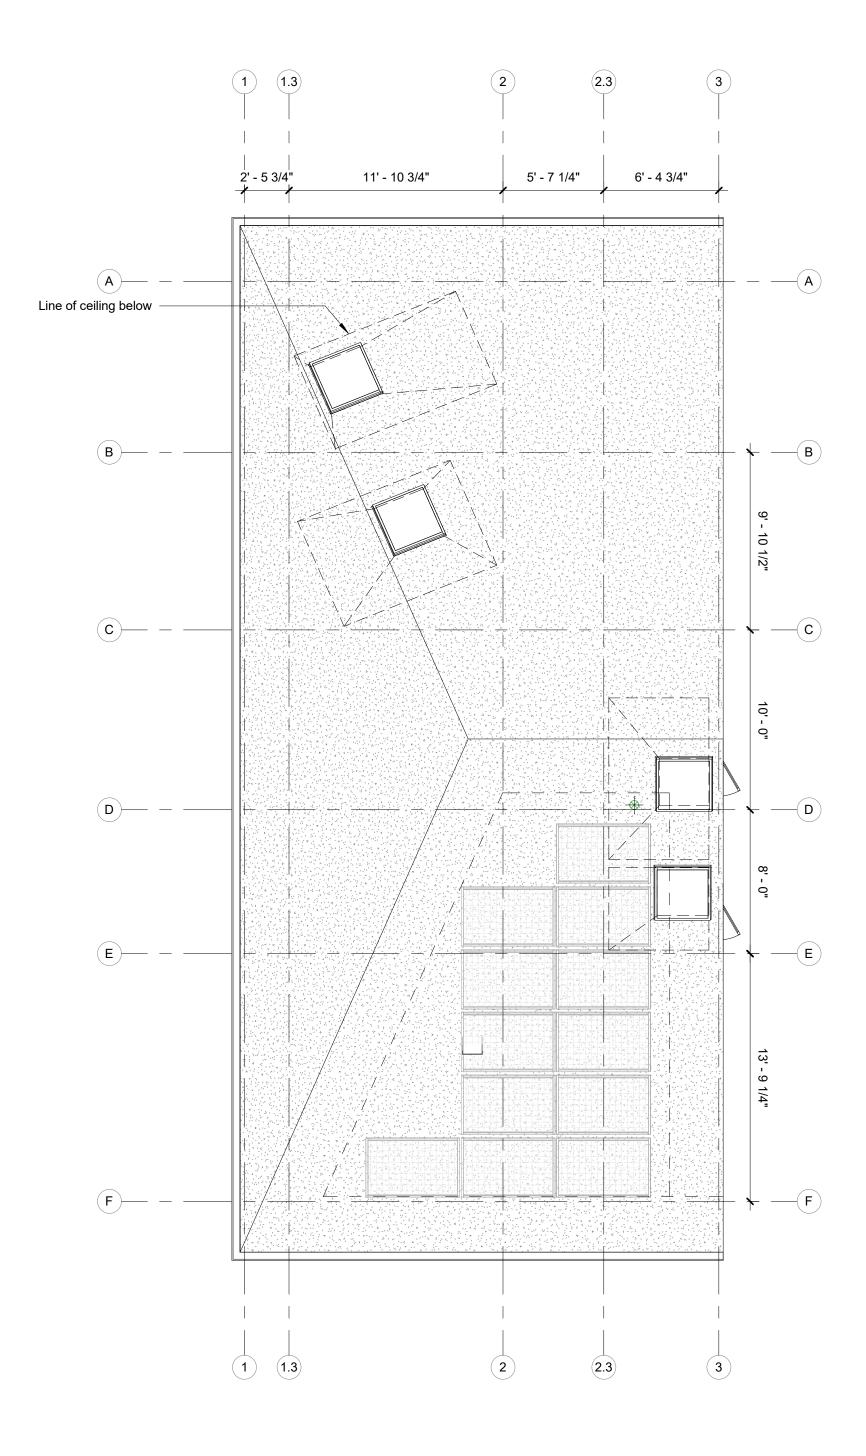VALUE DESCRIPTION

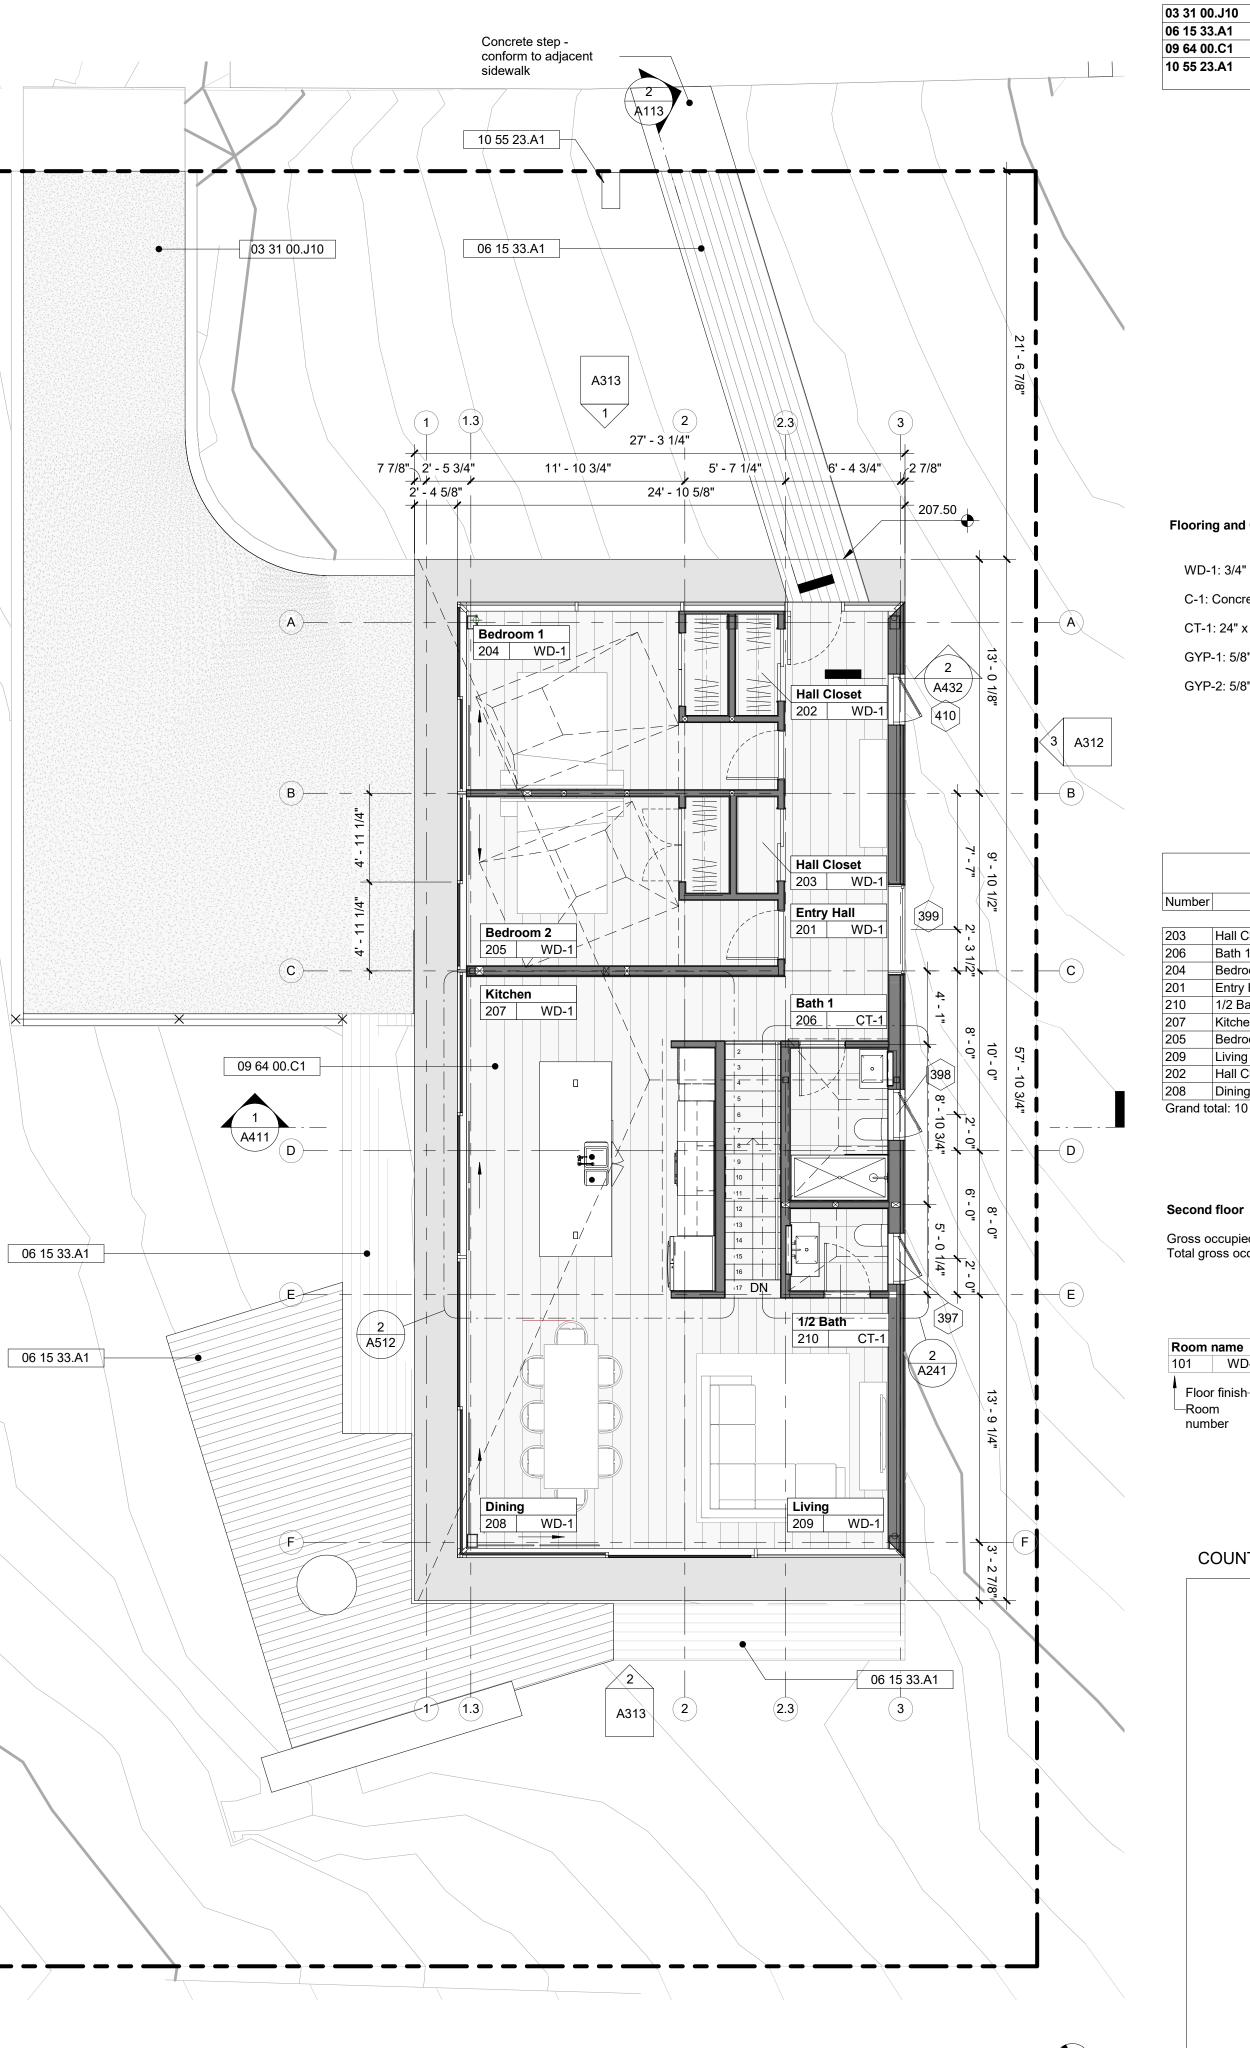0.J10	PERMEABLE CONCRETE DRIVEWAY - SEE CIVIL DETAILS
3.A1	THERMALLY MODIFIED 4" WOOD DECKING
0.C1	3/4" WIDE PLANK ENGINEERED OAK FLOORING
• • • • •	STAINLESS STEEL POST-MOUNTED MAILBOX WITH RAISED BUILDING ADDRESS NUMERALS

#### **REVISION**:

2

3

NO. DESCRIPTION

DESIGN REVIEW APPLICATION PLN2021-00187 CYCLE 2 PLN2021-00187 CYCLE 3

DATE

5/11/2021 8/5/2021 12/21/2021

### FOR REVIEW & FILING **NOT FOR CONSTRUCTION**

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ARCHITECT:

### **David Jaehning Architect**

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CLIENT:

#### Irene Chan-Jones and Bill Jones

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PROJECT NO:	PROJECT NAME	:	
2101	House	on a Hill	l
APN:	036-031-280		
PROJECT ADDRESS:	10th Street Montara, CA 9403	37	
PROJECT PHASI	E: Construct	ion Docun	nents
DRAWN:	AG	CHECKED	Checker
ISSUE DATE:	2/16/2022 9:03:30	PM	
DRAWING TITLE	SECOND FLOO	R PLAN & ROO	F PLAN
DRAWING NO:	A212		

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Flooring and Ceiling Type Legend

WD-1: 3/4" engineered wide-plank oak flooring

C-1: Concrete slab-on-grade

CT-1: 24" x 24" ceramic tile

GYP-1: 5/8" gypsum board


GYP-2: 5/8" Type 'X' gypsum board

	SECOND FLOOR AREAS				
r	Name	Area			
	Hall Closet	15 SF			
	Bath 1	46 SF			
	Bedroom 1	168 SF			
	Entry Hall	176 SF			
	1/2 Bath	25 SF			
	Kitchen	251 SF			
	Bedroom 2	161 SF			
	Living	210 SF			
	Hall Closet	16 SF			
	Dining	135 SF			
to	otal: 10 1204 SF				

Gross occupied area: 1,322 sf Total gross occupied area (both floors): 2,901 sf

101 WD-1 Floor finish-

COUNTY APPROVAL STAMP

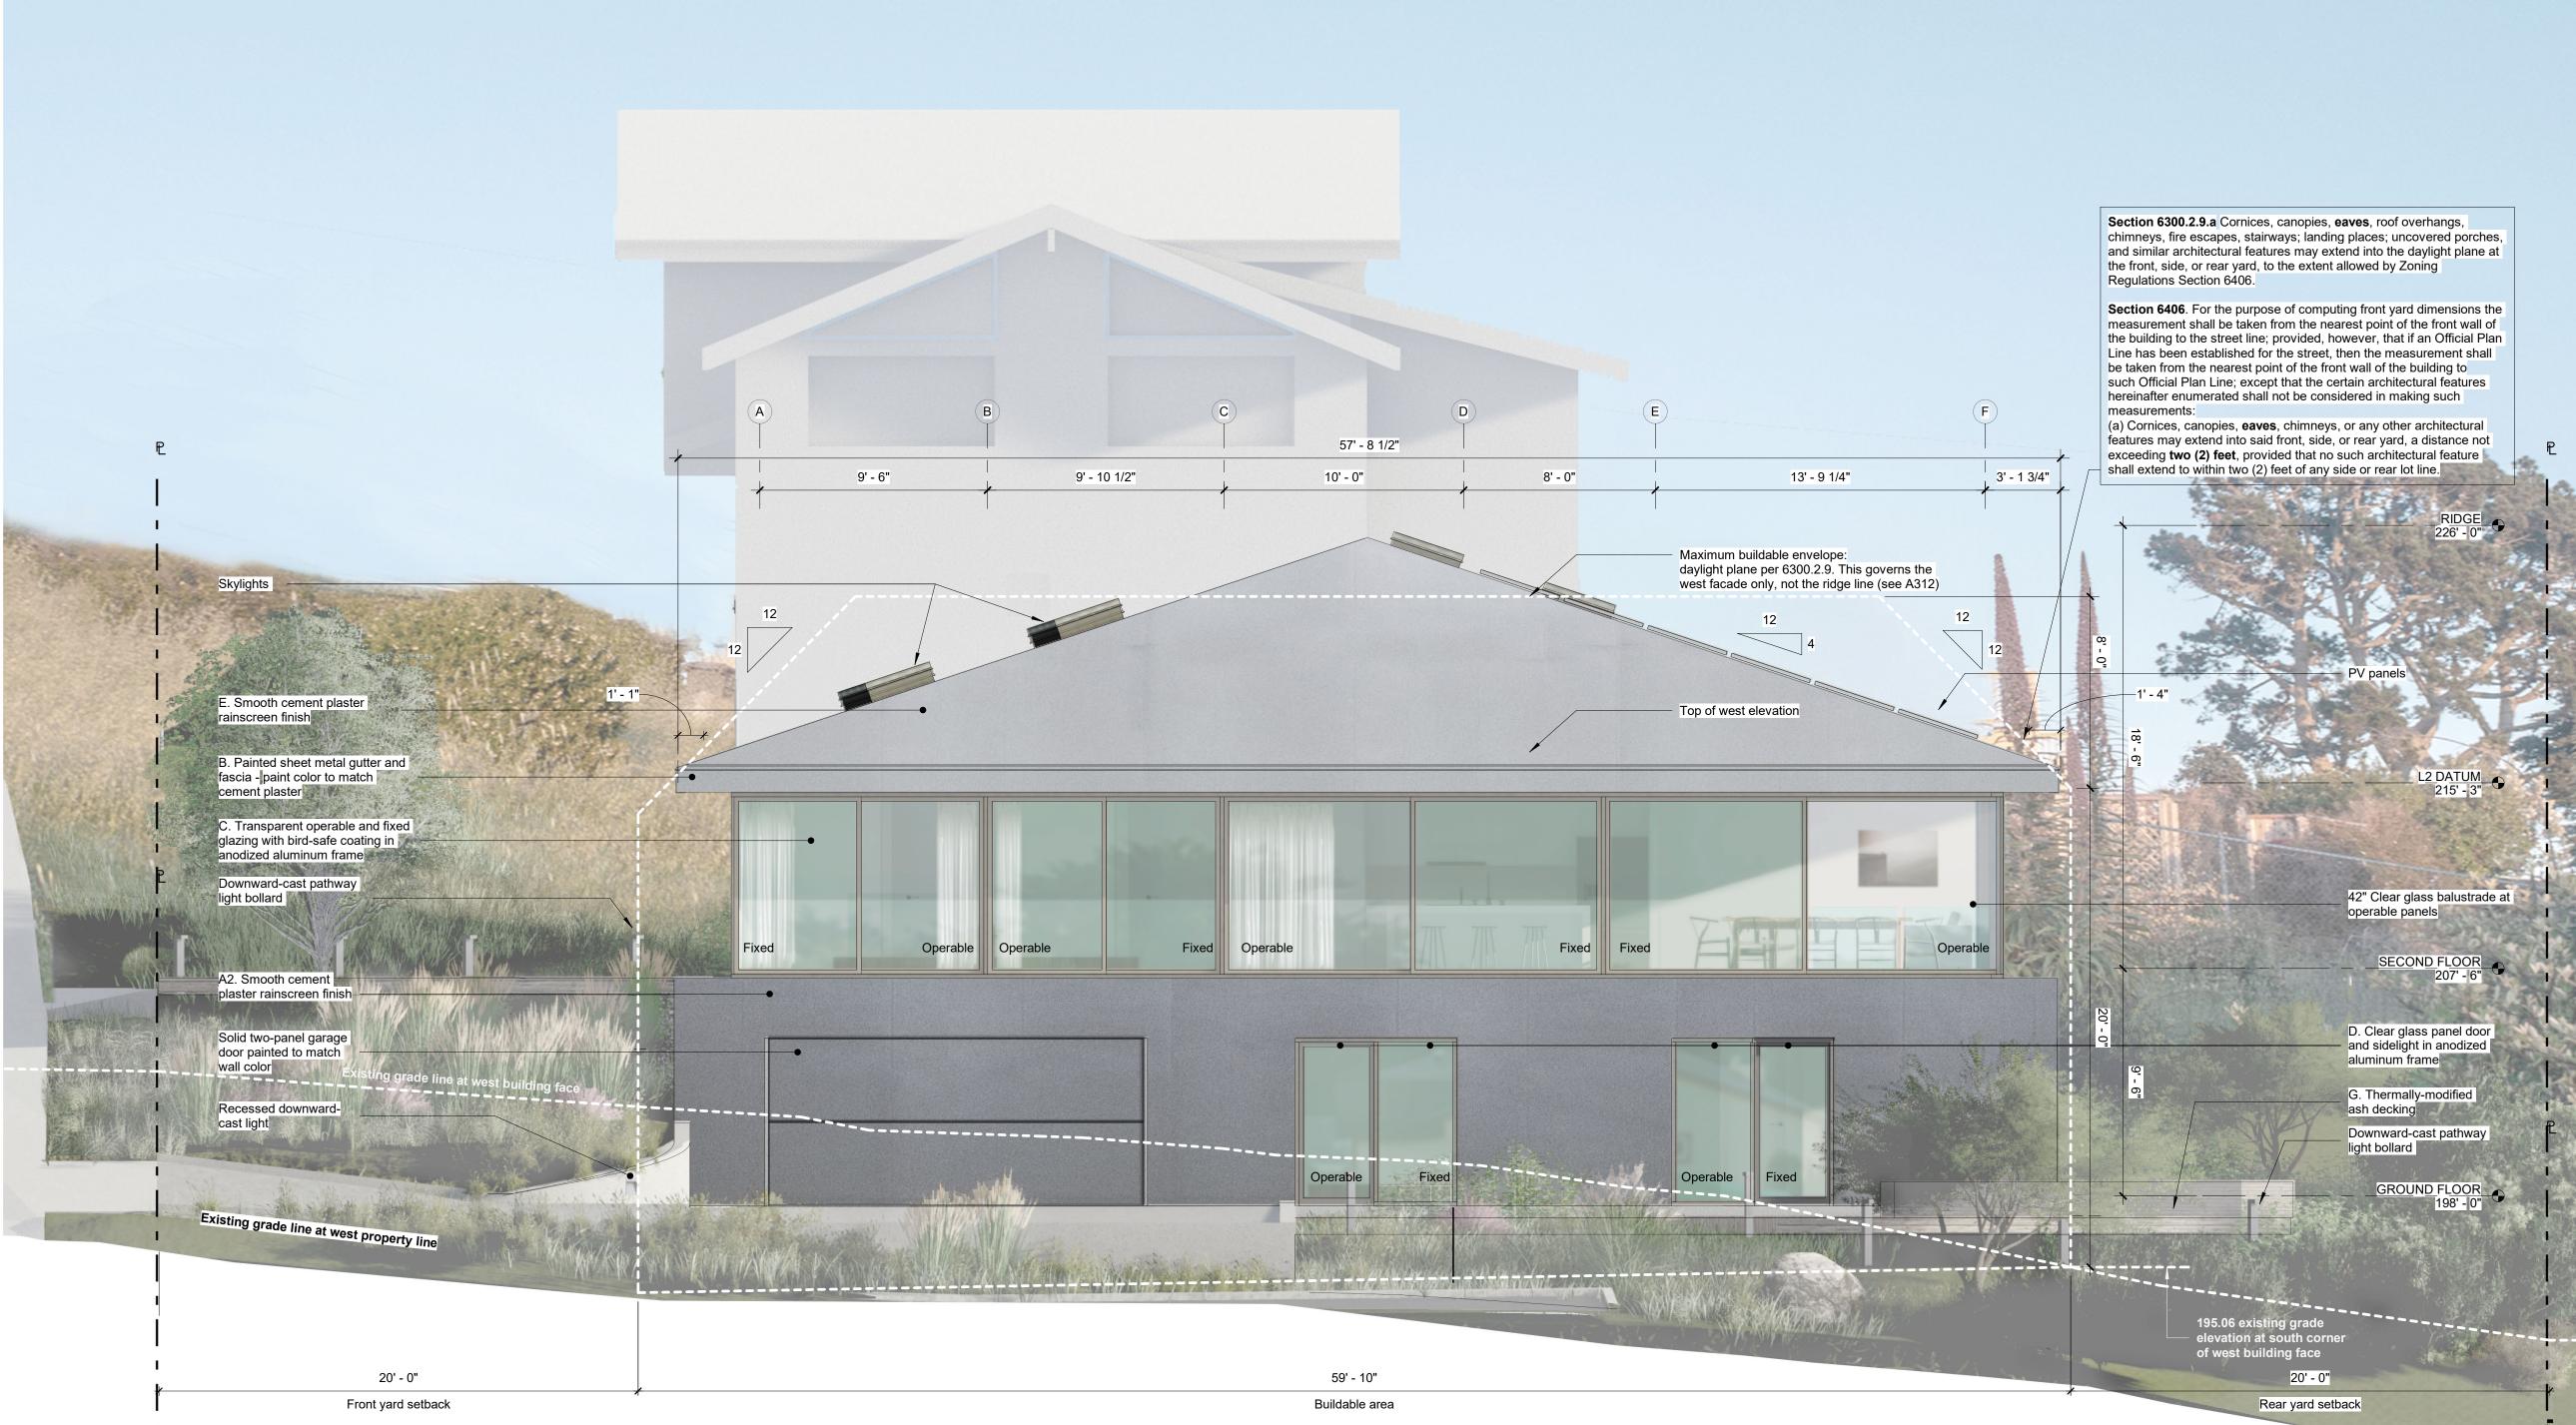

1 WEST ELEVATION 1/4" = 1'-0" REF 1 - A003


Building materials legend



A1. Exterior walls Elastomeric masonry coating over smooth cement plaster rainscreen: Sto StoColor Lastic elastomeric coating (StoColor 37302)




A2. Exterior walls Elastomeric masonry coating over smooth cement plaster rainscreen: Sto StoColor

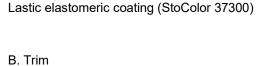


Elastomeric coating over sheet metal: Sto StoColor Lastic elastomeric coating (StoColor 37304)

C. Window frames Anodized aluminum: C31 Bronze Anodized (Reynaers)

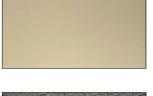





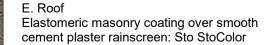

Anodized (Reynaers)

D. Doors

cement plaster rainscreen: Sto StoColor Lastic elastomeric coating (StoColor 37302)

G. Decks and railings Thermally-modified ash decking

Anodized aluminum: C31 Bronze

I. Retaining walls Reinforced poured concrete - light sandblast finish

#### **REVISION:**

NO.

DESCRIPTION

DESIGN REVIEW APPLICATION PLN2021-00187 CYCLE 2 PLN2021-00187 CYCLE 3 COASTSIDE DESIGN REVIEW

5/11/2021 8/5/2021

DATE

12/21/2021 02/16/2022

### FOR REVIEW & FILING **NOT FOR CONSTRUCTION**

STAMP:



ARCHITECT:

### **David Jaehning Architect**

381 11th Street, San Francisco, California 94103

CONSULTANT TEAM: STRUCTURAL/CIVIL: Design Everest, Inc. 365 Flower Lane, Mountain View, CA 94043

LANDSCAPE ARCHTECTURE: Tomas McKay: Architecture-Landscape Architecture 217 Bonita Avenue, Piedmont, CA 94611

IRRIGATION: Russell D Mitchell & Associates, Inc. 2760 Camino Diablo, Walnut Creek, CA 94597


CLIENT:

#### Irene Chan-Jones and Bill Jones

100 Burlwood Drive, San Francisco, CA 94127

COUNTY APPROVAL STAMP

PROJECT NO: PROJECT NAME:				
2101 House on a Hill				
APN:	036-031-280			
PROJECT ADDRESS:	10th Street Montara, CA 9403	7		
PROJECT PHASE: Construction Documents				
DRAWN:	AG	CHECKED	Checker	
ISSUE DATE:	2/16/2022 9:03:35	PM		
DRAWING TITLE: ELEVATIONS				
DRAWING NO: A311				
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3 EAST ELEVATION 1/4" = 1'-0" REF 1 - A211

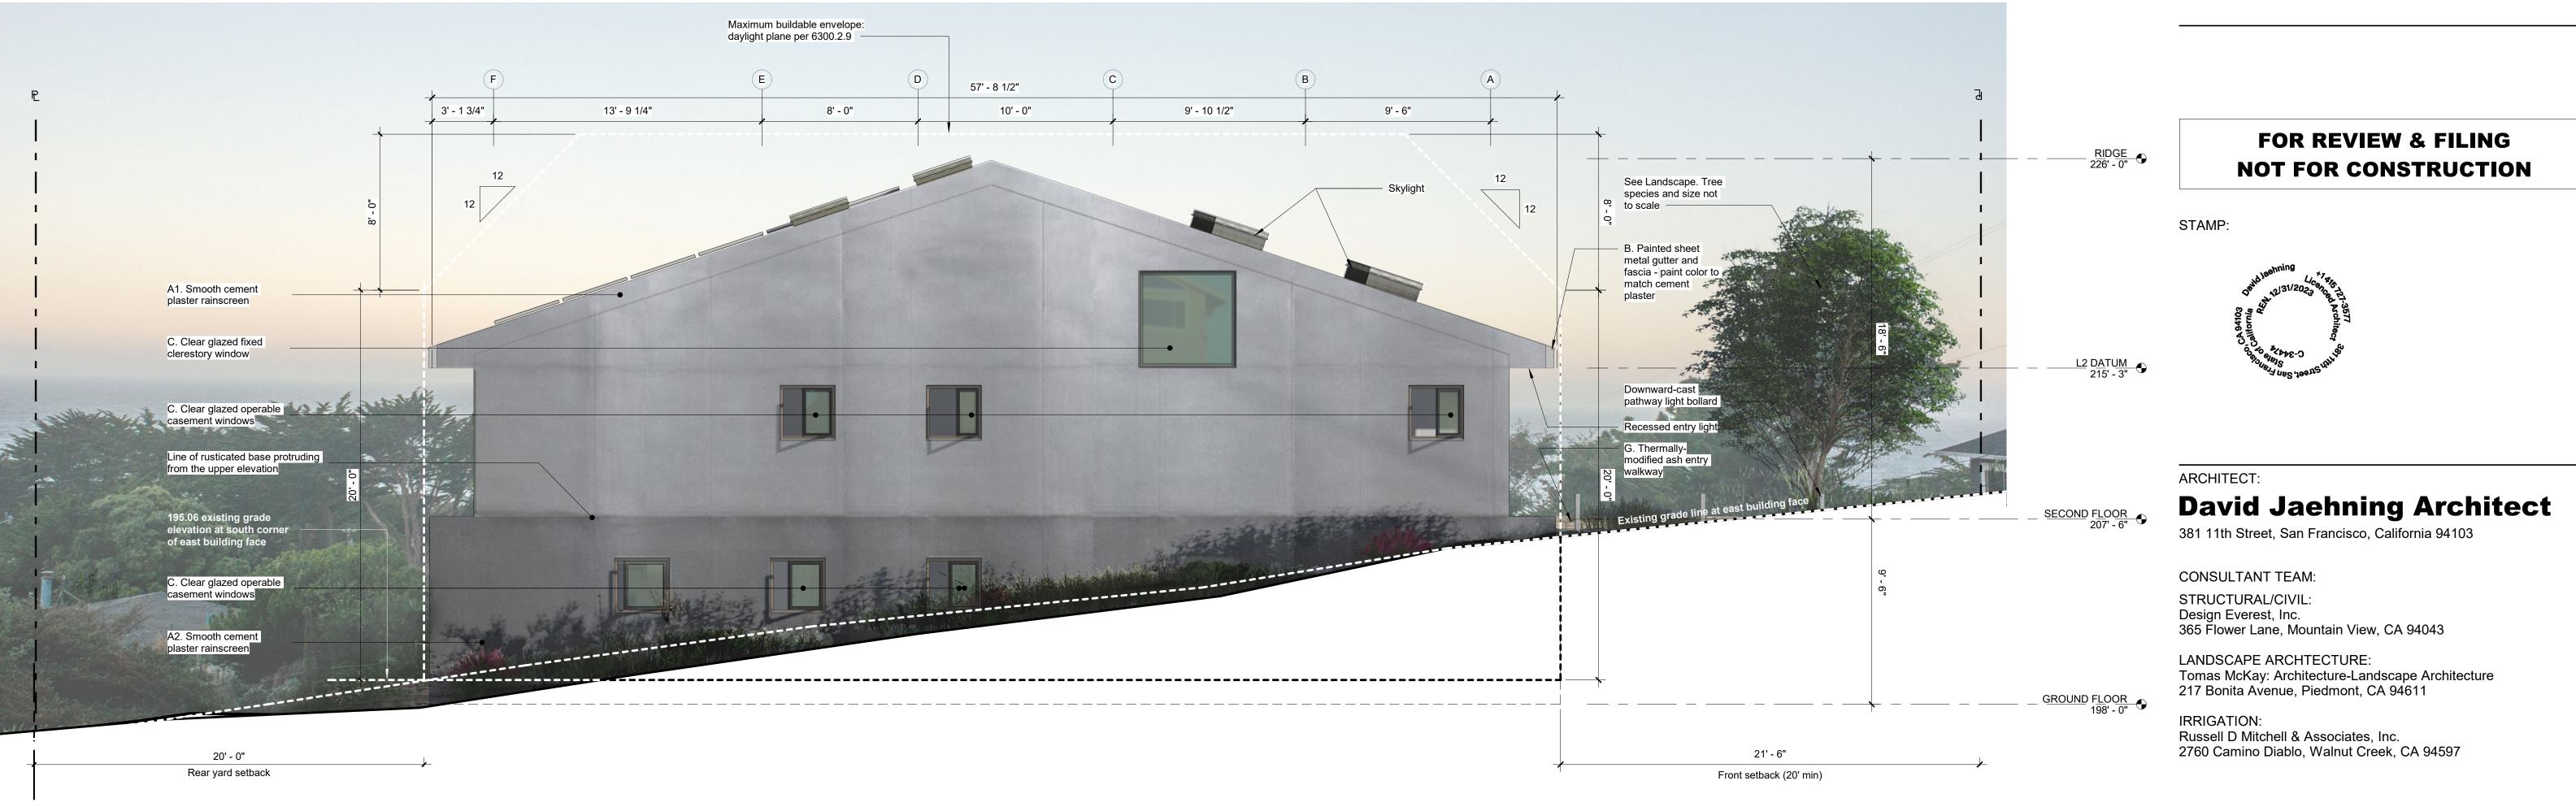Building materials legend



A1. Exterior walls Elastomeric masonry coating over smooth cement plaster rainscreen: Sto StoColor Lastic elastomeric coating (StoColor 37302)



A2. Exterior walls Elastomeric masonry coating over smooth cement plaster rainscreen: Sto StoColor

Lastic elastomeric coating (StoColor 37300)



B. Trim Elastomeric coating over sheet metal: Sto StoColor Lastic elastomeric coating (StoColor 37304)

C. Window frames Anodized aluminum: C31 Bronze Anodized (Reynaers)







#### Anodized aluminum: C31 Bronze Anodized (Reynaers)

D. Doors

E. Roof Elastomeric masonry coating over smooth cement plaster rainscreen: Sto StoColor Lastic elastomeric coating (StoColor 37302)

G. Decks and railings Thermally-modified ash decking

I. Retaining walls

Reinforced poured concrete - light sandblast finish

#### **REVISION**:

NO.

4

DESCRIPTION

DESIGN REVIEW APPLICATION PLN2021-00187 CYCLE 2 PLN2021-00187 CYCLE 3 COASTSIDE DESIGN REVIEW

### DATE 5/11/2021

8/5/2021 12/21/2021 02/16/2022

#### CLIENT:

#### Irene Chan-Jones and Bill Jones

100 Burlwood Drive, San Francisco, CA 94127

#### COUNTY APPROVAL STAMP

PROJECT NO:	PROJECT NAME	:			
2101	House	on a Hill			
APN:	036-031-280				
PROJECT ADDRESS:	10th Street Montara, CA 9403	37			
PROJECT PHASE: Construction Documents					
DRAWN:	AG	CHECKED	Checker		
ISSUE DATE:	2/16/2022 9:03:37	7 PM			
DRAWING TITLE	ELEVATIONS				
DRAWING NO:	A312				
All Rights Reserv	ed				

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Building materials legend

Elastomeric coating over sheet metal: (StoColor 37304)


Lastic elastomeric coating (StoColor 37304)





Thermally-modified ash decking



I. Retaining walls finish

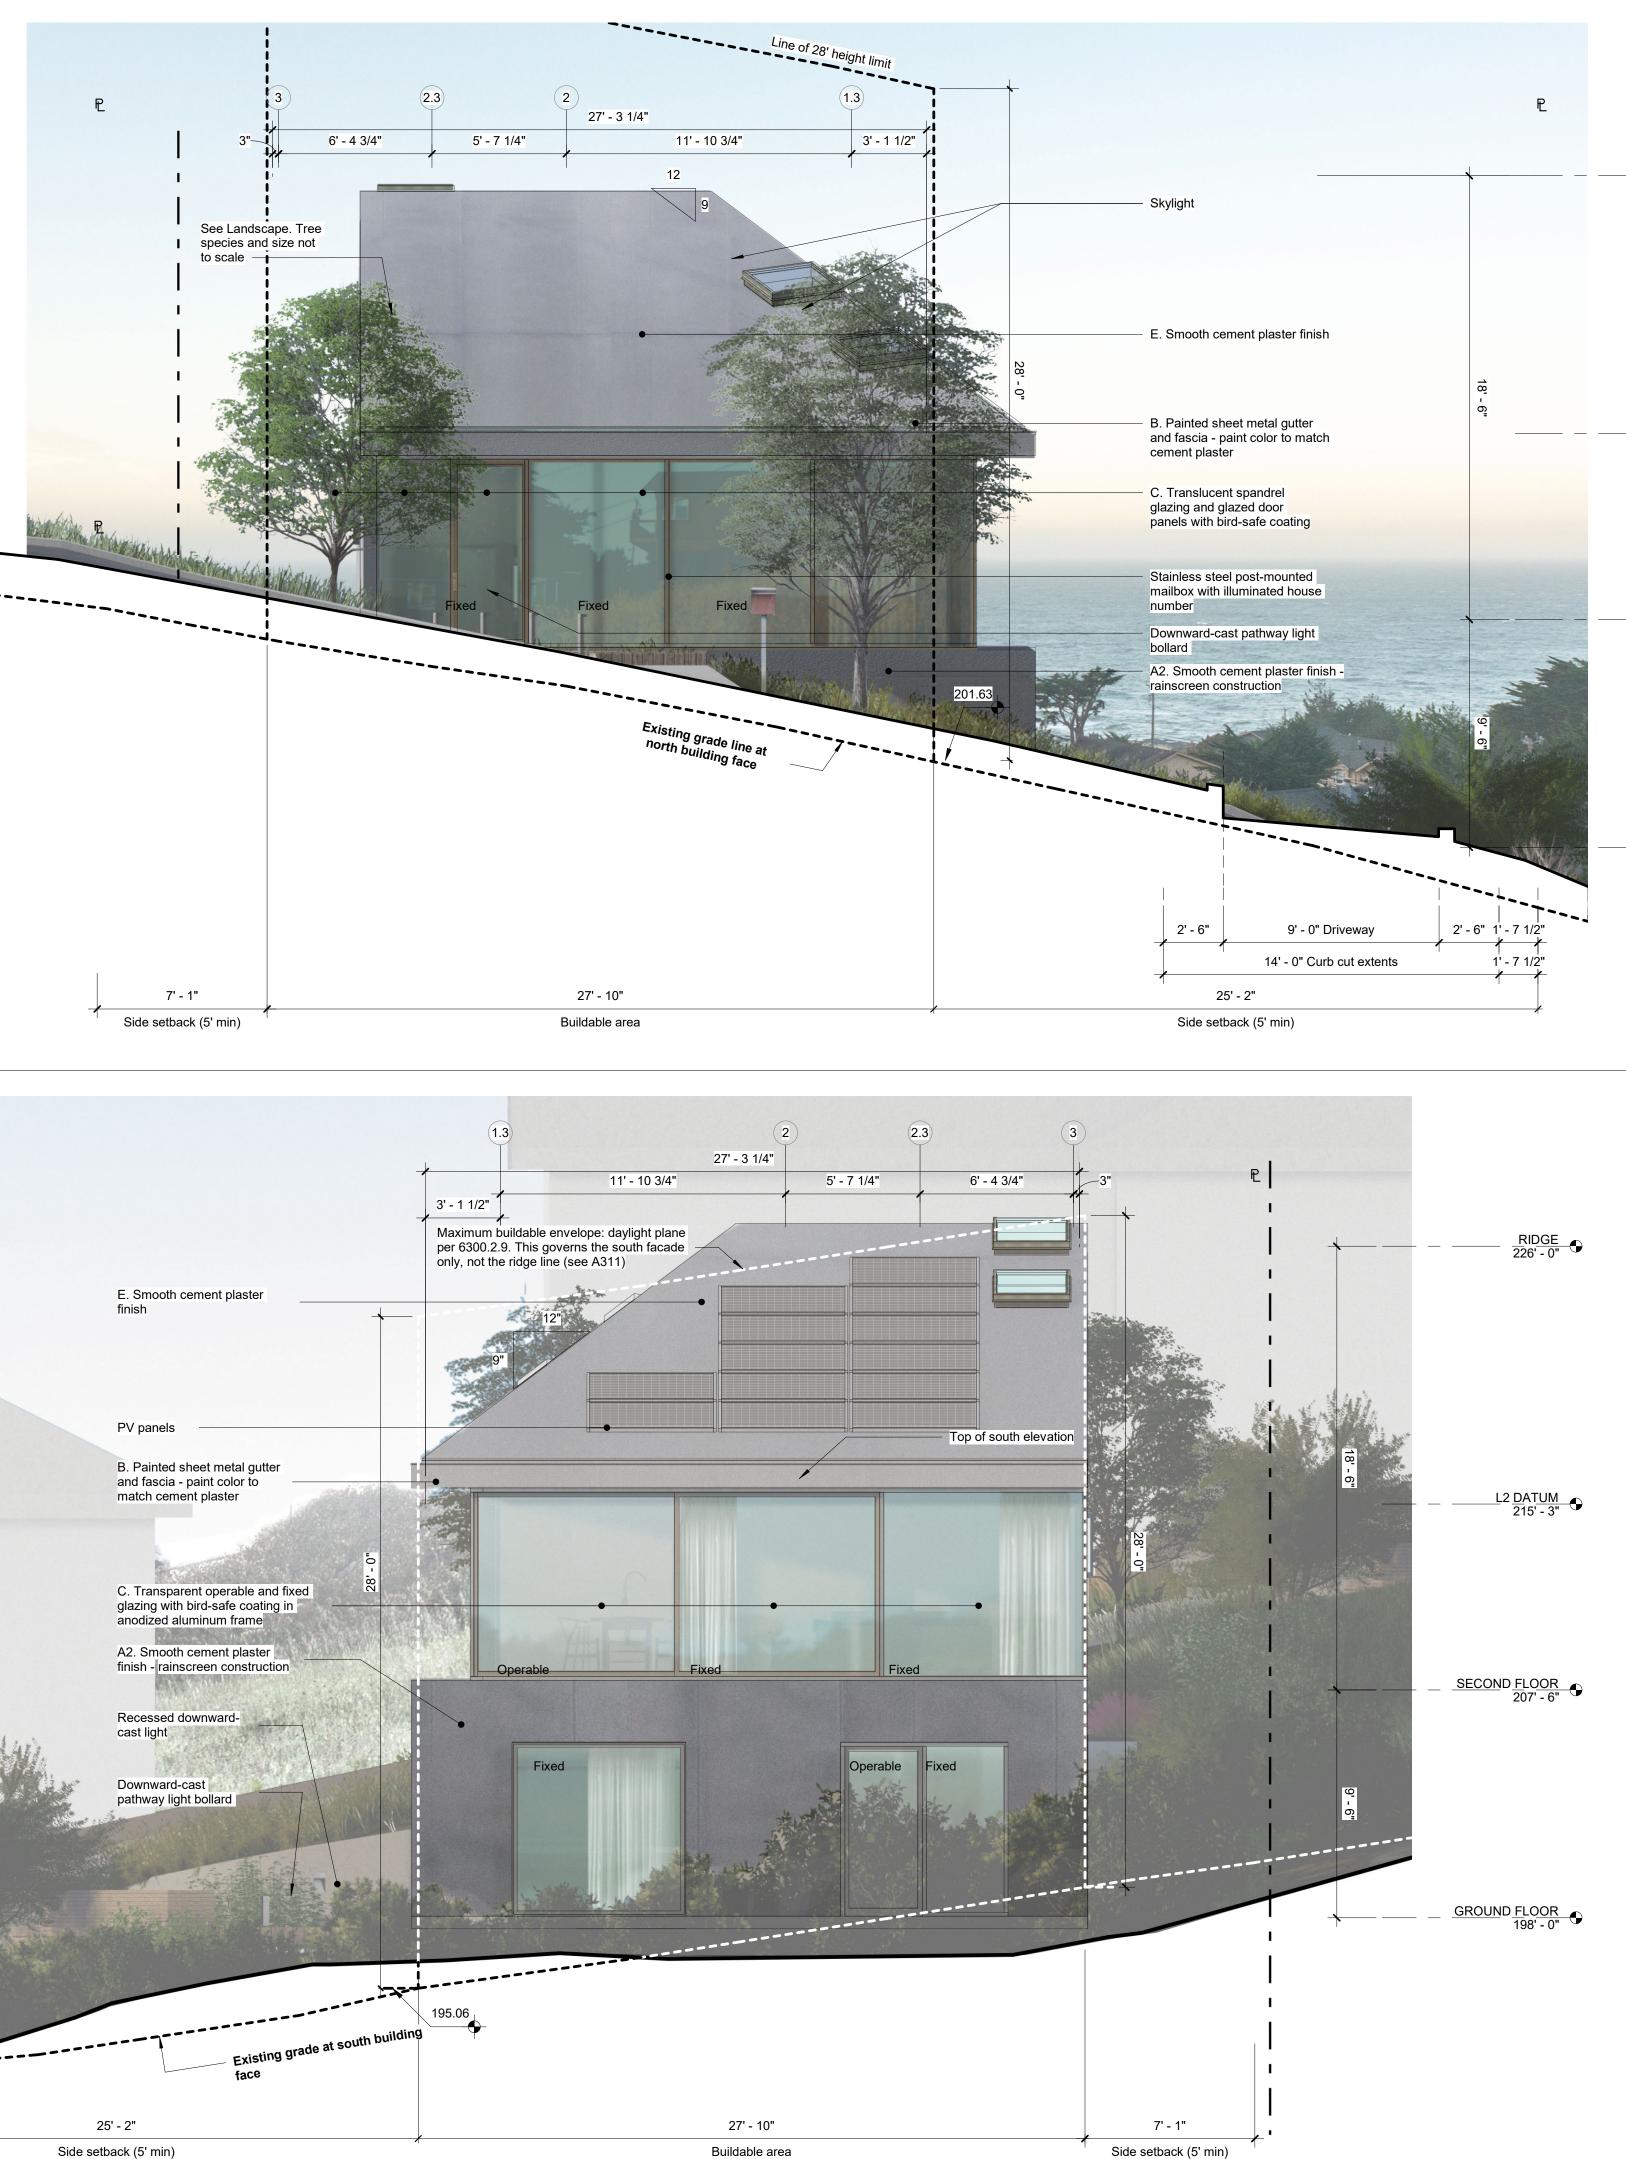

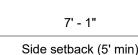

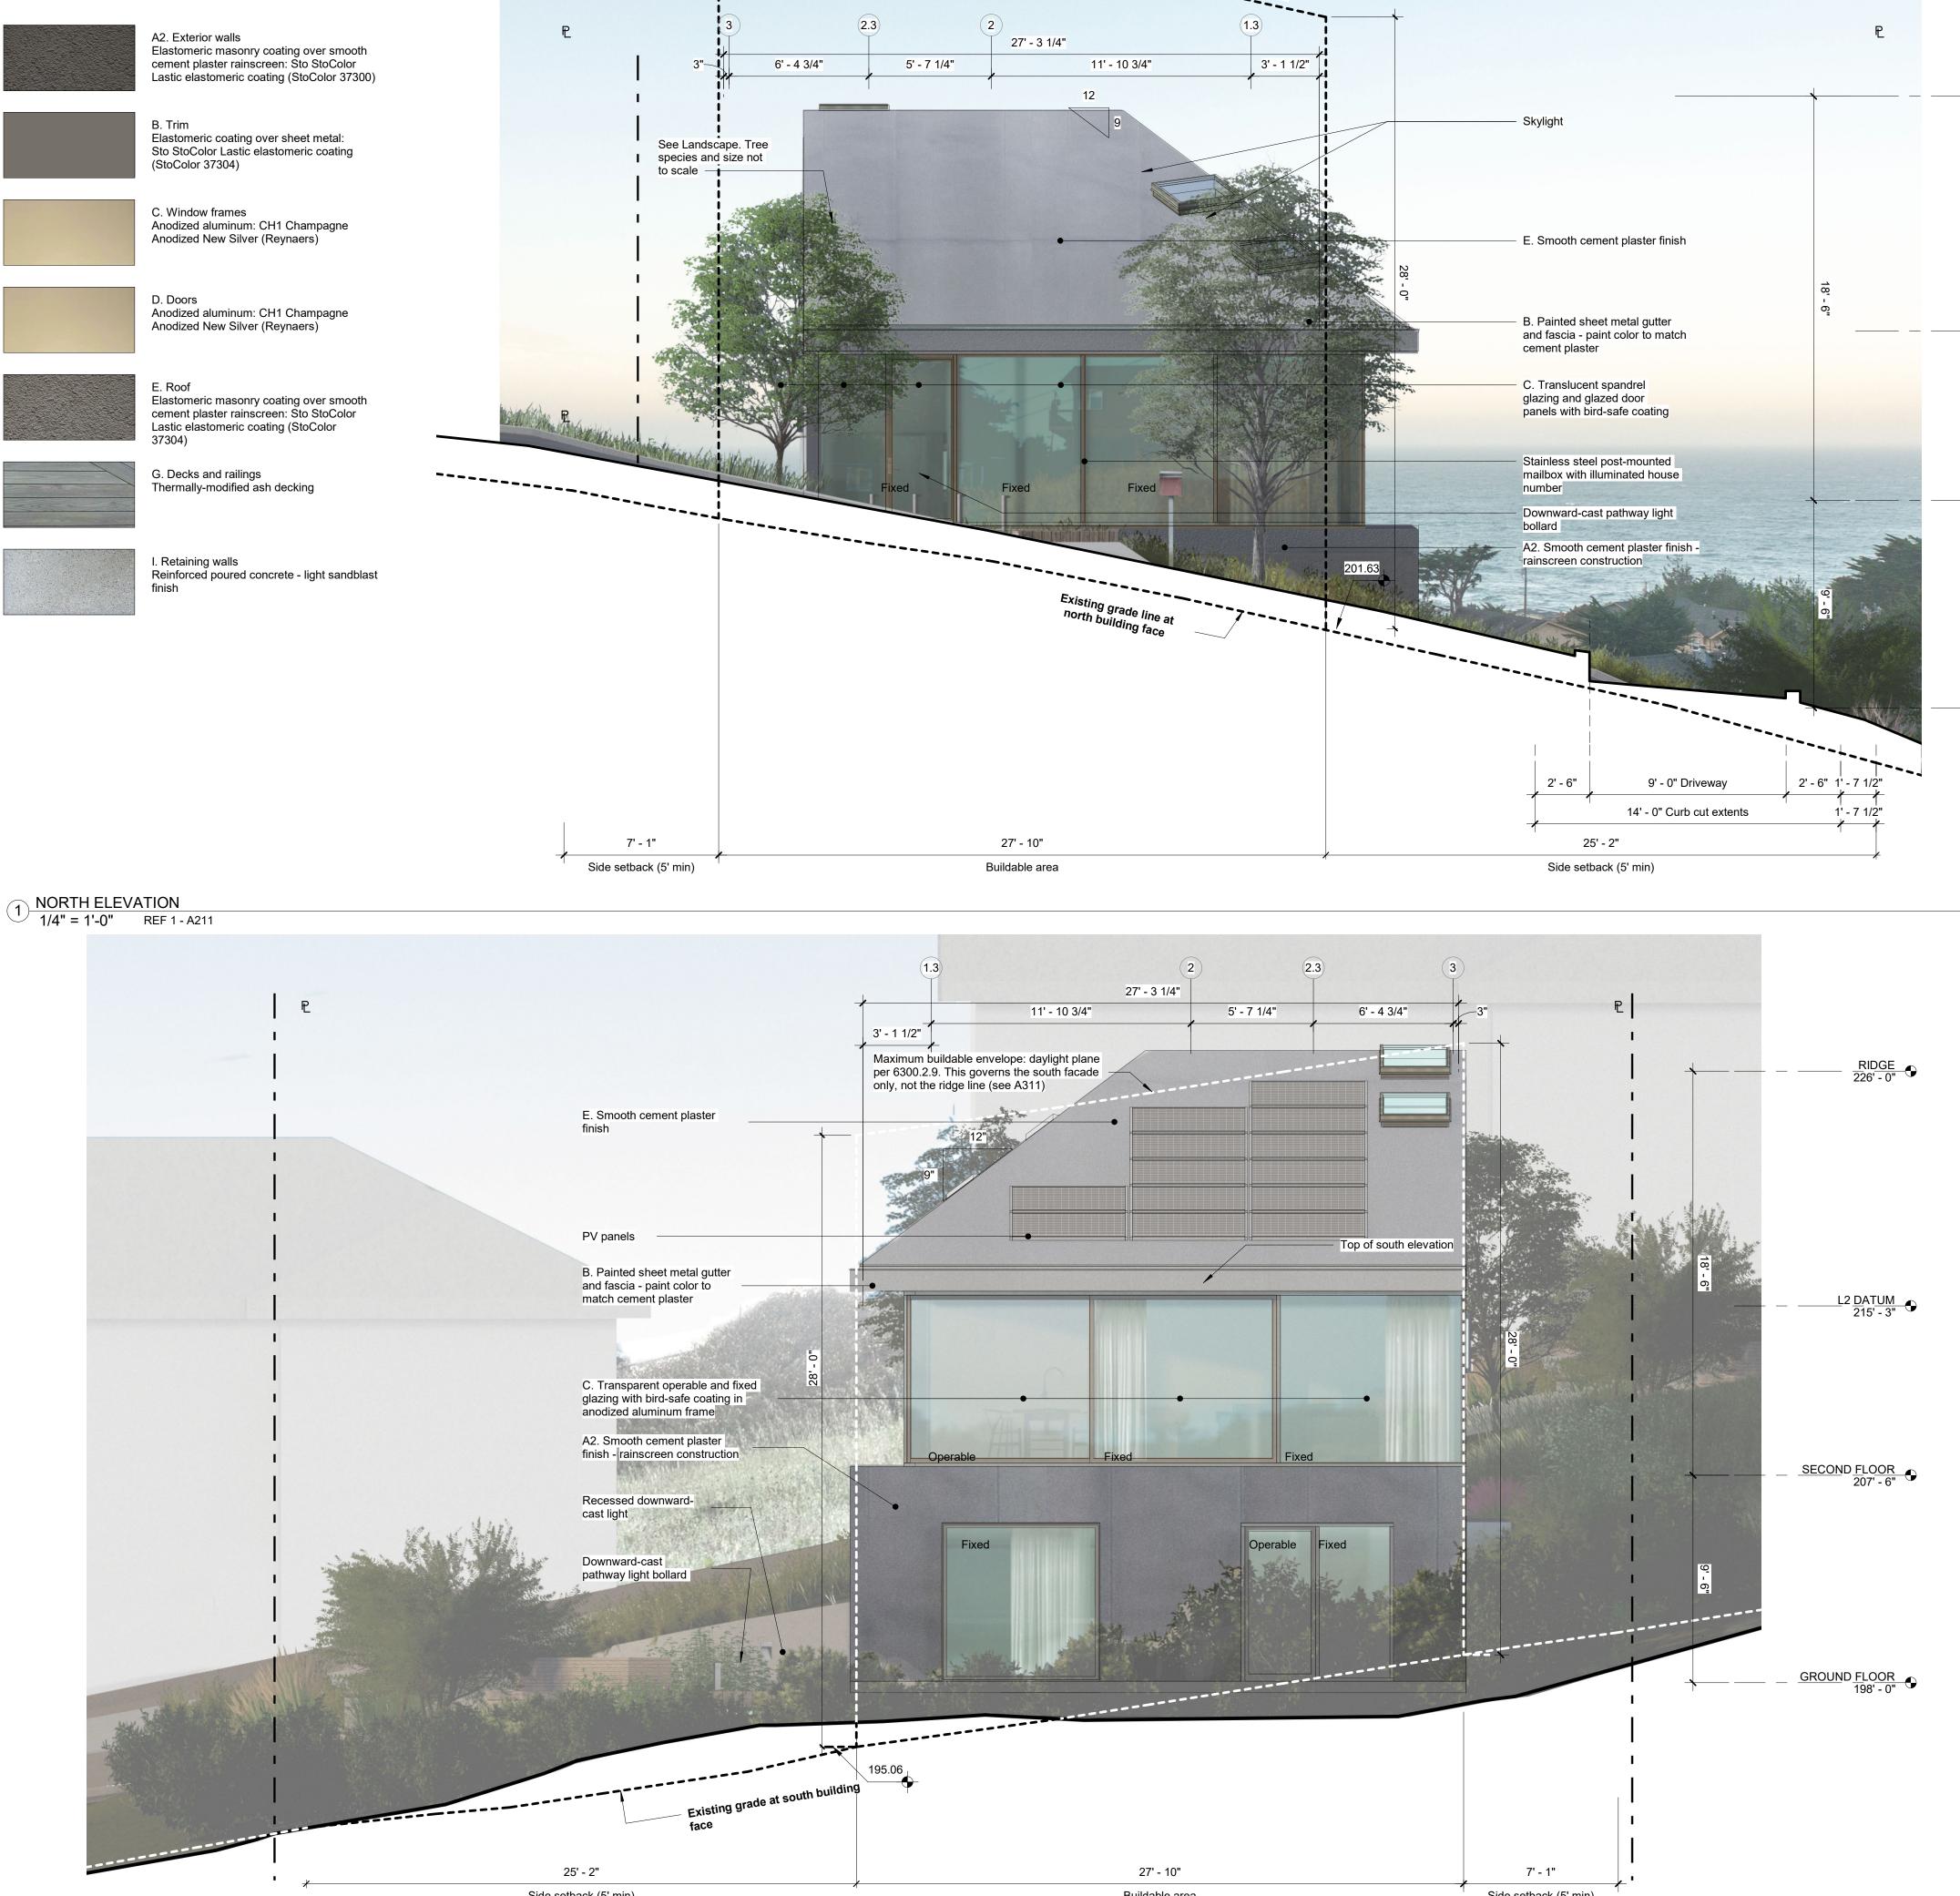

#### **REVISION:** NO.

DESCRIPTION

DESIGN REVIEW APPLICATION PLN2021-00187 CYCLE 2 PLN2021-00187 CYCLE 3 COASTSIDE DESIGN REVIEW

5/11/2021 8/5/2021

DATE

12/21/2021 02/16/2022

# L2 DATUM 215' - 3"

SECOND FLOOR 207' - 6"

RIDGE 226' - 0"

<u>GROUND</u> F<u>LOOR</u> 198' - 0"

#### 6300.2.6 Building Height

The maximum building height shall be established, as follows:

a. Up to 30% Slope. Where the average slope of the parcel area covered by the main residence is less than 30%, maximum building height is 28 feet.

b. 30% Slope or Greater. Where the average slope of the parcel area covered by the main residence is 30% or greater, maximum building height is 28 feet, unless increased by the Design Review Committee.

6300.2.9 Daylight Plane or Façade Articulation

New residential development shall conform to either the daylight plane or façade articulation options described in this section, as determined by the project applicant.

a. Daylight Plane Option

The daylight plane shall be established on two opposite house sides, i.e., either from the front and rear setback lines, or from the side setback lines, as determined by the project applicant and approved by the Design Review Committee.

The daylight plane shall be measured from the setback line at natural grade, upward a vertical distance of 20 feet, and then inward at an angle of 45° until the maximum building height is reached.

Cornices, canopies, eaves, roof overhangs, chimneys, fire escapes, stairways; landing places; uncovered porches, and similar architectural features may extend into the daylight plane at the front, side, or rear yard, to the extent allowed by Zoning Regulations Section 6406.

COUNTY APPROVAL STAMP

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ARCHITECT:

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LANDSCAPE ARCHTECTURE: Tomas McKay: Architecture-Landscape Architecture 217 Bonita Avenue, Piedmont, CA 94611

IRRIGATION: Russell D Mitchell & Associates, Inc. 2760 Camino Diablo, Walnut Creek, CA 94597

#### CLIENT:

#### Irene Chan-Jones and Bill Jones

100 Burlwood Drive, San Francisco, CA 94127

#### PROJECT NAME: PROJECT NO: House on a Hill 2101 APN: 036-031-280 PROJECT 10th Street ADDRESS: Montara, CA 94037 PROJECT PHASE: Construction Documents DRAWN: AG CHECKED Checker 2/16/2022 9:03:41 PM ISSUE DATE: DRAWING TITLE: **ELEVATIONS** DRAWING NO: A313

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