#### Planning and Building Department

#### **Certificate of Exemption** or Exclusion from a Coastal **Development Permit**

455 County Center, 2nd Floor • Redwood City, CA • 94063 Mail Drop: PLN 122 • TEL (650) 363-4161 • FAX (650) 363-4849

> Permanent Record Microfilmina Peguired

Permit #: PLN Permit #: BLD		Microfilming Required
1. Basic Information		
Owner Name: Irene Chan-Jones and Bill Jones  Address: 100 Burlwood Drive	Applicant Name: David Ja Address:	aehning
San Francisco, CA  Zip: 94127  Phone, W: 415-971-2565  Email Address: irenecj@mac.com, billrjones3rd@me.com	Phone, W: Email Address:	Zip: H:
2. Project Information		
Project Description: The proposed project includes a 2-story 2,901 sf single family with a two-car garage at ground level, an exterior deck, and landscape containing low- and very-low water plantings. The house is embedded in the site to reduce its height and apparent mass at the street, and the gentle slope of its broad hip roof works with the natural slope of the site and references the dominant roof forms of the surrounding residences. The garage is embedded in the deepest part of the excavation in order to locate the garage door away from the prominent street facade.  Assessor's Parcel Number(s):  036 — 031 — 280  — — —	Well  Proposed wate  Utility con  Well  Staking of well required.  Provide sit  Will this re removal?  If Yes, additional	r source: nection  location and property lines are te plan depicting location and all trees. equire any grading or vegetation/tree Yes \(\sigma\) No \(\sigma\) permits may be required. Such as: Tree Grading Permit, Land Clearing Permit,
3. Signatures		
We have reviewed this form as completed above and the basis for basis for exemption or exclusion are true and correct to the best in accordance with the terms of the exemption/exclusion catego exemption or exclusion issued for a water well and/or storage tale event the future house, the well, and/or storage tank requires a storage tank of the future house, the well, and/or storage tank requires a storage tank of the future house.	of our knowledge a ry selected on rever nk in the single fami variance.	nd we hereby agree to carry out this project se. We also understand and agree that any lily exclusion area will be invalidated in the  5/6/2021
Owner Date	Applicant	Date

(Both Owner and Applicant must sign unless this Application for Exemption or Exclusion accompanies a Building Permit Application for which the Applicant is an agent for the Owner acceptable to the Building Inspection Section.)

#### **Staff Use Only**

#### 4. Basis of Exemption or Exclusion

Use attached review sheet to determine basis of exemption and thether project qualifies. Review basis of exemption with applicant/owner and initial appropriate category below:

[PF B. In C. E. C. E. D. R D. R E. Si	inprovements to Existing Single Family Residence. RC 30610(a), CCR13250, ZR 6328.5(a)] inprovements to Existing Structure Other Than agle Family Residence or Public Works Facility. [PRC 610(b), CCR13253, ZR 6328.5(b)] instituting Navigation Channel. [PRC 30610(c), 6328.5(c)] in the provention of Maintenance Activity. RC 30610(d), CCR13252, ZR 6328.5(d)] in the province of RC 30610(e), CCR13240, AB 643, ZR 6328.5(e)]	<ul> <li>F. Agriculturally-Related Development Categorical Exclusion Area. [PRC 30610(e), CCR13240, ORDERS E-79-7 and E-81-1, ZR 6328.5(e)]</li> <li>G. Utility Connections. [PRC 30610(f), ZR 6328.5(f)]</li> <li>H. Replacement of Structures Following Disasters. [PRC 30610(g), ZR 6328.5(g)]</li> <li>I. Emergency Activities. [PRC 30611, ZR 6328.5(h)]</li> <li>J. Lot Line Adjustment. [ZR 6328.5(i)]</li> <li>K. Land Division for Public Recreation Purposes. [ZR 6328.5(l)]</li> </ul>
	ell Inspection - All Coastal Zonuired    Not Required	ne Areas
nspection	n made by:	Date of Inspection:
Yes	Removal of trees? If Yes, is tree removal permit included? Trimming of trees? Excessive removal of vegetation? Excessive grading? (If Yes, CDP is required) Erosion control plan required?	Approval of Permit is subject to the following: (check if applicable)  Submittal and Approval of a Tree Removal Permit  Submittal and Approval of a Grading Permit  Submittal and Approval of an Erosion Control Plan  Submittal and Approval of a Coastal Dev. Permit
6. Ap	proval	
thecked a  Exemption  Planning	above. on/Exclusion is approved.	nined that it meets all criteria for the exemption/exclusion  Date
<b>7. Pr</b> Fee	ocessing collected ginal Certificate of Exemption to Building Inspection	3. Any relevant Planning or Building Inspection files.
file. Cop 1. A	ies of Certificate of Exemption to: pplicant/Owner. lanning Department Exemption Binder.	4. California Coastal Commission, 45 Fremont Street, Suite 2000, San Francisco, CA 94105 Update Permit*Plan Case Screen and Activities

#### **Environmental Information Disclosure Form**

#### Planning and Building Department

BLD\_\_\_\_ Name of Owner: Address: Phone: Name of Applicant:

Phone:

PLN\_\_\_\_\_

Address:

**Existing Site Conditions** 

Project Address:

Zoning District:

Assessor's Parcel No.:

Parcel size: \_\_\_\_ Describe the extent and type of all existing development and uses on the project parcel, including the existence and purpose of any easements on the parcel, and a description of any natural features on the project parcel (i.e. steep terrain, creeks, vegetation). \_

(E) cotonoactor at the couth property boundary

s	No	Will this project involve:
		a. Addition to an existing structure > 50% of the existing area OR > 2,500 sq. ft?
		b. Construction of a new multi-family residential structure having 5 or more units?
		c. Construction of a commercial structure > 2,500 sq.ft?
		<ul> <li>d. Removal of mature tree(s) ( ≥ 6" d.b.h. in Emerald Lake Hills area or ≥ 12" d.b.h. in any residential zoning district)?</li> <li>If yes, how many trees to be removed?</li> </ul>
		e. Land clearing or grading?  If yes, please state amount in cubic yards (c.y.):  Excavation: c.y. Fill: c.y.
		f. Subdivision of land into 5 or more parcels?
		g. Construction within a State or County scenic corridor?
		h. Construction within a sensitive habitat?
		i. Construction within a hazard area (i.e. seismic fault, landslide, flood)?
		j. Construction on a hazardous waste site (check with Co. Env. Health Division)?

		a. Construction outside of the footprint of an existing, legal structure?
		b. Exterior construction within 100-feet of a stream?
		c. Construction, maintenance or use of a road, bridge, or trail on a stream bank or unstable hill slope?
		d. Land-use within a riparian area?
		e. Timber harvesting, mining, grazing or grading?
		f. Any work inside of a stream, riparian corridor, or shoreline?
		g. Release or capture of fish or commerce dealing with fish?
Please	explaii	n any "Yes" answers:

3. Na	3. National Pollutant Discharge Elimination System (NPDES) Review		
Yes	No	Will the project involve:	
		a. A subdivision or Commercial / Industrial Development that will result in the addition or replacement of <b>10,000 sq. ft.</b> or more of impervious surface?	
		If yes, Property Owner may be required to implement appropriate source control and site design measures and to design and implement stormwater treatment measures, to reduce the discharge of stormwater pollutants. Please consult the Current Planning Section for necessary forms and both construction and post-construction requirements.	
		b. Land disturbance of 1 acre or more of area?	
		If yes, Property Owner must file a Notice of Intent (NOI) to be covered under the statewide General Construction Activities Storm Water Permit (General Permit) <u>prior</u> to the commencement of construction activity. Proof of coverage under State permit must be demonstrated prior to the issuance of a building permit.	

#### Certification

I hereby certify that the statements furnished above and in the attached exhibits present the data and information required for this initial evaluation to the best of my ability, and the facts, statements and information presented are true and correct to the best of my knowledge and belief. If any of the facts represented here change, it is my responsibility to inform the County.

Signed: Date: 5/6/2021

(Applicant may sign)

#### **San Mateo County**

# **Application for a Grading Permit**

## Planning and Building Department

☐ Land Clearing

455 County Center, 2nd Floor · Redwood City CA 94063 Mail Drop: PLN 122 · TEL (650) 363-4161 · FAX (650) 363-4849

	Grading	
C	ompanion	Page

Applicant's Name:	
Primary Permit #:	

#### 1. Instructions

License #:

Please fill out the general Planning Permit Application Form and this form when applying for a Grading Permit. You must also submit all items indicated on the checklist found on the reverse side of the Planning Permit Application Form.

2. Basic Information - Land Clearing	
Land Clearing Operator	◆ Disposal Site:
Name:	
Address	
Zip:	◆ Purpose of removal:
Phone:	
License #:	
◆ Area to be cleared: sq. ft.	
• Average slope of area to be cleared:	
Type of vegetation to be removed:	
3. Land Clearing Plan Requirements	
The land clearing plans must show:  (1) Property lines.	(3) Existing structures
(2) Location of area to be cleared.	(4) Erosion control measures.
4. Basic Information - Grading	
Grading Operator	Geotechnical Consultant
Name:	Name:
Address:	Address:
Zip:	Zip:
Phone:	Phone:

License #:

Civil Engineer		◆ Haul site:
Name:		
Address:		◆ Purpose of grading:
Zip:		
Phone:		WW
License #:		
<ul> <li>Engineer's estimate of the quantity of material moved:</li> </ul>	ls to be	
cut:	cubic yards	List Assessor's parcel numbers of any adjacent property
fill:	cubic yards	owned by the owner or applicant, now or in the past:  036 — 031 — 280
Depth of cut:	ft.	
Depth of fill:	ft.	

#### **5. Grading Plan Requirements**

The grading plans, 24"x36", **prepared and signed by a civil engineer** shall contain the following:

- (1) All of the proposed uses for which the proposed grading is necessary.
- (2) Boundary lines of the site.
- (3) If there is a proposed subdivision, each lot or parcel of land into which the site is proposed to be divided.
- (4) The location of any existing buildings, structures, easements or underground utilities on the property where the work is to be performed and the location of any buildings or structures on adjacent land within 50 feet of the proposed work..
- (5) Accurate contours showing the topography of the existing ground extending at least 10 feet outside all boundary lines of the project site.
- (6) Elevations, locations, extent and slope of all proposed final grading shown by contours. Location of any rock disposal areas, buttress fills, subdrains, or other special features to be included in the work.
- (7) A statement of the quantities of material to be excavated and/or filled and the amount of such material to be imported to, or exported from, the site.

- (8) Location and nature of known or suspected soil or geologic hazard areas.
- (9) Specifications, cross-sections, profiles, elevations, dimensions and construction details based on accurate field data.
- (10) Construction details for roads, watercourses, culverts, bridges and drainage devices, retaining walls, gabion walls, cribbing, dams, and other improvements existing or to be constructed, together with supporting calculations and maps.
- (11) Approximate boundaries of any areas with a history of flooding.
- (12) Location, width, direction or flow and approximate location of top and toes of banks or any watercourse.
- (13) General location and character of vegetation covering the site, including all trees proposed to be removed and all trees 12" dbh within 20 feet of the area to be disturbed.
- (14) Name and registration number of the registered California civil engineer under whose direction the grading plan is prepared.

# HOUSE ON A HILL - PNL2021-00187-0360312800-CYCLE 3 PLANS

APN: 036-031-280 10th Street Montara, California 94037



CHITECTURAL:	STRUCTURAL/C

DAVID JAEHNING ARCHITECT **381 11TH STREET** SAN FRANCSICO. CA 94103 T: +1 415 272 9444

**DESIGN EVEREST** 365 FLOWER LANE MOUNTAIN VIEW, CA 94043 T: +1 415 870 1101

#### **BUILDING/PLANNING CODE INFORMATION:**

APPLICABLE BUILDING CODE: 2016 CA BUILDING STANDARDS

CODE, CA CODE OF REGULATIONS TITLE 24, CA RESIDENTIAL CODE, CA PLUMBING CODE, CA MECHANICAL CODE, CA ENERGY CODE, CA FIRE CODE, CALIFORNIA ELECTRICAL CODE

1,670 SF

CITY ZONED: S-17 COASTAL DEVELOPMENT DISTRICT

PARCEL SIZE: 5,995 SQ FT

LOT COVERAGE: BUILDING: 1,576 SF HARDSCAPE: 94 SF

TOTAL: DRIVEWAY AREA (PERMEABLE PAVING): 752 SF

FLOOR AREA RATIO: GOVERNED BY 6300.2.5a

LANDSCAPE AREA ( PLANTING): 3,157 SF

OCCUPANCY CLASSIFICATION: R-3

BUILDING AREA (GROSS): LEVEL 1: 1,579 SF 1,322 SF LEVEL 2:

TOTAL: 2,901 SF

ALLOWABLE AREA PER

6300.2.5a: (0.53)(5,995 SF) = 3,177 SF

BUILDING HEIGHT: 27' - 11 1/2"

GRADE ELEVATION: 198'-0"

BUILDING LEVELS: 2

MECHANICAL, **ELECTRICAL, & PLUMBING:** 

DESIGN/BUILD/PERMIT BY

LICENSED CONTRACTOR

**BUILDING/PLANNING CODE INFORMATION:** 

SEE SHEET A112 FOR ADD'L PARCEL COVERAGE CALCULATIONS

TYPE OF CONSTRUCTION:

**ROOF CONSTRUCTION:** 

**ALLOWABLE HEIGHT:** 

OCCUPANT LOAD:

**BUILDABLE AREA:** 

**EGRESS REQUIREMENTS:** 

PER SECTION 1006.2.1: IN GROUP-R-2 AND R-3 OCCUPANCIES, ONE MEANS OF EGRESS IS PERMITTED WITHIN AND FROM INDIVIDUAL DWELLING UNITS WITH A MAXIMUM OCCUPANT LOAD OF 20 WHERE THE DWELLING UNIT IS EQUIPPED THROUGHOUT WITH AN AUTOMATIC SPRINKLER SYSTEM IN **ACCORDANCE WITH SECTION** 903.1.1 OR 903.2.1.2 AND THE COMMON PATH OF EGRESS TRAVEL DOES NOT EXCEED 125

CEC, PART 5, CBSC TITLE 24:

45 MITCHELL BLVD SUITE 16

CLASS 'B' OR HIGHER PER CBC

2883 SF/ 200 GROSS = 14 PERSONS

50'-0" PER TABLE 504.3

ENERGY CALC CO

T: +1 415 457 0990

TYPE V-B

12,000 SF

TABLE 1505.1

SAN RAFAEL, CA 94903

SMOKE DETECTOR **REQUIREMENTS:** 

SMOKE DETECTORS TO BE HARD-WIRED AND INTERCONNECTED WITH BATTERY BACKUP PER CBC, STATE FIRE MARSHAL REGS, AND COASTSIDE FIRE ORDINANCE 2019-03. ONE DETECTOR MIN AT EACH FLOOR, ONE DETECTOR PER SLEEPING AREA, ONE CENTRALLY-LOCATED DETECTOR PER ACCESS AREA TO SLEEPING AREA.

# **SHEET LIST-PLANNING**

A002 | LIFE & FIRE SAFETY PLAN A003 LOT COVERAGE DIAGRAM

# # **GENERAL INFORMATION** A313 ELEVATIONS A000 COVER SHEET

SHEET LIST-PLANNING

**IRRIGATION:** 

2760 CAMINO DIABLO,

T: +1 925 939 3985

WALNUT CREEK CA 94597

RUSSELL D MITCHELL & ASSOCIATES

CIVIL C001 COVER SHEET C002 GRADING & DRAINAGE PLAN C003 UTILITY PLAN C004 CROSS SECTIONS C005 | CONSTRUCTION DETAILS C006 | CONSTRUCTION DETAILS C007 CONSTRUCTION DETAILS C008 | EROSION & SEDIMENT CONTROL PLANS C009 | EROSION & SEDIMENT CONTROL DETAILS SURVEY

LANDSCAPE

SU-1 SITE - SURVEY

L001 LANDSCAPE DESIGN PLAN & SITE LIGHTING PLAN L002 LANDSCAPE PLANTING PLAN

IRRIGATION

IR-I1 | IRRIGATION PLAN IR-I2 IRRIGATION NOTES AND LEGEND IR-I3 IRRIGATION DETAILS IR-I4 IRRIGATION DETAILS IR-I5 IRRIGATION DETAILS

ARCHITECTURAL A011 DEMOLITION SITE PLAN A112 ARCHITECTURAL SITE PLAN A113 ARCHITECTURAL SITE SECTIONS A211 GROUND FLOOR PLAN A212 SECOND FLOOR PLAN & ROOF PLAN A311 ELEVATIONS |A312 | ELEVATIONS

FIRE PROTECTION:

TBD

LANDSCAPE DESIGN: TOMAS MCKAY: ARCHITECTURE-

LANDSCAPE ARCHITECTURE 217 BONITA AVE, PIEDMONT CA 94611 T: +1 415 730 6649

**BUILDING/PLANNING CODE INFORMATION:** 

FIRE SPRINKLER REQUIREMENTS:

1 LOCATION PLAN

<sup>/</sup> 1" = 800'-0"

PROVIDE AUTOMATIC SPRINKLER SYSTEM (INSTALLED UNDER SEPARATE PERMIT) AT DWELLING AND GARAGE. ALL UNDERGROUND SPRINKLER LINES SHALL BE FLUSHED AND INSPECTED BY FIRE DISTRICT PRIOR TO HOOK-UP TO RISER.



**COUNTY APPROVAL STAMP** 

SURVEYOR:

**BGT LAND SURVEYING** 

SAN MATEO, CA 94401

871 WOODSIDE WAY

T: +1 650 212 1030

**REVISION:** 


DESCRIPTION

5/11/2021 DESIGN REVIEW APPLICATION PLN2021-00187 CYCLE 2 8/5/2021 PLN2021-00187 CYCLE 3 12/21/2021

DATE

### **FOR REVIEW & FILING NOT FOR CONSTRUCTION**

STAMP:

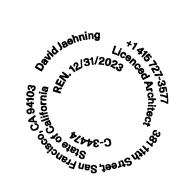

ARCHITECT:

# **David Jaehning Architect**

381 11th Street, San Francisco, California 94103

**CONSULTANT TEAM:** STRUCTURAL/CIVIL:

Design Everest, Inc. 365 Flower Lane, Mountain View, CA 94043

LANDSCAPE ARCHTECTURE Tomas McKay: Architecture-Landscape Architecture 217 Bonita Avenue, Piedmont, CA 94611

**IRRIGATION:** Russell D Mitchell & Associates, Inc.

2760 Camino Diablo, Walnut Creek, CA 94597

CLIENT:

#### **Irene Chan-Jones and Bill Jones**

100 Burlwood Drive, San Francisco, CA 94127

PROJECT NO: PROJECT NAME:

2101 House on a Hill

036-031-280 **PROJECT** 10th Street

ADDRESS: Montara, CA 94037

PROJECT PHASE: Construction Documents

Checker


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ISSUE DATE: 12/21/2021 9:47:40 PM DRAWING TITLE: COVER SHEET

**A000** 

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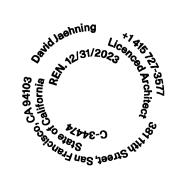
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#### **Irene Chan-Jones and Bill Jones**

100 Burlwood Drive, San Francisco, CA 94127

COUNTY APPROVAL STAMP

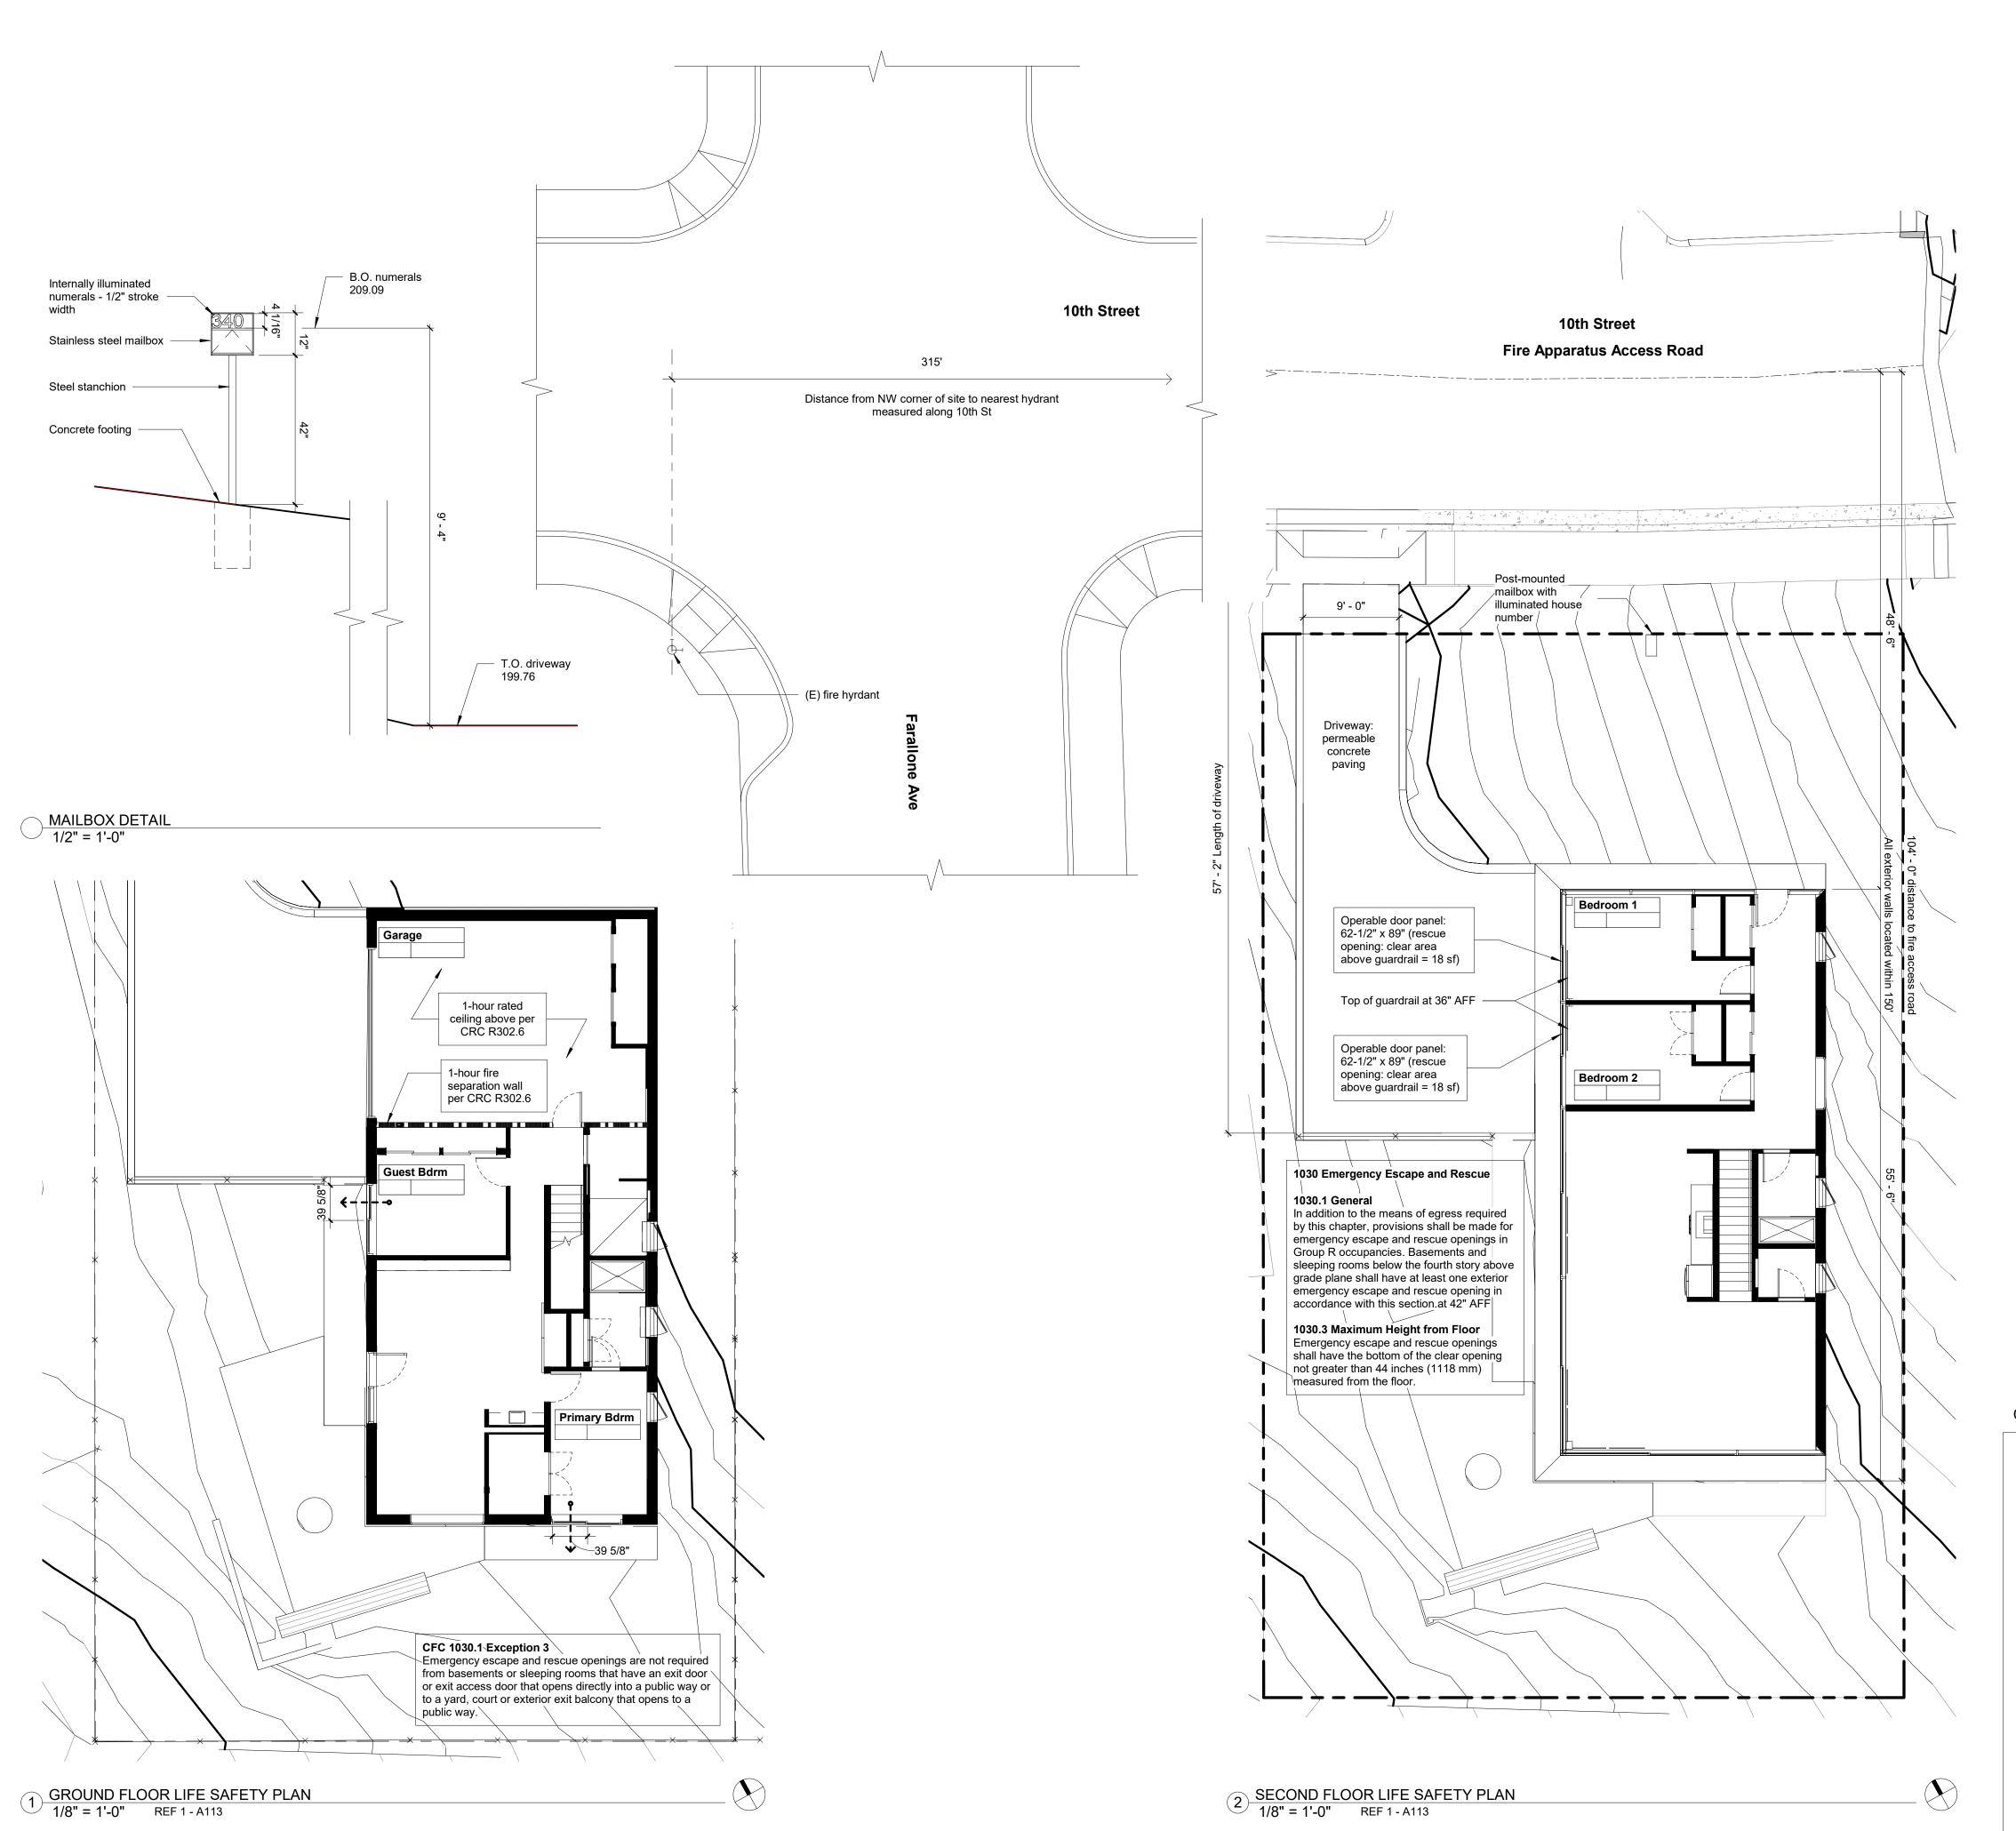**Fire Resistive Construction** 

703A.2 Qualification by Testing

issued by an approved agency.

considered noncombustible.

705A.2 Roof Coverings

the combustible decking.

705A.4 Roof Gutters

for noncombustible materials in Section 202.

Material and material assemblies tested in accordance with the requirements of Section 703A shall be accepted for use when the results and conditions of those tests are met. Product evaluation testing of material and material assemblies shall be approved or

listed by the State Fire Marshal, or identified in a current report

704A.4 Alternative Methods for Determining Ignition-Resistant

1. Noncombustible material. Material that complies with the definition

NONCOMBUSTIBLE. Material of which no part will ignite and burn when subjected to fire. Any material passing ASTM E136 shall be

Where the roof profile allows a space between the roof covering and roof decking, the spaces shall be constructed to resist the intrusion of flames and embers, be firestopped with approved materials or

nonperforated cap sheet complying with ASTM D3909 installed over

have one layer of minimum 72 pound (32.4 kg) mineral-surfaced

Roof gutters shall be provided with the means to prevent the

Exception: Any of the following shall be deemed to meet the assembly performance criteria and intent of this section:

1. One layer of 5/8-inch Type X gypsum sheathing applied behind the exterior covering or cladding on the exterior side of the framing

assembly designed for exterior fire exposure including assemblies

2. The exterior portion of a 1-hour fire resistive exterior wall

Gypsum Association Fire Resistance Design Manual

707A.5 Enclosed Roof Eaves and Roof Eave Soffits

tails, shall be protected by one of the following:

Noncombustible material

Ignition-resistant material

using the gypsum panel and sheathing products listed in the

The exposed underside of enclosed roof eaves having either a

boxed-in roof eave soffit with a horizontal underside, or sloping rafter

tails with an exterior covering applied to the under-side of the rafter

One layer of 5/8-inch Type X gypsum sheathing applied behind an

assemblies using the gypsum panel and sheathing products listed in

exterior covering on the underside of the rafter tails or soffit The exterior portion of a 1-hour fire resistive exterior wall assembly

applied to the underside of the rafter tails or soffit including

the Gypsum Association Fire Resistance Design Manual

accumulation of leaves and debris in the gutter.

PROJECT NO: PROJECT NAME:

2101 House on a Hill

036-031-280

PROJECT 10th Street

ADDRESS: Montara, CA 94037

PROJECT PHASE: Construction Documents

DRAWN: Author CHECKED Checker


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DRAWING TITLE: LIFE & FIRE SAFETY PLAN

DRAWING NO: **A002** 

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1 LOT COVERAGE DIAGRAM
1/8" = 1'-0"

The following regulations shall apply in any single-family residential district with which the "S-17"

# District is combined. Building Site Width

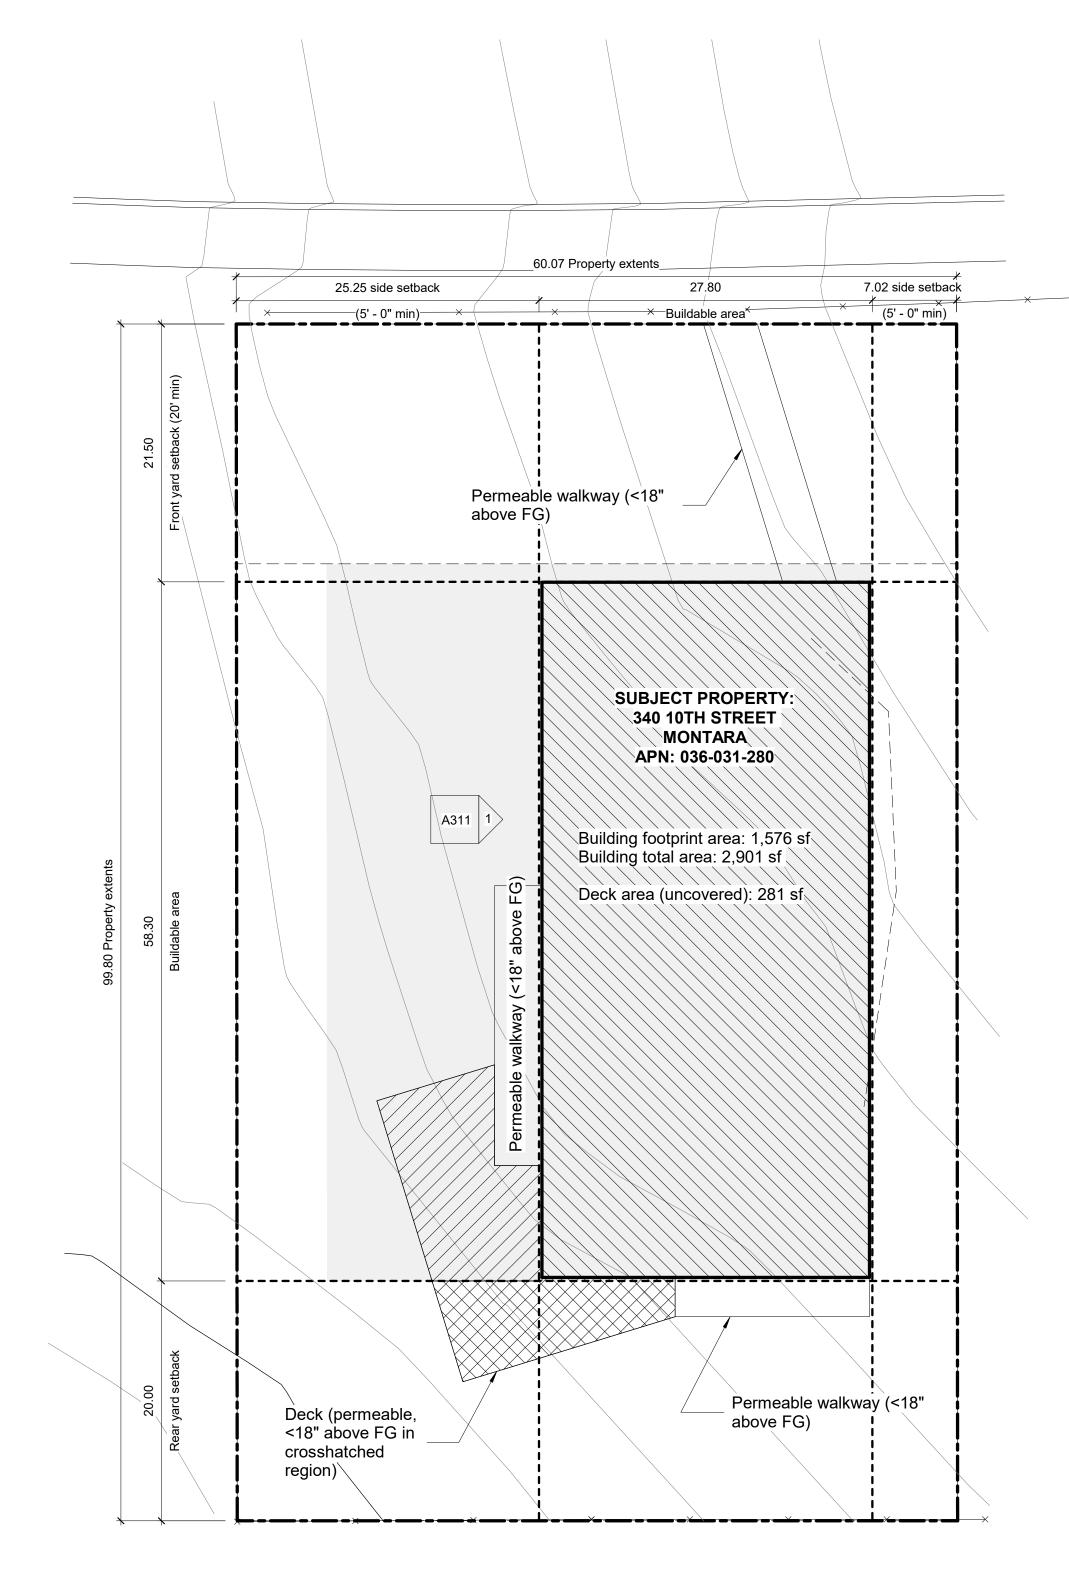The minimum building site width shall be an average of 50 feet.

#### Building site is 60.07' wide

# **Building Site Area**The minimum building site area shall be 5,000 sq ft

Building site area is 5,995 sq ft ±

#### Building Setbacks

The minimum setbacks shall be: Front setback: 20 ft Rear setback: 20 ft

Rear setback: 20 ft
Side setback: 5 ft if 16 ft in height or less; For structures over 16 feet in height: combined total of 15 feet with a minimum of 5 feet on any side.

#### Proposed front yard setback: 20 ft

Proposed rear yard setback: 20 ft
Proposed side yard setbacks: 25.25 ft (west) + 7.02 ft (east) = 32.27' total (>15')

In any area where the "S-17" District is combined with the "DR" District, the minimum side yard setback may be reduced to provide for creative design concepts such as "zero" side yard setbacks provided that: (1) the Design Review Committee approves, (2) the application involves joint development of two or more adjacent parcels, (3) the total side yard requirement is met and (4) a minimum side yard of 5 feet is maintained adjacent to any parcel not included with the application.

#### Parcel Coverage

The maximum parcel coverage shall be:

#### a. For structures 16 feet in height or less: 50%.

b. For structures greater than 16 feet in height: 35%.

Parcel coverage shall include all: (1) buildings, (2) accessory buildings, or (3) structures such as patios, decks, balconies, porches, bridges, and other similar uses which are eighteen (18) inches or more above the ground.

#### Building Floor Area

The maximum building floor area shall be established according to the parcel size: 5,000 - 11,968 sq ft = 0.53 of parcel size (or 3,177 SF)

The maximum building floor area shall include the floor area of all stories of all buildings and accessory buildings on a building site. Maximum building floor area specifically includes:

(1) gross floor area of all stories,

(2) the area of all decks, porches, balconies or other areas covered by a waterproof roof, which extends four (4) or more feet from exterior walls,

(3) the area of all garages and carports.

#### Parcel Coverage:

Structures >16' in height: 1,576 SF = 26.22% (complies with 35% limit)
Structures <16' in height: 281 SF = 4.6% (complies with 50% limit)
Hardscape: 94 SF = 1.5% (complies with 10% limit)

Total: 1,670 SF (28%)

Driveway (pervious) area: **752 SF** 

REVISION:

DESCRIPTION

PLN2021-00187 CYCLE 2 8/5/2021 PLN2021-00187 CYCLE 3 12/21/2021

DATE

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ARCHITE

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COUNTY APPROVAL STAMP

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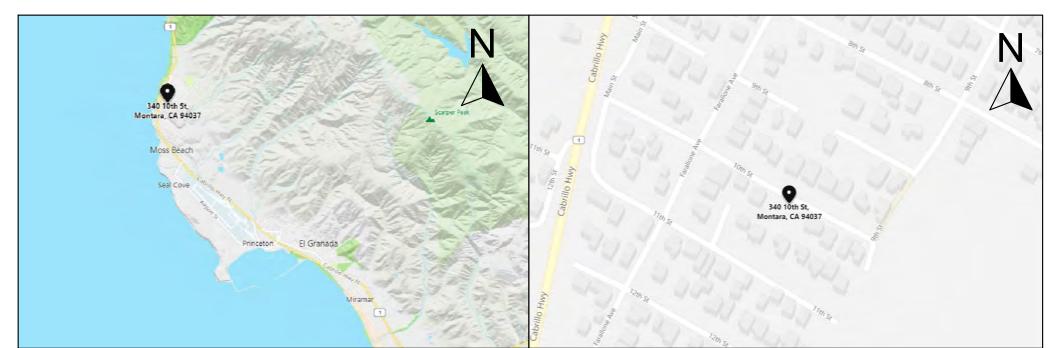
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DRAWING TITLE: LOT COVERAGE DIAGRAM

DRAWING NO: A003

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#### PROJECT LOCATION MAP

#### **VICINITY MAP**

#### BASIS OF BEARINGS:

THE BEARING, SOUTH 61°17'53" EAST, OF THE CENTERLINE OF 10TH STREET, AS SHOWN ON THAT CERTAIN RECORD OF SURVEY WHICH WAS FILED FOR RECORD IN BOOK 23 OF LLS MAPS PAGE 87 ON JUNE 20, 2002, SAN MATEO COUNTY RECORDS., WAS USED AS THE BASIS OF BEARINGS FOR THIS SURVEY.

#### **BENCHMARK:**

ELEVATIONS SHOWN HEREON ARE BASED UPON NGVD 29 ("MEAN SEA LEVEL" DATUM. SITE BENCHMARK IS THE SANITARY SEWER MANHOLE LID WITH AN ELEVATION OF 200.75 FEET.

#### **SURVEY NOTES:**

BGT RELIED UPON A LAWYERS TITLE COMPANY PRELIMINARY TITLE REPORT, ORDER NO. 0051900303, AS TITLE REFERENCE NO EASEMENTS WERE REFERENCED WITHIN SAID REPORT.

UTILITIES SHOWN HEREON TAKEN FROM VISUAL SURFACE EVIDENCE AND SHOULD BE CONSIDERED AS APPROXIMATE ONLY. ACTUAL LOCATIONS OF UTILITIES MAY VARY. TRUE LOCATION OF UTILITIES CAN ONLY BE OBTAINED BY EXPOSING THE UTILITY.

SURVEY PERFORMED BY: BGT LAND SURVEYING www.bgtsurveying.com

#### STATEMENT OF RESPONSIBILITY:

- 1. CONTRACTOR AGREES THAT HE SHALL ASSUME SOLE AND COMPLETE RESPONSIBILITY FOR JOB SITE CONDITIONS DURING THE COURSE OF CONSTRUCTION OF THIS PROJECT, INCLUDING SAFETY OF ALL PERSONS AND PROPERTY; THAT THIS REQUIREMENT SHALL APPLY CONTINUOUSLY AND NOT BE LIMITED TO NORMAL WORKING HOURS AND THAT THE CONTRACTOR SHALL DEFEND, INDEMNIFY AND HOLD THE OWNER AND THE ENGINEER HARMLESS FROM ANY AND ALL LIABILITY, REAL OR ALLEGED, IN CONNECTION WITH THE PERFORMANCE OR WORK ON THIS PROJECT.
- 2. PROTECT TREES TO REMAIN, UNLESS OTHERWISE NOTED, BOTH ON-SITE AND ADJACENT PROPERTIES.
- 3. PROTECT NEIGHBORING PROPERTIES FROM DAMAGE DURING CONSTRUCTION.
- 4. IT IS THE CONTRACTOR'S RESPONSIBILITY TO MAINTAIN AND PRESERVE THE EXISTING MONUMENTS OF RECORD. SHOULD THE CONTRACTOR DESTROY OR DISTURB ANY MONUMENTS OF RECORD, THE CONTRACTOR SHALL, AT ITS SOLE EXPENSE, RETAIN A CALIFORNIA LICENSED LAND SURVEYOR TO REPLACE SAID MONUMENTS AND FILE AN APPROPRIATE CORNER RECORD.
- 5. CONTRACTOR SHALL REPLACE OR REPAIR, AT HIS OWN EXPENSE, ALL DAMAGED, REMOVED OR OTHERWISE DISTURBED EXISTING UTILITIES, OR IMPROVEMENTS IN KIND.
- 6. THE CONTRACTOR SHALL COMPLY WITH ALL OSHA REQUIREMENTS RELATED TO SHORING OF EXCAVATIONS.
- 7. CONTRACTOR SHALL CLEAN STREETS TO REMOVE ACCUMULATION OF MUD AND DEBRIS RESULTING FORM CONSTRUCTION ACTIVITIES.
- 8. THE CONTRACTOR IS RESPONSIBLE FOR CONFORMING TO EXISTING PAVEMENT, ADJACENT LANDSCAPE AND OTHER IMPROVEMENTS WITH A SMOOTH TRANSITION IN PAVING, CURBS, GUTTERS, SIDEWALK, ETC. TO AVOID ABRUPT OR APPARENT CHANGES IN GRADES OR CROSS SLOPES, LOW SPOTS OR HAZARDOUS CONDITIONS
- 9. CONTRACTOR TO OBTAIN REQUIRED PERMITS FOR HAUL ROUTES PRIOR TO DEMOLITION AND CONSTRUCTION.
- 10. CONTRACTOR IS RESPONSIBLE FOR SCHEDULING ALL INSPECTIONS AS REQUIRED.
- 11. THE CONTRACTOR SHALL TAKE ALL NECESSARY PRECAUTIONS TO PRESERVE AND PROTECT THOSE TREES AND ANY FENCES WHICH MAY BE REQUIRED TO REMAIN BY THE OWNER.

#### PERVIOUS CONCRETE REQUIREMENTS:

#### CONTRACTOR OR PERMITEE SHALL:

- . PROVIDE CERTIFICATION FROM THE CONCRETE MANUFACTURER THAT THE CONCRETE MEETS THE REQUIREMENTS OF THE C3 STORMWATER HANDBOOK FOR PERVIOUS CONCRETE. THIS INCLUDES, BUT IS NOT LIMITED TO, HAVING A MINIMUM SURFACE INFILTRATION RATE OF 100 INCHES PER HOUR WHEN TESTED IN ACCORDANCE WITH ASTM C1701
- 2. ONLY CONTRACTORS HOLDING CERTIFICATION OF COMPLETION FROM THE NATIONAL READY MIX CONCRETE ASSOCIATION (NRMA) SHALL INSTALL THE CONCRETE AND AT LEAST ONE FOREMAN WITH THIS CERTIFICATION MUST BE ON THE JÓB SITE AT ALL TIMES DURING CONCRETE INSTALLATION.
- 3. PROTECT THE EXCAVATED AREA FROM EXCESSIVE COMPACTION DUE TO CONSTRUCTION TRAFFIC AND PROTECT THE FINISHED PAVEMENT FROM CONSTRUCTION TRAFFIC.

#### MAINTENANCE:

- 1. A MAINTENANCE PLAN SHALL BE PROVIDED
- 2. KEEP LANDSCAPED AREAS WELL MAINTAINED.
- 3. PREVENT SOIL FROM WASHING ONTO THE PAVEMENT. PERVIOUS PAVEMENT SURFACE SHALL BE VACUUM CLEANED USING COMMERCIALLY AVAILABLE SWEEPING MACHINES AT FOLLOWING TIMES: -END OF WINTER (APRIL)
  - -MID-SUMMER (JULY / AUGUST)
- -AFTER AUTUMN LEAF-FALL (NOVEMBER)
- 4. INSPECT OUTLETS YEARLY, PREFERABLY BEFORE WET SEASON. REMOVE ACCUMULATED TRASH/DEBRIS.
- 5. WHEN VACUUM CLEANING, INSPECT PERVIOUS PAVING FOR ANY SIGNS OF HYDRAULIC FAILURE.

#### AS NEEDED MAINTENANCE:

- 1. IF ROUTINE CLEANING DOES NOT RESTORE INFILTRATION RATES, THEN RECONSTRUCTION OF PART OF THE PERVIOUS SURFACE MAY BE REQUIRED.
- 2. THE SURFACE AREA AFFECTED BY HYDRAULIC FAILURE SHOULD BE LIFTED, IF POSSIBLE, FOR INSPECTION OF THE INTERNAL MATERIALS TO IDENTIFY THE LOCATION AND EXTENT OF BLOCKAGE.
- 3. LIFT AND REPLACE SURFACE MATERIALS AS NEEDED TO RESTORE INFILTRATION.
- GEOTEXTILES MAY NEED COMPLETE REPLACEMENT. 4. SUB-SURFACE LAYERS MAY NEED CLEANING AND REPLACING.
- 5. REMOVED SILTS MAY NEED TO BE DISPOSED OF AS CONTROLLED WASTE.

#### **EARTHWORK QUANTITIES** CUT: FILL: 309 CY EXPORT:

NOTE: EARTHWORK QUANTITIES SHOWN ARE APPROXIMATE

SHALL BE THE CONTRACTOR'S RESPONSIBILITY TO

IMPORT:

SHEET IN	DEX:
SHEET NO.	DESCRIPTION
C001	COVER SHEET
C002	GRADING & DRAINAGE PLAN
C003	UTILITY PLAN
C004	CROSS SECTIONS
C005	CONSTRUCTION DETAILS
C006	CONSTRUCTION DETAILS
C007	CONSTRUCTION DETAILS
C008	EROSION AND SEDIMENT CONTROL PLAN
C009	EROSION AND SEDIMENT CONTROL DETAILS











**ABBREVIATIONS:** 

3S	BOTTOM STEP
sW	BOTTOM OF WALL
X	EXISTING
F	FINISHED FLOOR
G	FINISHED GRADE
Ľ	FLOW LINE
IMA - A	HOT MIX ASPHALT (TYPE A
٧V	INVERT
B	GRADE BREAK
Р	LOW POINT
	ON OFNITED

TOP OF WALL

TYPICAL

L	LOW POINT
(	ON CENTER
(	DRIGINAL GROUND
F	PORTLAND CEMENT CONCRETE
F	PROPERTY LINE
F	POLYVINYL CHLORIDE
F	RADIUS
F	RETAINING
S	STORM DRAIN
5	SUBDRAIN
7	FOP OF CURB
٦	FOP OF DECK
٦	TOP OF GRATE
7	TOP OF STEP

LOT 13

LOT 30

# LEGEND:

SITE IMPROVEMENT PLAN

× 196.67

10TH STREET

**GARAGE** 

FF 197.79

PAD 196.79

× 201.16

HOUSE

FF 198.00

PAD 196.79

LOT 32

FG XXX.XX/ ----- SUB---------SD---SD-

N 6147'53" W

LOT 31

PROPERTY LINE SPOT ELEVATION

CONSTRUCTION REFERENCE NOTE SUBDRAIN SYSTEM DRAIN PIPE SYSTEM

EXISTING BUILDING DOWNSPOUT CLEAN OUT

PERMEABLE WOOD DECK

PERVIOUS CONCRETE DRIVEWAY CONCRETE SIDEWALK AND DRIVEWAY

# **FOR REVIEW & FILING**

**NOT FOR CONSTRUCTION** 

STAMP:

× 211.33 AC

× 203.34

LOT 10

LOT 33

NO SCALE





365 FLOWER LANE MOUNTAIN VIEW. CA 94043 **FOR SALES**: PHONE: (888) 311-3015 FOR CONSTRUCTION SUPPORT: PHONE: (888) 512-3152

EMAIL: constructionsupport@designeverest.com

PROJECT NAME: PROJECT NO:

#### 2101 House on a Hill

036-031-280 340 10th Street Montara, CA 94307 ADDRESS:

PROJECT PHASE: 100% Schematic Design


DRAWN: CHECKED: ISSUE DATE: November 02, 2021

COVER SHEET DRAWING TITLE:

**UNAUTHORIZED CHANGES & USE: THE ENGINEER** PREPARING THESE PLANS WILL NOT BE RESPONSIBLE FOR, OR LIABLE FOR, UNAUTHORIZED CHANGES TO OR USES OF THESE PLANS. ALL CHANGES TO THE PLANS MUST BE IN WRITING AND MUST BE APPROVED BY THE PREPARER OF THESE PLANS.

#### GRADING/DRAINAGE NOTES:

- 1. THE DESIGN AND LOCATIONS OF SUBDRAINAGE SYSTEMS AROUND THE FOUNDATION PERIMETER ARE DEPEND ON THE AVAILABLE INFORMATION DURING DESIGN PHASE. GEOTECHNICAL CONSULTANT SHALL REVIEW AND PROVIDE THE RECOMMENDATIONS BEFORE GRADING WORKS BEGIN.
- 2. IT IS EXTREMELY IMPORTANT THAT STRONG MEASURES BE TAKEN TO CONTROL AND CONDUCT ALL SURFACE AND SUBSURFACE WATERS AWAY FROM THE PROJECT SITE SO THAT THEY DO NOT ADVERSELY AFFECT THE FOUNDATION OF THE STRUCTURE OR THE STABILITY OF ADJACENT SLOPES, AND THAT ALL DRAINAGE FACILITIES BE DILIGENTLY MAINTAINED
- 3. PROTECTIVE NATURAL VEGETATION, AND EVEN PLANTING TREES AND SHRUBS ON BARREN SLOPES WILL ALSO HELP TO MAINTAIN SLOPE STABILITY AND LIMIT EROSION.
- 4. THE CONTRACTOR SHALL POTHOLE AND VERIFY LOCATIONS AND ELEVATIONS OF ALL CONNECTIONS TO EXISTING UNDERGROUND FACILITIES BEFORE ANY CONSTRUCTION. THE ENGINEER MUST BE NOTIFIED IMMEDIATELY IF CONDITIONS DIFFER FROM THOSE SHOWN ON THE PLANS SO THAT DESIGN CHANGES CAN BE MADE.
- 5. IT IS THE CONTRACTOR'S RESPONSIBILITY TO VERIFY THE LOCATIONS OF ALL EXISTING UNDERGROUND UTILITIES AND DRAIN PIPES. CALL USA (UNDERGROUND SERVICE ALERT) 2 WORKING DAYS BEFORE DIGGING AT 811. LOCATIONS SHOWN ON THE PLANS WERE TAKEN FROM AVAILABLE RECORDS AND ARE APPROXIMATE AND SHOWN FOR GENERAL INFORMATION ONLY, AND MAY BE INCOMPLETE RELOCATION OR REPAIR OF ANY DAMAGE TO UTILITIES OR PIPELINES AND PLUGGING OR REMOVAL OF ABANDONED LINES SHALL BE THE CONTRACTOR'S RESPONSIBILITY.
- 6. CONSTRUCTION ENTRANCES SHALL BE INSTALLED PRIOR TO COMMENCEMENT OF GRADING. ALL CONSTRUCTION TRAFFIC ACCESSING AND EXITING THE SITE MUST CROSS THE STABILIZED CONSTRUCTION ENTRANCE WAYS.
- 7. INFORMATION REGARDING EXISTING UTILITIES IS FROM RECORD DATA AND MAY NOT REPRESENT ACTUAL CONDITIONS. CONTRACTOR SHALL CONDUCT FIELD EVALUATION OF ALL EXISTING SUBSURFACE IMPROVEMENTS AND UTILITIES, WHETHER SHOWN ON THESE PLANS OR NOT. PRIOR TO THE COMMENCEMENT OF WORK
- 8. THE CONTRACTOR SHALL TAKE ALL PRECAUTIONS NECESSARY TO AVOID PROPERTY DAMAGE TO ADJACENT PROPERTIES DURING THE CONSTRUCTION PHASE OF THE PROJECT. THE CONTRACTOR WILL BE HELD RESPONSIBLE FOR ANY DAMAGES TO ADJACENT PROPERTIES OCCURRING DURING THE CONSTRUCTION PHASE OF THE PROJECT
- 9. THE CONTRACTOR WILL BE RESPONSIBLE FOR PROVIDING AND MAINTAINING TRAFFIC CONTROL DEVICES SUCH AS BARRICADES, WARNING SIGNS, DIRECTIONAL SIGNS, FLAGMEN AND LIGHTS TO CONTROL THE MOVEMENT OF TRAFFIC WHERE NECESSARY. PLACEMENT OF THESE DEVICES SHALL BE APPROVED BY THE COUNTY/CITY ENGINEER PRIOR TO PLACEMENT. TRAFFIC CONTROL DEVICES SHALL CONFORM TO THE APPROPRIATE CALIFORNIA MUTCD (MANUAL ON UNIFORM TRAFFIC CONTROL DEVICES)
- 10.IN ACCORDANCE WITH GENERALLY ACCEPTED CONSTRUCTION PRACTICES, THE CONTRACTOR WILL BE SOLELY AND COMPLETELY RESPONSIBLE FOR CONDITIONS ON THE JOB SITE, INCLUDING SAFETY OF ALL PERSONS AND PROPERTY DURING THE PERFORMANCE OF THE WORK. THIS REQUIREMENT WILL APPLY CONTINUOUSLY AND NOT BE LIMITED TO NORMAL WORKING HOURS.
- 11. THE CONTRACTOR SHALL BE REQUIRED TO OBTAIN ALL PERMITS FROM AUTHORITIES AND REGULATORY AGENCIES HAVING JURISDICTION OVER THE SITE, AS REQUIRED, PRIOR TO BEGINNING WORK.
- 12. BEFORE BEGINNING CONSTRUCTION, THE CONTRACTOR SHALL COMPLY WITH THE EROSION CONTROL PLAN AND PERMIT
- 13. MINIMIZE INTERFERENCE WITH ADJOINING ROADS, STREETS, WALKS, AND OTHER ADJACENT OCCUPIED OR USED FACILITIES DURING EARTH MOVING OPERATIONS.
- 14. DO NOT CLOSE OR OBSTRUCT STREETS, WALKS, OR OTHER ADJACENT OCCUPIED OR USED FACILITIES WITHOUT PERMISSION FROM OWNER AND AUTHORITIES HAVING JURISDICTION.
- 15. PROVIDE ALTERNATE ROUTES AROUND CLOSED OR OBSTRUCTED TRAFFIC WAYS IF REQUIRED BY OWNER OR AUTHORITIES HAVING JURISDICTION.
- 16. DO NOT CONDUCT WORK ON ADJOINING PROPERTY UNLESS DIRECTED BY ENGINEER.
- 17. DO NOT COMMENCE EARTH-MOVING OPERATIONS UNTIL TEMPORARY EROSION- AND SEDIMENTATION-CONTROL MEASURES ARE IN PLACE.
- 18. PROTECT STRUCTURES, UTILITIES, SIDEWALKS, PAVEMENTS, AND OTHER FACILITIES FROM DAMAGE CAUSED BY SETTLEMENT, LATERAL MOVEMENT, UNDERMINING, WASHOUT, AND OTHER HAZARDS CREATED BY EARTH MOVING OPERATION
- 19. PROTECT AND MAINTAIN EROSION AND SEDIMENTATION CONTROLS DURING EARTH MOVING OPERATIONS
- 20. PROTECT SUBGRADES AND FOUNDATION SOILS FROM FREEZING TEMPERATURES AND FROST. REMOVE TEMPORARY PROTECTION BEFORE PLACING SUBSEQUENT MATERIALS.
- 21. EXCAVATE BY HAND AROUND TREE TO INDICATED LINES, CROSS SECTIONS, ELEVATIONS, AND SUBGRADES. USE NARROW—TIME SPADING FORKS TO COMB SOIL AND EXPOSE ROOTS. DO NOT BREAK, TEAR, OR CHOP EXPOSED ROOTS, DO NOT USE MECHANICAL EQUIPMENT THAT RIPS. TEARS. OR PULLS ROOTS.
- 22. UNIFORMLY GRADE AREAS TO A SMOOTH SURFACE, FREE OF IRREGULAR SURFACE CHANGES. COMPLY WITH COMPACTION REQUIREMENTS AND GRADE TO CROSS SECTIONS. LINES. AND ELEVATIONS INDICATED
- 23.PROVIDE A SMOOTH TRANSITION BETWEEN ADJACENT EXISTING GRADES AND NEW GRADES
- 24. CONTRACTOR SHALL GRADE EVENLY BETWEEN SPOT ELEVATIONS SHOWN.
- 25.NO CUT OR FILL SLOPES MAY BE STEEPER THAN 2:1 (H: V) MAXIMUM
- 26.IN THE EVENT ADVERSE BEDDING PLANES ARE DISCOVERED DURING CONSTRUCTION REQUIRING SLOPE STABILIZATION TECHNIQUES. SUCH WORK SHALL BE APPROVED BY THE COUNTY ENGINEER UNDER A REVISED GRADING PLAN AND CHANGE ORDER.
- 27. FINE GRADING AROUND STRUCTURES SHALL DRAIN AWAY FROM FOOTINGS, TO THE SATISFACTION OF THE COUNTY INSPECTOR, TO SWALES WITH 1% MINIMUM SLOPE TO APPROVED DRAINAGE POINTS OR NOTED OTHERWISE ON PLANS.
- 28. ANY CHANGES IN THE WORK SHOWN HEREON SHALL BE SUBJECT TO THE APPROVAL OF THE COUNTY ENGINEER.
- 29.NO STOCKPILING AND/OR IMPORT/EXPORT HAULING SHALL BE PERMITTED UNLESS APPROVED ON THE GRADING PERMIT.
- 30. THE PERMITTEE SHALL EMPLOY A REGISTERED CIVIL ENGINEER OR SOIL ENGINEER TO PROVIDE CONSTANT ON-SITE GRADING SUPERVISION TO ASSURE COMPLIANCE WITH THE APPROVED PLANS.
- 31. WHERE IMPORT MATERIALS ARE REQUIRED FOR USE ON SITE, THE SOILS ENGINEER SHOULD BE NOTIFIED AT LEAST 48 HOURS IN ADVANCE OF IMPORTING IN ORDER TO SAMPLE AND TEST MATERIALS FROM PROPOSED BORROW SITES.
- 32. AREAS TO RECEIVE FILL OR FLATWORK SHALL BE CLEARED OF VEGETATION AND STRIPPED TO A SUFFICIENT DEPTH TO REMOVE MAJOR ROOT SYSTEMS. THE STRIPPED ORGANIC TOP SOIL MATERIAL MAY BE STOCK PILED FOR LATER USE IN LANDSCAPING AREAS.
- 33.PERMANENT CUT SLOPES SHALL BE AT A MAXIMUM INCLINATION OF 2:1 (HORIZONTAL TO VERTICAL) OR SHALL BE RETAINED BY STRUCTURAL WALLS.
- 34. FILLS PLACED ON SLOPING GRADES SHALL BE KEYED INTO FIRM SOIL AT THE BASE (OR RETAINED BY ENGINEERED WALLS), AND PROGRESSIVELY STEP-BENCHED UP THE SLOPE. THE GEOTECHNICAL ENGINEER SHALL INSPECT AND APPROVE THE SUBGRADE PREPARATION PRIOR TO PLACEMENT OF FILL. FILLS SHALL BE PLACED IN LEVEL LIFTS NO MORE THAN 8 INCHES IN THICKNESS, AND SHALL BE COMPACTED TO 95% RELATIVE COMPACTION UNDER ALL BUILDING AND PAVEMENT AREAS, AND TO 90% RELATIVE COMPACTION UNDER ALL OTHER AREAS. EXISTING SITE SOILS ARE SUITABLE AS FILL PROVIDED THEY ARE FREE OF ORGANIC MATERIAL AND ROCKS OR RUBBLE OVER 6 INCHES IN DIAMETER
- 35.DRAINAGE SYSTEM REQUIRE REGULAR MAINTENANCE TO ENSURE PROPER FUNCTIONING. CATCH BASINS AND DOWNSPOUT PIPES SHOULD BE FLUSHED REGULARLY (DEPENDANT ON THE RATE OF FALLING LEAF LITTER). IT IS CRITICAL THAT OUTLET DISSIPATERS/DRAINAGE BASINS BE INSPECTED AND FLUSHED APPLICABLE FACILITIES ON A REGULAR BASIS. IT IS RECOMMENDED THAT AN ACCURATE AS-BUILT PLAN OF THE DRAINAGE SYSTEMS BE PREPARED, AND THAT MAINTENANCE REQUIREMENTS BE DISCLOSED TO ALL FUTURE BUYERS OF THE PROPERTY.
- 36.IT IS RECOMMENDED THAT A TEMPORARY SHORING SYSTEM BE CONSTRUCTED AROUND THE BASEMENT AREA, FOR THE SAFETY OF THE CONSTRUCTION WORKERS AND FOR THE PROTECTION OF THE NEIGHBORS' EXISTING STRUCTURES.
- 37. PRIOR TO GRADING, THE PROPOSED STRUCTURE AND PAVEMENT AREAS SHOULD BE CLEARED OF ALL OBSTRUCTIONS, AND DELETERIOUS MATERIALS. THE EXISTING FOUNDATION AND PIPES SHOULD BE REMOVED. AFTER CLEARING, THESE AREAS SHOULD BE STRIPPED OF ALL ORGANIC TOPSOIL. THE PREDOMINANTLY ORGANIC MATERIALS GENERATED FROM THE STRIPPING SHOULD BE REMOVED FROM THE SITE.
- 38. AFTER THE ORGANIC TOPSOIL HAS BEEN STRIPPED, THE PROPOSED PAD AND BASEMENT AREA CAN BE EXCAVATED. THE TOP 8 INCHES OF THE BASEMENT AND GARAGE SUBGRADE SOIL SHOULD BE SCARIFIED, WATERED OR AERATED AS NECESSARY TO BRING THE SOIL TO ABOUT 2 PERCENT ABOVE THE OPTIMUM MOISTURE CONTENT, THE SUBGRADE SHOULD THEN BE UNIFORMLY RECOMPACTED TO AT LEAST 90 PERCENT RELATIVE COMPACTION. RELATIVE COMPACTION IS BASED ON THE MAXIMUM DRY DENSITY AS DETERMINED BY ASTM D1557 LATEST VERSION LABORATORY TEST PROCEDURE.

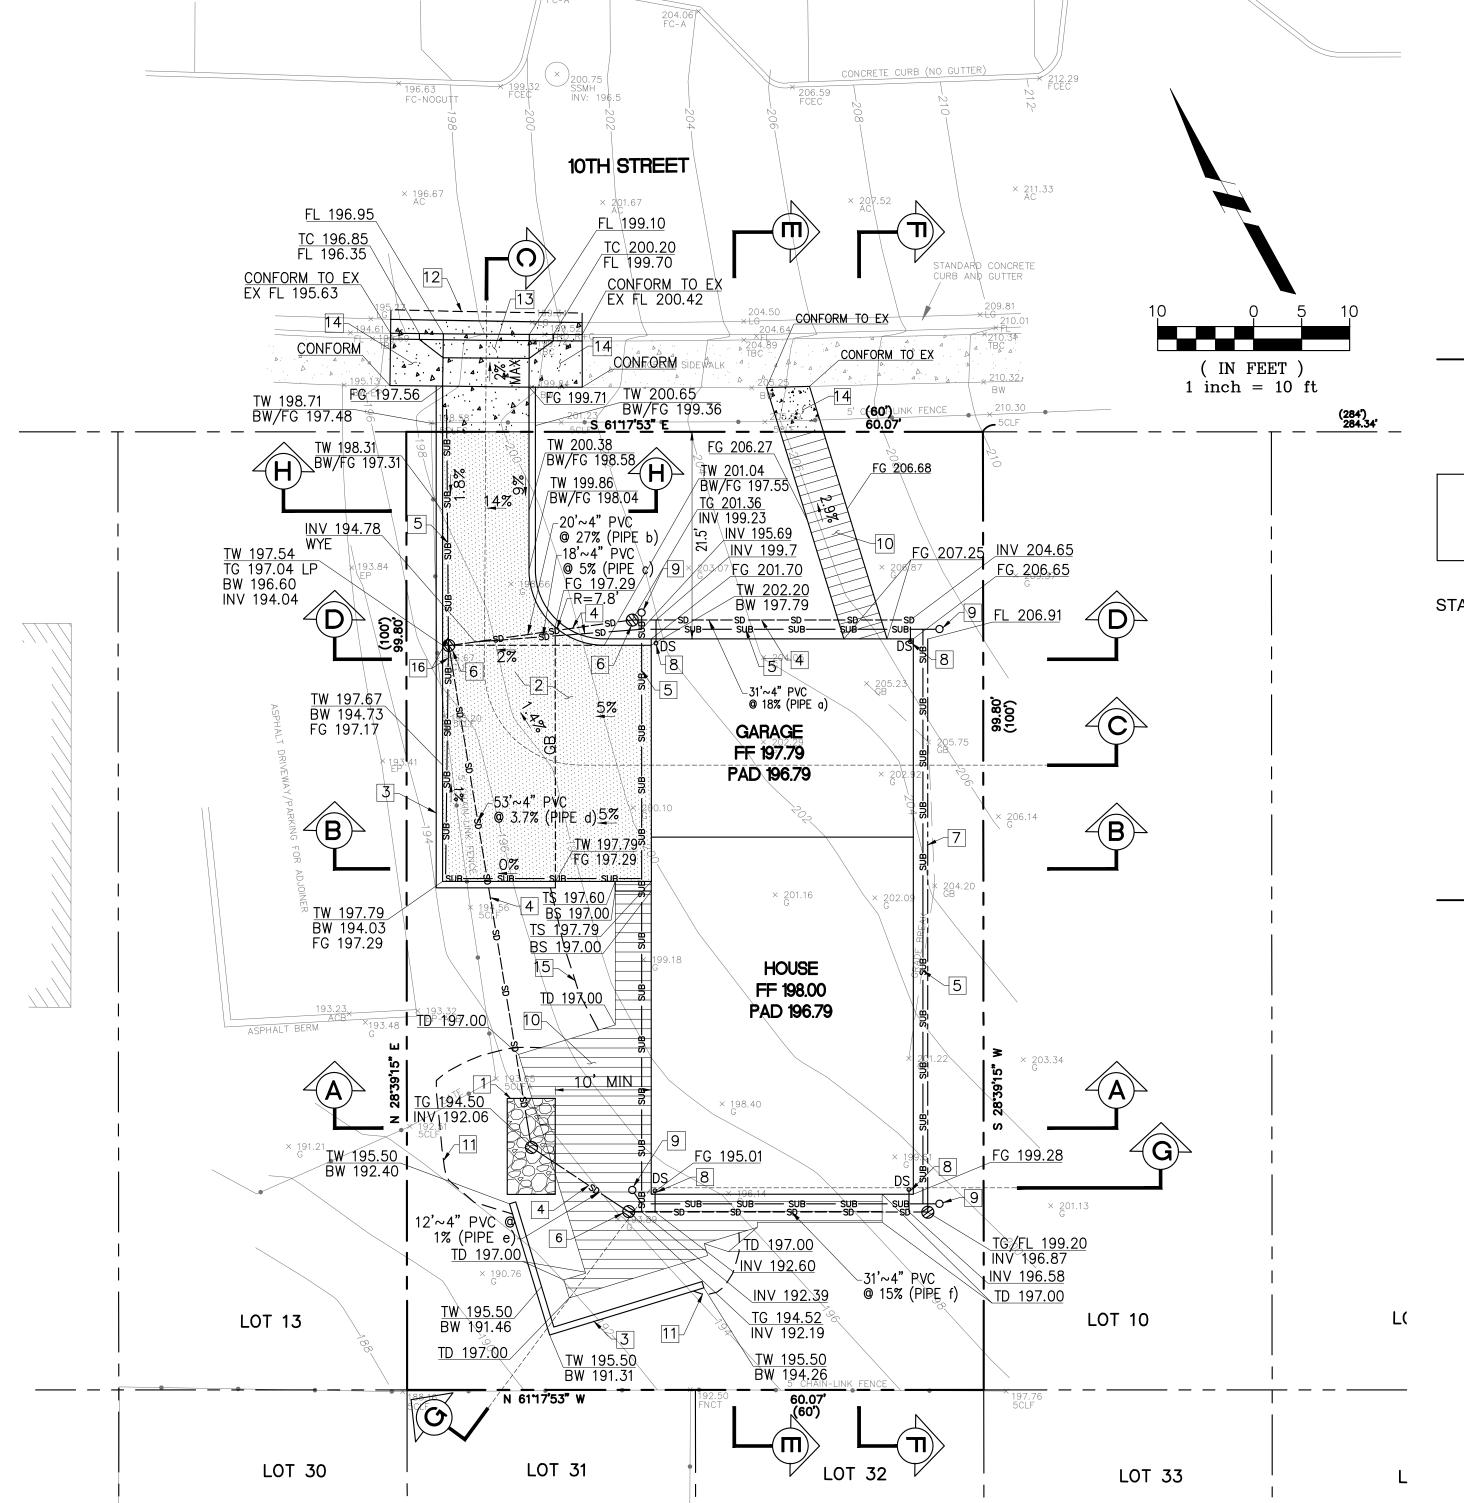

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## FOR REVIEW & FILING NOT FOR CONSTRUCTION

STAMP:

**REVISION:** 





365 FLOWER LANE MOUNTAIN VIEW, CA 94043 **FOR SALES**:

PHONE: (888) 311-3015 FOR CONSTRUCTION SUPPORT: PHONE: (888) 512-3152

EMAIL: constructionsupport@designeverest.com

## **CONSTRUCTION NOTES:**

- 1 GRAVEL BASIN 10'X5'X2' (SEE DETAIL 2 ON SHEET CO05)
- 2 PERVIOUS CONCRETE DRIVEWAY (SEE DETAIL 4 ON SHEET COO5)
- 3 RETAINING WALL (SEE STRUCTURAL PLAN)
- 4 | INSTALL 4" (SDR-35 PVC) NON-PERFORATED PIPE
- | INSTALL 4" (SDR-35 PVC) PERFORATED SUBDRAIN PIPE (SEE  $\stackrel{\smile}{\longrightarrow}$  Detail 5 on sheet coo5 for subdrain pipe behind wall)
- 6 INSTALL STANDARTPARK CATCH BASIN OR APPROVED EQUAL (SEE DETAIL 1 ON SHEET COO5)
- 7 | CONSTRUCT GRAVEL SWALE (SEE DETAIL 3 ON SHEET COO5)
- CONNECT DOWNSPOUT FROM ROOF TO UNDERGROUND STORM DRAIN PIPE (SEE DETAIL 7 ON SHEET COO5)
- 9 SUBDRAIN PIPE TO BE CONNECTED TO CLEAN OUT RISER THAT EXTEND TO SURFACE
- (SEE DETAIL 6 ON SHEET COO5) 10 PERMEABLE WOOD DECK (SEE ARCHITECTURE'S PLANS)
- | 11 | FILL CATCH POINT
- 12 1' SAWCUT & CONFORM
- 13 CONSTRUCT DRIVEWAY APPROACH (SEE SAN MATEO COUNTY Std DETAILS D-1)
- CONSTRUCT SIDEWALK, CURB & GUTTER AND TRANSITION TO EXISTING
- $\Box$  (SEE SAN MATEO COUNTY Std DETAILS D-3)
- 15 CUT DAYLIGHT
- 16 CONNECT SUBDRAIN PIPES TO CATCH BASIN

PROJECT NAME: PROJECT NO:

#### 2101 House on a Hill

036-031-280 340 10th Street **PROJECT** 

Montara, CA 94307 ADDRESS: PROJECT PHASE: 100% Schematic Design

DRAWN: CHECKED:


ISSUE DATE: November 02, 2021

GRADING AND DRAINAGE PLAN DRAWING TITLE:

**UNAUTHORIZED CHANGES & USE: THE ENGINEER** PREPARING THESE PLANS WILL NOT BE RESPONSIBLE FOR, OR LIABLE FOR, UNAUTHORIZED CHANGES TO OR USES OF THESE PLANS. ALL CHANGES TO THE PLANS MUST BE IN WRITING AND MUST BE APPROVED BY THE PREPARER OF THESE PLANS



- 1 TIE INTO EXISTING WATER MAIN (SEE MWSD 1" METERED SERVICE
- $\stackrel{-}{\longrightarrow}$  INSTALLATION DETAIL SD-01)
- 3 4" SEWER LATERAL PVC Sch 80 (MINIMUM 18" COVER, SEE PROFILE)
- 4 UNDERGROUND JOINT UTILITY LINE (FOR INFORMATION ONLY, SEE UTILITY — COMPANIES PLANS)
- 5 DOMESTIC SERVICE POINT OF ENTRY
- 6 JOINT UTILITY LINE POINT OF ENTRY
- 7 SEWER LATERAL POINT OF ENTRY
- 8 TYPE K COPPER TUBING 1" DOMESTIC WATER LINE (MINIMUM 36" COVER)
- INSTALL 1" WATER METER (SEE MWSD 1" METERED SERVICE INSTALLATION DETAIL SD-01)
- 10 INSTALL TYPE "A" BACKWATER PREVENTION DEVISE (SEE MWSD STANDARD  $\stackrel{\cdot}{\square}$  CLEANOUT & BACKWATER PREVENTION DEVICE STANDARD DETAIL SD-6)

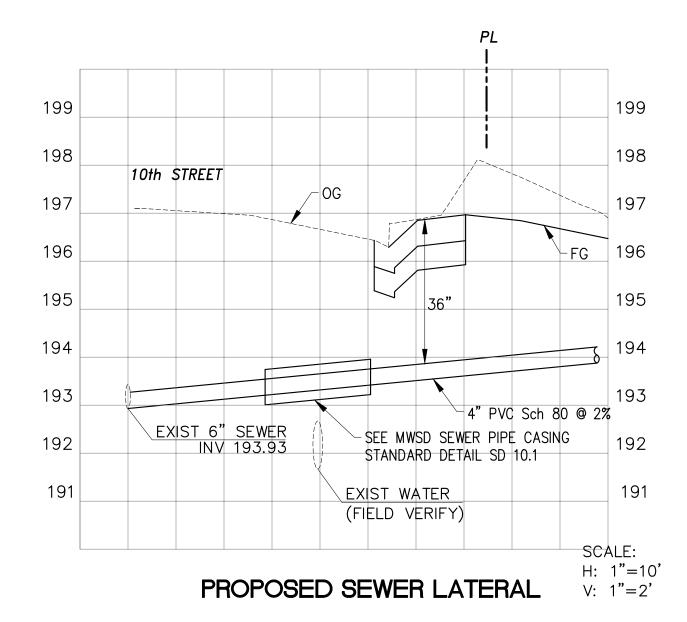

#### SANITARY SEWER SYSTEMS CONSTRUCTION NOTES:

1. IT IS THE RESPONSIBILITY OF THE PROPERTY OWNER OR HIS CONTRACTOR TO LOCATE AND UNCOVER THE LATERAL STUB OR WYE INSTALLED TO SERVE THE PROPERTY. WHEN THE LATERAL STUB OR WYE CANNOT BE LOCATED, EVEN THOUGH THE DISTRICT'S RECORDS INDICATE SUCH A CONNECTION EXISTS, THE LATERAL SEWER MUST BE CONNECTED TO THE MAIN SEWER AT A LOCATION DESIGNATED BY THE DISTRICT AT THE EXPENSE OF THE PROPERTY OWNER AS REQUIRED IN SECTION 3-10 OF THIS SPECIFICATION. THE DISTRICT DOES NOT GUARANTEE THE PRESENCE OR LOCATION OF LATERAL STUBS OR WYES

2. LATERAL SEWERS MUST BE LAID BY THE SHORTEST ROUTE FROM THE BUILDING PLUMBING OUTLET TO CONNECT TO THE MAIN SEWER AND MUST BE PERPENDICULAR TO THE PUBLIC RIGHT-OFWAY WHEN POSSIBLE. ALL PIPES MUST BE LAID TO LINE AND GRADE. EACH LENGTH OF PIPE MUST BE LAID ON A FIRM BED AS DETAILED IN STANDARD DRAWING SD-4 AND MUST HAVE FULL BEARING FOR ITS ENTIRE LENGTH BETWEEN BELLS. WHEN APPLICABLE, AN ADEQUATE BELL HOLE MUST BE DUG AT THE END OF EACH PIPE LENGTH FOR MAKING THE JOINT. BLOCKING UNDER THE LATERAL SEWER WILL NOT BE PERMITTED. THE INSIDE EDGE OF ANY CUT PIPE MUST BE BEVELED, AND BOTH BELL AND SPIGOT MUST BE MARKED FOR PROPER INSPECTION AND CLEANED BEFORE THE JOINT IS MADE. CARE MUST BE TAKEN TO PREVENT FOREIGN MATERIALS FROM ENTERING THE PIPE. WATER MUST BE PUMPED FROM THE TRENCH WHILE THE PIPES ARE LAID AND THE JOINTS MADE. BACKFILL MUST BE CAREFULLY AND UNIFORMLY PLACED AROUND THE PIPE, WITH NO ROCKS OR CLODS TOUCHING THE PIPE. IN ROCKY AREAS, IMPORTED BEDDING MATERIAL MAY BE REQUIRED. PIPE MUST NOT BE COVERED UNTIL INSPECTED BY A DISTRICT REPRESENTATIVE.

3. PRIOR TO BACKFILLING, LATERAL SEWER INSTALLATIONS AND MODIFICATIONS MUST BE INSPECTED BY A DISTRICT REPRESENTATIVE OR ENGINEER (REPRESENTATIVE). WHEN REQUIRED, TESTS FOR WATERTIGHTNESS MUST BE DONE IN THE PRESENCE OF A DISTRICT REPRESENTATIVE. CONNECTIONS TO THE MAIN SEWER MUST BE DONÉ IN THE PRESENCE OF A DISTRICT REPRESENTATIVE. INSPECTIONS MUST BE SCHEDULED WITH THE DISTRICT GIVING THREE WORKING DAYS ADVANCE NOTICE. INSPECTIONS ARE NOT MADE ON SATURDAYS, SUNDAYS, OR HOLIDAYS.

4. EXCAVATION AND BACKFILLING. TRENCHES FOR LATERAL SEWERS WITHIN PUBLIC STREETS MUST BE EXCAVATED AND BACKFILLED AND THE PAVEMENT RESTORED IN STRICT ACCORDANCE WITH THE LAWS, ORDINANCES, AND REGULATIONS OF THE STATE OF CALIFORNIA, SAN MATEO COUNTY AND/OR AGENCY HAVING JURISDICTION OVER SAID STREET. THE DISTRICT, CITY AND/OR COUNTY RESERVES THE RIGHT TO REQUIRE COMPACTION TESTS ON TRENCH BACKFILL BY A SOILS ENGINEER. THE COST OF COMPACTION TESTS MUST BE PAID BY THE CONTRACTOR OR PROPERTY OWNER.

5. IMPERVIOUS CLAY TRENCH PLUGS MUST BE CONSTRUCTED IN THE PIPE ZONE BACKFILL AT INTERVALS OF APPROXIMATELY FIFTY (50) FEET, OR AS OTHERWISE DIRECTED BY A DISTRICT. IMPERVIOUS CLAY TRENCH PLUGS MUST: A) CONSIST OF DENSE CLAY MATERIAL FREE OF ROCKS AND VEGETATION, AND B) BE MOISTURE-CONDITIONED AND MECHANICALLY COMPACTED TO THE SAME DENSITY AS THE ADJOINING BACKFILL MATERIAL.

6. TRENCHES IN GROUND SLOPING GREATER THAN FIFTY PERCENT (50%) FROM THE HORIZONTAL MUST BE PROTECTED FROM EROSION BY PLACING RIP-RAP IN CEMENT MORTAR OR CONCRETE LAID FLUSH WITH THE SLOPE OVER THE BACKFILLED TRENCH, OR OTHER PROTECTIVE MEASURES MUST BE TAKEN AS DIRECTED BY A SOILS ENGINEER AND APPROVED BY THE DISTRICT. DRAINS WHICH ARE TWO INCHES IN DIAMETER MUST BE INSTALLED IN THE CONCRETE COVERING AT FIVE-FOOT INTERVALS ALONG THE TRENCH LINE. FOR TRENCHES IN SLOPES LESS THAN FIFTY PERCENT (50%) THE DISTRICT MAY REQUIRE THE USE OF REDWOOD TRENCH DAMS OR OTHER TYPES OF EROSION CONTROL.

7. UNLESS OTHERWISE DIRECTED BY THE DISTRICT, LATERAL SEWERS MUST BE TESTED BY PLUGGING AND FILLING WITH EITHER WATER OR COMPRESSED AIR TO FOUR (4) PSI, IN ACCORDANCE WITH THE DISTRICT STANDARD SEWER SPECIFICATIONS. FOR WATER TESTS, LEAKAGE MUST NOT EXCEED 20 GALLONS PER DAY PER INCH OF INTERNAL DIAMETER PER MILE OF SEWER LINE BEING TESTED (0.07 GALLONS PER HOUR PER 100 FEET OF 4-INCH DIAMETER PIPE). FOR AIR TESTS, THE PRESSURE MUST NOT DROP MORE THAN ONE PSI OVER A THREE-MINUTE PERIOD. TESTS MUST BE PERFORMED IN THE PRESENCE OF A DISTRICT REPRESENTATIVE.

8. PRESSURE SEWERS MUST BE TESTED UNDER A PRESSURE OF NOT LESS THAN 50 PSI WITHOUT LEAKAGE FOR A PERIOD OF FIFTEEN MINUTES. AIR TESTING IS NOT ALLOWED.

9. WHEN ENCOUNTERING SPECIAL CONDITIONS WHICH ARE NOT COVERED BY THE SPECIFICATIONS HEREIN OR THE DISTRICT STANDARD SPECIFICATIONS AND/OR CODE, A DISTRICT REPRESENTATIVE AND/OR THE DISTRICT ENGINEER WILL DIRECT THE CONTRACTOR OR PROPERTY OWNER IN THE REQUIRED PROCEDURES.

#### UTILITY NOTES:


- 1. UTILITY INFORMATION FROM PLANS AND MARKINGS WAS COMBINED WITH OBSERVED EVIDENCE OF UTILITIES FROM THE FIELD AND COUNTY/DISTRICT RECORDS TO DEVELOP A VIEW OF THE UNDERGROUND UTILITIES SHOWN HEREIN.
- 3. ALL UTILITIES SHALL BE FURNISHED AND INSTALLED PER THE REQUIREMENTS OF THE SPECIFICATIONS, AND STANDARD DETAILS FROM MONTARA WATER AND SANITRAY
- 4. ALL UTILITY PIPE BEDDING SHALL BE CONSTRUCTED PER THE REQUIREMENTS OF THE MONTARA WATER AND SANITARY DISTRICT (MWSD) STANDARD SPECIFICATIONS
- AND DETAILS. 5. ALL CONNECTIONS TO EXISTING UTILITIES SHALL BE PERFORMED PER THE REQUIREMENTS OF THE UTILITY DISTRICT. THE MONTARA WATER AND SANITARY DISTRICT
- ENGINEER MUST BE NOTIFIED AT LEASE 48 HOURS PRIOR TO ANY UTILITY WORK. 6. 24 HOURS NOTICE SHALL BE GIVEN TO THE UTILITY COMPANIES, AND THE DISTRICT, BEFORE THE BEGINNING OF ANY OPERATION INVOLVING THEIR FACILITIES OR
- 7. CONTRACTOR SHALL NOTIFY AND COORDINATE WITH THE APPROPRIATE UTILITY COMPANIES PRIOR TO THE REMOVAL OF INDICATED UTILITIES ON SITE. CONTRACTOR
- SHALL BE RESPONSIBLE FOR OBTAINING ANY PERMITS REQUIRED FOR DEMOLITION AND HAUL OFF FROM THE APPROPRIATE AUTHORITIES.
- 8. BUILDING CONTRACTOR SHALL BE RESPONSIBLE FOR COORDINATION WITH THE POWER COMPANY FOR THE INSTALLATION OF ELECTRICAL CONDUIT AND CONNECTION TO
- EXISTING POWER SOURCE. 9. ALL SURPLUS EXCAVATED MATERIAL FROM THE TRENCH SHALL BE DISPOSED OFF THE SITE BY CONTRACTOR.
- 10. COORDINATE EXACT TRENCHING, ROUTING, AND POINT OF TERMINATION WITH ALL UTILITY COMPANIES.
- 11. CONTRACTOR SHALL COORDINATE ANY DISRUPTIONS TO EXISTING UTILITY SERVICES WITH ADJACENT PROPERTY OWNERS. 12. ALL ELECTRIC, TV CABLE AND TELEPHONE SERVICE LINES SHALL BE INSTALLED ACCORDING TO THE APPROPRIATE UTILITY COMPANIES SPECIFICATIONS AS APPLICABLE.
- ALL UTILITY DISCONNECTIONS SHALL BE COORDINATED WITH THE DESIGNATED UTILITY COMPANIES. 13. ALL TRENCH BACKFILL TO BE COMPACTED TO A MINIMUM OF 95 PERCENT OR AS INDICATED IN MWSD SPECIFICATIONS.

PRIOR TO PLACEMENT. TRAFFIC CONTROL DEVICES SHALL CONFORM TO THE APPROPRIATE CALIFORNIA MUTCD (MANUAL ON UNIFORM TRAFFIC CONTROL DEVICES).

- 14. THE CONTRACTOR WILL BE RESPONSIBLE FOR PROVIDING AND MAINTAINING TRAFFIC CONTROL DEVICES SUCH AS BARRICADES, WARNING SIGNS, DIRECTIONAL SIGNS, FLAGMEN AND LIGHTS TO CONTROL THE MOVEMENT OF TRAFFIC WHERE NECESSARY. PLACEMENT OF THESE DEVICES SHALL BE APPROVED BY THE COUNTY ENGINEER
- 15. PRIOR TO INSTALLATION OF STORM OR SANITARY SEWER, WATER LATERAL OR ANY OTHER UTILITIES, THE CONTRACTOR SHALL EXCAVATE, VERIFY, AND DETERMINE ALL POINTS OF CONNECTION AND ALL UTILITY CROSSINGS AND INFORM THE OWNER AND THE ENGINEER OF ANY CONFLICTS OR REQUIRED DEVIATIONS FROM THE PLAN PRIOR TO CONSTRUCTION. NOTIFICATION SHALL BE MADE A MINIMUM OF 72 HOURS PRIOR TO CONSTRUCTION, THE ENGINEER AND ITS CLIENTS SHALL BE HELD
- HARMLESS IN THE EVENT THAT THE CONTRACTOR FAILS TO MAKE SUCH NOTIFICATION. 16. SEE UTILITY COMPANIES PLANS FOR ADDITIONAL INFORMATION.

2. CONTRACTOR SHALL PROTECT EXISTING UTILITIES NOT DEEMED FOR REMOVAL.

17. NOTIFY UNDERGROUND SERVICE ALERT (USA) AT LEAST 48 HOURS PRIOR TO SITE WORK TO IDENTIFY LOCATION OF UNDERGROUND UTILITIES.

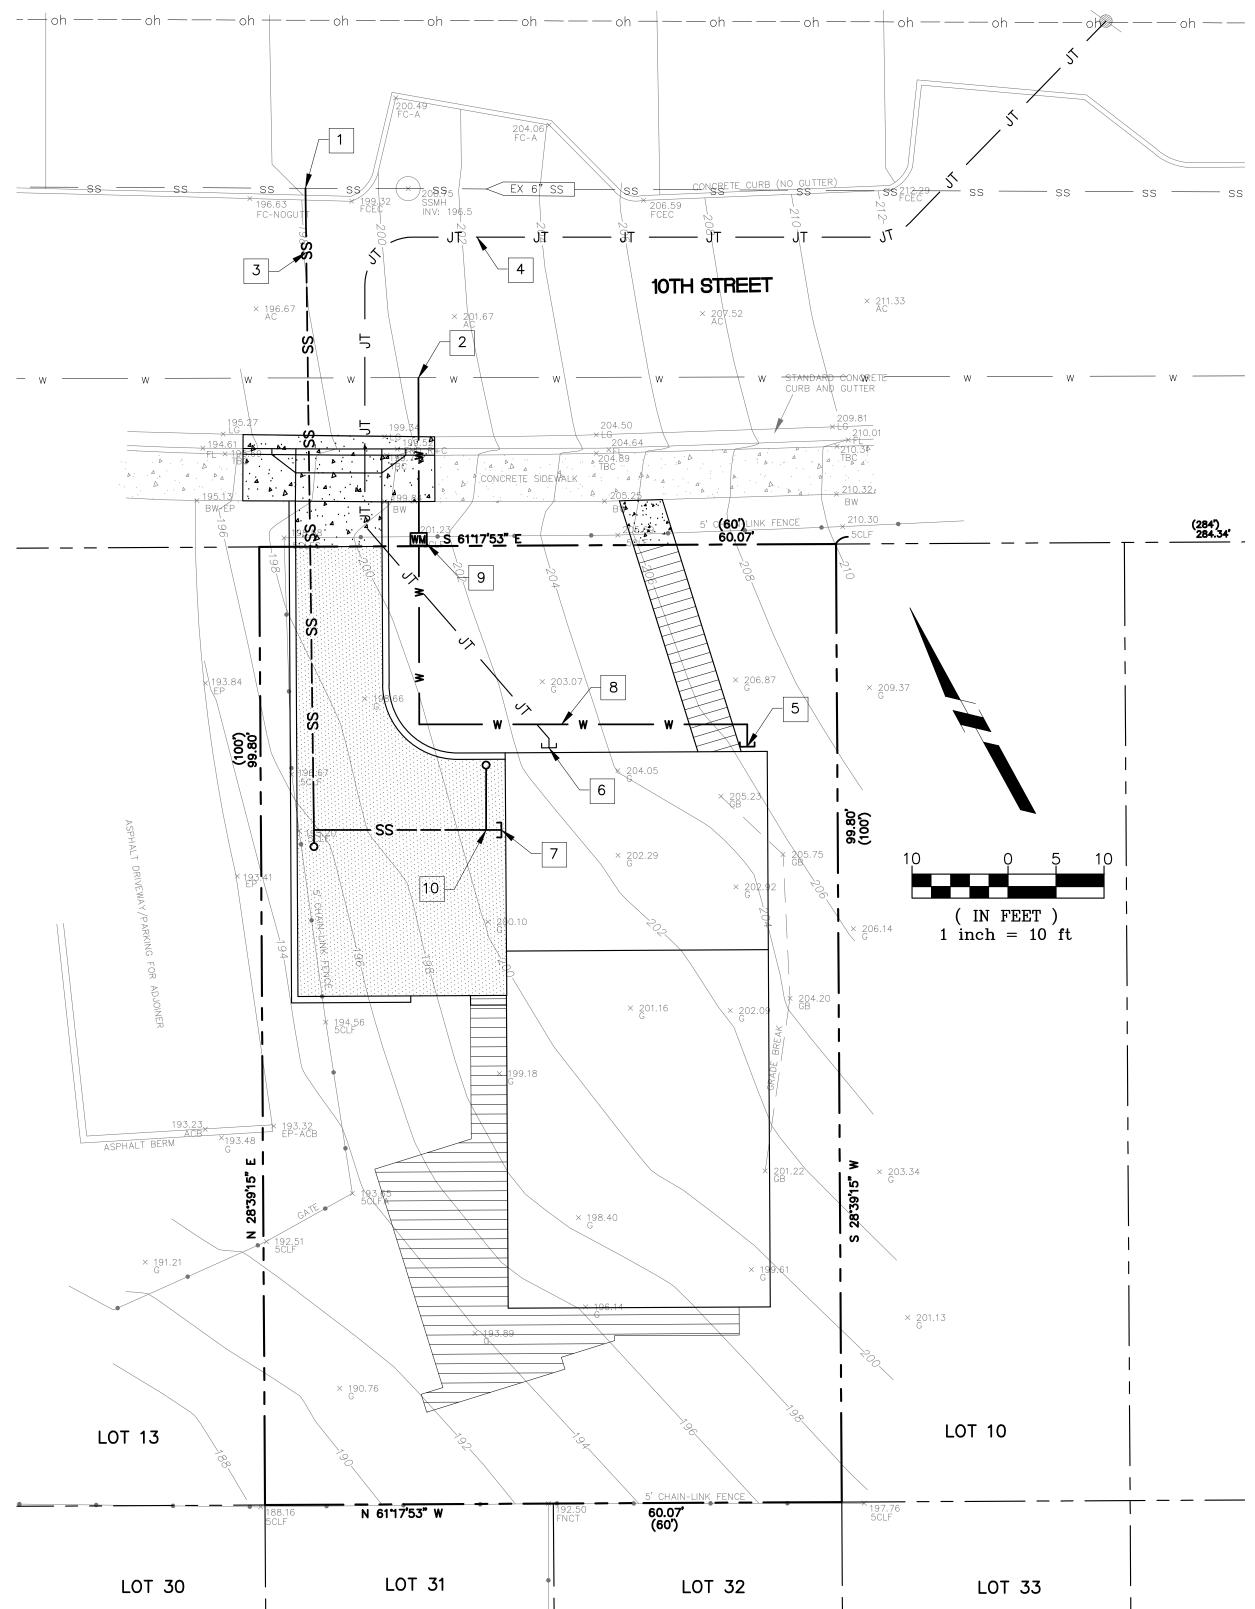



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365 FLOWER LANE MOUNTAIN VIEW, CA 94043 **FOR SALES**:

PHONE: (888) 311-3015 FOR CONSTRUCTION SUPPORT: PHONE: (888) 512-3152 EMAIL: constructionsupport@designeverest.com

PROJECT NO: PROJECT NAME:

2101 House on a Hill

036-031-280

340 10th Street **PROJECT** Montara, CA 94307 ADDRESS:

PROJECT PHASE: 100% Schematic Design


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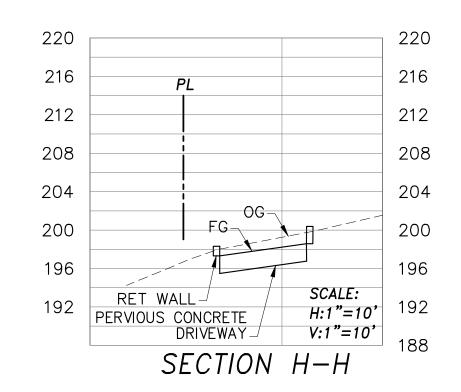
ISSUE DATE: November 02, 2021 UTILITY PLAN


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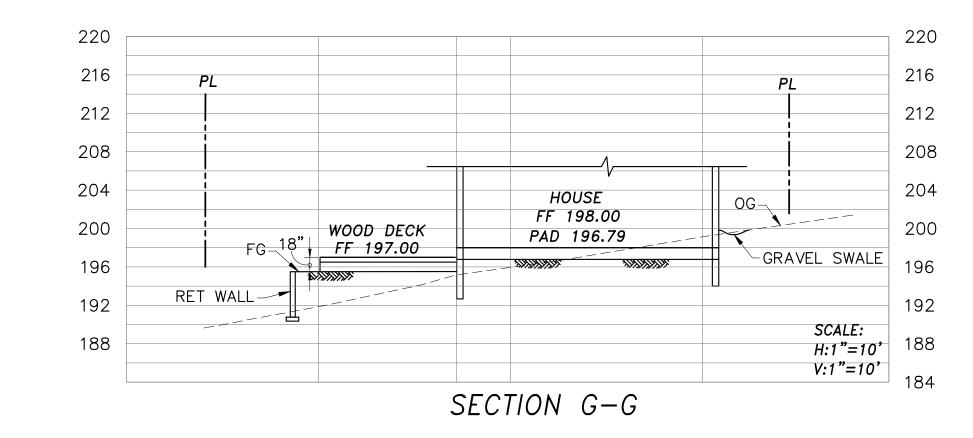
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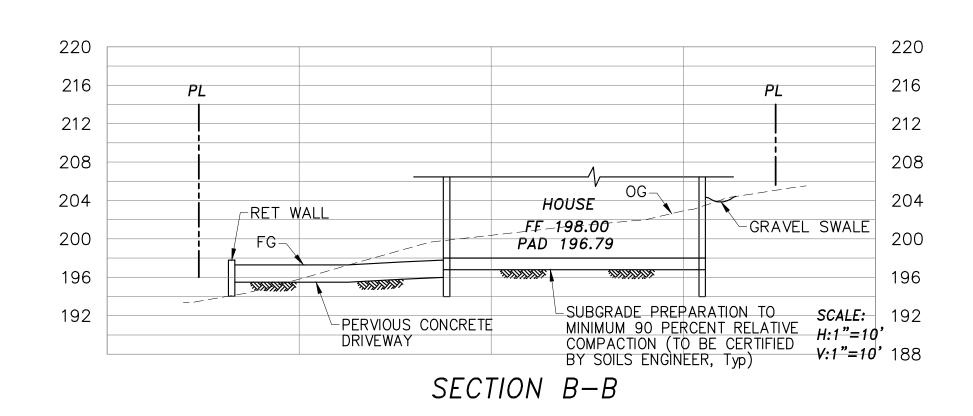











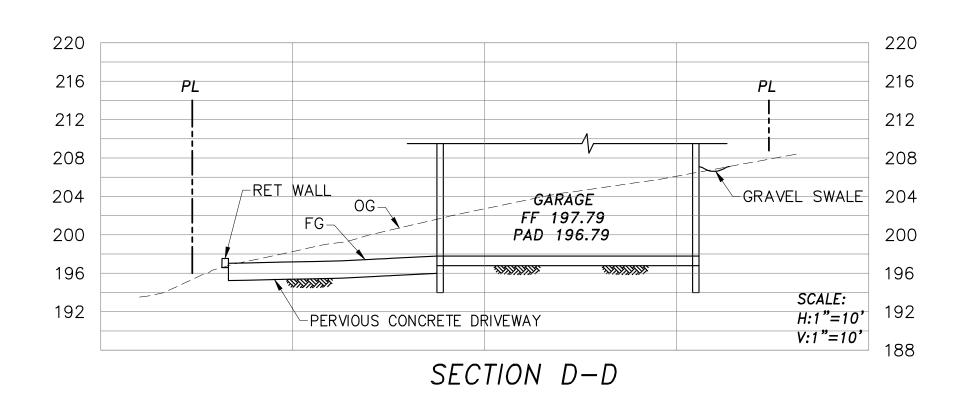

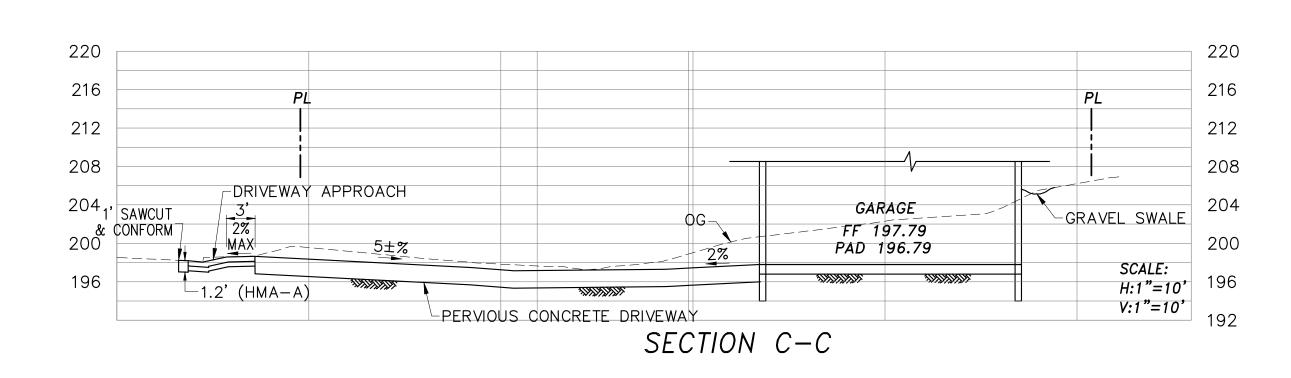

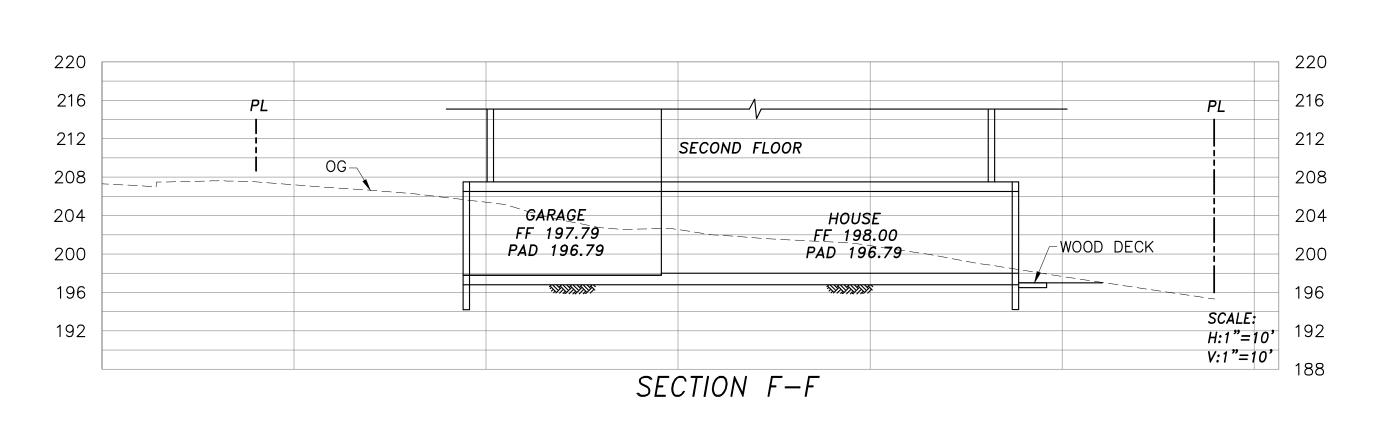

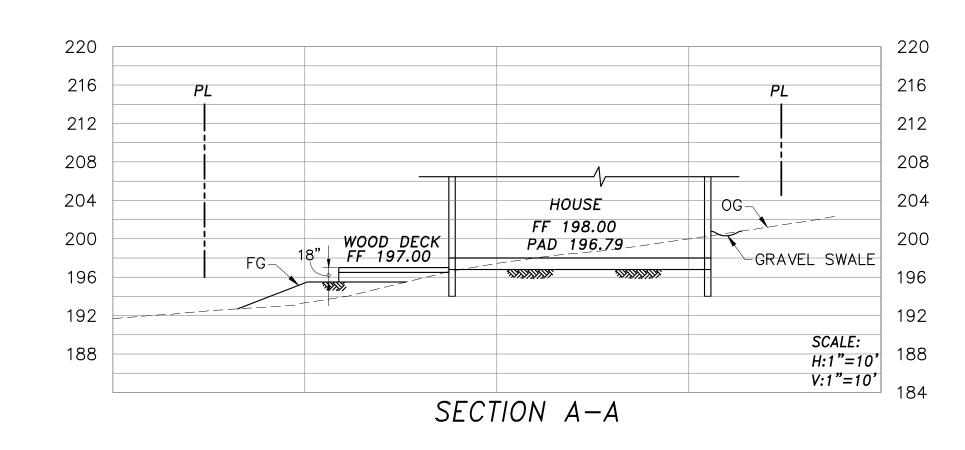

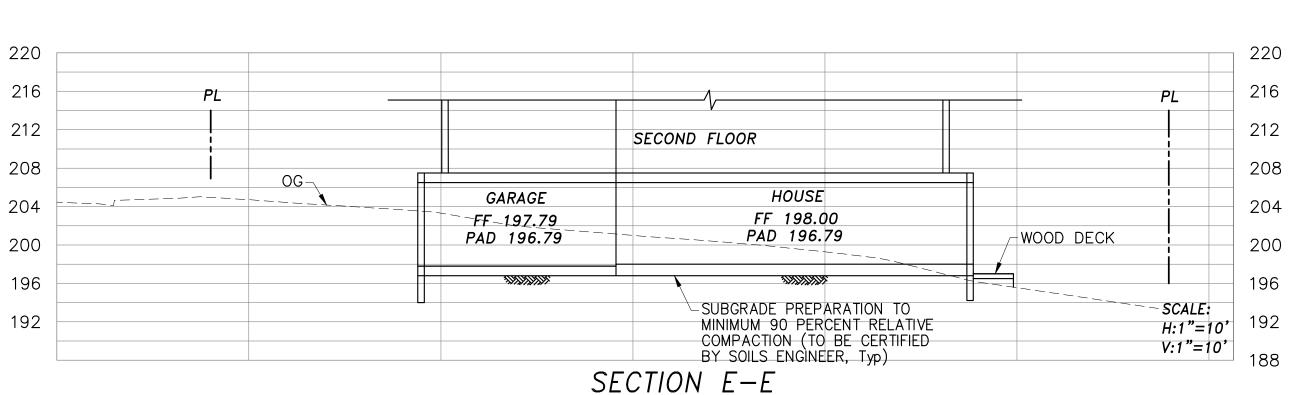



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PROJECT NO: PROJECT NAME:

2101 House on a Hill

APN: 036-031-280

PROJECT 340 10th Street
ADDRESS: Montara, CA 94307

PROJECT PHASE: 100% Schematic Design


DRAWN: CK CHECKED: CK

ISSUE DATE: November 02, 2021

DRAWING TITLE: CROSS SECTIONS

DRAWING NO: C004

UNAUTHORIZED CHANGES & USE: THE ENGINEER PREPARING THESE PLANS WILL NOT BE RESPONSIBLE FOR, OR LIABLE FOR, UNAUTHORIZED CHANGES TO OR USES OF THESE PLANS. ALL CHANGES TO THE PLANS MUST BE IN WRITING AND MUST BE APPROVED BY THE PREPARER OF THESE PLANS.

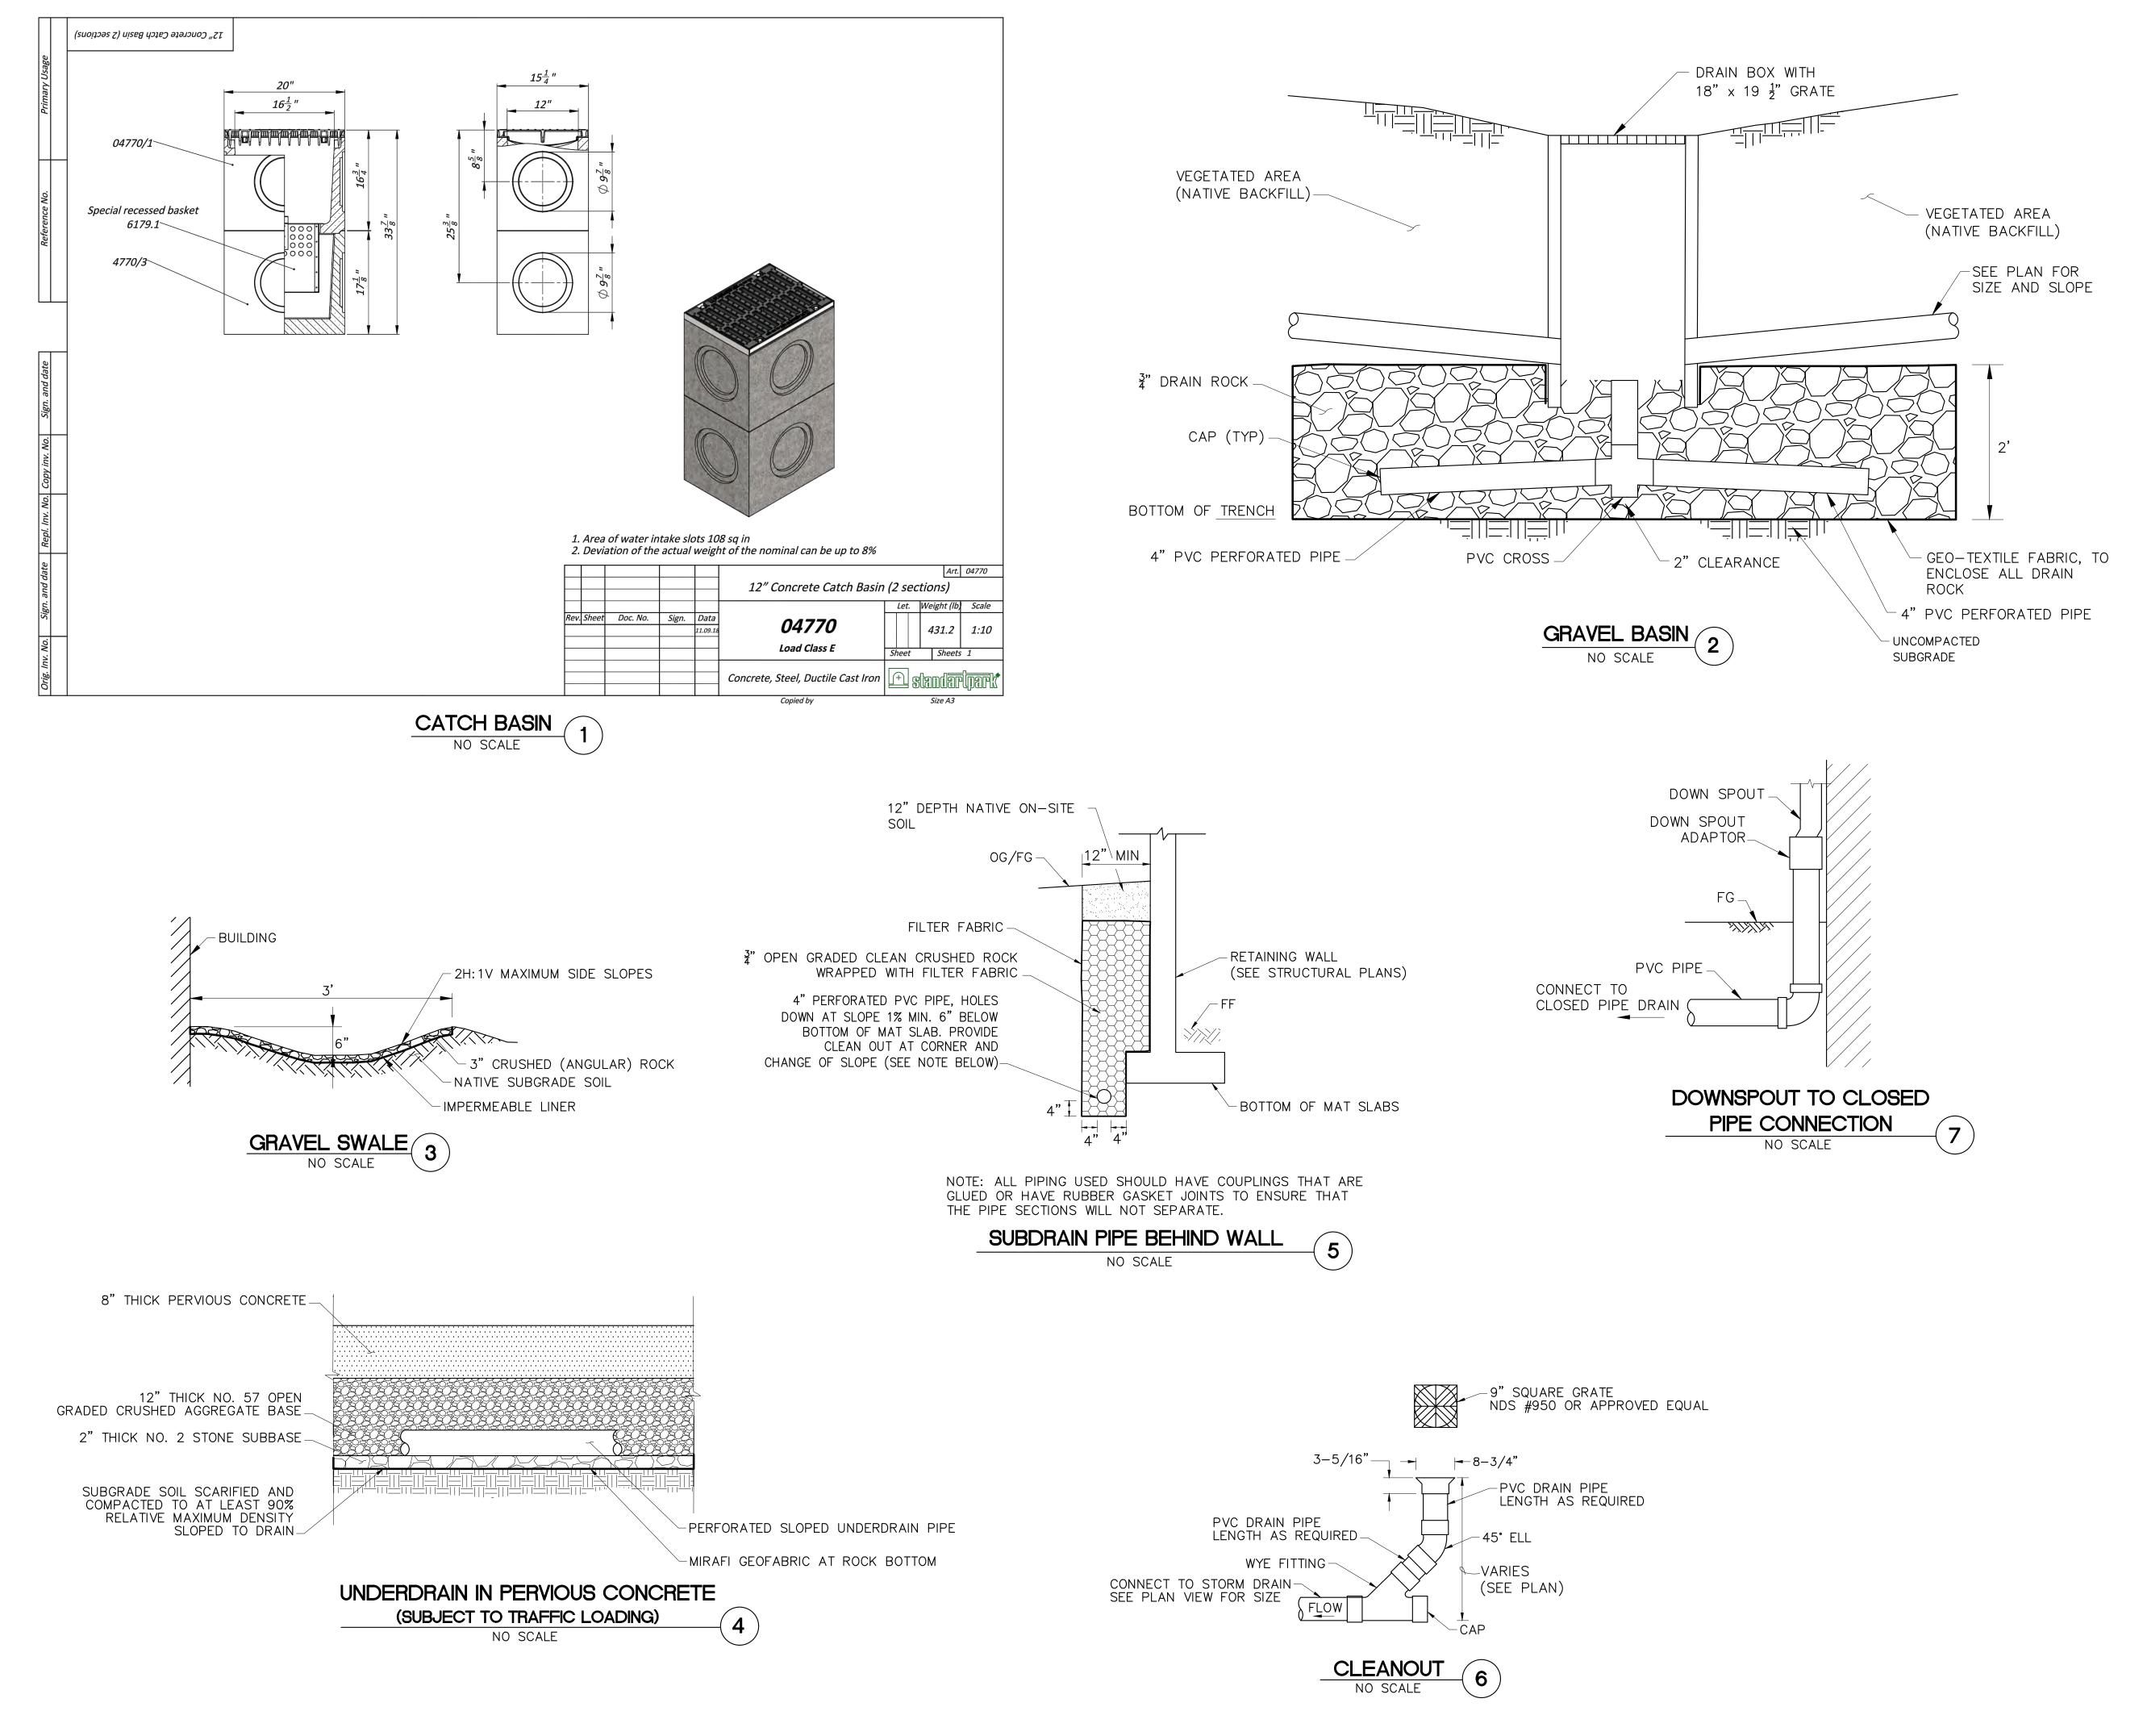

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APN: 036-031-280

PROJECT 340 10th Street
ADDRESS: Montara, CA 94307

#### PROJECT PHASE: 100% Schematic Design


DRAWN: CK CHECKED: CK

ISSUE DATE: November 02, 2021

DRAWING TITLE: CONSTRUCTION DETAILS

DRAWING NO: C005

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TYPE "A" BACKWATER PREVENTION DEVICE, SEE STANDARD DETAIL

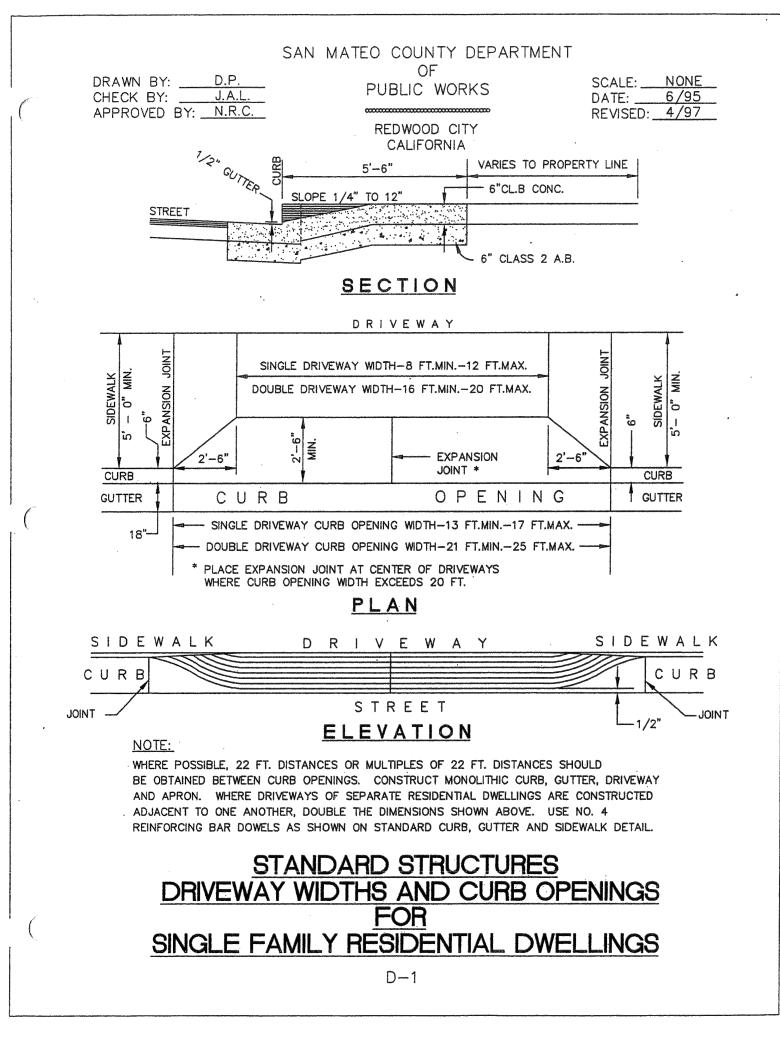TOP OF THE PIPE TO A MINIMUM OF 6" ABOVE THE FINISHED GROUND SURFACE.

TYPE A BACKWATER PREVENTION DEVICE (CONTRA COSTA RELIEF VALVE,

ALSO KNOWN AS MUSHROOM CAP) SHALL BE INSTALLED ON A

TYPE A BACKWATER PREVENTION DEVICE MAY BE INSTALLED TO LEFT OR RIGHT SIDE OF LATERAL IN GARAGE OR STEP AREAS.

MEANS NECESSARY TO ACHIEVE 90% COMPACTION.


PER STANDARD DETAIL SD6.

4" MINIMUM RISER PIPE NOT MORE THAN 2' FROM BUILDING WALL,

LATERAL TRENCHES IN AREA OF PUBLIC STREET CURB, GUTTER AND


SIDEWALK SHALL BE COMPACTED THE SAME AS TYPICAL TRENCH DETAIL


SD 4. AREAS AROUND NEW CONCRETE CLEAN-OUT BOXES SHALL BE SOILS TESTED TO 90% COMPACTED. CONTRACTOR IS TO USE WHATEVER

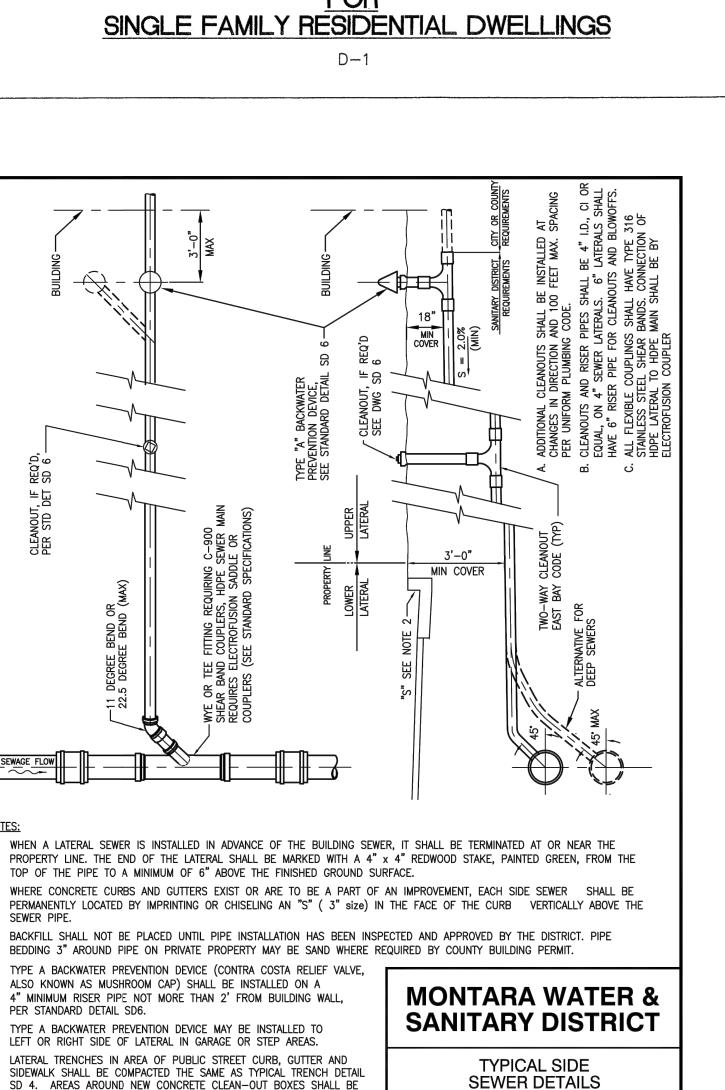


SD 5

2017

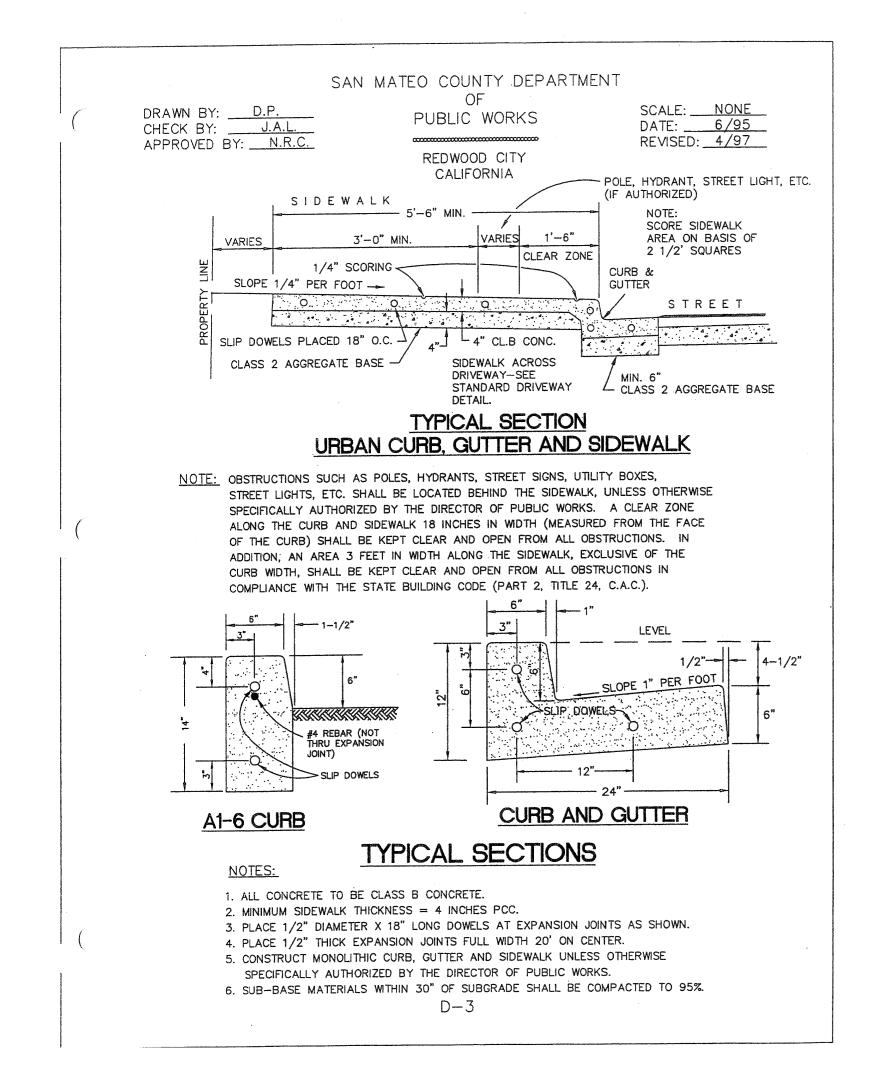

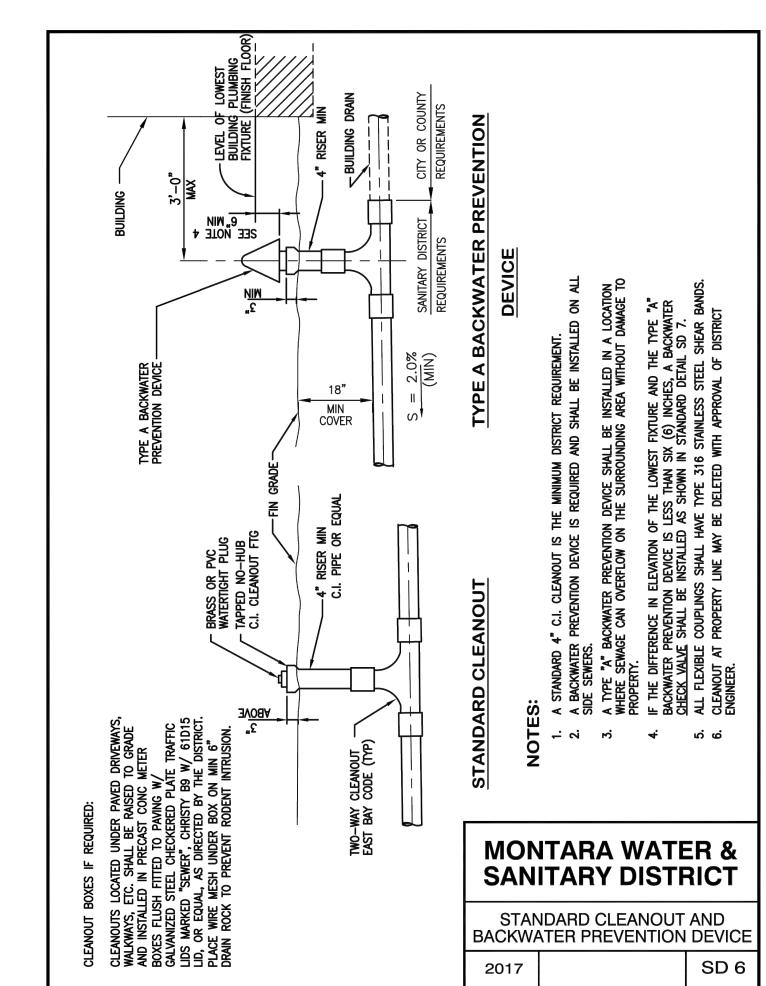

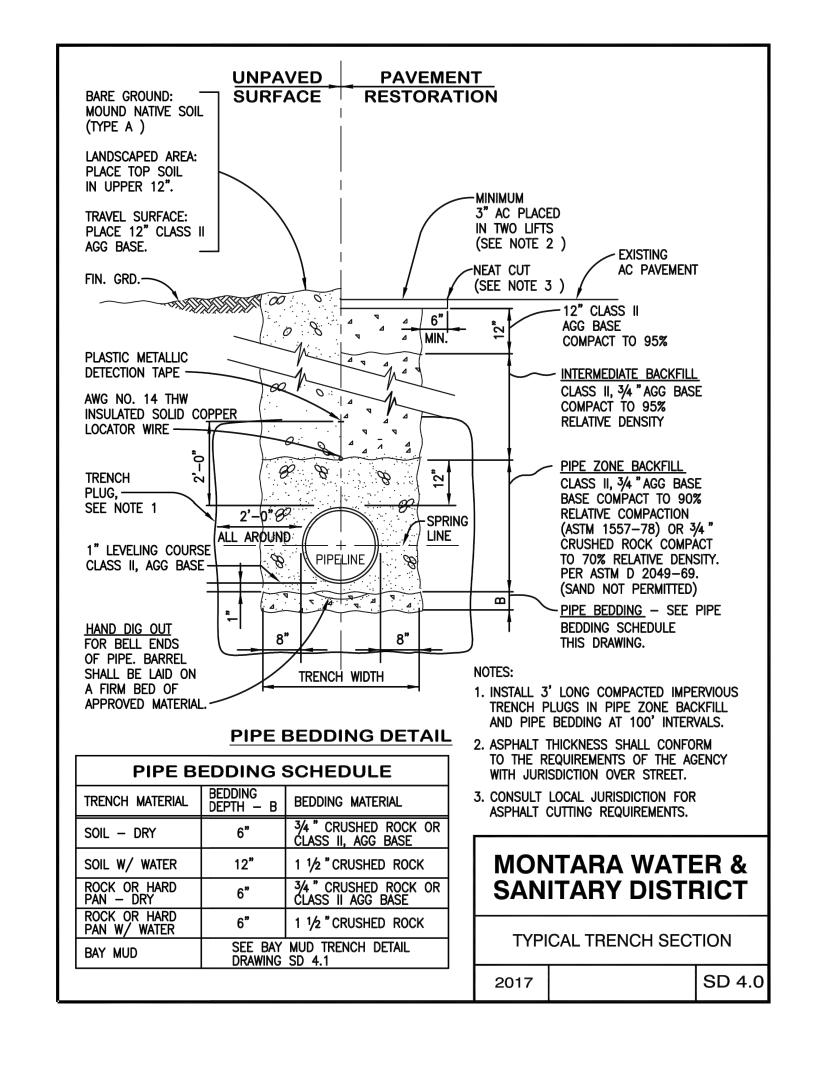

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PHONE: (888) 512-3152 EMAIL: constructionsupport@designeverest.com

PROJECT NAME: PROJECT NO:

#### 2101 House on a Hill

036-031-280 340 10th Street **PROJECT** Montara, CA 94307 ADDRESS:

#### PROJECT PHASE: 100% Schematic Design


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ISSUE DATE: November 02, 2021


DRAWING TITLE: CONSTRUCTION DETAILS


**C006** DRAWING NO:


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365 FLOWER LANE

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PROJECT NO: PROJECT NAME:
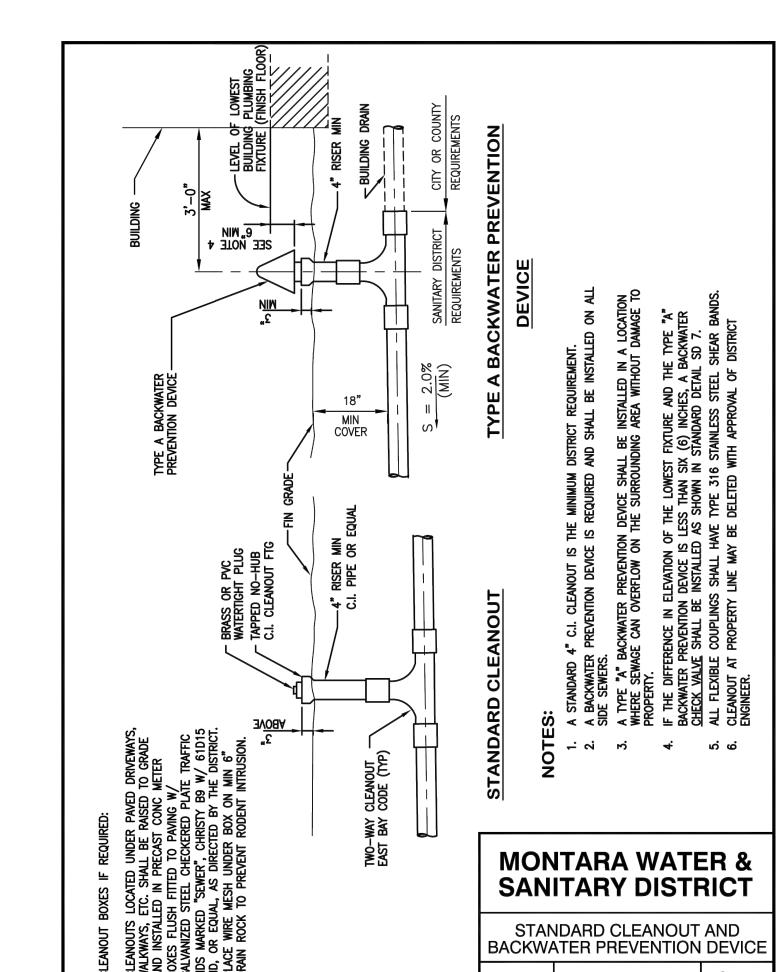
# 2101 House on a Hill

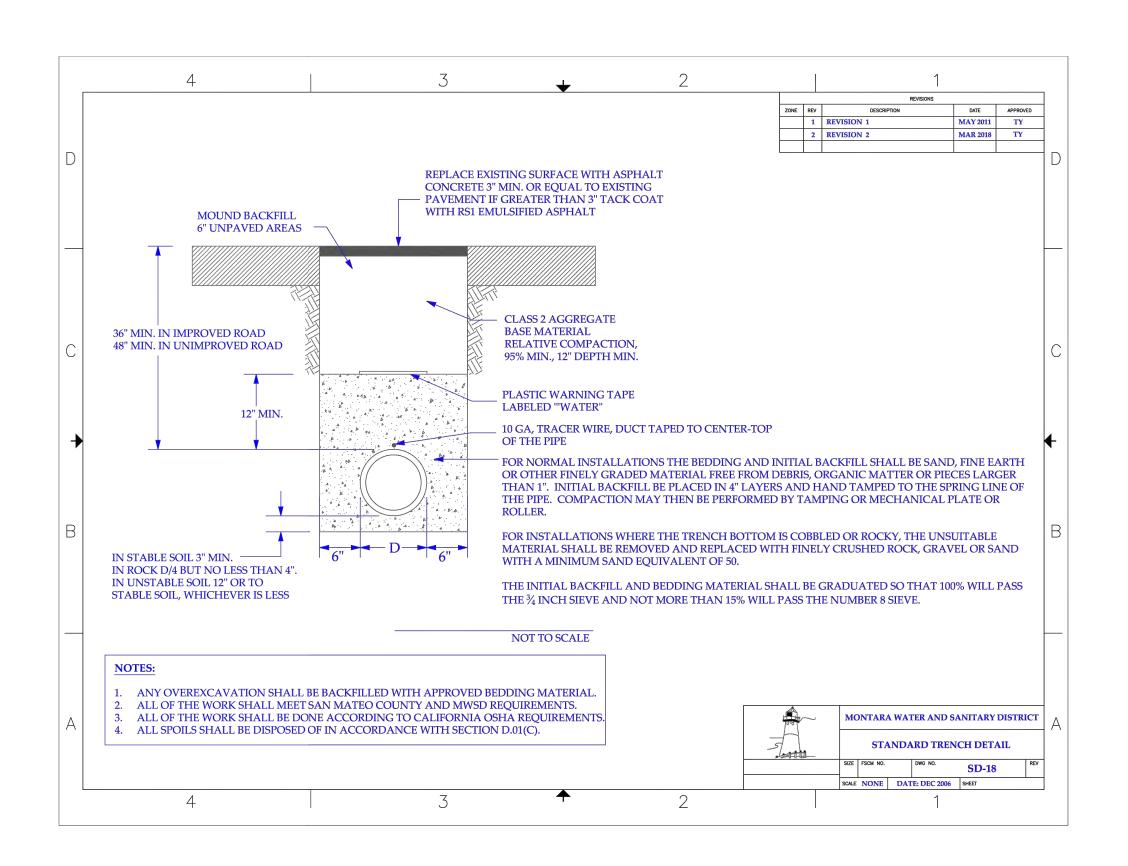APN: 036-031-280

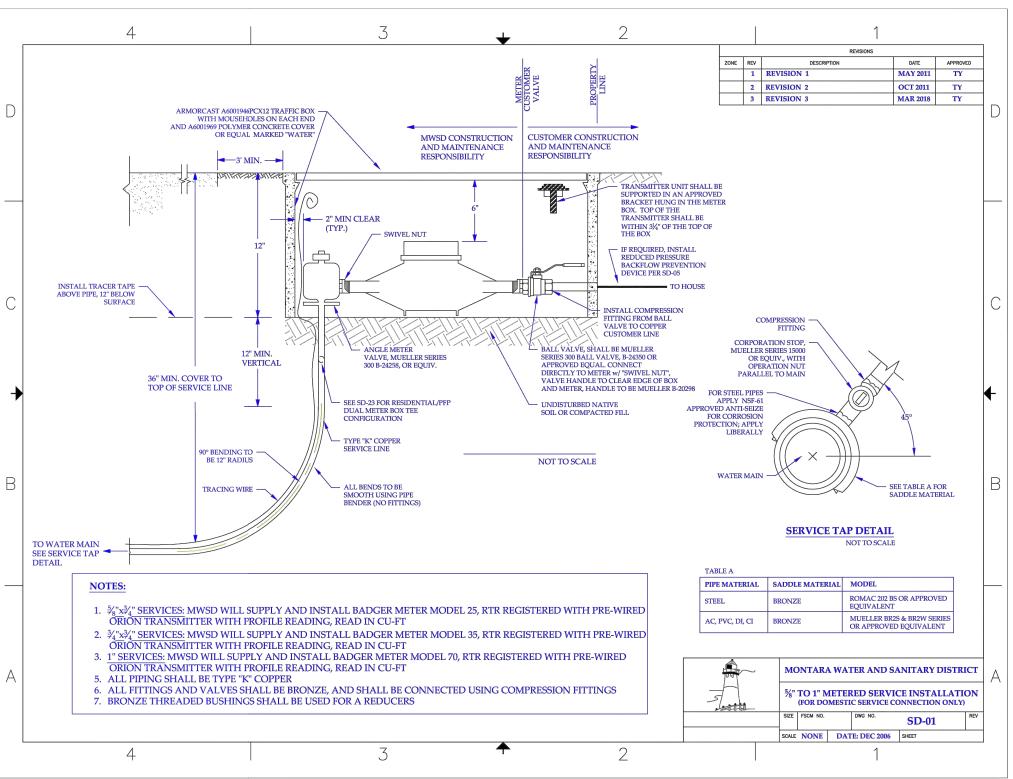PROJECT 340 10th Street
ADDRESS: Montara, CA 94307
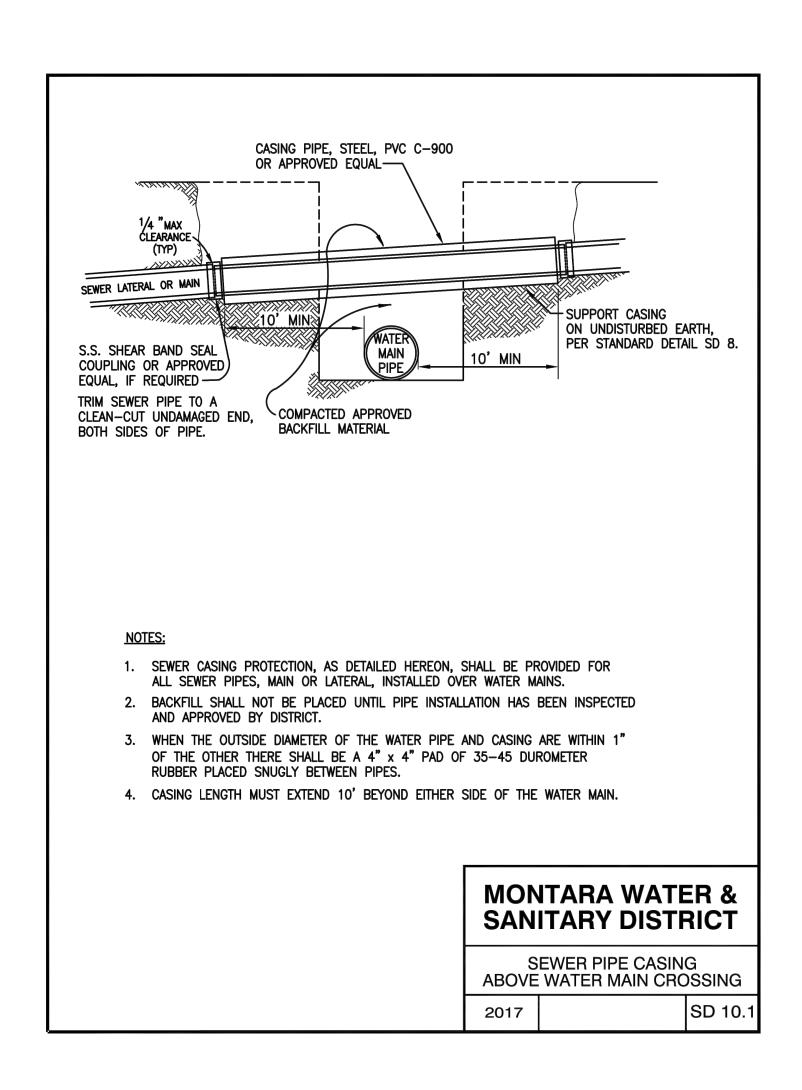
#### PROJECT PHASE: 100% Schematic Design

DRAWN: CK CHECKED: CK

ISSUE DATE: November 02, 2021

DRAWING TITLE: CONSTRUCTION DETAILS

DRAWING NO:

C007

UNAUTHORIZED CHANGES & USE: THE ENGINEER PREPARING THESE PLANS WILL NOT BE RESPONSIBLE FOR, OR LIABLE FOR, UNAUTHORIZED CHANGES TO OR USES OF THESE PLANS. ALL CHANGES TO THE PLANS MUST BE IN WRITING AND MUST BE APPROVED BY THE PREPARER OF THESE PLANS.

#### **EROSION CONTROL NOTES:**

- A. ALL GRADING, EROSION AND SEDIMENT CONTROL AND RELATED WORK UNDERTAKEN ON THIS SITE IS SUBJECT TO ALL TERMS AND CONDITIONS OF THE CITY GRADING ORDINANCE AND MADE A PART HEREOF BY REFERENCE.
- B. THE CONTRACTOR WILL BE LIABLE FOR ANY AND ALL DAMAGES TO ANY PUBLICLY OWNED AND MAINTAINED ROAD CAUSED BY THE AFORESAID CONTRACTOR'S GRADING ACTIVITIES, AND SHALL BE RESPONSIBLE FOR THE CLEANUP OF ANY MATERIAL SPILLED ON ANY PUBLIC ROAD ON THE HAUL ROUTE.
- C. THE EROSION CONTROL MEASURES ARE TO BE OPERABLE DURING THE RAINY SEASON, OCTOBER FIRST TO APRIL FIFTEENTH. EROSION CONTROL PLANTING IS TO BE COMPLETED BY OCTOBER FIRST. NO GRADING OR UTILITY TRENCHING SHALL OCCUR BETWEEN OCTOBER FIRST AND APRIL FIFTEENTH UNLESS AUTHORIZED BY THE COUNTY ENGINEER.
- D. ALL EROSION CONTROL MEASURES SHALL BE MAINTAINED UNTIL DISTURBED AREAS ARE STABILIZED AND CHANGES TO THIS EROSION AND SEDIMENT CONTROL PLAN SHALL BE MADE TO MEET FIELD CONDITIONS ONLY WITH THE APPROVAL OF OR AT THE DIRECTION OF THE SOILS ENGINEER.
- E. ALL EROSION CONTROL FACILITIES MUST BE INSPECTED AND REPAIRED AT THE END OF EACH WORKING DAY DURING THE RAINY
  SEASON
- F. A CONSTRUCTION ENTRANCE SHALL BE PROVIDED AT ANY POINT OF EGRESS FROM THE SITE TO ROADWAY. A CONSTRUCTION ENTRANCE SHOULD BE COMPOSED OF COARSE DRAIN ROCK (2" TO 3") MINIMUM DIAMETER AT LEAST EIGHT INCHES THICK BY FIFTY (50) FEET LONG BY TWENTY (20) FEET WIDE UNLESS SHOWN OTHERWISE ON PLAN AND SHALL BE MAINTAINED UNTIL THE SITE IS PAVED.
- G. WATER UTILIZED IN THE STABILIZATION MATERIAL SHALL BE OF SUCH QUALITY THAT IT WILL PROMOTE GERMINATION AND STIMULATE GROWTH OF PLANTS. IT SHALL BE FREE OF POLLUTANT MATERIALS AND WEED SEED.
- H. STABILIZATION MATERIALS SHALL BE APPLIED AS SOON AS PRACTICABLE AFTER COMPLETION OF GRADING OPERATIONS AND PRIOR TO THE ONSET OF WINTER RAINS, OR AT SUCH OTHER TIME AS DIRECTED BY THE CITY ENGINEER. THE MATERIAL SHALL BE APPLIED BEFORE INSTALLATION OF OTHER LANDSCAPING MATERIALS SUCH AS TREES, SHRUBS AND GROUND COVERS.
- I. THE STABILIZATION MATERIAL SHALL BE APPLIED WITHIN 4—HOURS AFTER MIXING, MIXED MATERIAL NOT USED WITHIN 4—HOURS SHALL BE REMOVED FROM THE SITE.
- J. THE CONTRACTOR SHALL MAINTAIN THE SOIL STABILIZATION MATERIAL AFTER PLACEMENT. THE CITY ENGINEER MAY REQUIRE SPRAY APPLICATION OF WATER OF OTHER MAINTENANCE ACTIVITIES TO ASSURE THE EFFECTIVENESS OF THE STABILIZATION PROCESS. APPLICATION OF WATER SHALL BE ACCOMPLISHED USING NOZZLES THAT PRODUCE A SPRAY THAT DOES NOT CONCENTRATE OR WASH AWAY THE STABILIZATION MATERIALS.
- K. THE FACILITIES SHOWN ON THIS PLAN ARE DESIGNED TO CONTROL EROSION AND SEDIMENT DURING THE RAINY SEASON. GRADING OPERATIONS DURING RAINY SEASON, WHICH LEAVE DENUDED SLOPES SHALL BE PROTECTED WITH EROSION CONTROL MEASURES IMMEDIATELY FOLLOWING GRADING OF THE SLOPES.
- L. CONSTRUCTION ENTRANCES SHALL BE INSTALLED PRIOR TOO COMMENCEMENT OF GRADING. ALL CONSTRUCTION TRAFFIC ENTERING ONTO THE PAVED ROADS MUST CROSS THE STABILIZED CONSTRUCTION ENTRANCEWAYS.
- M. CONTRACTOR SHALL MAINTAIN STABILIZED ENTRANCE AT EACH VEHICLE ACCESS POINT TO EXISTING PAVED STREETS. ANY MUD OR DEBRIS TRACKED ONTO PUBLIC STREETS SHALL BE REMOVED DAILY AND AS REQUIRED BY THE COUNTY.
- N. WHEN NECESSARY, WHEELS SHALL BE CLEANED TO REMOVE SEDIMENT PRIOR TO ENTRANCE ONTO PUBLIC RIGHT—OF—WAY. WHEN WASHING IS REQUIRED, IT SHALL BE DONE ON AN AREA STABILIZED WITH CRUSHED STONE WHICH DRAINS INTO AN APPROVED SEDIMENT TRAP OR SEDIMENT BASIN. ALL SEDIMENT SHALL BE PREVENTED FROM ENTERING ANY STORM DRAIN, DITCH OR WATERCOURSE THROUGH USE OF SAND BAGS, GRAVEL, BOARDS, OR OTHER APPROVED METHODS.
- O. STRAW MULCH OR FIBER MATTE SHALL BE SUFFICIENTLY AVAILABLE ON—SITE DURING THE GRADING PERIOD READY TO BE INSTALLED ON FRESH SLOPES THAT MAY BE ERODED DURING STORMY WEATHER.
- P. INLET PROTECTION SHALL BE INSTALLED AT OPEN INLETS TO PREVENT SEDIMENT FROM ENTERING THE STORM DRAIN SYSTEM. INLETS NOT USED IN CONJUNCTION WITH EROSION CONTROL ARE TO BE BLOCKED TO PREVENT ENTRY OF SEDIMENT.
- Q. THIS EROSION AND SEDIMENT CONTROL PLAN MAY NOT COVER ALL THE SITUATIONS THAT MAY ARISE DURING CONSTRUCTION DUE TO UNANTICIPATED FIELD CONDITIONS. VARIATIONS AND ADDITIONS MAY BE MADE TO THIS PLAN IN THE FIELD. NOTIFY THE COUNTY REPRESENTATIVE OF ANY FIELD CHANGES.
- R. CLEANOUT THE CONCRETE DITCH AT COMPLETION OF THE PROJECT.
- S. SITE CLEARING AND EARTH—MOVING ACTIVITIES ARE ONLY ALLOWED DURING DRY WEATHER. EROSION AND SEDIMENTS CONTROL
  PRACTICES SHALL BE INSTALLED AND IMPLEMENTED PRIOR TO EARTH—MOVING ACTIVITIES AND CONSTRUCTION.

#### MAINTENANCE NOTES:

- 1. REPAIR DAMAGES CAUSED BY SOIL EROSION OR CONSTRUCTION AT THE END OF EACH WORKING DAY.
- 2. SWALES SHALL BE INSPECTED PERIODICALLY AND MAINTAINED AS NEEDED.
- 3. SEDIMENT TRAPS, BERMS, AND SWALES ARE TO BE INSPECTED AFTER EACH STORM AND REPAIRS MADE AS NEEDED.
- 4. SEDIMENT SHALL BE REMOVED AND SEDIMENT TRAPS RESTORED TO ITS ORIGINAL DIMENSIONS WHEN SEDIMENT HAS ACCUMULATED TO A DEPTH OF ONE FOOT.
- 5. SEDIMENT REMOVED FROM TRAP SHALL BE DEPOSITED IN A SUITABLE AREA AND IN SUCH A MANNER THAT IT WILL NOT ERODE.
- 6. RILLS AND GULLIES MUST BE REPAIRED.

#### NON-STORM WATER MANAGEMENT

- 1. CONTRACTOR SHALL IMPLEMENT MEASURES TO CONTROL ALL NON—STORM WATER DISCHARGES DURING CONSTRUCTION.
- 2.CONTRACTOR SHALL WASH VEHICLES IN SUCH A MANNER AS TO PREVENT NON-STORM WATER DISCHARGES TO SURFACE WATERS OR MS4 DRAINAGE SYSTEM.
- 3.CONTRACTOR SHALL CLEAN STREETS IN SUCH A MANNER AS TO PREVENT UNAUTHORIZED NON-STORM WATER DISCHARGES FROM REACHING SURFACE WATER OR MS4 DRAINAGE SYSTEMS.

#### DUST CONTROL

- 1. THE CONSTRUCTION ACTIVITIES WILL GENERATE DUST AND PARTICULATE MATTER. PRIOR TO THE ISSUANCE OF A GRADING PERMIT, A DUST MITIGATION PLAN SHALL BE SUBMITTED TO THE CITY FOR REVIEW AND APPROVAL. THE PLAN SHALL SPECIFY THE METHODS OF CONTROL THAT WILL BE UTILIZED, DEMONSTRATE THE AVAILABILITY OF NEEDED EQUIPMENT AND PERSONNEL, AND IDENTIFY A RESPONSIBLE INDIVIDUAL WHO CAN AUTHORIZE THE IMPLEMENTATION OF ADDITIONAL MEASURES, IF NEEDED. THE CONSTRUCTION DUST MITIGATION PLAN SHALL, AT MINIMUM, INCLUDE THE FOLLOWING:
- A. THE PROVISION OF EQUIPMENT AND STAFFING FOR WATERING OF ALL EXPOSED OR DISTURBED SOIL SURFACES AT LEAST TWICE DAILY, INCLUDING WEEKENDS AND HOLIDAYS. AN APPROPRIATE DUST PALLIATIVE OR SUPPRESSANT ADDED TO WATER BEFORE THE APPLICATION SHOULD BE UTILIZED.
- B.WATERING OR COVERING OF STOCKPILES OF DEBRIS, SOIL, SAND OR OTHER MATERIALS THAT CAN BE BLOWN BY THE WIND.
- C.THE REGULAR SWEEPING OF CONSTRUCTION AREAS AND ADJACENT STREETS OF ALL MUD AND DEBRIS, SINCE THIS MATERIAL CAN BE PULVERIZED AND LATER RE-SUSPENDED BY VEHICLE TRAFFIC.
- D.THE ENFORCEMENT OF A SPEED LIMIT OF 15 MILES PER HOUR FOR ALL CONSTRUCTION VEHICLES WHEN OFF-PAVEMENT.
- E.ALL MATERIALS TRANSPORTED BY TRUCK WILL BE COVERED OR WETTED DOWN.
- F.ALL INACTIVE PORTIONS OF THE SITE WILL BE WATERED WITH AN APPROPRIATE DUST SUPPRESSANT, COVERED OR SEEDED.
- G.SUSPENSION OF EARTHMOVING OR OTHER DUST-PRODUCING ACTIVITIES DURING PERIODS OF HIGH WINDS WHEN DUST CONTROL MEASURES ARE UNABLE TO AVOID VISIBLE DUST PLUMES.
- 2. COUNTY INSPECTOR MAY ADD/MODIFY EROSION CONTROL MEASURES AS REQUIRED.

#### HAZARDOUS MATERIALS AND WASTES MANAGEMENT:

USE THIS BMP WHEN PROJECTS INVOLVE THE STORAGE AND USE OF HAZARDOUS MATERIALS, AND THE GENERATION OF WASTE BYPRODUCTS FROM THE FOLLOWING:

-INSTALL TEMPORARY

INSTALL TEMPORARY

INLET PROTECTION (Typ)-

INLET PROTECTION (Typ)

10TH STREET

- PETROLEUM PRODUCTS SUCH AS OILS, FUELS, GREASES, COLD MIX AND TARS
- GLUES, ADHESIVES AND SOLVENTS
- HERBICIDES, PESTICIDES AND FERTILIZERS
- PAINTS, STAINS AND CURING COMPOUNDS
- OTHER HAZARDOUS OR TOXIC SUBSTANCES

# HAZARDOUS MATERIALS AND WASTES SHALL BE MANAGED IN ACCORDANCE WITH THE FOLLOWING PROCEDURES:


EARTH BERMS

- MINIMIZE THE AMOUNT OF HAZARDOUS MATERIALS STORED AT THE CONSTRUCTION SITE AND THE PRODUCTION AND GENERATION OF HAZARDOUS WASTE AT THE CONSTRUCTION SITE.
- COVER OR CONTAINERIZE AND PROTECT FROM VANDALISM ANY HAZARDOUS MATERIALS AND WASTE.
- CLEARLY MARK ALL HAZARDOUS MATERIALS AND WASTE. PLACE HAZARDOUS WASTE
   CONTAINERS IN SECONDARY CONTAINMENT SYSTEMS IF STORED AT THE CONSTRUCTION SITE.
- STOCKPILED COLD MIX SHOULD BE PLACED ON AND COVERED WITH PLASTIC.DO NOT MIX WASTE MATERIALS, BECAUSE THIS COMPLICATES OR INHIBITS DISPOSAL AND
- STORM WATER THAT COLLECTS WITHIN SECONDARY CONTAINMENT STRUCTURES MUST BE INSPECTED PRIOR TO BEING DISCHARGED TO ENSURE NO POLLUTANTS ARE PRESENT. CONTAMINATED STORM WATER IS NOT ALLOWED TO BE DISCHARGED AND SHOULD BE DISPOSED OF
- -SPILLS CONNOT BE DISCHARGED FROM A SECONDARY CONTAINMENT SYSTEM.

RECYCLING OPTIONS AND CAN RESULT IN DANGEROUS CHEMICAL REACTIONS.

IN ACCORDANCE WITH ALL APPLICABLE LAWS AND REGULATIONS.

- -HAZARDOUS WASTE MUST BE SEGREGATED FROM OTHER SOLID WASTE AND DISPOSED OF PROPERLY.
- -IN ADDITION TO FOLLOWING THIS BMP, EMPLOYEES AND CONTRACTORS ARE RESPONSIBLE FOR COMPLIANCE WITH FEDERAL, STATE, AND LOCAL LAWS REGARDING STORAGE, HANDLING, TRANSPORTATION, AND DISPOSAL OF HAZARDOUS WASTE.

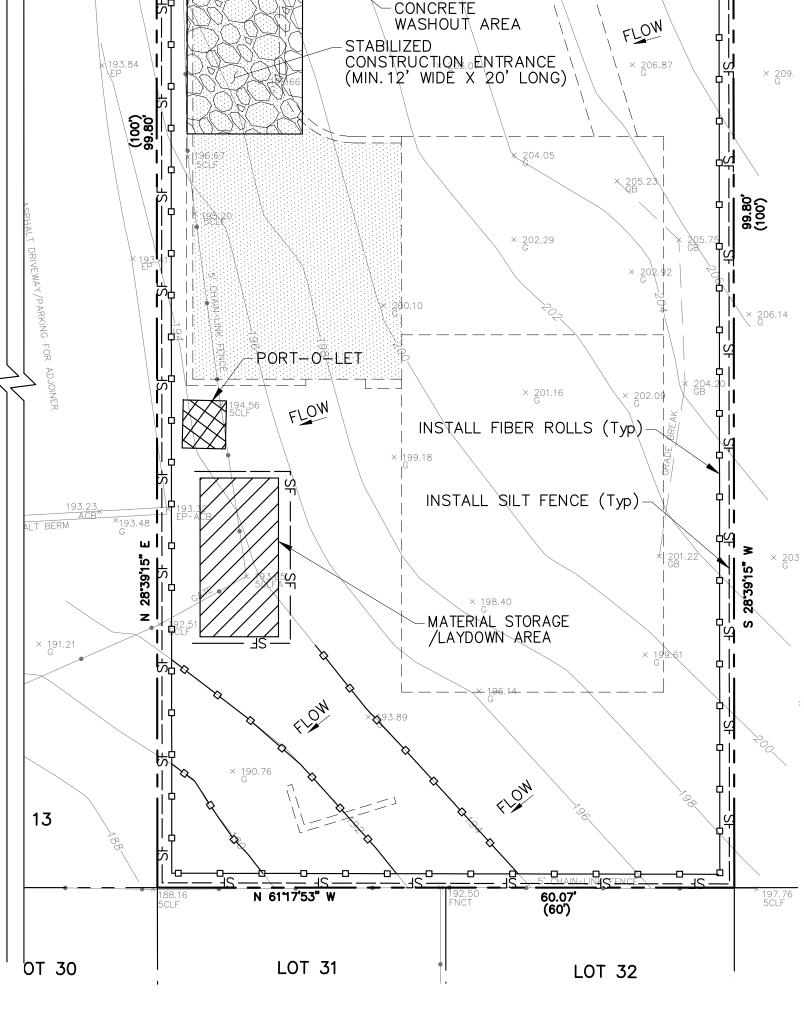

10TH STREET

# FOR REVIEW & FILING NOT FOR CONSTRUCTION

STAMP:

( IN FEET

1 inch = 10 ft

CURB AND GUTTER

**REVISION:** 





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MOUNTAIN VIEW, CA 94043
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PROJECT NO: PROJECT NAME:

# 2101 House on a Hill

Montara, CA 94307

APN: 036-031-280
PROJECT 340 10th Street

ADDRESS:

#### PROJECT PHASE: 100% Schematic Design

DRAWN: CK CHECKED: CK

ISSUE DATE: November 02, 2021

DRAWING TITLE: EROSION AND SEDIMENT CONTROL PLAN

DRAWING NO:

S & USE: THE ENGINEER

**C008** 

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Know what's below.

Call before you dig.

**SE-10** 

SE-1

STOCKPILE PROTECTION PLAN

SECTION A

SP-1. STOCKPILE PROTECTION

or plastic sheet


SILT FENCE (SEE SF DETAIL FOR

Fiber rolls may be used as alternative

SILT FENCE (SEE SF DETAIL FOR INSTALLATION REQUIREMENTS)

INSTALLATION REQUIREMENTS)
Fiber rolls may be used as alternative

Silt Fence

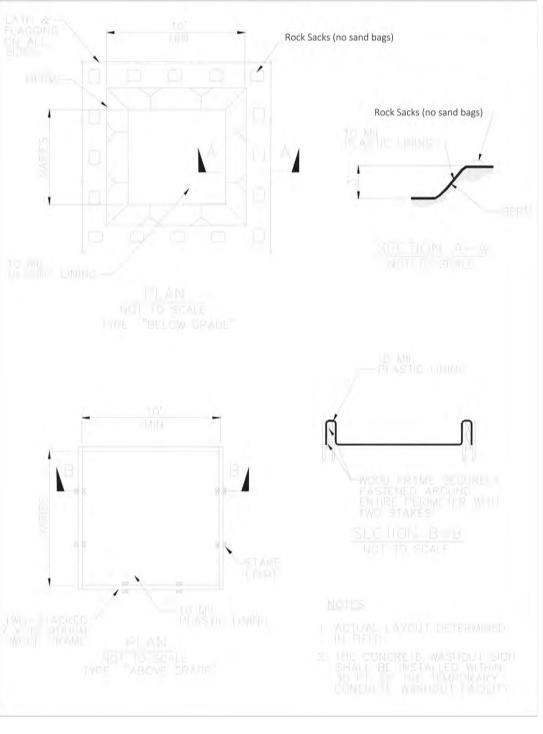

Construction www.casqa.org

(inlet to have filter fabric or basket)

Spillway, 1-bag high -

TYPICAL PROTECTION FOR INLET ON SUMP

TYPICAL PROTECTION FOR INLET ON GRADE

6. Protection can be effective even if it is not immediately adjacent to the inlet provided that the inlet is

4. Bags must be removed after adjacent operation is completed 5. Not applicable in areas with high silts and clays without filter fabric.

**Storm Drain Inlet Protection** 

# If more than one fiber roll is placed in a row, the rolls must be overlapped, not abutted.

Turn the ends of the fiber roll up-slope to prevent runoff from going around the roll.

www.casqa.org


**Storm Drain Inlet Protection** 

Concrete block laid— lengthwise on sides @ perimeter of opening


- Runoff with sediment

min. 4" to max. 6" size for aggregate -12 " Min, unless otherwise specified by a soils engineer SECTION B-B NOTE: Construct sediment barrier and channelize runoff to sediment trapping device emporary pipe culvert 20' min, or max allowed by site (for smaller sites)

Construction www.casqa.org

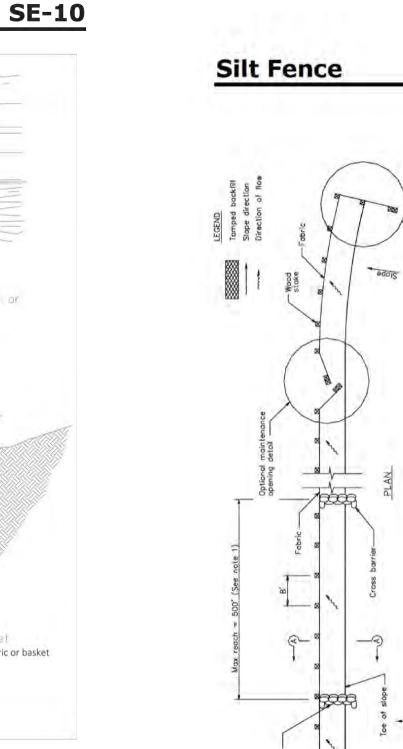

www.cabmphandbooks.com

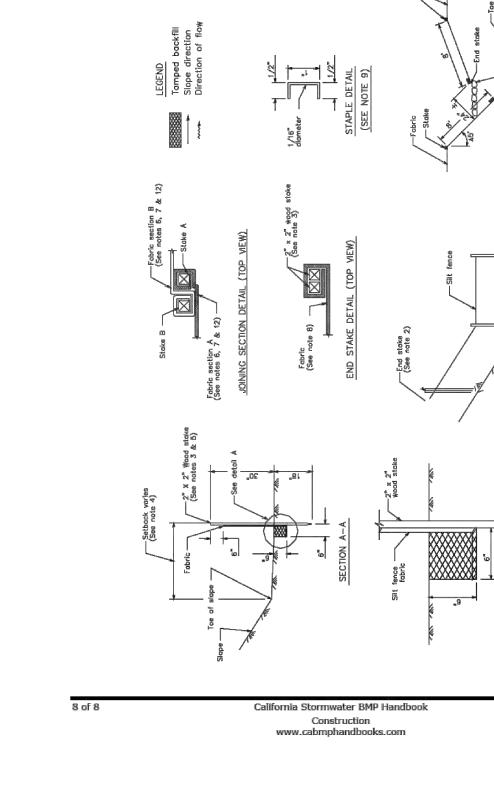

SE-1

**FOR REVIEW & FILING NOT FOR CONSTRUCTION** 

STAMP:



DESIGN EVEREST

MOUNTAIN VIEW, CA 94043 **FOR SALES**: PHONE: (888) 311-3015 FOR CONSTRUCTION SUPPORT: PHONE: (888) 512-3152 EMAIL: constructionsupport@designeverest.com

365 FLOWER LANE

PROJECT NAME: PROJECT NO:

2101 House on a Hill

036-031-280 340 10th Street PROJECT Montara, CA 94307 ADDRESS:

PROJECT PHASE: 100% Schematic Design


DRAWN: CHECKED:

ISSUE DATE: November 02, 2021

DRAWING TITLE: EROSION AND SEDIMENT CONTROL DETAILS

**C009** DRAWING NO:

UNAUTHORIZED CHANGES & USE: THE ENGINEER PREPARING THESE PLANS WILL NOT BE RESPONSIBLE FOR, OR LIABLE FOR, UNAUTHORIZED CHANGES TO OR USES OF THESE PLANS. ALL CHANGES TO THE PLANS MUST BE IN WRITING AND MUST BE APPROVED BY THE PREPARER OF THESE PLANS.

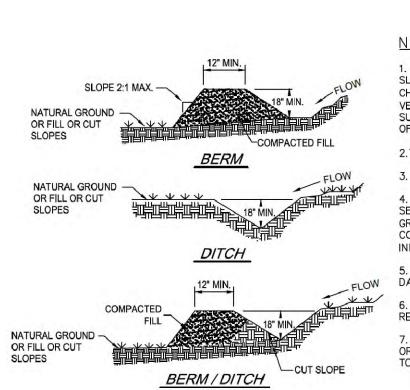

1. Intended for short-term use. 2. Use to inhibit non-storm water flow. 3. Allow for proper maintenance and cleanup.

protected from potential sources of pollution.

California Stormwater BMP Handbook

Rock Sacks

2-bogs high

Construction www.casqa.org

www.casqa.org 1. POSITIVE GRADE MUST BE PROVIDED TO ASSURE DRAINAGE. 2:1 MAX. SIDE SLOPE. IF SLOPE EXCEEDS 2% OR CHANNEL IS CONSTRUCTED IN FILL, PROVIDE CHANNEL LINER PER DETAIL, EC 5, TRY NOT TO EXCEED 5% (HIGH RUNOFF VELOCITIES RESULT). MAXIMUM DRAINAGE AREA IS 5.00 ACRES WITHOUT SUPPORTING CALCULATIONS FOR PERMANENT CHANNEL. DIVERSIONS AT THE TOPS OF SLOPES MUST EMPTY INTO AN APPROVED SLOPE DRAIN.

> 3. MACHINE COMPACTING OF ALL FILL IS REQUIRED. 4. DIVERSIONS SUFFICIENT TO DIRECT ALL SEDIMENT—LADEN STORMWATER INTO SEDIMENT CONTROL DEVICE MUST BE INSTALLED PRIOR TO CLEARING AND GRUBBING OF AREA (OR IN CONJUNCTION WITH THIS OPERATION FEDIMENT

5. DIVERSIONS SHOULD BE LOCATED AS SHOWN ON THE PLANS AND TO MINIMIZE DAMAGES BY CONSTRUCTION OPERATIONS. 6. DIVERSIONS SHOULD BE SEEDED AND LINED WITH STRAW MAT IF THEY ARE TO

(to have filter fabric or basket)

SE-5


-Hardware alath or wire mesh —Filtered water - Curb inlet Inlet to have filter fabric or basket


DI PROTECTION - TYPE 4
NOT TO SCALE


2. THE BERM / DITCH IS THE MOST COMMONLY USED DIVERSION.


CONTROLS AND DIVERSIONS ARE INSTALLED AT EACH CRITICAL POINT AS

7. CHECK DIVERSIONS AFTER EACH RAIN, AND ONCE PER SEVEN CALENDAR DAYS OR MORE FREQUENTLY IF REQUIRED BY REGULATORY AGENCY. REPAIR AS NEEDED TEMPORARY DIVERSION BERM / DITCH

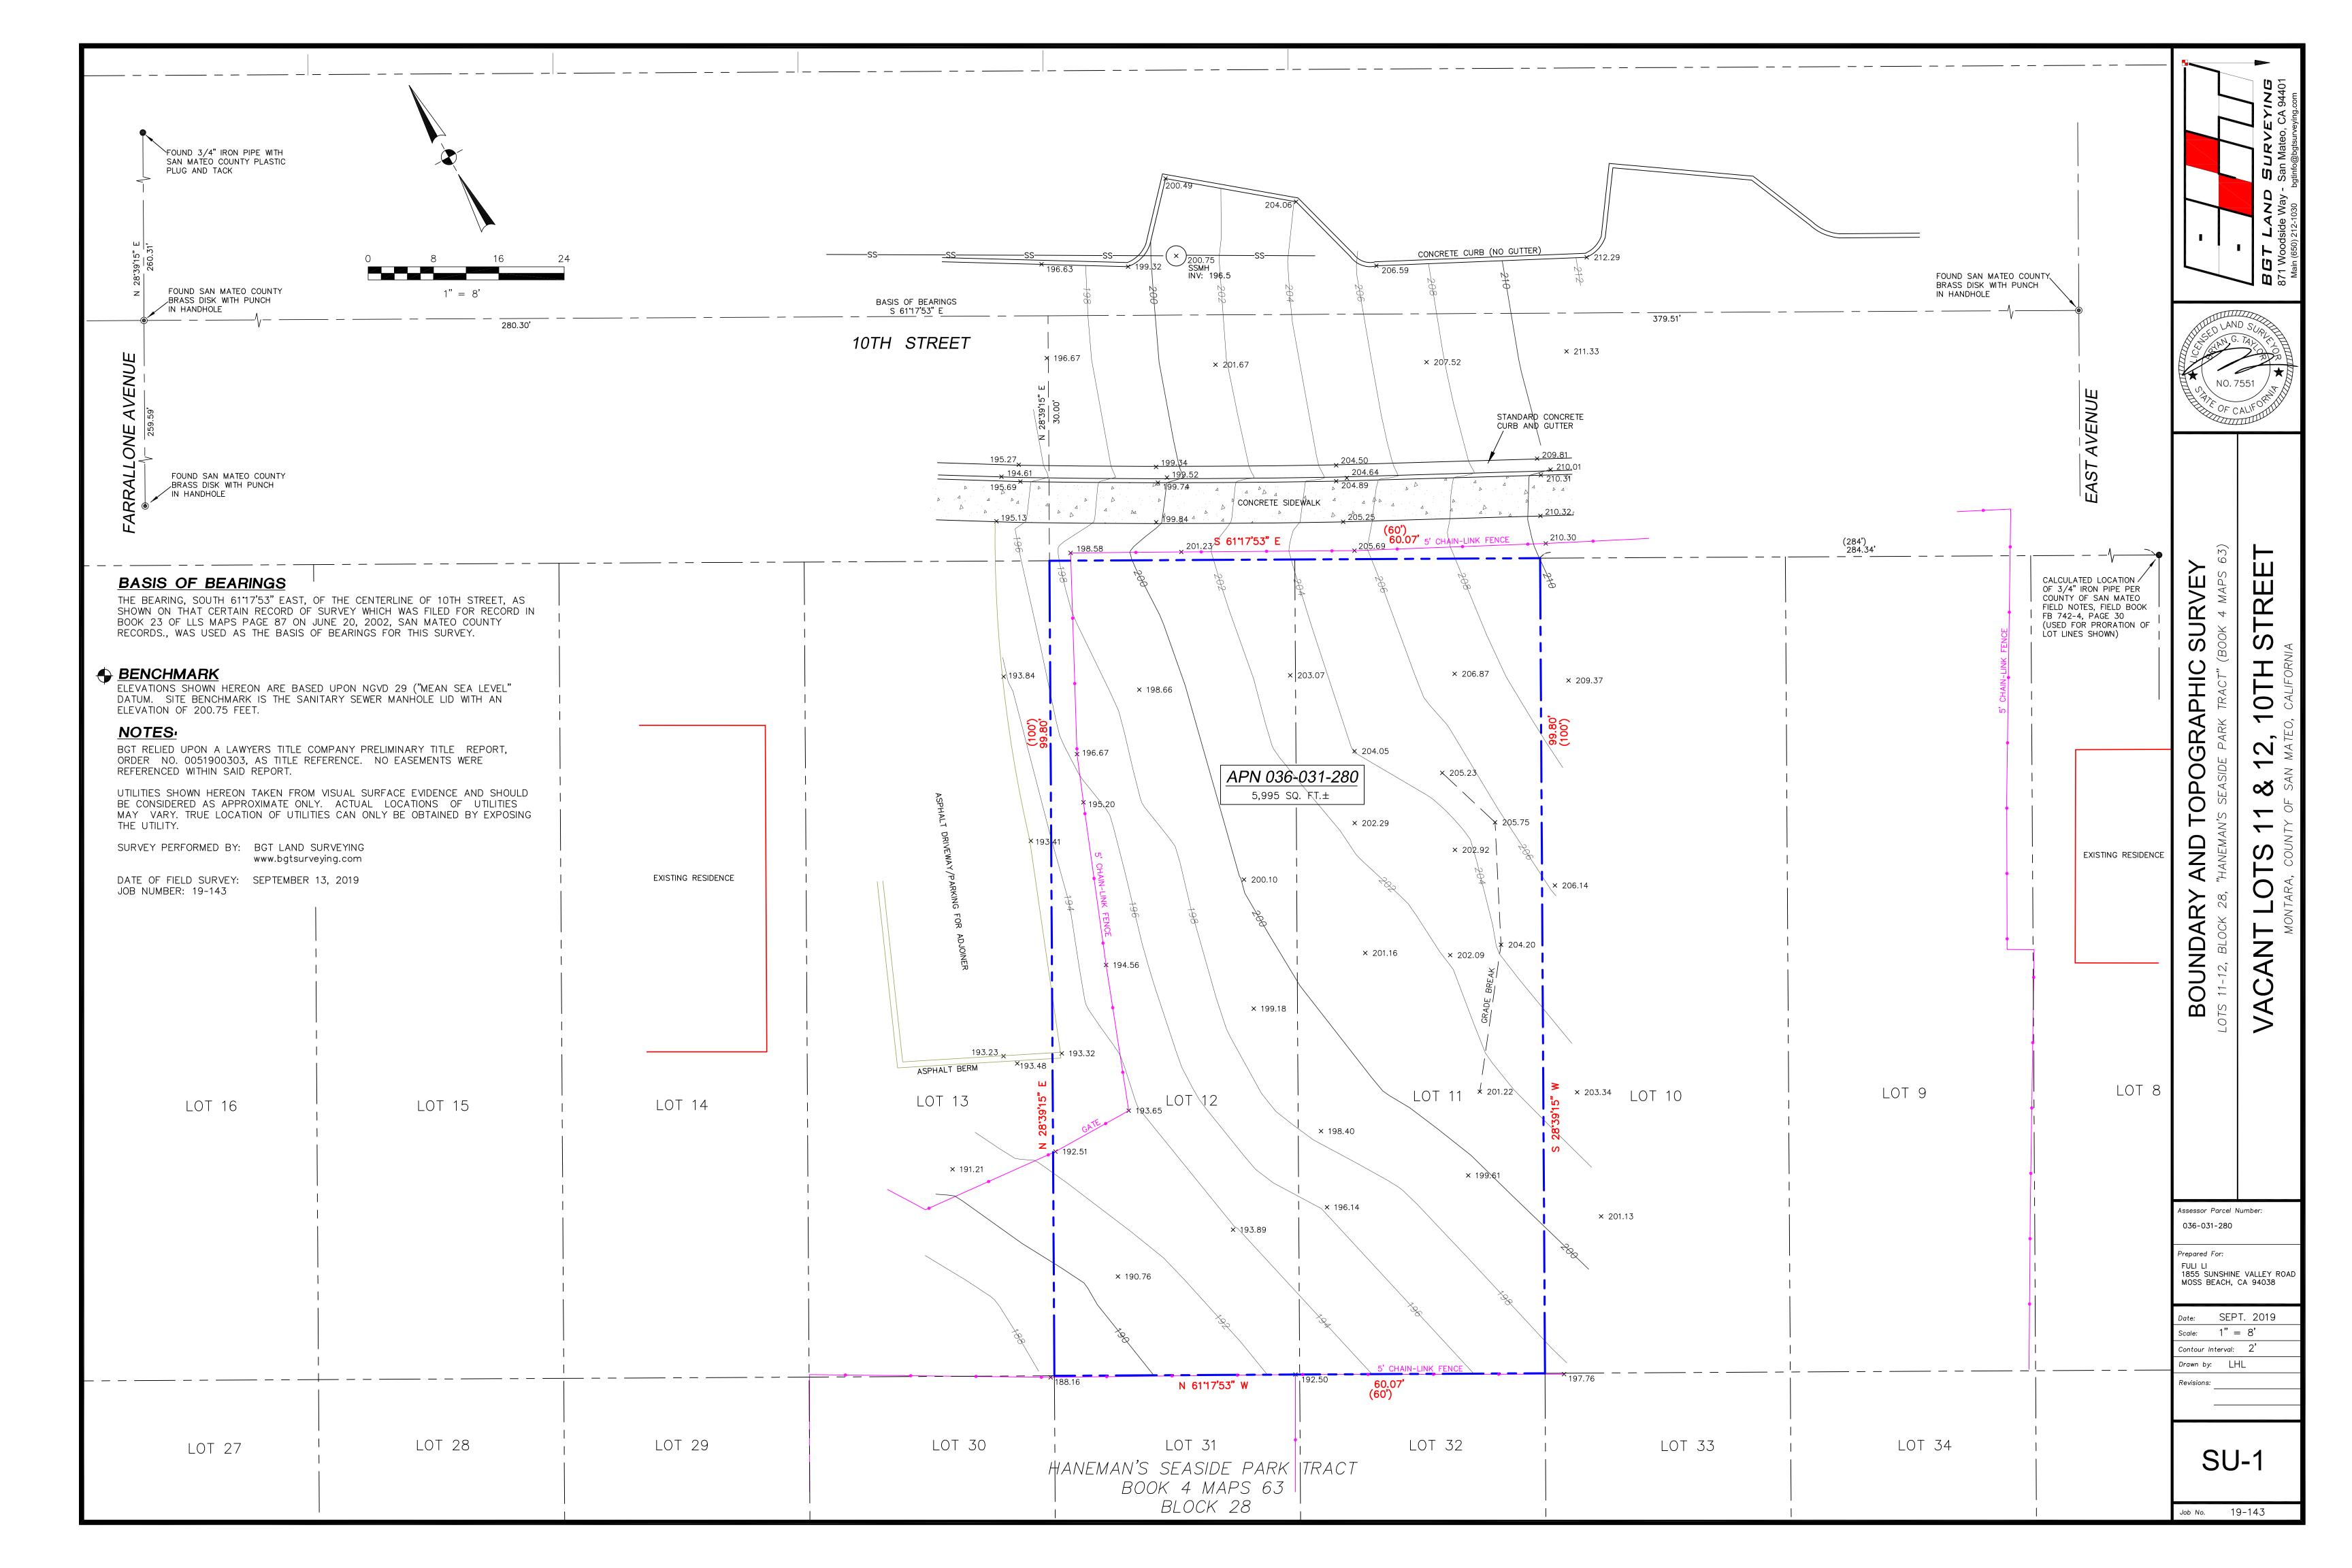


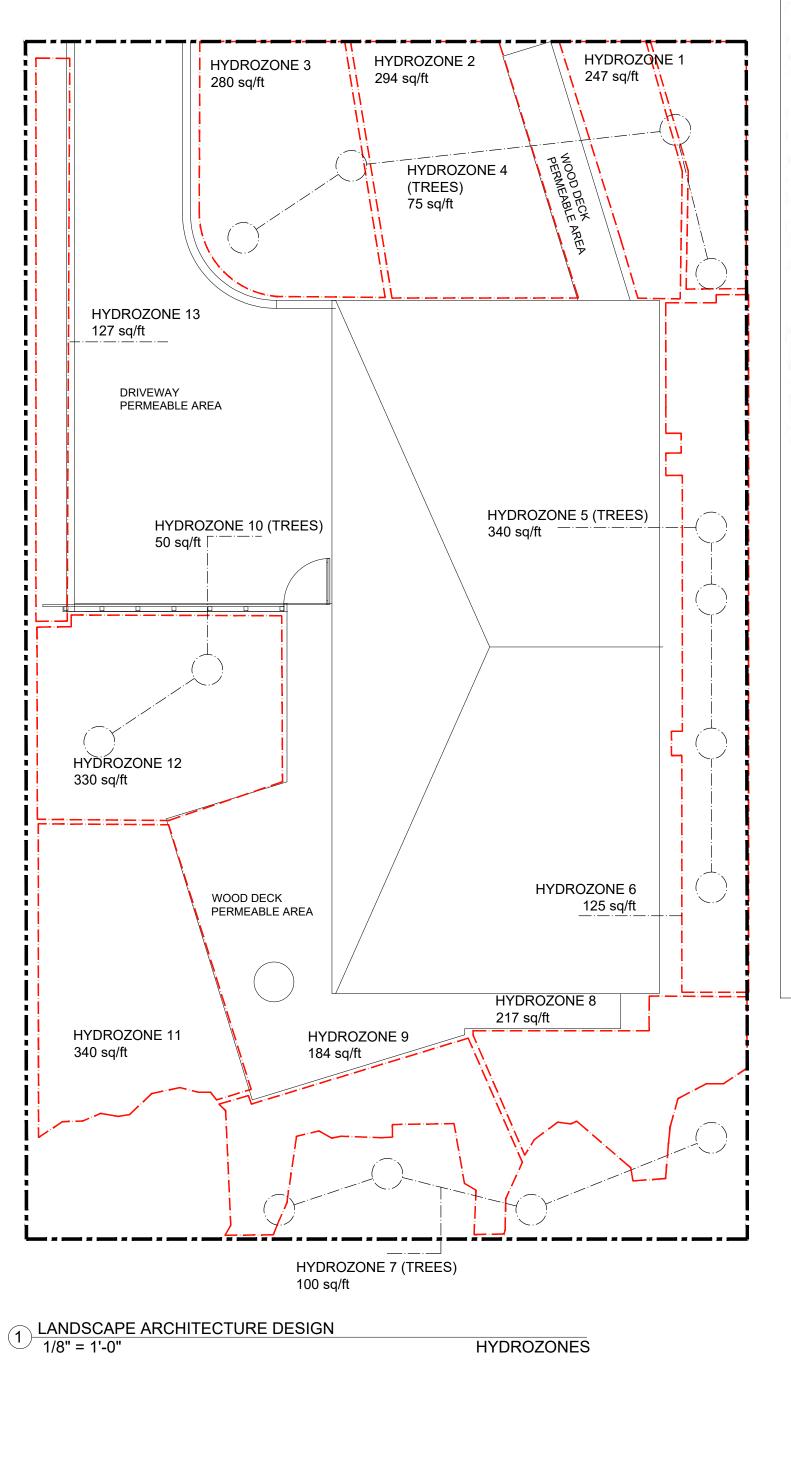

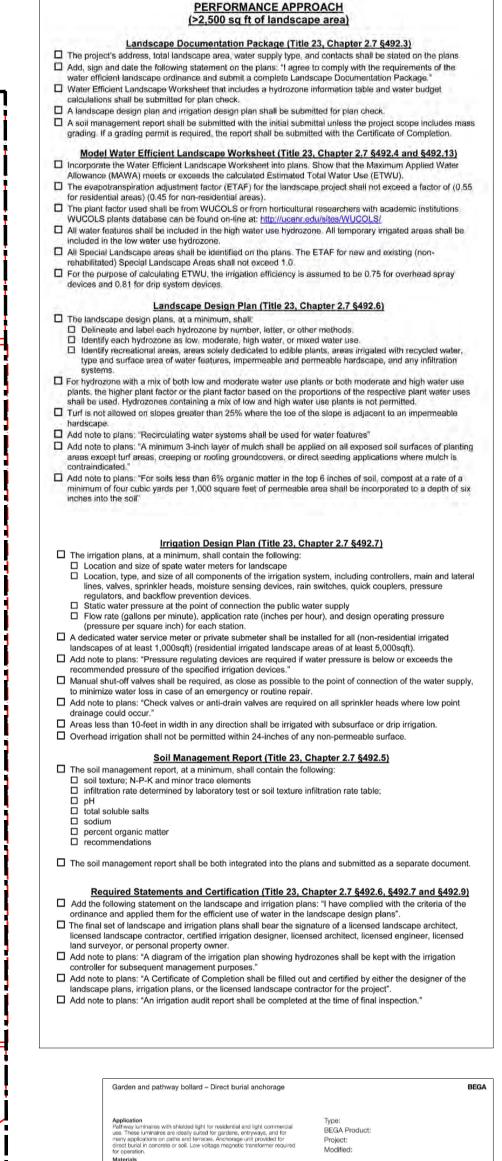

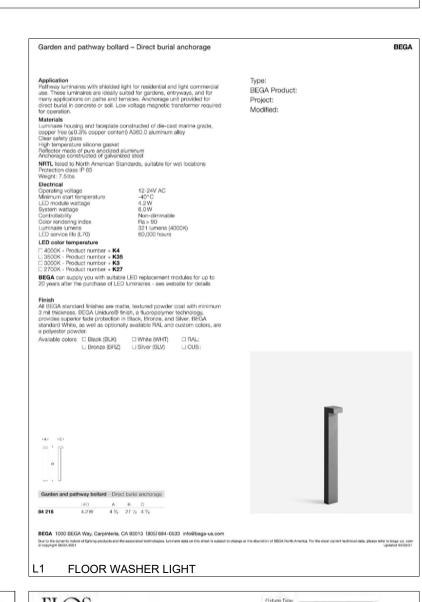


L4 RECESSED LIGHT FIXTURE

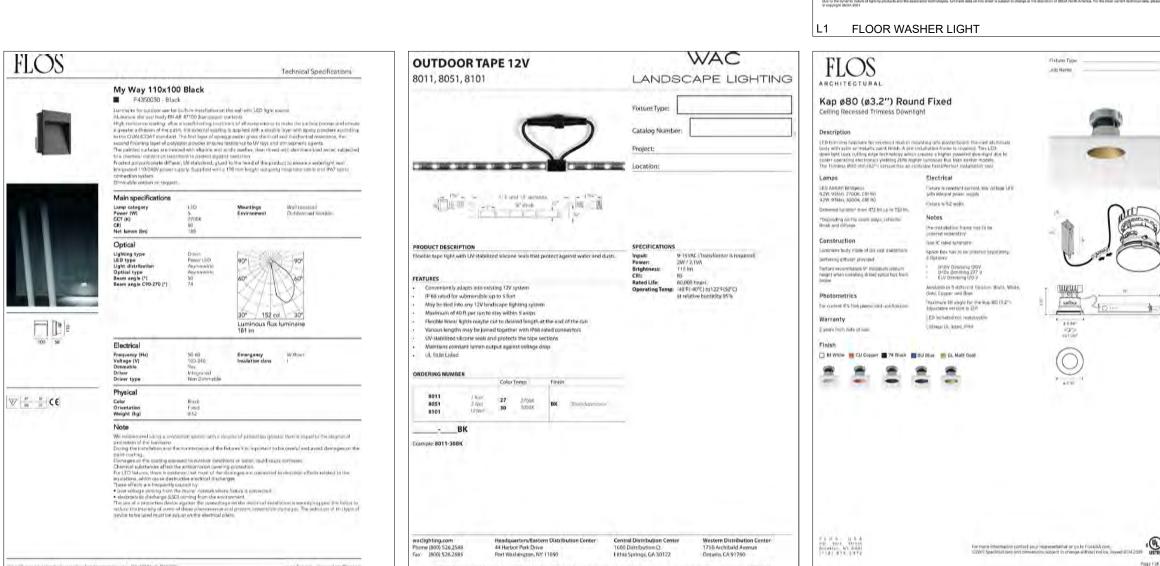

L3 LED WALL WASHER LIGHT

L2 RECESSED STEP/BRICK LIGHT

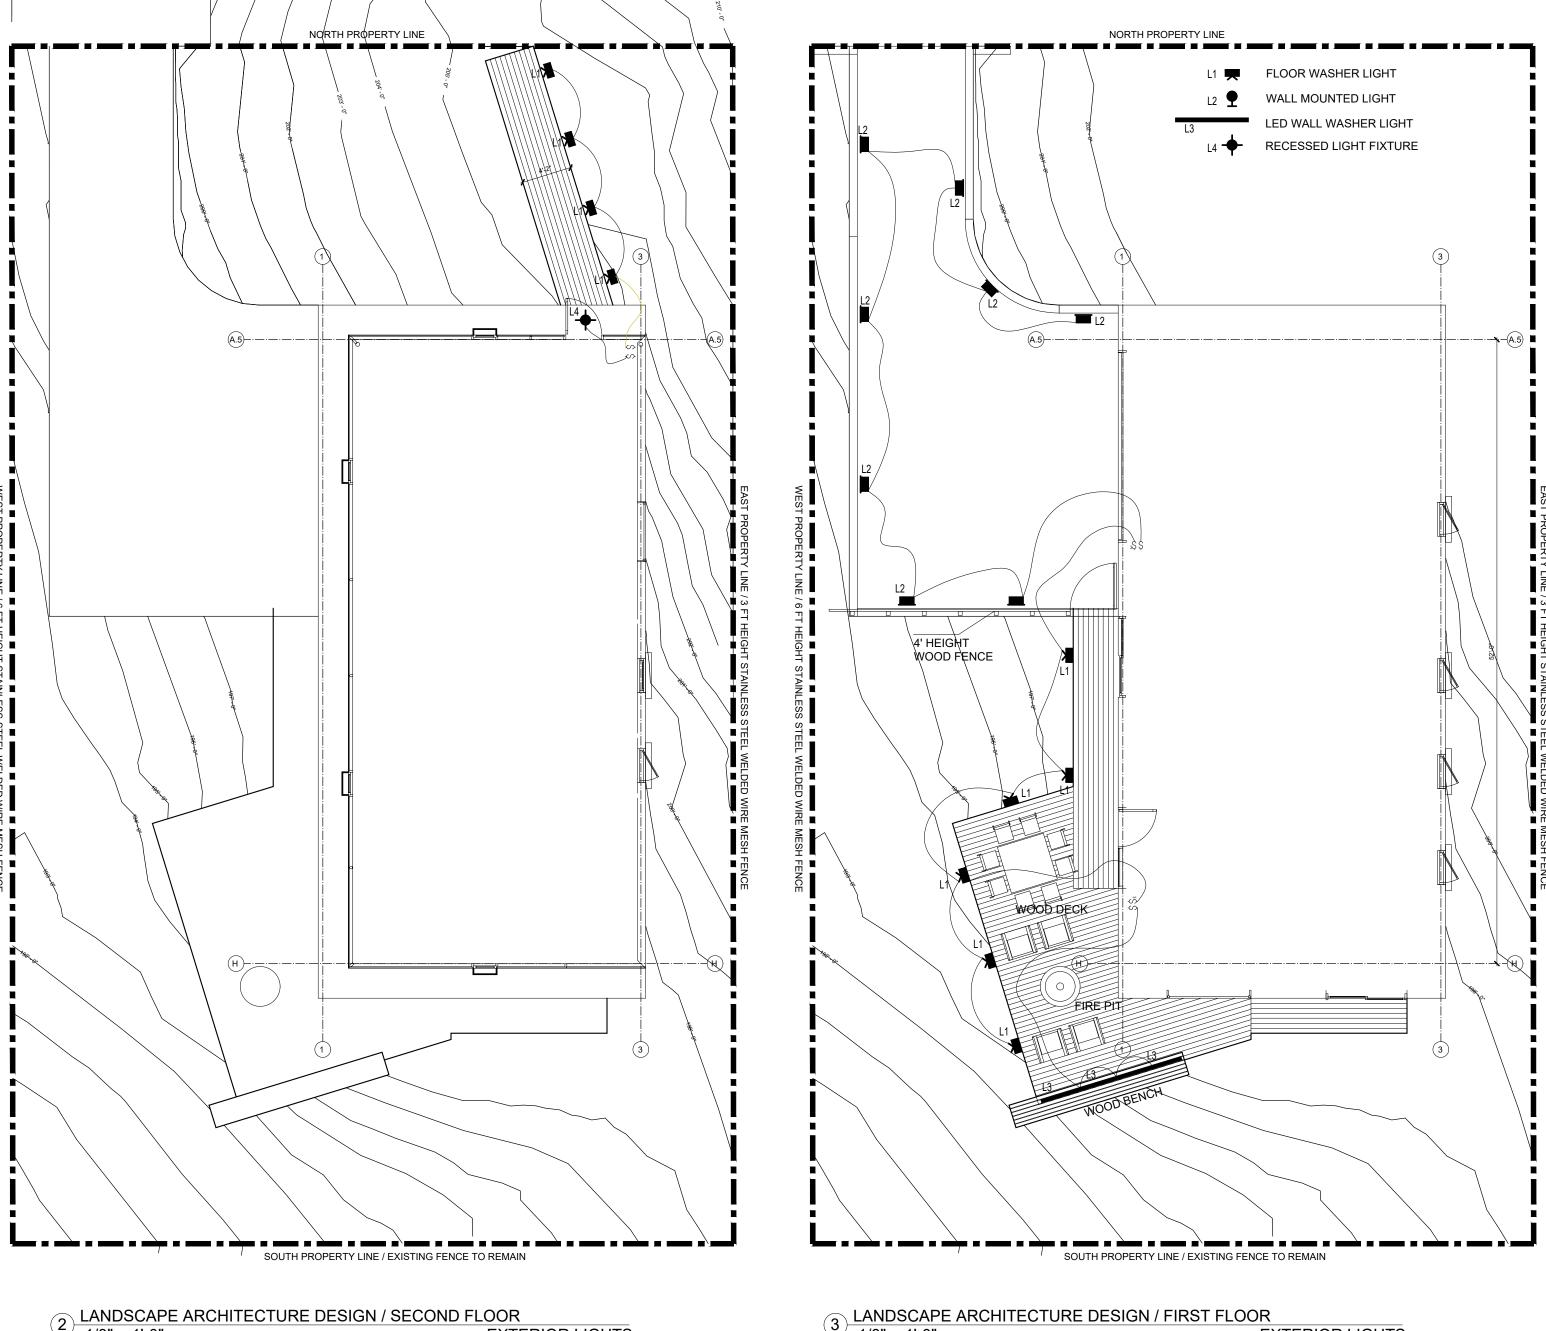

2 LANDSCAPE ARCHITECTURE DESIGN / SECOND FLOOR **EXTERIOR LIGHTS** 

be 0.55 or below for residential areas, and 0.45 or

below for non residential areas.

WATER EFFICIENTE LANDSCAPE WORKSHEET

2,709

2,709

0,42

B/A

(B/D)

(B/D) + (A/C) 0,42

Reference Evapotranspiration (ETo) 33.9

Total Area

Total Area

Average ETAF

Average ETAF

All Landscapes Areas Total ETAF x Area

Montara Water and Sanitary District ETAF (PF/IE) Plant Irrigation Factor (PF) Method Landscape ETAF x Area Estimated Total Total Landscape Area 3,346 sq/ft Area (sp, ft) Total Landscape Area covered by 455 sq/ft Regular Landscape Areas entrance and backyard decks . Front yard east Total Landscape Area to be planted 2,891 sq/ft 2,891 sq/ft New landscape area Front vard mid 2 2,891 sq/ft Planted area 4. Front vard trees The site is located in the USDA Plant Hardiness Zone 10a : 30 to 35 (F) 5. Side yard east trees Recirculating water systems shall be used for water features 0.75 7. Back vard trees 100 A minimum 3-inch layer of mulch shall be applied on all exposed soil surfaces of 8. Back vard east 0.81 planting areas except turf areas, creeping or rooting groundcovers, or direct seeding 9. Back yard mid applications where mulch is contraindicated. 10. Side yard west trees - For soils less than 6% organic matter in the top 6 inches of soil, compost at a rate 0.81 1. Back yard west of a minimum of four cubic yards per 1,000 square feet of permeable area shall be 0.81 0.4 12. Side vard west incorporated to a depth of six inches into the soil. DRIP 0.81 0.4 TOTALS 2,709 (A) 1,151 (B) At the time of final inspection, the permit applicant must provide the owner of the Special Landscape Areas property with a certificate of completion, certificate of installation, irrigation schedule of landscape and irrigation maintenance. · Unless contradicted by a soil test, compost at a rate of a minimum of four cubic ETWU Total 22,821 yards per 1,000 square feet of permeable area shall be incorporated to a depth of Maximum Allowed Water Allowance (MAWA) 31,316 six inches into the soil. **ETAF Calculations** - A diagram of the irrigation plan showing hydrozones shall be kept with the irrigation Regular Landscape Areas controller for subsequent management purposes Average ETAF for Regular Landscape Areas must Total ETAF x Area

Project Type

Water Supply

- A Certificate of Completion shall be filled out and certified by either the designer of the landscape plans, irrigation plans, or the licensed landscape contractor for - An irrigation audit report shall be completed at the time of final inspection.

New dwelling

Potable water

- A diagram of the irrigation plan showing hydrozones shall be kept with the irrigation controller for subsequent management purposes. - A certificate of completion shall be filled out and certified by either the LA, designer, of the planting/irrigation plans, or the licensed landscape contractor for the project. - At the time of final inspection, the permit applicant must provide the owner of the property with a certificate of completion, certificate of installation, irrigation schedule of landscape and irrigation maintenance.

THE SOIL MANAGEMENT REPORT, REQUESTED BY THE WATER EFFICIENT LANDSCAPE ORDINANCE (WELO) WILL BE ADDED IN A DEFERRED SUBMITTAL

IT WILL BE PROVIDED WITH THE BUILDING PERMIT APPLICATION.

**EXTERIOR LIGHTS** 

COUNTY APPROVAL STAMP

I agree to comply with the requirements

of the water efficient landscape

ordinance and submit a complete


Landscape Documentation Package

Tomas McKay. May 6th, 2021

# FOR REVIEW & FILING **NOT FOR CONSTRUCTION**

STAMP:

**REVISION:** 

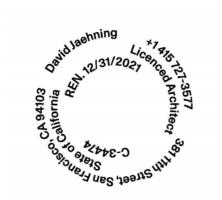

# **David Jaehning Architect**

381 11th Street. San Francisco. California 94103

**CONSULTANT TEAM:** STRUCTURAL/CIVIL: Design Everest, Inc. 365 Flower Lane, Mountain View, CA 94043

LANDSCAPE ARCHTECTURE: Tomas McKay: Architecture-Landscape Architecture 217 Bonita Avenue, Piedmont, CA 94611

IRRIGATION: Russell D Mitchel Associates, Inc. 2760 Camino Diablo, Walnut Creek, CA 94597

#### **Irene Chan-Jones and Bill Jones**

100 Burlwood Drive, San Francisco, CA 94127

PROJECT NAME: PROJECT NO:

**House on a Hill** 

**PROJECT** 340 10th Street Montara, CA 94037 ADDRESS:

PROJECT PHASE: 100% Schematic Design

DRAWN: CHECKED DJ

07/22/2021 12:30 AM


DRAWING TITLE: LANDSCAPE DESIGN PLAN &

SITE LIGHTING PLAN


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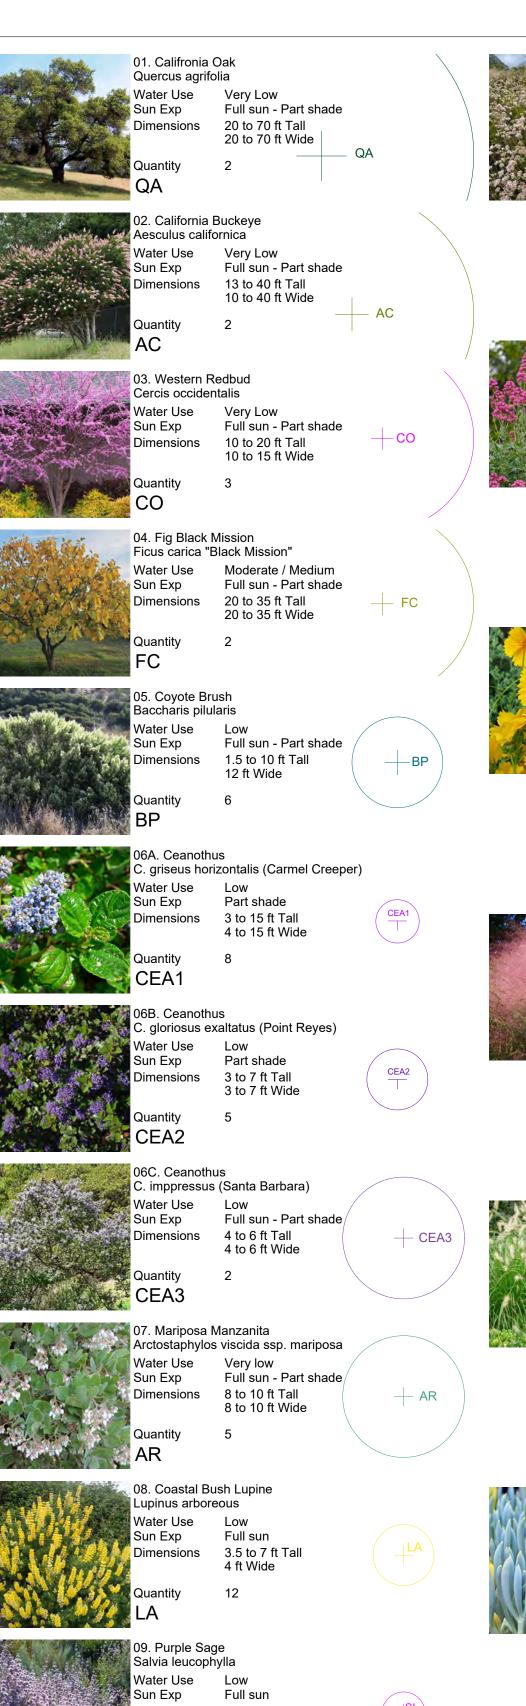
**L001** 

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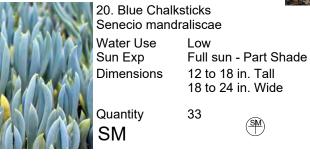


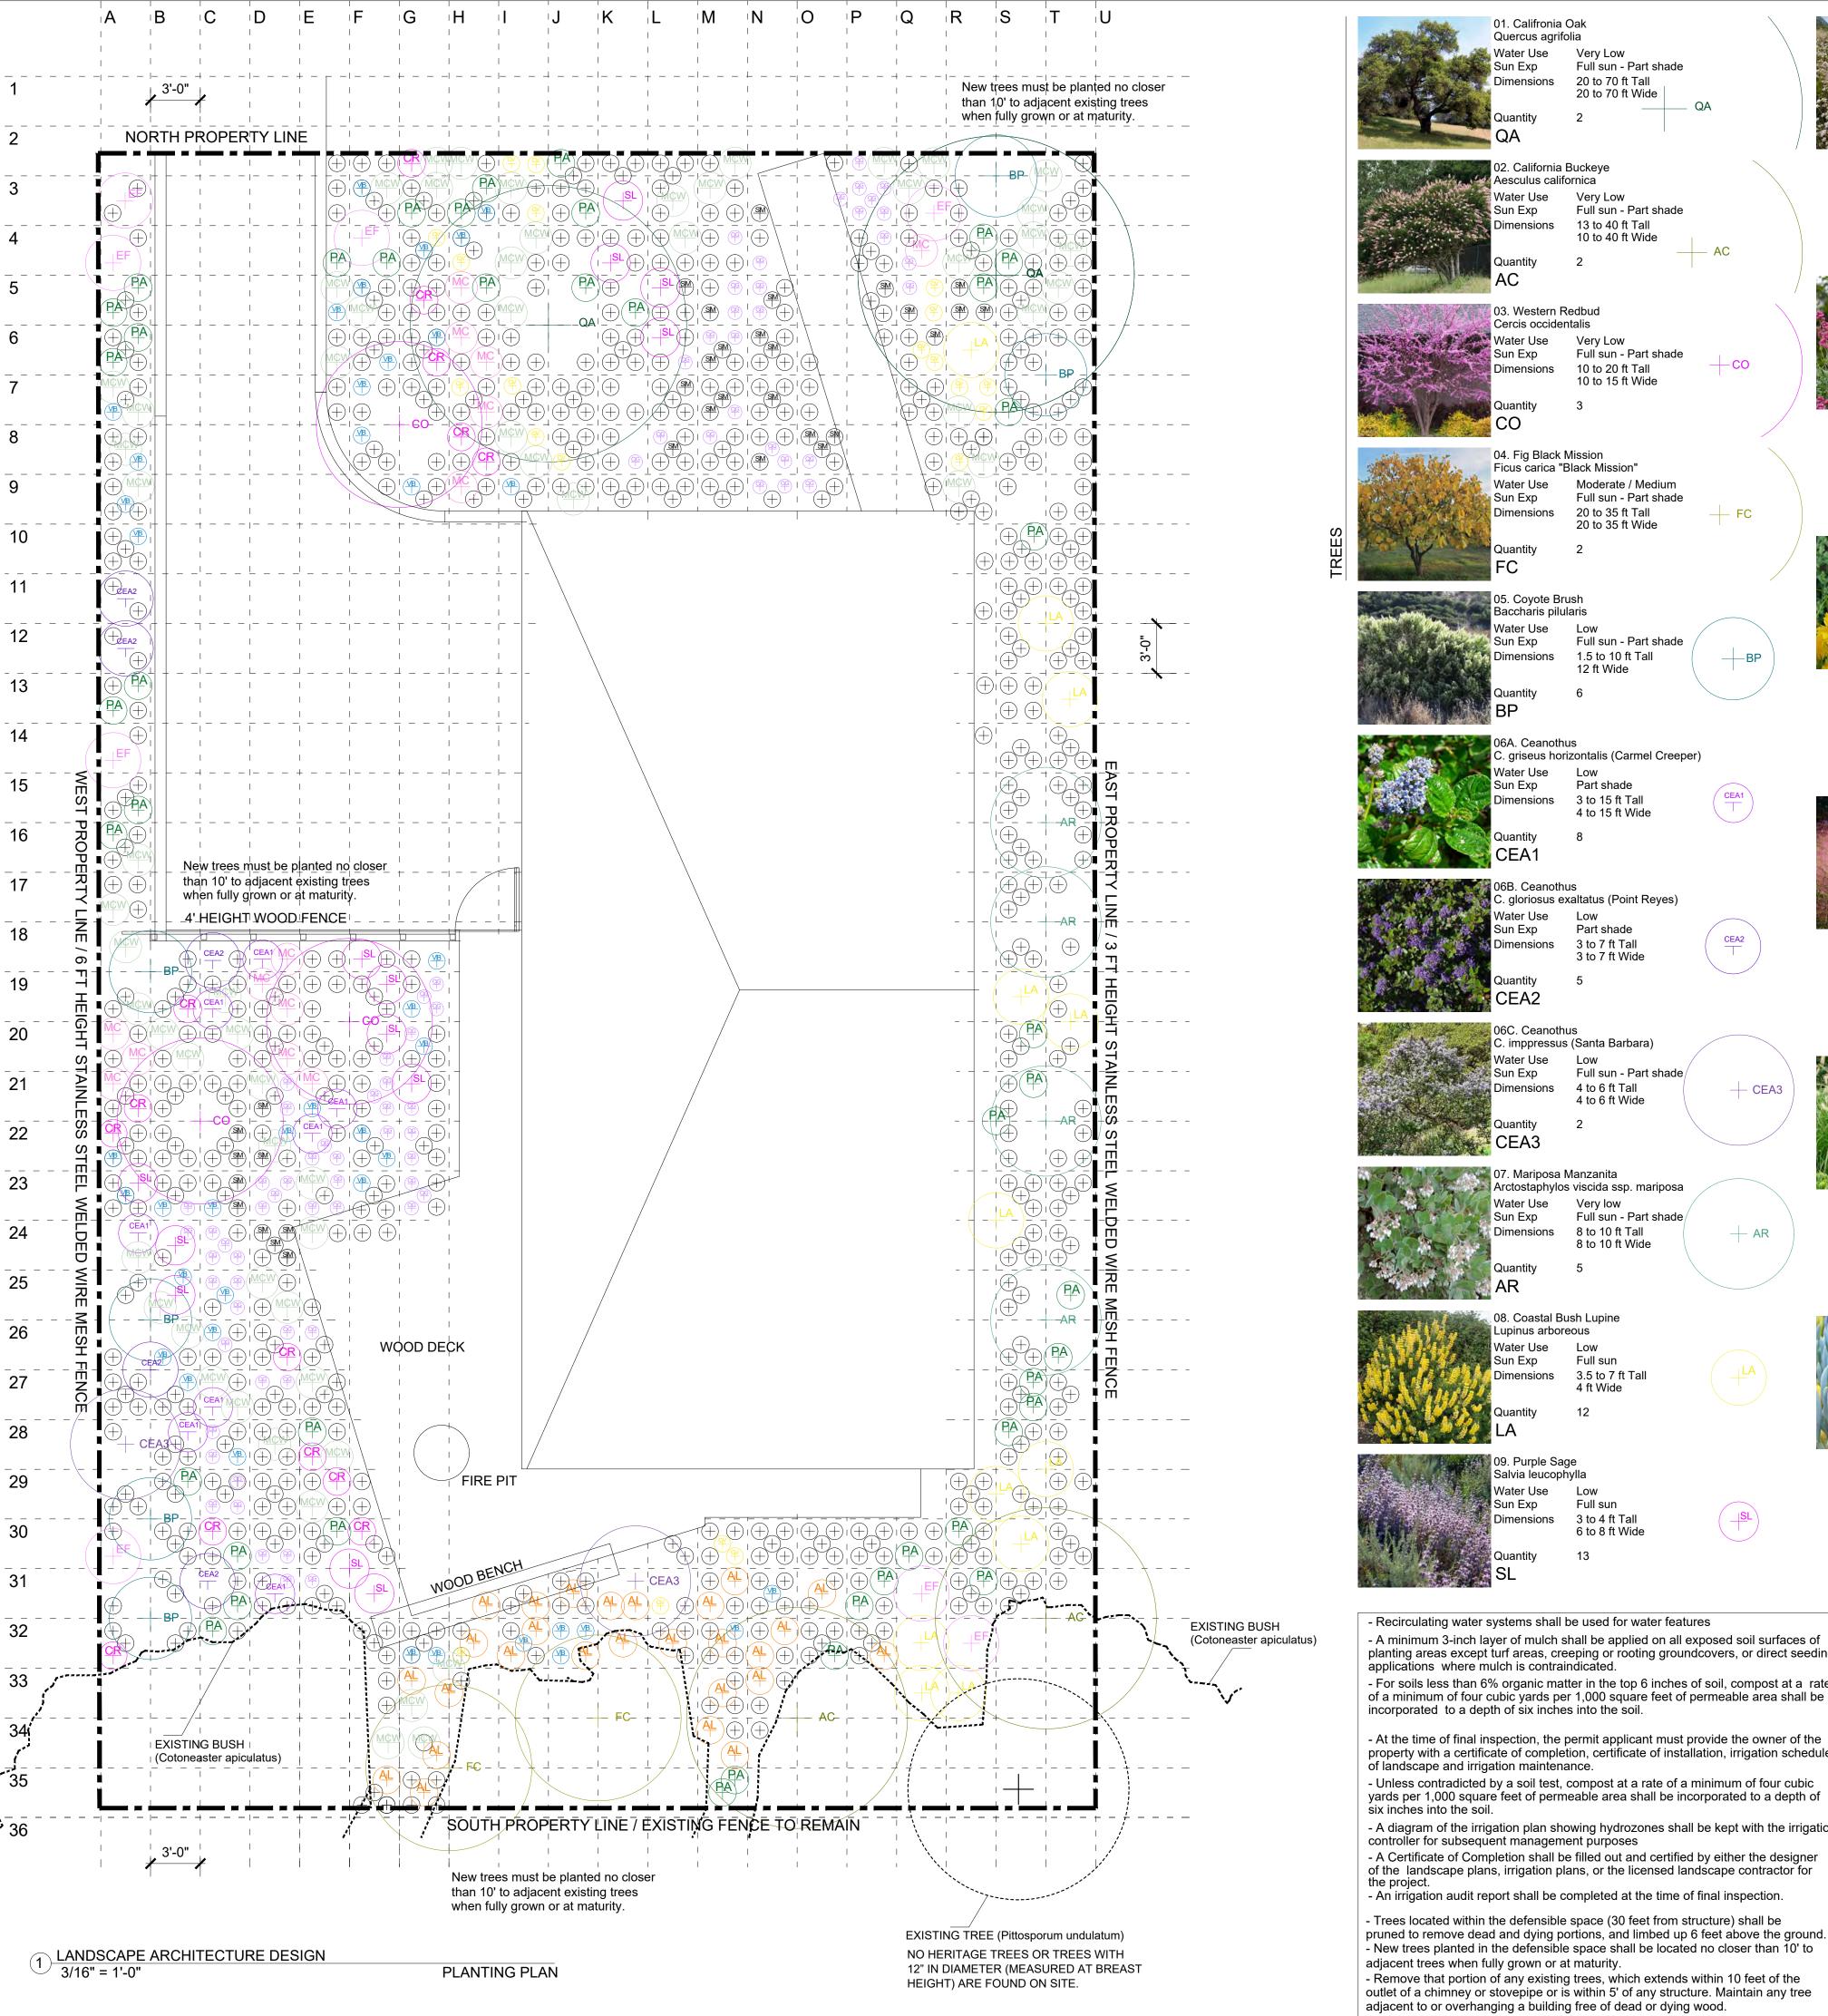



6 to 8 ft Wide



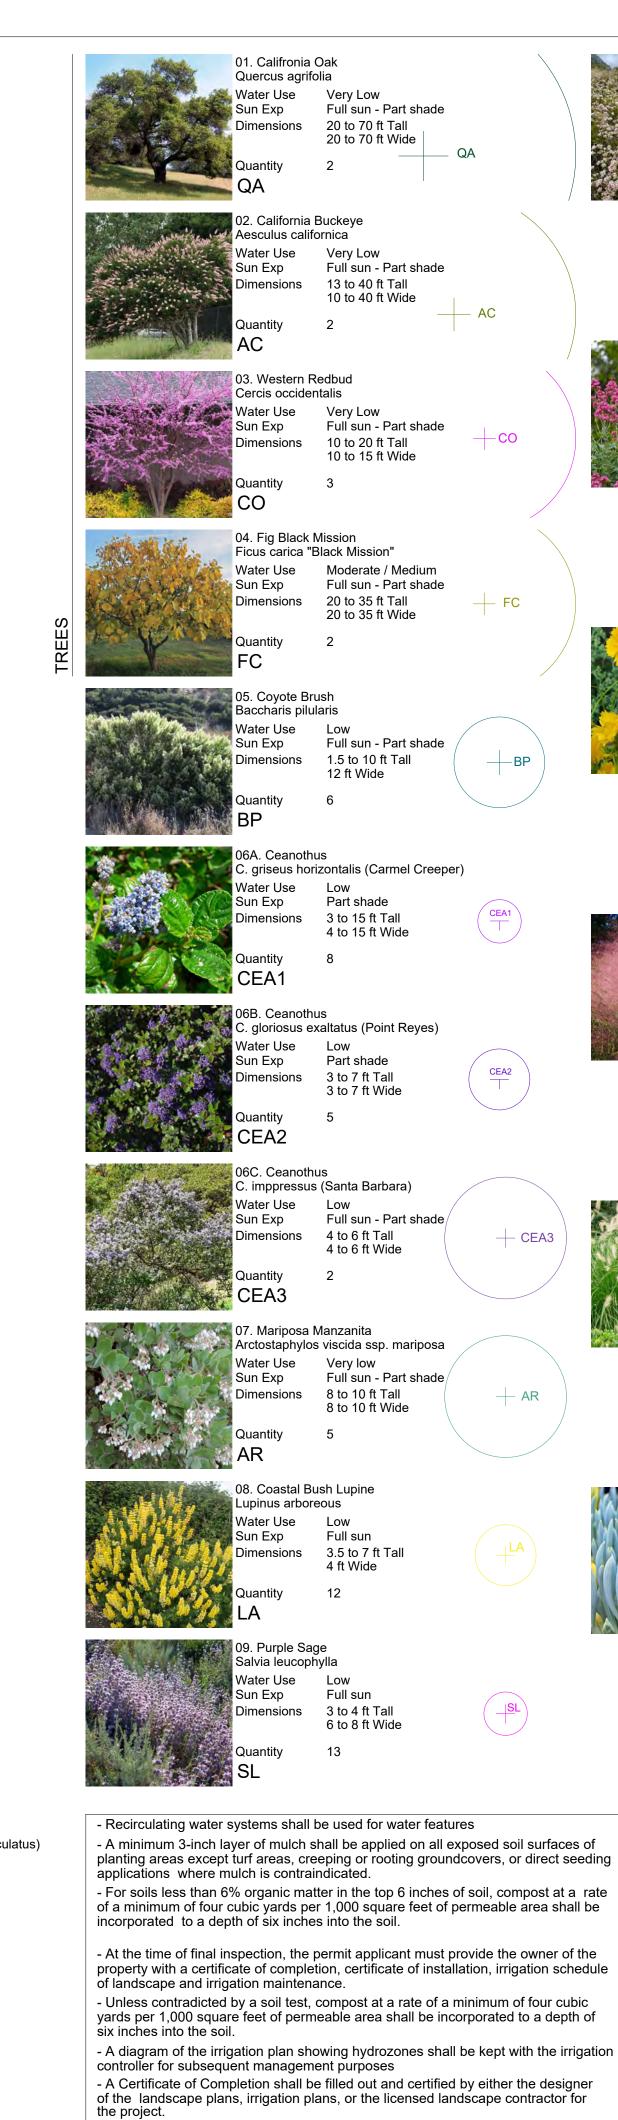



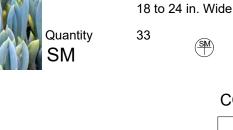

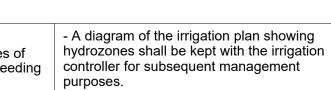

- A certificate of completion shall be filled out and certified by either the LA, designer, of the planting/irrigation plans, or the licensed landscape contractor for the

- At the time of final inspection, the permit applicant must provide the owner of the property with a certificate of completion, certificate of installation, irrigation schedule of landscape and irrigation maintenance.

> I agree to comply with the requirements of the water efficient landscape ordinance and submit a complete Landscape Documentation Package Tomas McKay. May 6th, 2021



Sun Exp

Water Use

Sun Exp

Full sun

2 ft Wide

Dimensions 2 to 3 ft Tall

Threadleaf Coreopsis Coreopsis verticillata cvs.

Sun Exp Full sun

Muhlenbergia capillaris

Sun Exp

Quantity

18. Fountain Grass

Water Use

Dimensions

Sun Exp

Pennisetum alopecuroides 'Hameln'


Full sun - Part Shade

1.5 to 2.5 ft Tall

1.5 to 2.5 ft Wide

Dimensions 1 to 2 ft Tall



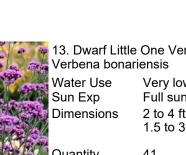

13. Dwarf Little One Verbena / 14 Sun Exp Full sun - Part Shade Dimensions 2 to 4 ft Tall 1.5 to 3 ft Wide

Sun Exp Full sun - Part Shade 0.5 to 2 ft Tall Dimensions 2 ft Wide

Full sun - Part Shade Dimensions 2 to 3 ft Tall 2 to 3 ft Wide 7. White Cloud Muhlygrass



19. New Zealand Wind Grass Anemanthele lessoniana Water Use Moderate / Medium Sun Exp Full sun - Part Shade 2 to 3 ft Tall Dimensions 2 to 3 ft Wide

100 Burlwood Drive, San Francisco, CA 94127

**CONSULTANT TEAM:** 

STRUCTURAL/CIVIL:

LANDSCAPE ARCHTECTURE:

Russell D Mitchel Associates, Inc.

Design Everest, Inc.

IRRIGATION:

**REVISION:** 

STAMP:

COUNTY APPROVAL STAMP

House on a Hill

PROJECT NAME:

**FOR REVIEW & FILING** 

**NOT FOR CONSTRUCTION** 

**David Jaehning Architect** 

381 11th Street, San Francisco, California 94103

365 Flower Lane, Mountain View, CA 94043

217 Bonita Avenue, Piedmont, CA 94611

2760 Camino Diablo, Walnut Creek, CA 94597

Tomas McKay: Architecture-Landscape Architecture

**Irene Chan-Jones and Bill Jones** 

**PROJECT** 340 10th Street ADDRESS: Montara, CA 94037

PROJECT PHASE: 100% Schematic Design CHECKED DJ DRAWN:


ISSUE DATE: 07/23/2021 12:30 PM

DRAWING TITLE: LANDSCAPE PLANTING PLAN

**L002** DRAWING NO:

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PROJECT NO:

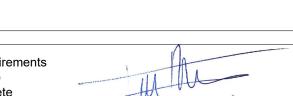

IRRIGATION CONTROLLER "C". MOUNT ON INTERIOR WALL AT THIS LOCATION AS DETAILED AND AS DIRECTED BY ARCHITECT. CONNECT TO 120 VOLT A.C. ELECTRICAL SERVICE INSTALLED AT THIS LOCATION UNDER ELECTRICAL CONTRACT. IRRIGATION CONTRACTOR SHALL COORDINATE LOCATION OF ELECTRICAL SERVICE PRIOR TO CONSTRUCTION. —

PROPOSED RESIDENCE WATER METER -

#### NOTES:


- 1. IRRIGATION EQUIPMENT MAY BE SHOWN WITHIN HARDSCAPE FOR GRAPHIC CLARITY ONLY. INSTALL ALL IRRIGATION EQUIPMENT WITHIN PLANTED AREAS. IRRIGATION PIPE AND WIRE CROSSING BENEATH HARDSCAPE SURFACES SHALL BE CONTAINED WITHIN SLEEVING OR SCHEDULE 40 PVC CONDUIT. SLEEVING SIZE SHALL BE A MINIMUM OF TWO TIMES THE AGGREGATE DIAMETER OF ALL PIPES CONTAINED WITH SLEEVE. PROVIDE VERTICAL SWEEP FOR ALL ELECTRICAL CONDUIT ON EACH SIDE OF HARDSCAPE AND TERMINATE ENDS AT 12" MINIMUM DEPTH AND 12" FROM HARDSCAPE SURFACE.
- 2. UNSIZED LATERAL LINE PIPING LOCATED DOWN STREAM OF 1" PIPING SHALL BE 3/4" IN SIZE (TYPICAL).
- 3. SIZING OF LATERAL PIPE SHALL BE AS FOLLOWS:

0-6 GPM 7-12 GPM 1.25" 13-20 GPM

4. SIZING OF LATERAL PIPE FOR DRIPLINE (12" O.C. GRID WITH 0.6 GPH OR LESS EMITTERS) SHALL BE AS FOLLOWS:

0-500 FT 501-1100 FT 1101-2000 FT

- 6. EACH DRIP ZONE SHALL RECEIVE A FLUSH VALVE AND OPERATION INDICATOR AT FARTHEST ENDS OF EACH SYSTEM.
- 7. CONTRACTOR TO INSTALL ALL IRRIGATION PIPING TO GO AROUND ALL UTILITY BOX, LIGHTS, SIGNS, ETC. (DRAWINGS ARE DIAGRAMMATIC).
- 8. CONTRACTOR TO LOCATE REMOTE CONTROL VALVE BOXES AWAY FROM PROMINENT, HIGHLY VISIBLE LOCATION. CONTACT LANDSCAPE ARCHITECT FOR EXACT LOCATIONS.

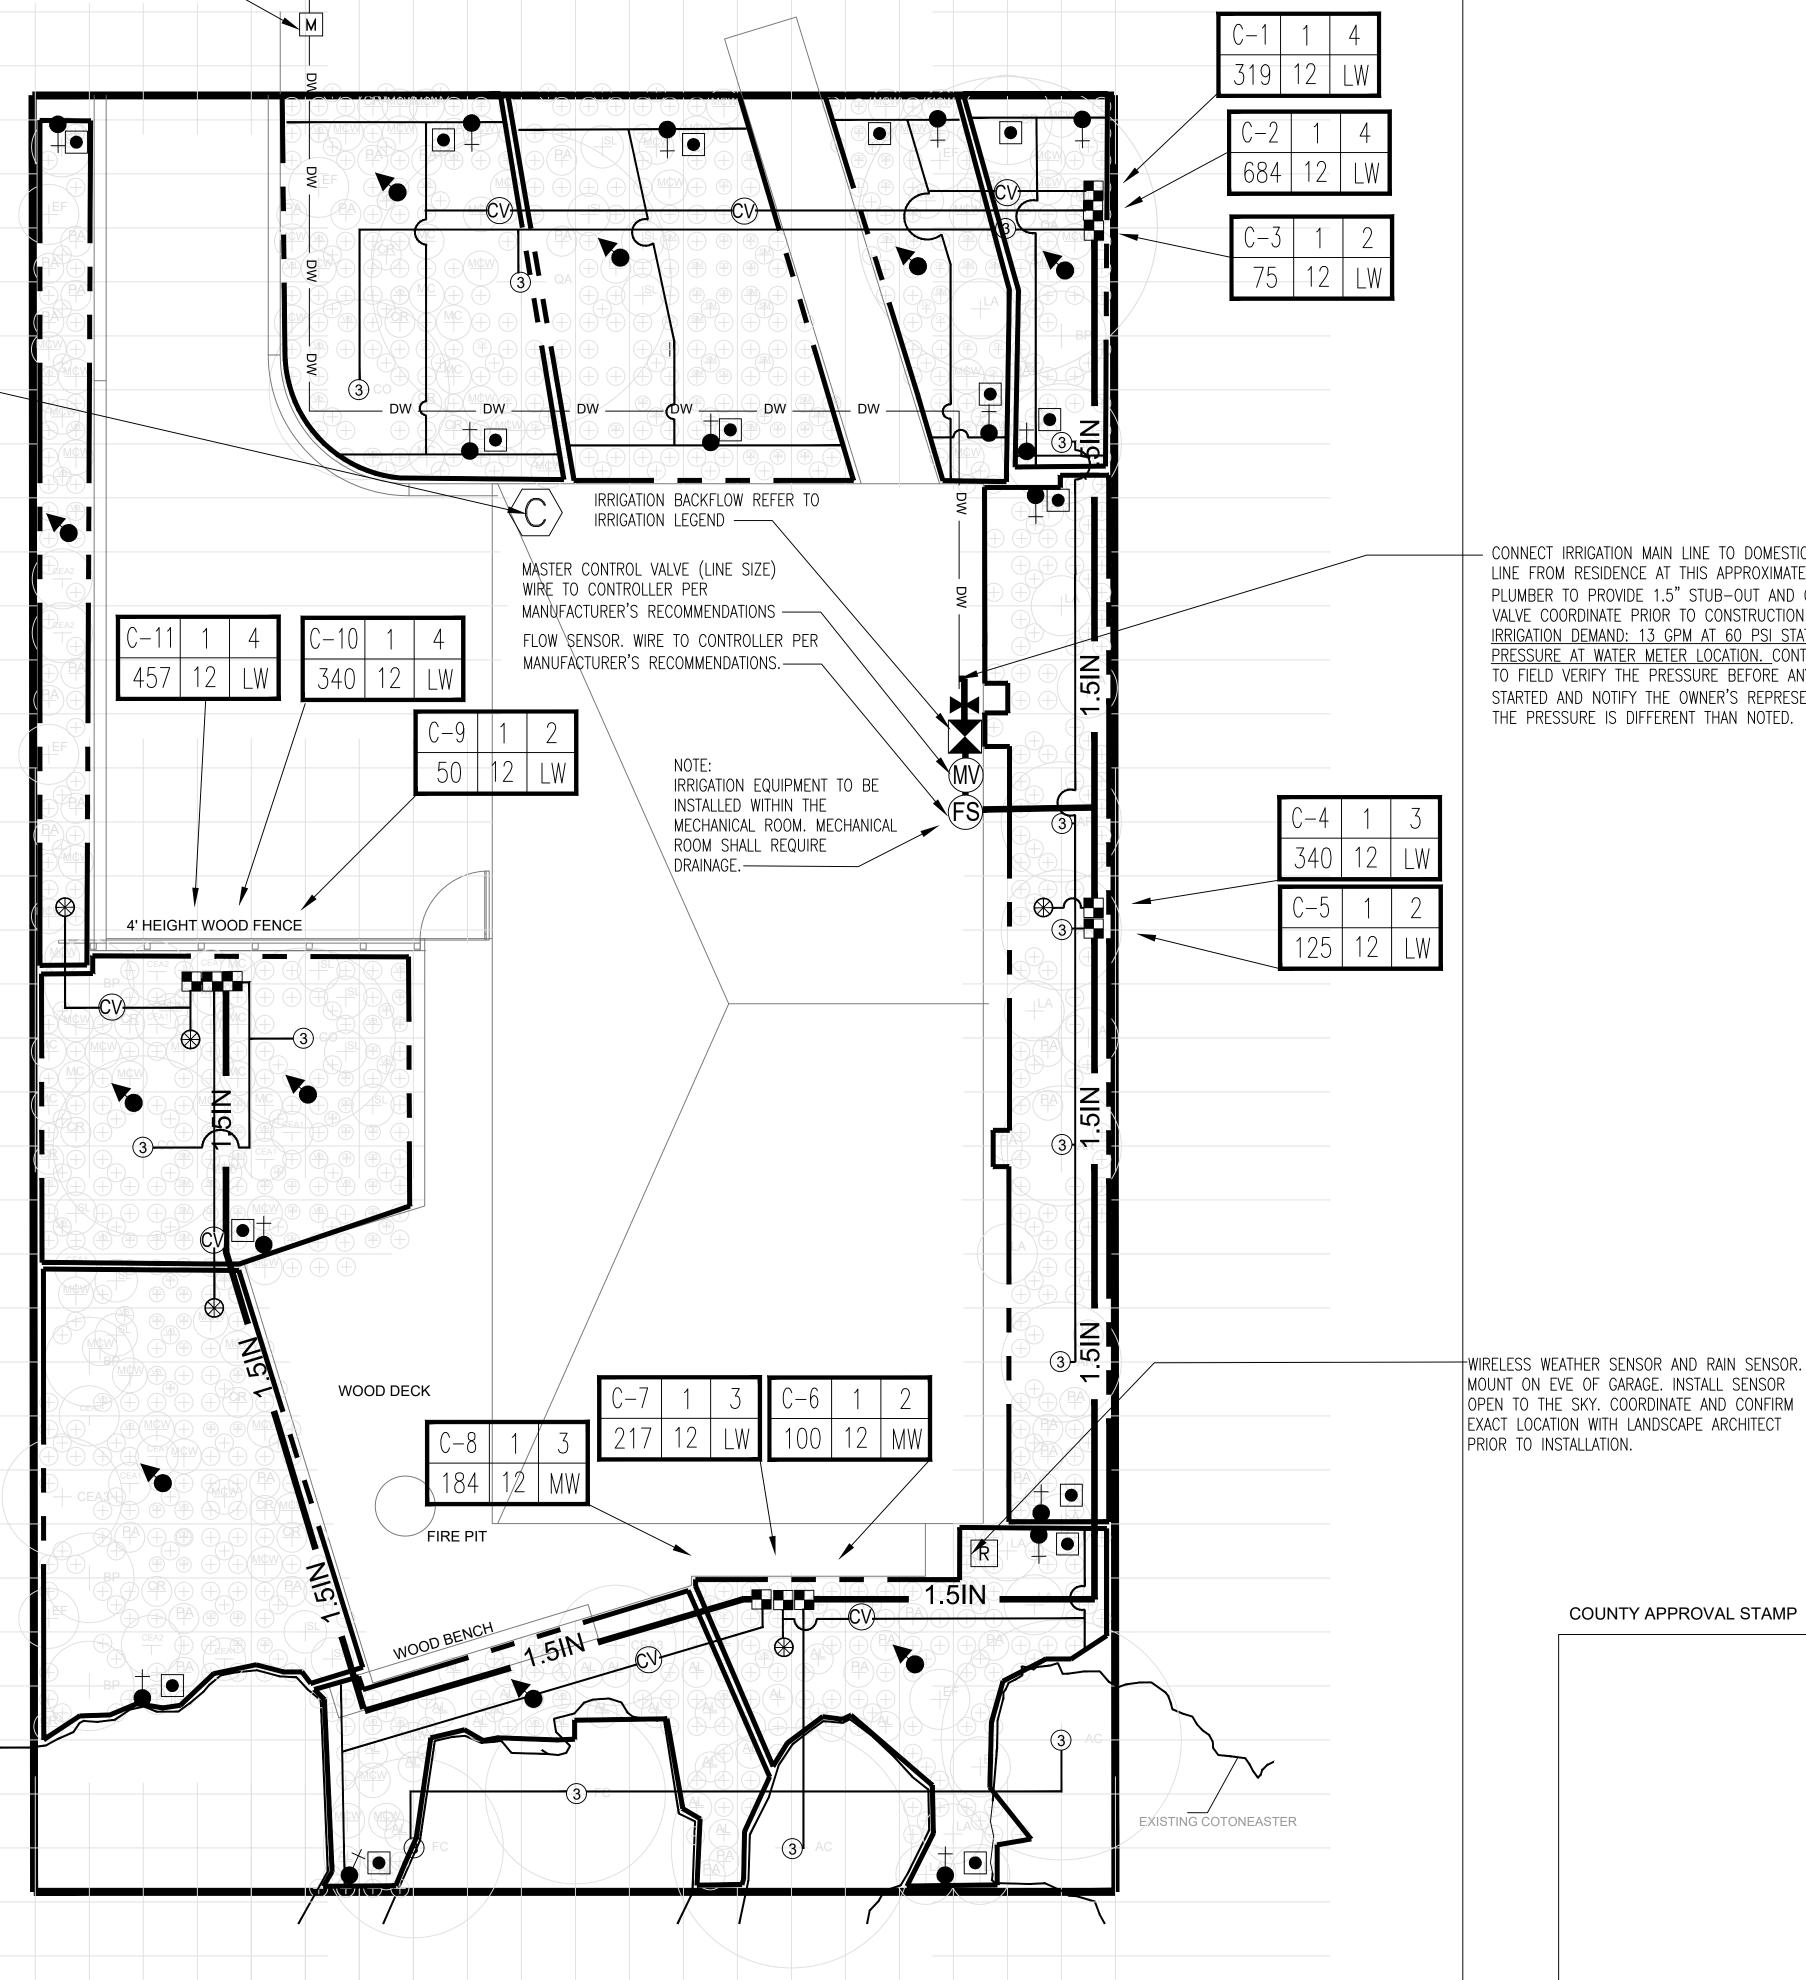

- CONNECT IRRIGATION MAIN LINE TO DOMESTIC WATER LINE FROM RESIDENCE AT THIS APPROXIMATE LOCATION PLUMBER TO PROVIDE 1.5" STUB-OUT AND GATE VALVE COORDINATE PRIOR TO CONSTRUCTION. MAXIMUM IRRIGATION DEMAND: 13 GPM AT 60 PSI STATIC PRESSURE AT WATER METER LOCATION. CONTRACTOR TO FIELD VERIFY THE PRESSURE BEFORE ANY WORK IS STARTED AND NOTIFY THE OWNER'S REPRESENTATIVE IF THE PRESSURE IS DIFFERENT THAN NOTED.

**FOR REVIEW & FILING NOT FOR CONSTRUCTION** 

ARCHITECT:

# **David Jaehning Architect**

381 11th Street, San Francisco, California 94103

**CONSULTANT TEAM:** STRUCTURAL/CIVIL: Design Everest, Inc. 365 Flower Lane, Mountain View, CA 94043

LANDSCAPE ARCHTECTURE: Tomas McKay: Architecture-Landscape Architecture 217 Bonita Avenue, Piedmont, CA 94611

IRRIGATION: Russell D Mitchell & Associates, Inc. 2760 Camino Diablo, Walnut Creek, CA 94597

CLIENT:

#### **Irene Chan-Jones and Bill Jones**

100 Burlwood Drive, San Francisco, CA 94127

COUNTY APPROVAL STAMP

PROJECT NO: PROJECT NAME: 2101 House on a Hill

APN: 036-031-280

**PROJECT** 10th St Montara, CA 94037

ADDRESS:

PROJECT PHASE: 100% Schematic Design

DRAWN: Jose Cruz CHECKED:

ISSUE DATE: 6/30/2021

DRAWING TITLE: IRRIGATION PLAN

DRAWING NO:

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Irrigation Consultant: Russell D. Mitchell Associates, Inc. 2760 Camino Diablo Walnut Creek, CA 94597

www.rmairrigation.com

 $1 \frac{\text{IRRIGATION PLAN}}{3/16" = 1'-0"}$ 



# IRRIGATION NOTES

- THESE IRRIGATION DRAWINGS ARE DIAGRAMMATIC AND INDICATIVE OF THE WORK TO BE INSTALLED. ALL PIPING, VALVES, AND OTHER IRRIGATION COMPONENTS MAY BE SHOWN WITHIN PAVED AREAS FOR GRAPHIC CLARITY ONLY AND ARE TO BE INSTALLED WITHIN PLANTING AREAS. DUE TO THE SCALE OF THE DRAWINGS, IT IS NOT POSSIBLE TO INDICATE ALL OFFSETS, FITTINGS, SLEEVES, CONDUIT, AND OTHER ITEMS WHICH MAY BE REQUIRED. INVESTIGATE THE STRUCTURAL AND FINISHED CONDITION AFFECTING THE CONTRACT WORK INCLUDING OBSTRUCTIONS, GRADE DIFFERENCES OR AREA DIMENSIONAL DIFFERENCES. IN THE EVENT OF FIELD DISCREPANCY WITH CONTRACT DOCUMENTS, PLAN THE INSTALLATION WORK ACCORDINGLY BY NOTIFICATION AND APPROVAL OF THE OWNER'S AUTHORIZED REPRESENTATIVE AND ACCORDING TO THE CONTRACT SPECIFICATIONS. NOTIFY AND COORDINATE IRRIGATION CONTRACT WORK WITH APPLICABLE CONTRACTORS FOR THE LOCATION AND INSTALLATION OF PIPE, CONDUIT OR SLEEVES THROUGH OR UNDER WALLS, ROADWAYS, PAVING AND STRUCTURES BEFORE CONSTRUCTION. IN THE EVENT THESE NOTIFICATIONS ARE NOT PERFORMED, THE CONTRACTOR ASSUMES FULL RESPONSIBILITY FOR REQUIRED REVISIONS.
- 2. THE CONTRACTOR SHALL COMPLY WITH ALL APPLICABLE CODES, STANDARDS, AND REGULATIONS. ALL WORK AND MATERIALS SHALL BE IN FULL ACCORDANCE WITH THE LATEST RULES AND REGULATIONS OF THE NATIONAL ELECTRIC CODE; THE UNIFORM PLUMBING CODE, PUBLISHED BY THE WESTERN PLUMBING OFFICIALS ASSOCIATION; AND OTHER STATE OR LOCAL LAWS OR REGULATIONS. NOTHING IN THESE DRAWINGS IS TO BE CONSTRUED TO PERMIT WORK NOT CONFORMING TO THESE CODES OR REGULATIONS. THE CONTRACTOR SHALL FURNISH WITHOUT ANY EXTRA CHARGE, ANY ADDITIONAL MATERIAL AND LABOR WHEN REQUIRED BY THE COMPLIANCE WITH THESE CODES AND REGULATIONS.
- 3. THE CONTRACTOR SHALL COORDINATE INSTALLATION OF IRRIGATION SYSTEM WITH LAYOUT AND INSTALLATION OF THE PLANT MATERIALS TO INSURE THAT THERE WILL BE COMPLETE AND UNIFORM IRRIGATION COVERAGE OF PLANTING IN ACCORDANCE WITH THESE DRAWINGS, AND CONTRACT DOCUMENTS. THE IRRIGATION LAYOUT SHALL BE CHECKED BY THE CONTRACTOR AND OWNER'S AUTHORIZED REPRESENTATIVE PRIOR TO CONSTRUCTION TO DETERMINE IF ANY CHANGES, DELETIONS, OR ADDITIONS ARE REQUIRED. IRRIGATION SYSTEM SHALL BE INSTALLED AND TESTED PRIOR TO INSTALLATION OF PLANT MATERIAL.
- 4. THE INTENT OF THIS IRRIGATION SYSTEM IS TO PROVIDE THE MINIMUM AMOUNT OF WATER REQUIRED TO SUSTAIN GOOD PLANT HEALTH.
- 5. IT IS THE RESPONSIBILITY OF THE MAINTENANCE CONTRACTOR AND/OR OWNER TO PROGRAM THE IRRIGATION CONTROLLER(S) TO PROVIDE THE MINIMUM AMOUNT OF WATER NEEDED TO SUSTAIN GOOD PLANT HEALTH. THIS INCLUDES MAKING ADJUSTMENTS TO THE PROGRAM FOR SEASONAL WEATHER CHANGES, PLANT MATERIAL, WATER REQUIREMENTS, MOUNDS, SLOPES, SUN, SHADE AND WIND EXPOSURE.
- 6. IT IS THE RESPONSIBILITY OF A LICENSED ELECTRICAL CONTRACTOR TO PROVIDE 120 VOLT A.C. (2.5 AMP DEMAND PER CONTROLLER) ELECTRICAL SERVICE TO THE CONTROLLER LOCATION(S). IT IS THE RESPONSIBILITY OF THE IRRIGATION CONTRACTOR TO COORDINATE THE ELECTRICAL SERVICE STUB-OUT TO THE CONTROLLER(S). PROVIDE PROPER GROUNDING PER CONTROLLER MANUFACTURER'S INSTRUCTIONS AND IN ACCORDANCE WITH LOCAL CODES.
- SCHEDULE A MEETING WHICH INCLUDES REPRESENTATIVES OF THE IRRIGATION CONTROLLER MANUFACTURER, THE MAINTENANCE CONTRACTOR, THE OWNER AND THE IRRIGATION CONTRACTOR AT THE SITE FOR INSTRUCTION ON THE PROPER PROGRAMMING AND OPERATION OF THE IRRIGATION CONTROLLER.
- 8. INSTALL 3" DETECTABLE TAPE ABOVE ALL PRESSURIZED MAIN LINES AS DETAILED. USE CHRISTY MODEL #TA-DT-3-BIRR FOR POTABLE IRRIGATION SYSTEMS OR #TA-DT-3-PRW FOR RECYCLED IRRIGATION WATER SYSTEMS.
- PROVIDE EACH IRRIGATION CONTROLLER WITH ITS OWN INDEPENDENT LOW VOLTAGE COMMON GROUND WIRE.
- 10. IRRIGATION CONTROL WIRES: SOLID COPPER WITH U.L. APPROVAL FOR DIRECT BURIAL IN GROUND. COMMON GROUND WIRE: SIZE #12-1 WIRE WITH A WHITE INSULATING JACKET. CONTROL WIRE SERVICING REMOTE CONTROL VALVES: SIZE #14-1 WIRE WITH INSULATING JACKET OF COLOR OTHER THAN WHITE. SPLICES SHALL BE MADE WITH 3M-DBY SEAL PACKS OR APPROVED EQUAL.
- 11. SPLICING OF LOW VOLTAGE WIRES IS PERMITTED IN VALVE BOXES ONLY. LEAVE A 36" LONG, 1" DIAMETER COIL OF EXCESS WIRE AT EACH SPLICE AND A 36" LONG EXPANSION LOOP EVERY 100 FEET ALONG WIRE RUN. TAPE WIRES TOGETHER EVERY TEN FEET. DO NOT TAPE WIRES TOGETHER WHERE CONTAINED WITHIN SLEEVING OR CONDUIT.
- 12. INSTALL BLACK PLASTIC VALVE BOXES WITH BOLT DOWN, NON HINGED COVER MARKED "IRRIGATION CONTROL VALVE". BOX BODY SHALL HAVE KNOCK OUTS. ACCEPTABLE VALVE BOX MANUFACTURER'S INCLUDE NDS, CARSON OR APPROVED EQUAL.

- 13. THE CONTRACTOR SHALL LABEL CONTROL LINE WIRE AT EACH REMOTE CONTROL VALVE WITH A 2 1/4" X 2 3/4" POLYURETHANE I.D. TAG, INDICATING IDENTIFICATION NUMBER OF VALVE (CONTROLLER AND STATION NUMBER). ATTACH LABEL TO CONTROL WIRE. THE CONTRACTOR SHALL PERMANENTLY STAMP ALL VALVE BOX LIDS WITH APPROPRIATE IDENTIFICATION AS NOTED IN CONSTRUCTION DETAILS.
- 14. FLUSH AND ADJUST IRRIGATION OUTLETS AND NOZZLES FOR OPTIMUM PERFORMANCE AND TO PREVENT OVER SPRAY ONTO WALKS, ROADWAYS, AND/OR BUILDINGS. SELECT THE BEST DEGREE OF THE ARC AND RADIUS TO FIT THE EXISTING SITE CONDITIONS AND THROTTLE THE FLOW CONTROL AT EACH VALVE TO OBTAIN THE OPTIMUM OPERATING PRESSURE FOR EACH CONTROL ZONE.
- 15. WHERE IT IS NECESSARY TO EXCAVATE ADJACENT TO EXISTING TREES, USE CAUTION TO AVOID INJURY TO TREES AND TREE ROOTS. EXCAVATE BY HAND IN AREAS WHERE TWO (2) INCH AND LARGER ROOTS OCCUR. BACK FILL TRENCHES ADJACENT TO TREE WITHIN TWENTY-FOUR (24) HOURS. WHERE THIS IS NOT POSSIBLE SHADE THE SIDE OF THE TRENCH ADJACENT TO THE TREE WITH WET BURLAP OR CANVAS.
- 16. THE IRRIGATION SYSTEM DESIGN IS BASED ON THE MINIMUM OPERATING PRESSURE SHOWN ON THE IRRIGATION DRAWINGS. VERIFY WATER PRESSURE PRIOR TO CONSTRUCTION. REPORT ANY DIFFERENCE BETWEEN THE WATER PRESSURE INDICATED ON THE DRAWINGS AND THE ACTUAL PRESSURE READING AT THE IRRIGATION POINT OF CONNECTION TO THE OWNER'S AUTHORIZED REPRESENTATIVE.
- 17. IRRIGATION DEMAND: REFER TO PLANS.
- 18. THE EXISTING MAIN LINE SHOWN ON THE DRAWINGS IS DIAGRAMMATIC. VERIFY AND LOCATE EXISTING MAIN LINE IN FIELD REPORT TO ARCHITECT IN WRITING ANY DEVIATION OF EXISTING MAIN LINE LOCATION FROM THAT SHOWN ON THE DRAWINGS.
- 19. PIPE THREAD SEALANT COMPOUND SHALL BE RECTOR SEAL #5.
- 20. THE LANDSCAPE CONTRACTOR SHALL BE RESPONSIBLE FOR MINOR CHANGES IN THE IRRIGATION LAYOUT DUE TO OBSTRUCTIONS NOT SHOWN ON THE IRRIGATION DRAWINGS SUCH AS LIGHTS, FIRE HYDRANTS, SIGNS, ELECTRICAL ENCLOSURES, ETC.
- 21. WHEN WORK OF THIS SECTION HAS BEEN COMPLETED AND SUCH OTHER TIMES AS MAY BE DIRECTED, REMOVE ALL TRASH, DEBRIS, SURPLUS MATERIALS AND EQUIPMENT FROM SITE.
- 22. CONTRACTOR SHALL BE RESPONSIBLE FOR SUPPLEMENTAL HAND WATERING OF ALL PLANT MATERIAL WITHIN DRIPLINE AREAS UNTIL THE PLANTS ARE SUFFICIENTLY ESTABLISHED.
- 33. CONTRACTOR SHALL PROVIDE COMPLETE CONTROLLER HYDROZONES CHARTS AND PLACE WITHIN CONTROLLER ENCLOSURE AFTER AS-BUILT DRAWINGS HAVE BEEN COMPLETED. REVIEWED AND APPROVED BY THE CITY LANDSCAPE ARCHITECT.
- 34. A CERTIFICATE OF COMPLETION SHALL BE FILLED OUT AND CERTIFIED BY EITHER LA, DESIGNER, OF THE PLANTING/ THE LICENSED LANDSCAPE CONTRACTOR FOR THE PROJECT.
- 35. AT THE TIME OF FINAL INSPECTION, THE PERMIT APPLICANT MUST PROVIDE THE OWNER OF THE PROPERTY WITH A CERTIFICATE OF COMPLETION, CERTIFICATE OF INSTALLATION, IRRIGATION SCHEDULE OF LANDSCAPE AND IRRIGATION MAINTENANCE, ALL THESES SHALL BE COMPLETED BY LANDSCAPE CONTRACTOR.

"A Landscape Irrigation Audit is require. This Audit must be completed by a Certified Landscape Irrigation Auditor, not the designer or installer. The Audit must be submitted to the Building Department, with Certificate of Completion (Appendix C) as required by the Department of Water Resources, prior to scheduling a Final Inspection of the Water Efficient Landscape permit."

WATER CONSERVATION STATEMENT RUSSELL D MITCHELL AND ASSOCIATES, INC. (RMA) HAVE COMPLIED WITH THE CRITERIA OF THE MODEL WATER EFFICIENT LANDSCAPE ORDINANCE AND APPLIED THEM ACCORDINGLY FOR THE EFFICIENT USE OF WATER IN THE LANDSCAPE DESIGN PLAN. Ine Co JOSE L. CRUZ IRRIGATION CONSULTANT-PROJECT MANAGER

IRRIGATION LEGEND

SYMBOL	NUMBER	DESCRIPTION	NOZZLE GPM	OPERATING PSI	OPERATING RADIUS (FEET)							
<b>⚠</b>	DB-04-PC-CV	TORO BUBBLE (SHRUB) MIN. 1 PER SHRUB	0.066	30	TRICKLE							
3	HDL-04-CV	ON GRADE HUNTER HDL DRIP RING FOR TREES (3 RINGS PER TREE) SEE DETAIL	GRADE HUNTER HDL DRIP 0.10 30 G FOR TREES (3 RINGS PER									
•	ICV-100	HUNTER REMOTE CONTROL VALV	' /E	1	1							
<b>B</b>	ICZ-101	HUNTER REMOTE CONTROL VALV	VE DRIPZONE KIT	-								
•+	PLD-BV	HUNTER MANUAL FLUSH VALVE										
•	ECO-ID	HUNTER ECO-INDICATOR										
<b>₩</b>	T-580-A-1.25" ICV-101G	NIBCO BRASS BALL VALVE HUNTER MASTER VALVE (NORMA	ALLY CLOSED)									
FS	HC-100-FLOW	HUNTER FLOW METER-PRIVATE	METER									
	975XLSEU-1"	WILKINS REDUCED PRESSURE E	BACKFLOW ASSEM	IBLY								
C	PHC-600i	HUNTER PRO-HC (6-24) STATE ENCLOSURE.	TION CONTROLLE	R IN A PLASTIC	C WALL MOUNTED							
R	WR-CLIK	HUNTER WIRELESS RAIN-CLIK S AS SOON AS IT STARTS RAINING		ICALLY SHUTS	THE SYSTEM OFF							
(CV)	KC OR KSC	NDS KSC SERIES CHECK VALVE SPRING CHECK VALVE FOR DOW										
	· 	CONTROLLER AND STATION NUM	1BER									
		REMOTE CONTROL VALVE SIZE	(IN INCHES)									
• •	•	FLOW (GPM)										
•		WATER USE CLASSIFICATION OF	ZONE									
		APPLICATION RATE (IN/HR) or DRIPLINE SPACING										
		AREA (SQ. FT.)										
<b>∮</b> <b>□</b> or <b>⊙</b> ——		ASSOCIATED REMOTE CONTROL VALVE										
		MAIN LINE: 1.5" THROUGHOUT: 1120-SCHEDULE 40 PVC PLASTIC PIPE WITH SCHEDULE 40 PVC SOLVENT WELD FITTINGS. 18" COVER.										
			GER: PVC PLASTIC PI PVC SOLVENT W									
		DRIPLINE 3/4" AND LAR LATERAL LINE: 1120-SCHEDUL 40	GER: LE 40 PVC PLAS PVC SOLVENT W									
===			PVC PLASTIC PII SPECIFICATIONS ( TH OF COVER.									
DV/C LATEDAL		- DRIPLINE REMOTE CONTROL VA	LVE									
SUPF HEAD	PLY EXHAUST	DRIP ZONE: HUNTER HDL SERIES DRIPLINE WITH BUILT IN PRESSURE COMPENSATION AND CHECK VALVE, PART #HDL-06-12-250-CV. USE PLD FITTINGS. TUBING TO BE INSTALLED 4" BELOW GRADE IN A 12" O.C. GRID ACCORDING TO DETAILS. SIZE EXHAUST HEADERS AS FOLLOWS: 1": 0-10 GPM, 1.25": 11-20 GPM. ALL EXHAUST HEADERS SHALL BE 1" SCH 40 PVC OR 1" SCH 40 FLEXIBLE PVC. USE SCH. 40 PVC SOLVENT WELD FITTINGS. EXTEND PVC HEADERS TO THE ENDS OF ALL DRIP ZONES TO BALANCE FLOW IF REQUIRED. SEE DETAILS FOR FURTHER INFORMATION.										
PVC LATERAL		DRIPLINE	E REMOTE CONTR	ROL VALVE								
		TUBING 3 3 GPM A NEEDED.	AND NO PVC SU	Y WHEN DRIP : PPLY/EXHUST LINE TUBING C	ZONE IS LESS THAN							

**REVISION:** 

# **FOR REVIEW & FILING** NOT FOR CONSTRUCTION

ARCHITECT:

# **David Jaehning Architect**

381 11th Street, San Francisco, California 94103

CONSULTANT TEAM:

STRUCTURAL/CIVIL Design Everest, Inc. 365 Flower Lane, Mountain View, CA 94043

LANDSCAPE ARCHTECTURE: Tomas McKay: Architecture-Landscape Architecture 217 Bonita Avenue, Piedmont, CA 94611

IRRIGATION:

Russell D Mitchell & Associates. Inc. 2760 Camino Diablo, Walnut Creek, CA 94597

CLIENT:

#### Irene Chan-Jones and Bill Jones

100 Burlwood Drive, San Francisco, CA 94127

COUNTY APPROVAL STAMP

PROJECT NAME: PROJECT NO: 2101 **House on a Hill** 

APN: 036-031-280

**PROJECT** 10th St Montara, CA 94037 ADDRESS:

PROJECT PHASE: 100% Schematic Design DRAWN: CHECKED: Jose Cruz

6/30/2021 **ISSUE DATE:** 

DRAWING TITLE: IRRIGATION NOTES AND

**LEGEND** 

DRAWING NO: **IR-12** 

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*Irrigation Consultant:* Russell D. Mitchell Associates, Inc.

2760 Camino Diablo Walnut Creek, CA 94597 www.rmairrigation.com





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IRRIGATION: Russell D Mitchell & Associates, Inc.

2760 Camino Diablo, Walnut Creek, CA 94597

CLIENT:

100 Burlwood Drive, San Francisco, CA 94127

PROJECT NO: PROJECT NAME:

APN: 036-031-280

**PROJECT** 10th St Montara, CA 94037 ADDRESS:

PROJECT PHASE: 100% Schematic Design

Jose Cruz CHECKED: DRAWN:


6/30/2021 ISSUE DATE:

DRAWING TITLE: IRRIGATION DETAILS

DRAWING NO: **IR-13** 

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- (1) REDUCED PRESSURE BACKFLOW ASSEMBLY.
- ◯ SCHEDULE 40 PVC MALE ADAPTER-2 TOTAL. ② WROUGHT COPPER MALE ADAPTER-2 OTAL 8 CONCRETE SUPPORT BLOCK.
- 3 COPPER TYPE "K" PIPE (LENGTH AS REQUIRED).

(SOLDER x THREAD CONNECTION).

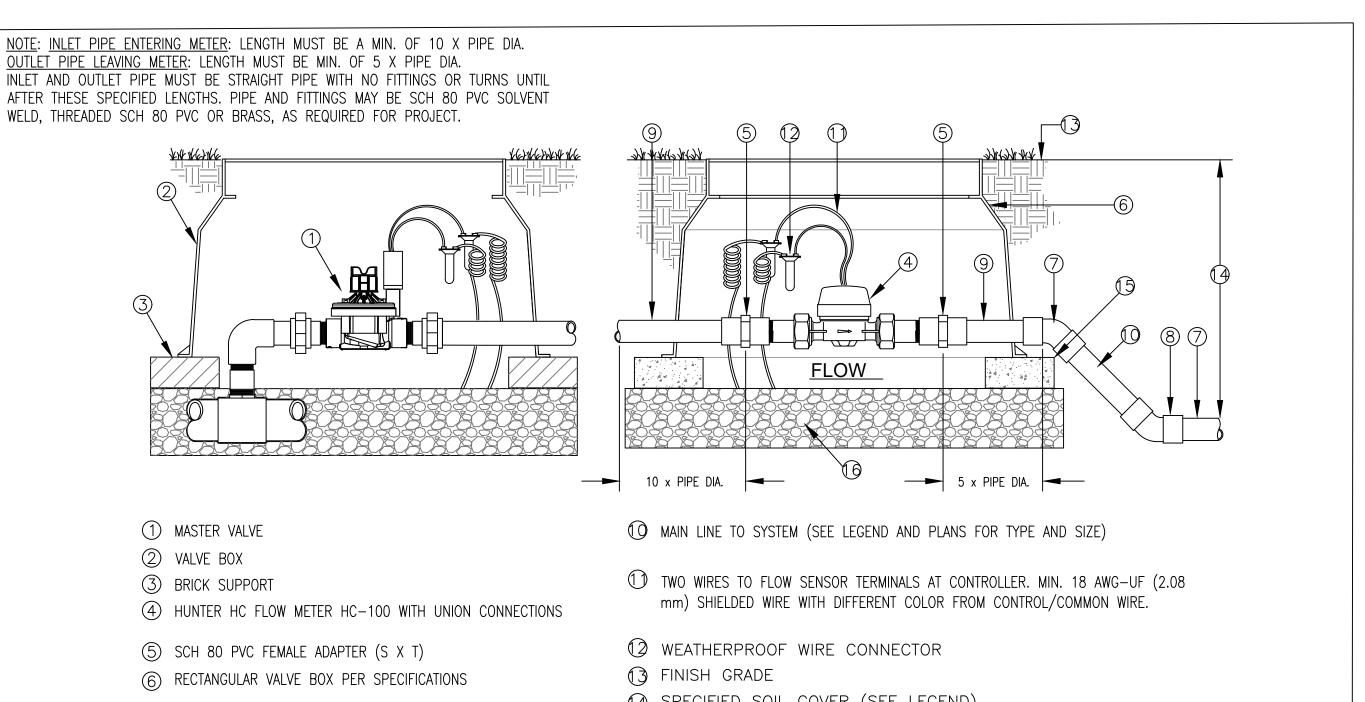1) PVC MAIN LINE TO IRRIGATION SYSTEM.  $\stackrel{ extstyle 4}{ extstyle }$  wrought copper 90° elbow-2 total (solder x THREAD CONNECTION).

SCALE: NONE

- (5) PVC MAIN LINE TO POINT OF CONNECTION.
- 6) BUSH AS NECESSARY FOR SIZE TRANSITION.
- INSTALL A FREEZE PREVENTATIVE BLANKET AROUND BACKFLOW ASSEMBLY. BLANKET SHALL BE GREEN.

REDUCED PRESSURE BACKFLOW ASSEMBLY

NIPPLES AND FITTINGS TO BE SAME IPT SIZE AS BACKFLOW ASSEMBLY.

- LINE TO PROPER DEPTH DO NOT SOLDER CONNECT FITTINGS WHILE THREADED INTO BACKFLOW ASSEMBLY. THIS MAY CAUSE DAMAGE TO DEVICE.

NEEDED)

(7) SCH 80 PVC 45 DEGREE ELBOW (S X S) TO LOWER MAIN LINE TO PROPER DEPTH (SIZE FOR LARGER MAIN LINE AS

HUNTER HC-100 FLOW METER & MASTER VALVE INSTALLATION

- (8) SCH 80 PVC 45 DEGREE ELBOW (S X S) TO LOWER MAIN
- 9 1.5" DIA. (40 mm) MAIN LINE AT INLET & OUTLET
- (4) SPECIFIED SOIL COVER (SEE LEGEND)
- (5) COMMON BRICK
- (6) GRAVEL BASE, 6" (15 cm) DEEP

BRASS BALL VALVE SCALE: NONE

1) SCH 40 PVC 90° ELBOW (SxS) FROM PVC

NOTE:
BRASS NIPPLES WILL ALLOW
FOR A 10 FPS FLOW THROUGH VALVE.

10" ROUND X 12" DEEP PLASTIC VALVE BOX

(5) MALE ADAPTER. REFER TO LEGEND FOR FITTING TYPE.

6 COMMON BRICK, TWO TOTAL-180° APART

7) PEA GRAVEL (NO SOIL IN VALVE BOX)

2 BALL VALVE

3 FINISH GRADE

(4) PVC MAIN LINE

- MAIN LINE BELOW. ② SCH 40 PVC PIPE. LENGTH AS REQUIRED.
- ③ SCH 80 PVC MALE ADAPTER.
- 4 CARSON 1220 RECTANGULAR PLASTIC VALVE
- CONTROL VALVE DETAIL.

BOX WITH LID. INSTALL PER REMOTE

- (5) NDS 1"LO-TORQ BALL VALVE THREADED (PART #LT-1000-T)
- 6 DURA 1" MIPT x 1" SWIVEL 90° (PART #306-009)

#08303) 3 TOTAL.

(8) DURA 1" MULTI-PORT MANIFOLD (PART #301-010-2)

REFER TO IRRIGATIO LEGEND

- 9 DRIP REMOTE CONTROL VALVE. REFER TO LEGEND FOR MODEL.
- (1) FILTER. REFER TO LEGEND FOR MODEL.
- (1) 40 PSI REGULATOR. REFER TO LEGEND FOR
- (2) DURA 1" x 3/4" MALE ADAPTER (PART
- (3) DURA 1" SLIP X 1" SWIVEL (PART #329-011) 4 TOTAL.
  - (4) SCHEDULE 40 PVC LATERAL TO DRIP IRRIGATION

9 FINISH GRADE.

(1) REFER TO IRRIGATION LEGEND.

12) WILKINS NR3XL DOUBLE UNION

ON PLANS (MATCH SIZE OF


BACKLFOW) INSTALL IF NEED.

PRESSURE REDUCING VALVE. SET

DISCHARGE PRESSURE AS INDICATED


- (5) DURA 1" CAP (PART #348-010)
- (6) BUBBLER OR SPRINKLER REMOTE CONTROL VALVE. REFER TO LEGEND FOR MODEL.
- REGULATORS. USE 1"x1" DURA THREAD ADAPTER ON 1" REGULATORS

#08303-131). ONLY REQUIRED WITH 3/4" OUTLET TO SCHEDULE 40 PVC LATERAL TO BUBBLER OR

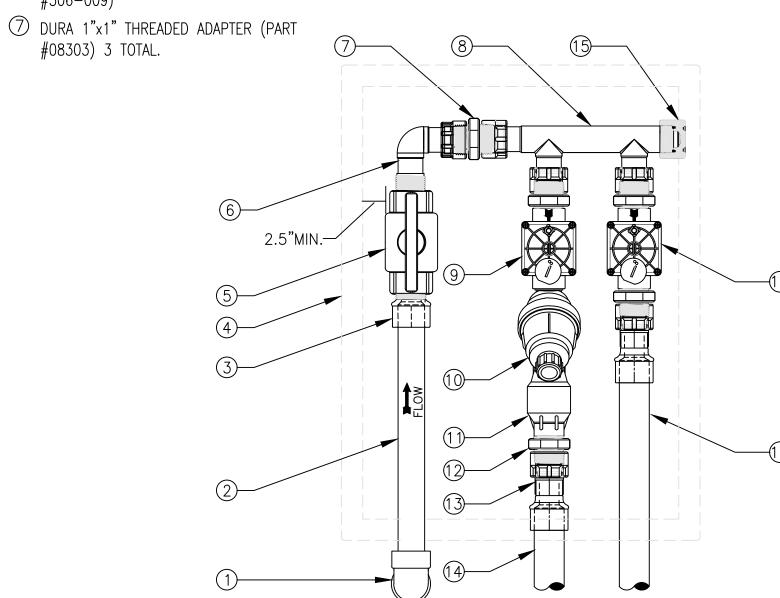

TWO REMOTE VALVE MANIFOLD DETAIL SCALE: NONE

COUNTY APPROVAL STAMP

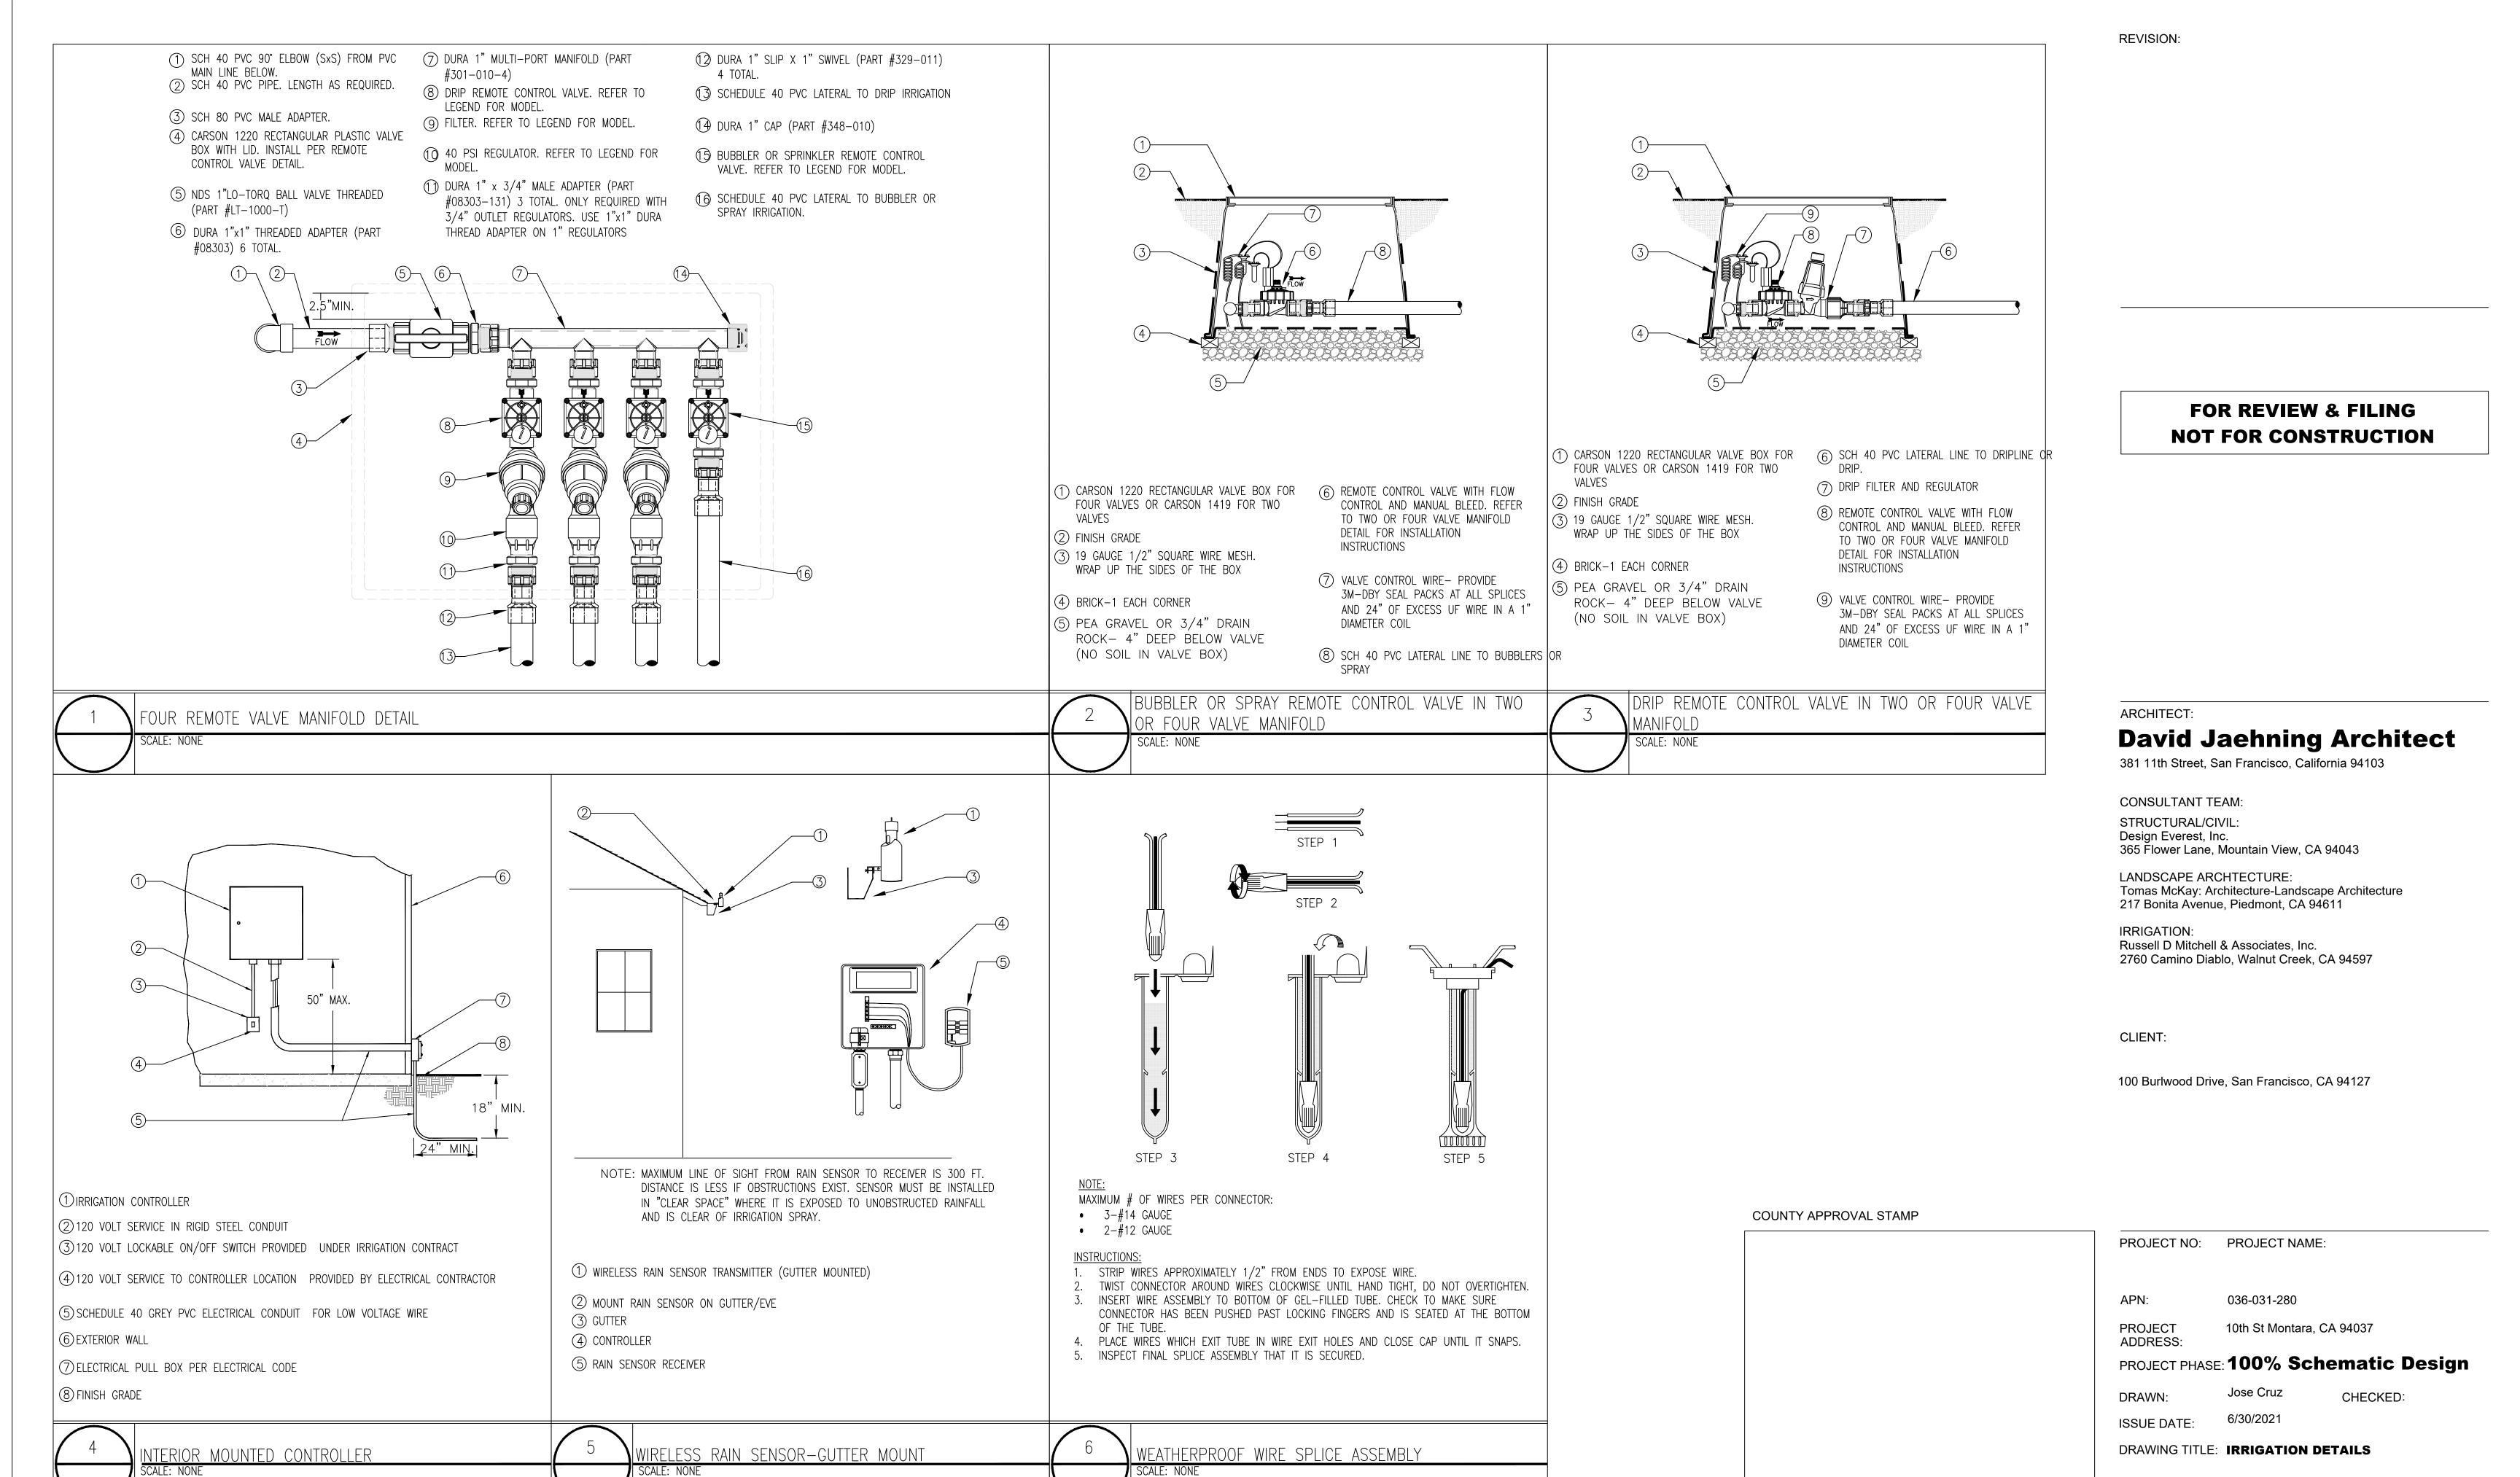


DRAWING NO:


Architect.

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**IR-14** 

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ARCHITEC

**REVISION:** 
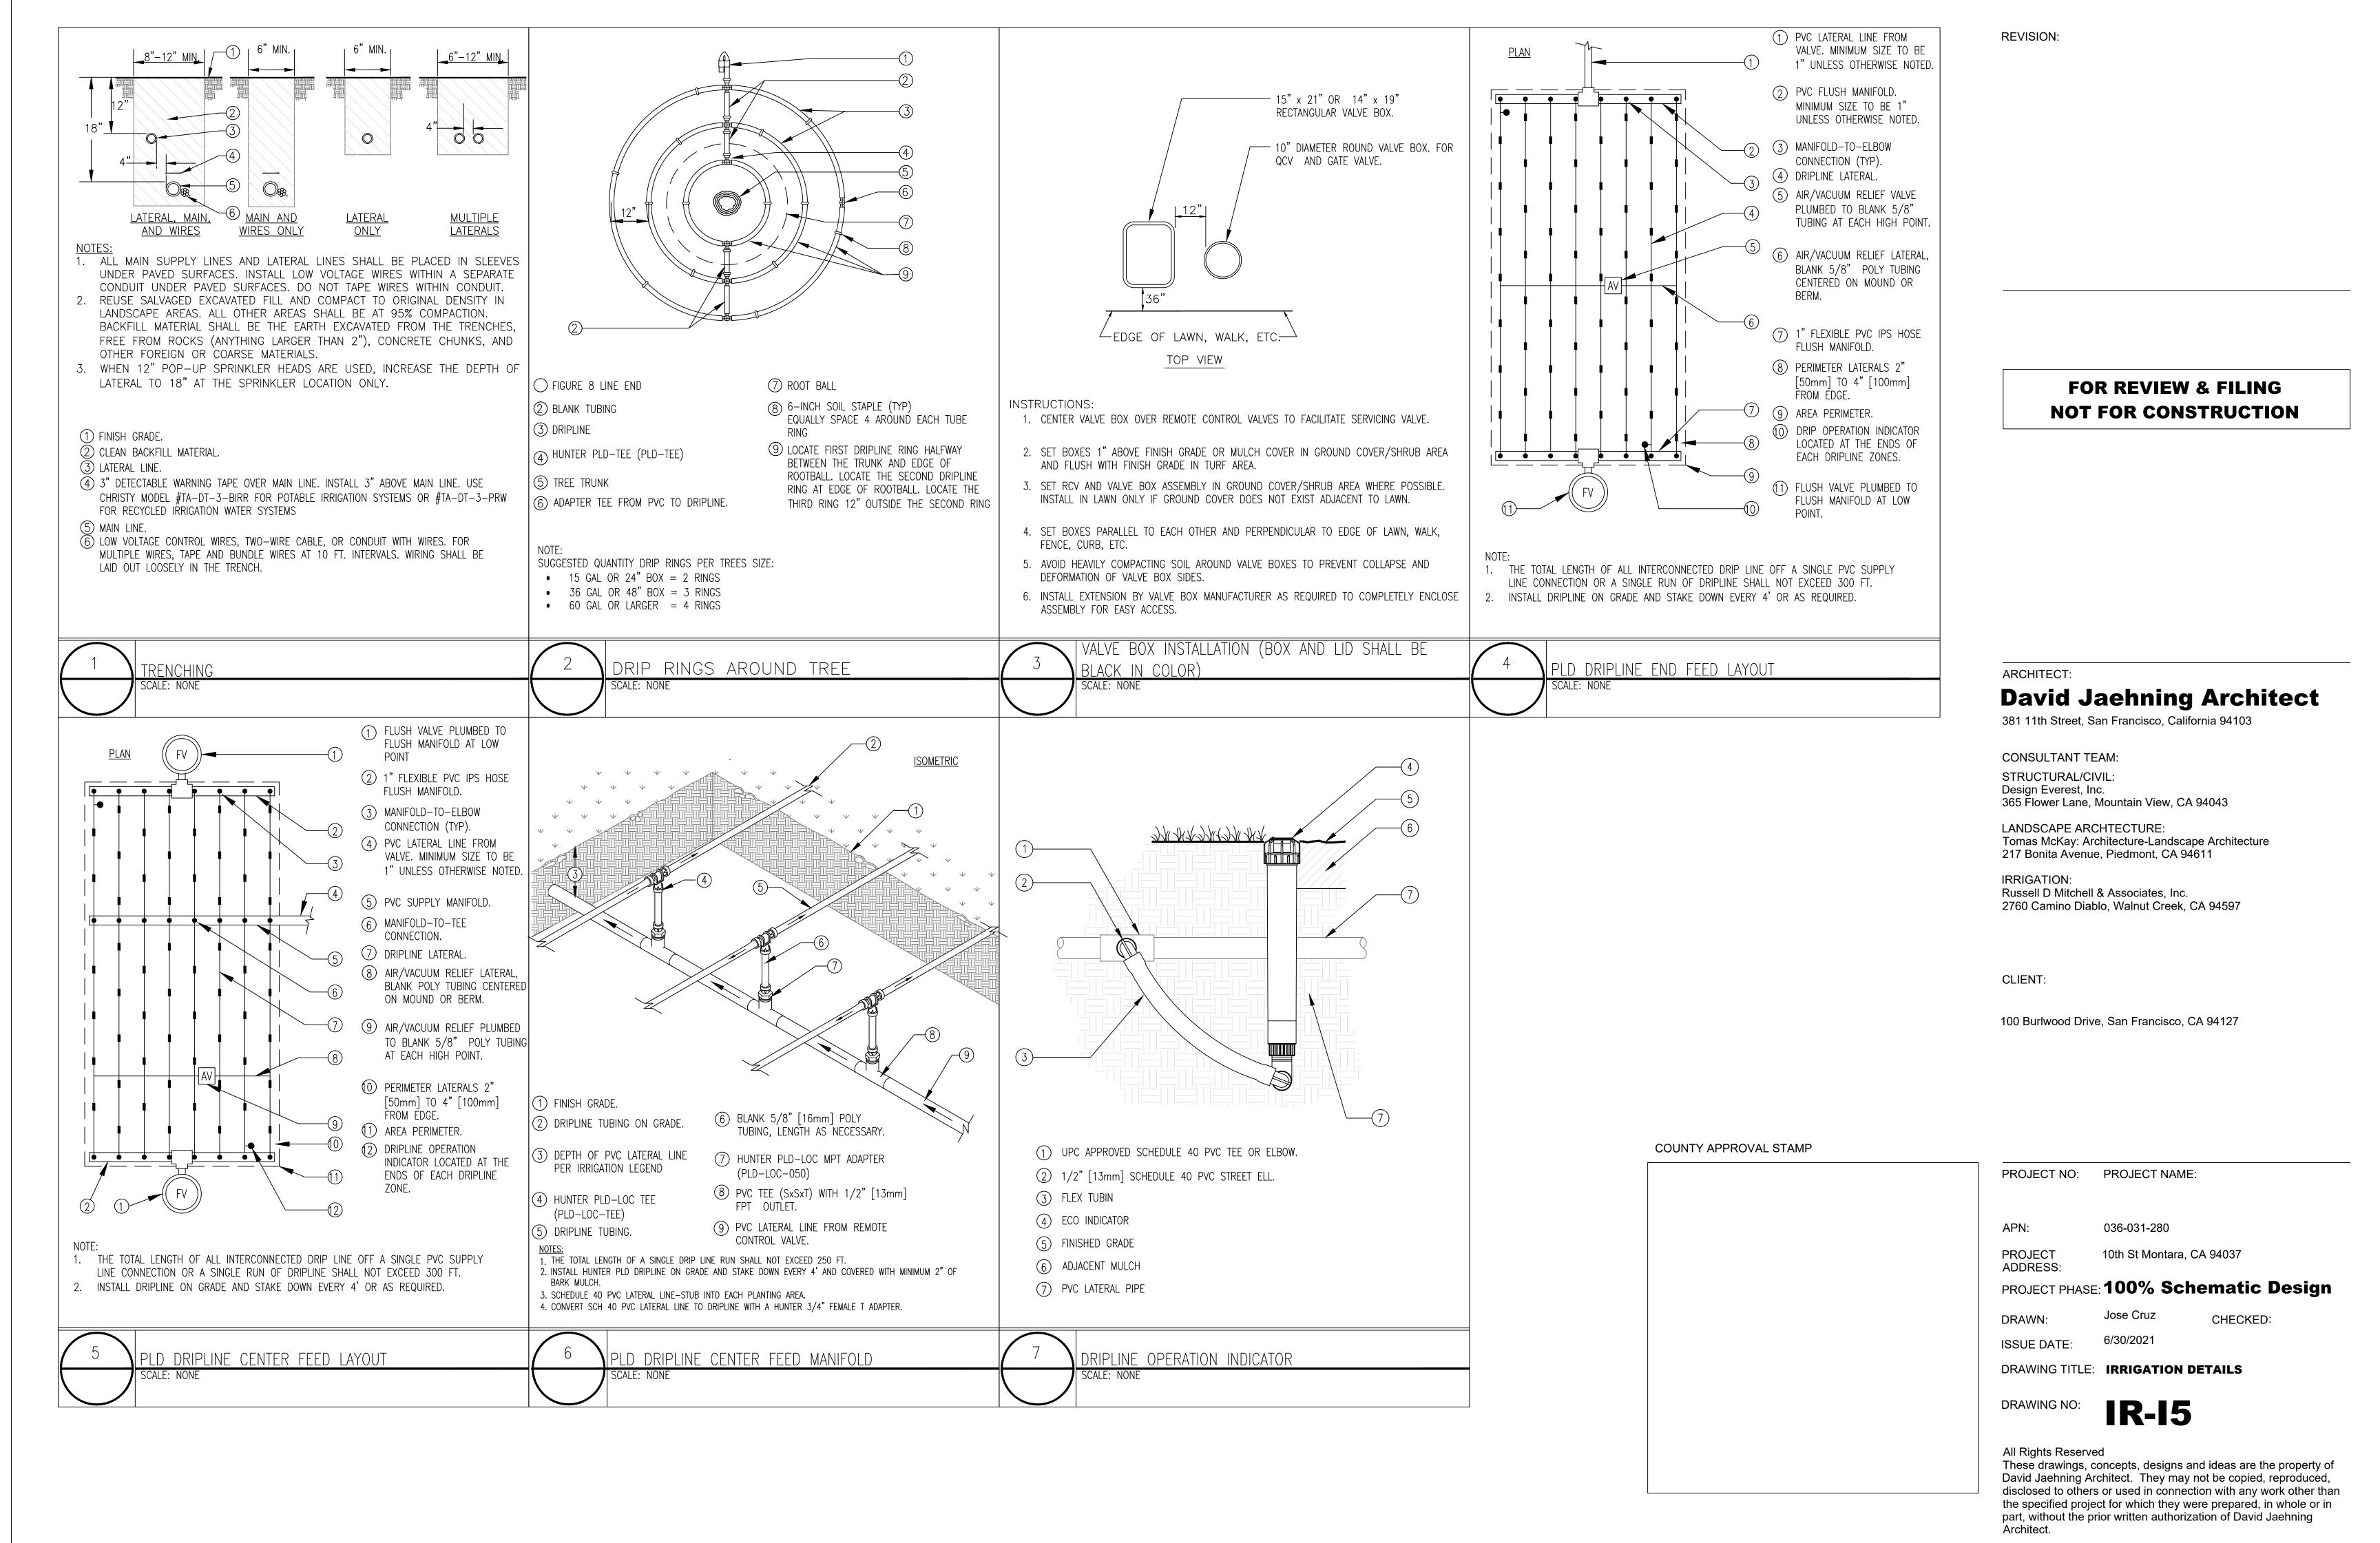
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IRRIGATION: Russell D Mitchell & Associates, Inc. 2760 Camino Diablo, Walnut Creek, CA 94597

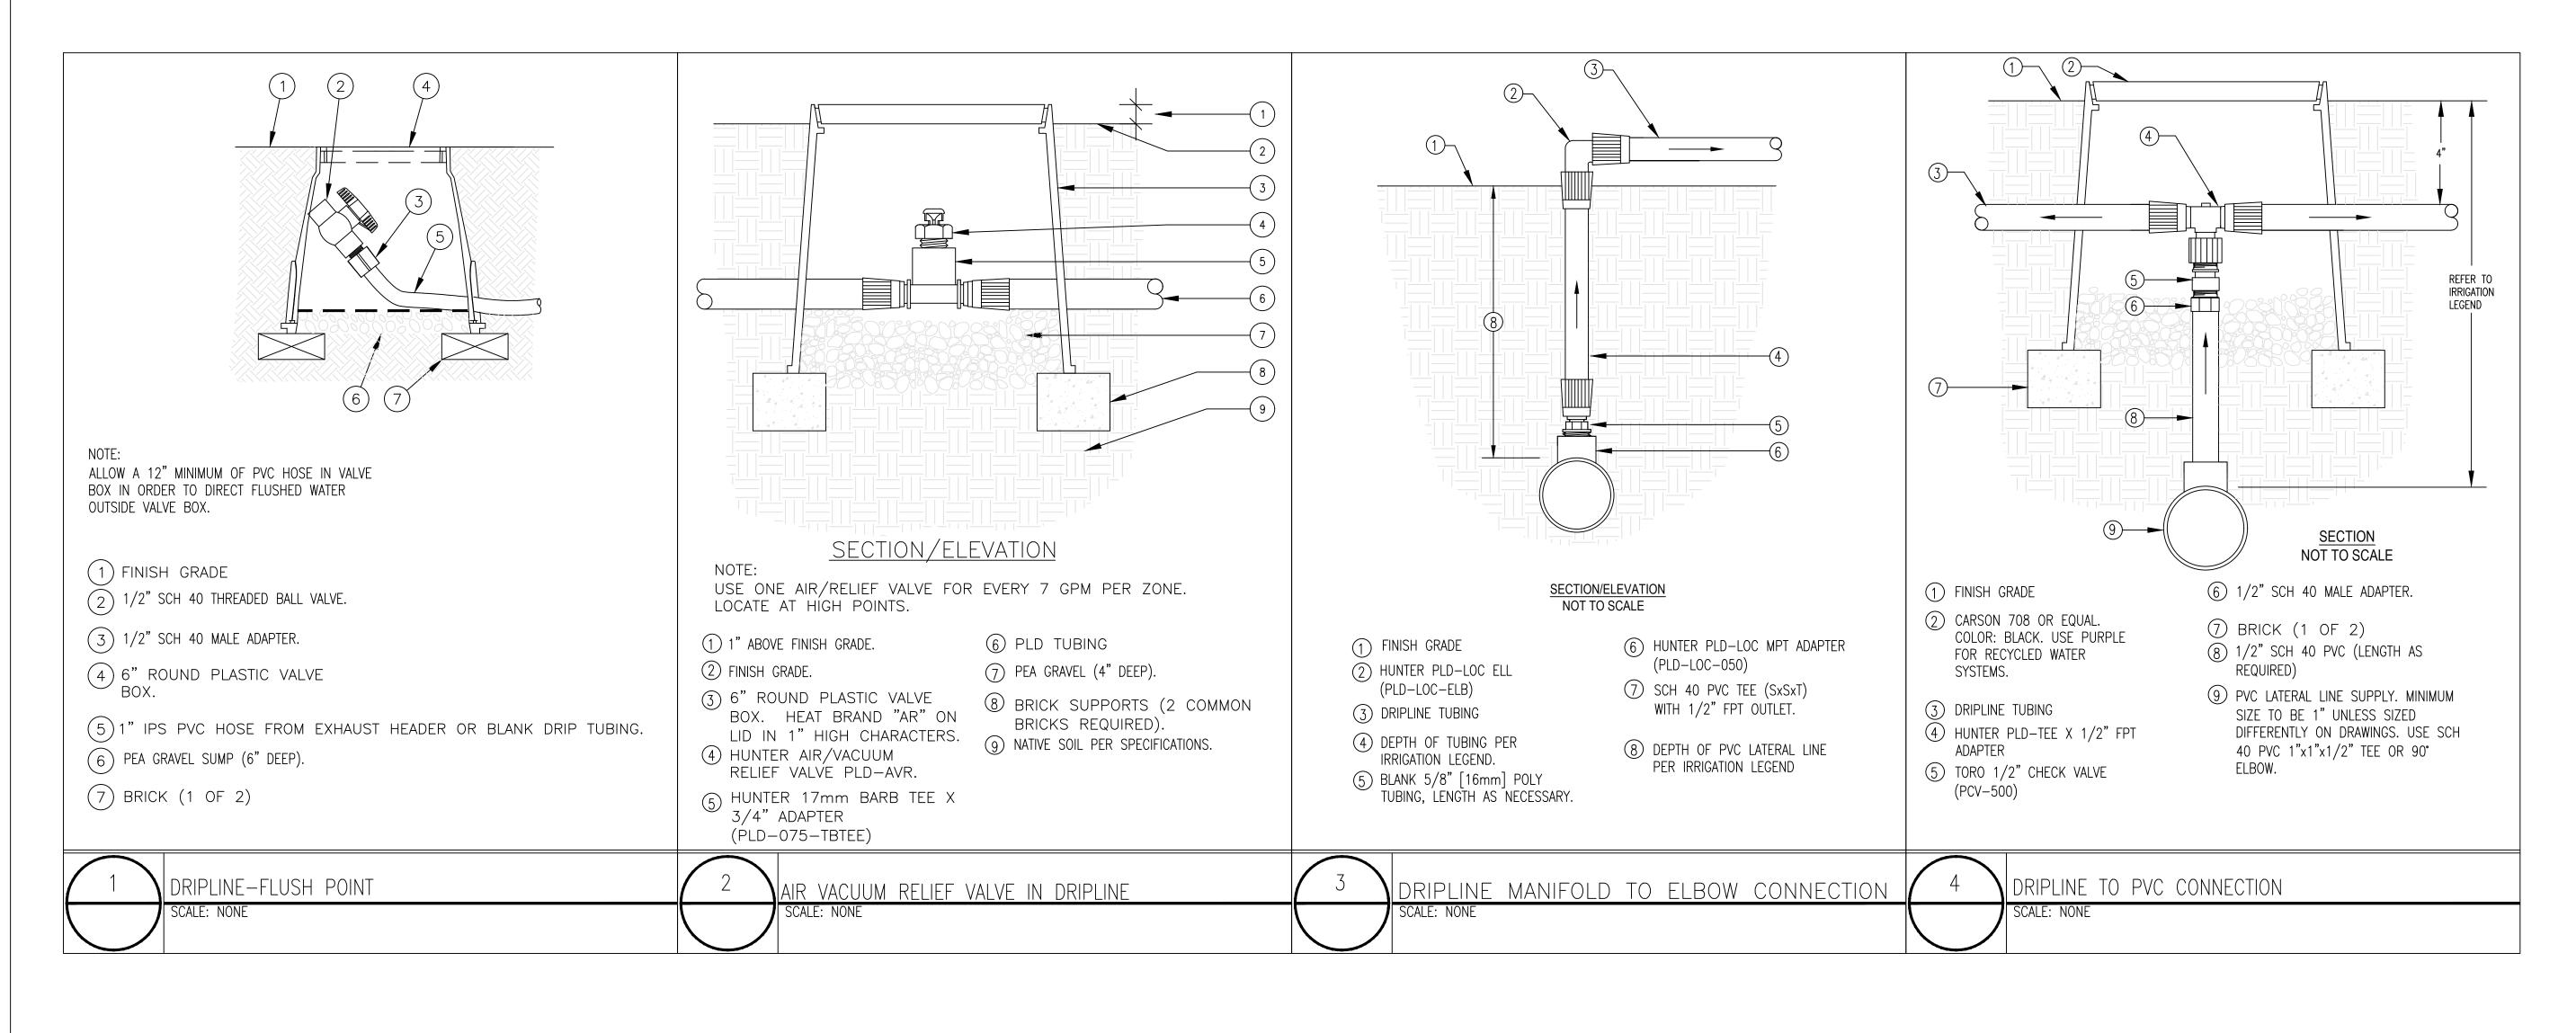CLIENT:

100 Burlwood Drive, San Francisco, CA 94127

COUNTY APPROVAL STAMP

PROJECT NO: PROJECT NAME:

APN: 036-031-280

PROJECT 10th St Montara, CA 94037 ADDRESS:

PROJECT PHASE: 100% Schematic Design

DRAWN: Jose Cruz CHECKED:

ISSUE DATE: 6/30/2021

DRAWING TITLE: IRRIGATION DETAILS

DRAWING NO: IR-16

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#### WATER USE ESTIMATION & IRRIGATION SCHEDULE - 340 10th ST. MONTARA CA

WATER TYPE	POTABLE	
CITY	Hal Moon Bay	*Nearest City to project with published ET data*
ETO	33.9	
DATE	7/21/2021	

REGULAR LANDSCAPE AREAS

									,		_								_						
												JAN	FEB	MAR	APR	MAY	JUNE	JULY	AUG	SEP	ост	NOV	DEC		
			WATER USE TYPE	_													MONTH	ILY ETO						ETWU (GALLONS	PERCENTAGE OF
			(LW=LOW,									1.5	1.7	2.4	3.0	3.9	4.3	4.3	4.2	3.5	2.8	1.3	1.0	PER YEAR)	LANDSCAPE
			MW=MOD,					PRECIP. RATE/ APPLICATION RATE		CYCLES PER	DAYS PER				1 0.0		1					1 2.0	1.0	ŕ	,
STATION/HYDROZONE	GPM	AREA (sq.ft) (HA)	HW=HIGH)	PLANT TYPE	IRRIGATION TYPE	PLANT FACTOR (PF)	IRRIGATION EFFICIENCY (IE)	(IN/HR)	ETAF (PF/IE)	DAY	WEEK					TOTAL	RUN TIME IN	I MINUTES PEI	RDAY						<u> </u>
C-1	4	319	LW	SHRUB GC LW	DRIP LINE 12"	0.3	0.81	0.9	0.4	2	2	0.0	0.0	7.0	9.0	11.0	12.0	12.0	12.0	10.0	8.0	4.0	0.0	2,483	11%
C-2	4	684	LW	SHRUB GC LW	DRIP LINE 12"	0.3	0.81	0.9	0.4	2	2	0.0	0.0	7.0	9.0	11.0	12.0	12.0	12.0	10.0	8.0	4.0	0.0	5,325	24%
C-3	2	75	LW	TREE LW	DRIP RINGS	0.3	0.75	0.9	0.4	2	2	0.0	0.0	8.0	10.0	12.0	13.0	13.0	13.0	11.0	9.0	4.0	0.0	631	3%
C-4	3	340	LW	SHRUB GC LW	DRIP LINE 12"	0.3	0.81	0.9	0.4	2	2	0.0	0.0	7.0	9.0	11.0	12.0	12.0	12.0	10.0	8.0	4.0	0.0	2,647	12%
C-5	2	125	LW	SHRUB GC LW	DRIP LINE 12"	0.3	0.81	0.9	0.4	2	2	0.0	0.0	7.0	9.0	11.0	12.0	12.0	12.0	10.0	8.0	4.0	0.0	973	4%
C-6	2	100	MW	TREE MW	DRIP RINGS	0.5	0.75	0.9	0.7	2	3	0.0	0.0	9.0	11.0	14.0	15.0	15.0	15.0	12.0	10.0	5.0	0.0	1,401	3%
C-7	3	217	LW	SHRUB GC LW	DRIP LINE 12"	0.3	0.81	0.9	0.4	2	2	0.0	0.0	7.0	9.0	11.0	12.0	12.0	12.0	10.0	8.0	4.0	0.0	1,689	8%
C-8	3	184	MW	SHRUB GC MW	DRIP LINE 12"	0.5	0.81	0.9	0.6	2	3	0.0	0.0	8.0	10.0	13.0	14.0	14.0	14.0	11.0	9.0	5.0	0.0	2,387	6%
C-9	2	50	LW	TREE LW	DRIP RINGS	0.3	0.75	0.9	0.4	2	2	0.0	0.0	8.0	10.0	12.0	13.0	13.0	13.0	11.0	9.0	4.0	0.0	420	2%
C-10	4	340	LW	SHRUB GC LW	DRIP LINE 12"	0.3	0.81	0.9	0.4	2	2	0.0	0.0	7.0	9.0	11.0	12.0	12.0	12.0	10.0	8.0	4.0	0.0	2,647	12%
C-11	4	457	LW	SHRUB GC LW	DRIP LINE 12"	0.3	0.81	0.9	0.4	2	2	0.0	0.0	7.0	9.0	11.0	12.0	12.0	12.0	10.0	8.0	4.0	0.0	3,557	16%
	TOTAL	2,891									•	•	•		•	•	•		•		•		TOTAL	24,160	100%

SPECIAL LANDSCAPE AREAS										
HYDROZONE #	HYDROZONE NAME	AREA (sq.ft) (HA)	Percentage of Landscape							
			0%							

	GALLONS/YR	33,420
MAWA	ACRE FEET/YR	0.10
	HOEND	44.00
	HCF/YR	44.68
	GALLONS/YR	24,160
ETWU	ACRE FEET/YR	0.07
	HCEMB	32 30

SITE IRRIGATION	SITE PLANT	
EFFICIENCY	FACT0R	MAWA COMPLIANT
80.5%	0.32	YES

ETAF Calculations							
REGULAR LANDSCAPE ARE	AS						
TOTAL ETAF x AREA	1,150						
TOTAL AREA	2,891						
AVG ETAE	39.76%						

THE IRRIGATION VALVE SCHEDULE SHOWN ABOVE IS INTENDED TO BE USED AS A GUIDELINE ONLY AND INDICATES THE APPROXIMATE RUN TIMES IN MINUTES FOR EACH VALVE BASED ON ESTIMATED WEEKLY WATER REQUIREMENTS FOR ESTABLISHED PLANT MATERIAL. THE TIMES SHOWN ARE APPROXIMATE AND HAVE BEEN DEVELOPED FROM LOCAL AND CURRENT AVERAGES FOR EVAPOTRANSPIRATION, AND REFLECTTHE WATER REQUIREMENTS OF THE PLANT MATERIAL BASED ON PLANT TYPE AND THE APPROXIMATE PRECIPITATION OR APPLICATION RATES OF THE IRRIGATION SYSTEM TYPE. ACTUAL RUN TIMES MAY BE DIFFERENT DEPENDING ON A VARIETY OF FACTORS INCLUDING TOPOGRAPHY, SOIL STRUCTURE, SUN AND WIND EXPOSURE, WEATHER, ACTUAL PLANT WATER REQUIREMENTS, OVERALL PRECIPITATION RATE OF ZONE, ETC.

MAWA FORMULA	
MAXIMUM APPLIED WATER ALLOWANCE (MAWA) GALLONS PER YEAR	
$MAWA = (ETo)(0.62)[(LA \times 0.55) + (0.45 \times SLA)]$	

ETo = REFERENCE EVAPOTRANSPIRATION

0.45= ET ADJUSTMENT FACTOR

LA=LANDSCAPED AREA (SQUARE FEET) 0.62 = CONVERSION FACTOR (GALLONS/SQ.FT/YR)

PF = PLANT FACTOR FOR HYDROZONES

**ETWU FORMULA** 

ESTIMATED TOTAL WATER USE (ETWU) GALLONS PER YEAR

ETWU= ((ETO)(.62)(ETAF x LA))

HA = HYDROZONE AREA (SQ.FT)

0.62 = CONVERSION FACTOR (GALLONS/SQ.FT/YR)

ETo = REFERENCE EVAPOTRANSPIRATION

IE = IRRIGATION EFFICIENCY (0.81)-BUBBLER/DRIP

IE = IRRIGATION EFFICIENCY (0.75)-ROTORS/SPRAY

**REVISION:** 

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STAMP:

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**IRRIGATION:** Russell D Mitchel Associates, Inc. 2760 Camino Diablo, Walnut Creek, CA 94597

CLIENT:

#### **Irene Chan-Jones and Bill Jones**

100 Burlwood Drive, San Francisco, CA 94127

PROJECT NO: PROJECT NAME:

#### 2101 House on a Hill

PROJECT ADDRESS:

10th St Montara, CA 94037

CHECKED

PROJECT PHASE: 100% Schematic Design

DRAWN: Jose Cruz ISSUE DATE:

6/30/2021

DRAWING TITLE: IRRIGATION WATER


**CALCULATIONS** 

DRAWING NO:

**A212** 

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1 DEMOLITION SITE PLAN
1/8" = 1'-0"

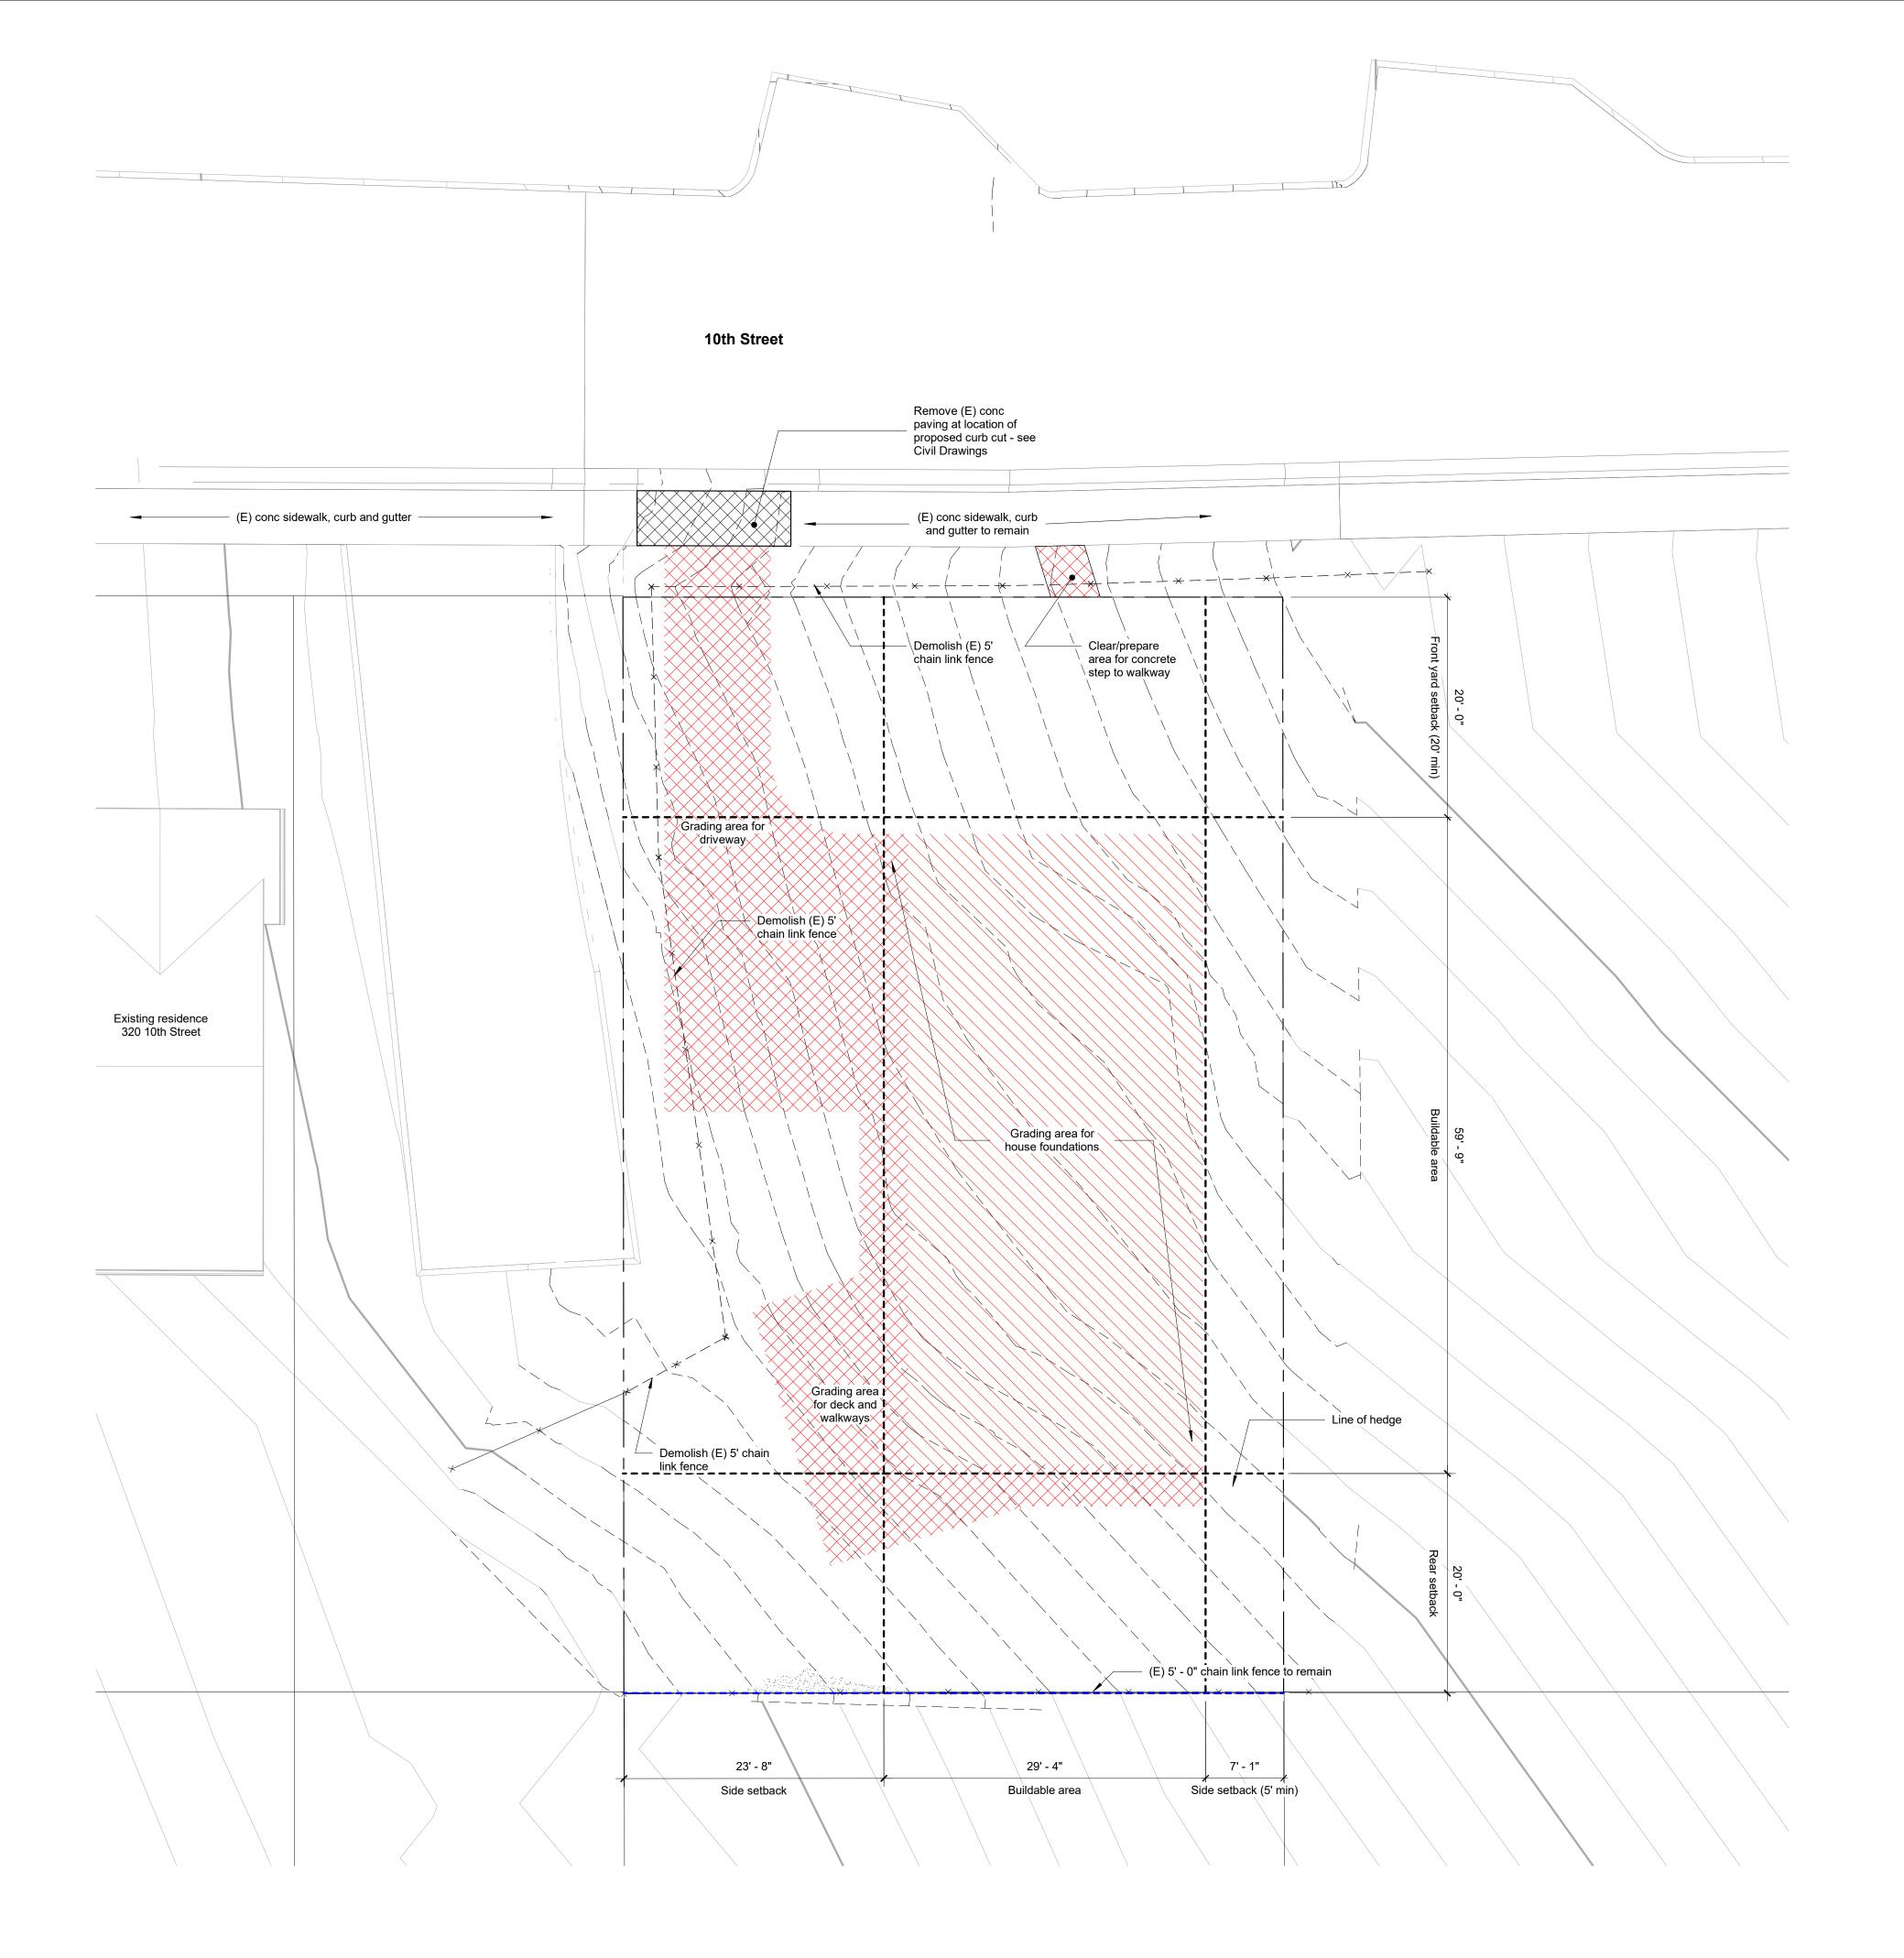

#### **REVISION:**

NO. DESCRIPTION

 DESIGN REVIEW APPLICATION
 5/11/2021

 PLN2021-00187 CYCLE 2
 8/5/2021

 PLN2021-00187 CYCLE 3
 12/21/2021

DATE

# FOR REVIEW & FILING NOT FOR CONSTRUCTION

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#### ARCHITECT:

# **David Jaehning Architect**

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#### CLIENT:

#### **Irene Chan-Jones and Bill Jones**

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#### COUNTY APPROVAL STAMP

PROJECT NO: PROJECT NAME:

2101 House on a Hill

PN: 036-031-280

PROJECT 10th Street
ADDRESS: Montara, CA 94037

PROJECT PHASE: Construction Documents

DRAWN: AG CHECKED Checker

ISSUE DATE: 12/21/2021 9:47:42 PM


DRAWING TITLE: **DEMOLITION SITE PLAN** 

DRAWING NO:

A011

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#### **ELEMENT KEYNOTES**

VALUE DESCRIPTION

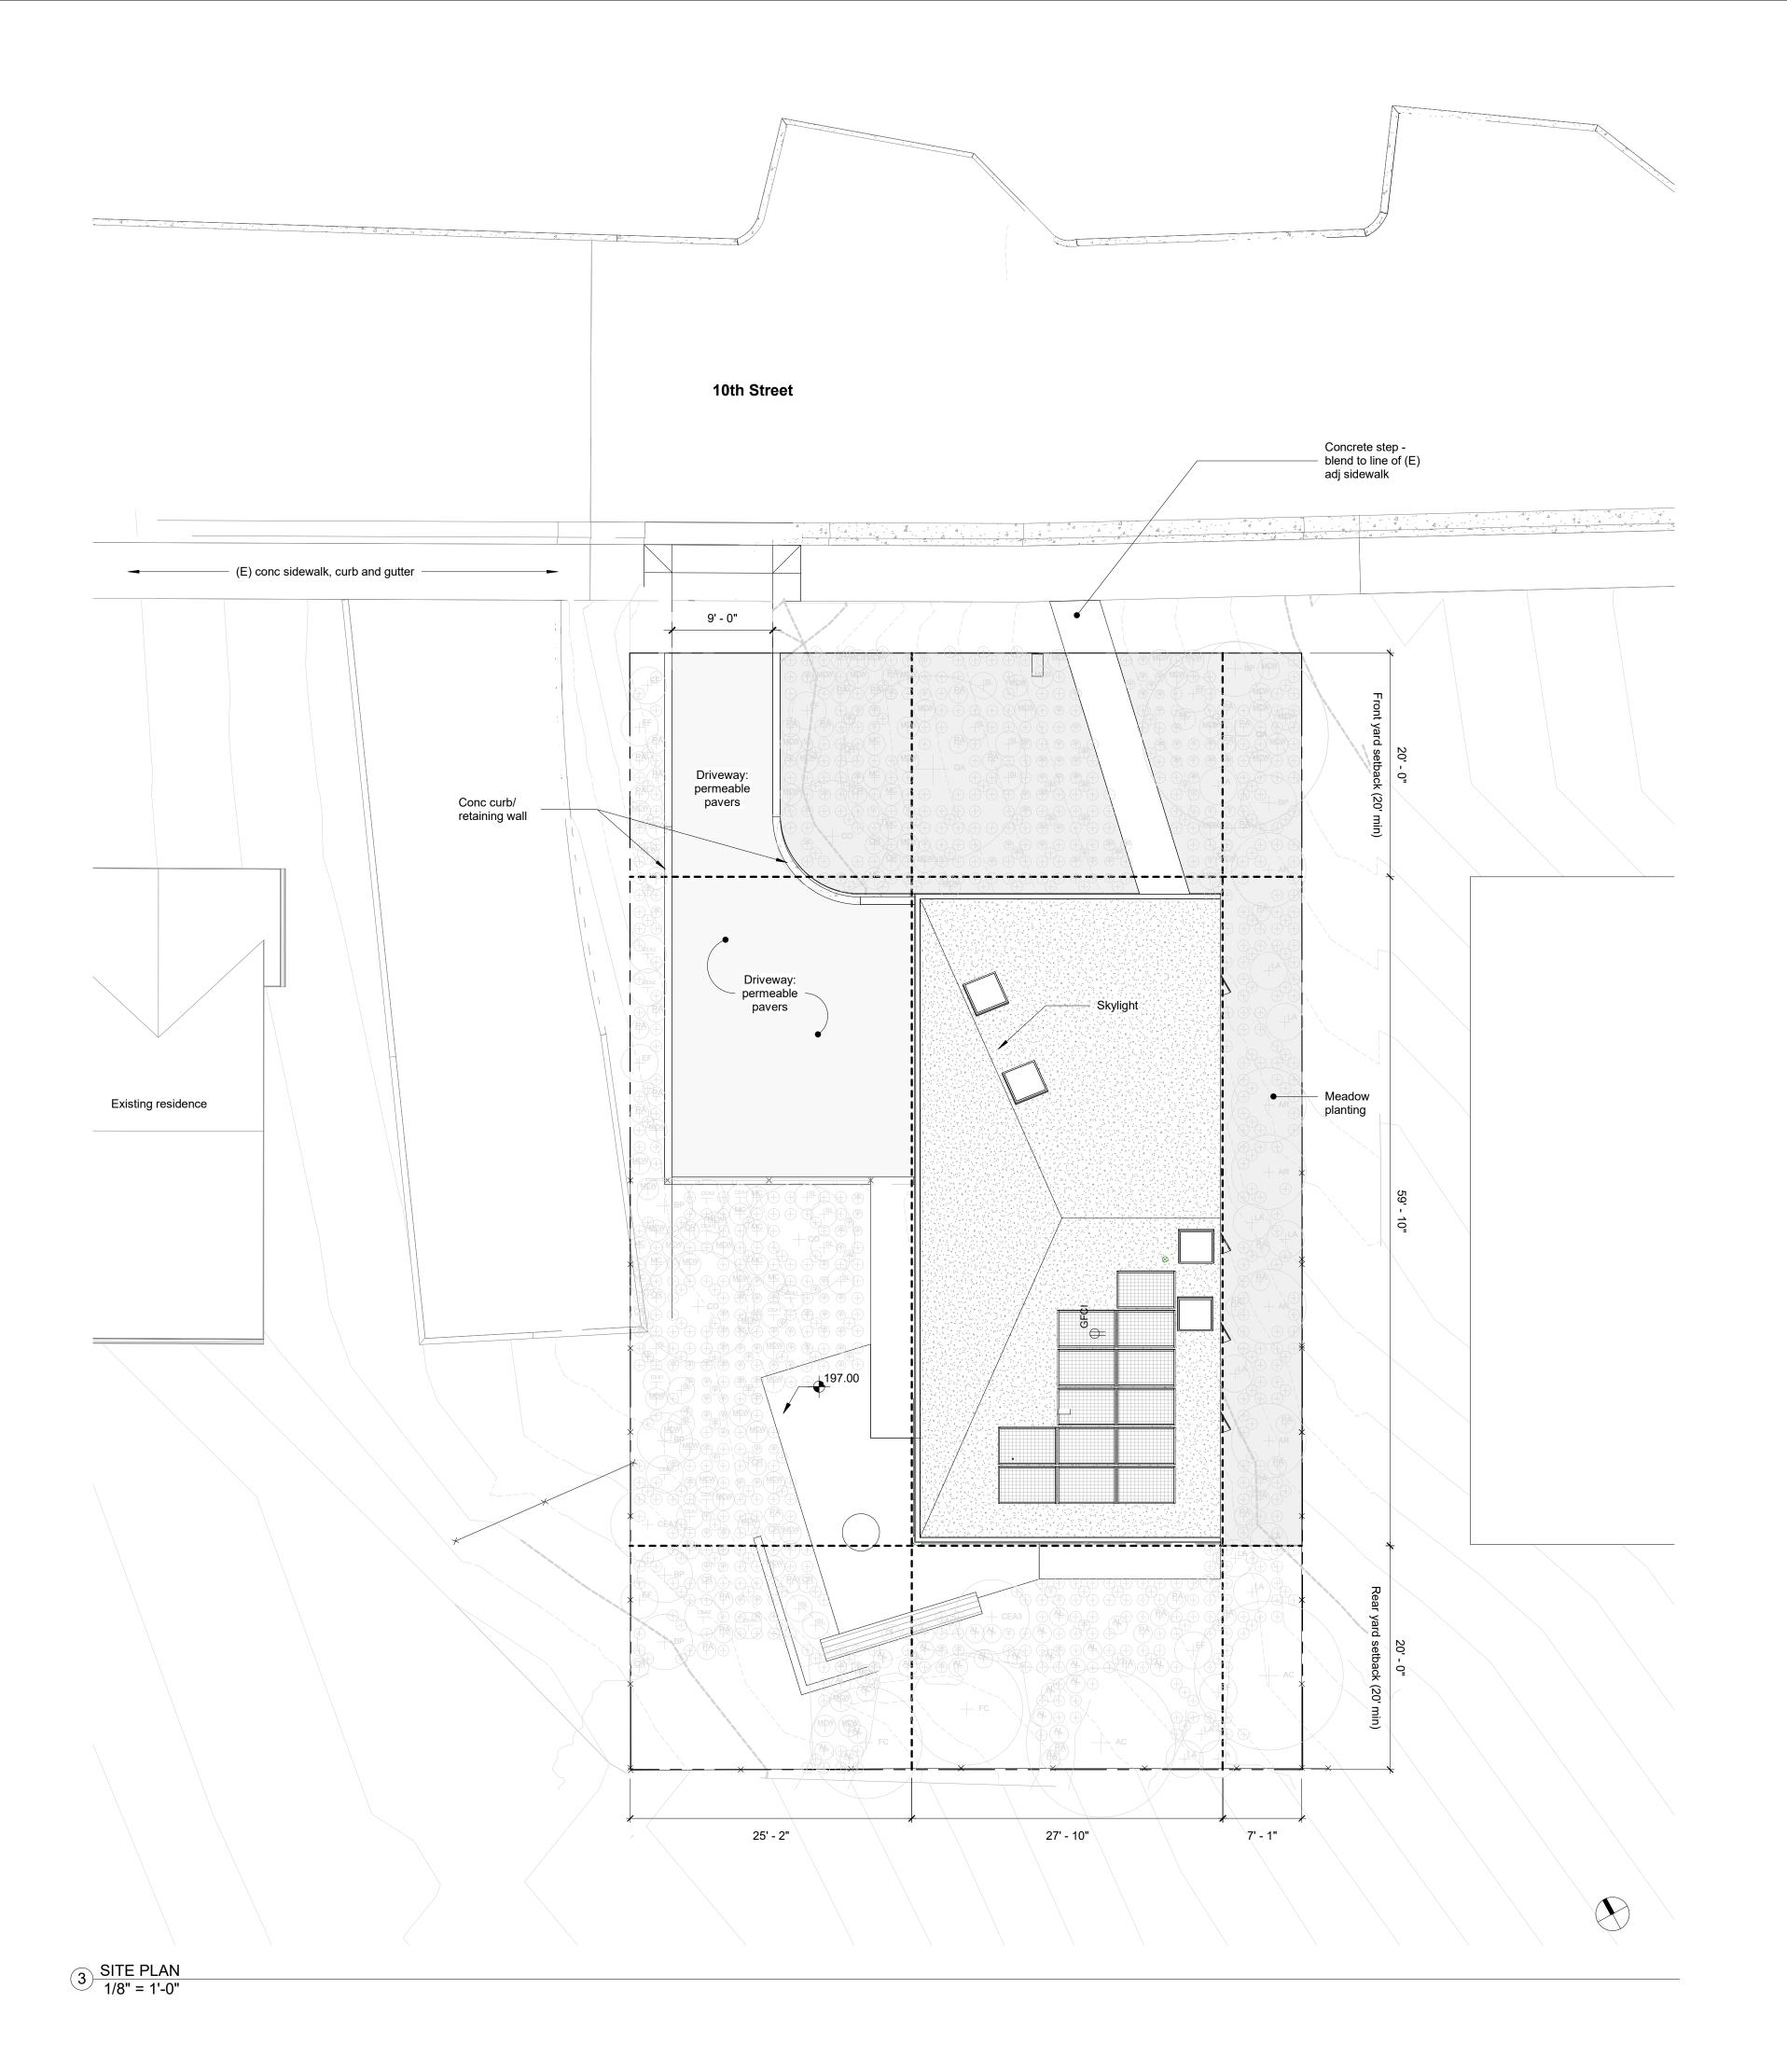**REVISION:** 

NO. DESCRIPTION

DESIGN REVIEW APPLICATION 5/11/2021 PLN2021-00187 CYCLE 2 8/5/2021 PLN2021-00187 CYCLE 3 12/21/2021

DATE

#### Section 6300.2 Regulations for "S-17" Combining District (Midcoast)

The following regulations shall apply in any single-family residential district with which the "S-17" District is combined.

**Building Site Width** The minimum building site width shall be an average of 50 feet.

Building site is 60.07' wide

**Building Site Area** The minimum building site area shall be 5,000 sq ft

Building site area is 5,995 sq ft ±

**Building Setbacks** The minimum setbacks shall be: Front setback: 20 ft Rear setback: 20 ft

Side setback: 5 ft if 16 ft in height or less; combined 15 ft if over 16 ft in height with

a minimum of 5 ft on any side

In any area where the "S-17" District is combined with the "DR" District, the minimum side yard setback may be reduced to provide for creative design concepts such as "zero" side yard setbacks provided that: (1) the Design Review Committee approves, (2) the application involves joint development of two or more adjacent parcels, (3) the total side yard requirement is met and (4) a minimum side yard of 5 feet is maintained adjacent to any parcel not included with the application.

Parcel Coverage

The maximum parcel coverage shall be:

a. For structures 16 feet in height or less: 50%.

b. For structures greater than 16 feet in height: 35%.

Parcel coverage shall include all: (1) buildings, (2) accessory buildings, or (3) structures such as patios, decks, balconies, porches, bridges, and other similar uses which are eighteen (18) inches or more above the ground.

**Building Floor Area** 

The maximum building floor area shall be established according to the parcel size: 5,000 - 11,968 sq ft = 0.53 of parcel size (or **3,177 sq ft**)

The maximum building floor area shall include the floor area of all stories of all buildings and accessory buildings on a building site. Maximum building floor area specifically includes: (1) gross floor area of all stories,

(2) the area of all decks, porches, balconies or other areas covered by a waterproof roof, which extends four (4) or more feet from exterior walls, (3) the area of all garages and carports.

Building floor area:

Ground floor (gross enclosed floor area, incl garage): 1,579 sf Second floor (gross enclosed floor area): 1,322 sf

Second floor unoccupied exterior setback area (269 sf) extends 2' - 6" (>4' - 0") from the line of the exterior wall.

Total building floor area: **2,901 sf** (< 3,177 sf)

Impervious Surface Area.

The amount of parcel area covered by impervious structures less than eighteen inches (18") in height is limited to ten percent (10%) parcel size (not to exceed 1,170 sq. ft. for residential uses). Impervious structures include, but are not limited to, non-porous driveways, decks, patios, walkways and swimming pools.

Parcel size: 5,995 SF

Parcel Coverage:

Structures >16' in height: 1,576 SF= 26.22% (complies with 35% limit) Hardscape: 94 SF = 1.5% (complies with 10% limit) 1,670 SF (28%)

Driveway (pervious) area: **752 SF** 

COUNTY APPROVAL STAMP

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STAMP:



ARCHITECT:

# **David Jaehning Architect**

381 11th Street, San Francisco, California 94103

CONSULTANT TEAM: STRUCTURAL/CIVIL: Design Everest, Inc.

LANDSCAPE ARCHTECTURE: Tomas McKay: Architecture-Landscape Architecture

IRRIGATION:

217 Bonita Avenue, Piedmont, CA 94611

365 Flower Lane, Mountain View, CA 94043

Russell D Mitchell & Associates, Inc. 2760 Camino Diablo, Walnut Creek, CA 94597

CLIENT:

#### **Irene Chan-Jones and Bill Jones**

100 Burlwood Drive, San Francisco, CA 94127

PROJECT NAME: PROJECT NO:

2101 House on a Hill

036-031-280

PROJECT 10th Street ADDRESS: Montara, CA 94037

PROJECT PHASE: Construction Documents

DRAWN: CHECKED ISSUE DATE: 12/21/2021 9:47:51 PM

DRAWING TITLE: **ARCHITECTURAL SITE PLAN** 

**A112** DRAWING NO:

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#### Section 6300.2 Regulations for "S-17" Combining District (Midcoast)

**Building Height**The maximum building height shall be established, as follows:

a. Up to 30% Slope. Where the average slope of the parcel area covered by the main residence is less than 30%, maximum building height is 28 feet.

The average slope on the subject property is less than 30% - project is governed by this height limit.

b. 30% Slope or Greater. Where the average slope of the parcel area covered by the main residence is 30% or greater, maximum building height is 28 feet, unless increased by the Design Review Committee.

The Design Review Committee may increase the maximum building height to 33 feet for either: (1) The center 40% of the house, or

(2) The downslope wall. Where the downslope wall height limit is increased to 33 feet, maximum building height for the house shall be the plane formed by connecting the maximum upslope wall height (28 feet) with the maximum downslope wall height (33 feet).

Building height shall be measured as the vertical distance from any point on the natural grade to the topmost point of the building

Finished grade, measured at the outside face of exterior perimeter walls, shall not significantly deviate from the natural grade, to the satisfaction of the Design Review Committee.


27' - 10"

Buildable area

7' - 1"

Side setback (5' min)

Lot 10

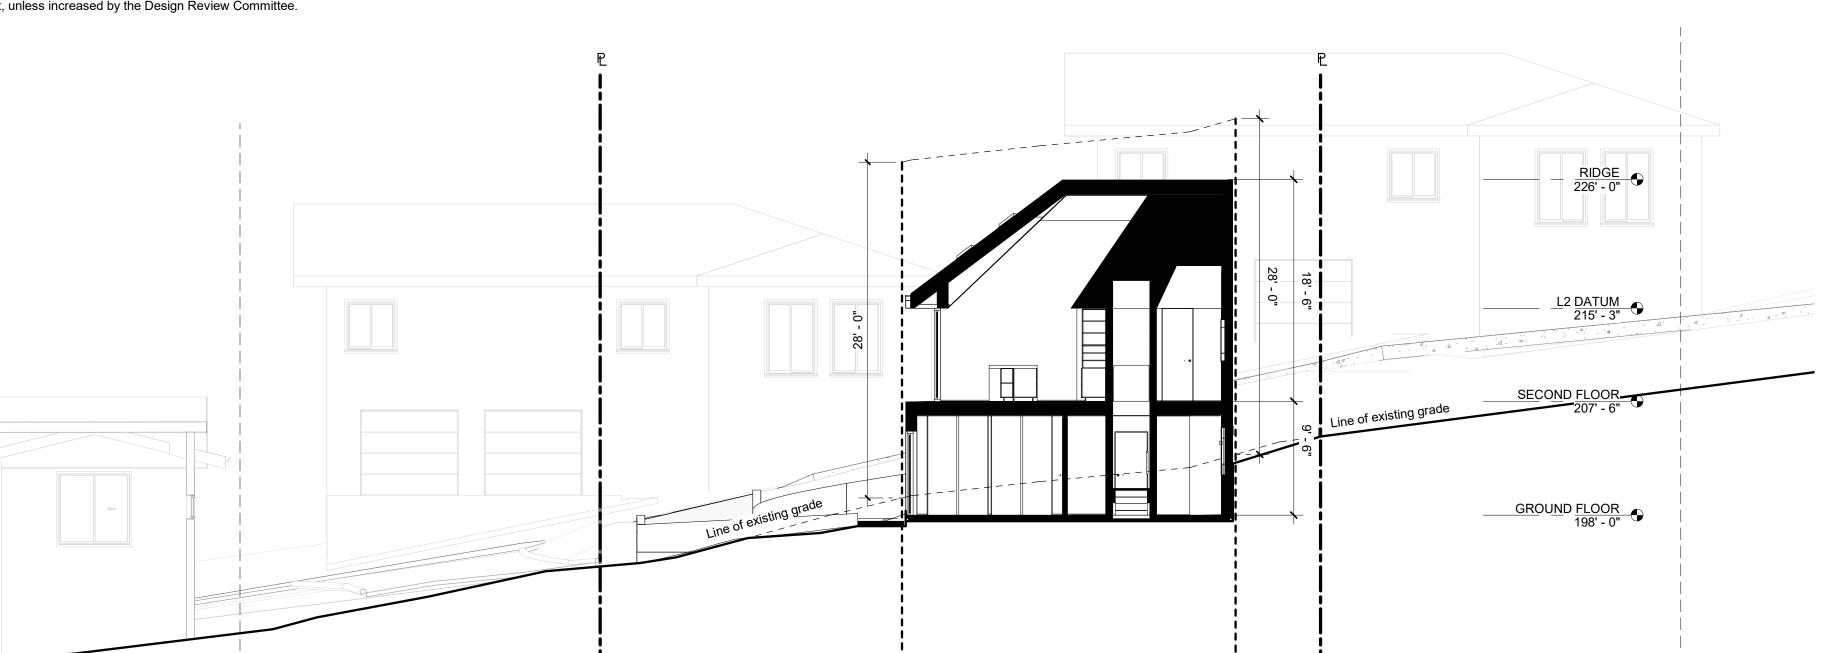


25' - 2" Side setback

Concrete step - conform to (E) sidewalk 206.06 207.45 T.O. permeable walkway

2 SECTION AT ENTRY WALKWAY
3/16" = 1'-0" REF 1 - A211



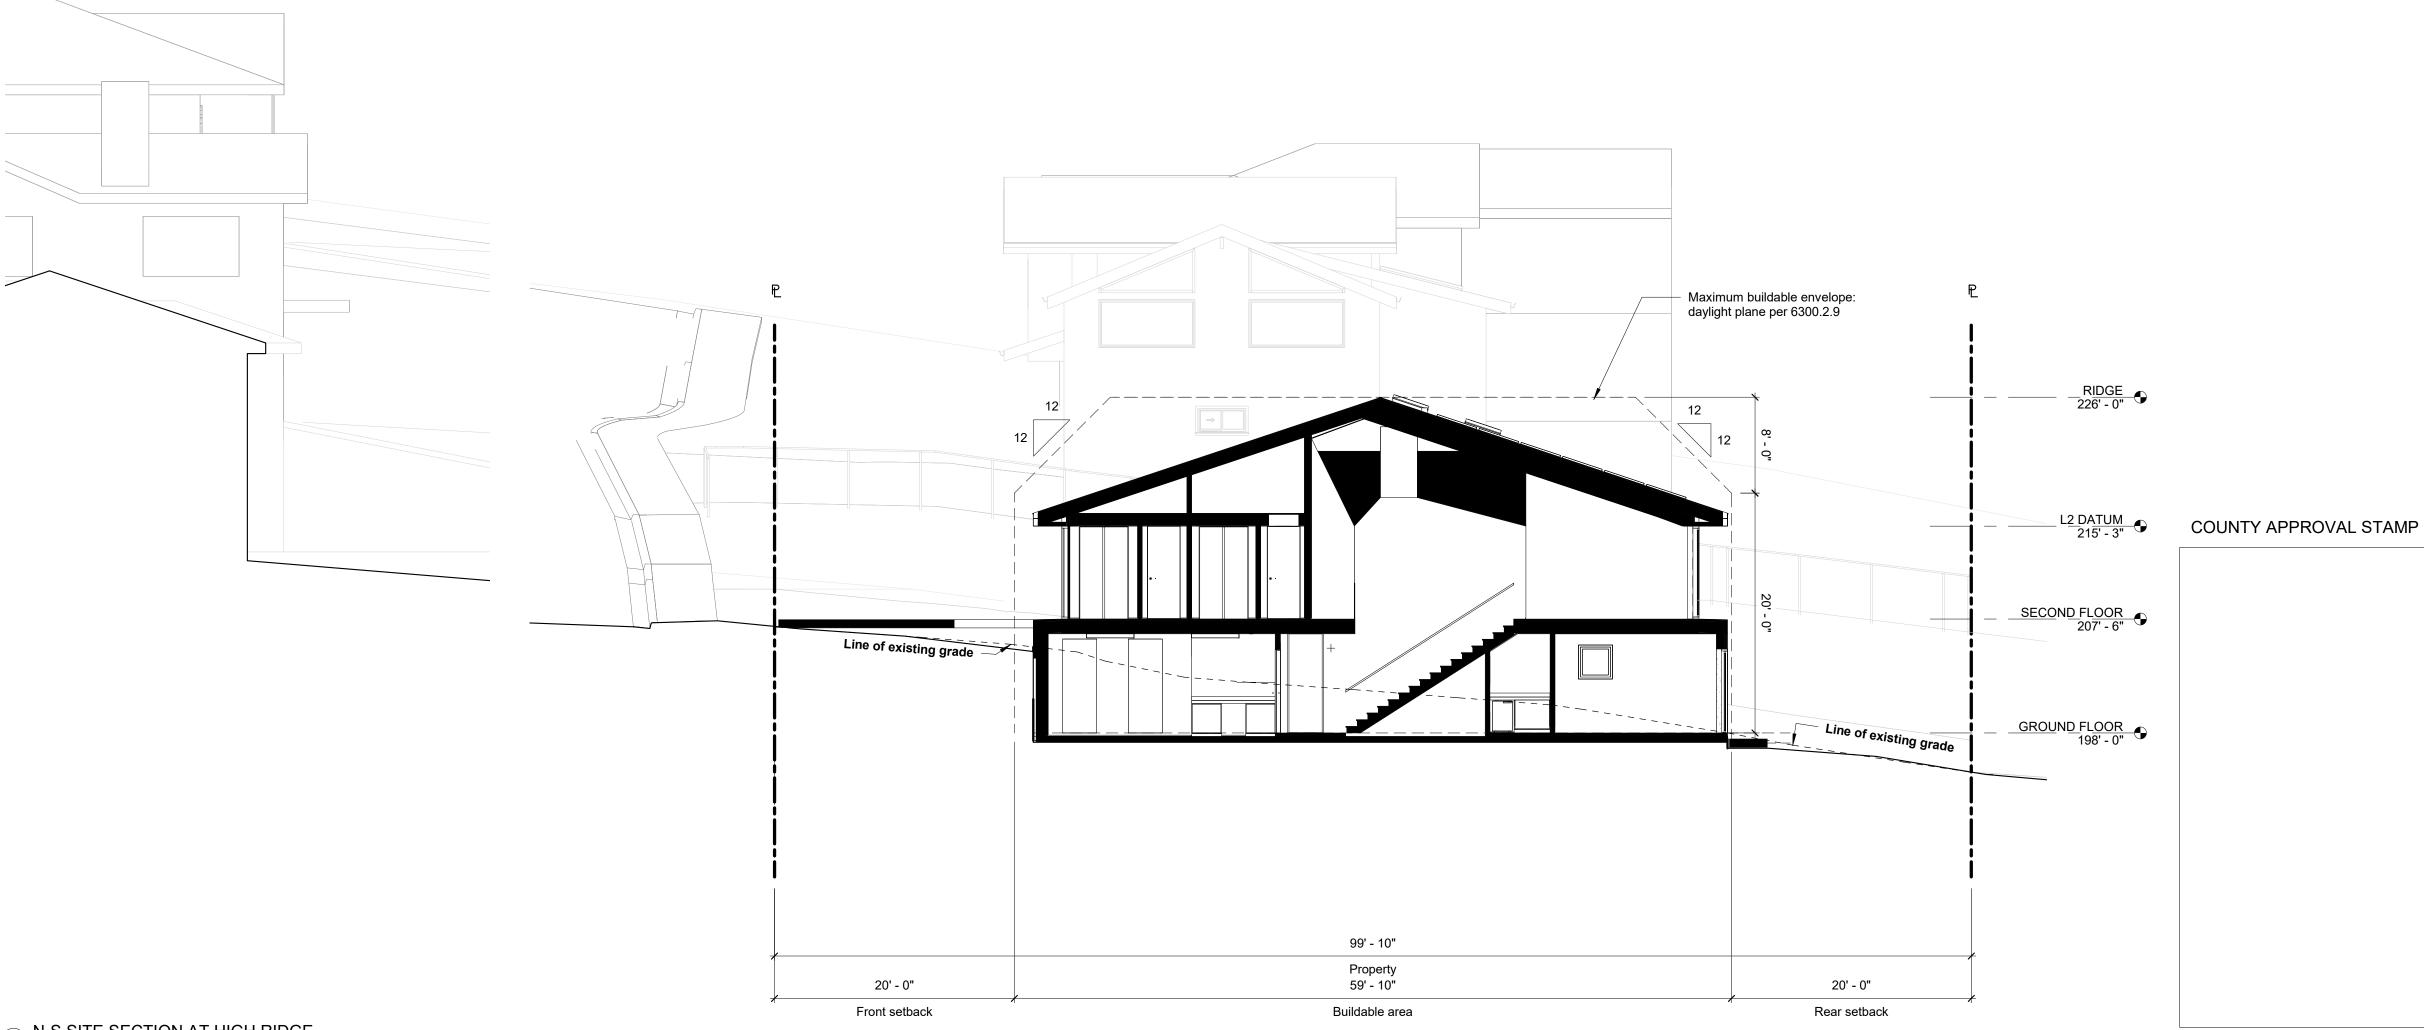

**FOR REVIEW & FILING** 

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DATE

5/11/2021

8/5/2021

12/21/2021

STAMP:

**REVISION:** 

DESCRIPTION

DESIGN REVIEW APPLICATION

PLN2021-00187 CYCLE 2

PLN2021-00187 CYCLE 3



ARCHITECT:

# **David Jaehning Architect**

381 11th Street, San Francisco, California 94103

CONSULTANT TEAM: STRUCTURAL/CIVIL: Design Everest, Inc. 365 Flower Lane, Mountain View, CA 94043

LANDSCAPE ARCHTECTURE: Tomas McKay: Architecture-Landscape Architecture 217 Bonita Avenue, Piedmont, CA 94611

IRRIGATION: Russell D Mitchell & Associates, Inc. 2760 Camino Diablo, Walnut Creek, CA 94597

CLIENT:

#### **Irene Chan-Jones and Bill Jones**

100 Burlwood Drive, San Francisco, CA 94127

PROJECT NAME: PROJECT NO:

2101 House on a Hill

036-031-280

10th Street PROJECT Montara, CA 94037 ADDRESS:

PROJECT PHASE: Construction Documents

DRAWN: CHECKED Checker

12/21/2021 9:47:53 PM ISSUE DATE:


DRAWING TITLE: ARCHITECTURAL SITE SECTIONS

**A113** 

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4 N-S SITE SECTION AT HIGH RIDGE 1/8" = 1'-0"



1 GROUND FLOOR PLAN
3/16" = 1'-0"
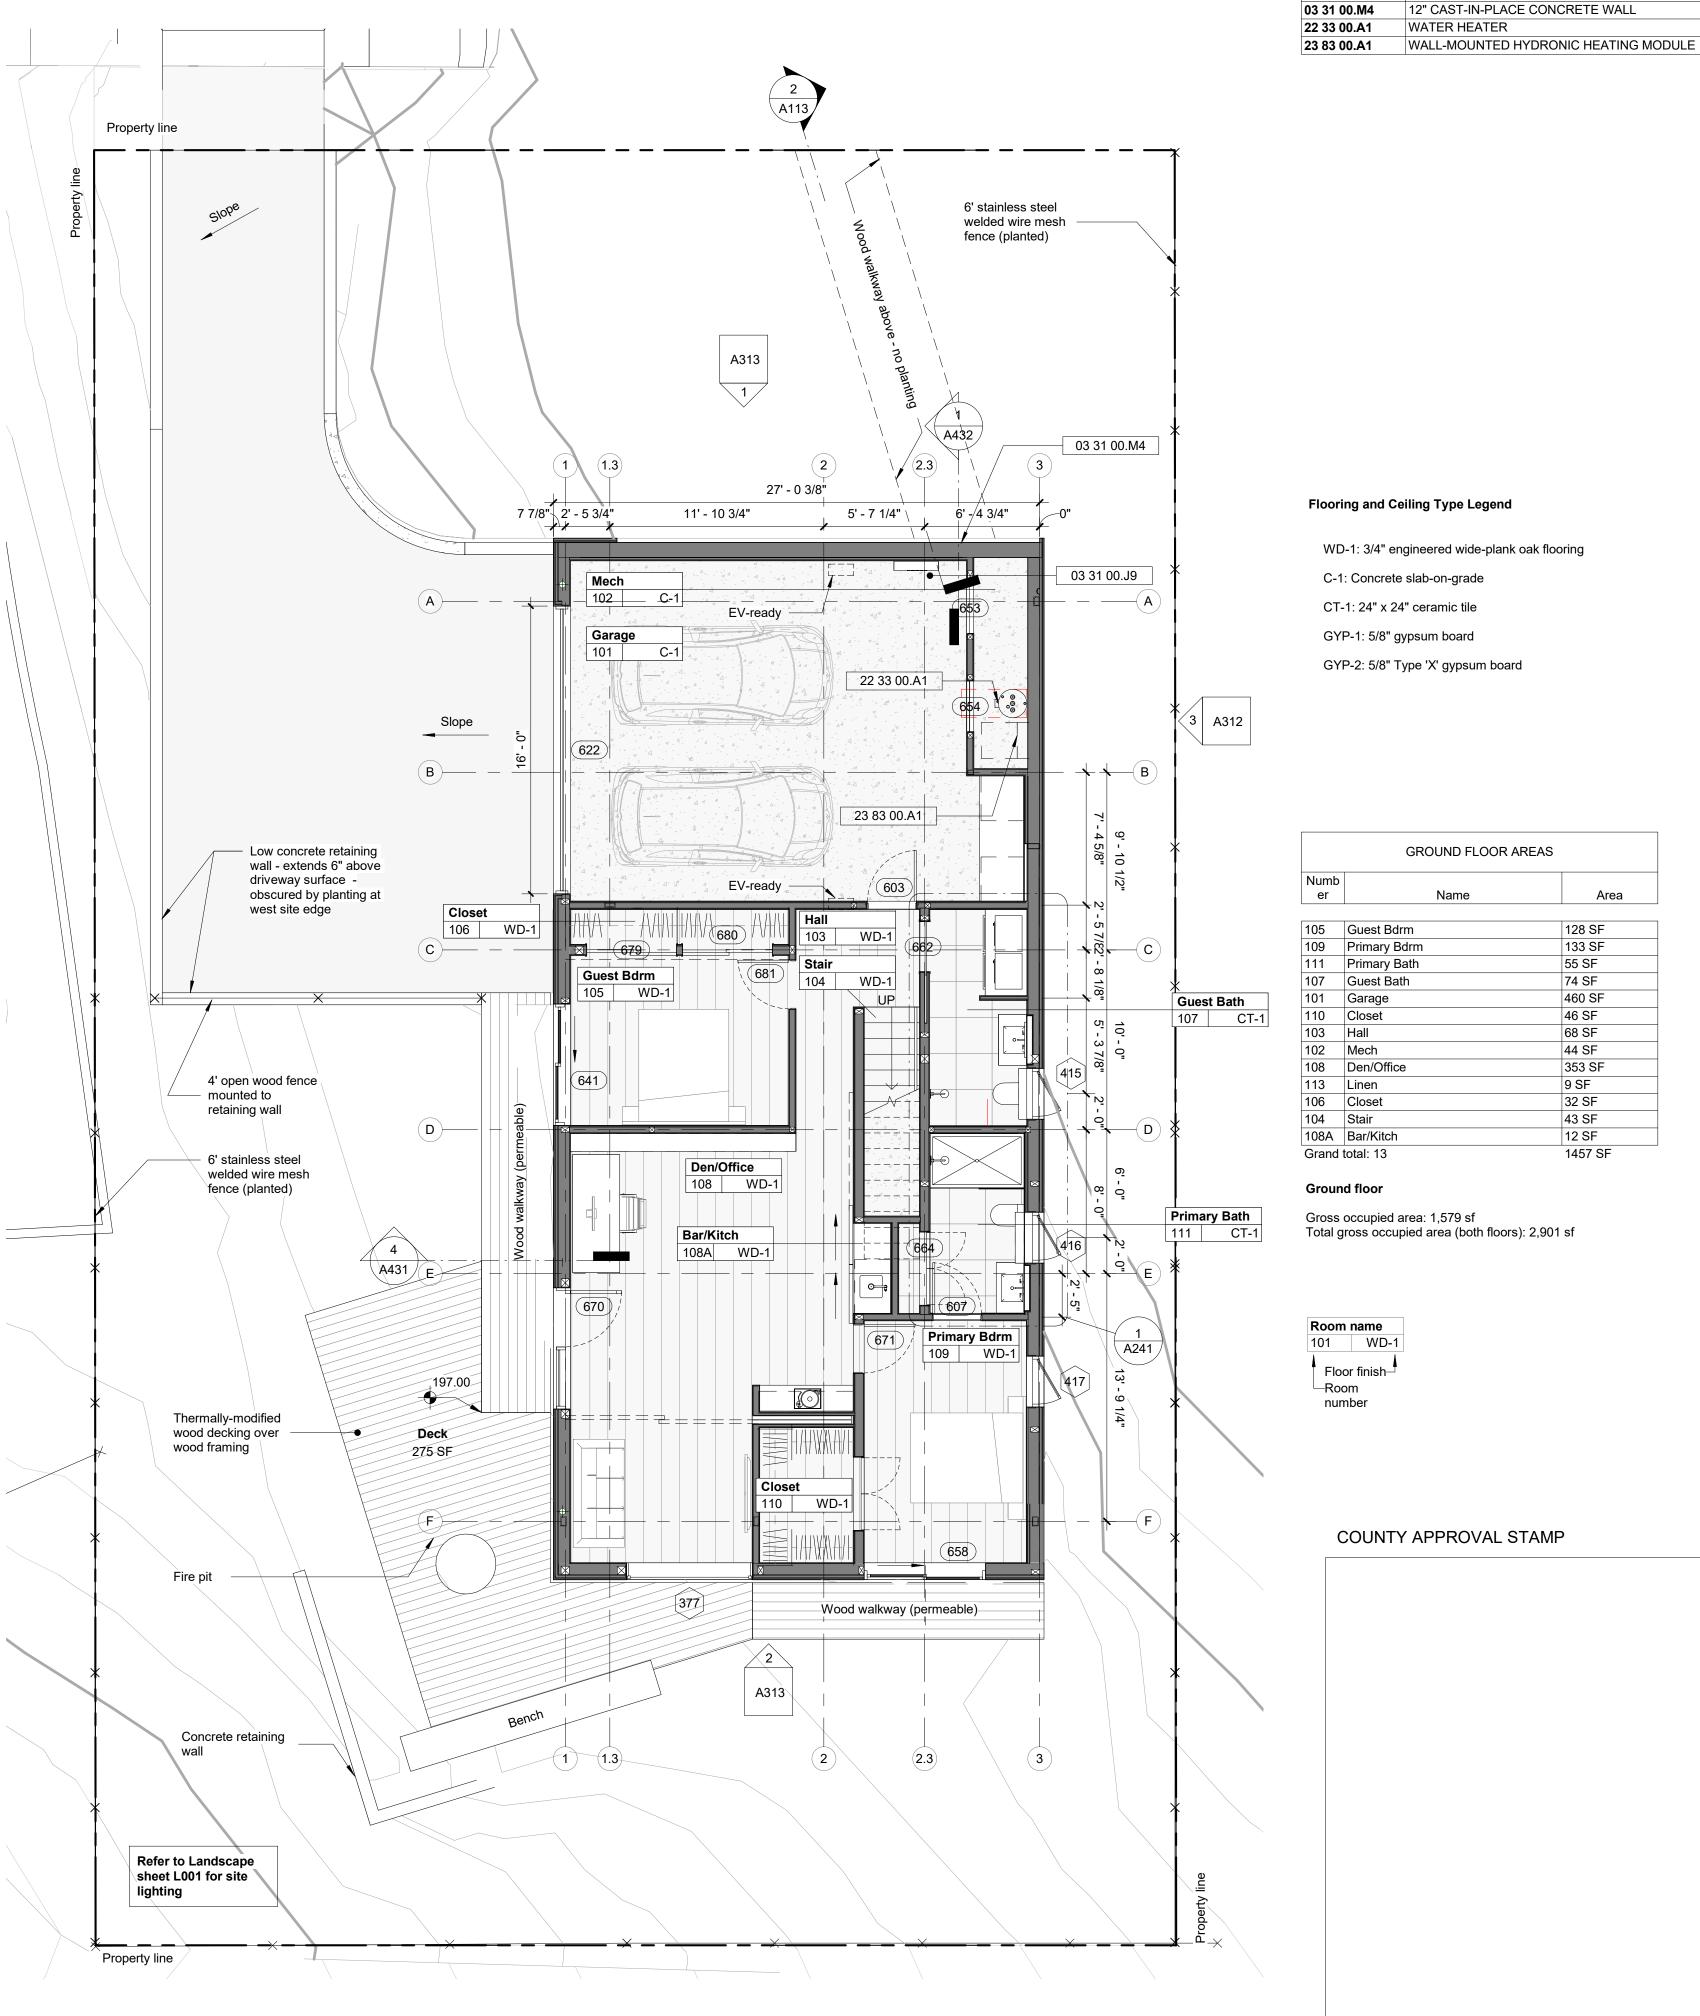
#### **ELEMENT KEYNOTES**

VALUE DESCRIPTION

12" CAST-IN-PLACE CONCRETE MAT SLAB 12" CAST-IN-PLACE CONCRETE WALL WATER HEATER

GROUND FLOOR AREAS

Area

128 SF

133 SF

55 SF

74 SF

460 SF

46 SF

68 SF

44 SF

353 SF

32 SF

43 SF

12 SF

1457 SF

9 SF

**REVISION:** 

NO. DESCRIPTION

5/11/2021 DESIGN REVIEW APPLICATION PLN2021-00187 CYCLE 2 8/5/2021 PLN2021-00187 CYCLE 3 12/21/2021

DATE

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#### ARCHITECT:

# **David Jaehning Architect**

381 11th Street, San Francisco, California 94103

CONSULTANT TEAM: STRUCTURAL/CIVIL: Design Everest, Inc. 365 Flower Lane, Mountain View, CA 94043

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IRRIGATION: Russell D Mitchell & Associates, Inc. 2760 Camino Diablo, Walnut Creek, CA 94597

## CLIENT:

#### **Irene Chan-Jones and Bill Jones**

100 Burlwood Drive, San Francisco, CA 94127

PROJECT NAME: PROJECT NO:

#### 2101 House on a Hill

036-031-280 APN: 10th Street **PROJECT** 

ADDRESS: Montara, CA 94037

PROJECT PHASE: Construction Documents

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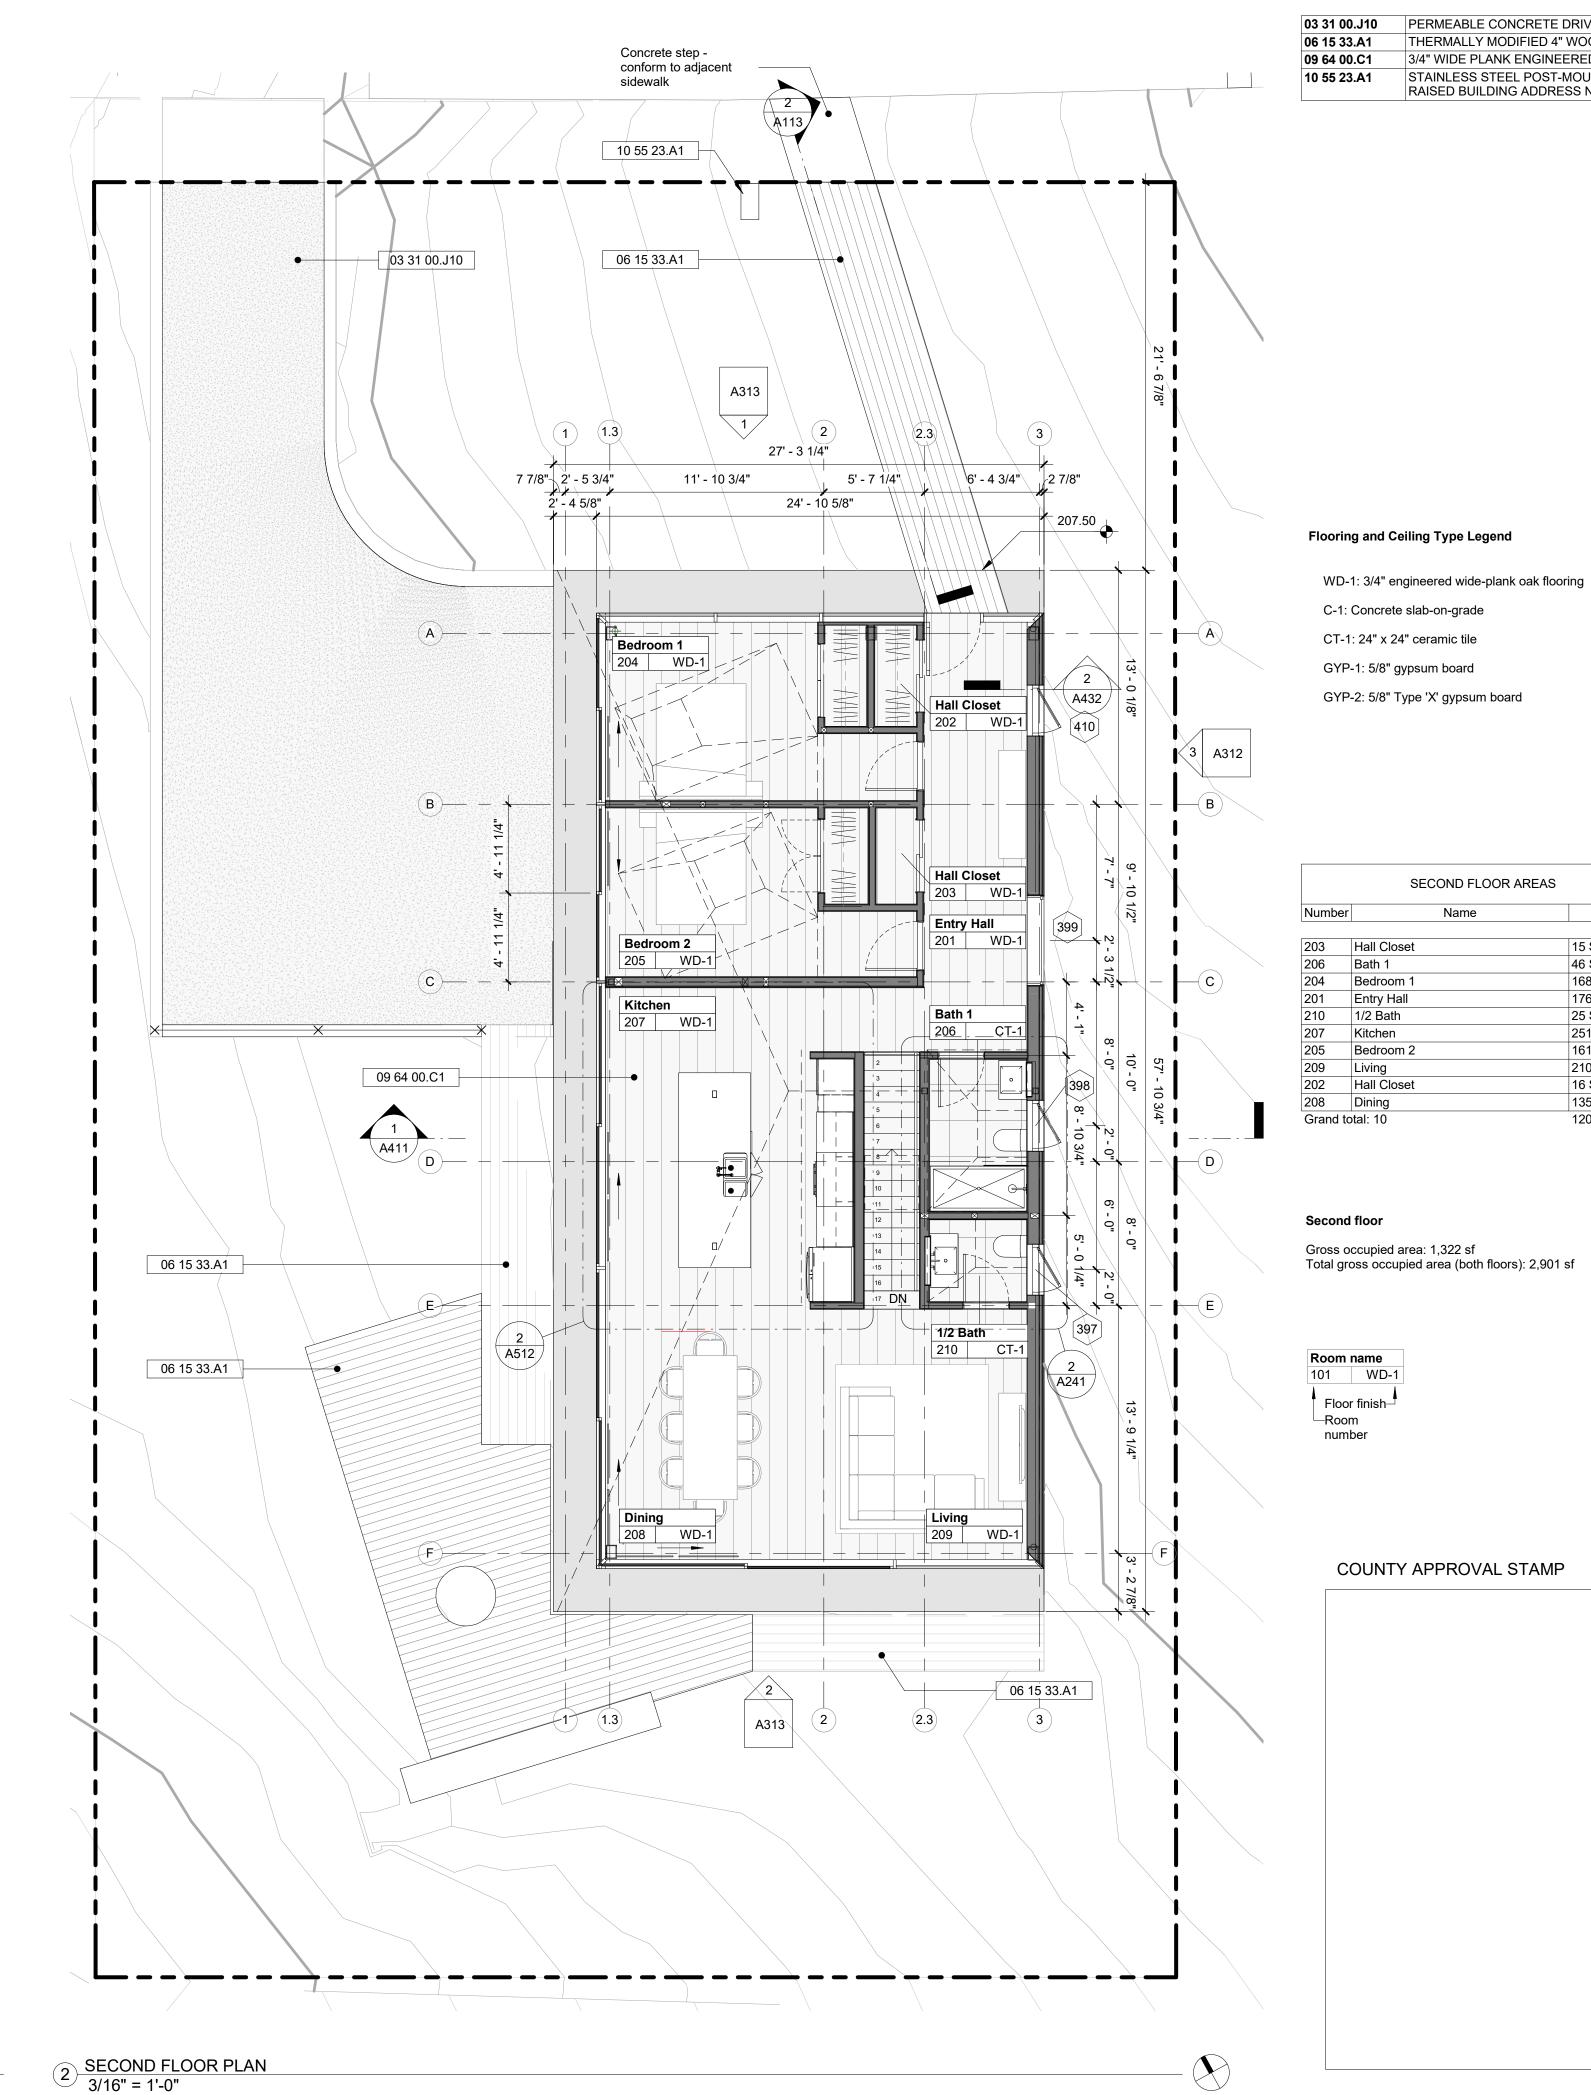
DRAWN: CHECKED 12/21/2021 9:47:56 PM ISSUE DATE:

DRAWING TITLE: **GROUND FLOOR PLAN** 

**A211** 

DRAWING NO:

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**ELEMENT KEYNOTES** 

VALUE DESCRIPTION

SECOND FLOOR AREAS

Bath 1

Bedroom 1 Entry Hall

1/2 Bath

Kitchen

Bedroom 2

Hall Closet

Area

15 SF

46 SF

168 SF

176 SF

25 SF

251 SF

161 SF

210 SF

16 SF

135 SF

1204 SF

03 31 00.J10 PERMEABLE CONCRETE DRIVEWAY - SEE CIVIL DETAILS THERMALLY MODIFIED 4" WOOD DECKING 09 64 00.C1 3/4" WIDE PLANK ENGINEERED OAK FLOORING STAINLESS STEEL POST-MOUNTED MAILBOX WITH RAISED BUILDING ADDRESS NUMERALS

**REVISION:** 

DESCRIPTION

5/11/2021 DESIGN REVIEW APPLICATION PLN2021-00187 CYCLE 2 8/5/2021 PLN2021-00187 CYCLE 3 12/21/2021

DATE

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#### ARCHITECT:

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381 11th Street, San Francisco, California 94103

CONSULTANT TEAM: STRUCTURAL/CIVIL: Design Everest, Inc. 365 Flower Lane, Mountain View, CA 94043

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IRRIGATION: Russell D Mitchell & Associates, Inc. 2760 Camino Diablo, Walnut Creek, CA 94597

#### CLIENT:

# **Irene Chan-Jones and Bill Jones**

100 Burlwood Drive, San Francisco, CA 94127

PROJECT NAME: PROJECT NO:

> 2101 House on a Hill

036-031-280

10th Street Montara, CA 94037 PROJECT ADDRESS:

PROJECT PHASE: Construction Documents

Checker

DRAWN: CHECKED

12/21/2021 9:48:06 PM ISSUE DATE:

DRAWING TITLE: **SECOND FLOOR PLAN & ROOF PLAN** 

DRAWING NO: **A212** 

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1 (1.3)

1) (1.3)

2' - 5 3/4"

Line of ceiling below

11' - 10 3/4"

5' - 7 1/4"

6' - 4 3/4"



1 WEST ELEVATION
1/4" = 1'-0" REF 1 - A003



**REVISION:** 

DESCRIPTION

5/11/2021 DESIGN REVIEW APPLICATION PLN2021-00187 CYCLE 2 8/5/2021 PLN2021-00187 CYCLE 3 12/21/2021

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CONSULTANT TEAM:

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365 Flower Lane, Mountain View, CA 94043 LANDSCAPE ARCHTECTURE:

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IRRIGATION:

Russell D Mitchell & Associates, Inc. 2760 Camino Diablo, Walnut Creek, CA 94597

#### **Irene Chan-Jones and Bill Jones**

100 Burlwood Drive, San Francisco, CA 94127

COUNTY APPROVAL STAMP

#### **House on a Hill** 2101

PROJECT NAME:

036-031-280

PROJECT NO:

PROJECT 10th Street ADDRESS: Montara, CA 94037

# PROJECT PHASE: Construction Documents

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12/21/2021 9:48:13 PM ISSUE DATE:

DRAWING TITLE: **ELEVATIONS** 


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**A311** 

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ARCHITECT:

# **David Jaehning Architect**

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Tomas McKay: Architecture-Landscape Architecture 217 Bonita Avenue, Piedmont, CA 94611

IRRIGATION:
Russell D Mitchell & Associates, Inc.
2760 Camino Diablo, Walnut Creek, CA 94597

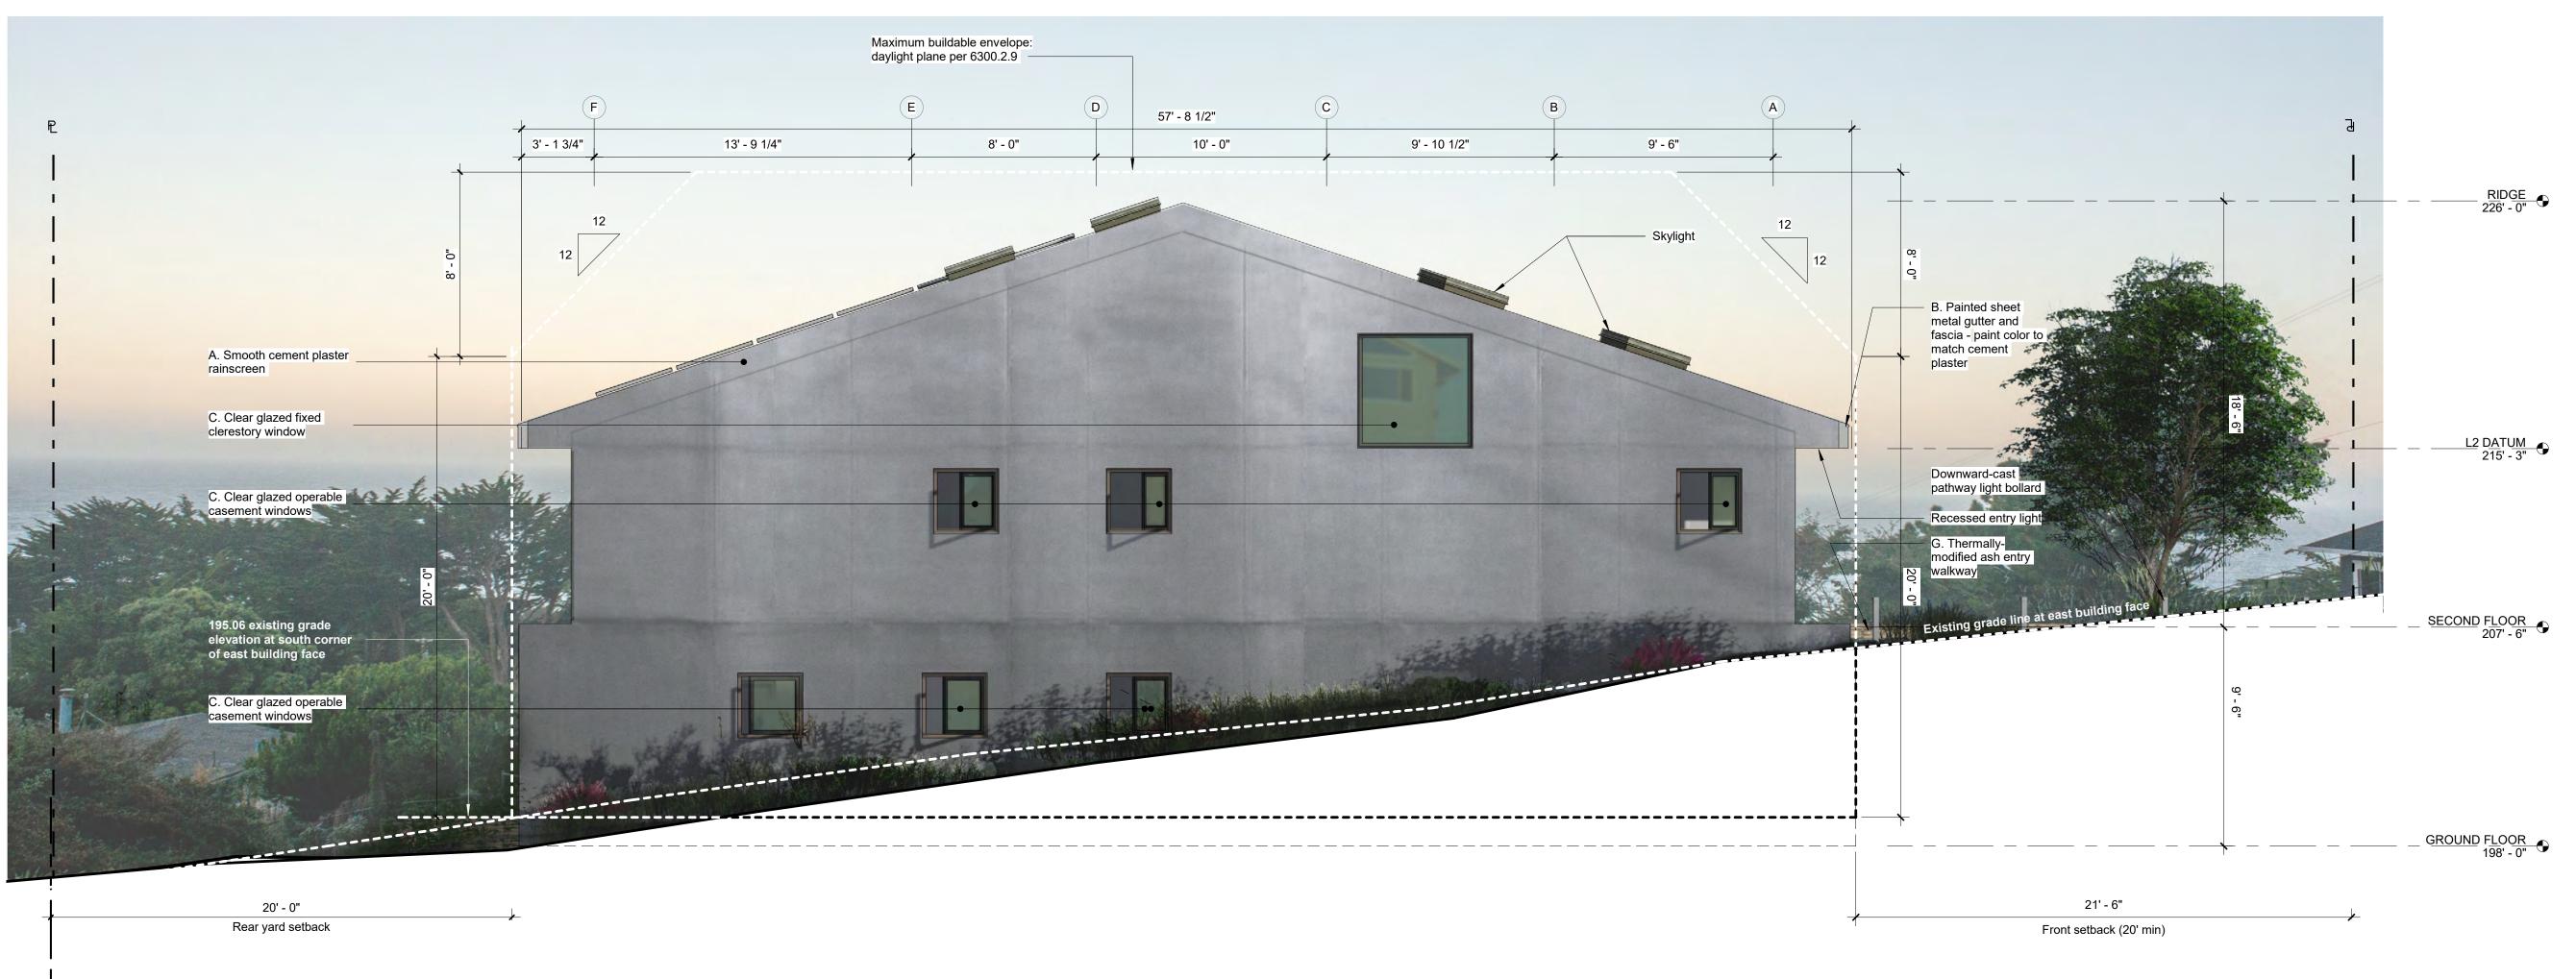CLIENT:

#### Irene Chan-Jones and Bill Jones

100 Burlwood Drive, San Francisco, CA 94127

3 EAST ELEVATION 1/4" = 1'-0" REF 1 - A211

#### Building materials legend A. Exterior walls Elastomeric masonry coating over smooth Elastomeric masonry coating over smooth cement plaster rainscreen: Sto StoColor cement plaster rainscreen: Sto StoColor Lastic elastomeric coating (StoColor 37302) Lastic elastomeric coating (StoColor 37302) G. Decks and railings Elastomeric coating over sheet metal: Thermally-modified ash decking Sto StoColor Lastic elastomeric coating (StoColor 37304) I. Retaining walls Reinforced poured concrete - light sandblast C. Window frames Anodized aluminum: C31 Bronze Anodized (Reynaers) finish D. Doors Anodized aluminum: C31 Bronze Anodized (Reynaers)

COUNTY APPROVAL STAMP

PROJECT NO: PROJECT NAME:

2101 House on a Hill

APN: 036-031-280
PROJECT 10th Street

ADDRESS: Montara, CA 94037

PROJECT PHASE: **Construction Documents**DRAWN: AG CHECKED Checker

: ISSUE DATE: 12/21/2021 9:48:19 PM

DRAWING TITLE: **ELEVATIONS** 


RAWING NO: A312

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1 NORTH ELEVATION
1/4" = 1'-0" REF 1 - A211



**REVISION:** 

DESCRIPTION

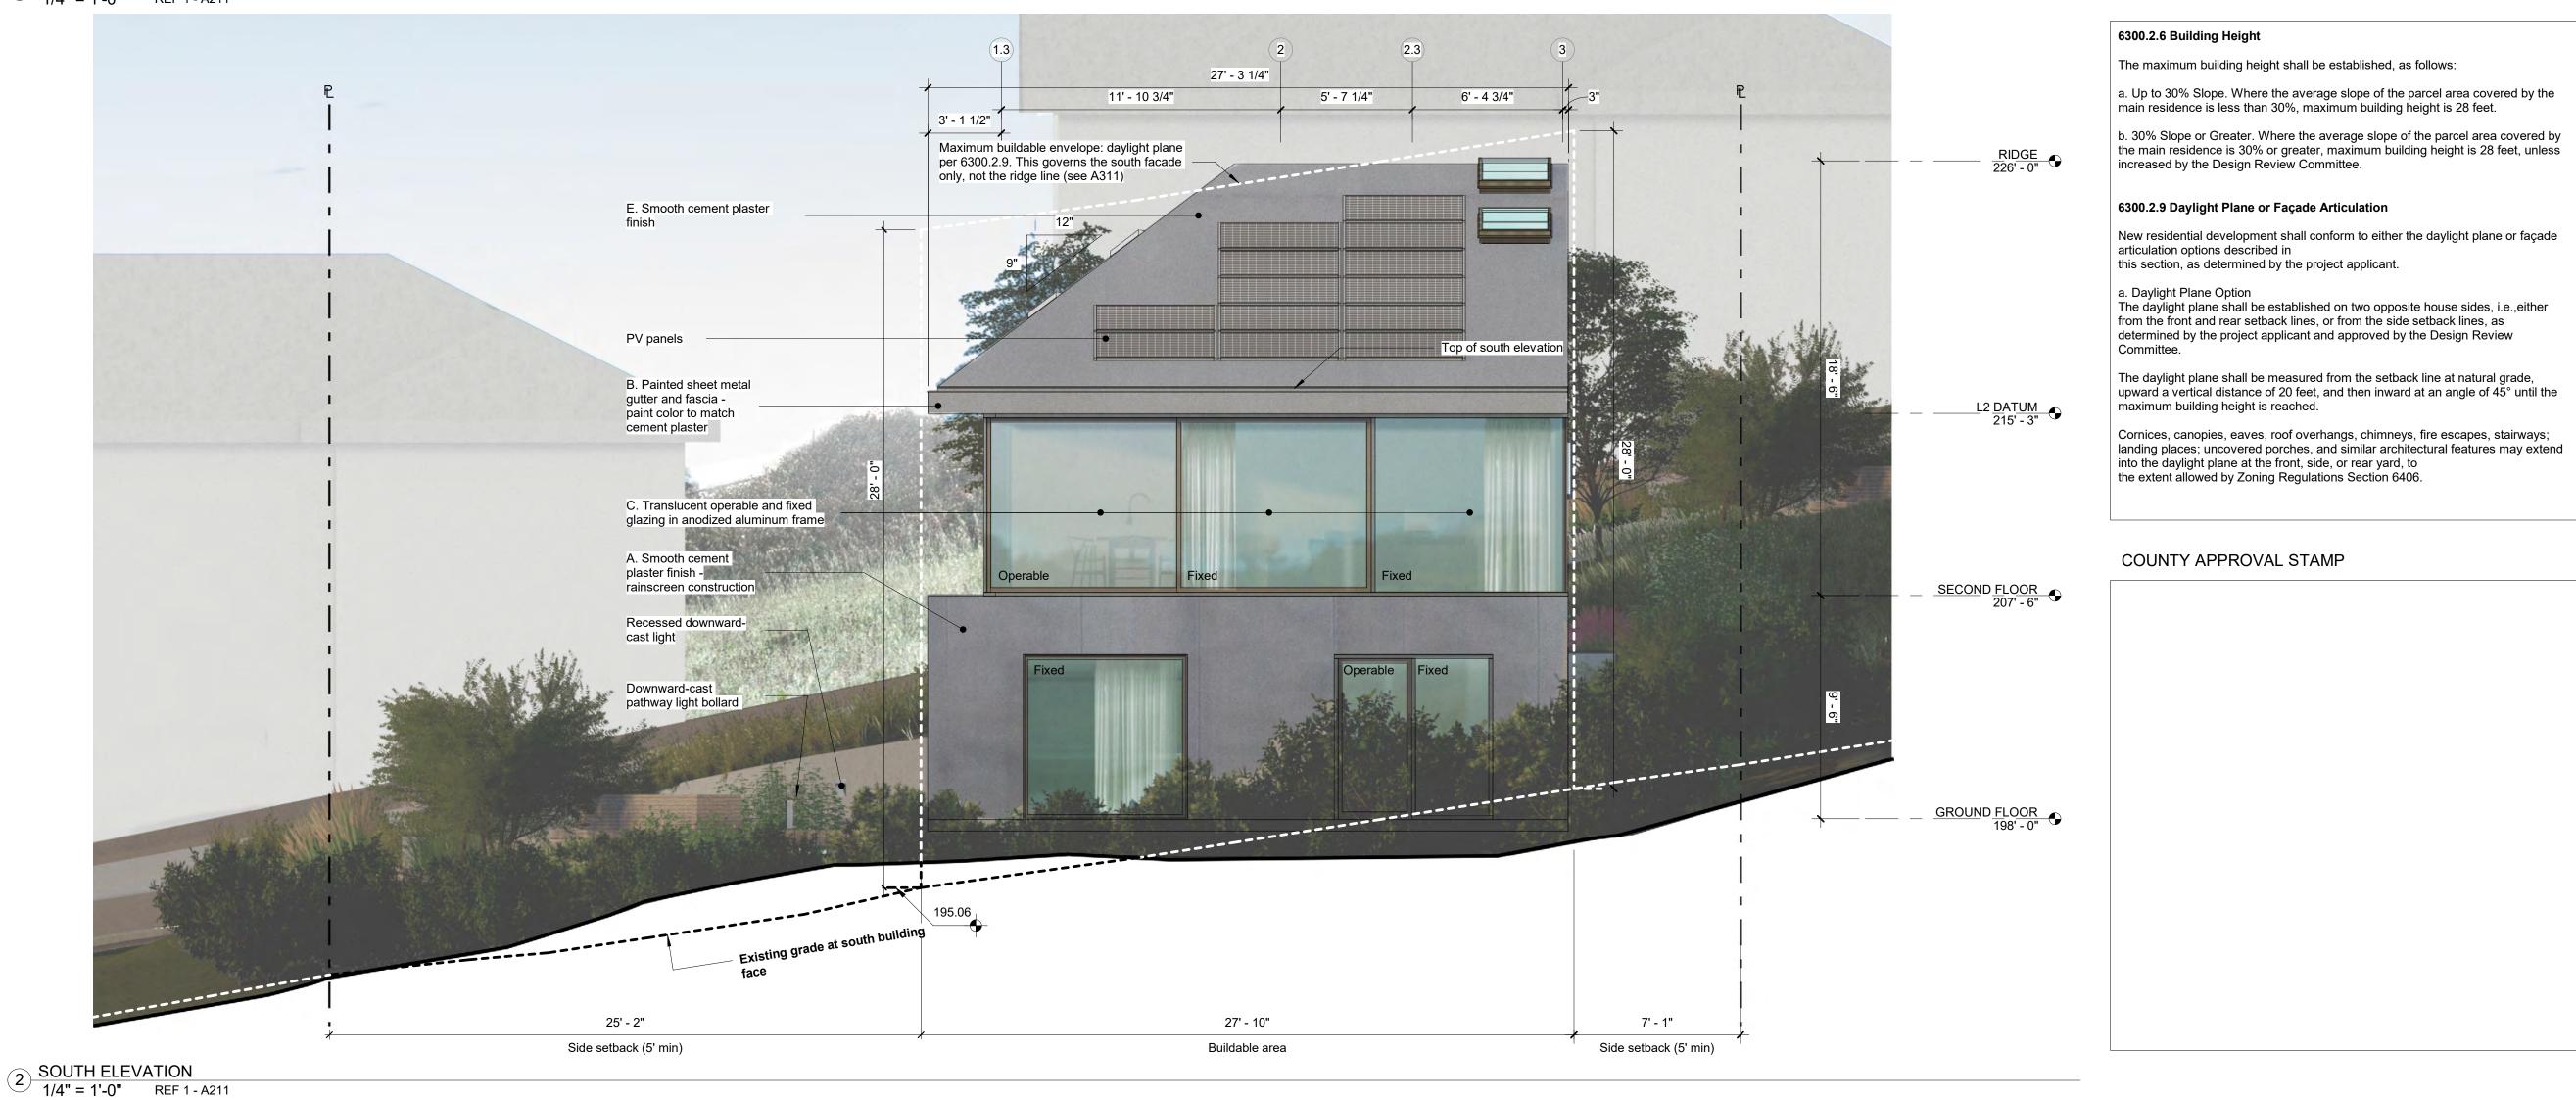5/11/2021 DESIGN REVIEW APPLICATION PLN2021-00187 CYCLE 2 8/5/2021


PLN2021-00187 CYCLE 3

DATE

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#### ARCHITECT:

# **David Jaehning Architect**

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CONSULTANT TEAM:
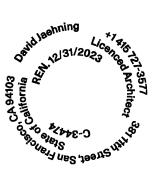
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LANDSCAPE ARCHTECTURE: Tomas McKay: Architecture-Landscape Architecture

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217 Bonita Avenue, Piedmont, CA 94611

IRRIGATION:

Russell D Mitchell & Associates, Inc. 2760 Camino Diablo, Walnut Creek, CA 94597

#### **Irene Chan-Jones and Bill Jones**

100 Burlwood Drive, San Francisco, CA 94127

COUNTY APPROVAL STAMP

PROJECT NAME: PROJECT NO:

**House on a Hill** 2101

036-031-280 PROJECT 10th Street ADDRESS: Montara, CA 94037

PROJECT PHASE: Construction Documents

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ISSUE DATE: 12/21/2021 9:48:29 PM

DRAWING TITLE: **ELEVATIONS** 

**A313** 

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