#### **Application for Design Review by the County Coastside Design Review Committee**

#### **1. Basic Information**

#### **Applicant:**

Name: Bruce Gehrels

Address: 3378 Brittan St.

San Carlos, Ca Zip: 94070

Phone,W: (650) 283-0942 H:

Email: cks.environmental@post.com

Architect or Designer (if different from Applicant):

**Kellond Architects** Name:

Address:	14510 Big Basin Way,	Ste. 205, Saratoga, Ca	Zip: <b>95070</b>	
Phone,W:	<b>(408) 741-0600</b> H:	Email:		

### **2. Project Site Information**

Project location:	Site Description:		
APN: 048-013-790	🗴 Vacant Parcel		
Address: No Situs; Cortez Ave at 1st Ave, Miramar	X Existing Development (Please describe):		
Zip:	Improved w/ all utilities & street improvements		
Zoning: R-1/S-94			
Parcel/lot size: <b>7,446</b> sq. ft.			
<b>3. Project Description</b>			
Project:	Additional Permits Required:		
X New Single Family Residence: 2,601 sq. ft	Certificate of Compliance Type A or Type B		
□ Addition to Residence: sq. ft	Coastal Development Permit		
X Other: _A.D.U. 367 s.f.	Fence Height Exception (not permitted on coast)		
Garage 462 s.f.	Grading Permit or Exemption		
Describe Project:	Home Improvement Exception		
	Non-Conforming Use Permit		
	Off-Street Parking Exception		

□ Variance

## **Planning and Building Department**

County Government Center = 455 County Center = Redwood City CA 94063 Mail Drop PLN 122 = 650 • 363 • 4161 = FAX 650 • 363 • 4849

Permit #: PLN

Other Permit #: \_\_\_\_

**Owner** (if different from Applicant):

Name: Thomas Carey Trustee

Address: 1580 Laurel St, Ste C

San Carlos, Ca Zip: **94070** 

Phone, W: (650) 394-8615 H:

Email:

#### 4. Materials and Finish of Proposed Buildings or Structures

Fill in Blanks:	Material	Color/Finish	Check If matches existing
		(If different from existing, attach sa	mple)
a. Exterior walls	as noted in plans		
b. Trim	as noted in plans		
c. Windows	as noted in plans		
d, Doors	as noted in plans		
e. Roof	as noted in plans		
f. Chimneys	as noted in plans		
g, Decks & railings	as noted in plans		
h. Stairs			
i. Retaining walls			
j. Fences	as noted in plans		
k. Accessory buildings	as noted in plans		
I. Garage/Carport	as noted in plans		

#### **5. Required Findings**

To approve this application, the County must determine that this project complies with all applicable regulations including the required findings that the project does conform to the standards and guidelines for design review applicable to the location of the project pursuant to Section 6565.10.

**u** (optional) Applicant's Statement of project compliance with standards and guidelines (check if attached).

#### 6. Signatures

I hereby certify that the information stated above and on forms, plans, and other materials submitted herewith in support of the application is true and correct to the best of my knowledge. It is my responsibility to inform the County of San Mateo through my assigned project planner of any changes to information represented in these submittals.

**T.J. Carey, Trustee** Owner:

*Bruce Gehrels* Applicant:

5/28/2021

5/28/2021

.....

Date:

Date:

#### **4. Project Information**

Does this project, the parcel on which it is located or the immediate vicinity involve or include:			p. Between the sea and the nearest public road?		
- Demolition of existing bousing units?	Yes	No	q. Existing or proposed provisions for public access to the shoreline?		$\checkmark$
a. Demolition of existing housing units? (If yes, give value of owner-occupied		$\checkmark$	r. Public or commercial recreation facilities?		$\checkmark$
units or current monthly rent of rental units in explanation below.)			s. Visitor-serving facilities?		
b. Creeks, streams, lakes or ponds?		$\checkmark$	t. Existing or proposed public trail		
c. Wetlands (marshes, swamps, mudflats)?		$\checkmark$	easements?		$\checkmark$
d. Beaches?		$\checkmark$	Explain all Yes answers below. Indicate		
e. Sand Dunes?		$\checkmark$	item applies to the project itself, the parcel on located, or the immediate vicinity (attach add		
f. Sea cliff, coastal bluffs or blufftops?		$\checkmark$	necessary):		
g. Ridgetops?		$\checkmark$			
h. Pampas Grass, invasive brooms or Weedy Thistle?		$\checkmark$	K.) Landscaping: Required by SMCO for	new res	sidence
i. Removal of trees or vegetation?		$\checkmark$			
j. Grading or alteration of landforms?		$\checkmark$			
k. Landscaping?	$\checkmark$				
I. Signs?		$\checkmark$			
m. Phone or utility line extensions or connections, either above or below ground (explain which)?					
n. Areas subject to flooding?		$\checkmark$			
o. Development on slopes 30% or steeper?		<b>√</b>			

#### 5. Staff Use Only

#### **California Coastal Commission Jurisdiction**

A. Does the Proposed Project Involve:

1. A subdivision, Certificate of Compliance Type B, Use Permit, or Planned Agricultural District Permit?

The Yes I No

2. Construction or grading within 100 feet of a stream or wetland?

🗖 Yes

🗹 No

3. A parcel located between the sea and the first public through road paralleling the sea; 300 feet from the inland extent of any beach or mean high tide line if there is no beach; or within 300 feet of the top of the seaward face of a coastal bluff?

🗆 Yes 🗹 No

Yes to any one of the above means that the Coastal Development Permit is appealable to the Coastal

Commission; a public hearing is always required.

B. Does the proposed project involve lands below the mean high tide line and lands where the public trust may exist? (See "Post CCP Certification Permit and Appeal Jurisdiction Map).

Yes

🗹 No

Yes to above means that the California Coastal Commission retains permit jurisdiction over all or part of the proposed project. A Coastal Development Permit from that agency is required.

Reviewed by:

#### San Mateo County

## **Planning Permit** Ар

455 County Center, 2nd Floor - Redwood City CA 94063 Mail Drop: PLN 122 = TEL (650) 363-4161 = FAX (650) 363-4849 www.co.sanmateo.ca.us/planning

Application Form	PLN:			
••	BLD:			
Applicant/Owner Information				
Applicant: Bruce Gehrels				
Mailing Address: 3378 Brittan St.				
San Carlos, California		Zip: <b>94070</b>		
Phone, W: 6502830942	H:			
E-mail Address: cks.environmental@post.com	FAX:			
Name of Owner (1): Thomas Carey Trustee	Name of Owner (2):			
Mailing Address: 1580 Laurel St, Ste.C	Mailing Address:			
San Carlos, California				
California Zip: 94070		Zip:		
Phone,W: 6503948615	Phone,W:			
H:	Н:			
E-mail Address:	E-mail Address:			
Project Information				
Project Location (address):	Assessor's Parcel Numbers:	48 - 13 - 790		
No Situs, Cortez St @1st AvMiramar				
Zoning: R1/S-94	Parcel/lot size: 7,446	SF (Square Feet)		

Single-Family Dwelling, 2,601 sq.ft. ; Accessory Dwelling Unit, 367 sq. ft.

Planning : Design Review, Coastside; CEQA Exemption.

Describe Existing Site Conditions/Features (e.g. topography, water bodies, vegetation):

Vacant level Lot, no vegetation, no trees.

Describe Existing Structures and/or Development:

No structures; All utilities & improved street present at site.

We hereby certify that the information stated above and on forms, plans and other materials submitted herewith in support of the application is true and correct to the best of our knowledge. It is our responsibility to inform the County of San Mateo through our assigned project planner of any changes to information represented in these submitalls.

Owner's signature:

Owner's signature:

Applicant's signature:

#### Planning and Building Department

Application for a Coastal Development Permit

455 County Center , 2nd Floor • Redwood City, CA 94063 Mail Drop: PLN 122 • TEL (650) 363-4161 • FAX (650) 363-4849

#### **Companion Page**

Applicant's Name: Bruce Gehrels

Primary Permit #:

#### **1. Instructions**

Please fill out the general Planning Permit Application Form and this form when applying for a Coastal Development Permit. You must also submit all items indicated on the checklist found on the reverse side of the Planning Permit Application Form.

2. Basic Information	
Does the owner or applicant own any adjacent property not listed?	Have you or anyone else previously applied to either the County of San Mateo or the California Coastal Commission for a Coastal Development Permit for this or a similar project at this location?
If yes, list Assessor's Parcel Number(s):	If yes, explain (include date and application file numbers).

#### **3. Materials and Finish of Proposed Buildings or Structures**

Note: By completing this section you do not need to file a separate application for Design Review Approval.

Fill in Blanks:	Material	Color/Finish	Check if matches existing
a. Exterior Walls	per Plans		
b. Trim	per Plans		
c. Roof	per Plans		
d. Chimneys	per Plans		
e. Accessory Buildings	per Plans		
f. Decks/Stairs	n/a		
g. Retaining Walls	n/a		
h. Fences	per Plans		
i. Storage Tanks	n/a		

# EXTERIOR COLORS & MATERIALS

1&2




3

- 1. Walls : Board & batten @ 2nd floor, painted 'White'
- 2. Doors & Windows, Trim : Andersen-metal clad, 'White', Painted trim to match
- 3. Roof : Composition Shingle, Certainteed Landmark TL, 'Thunderstorm Gray'
- 4. Walls : Wood shingle @ 1st floor, stained—Cabot, 'Mulberry'
- 5. Metal railing @ deck

Cortez Ave.

APN:048-013-790

Half Moon Bay, California

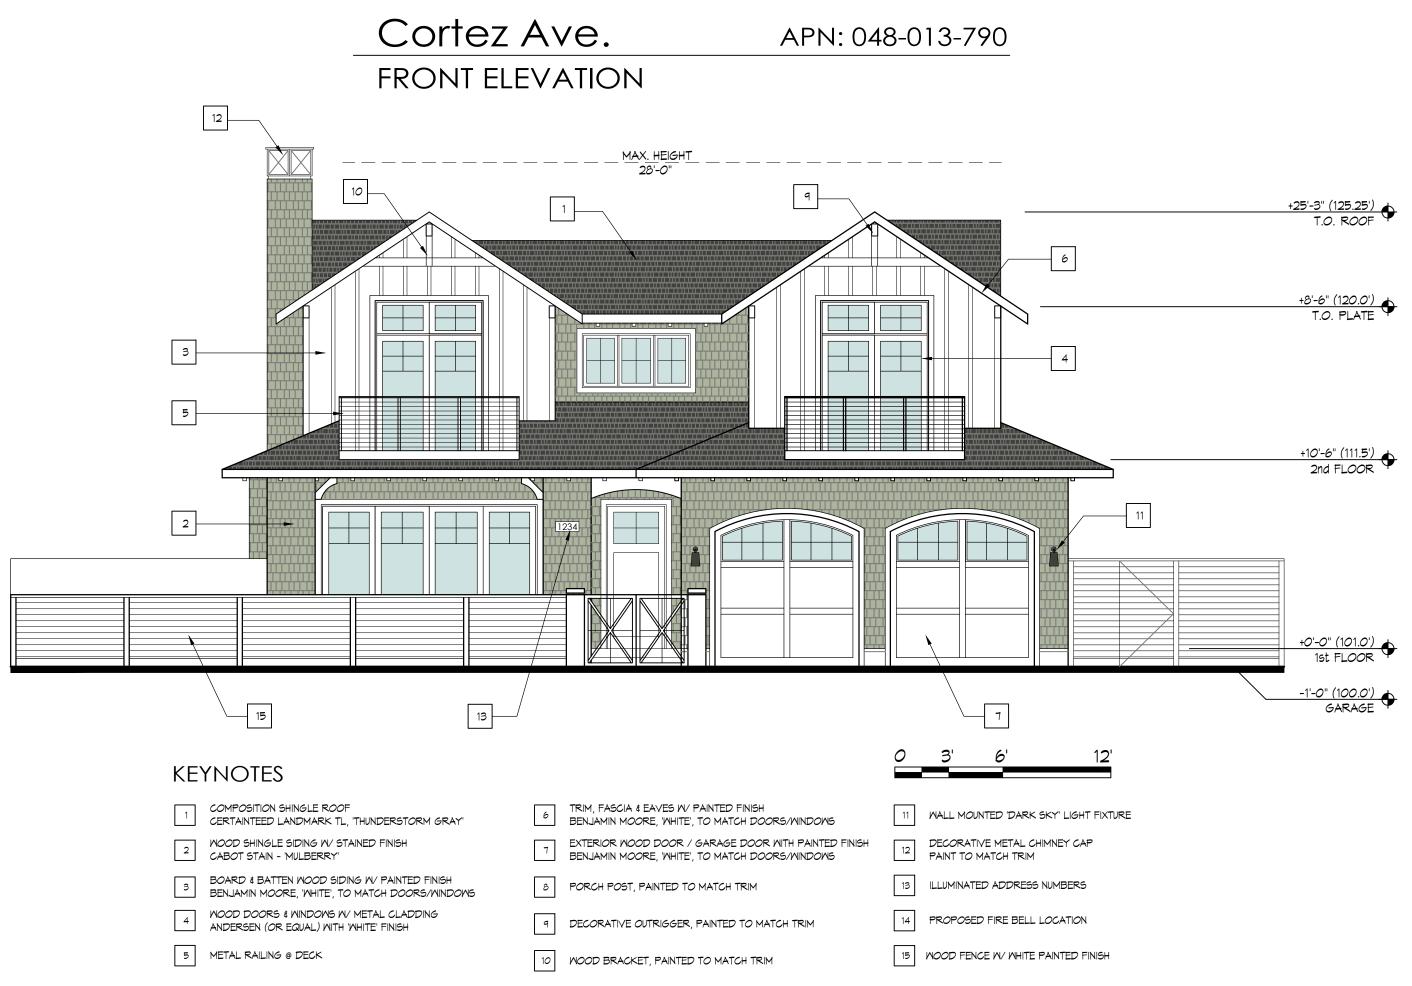

## FRONT DOOR

11/6/21, 9:29 AM

Design Tool | Andersen Windows

ANDERSEN

#### PANEL STYLE #402 ARTS AND CRAFTS



Interior



Exterior

#### Summary

Configuration	Single Door
Interior Color	White
Glass	Low-E4® Glass
Hardware	Albany, Black
Grille Pattern	Specified Equal Light
Grille Width	1 1/8"
Exterior	Colony White

#### LOVE THE LIFE YOU SEETM

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Cortez Ave.

APN:048-013-790

Half Moon Bay, California

# GARAGE DOOR



Semi-Custom Garage door by Ranch House Doors Similar to RHD# 087 with arched top and windows

Cortez Ave.

APN:048-013-790


Half Moon Bay, California

# EXTERIOR WALL MOUNTED LIGHT FIXTURE

#### Lightray | 6101ABZ

lab Name:\_\_\_\_\_\_Job Type:\_\_\_\_\_\_Quantity:\_\_\_\_\_\_Comments:\_\_\_\_\_\_



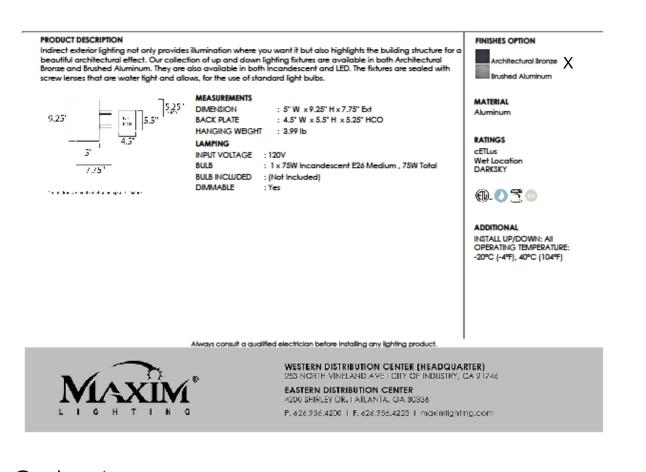

Cortez Ave.

APN:048-013-790

Half Moon Bay, California


# PROPOSED NEW RESIDENCE & A.D.U.

# APN: 048-013-790 Cortez Ave. Half Moon Bay, CA 94019

# SHEET INDEX

- PROJECT INFO & ARCHITECTURAL SITE PLAN SD-1
- C-0 TOPOGRAPHIC SURVEY
- SD-2.1 FLOOR PLANS
- SD-2.2 ROOF PLAN
- SD-3 EXTERIOR ELEVATIONS
- SD-4 A.D.U. PLAN & ELEVATIONS
- SECTIONS SD-5
- SD-6 FLOOR AREA & COVERAGE
- C-1 GRADING & DRAINAGE PLAN
- EROSION & SEDIMENT CONTROL PLAN C-2
- BEST MANAGEMENT PRACTICES
- L-1.1 LANDSCAPE PLAN
- L-2.1 LANDSCAPE IRRIGATION PLAN

# **PROJECT LOCATION**

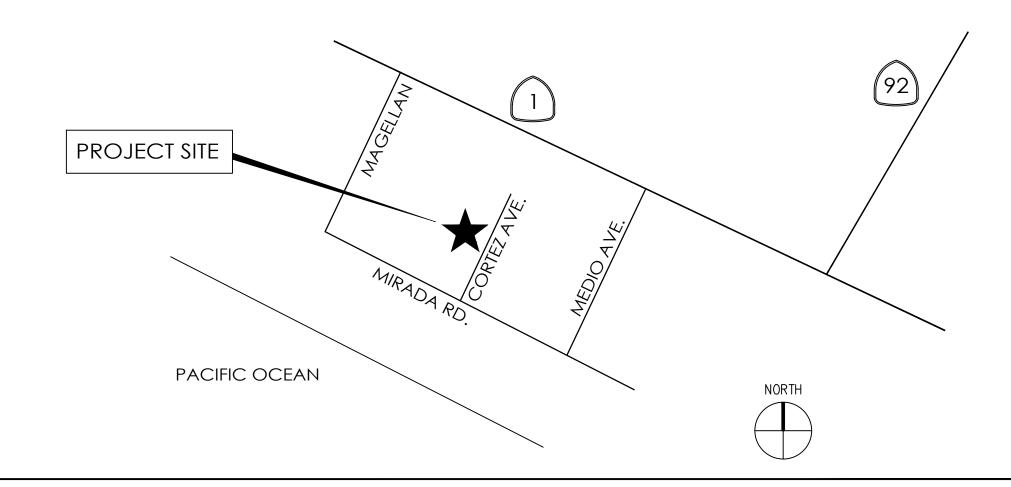


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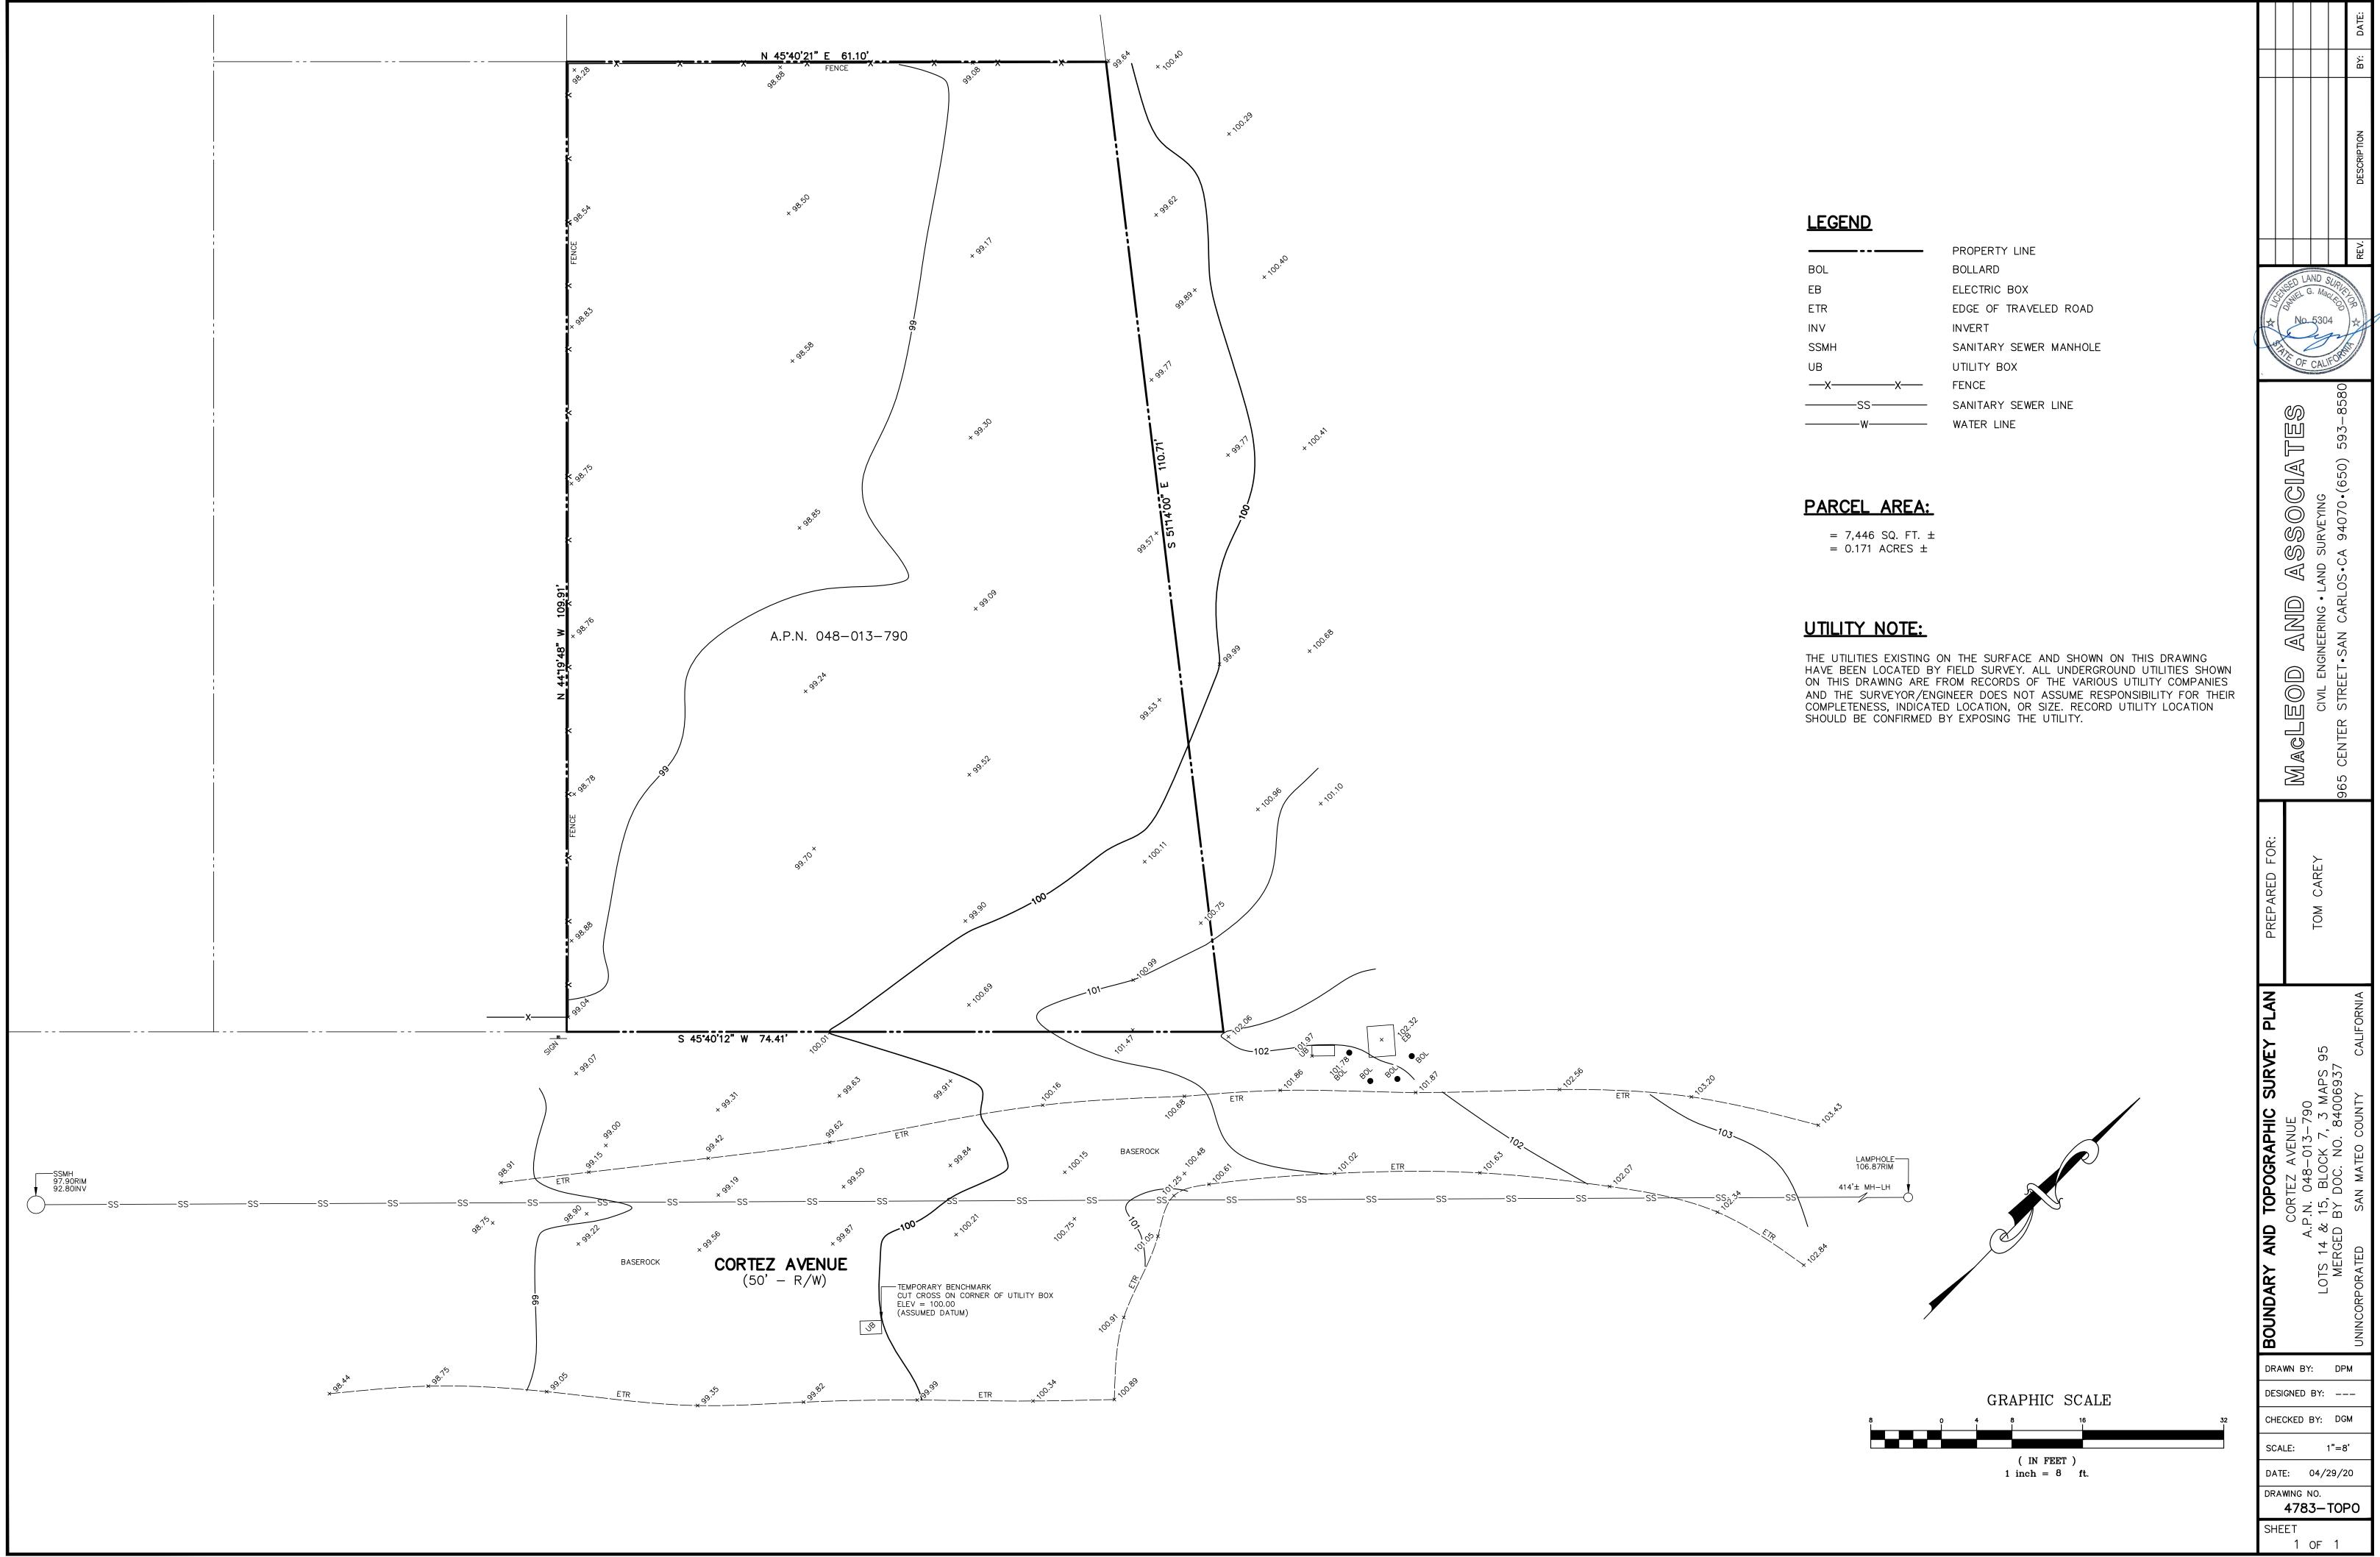
ZONING	R-1/S-94	
	-	
SITE AREA	7,446 S.F.	
ALLOWABLE FLOOR AREA	3,574 S.F.	(48% OF SITE AREA)
PROJECT FLOOR AREA	3,460 S.F.	(46% OF SITE AREA)
ALLOWABLE COVERAGE	2,233.8 S.F.	(30% OF SITE AREA)
PROJECT COVERAGE	2,233 S.F.	(30% OF SITE AREA)
ALLOWABLE IMPERVIOUS	744.6 S.F.	(10% OF SITE AREA)
PROJECT IMPERVIOUS	596 S.F.	(8% OF SITE AREA)
FLOOR AREA - LIVING		SITE COVER
	1.070.0.5	

FIRST FLOOR - LIVING	1,370 S.F.
SECOND FLOOR - LIVING	1,261 S.F.
TOTAL - LIVING	2,631 S.F.
FLOOR AREA - GARAGE	462 S.F.
FLOOR AREA - A.D.U.	367 S.F.


## ERAGE

TOTAL	2,233 S.F.
(BUILDING FOOTPRINTS & PORC	CHES)
IMPERVIOUS SURFACE	
TOTAL	596 S.F.
(PATIOS, FRONT WALK)	



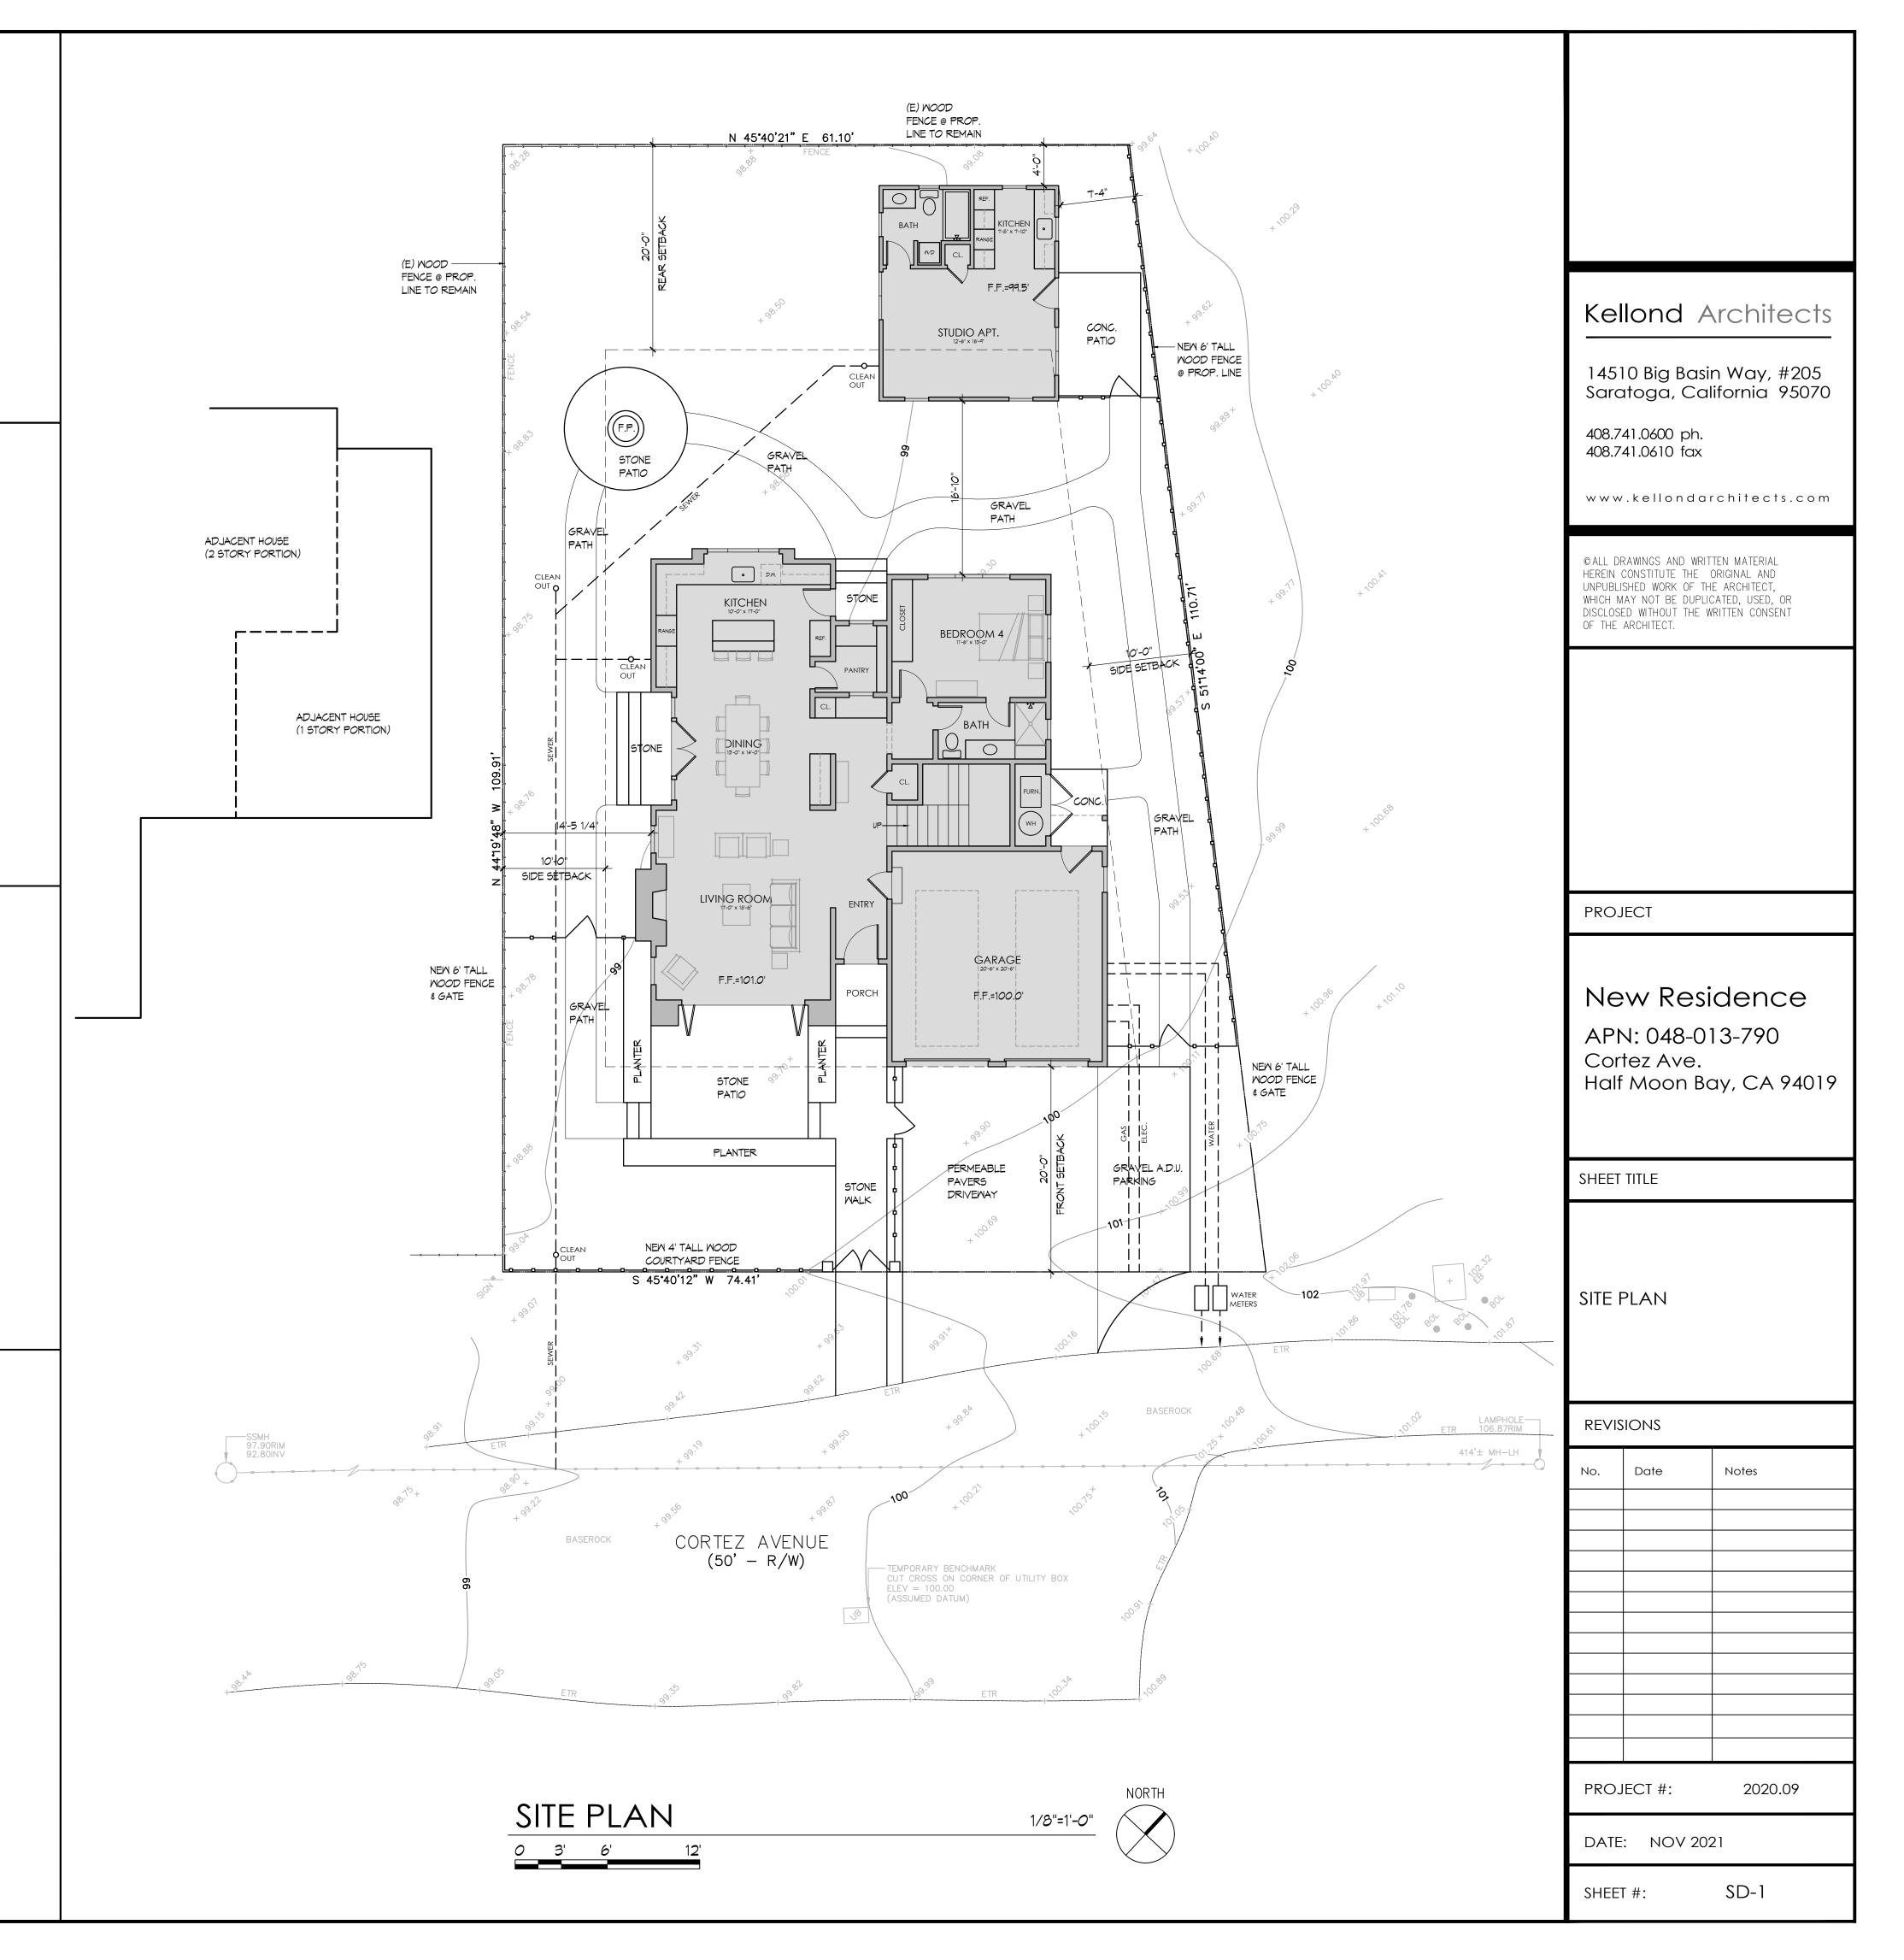

BOL		
EB		
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SSMH		
UB		
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	ss—	
	-w	
X	SS	X

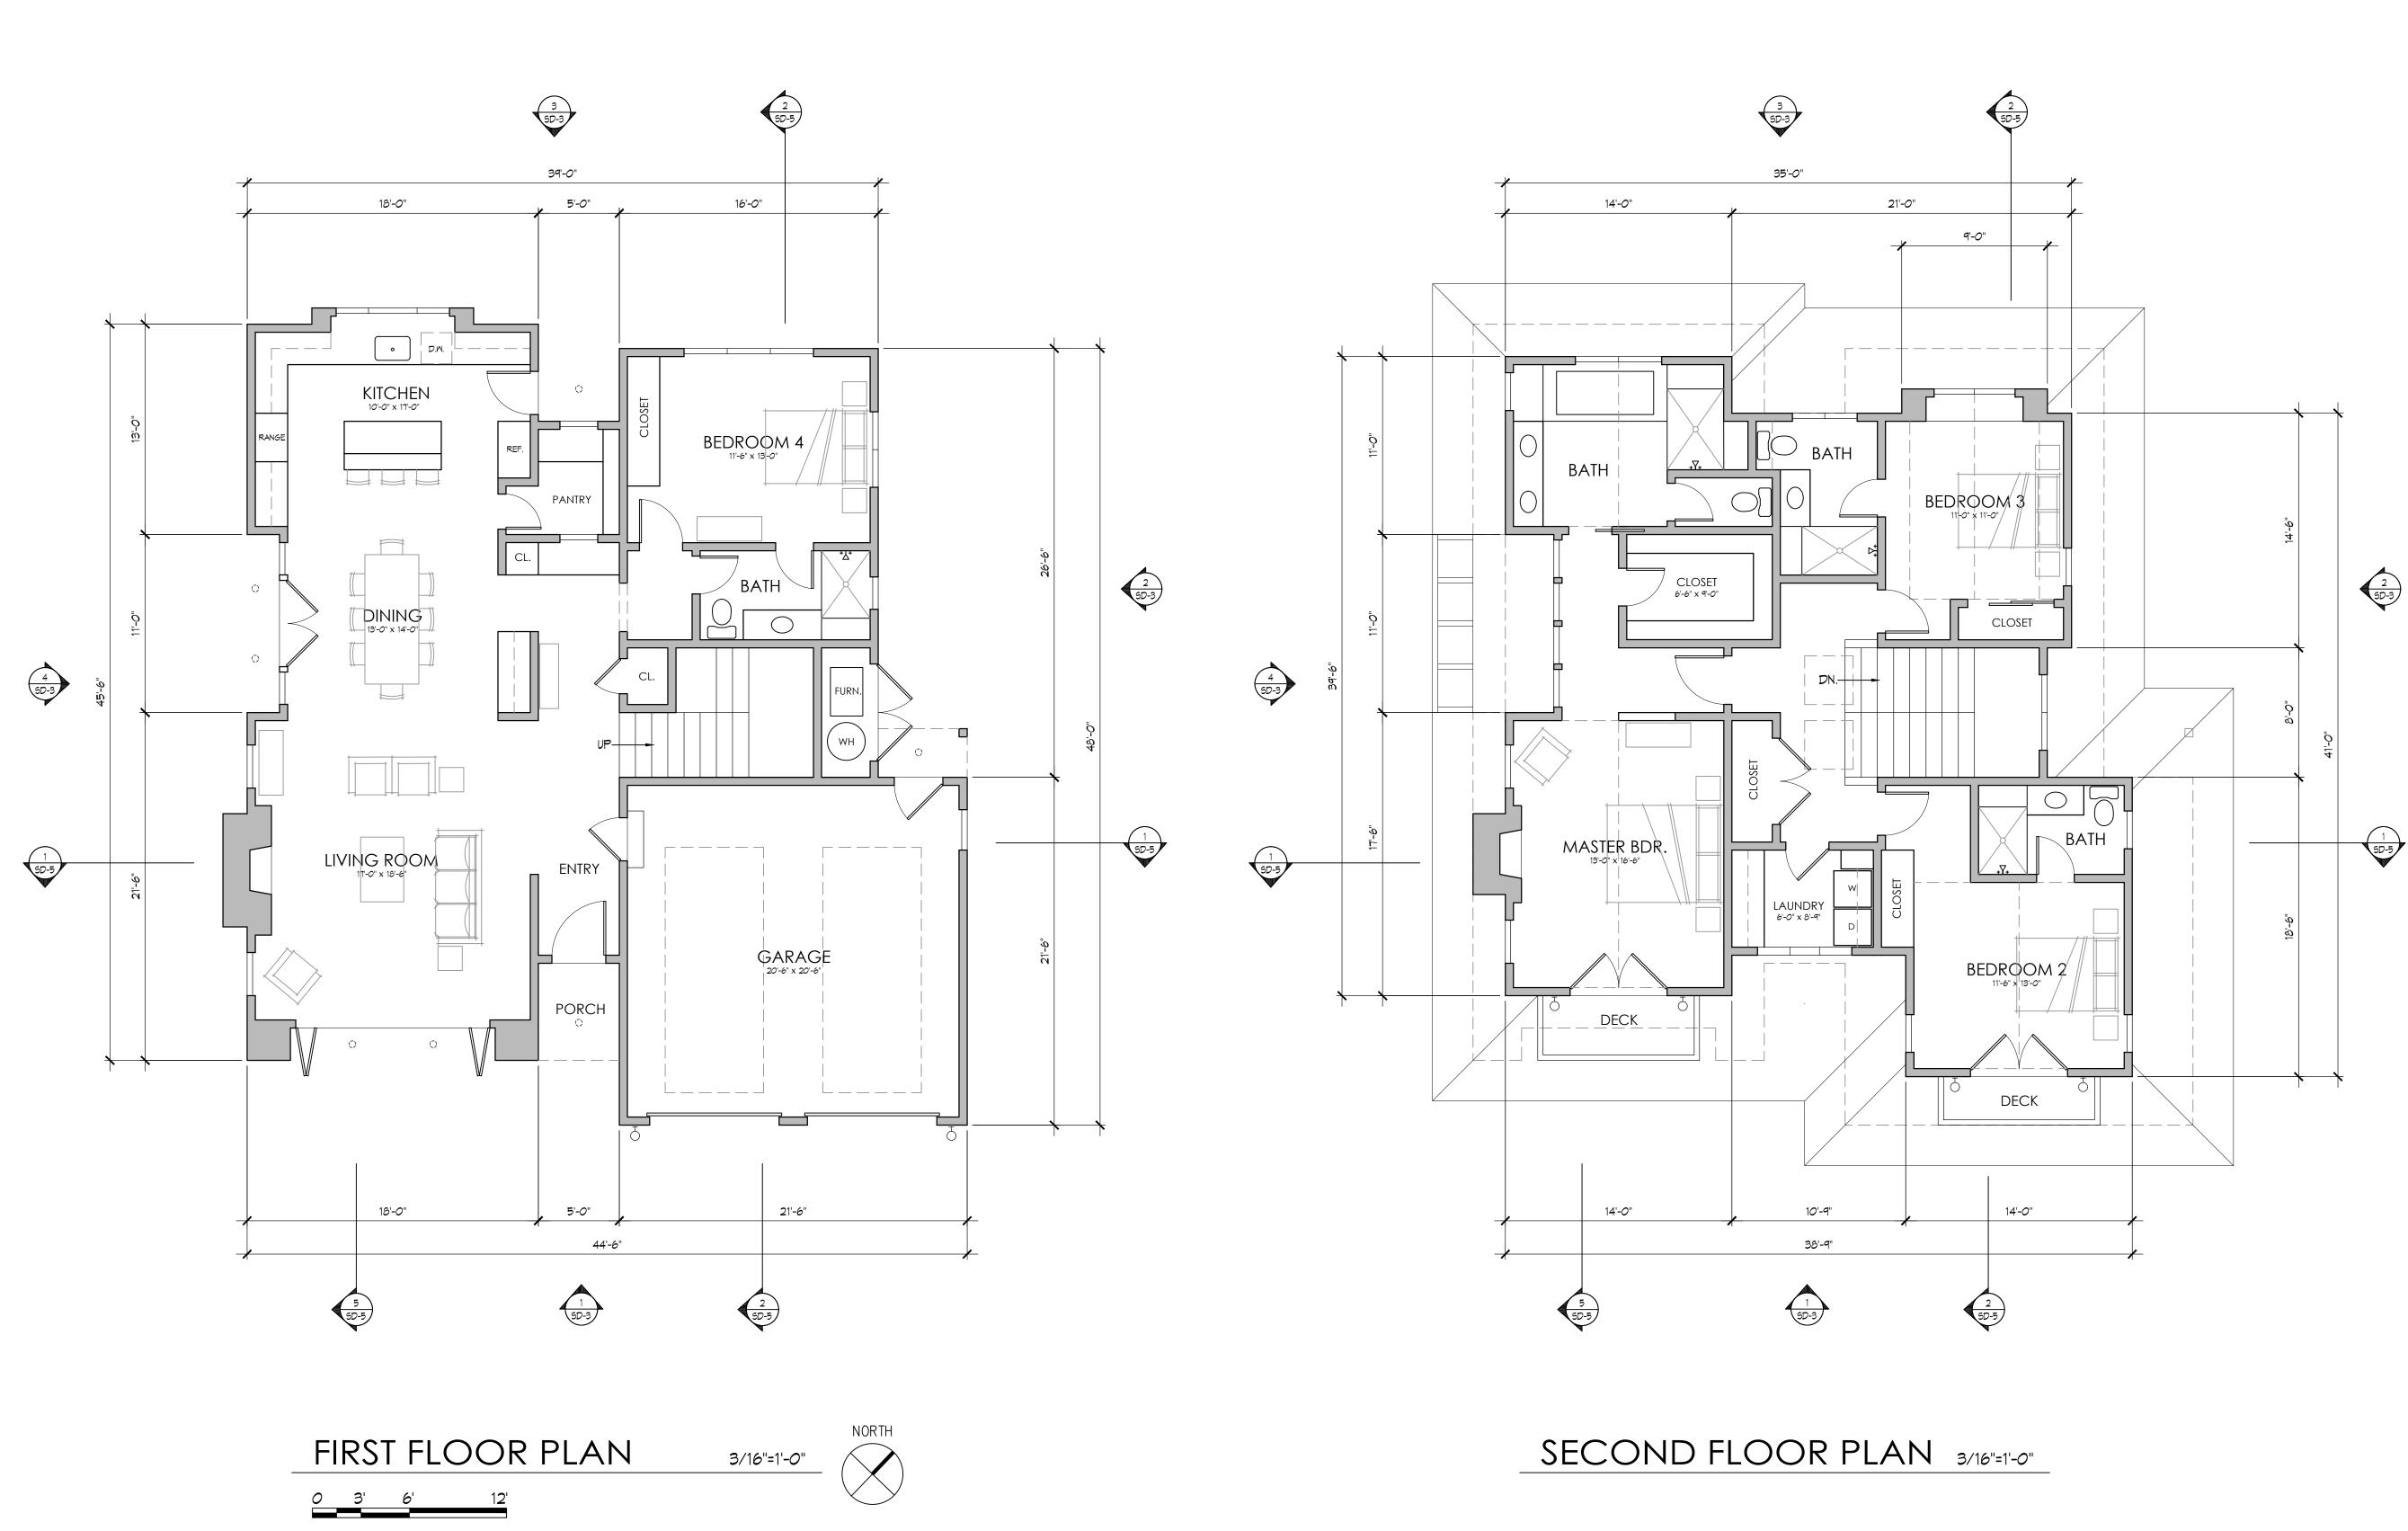


# EXTERIOR LIGHT FIXTURES

WALL MOUNTED EXTERIOR LIGHT FIXTURE DARK SKY DOWNLIGHT (SEE ELEVS ON SD-3)

RECESSED EXTERIOR SOFFIT LIGHT FIXTURE LED DOWNLIGHT


Kellond Architects         14510 Big Basin Way, #205         Saratoga, California 95070         408.741.0600 ph.         408.741.0610 fax         www.kellondarchitects.com         ØAL DRAWINGS AND WRITTEN KATERIAL UWRUGUSSED WITHOUT THE WRITTEN CONSENT OF THE ARCHITECT         PROJECT         PROJECT         APN: 048-013-790 Cortez Ave. Half Moon Bay, CA 9401         SHEET TITLE         FLOOR PLANS         REVISIONS         Notes         Interval         Inter			
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Saratoga, California 95070         408.741.0600 ph.         408.741.0610 fax         www.kellondarchitects.com         SAL DRAWINGS AND WRITTEN MATERIAL         HEREIN CONSTITUTE THE ORIGINAL AND         UNPUBLISHEW WORK OF THE ARCHTECT,         WINNOT BE DUPLICATED, USED, OR         DSCICESE WORK OF THE ARCHTECT,         WINNOT BE DUPLICATED, USED, OR         DSCICESE WORK OF THE ARCHTECT,         PROJECT         New Residence         APN: 048-013-790         Cortez Ave.         Half Mooon Bay, CA 94017         SHEET TITLE         FLOOR PLANS         REVISIONS         No.       Date         Notes         I       I         I       I         Half Moon Bay, CA 94017	Ke	lond A	Architects
408.741.0610 fax         www.kellondarchitects.com         ©ALL DRAWINGS AND WRITEIN MATERIAL HEREIN CONSTITUTE THE ORIGINAL AND UNPUBLISHED WORK OF THE ARCHITECT, WHICH MAY NOT BE DUPICATED, USED, OR DISCLOSED WITHOUT THE WRITTEIN CONSENT OF THE ARCHITECT.         PROJECT         PROJECT         SHEET TITLE         SHEET TITLE         FLOOR PLANS         No.       Date         Notes       Date         NO.       Date         NO.       Date         NO.       Date         NO.       Date			
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	DATE	: NOV 202	21



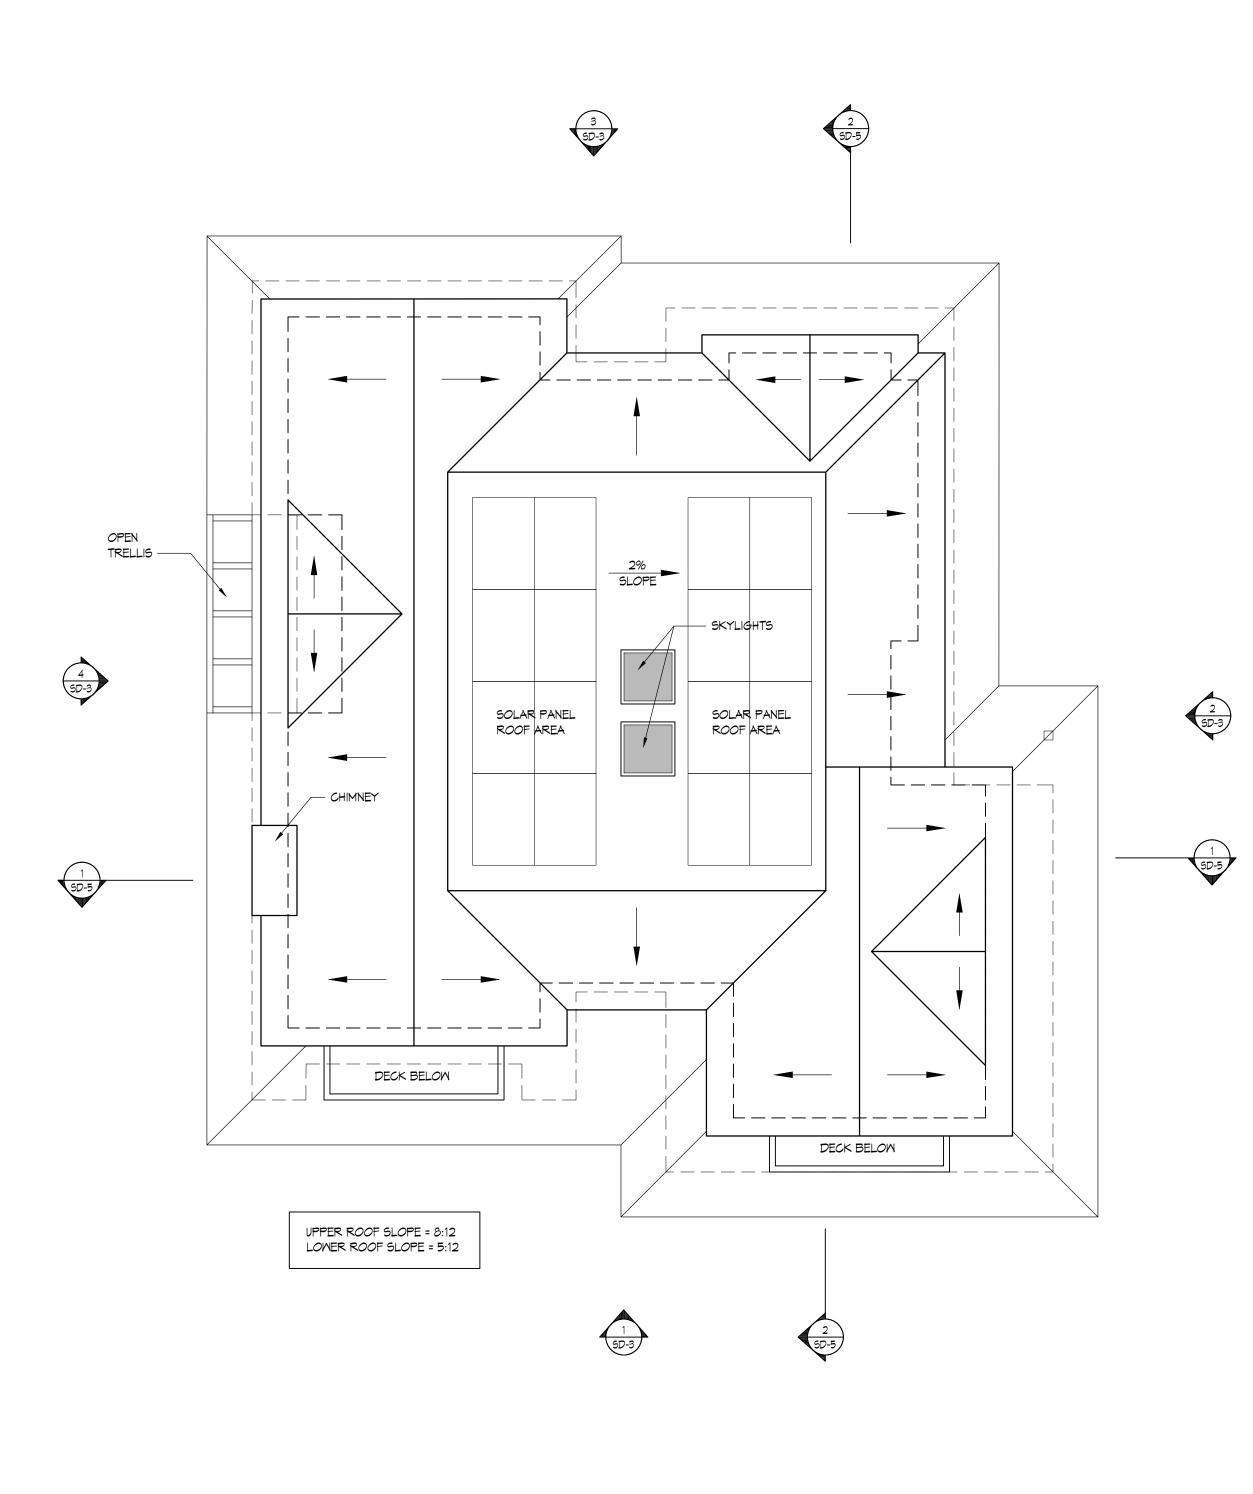

ROOF PLAN 0 3' 6' 12'

3/16"=1'-0"

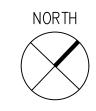

# Kellond Architects

14510 Big Basin Way, #205 Saratoga, California 95070

408.741.0600 ph. 408.741.0610 fax

www.kellondarchitects.com

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PROJECT

# New Residence


APN: 048-013-790 Cortez Ave. Half Moon Bay, CA 94019

SHEET TITLE

ROOF PLAN

## REVISIONS

No.	Date	Notes		
PROJ	IECT #:	2020.09		
DATE	DATE: APRIL 2021			
SHEE	Г #:	SD-2.2		

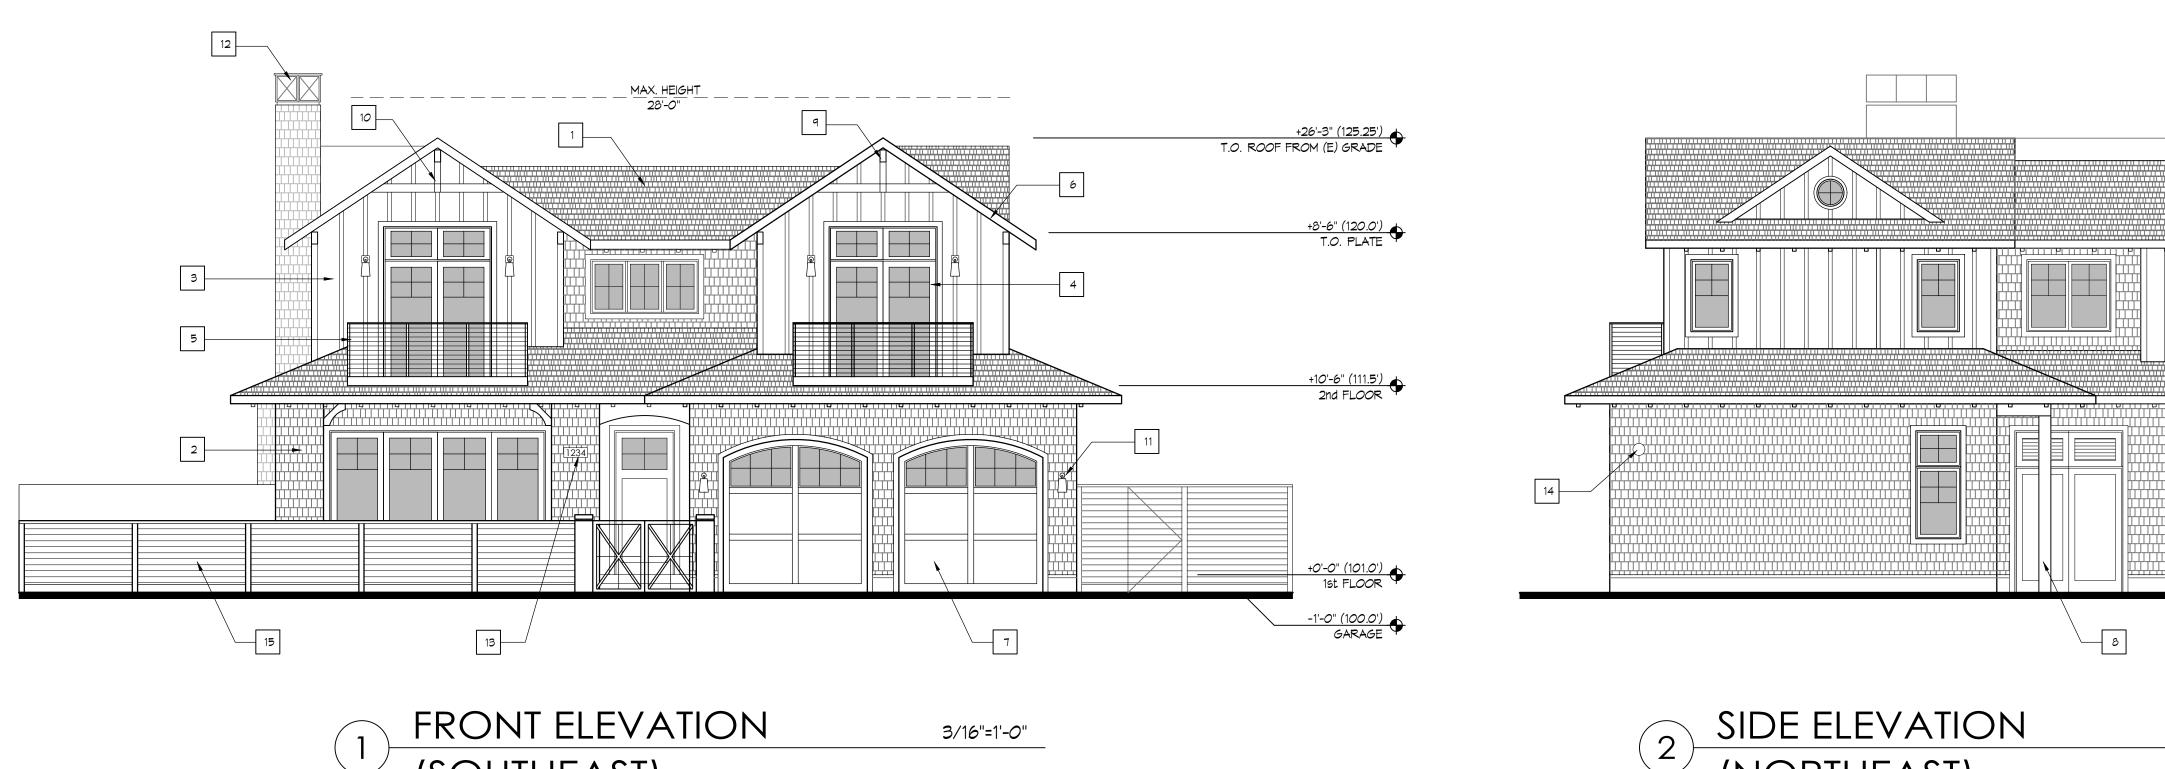







3/16"=1'-0"






(NORTHEAST)

# KEYNOTES

- COMPOSITION SHINGLE ROOF CERTAINTEED LANDMARK TL, 'THUNDERSTORM GRAY'
- 2 WOOD SHINGLE SIDING W/ STAINED FINISH CABOT STAIN - 'MULBERRY'
- 3 BOARD & BATTEN WOOD SIDING W/ PAINTED FINISH BENJAMIN MOORE, 'WHITE', TO MATCH DOORS/WINDOWS
- 4 WOOD DOORS & WINDOWS W/ METAL CLADDING ANDERSEN (OR EQUAL) WITH 'WHITE' FINISH
- 5 METAL RAILING @ DECK

- 6 TRIM, FASCIA & EAVES W/ PAINTED FINISH BENJAMIN MOORE, 'WHITE', TO MATCH DOORS/WINDOWS
- Image: The second se
- 8 PORCH POST, PAINTED TO MATCH TRIM
- 9 DECORATIVE OUTRIGGER, PAINTED TO MATCH TRIM
- 10 WOOD BRACKET, PAINTED TO MATCH TRIM

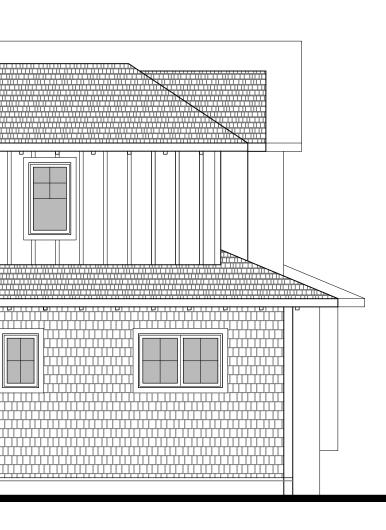

3/16"=1'-0"

3/16"=1'-0"

FINISH<br/>H DOORS/WINDOWS11WALL MOUNTED 'DARK SKY' LIGHT FIXTUREDOOR WITH PAINTED FINISH<br/>H DOORS/WINDOWS12DECORATIVE METAL CHIMNEY CAP<br/>PAINT TO MATCH TRIMTRIM13ILLUMINATED ADDRESS NUMBERSTO MATCH TRIM14PROPOSED FIRE BELL LOCATIONTH TRIM15WOOD FENCE W/ WHITE PAINTED FINISH

# Kellond Architects

14510 Big Basin Way, #205 Saratoga, California 95070

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PROJECT

# New Residence


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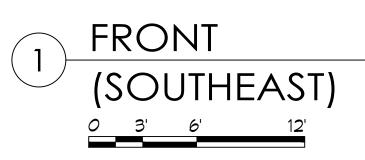
SHEET TITLE

ELEVATIONS


# REVISIONS

No.	Date	Notes
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DATE	: APRIL 20	21
SHEET	Γ#:	SD-3



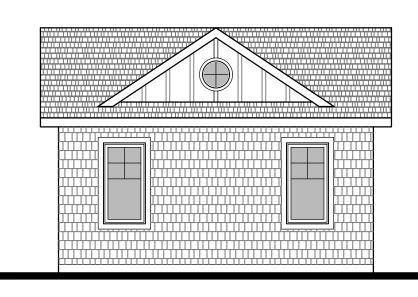


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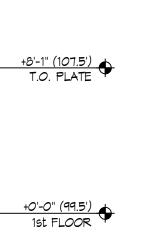
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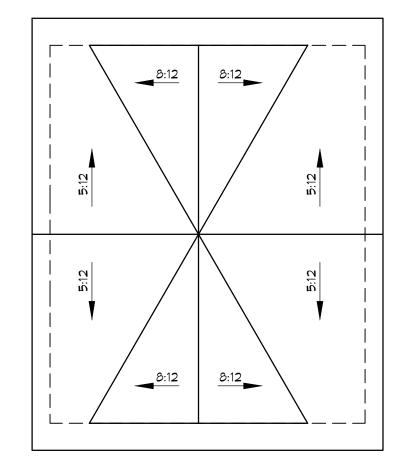
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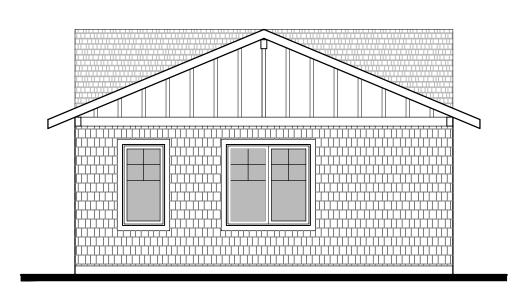


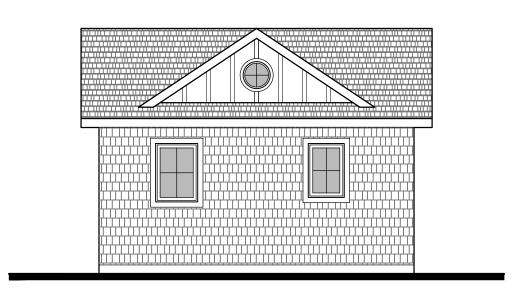3/16"=1'-0"






ROOF PLAN

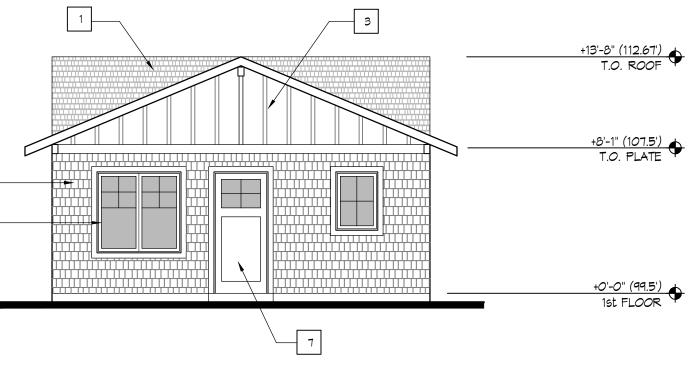



3/16"=1'-0"

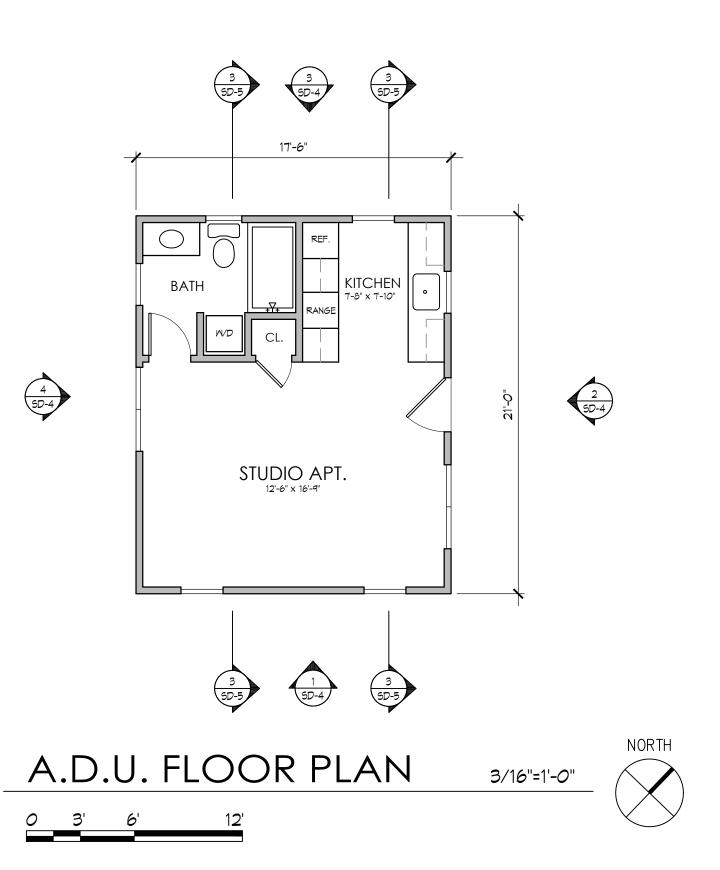

# KEYNOTES

 
 COMPOSITION SHINGLE ROOF

 1
 CERTAINTEED LANDMARK TL, 'THUNDERSTORM GRAY'
 2 WOOD SHINGLE SIDING W/ STAINED FINISH CABOT STAIN - 'MULBERRY'

3 BOARD & BATTEN WOOD SIDING W/ PAINTED FINISH BENJAMIN MOORE, 'WHITE', TO MATCH DOORS/WINDOWS

4 WOOD DOORS & WINDOWS W/ METAL CLADDING ANDERSEN (OR EQUAL) WITH 'WHITE' FINISH

5 METAL RAILING @ DECK

6	TRIM, FASCIA & EAVES W/ PAINTED FINISH BENJAMIN MOORE, 'WHITE', TO MATCH DOORS/WIN
٦	EXTERIOR WOOD DOOR / GARAGE DOOR WITH P; BENJAMIN MOORE, 'WHITE', TO MATCH DOORS/WIN
8	FRONT PORCH POST, PAINTED TO MATCH TRIM

9 DECORATIVE OUTRIGGER, PAINTED TO MATCH TRIM

10 WOOD BRACKET, PAINTED TO MATCH TRIM

3/16"=1'-0"

ED FINISH ATCH DOORS/WINDOWS GE DOOR WITH PAINTED FINISH ATCH DOORS/WINDOWS

11 WALL MOUNTED 'DARK SKY' LIGHT FIXTURE

 DECORATIVE METAL CHIMNEY CAP

 12
 PAINT TO MATCH TRIM

13 ILLUMINATED ADDRESS NUMBERS

14 PROPOSED FIRE BELL LOCATION

# Kellond Architects

14510 Big Basin Way, #205 Saratoga, California 95070

408.741.0600 ph. 408.741.0610 fax

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PROJECT


# New Residence


APN: 048-013-790 Cortez Ave. Half Moon Bay, CA 94019


SHEET TITLE

A.D.U. PLANS & ELEVATIONS

REVISIONS				
No.	Date	Notes		
PROJECT #: 2020.09				
DATE	DATE: APRIL 2021			
SHEET #: SD-4				

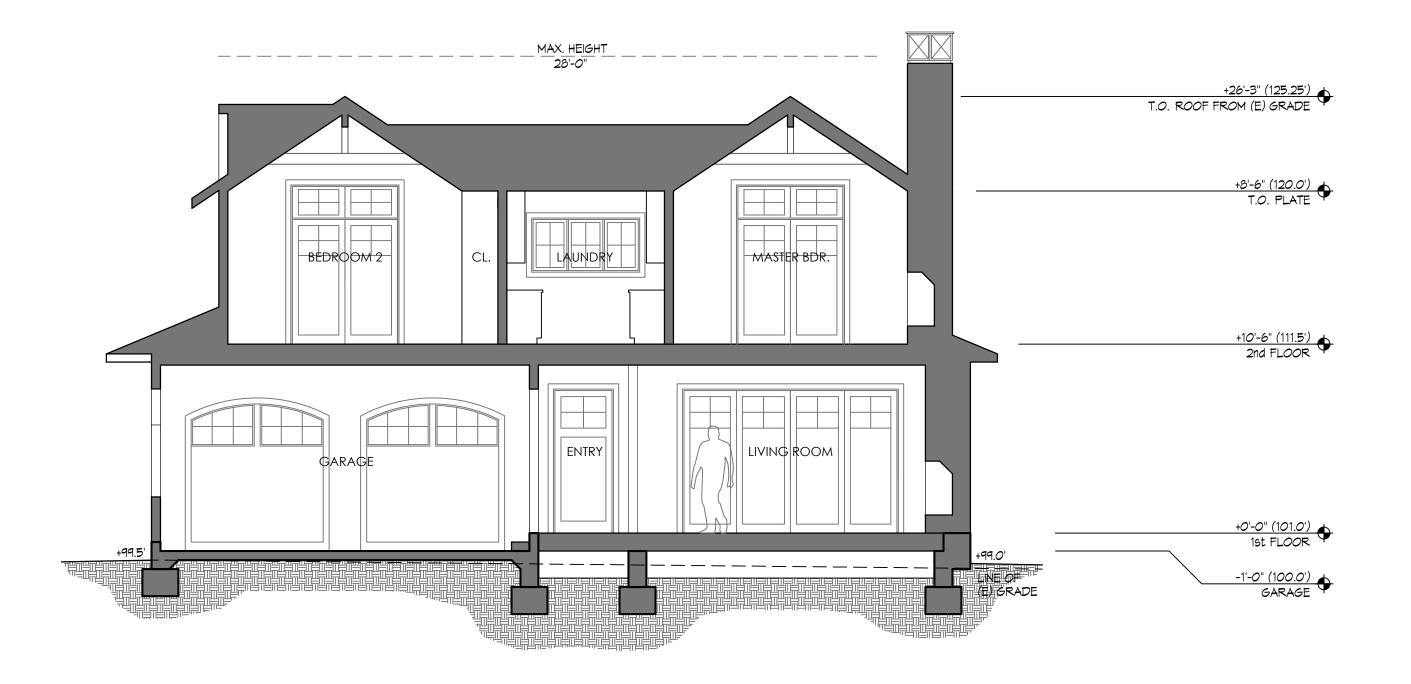

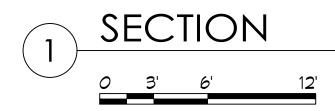

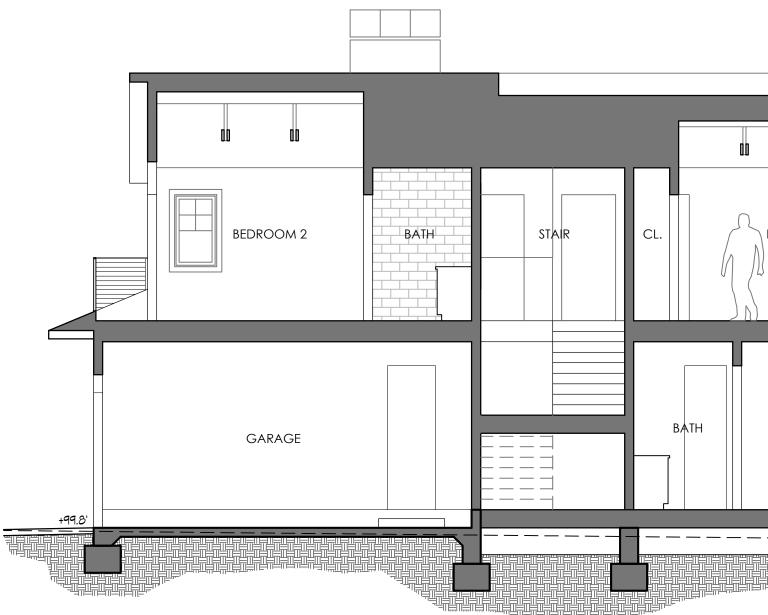



2 SECTION

3/16"=1'-0"

+26'-0" (125.3') T.O. ROOF FROM (E) GRADE +8'-6" (120.0') T.O. PLATE ) bedroom 3 +10'-6" (111.5') 2nd FLOOR BEDROOM 4 +0'-0" (101.0') 1st FLOOR +99.B' · — — — — — — — — — — . -1'-0" (100.0') GARAGE 🔶


3/16"=1'-0"

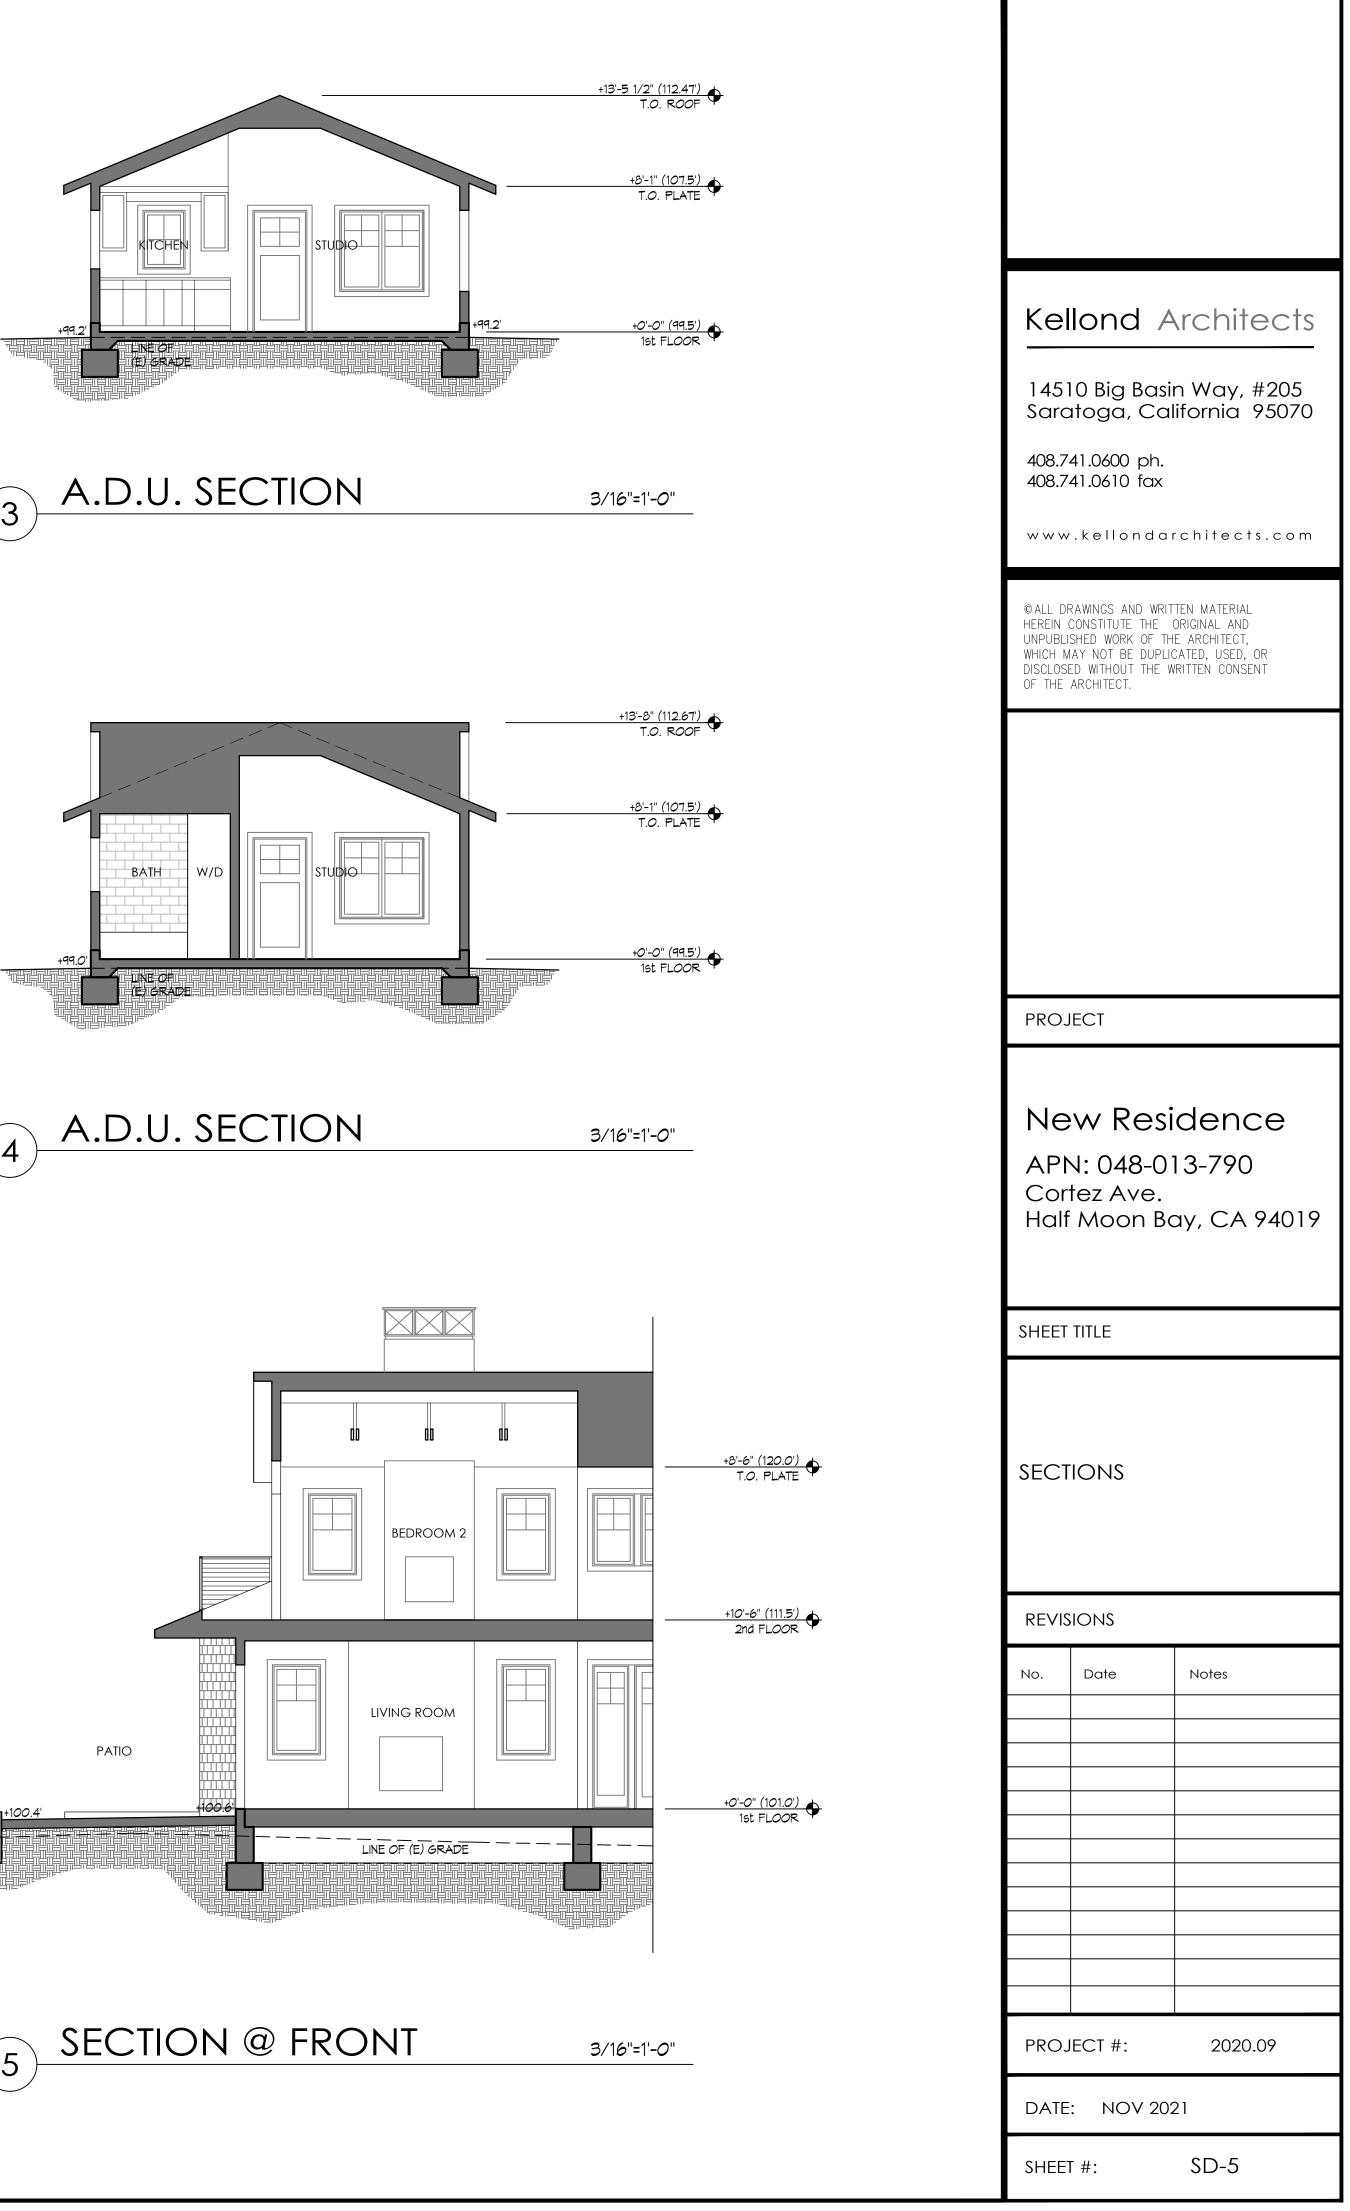

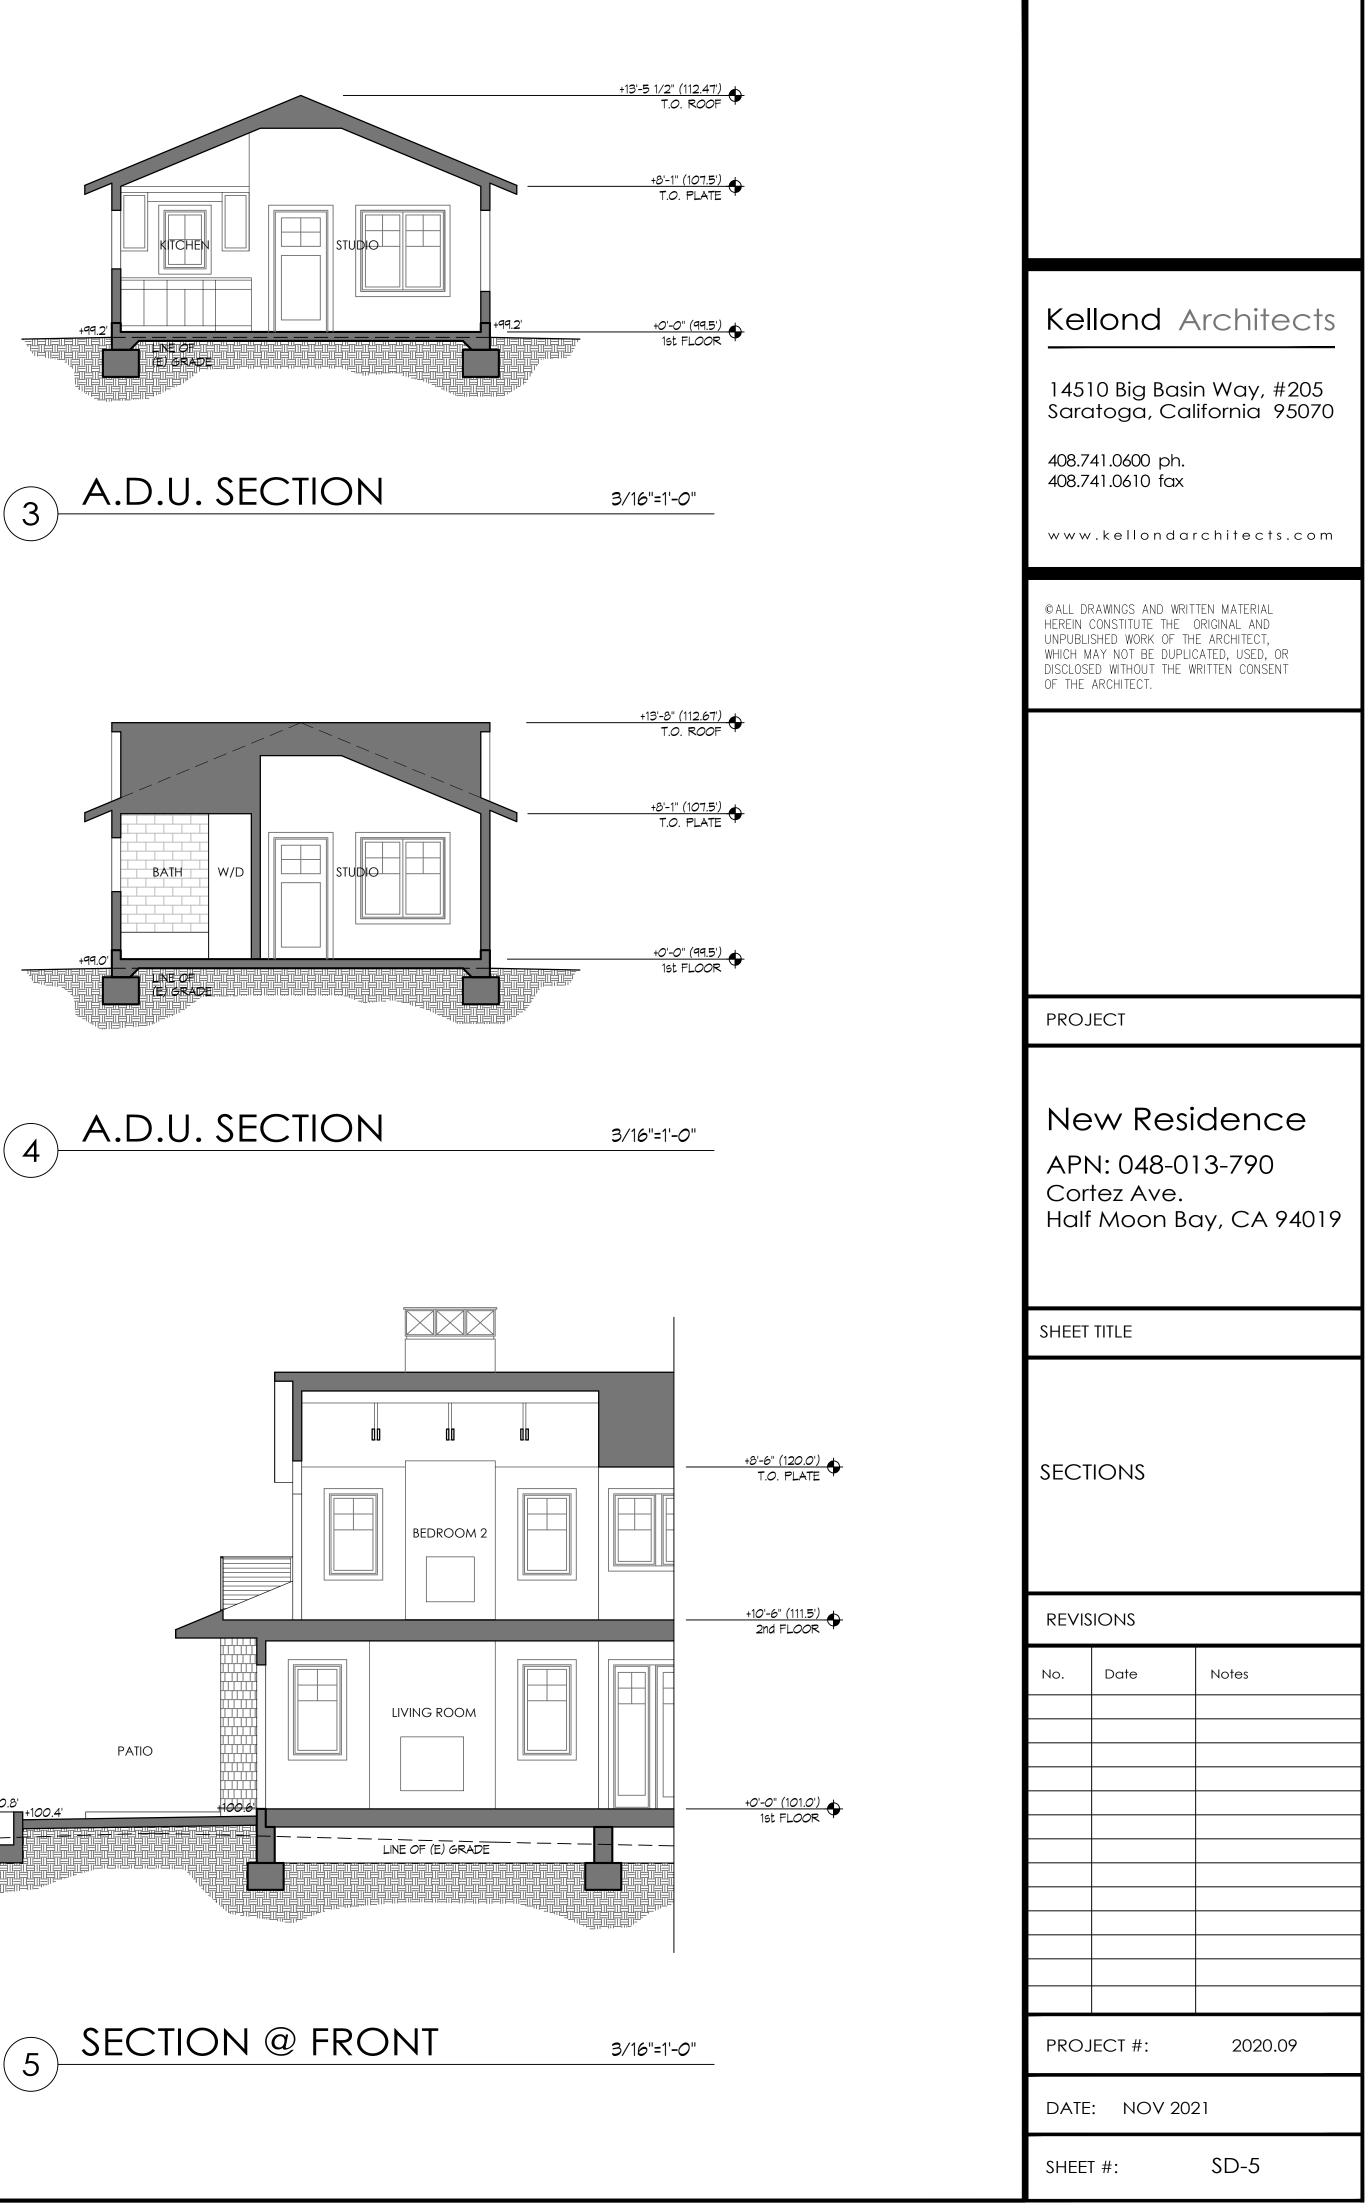





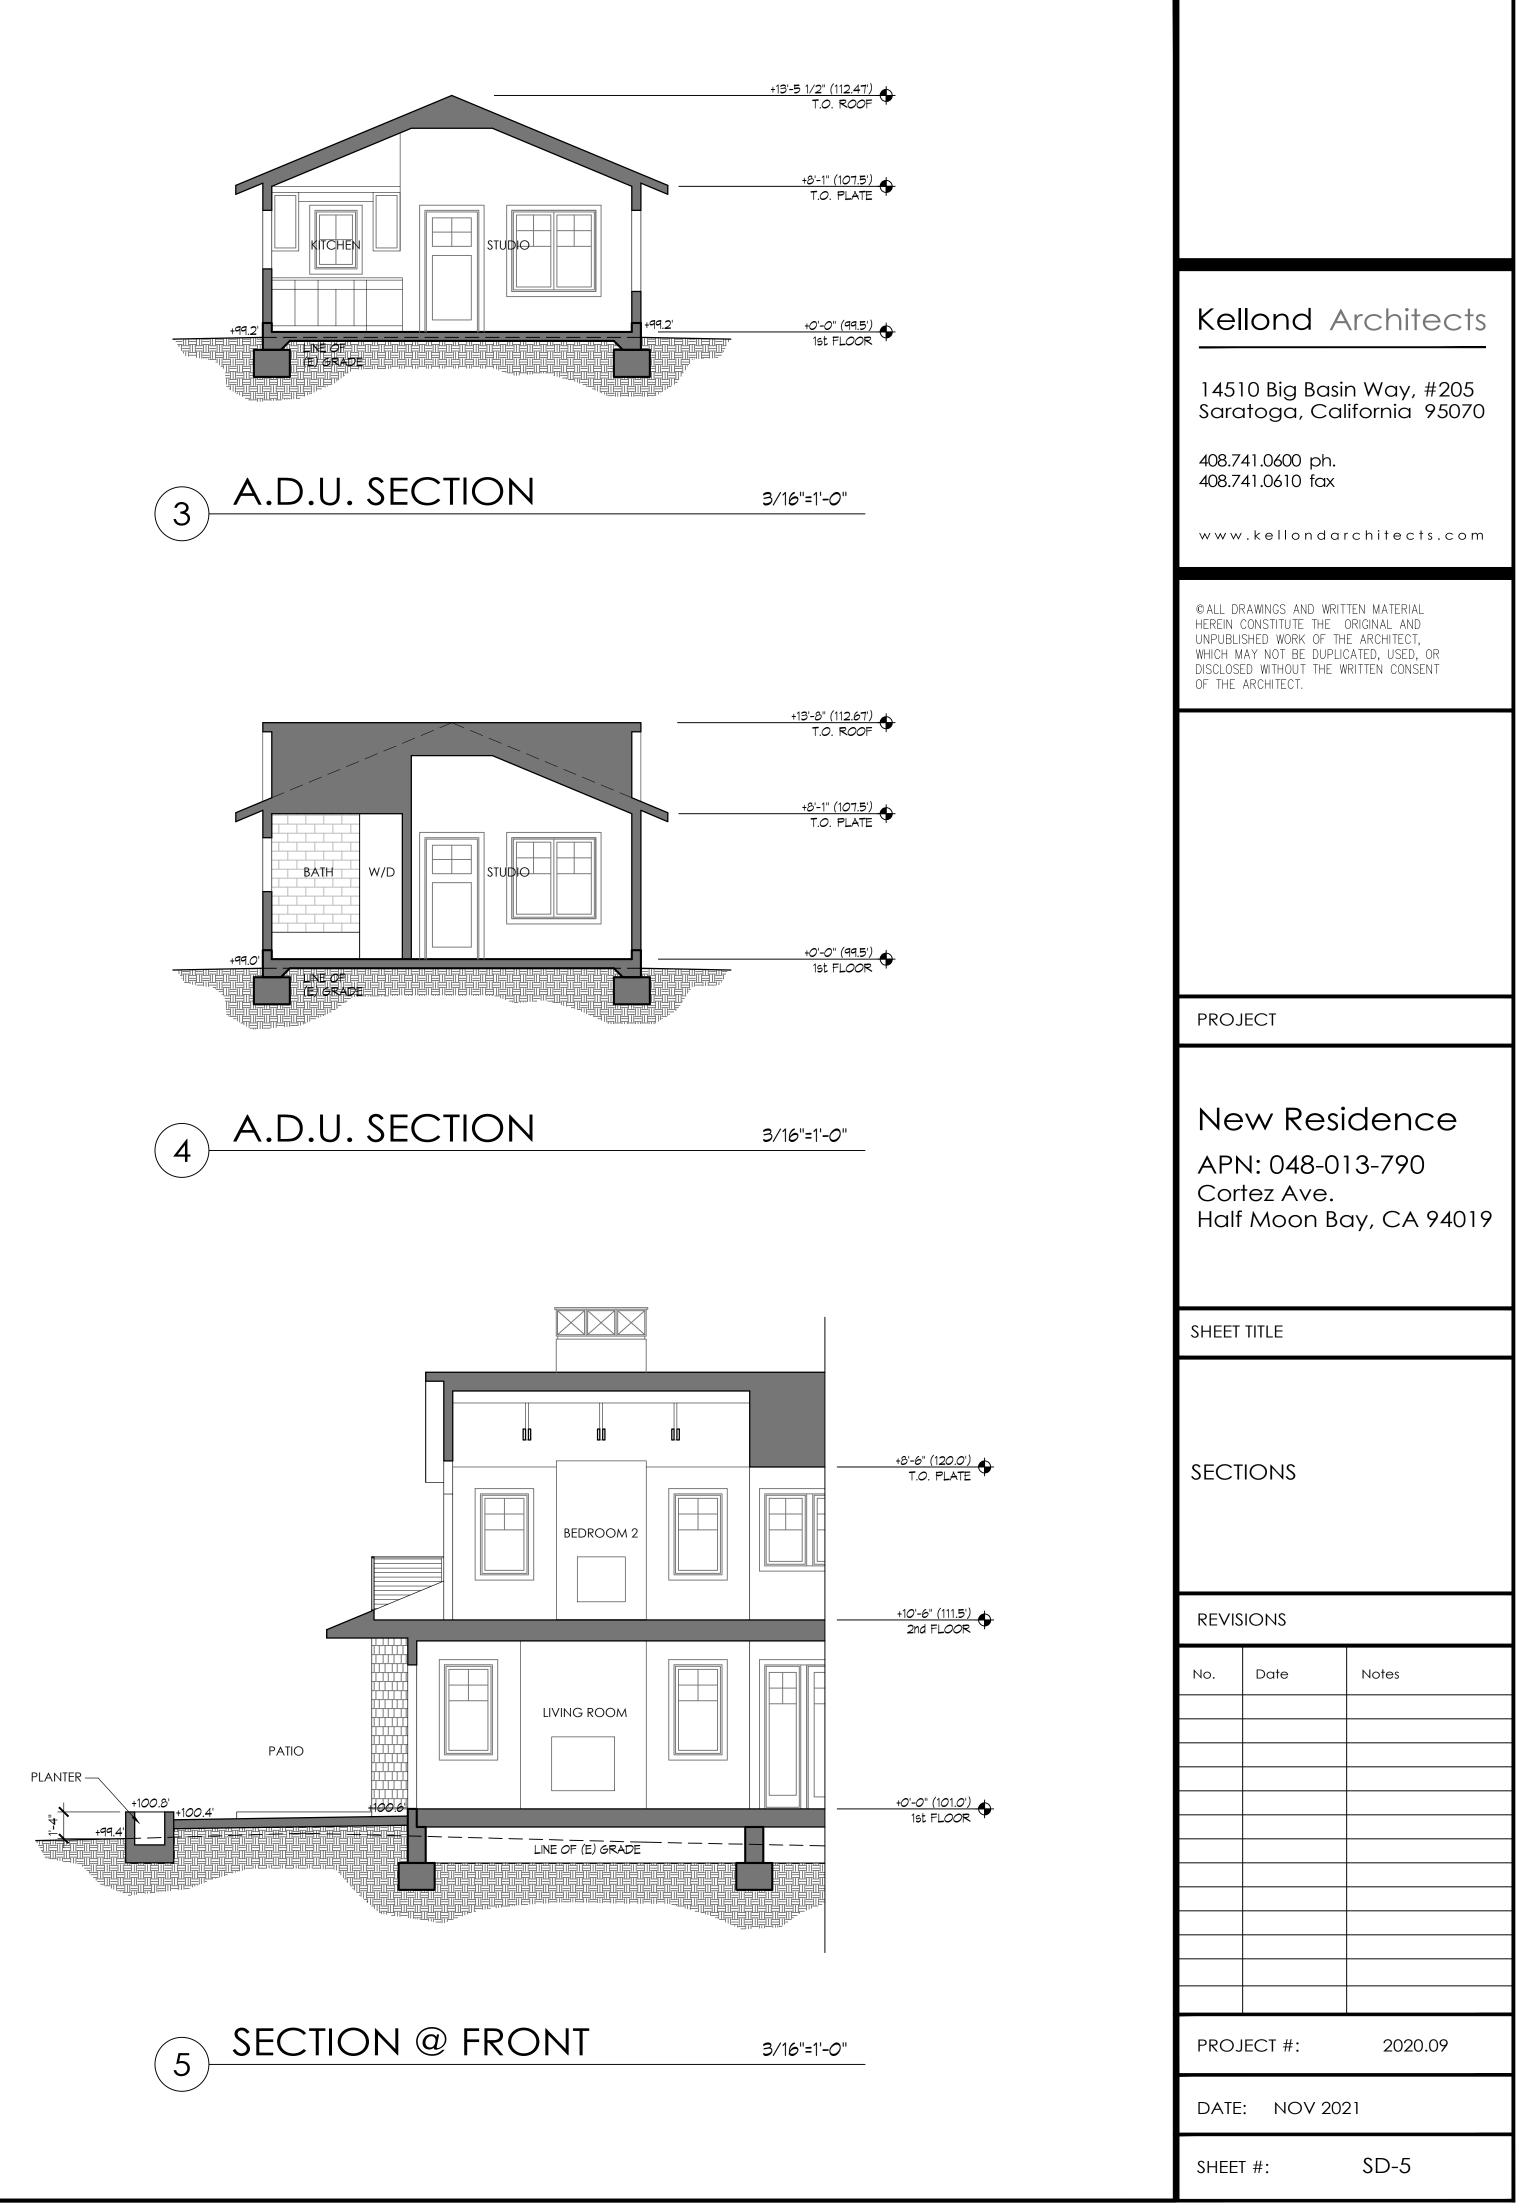

#### PROPOSED COVERAGE

MAIN HOUSE	1,866 \$
A.D.U.	367 S
TOTAL	2,233 \$

### ALLOWABLE COVERAGE

TOTAL 2,233.8 S.F.

### COVERAGE CALCS

$\left(1\right)$	18 S.F.	
2	16 S.F.	

TOTAL PORCHES = 34 S.F.

HOUSE FOOTPRINT = 1,832 S.F.

MAIN HOUSE TOTAL = 1,866 S.F.

# 5 S.F. S.F. \_\_\_\_\_ 3 S.F.

# PROPOSED FLOOR AREA

MAIN HOUSE	3,093 S.F.
A.D.U.	367 S.F.
TOTAL	3,460 S.F.

# ALLOWABLE FLOOR AREA

TOTAL 3,574 S.F.

# FLOOR AREA CALCS


- SECOND FLOOR A 525 S.F. B 304 S.F. © 55 S.F.
- D 118 S.F.
- E 259 S.F.
- TOTAL = 1,261 S.F.

# FIRST FLOOR


- A 749 S.F.
  B 167 S.F.
  C 424 S.F.
  D 462 S.F.

- E 30 S.F.
- TOTAL = 1,832 S.F.

# MAIN HOUSE TOTAL = 3,093 S.F.

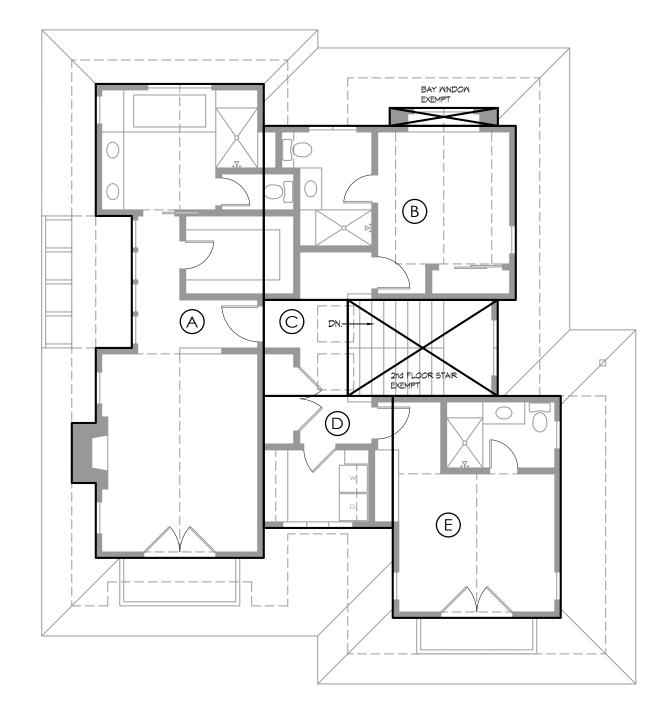


# SECOND FLOOR PLAN 1/8"=1'-0"

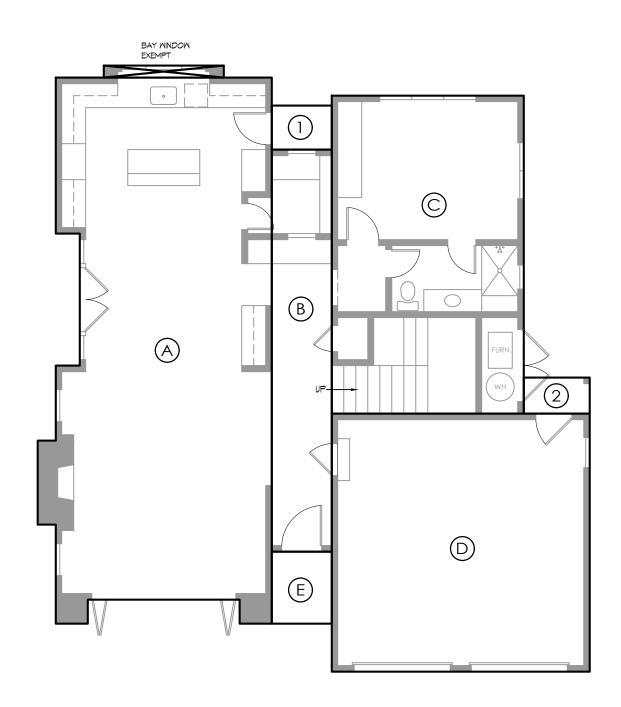



# Kellond Architects 14510 Big Basin Way, #205 Saratoga, California 95070 408.741.0600 ph. 408.741.0610 fax www.kellondarchitects.com ©ALL DRAWINGS AND WRITTEN MATERIAL HEREIN CONSTITUTE THE ORIGINAL AND UNPUBLISHED WORK OF THE ARCHITECT, WHICH MAY NOT BE DUPLICATED, USED, OR DISCLOSED WITHOUT THE WRITTEN CONSENT OF THE ARCHITECT. PROJECT New Residence APN: 048-013-790 Cortez Ave. Half Moon Bay, CA 94019 SHEET TITLE FLOOR AREA & COVERAGE REVISIONS Date Notes No. PROJECT #: 2020.09 DATE: NOV 2021 SD-6 SHEET #:

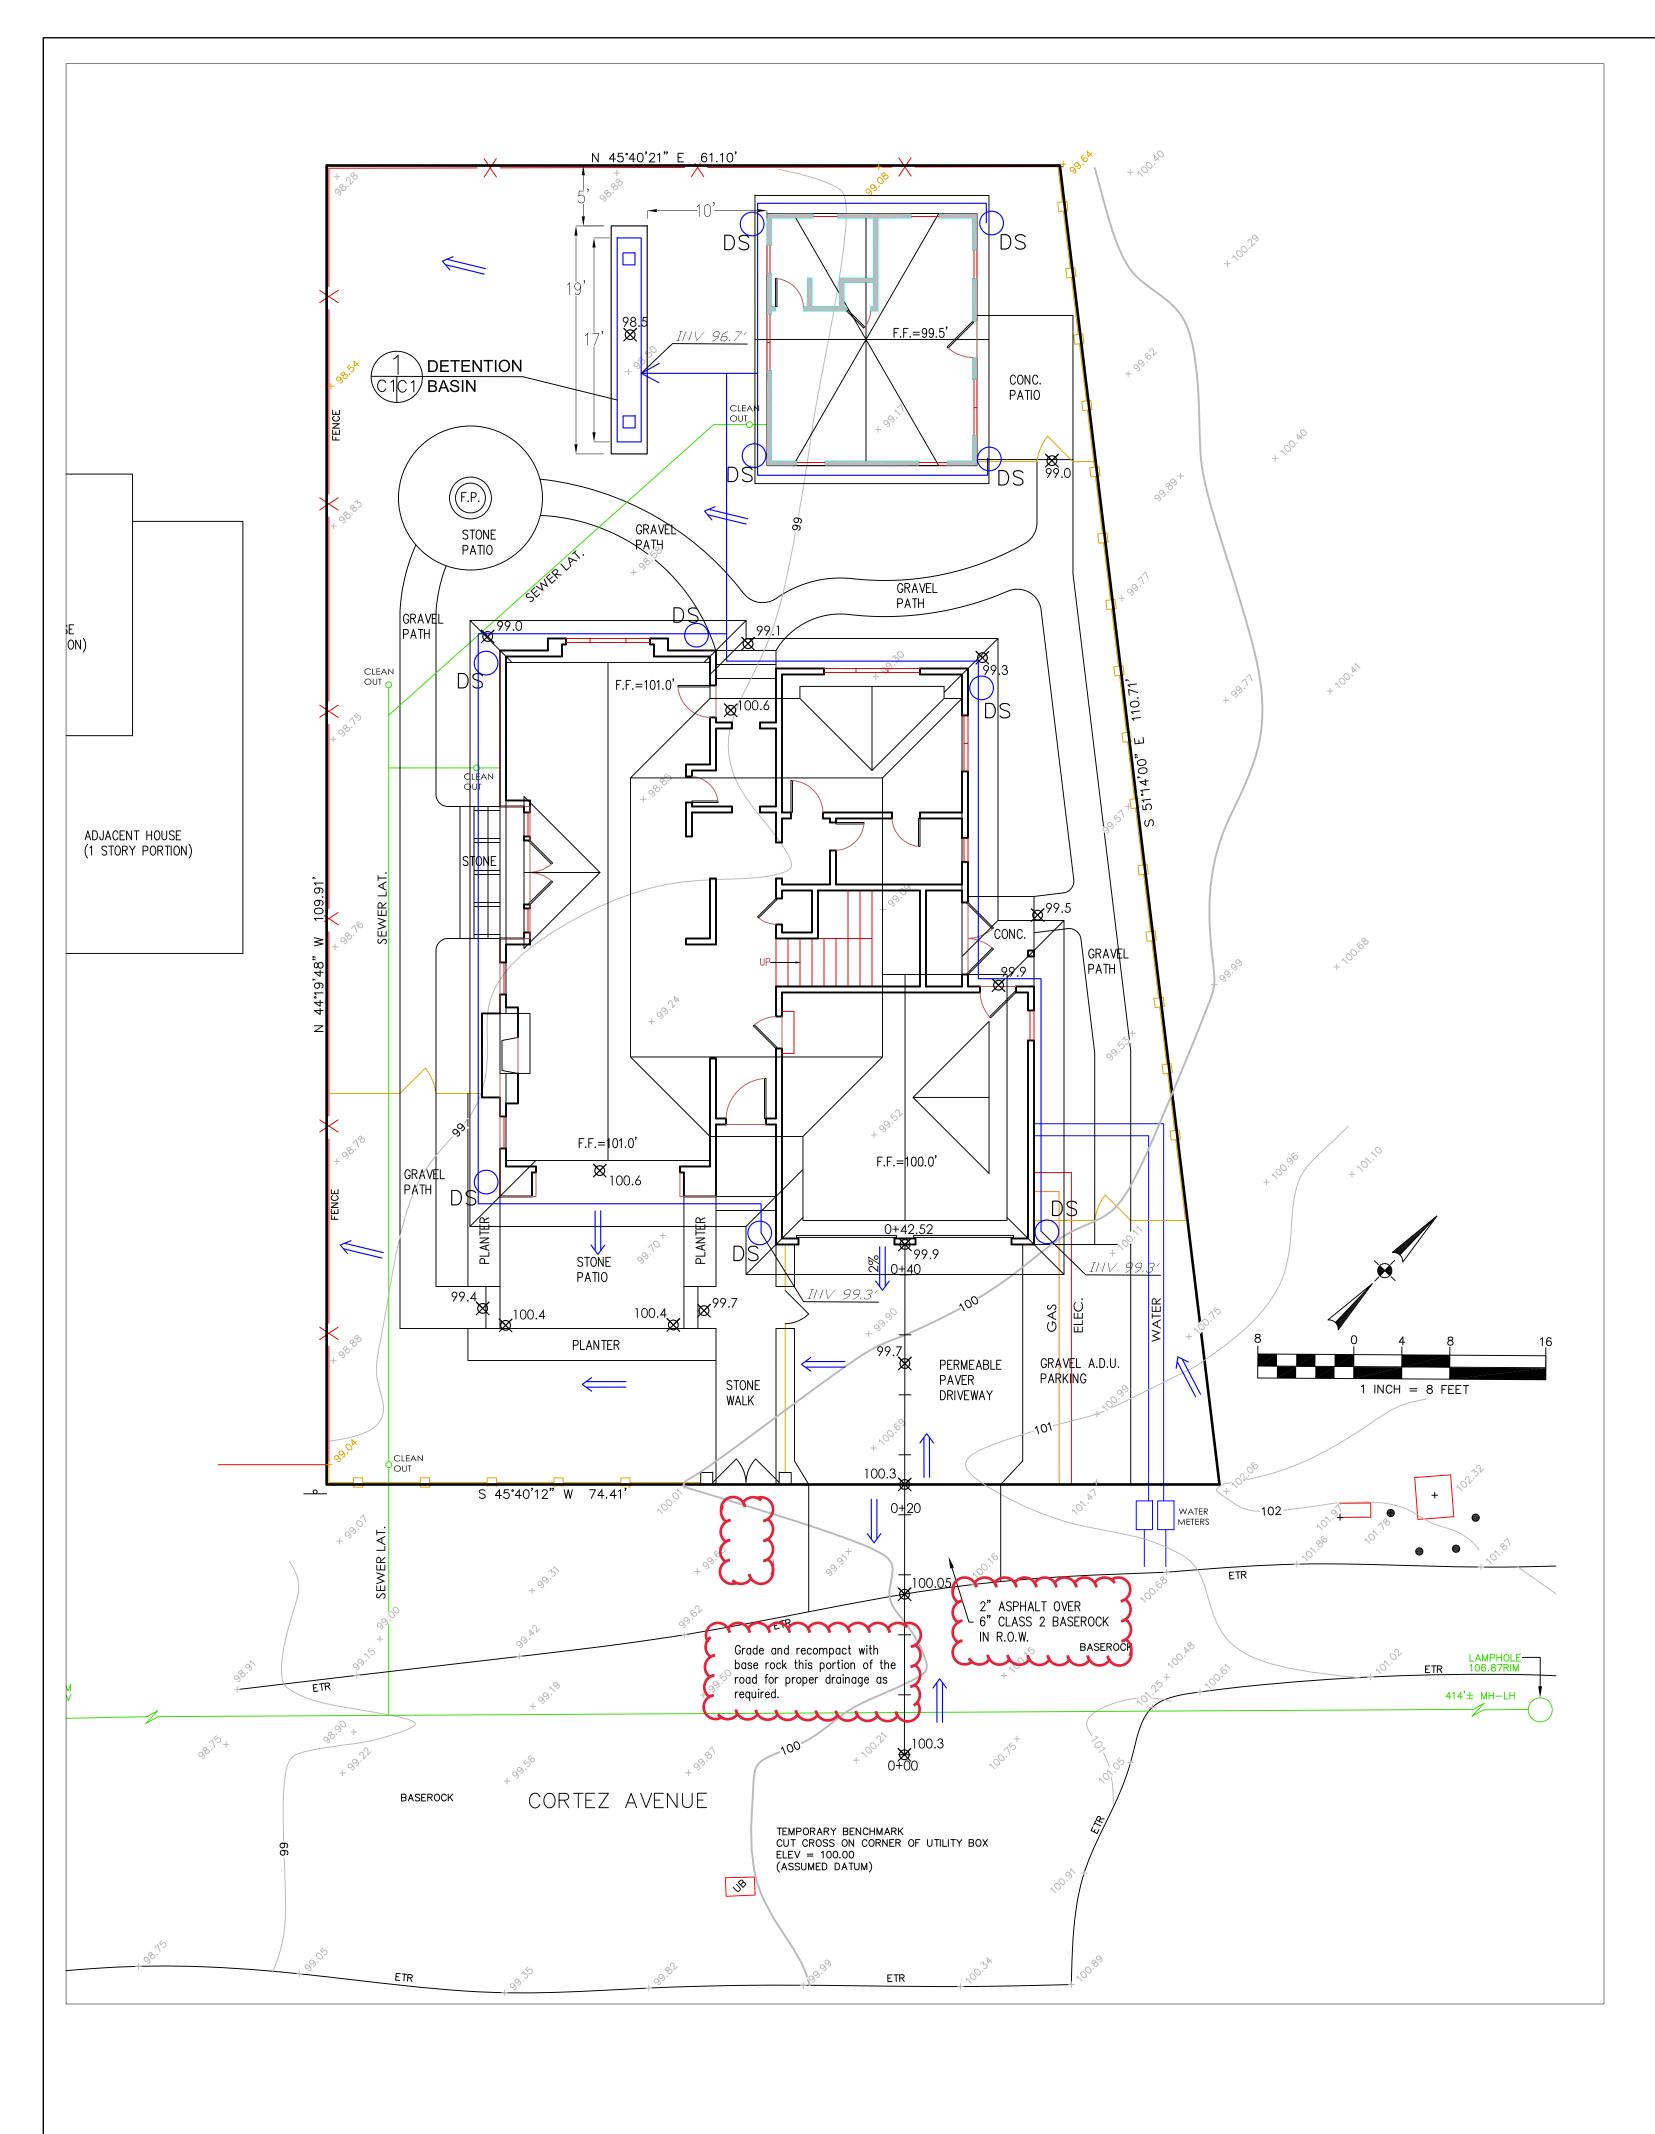


# LEGEND (E) CONTOUR ു<sup>ള്</sup> EXISTING SPOT ELEVATION X PROPOSED SPOT ELEVATION 99.9

# **GENERAL NOTES**

1. PLANS PREPARED AT THE REQUEST OF: BRUCE GEHRELS, OWNER 2. TOPOGRAPHY BY OTHERS, UNKNOWN DATE. 3. THIS IS NOT A BOUNDARY SURVEY. 4. ELEVATION DATUM ASSUMED. 5. THE GEOTECHNICAL REPORT: PENDING 

MAINTENANCE ACCESS 12"X12" COARSE SCREEN FILTER 24" DIAM. PERFORATED PIPES: SINGLE WALL CORRUGATED HDPE < L=17' EACH MIRAFI 140N FILTER FABRIC AT ROCK/SOIL INTERFACE DESIGN BASIS: 10-YEAR STORM EVENT WITH I HOUR DURATION ON HARD SURFACES. RAINFALL INTENSITY = 0.847 IN/HR DETENTION BASIN CICINOT TO SCALE

105	
,100.3' AT C/L	100.3' AT P/L
EDGE OF F	AVEMENT (E
800	2.7%
Engine	Lunn
GRADE (E)	
95 0+00	
	LE 1''=5'

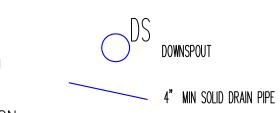

mmmmmm

6. STORMWATER MANAGEMENT CONSTRUCTION INSPECTIONS SHALL BE SCHEDULED FOR APPLICABLE DRAINAGE INSPECTIONS, WHICH INCLUDE SITE CLEARANCE AND EROSION CONTROL MEASURES INSTALLATION AS WELL AS INSPECTION OF MAJOR DRAINAGE CONTAINMENT, TREATMENT, AND CONVEYANCE DEVICES BEFORE BEING BURIED (INCLUDING REQUIRED MATERIAL LABELS, E.G. PIPES, SUB-GRADE MATERIALS, ETC.). PLEASE FOLLOW THE INSPECTION CARD INSTRUCTIONS AND CALL SIGMA PRIME (650-728-3590) TO SCHEDULE DRAINAGE INSPECTIONS ACCORDINGLY. THERE SHALL BE THREE INSPECTIONS: ONE FOR EROSION CONTROL INSTALLATION, ONE BEFORE DRAINAGE FACILITIES ARE BURIED, AND ONE

7. ALL WORK IN COUNTY RIGHT OF WAY MUST HAVE ENCROACHMENT PERMITS AND INSPECTIONS PRIOR TO BUILDING OCCUPANCY PERMIT.

# **GRADING NOTES**

CUT VOLUME : 40 CY (FOR FOUNDATION) FILL VOLUME: 0 CY

VOLUMES ABOVE ARE APPROXIMATE.

THE SUBGRADE BELOW ALL PAVED AREAS SHALL BE BASEROCK COMPACTED TO 95%.

ALL GRADING SHALL CONFORM TO LOCAL CODES AND ORDINANCES.

ALL TRENCHES UNDER PROPOSED PAVED AREAS OR CONCRETE SHALL BE BACKFILLED TO SUBGRADE ELEVATION WITH COMPACTED APPROVED GRANULAR MATERIALS, IF TRENCHES ARE IN PROPOSED LANDSCAPE AREAS, THEY SHALL BE BACKFILLED WITH COMPACTED APPROVED GRANULAR MATERIAL TO WITHIN ONE FOOT OF FINISHED GRADE, AND THEN FILLED WITH HAND TAMPED SOILS.

# DRAINAGE NOTES

1. DRAINAGE INTENT: IT IS THE INTENT OF THE DRAINAGE SYSTEM TO CONVEY ROOF RUNOFF TO A SAFE LOCATION, AND TO MINIMIZE EXCESSIVE MOISTURE AROUND FOUNDATIONS. SLOPE ALL IMPERVIOUS SURFACES A MINIMUM OF 2% AWAY FROM BUILDING. DIRECT SLOPES SUCH THAT STORMWATER WILL NOT BE DIVERTED ONTO ADJACENT PROPERTIES.


2. ALL DOWNSPOUT DRAIN LINES SHALL LEAD TO DETENTION BASIN, AS SHOWN.

3. ALL ROOF DRAINAGE PIPES SHALL BE 4" DIAMETER MINIMUM SOLID PIPE, SLOPED AT 1% MINIMUM.


4. INCREASED RUNOFF SHALL NOT BE ALLOWED TO CROSS TO NEIGHBORING PROPERTIES.


5. IT IS THE PROPERTY OWNER'S RESPONSIBILITY TO CHECK ON ALL STORMWATER FACILITIES SUCH AS ROOF GUTTERS, DOWNSPOUT LINES, AND THE DETENTION BASIN TO BE SURE THAT THEY ARE CLEAR OF EXCESSIVE DEBRIS AND OPERATING EFFICIENTLY. THE FACILITIES SHALL BE CHECKED EVERY FALL AND PERIODICALLY DURING THE RAINY SEASON.


## SECTION AND DETAIL CONVENTION

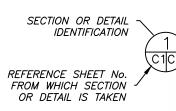



REFERENCE SHEET No. ON - WHICH SECTION OR DETAIL IS SHOWN

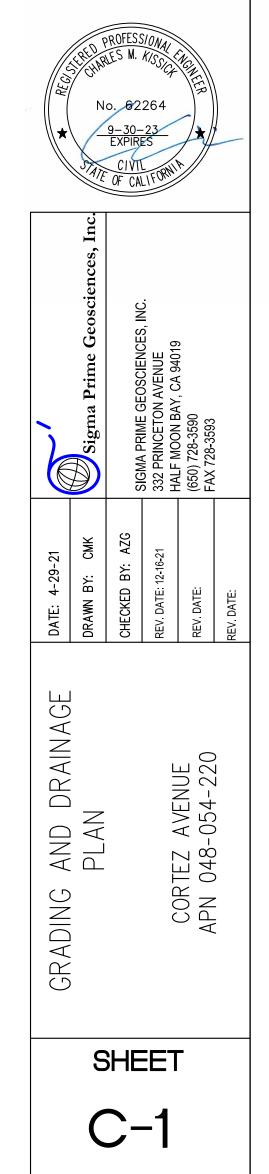


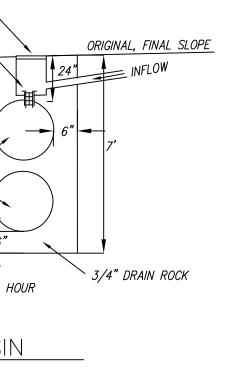

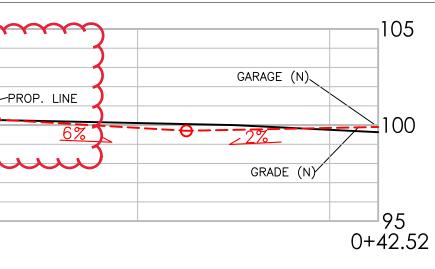

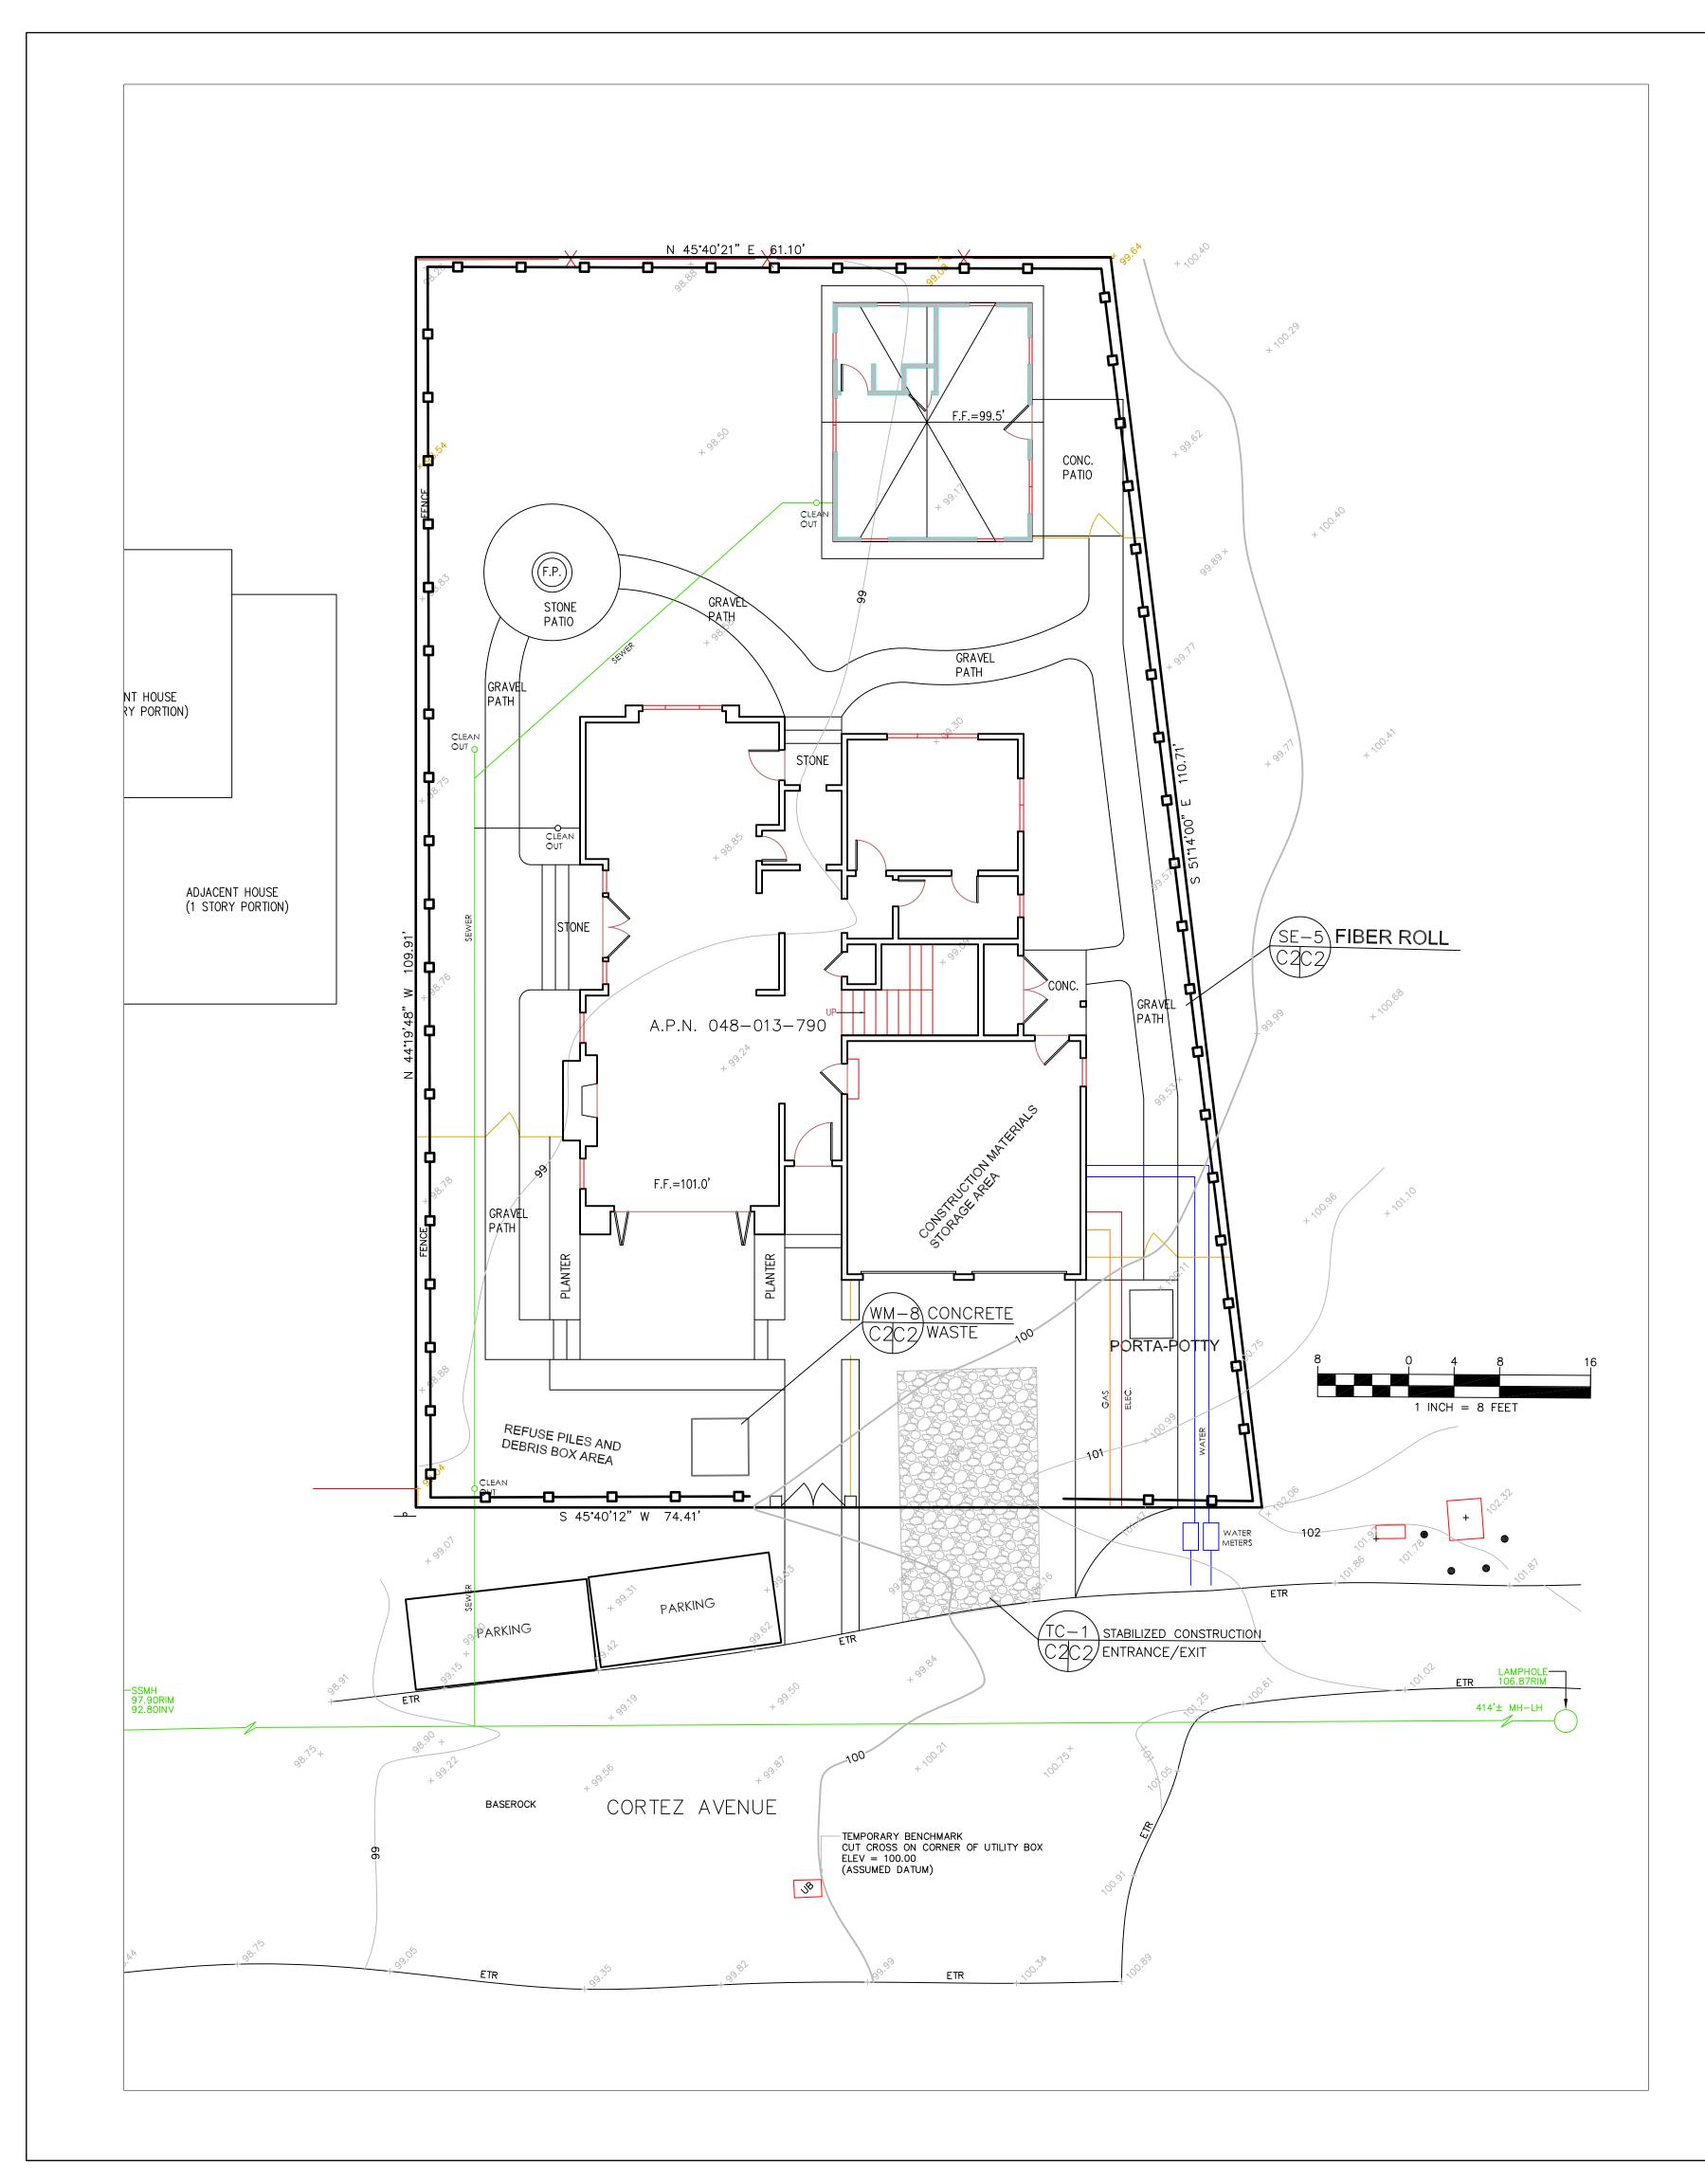

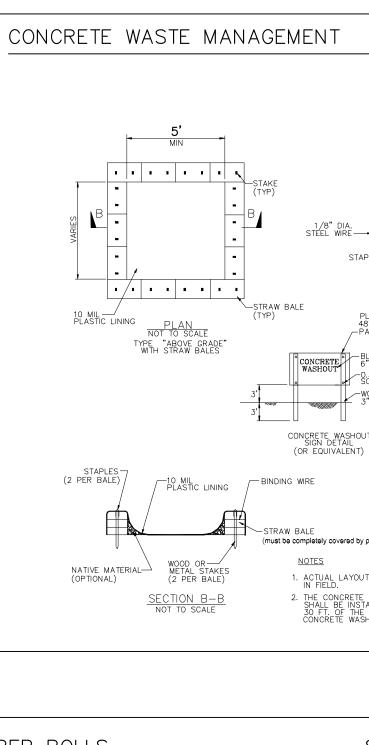

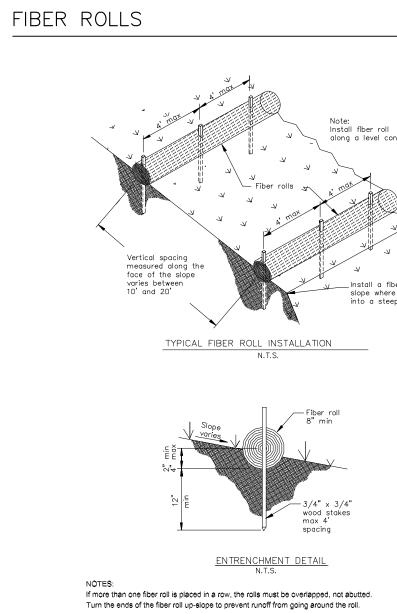

# GENERAL EROSION AND SEDIMENT CONTROL NOTES

FIBER ROLE INSTALL AT LOCATIONS SHOWN. AFIX AS SHOWN IN DETAIL SE-5

 There will be no stockpiling of soil. All excavated soil will be hauled off-site as it is excavated.

- Perform clearing and earth-moving activities only during dry weather. Measures to ensure adequate erosion and sediment control shall be installed prior to earth-moving activities and construction.
- Erosion control materials to be on-site during off-season.
- Measures to ensure adequate erosion and sediment control are required year-round.
   Stabilize all denuded areas and maintain erosion control measures continuously between October 1 and April 30.
- Store, handle, and dispose of construction materials and wastes properly, so as to prevent their contact with stormwater.
- Control and prevent the discharge of all potential pollutants, including pavement cutting wastes, paints, concrete, petroleum products, chemicals, wash water or sediments, and non-stormwater discharges to storm drains and watercourses.
- Avoid cleaning, fueling, or maintaining vehicles on-site, except in a designated area where wash water is contained and treated.
- · Limit and time applications of pesticides and fertilizers to prevent polluted runoff.
- Limit construction access routes to stabilized, designated access points
- Avoid tracking dirt or other materials off-site; clean off-site paved areas and sidewalks using dry sweeping methods.
- Train and provide instruction to all employees and subcontractors regarding the Watershed Protection Maintenance Standards and construction Best Management Practices.
- Placement of erosion materials is required on weekends and during rain events.
- The areas delineated on the plans for parking, grubbing, storage etc., shall not be enlarged or "run over."
- · Dust control is required year-round.

WM-8

• Erosion control materials shall be stored on-site.

PLE DETAIL PLE DETAIL PLE ADD B" X 24" AINTED WHITE BLACK LETTERS 5 HEIGHT 5.5" LAG SCREWS	EROSION CONTROL POINT OF CONTACT THIS PERSON WILL BE RESPONSIBLE FOR EROSION CONTROL AT THE SITE AND WILL BE THE COUNTY'S MAIN POINT OF CONTACT IF CORRECTIONS ARE REQUIRED.	*	No. <u>9-</u>	6226 <u>30–21</u> PIRES	4 - <b>1</b>		
SCREWS NOOD POST "X 3" X 8' JT y plastic lining) IT DETERMINED WITHIN TALLED WITHIN TEMPORARY HOUT FACILITY.	NAME: BRUCE GEHRELS   TITLE/QUALIFICATION: OWNER   PHONE: 650-604-2463   PHONE: E-MAIL:   BRUCEGEHRELS@GMAIL.COM		Sigma Prime Geosciences, Inc.	SICMA DDIME CEOSCIENCES INC	332 PRINCETON AVENUE HALF MOON BAY, CA 94019	(650) 728-3590 FAX 728-3593	
SE-5	STABILIZED CONSTRUCTION ENTRANCE/EXIT TC-1	DATE: 4-29-21	DRAWN BY: CMK	CHECKED BY: AZG	REV. DATE:	rev. date:	REV. DATE:
tour.	12" Min, unless otherwise specified by a soils engineer <u>SECTION B-B</u> NTS NOTE: Construct sediment barrier and channelize runoff to sediment trapping device B 10' min, or as required to accomodate anticipated traffic, whichever is greater Temporary pipe culvert as needed		ERUSION ANU SEDIMENT	, , ,	<u> </u>		0
	20' min, or max allowed by site (for smaller sites) Match Existing		S	ΞHE	ET	_	
	Grade <u>PLAN</u> NTS			<u> </u>		$\geq$	




#### SAN MATEO COUNTYWIDE Water Pollution **Prevention Program**

# **Construction Best Management Practices (BMPs)**

Construction projects are required to implement the stormwater best management practices (BMP) on this page, as they apply to your project, all year long.

Clean Water. Healthy Community.

#### **Materials & Waste Management**

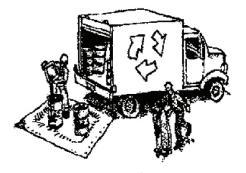

#### Non-Hazardous Materials

- Berm and cover stockpiles of sand, dirt or other construction material with tarps when rain is forecast or if not actively being used within 14 days.
- Use (but don't overuse) reclaimed water for dust control.

#### Hazardous Materials

- Label all hazardous materials and hazardous wastes (such as pesticides, paints, thinners, solvents, fuel, oil, and antifreeze) in accordance with city, county, state and federal regulations.
- □ Store hazardous materials and wastes in water tight containers, store in appropriate secondary containment, and cover them at the end of every work day or during wet weather or when rain is forecast.
- General Follow manufacturer's application instructions for hazardous materials and be careful not to use more than necessary. Do not apply chemicals outdoors when rain is forecast within 24 hours.
- Arrange for appropriate disposal of all hazardous wastes.

#### Waste Management

- Cover waste disposal containers securely with tarps at the end of every work day and during wet weather.
- Check waste disposal containers frequently for leaks and to make sure they are not overfilled. Never hose down a dumpster on the construction site.
- Clean or replace portable toilets, and inspect them frequently for leaks and spills.
- Dispose of all wastes and debris properly. Recycle materials and wastes that can be recycled (such as asphalt, concrete, aggregate base materials, wood, gyp board, pipe, etc.)
- Dispose of liquid residues from paints, thinners, solvents, glues, and cleaning fluids as hazardous waste.

#### **Construction Entrances and Perimeter**

- **X** Establish and maintain effective perimeter controls and stabilize all construction entrances and exits to sufficiently control erosion and sediment discharges from site and tracking off site.
- Sweep or vacuum any street tracking immediately and secure sediment source to prevent further tracking. Never hose down streets to clean up tracking.

**Equipment Management & Spill Control** 

Designate an area, fitted with appropriate BMPs, for

□ Perform major maintenance, repair jobs, and vehicle

□ If refueling or vehicle maintenance must be done

onsite, work in a bermed area away from storm drains

and over a drip pan or drop cloths big enough to collect

fluids. Recycle or dispose of fluids as hazardous waste.

□ If vehicle or equipment cleaning must be done onsite,

clean with water only in a bermed area that will not

allow rinse water to run into gutters, streets, storm

Do not clean vehicle or equipment onsite using soaps,

solvents, degreasers, or steam cleaning equipment.

Keep spill cleanup materials (e.g., rags, absorbents and

repair leaks promptly. Use drip pans to catch leaks

□ Inspect vehicles and equipment frequently for and

X Clean up spills or leaks immediately and dispose of

Do not hose down surfaces where fluids have spilled.

Sweep up spilled dry materials immediately. Do not

try to wash them away with water, or bury them.

□ Report significant spills immediately. You are required

by law to report all significant releases of hazardous

materials, including oil. To report a spill: 1) Dial 911

or your local emergency response number, 2) Call the

Governor's Office of Emergency Services Warning

Clean up spills on dirt areas by digging up and

properly disposing of contaminated soil.

Center, (800) 852-7550 (24 hours).

Use dry cleanup methods (absorbent materials, cat

cat litter) available at the construction site at all times.

vehicle and equipment parking and storage.

and equipment washing off site.

drains, or surface waters.

**Spill Prevention and Control** 

until repairs are made.

litter, and/or rags).

cleanup materials properly.

Maintenance and Parking

**Earthmoving** 

**Paving/Asphalt Work** 

- Avoid paving and seal coating in wet weather or when rain is forecast, to prevent materials that have not cured from contacting stormwater runoff.
- Cover storm drain inlets and manholes when applying seal coat, tack coat, slurry seal, fog seal, etc.
- X Collect and recycle or appropriately dispose of excess abrasive gravel or sand. Do NOT sweep or wash it into gutters.
- Do not use water to wash down fresh asphalt concrete pavement.

#### Sawcutting & Asphalt/Concrete Removal

- □ Protect nearby storm drain inlets when saw cutting. Use filter fabric, catch basin inlet filters, or gravel bags to keep slurry out of the storm drain system.
- □ Shovel, abosorb, or vacuum saw-cut slurry and dispose of all waste as soon as you are finished in one location or at the end of each work day (whichever is sooner!).
- □ If sawcut slurry enters a catch basin, clean it up immediately.
- tarps all year-round.
- under cover.


# Storm drain polluters may be liable for fines of up to \$10,000 per day!

#### Schedule grading and excavation work during dry weather.

- Stabilize all denuded areas, install and maintain temporary erosion controls (such as erosion control fabric or bonded fiber matrix) until vegetation is established.
- X Remove existing vegetation only when absolutely necessary, and seed or plant vegetation for erosion control on slopes or where construction is not immediately planned.
- Prevent sediment from migrating offsite and protect storm drain inlets, gutters, ditches, and drainage courses by installing and maintaining appropriate BMPs, such as fiber rolls, silt fences, sediment basins, gravel bags, berms, etc.
- □ Keep excavated soil on site and transfer it to dump trucks on site, not in the streets.

#### **Contaminated Soils**

- □ If any of the following conditions are observed, test for contamination and contact the Regional Water Quality Control Board:
- Unusual soil conditions, discoloration, or odor.
- Abandoned underground tanks.
- Abandoned wells
- Buried barrels, debris, or trash

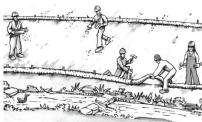



# rain, runoff, and wind.



#### **Concrete, Grout & Mortar** Application



□ Store concrete, grout, and mortar away from storm drains or waterways, and on pallets under cover to protect them from

Wash out concrete equipment/trucks offsite or in a designated washout area, where the water will flow into a temporary waste pit, and in a manner that will prevent leaching into the underlying soil or onto surrounding areas. Let concrete harden and dispose of as

□ When washing exposed aggregate, prevent washwater from entering storm drains. Block any inlets and vacuum gutters, hose washwater onto dirt areas, or drain onto a bermed surface to be pumped and disposed of properly.




□ Protect stockpiled landscaping materials from wind and rain by storing them under

□ Stack bagged material on pallets and

X Discontinue application of any erodible landscape material within 2 days before a forecast rain event or during wet weather.



#### **Painting & Paint Removal**

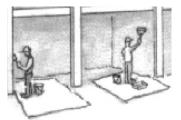

#### Painting Cleanup and Removal


- X Never clean brushes or rinse paint containers into a street, gutter, storm drain, or stream.
- For water-based paints, paint out brushes to the extent possible, and rinse into a drain that goes to the sanitary sewer. Never pour paint down a storm drain.
- □ For oil-based paints, paint out brushes to the extent possible and clean with thinner or solvent in a proper container. Filter and reuse thinners and solvents. Dispose of excess liquids as hazardous waste.
- □ Paint chips and dust from non-hazardous dry stripping and sand blasting may be swept up or collected in plastic drop cloths and disposed of as trash.
- Chemical paint stripping residue and chips and dust from marine paints or paints containing lead, mercury, or tributyltin must be disposed of as hazardous waste. Lead based paint removal requires a statecertified contractor.

#### Dewatering



- Discharges of groundwater or captured runoff from dewatering operations must be properly managed and disposed. When possible send dewatering discharge to landscaped area or sanitary sewer. If discharging to the sanitary sewer call your local wastewater treatment plant.
- Divert run-on water from offsite away from all disturbed areas.
- U When dewatering, notify and obtain approval from the local municipality before discharging water to a street gutter or storm drain. Filtration or diversion through a basin, tank, or sediment trap may be required.
- □ In areas of known or suspected contamination, call your local agency to determine whether the ground water must be tested. Pumped groundwater may need to be collected and hauled off-site for treatment and proper disposal.

LAV AS
LOR RAZ
DOD VIS
LIM PER
HAR VIO
(N) Unit Pavers, permeable –
(E) WOOD FENCE @ PROP.
LINE TO REMAIN
PIT TOB
MYR CAL
DOD VIS
(N) Gravel Path –
NAN DOM
MYR CAL
NEW 6' TALL
∉ GATE ERICA
CAREX
(N) Gravel Path –
LAV ANG
TUL VIO
LIM PER
LOR RAZ
(N) Fence, horizontal slat 4' high
SSMH 97.90RIM 92.80INV
9 <sup>8-15+</sup>
(1

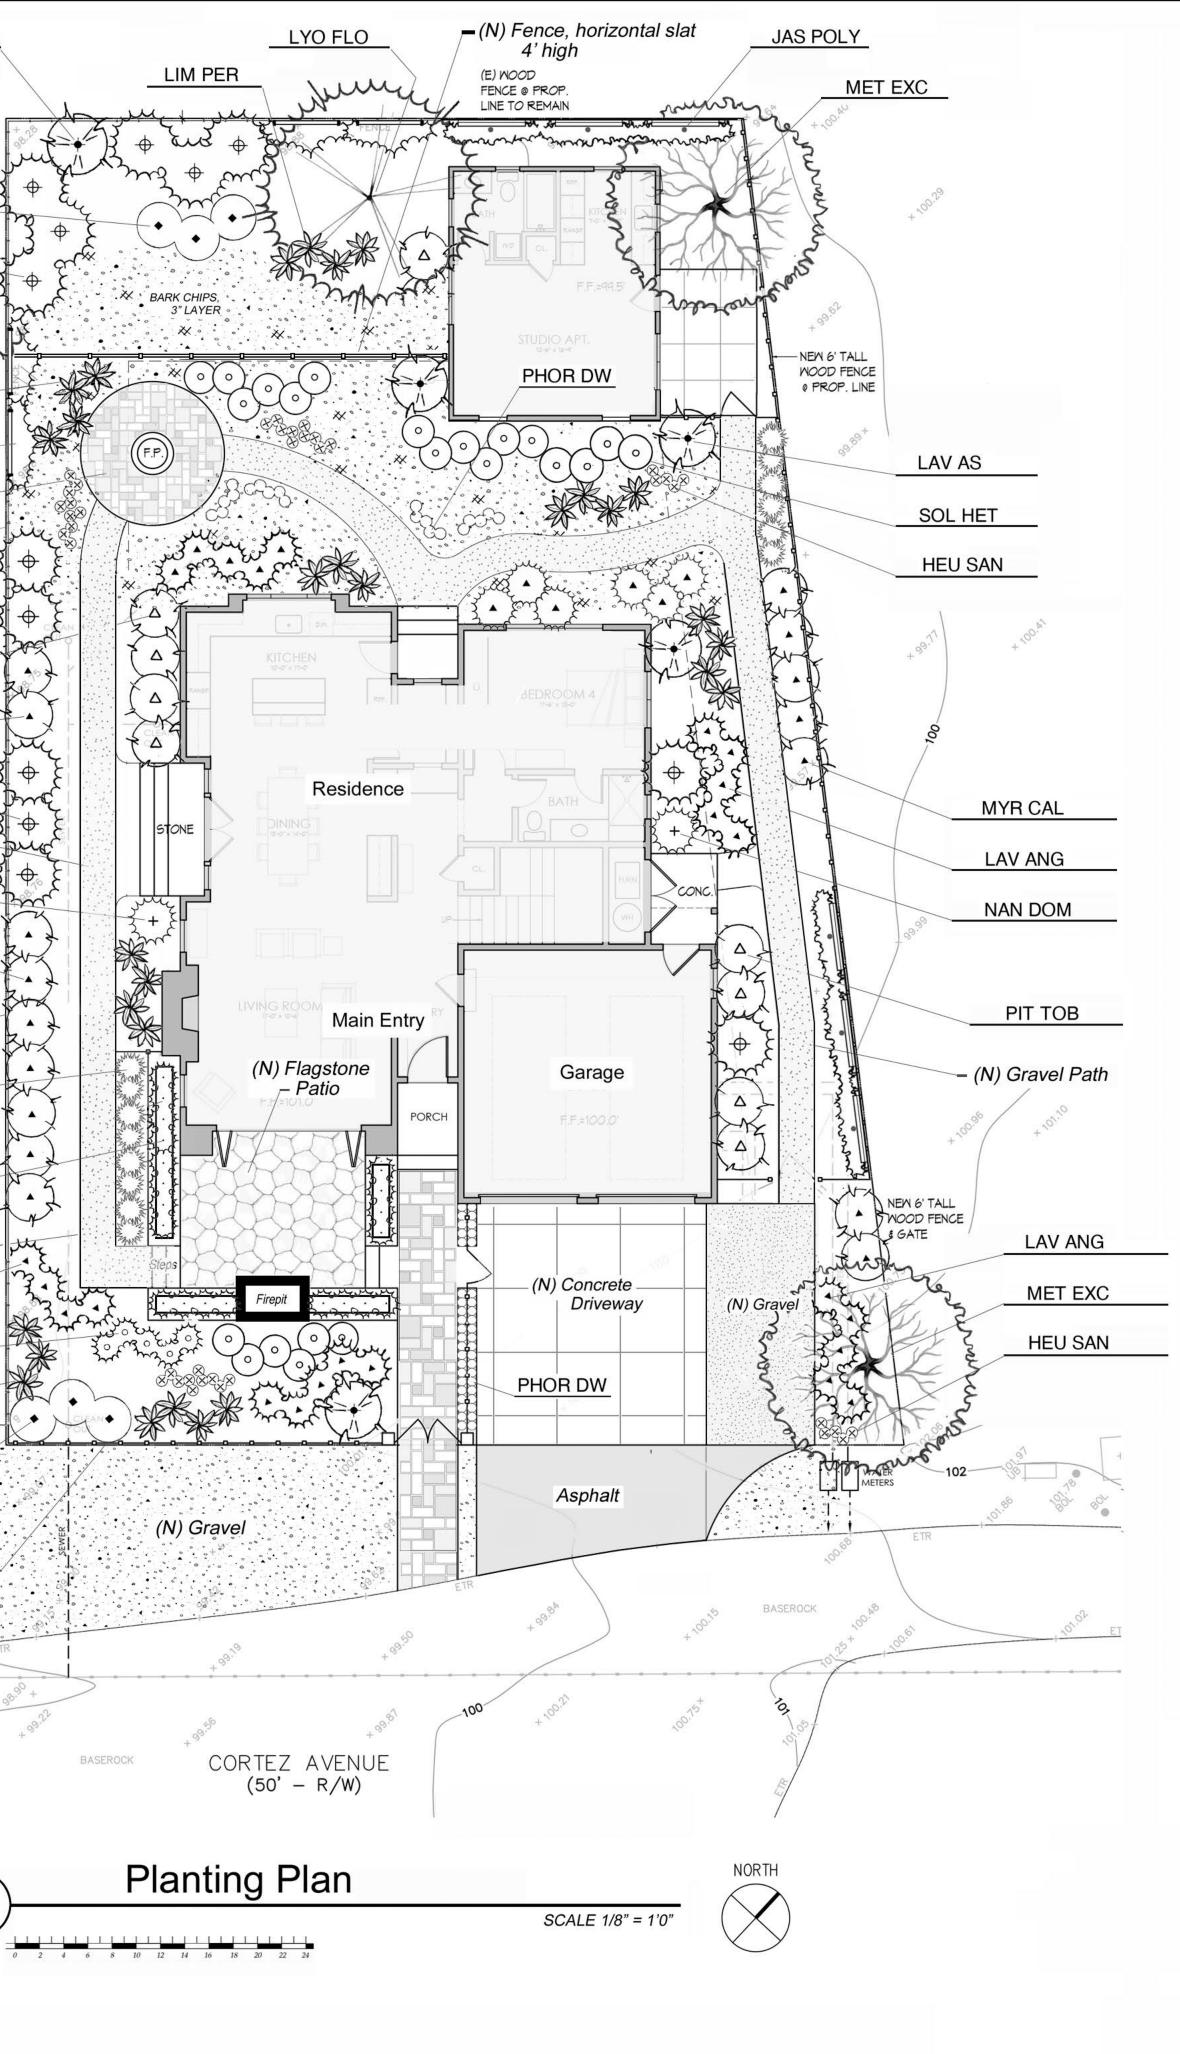

Plant Lis	st					
No.	Botanical Name	Common Name	Qty*	Size	WU	Plant Type
MET EXC	Metrosideros excelsus	New Zealand	2	15 Gal	L	Evgn Tree
LYO FLO	Lyonothamnus floribundus	Fernleaf Catalina	1	24" Box	L	Evgn Tree
	ssp. asplenifolius	Ironwood				
CAREX	Carex tumulicola	Foothill Sedge		1 Gal	L	Sedge
DOD VIS	Dodonaea viscosa	Hopseed Bush	r	5 Gal	L	Evgn Shrub
ERICA	Erica carnea	Heather		1 Gal	L	Low Shrub
HAR VIO	Hardenbergia violacea	Lilac Vine		15 Gal	М	Evgn Vine
HEU SAN	Heuchera sanguinea	Coral Bells		1 Gal	L	Perennial
LAV ANG	Lavendula angustifolia	English Lavender		1 Gal	L	Low Shrub
LAV AS	Lavatera assurgentifolia	Tree Mallow		5 Gal	L	Evgn Shrub
LIM PER	Limonium perezii	Sea Thrift		1 Gal	L	Perennial
LOR RAZ	Loropetalum 'Razzleberri'	NCN		5 Gal	L	Evgn Shrub
MYR CAL	Myrica californica	Pacific Wax Myrtle		5 Gal	L	Evgn Shrub
NAN DOM	Nandina domestica	Heavenly Bamboo		5 Gal	L	Evgn Shrub
PHOR DW	Phormium Dwarf Red	Miniature Red Flax		1 Gal.	L	Evgn Sub-shrub
PIT TOB	Pittosporum tobira	Variegated Japanese		5 Gal	L	Evgn Shrub
		Pittosporum				
RHODO	Rhododendron	Rhododendron		5 Gal	М	Evgn Shrub
SOL HET	Sollya heterophylla	Australian Bluebells		1 Gal	L	Evgn Sub-shrub
TUL VIO	Tulbaghia violacea	Society Garlic		1 Gal	L	Perennial
JAS POLY	Jasminum polyanthem	Pink Flowering		15 Gal	М	Evgn Vine
		Jasmine				
Note: Contracto	r to verify quantities.					

## PLANTING NOTES

- 1. CONTRACTOR SHALL CONTACT UNDERGROUND SERVICES ADMINISTRATION PRIOR TO EXCAVATION AND GRADING.
- 2. ALL PLANTING AREAS SHALL BE CLEARED OF WEEDS AND OTHER DEBRIS. THE CONTRACTOR SHALL VERIFY WITH THE OWNER WHICH EXISTING PLANTS ARE TO REMAIN. EXISTING PLANTS TO BE REMOVED SHALL BE VERIFIED WITH OWNER PRIOR TO REMOVAL. ALL IVY IN PROJECT AREA SHALL BE REMOVED; IVY SHALL BE SPRAYED WITH HERBICIDE TWO WEEKS PRIOR TO REMOVAL.
- 3. SOIL TESTING SHALL BE UNDERTAKEN BY THE CONTRACTOR, AND PERFORMED BY A CERTIFIED LABORATORY. A COPY OF THE REPORT SHALL BE PROVIDED TO THE OWNER AND LANDSCAPE ARCHITECT. RECOMMENDATIONS FOR AMENDMENTS AND FERTILIZATION SHALL REFLECT THE NUTRIENT REQUIREMENTS OF SPECIFIED PLANT SPECIES.
- 4. SOIL AMENDMENTS SHALL BE FREE OF DEBRIS SUCH AS LITTER, BROKEN CLAY POTS, AND OTHER FOREIGN MATERIAL. ROCKS LARGER THAN ONE INCH DIAMETER WILL NOT BE PERMITTED. SOIL AMENDMENTS SHALL HAVE THE FOLLOWING CONTENT: REDWOOD NITRIFIED COMPOST 40%, COARSE SAND 30%, BLACK TOPSOIL 30%.
- 5. PLANT HOLES SHALL BE DOUBLE THE SIZE OF THE CONTAINER (generally). THE WALLS AND BASES OF PLANT HOLES SHALL BE SCARIFIED. HOLES SHALL BE BACKFILLED WITH THE FOLLOWING MIXTURE: 80% TO 20% IMPORTED SOIL TO EXISTING SOIL.
- 6. SOIL BERMS SHALL BE FORMED AROUND ALL PLANTS 1 GALLON SIZE AND LARGER. BASINS SHALL BE MULCHED WITH A 3"LAYER OF BARK CHIPS, MINIMUM OF 1" IN SIZE. PLANTING AREAS SHALL BE COVERED WITH A TWO INCH LAYER OF BARK CHIPS.
- 7. ALL PLANTS SHALL BE FERTILIZED. FERTILIZER SHALL BE COMMERCIALLY AVAILABLE TYPE, AGRIFORM OR EQUIVALENT. APPLICATION SHALL BE ACCORDING TO MANUFACTURER'S INSTRUCTIONS. RESIDUAL WEED PRE-EMERGENT SHALL BE APPLIED BY THE CONTRACTOR. APPLICATION SHALL BE ACCORDING TO MANUFACTURER'S INSTRUCTIONS.
- 8. TREES SHALL BE STAKED WITH TWO PRESSURE TREATED 2" DIAMETER POLES. TREE TRUNK SHALL BE SECURED WITH TWO RUBBER TIES OR STRAPS FORMING A FIGURE-EIGHT BETWEEN

PREPARED BY:	BRUCE A. CHAN CA RLA #2324 923 ARGUELLO STREET, SUITE 200 REDWOOD CITY CA 94063
	650-346-7645 650-367-8139 (FAX)
	bacla@sbcglobal.net
	criteria of the ordinance and applied them accordingly water the irrigation design plan."
Signed Dr.	A.A.

Bruce A. Landscape A: CA Lic. # 002 923 Arguello Street, Redwood City, Cali Tel (650) 346 Fax (650) 367 Email: bacla@sbc Landscape Arc Environmenta Site Plann	rchitect 2324 Suite 200 fornia 94063 -7645 7-8139 global.net hitecture I Design							
No. 2324 EXP 3-31-22 OF CALLFORM								
New Residence	LOLIEZ AVE. Half Moon Bay, CA 94019							
TITLE								
Landso Plan	cape							
REVISIO	ONS							
Date	Notes							
PROJECT #:								
DATE: 6-22-21								
SHEET #:								

L 1.1

# **IRRIGATION MAINTENANCE SCHEDULE**

			Frequency				
General System Components		Weekly	Monthly	Quarterly	Annually		
1	Check that the controller program is correct.		Х				
2	If the controller has battery backup power, replace the battery yearly.				x		
3	Operate each station to make sure valves are opening and closing properly.		x				
4	Open the valve box while the system is running and check for valve leaks. Check for leaks, standing water, soggy ground and eroded soil.		x				
5	Inspect filter screens for holes or calcium buildup. Replace if it has holes,			X			
6	and soak screen in a 50-50 vinegar-water solution to remove calcium. After making all repairs or adjustments, flush each line for about a minute.			x			
0	Do this by removing the end-cap and turning on the valve						
	(there should be a removable exposed cap at the end of each line,						
	or sometimes the irrigation tubing is just kinked over and held in place).						
				1			
Sprir	Iklers						
7	Replace broken or missing sprinkler heads.	X					
	Don't mix head types on the same system.						
8	Check that sprinkler heads are flush with the soil surface and straight.		X				
9	Clear grass, plants and other obstructions that block sprinkler spray.	x					
10	Adjust sprinkler heads so there is no overspray; such that there is no water	x					
	spray hitting walls, driveways or sidewalks.						
11	Perform a sprinkler can test (or audit) to evaluate run times for each				X		
	irrigation circuit for greatest water efficiency.						
Drip	or Bubbler System						
12	Turn on the system 20-30 minutes before and during the inspection		X				
	to allow enough time for emitter wetting patterns to show.						
13	Fix and replace clogged or missing emitters.		X				
14	Repair or replace damaged bubblers. Some bubblers are adjustable. Check flow for proper setting.	x					
15	Move emitters out to drip line as plants grow or adjust bubbler basin sizes.			X			
		1	1	1			

# **IRRIGATION STATION RUN TIMES**

Station/			Frequency				
Valve	Description	Туре	Winter	Spring	Summer	Fall	
1	Shrubs & Groundcover	Drip	Sat Tu Th	Sat Tu Th	Sat Tu Th	Sat Tu Th	
			Off	20 min	30 min	15 min	
2	Shrubs & Groundcover	Drip	Sat Tu Th	Sat Tu Th	Sat Tu Th	Sat Tu Th	
			Off	20 min	30 min	15 min	
3	Lawn	Spray	Su M W F				
			Off	15 min	15 min	10 min	
4	Shrubs & Groundcover	Drip	Sat Tu Th	Sat Tu Th	Sat Tu Th	Sat Tu Th	
			Off	20 min	30 min	15 min	
5	Shrubs & Groundcover	Drip	Sat Tu Th	Sat Tu Th	Sat Tu Th	Sat Tu Th	
			Off	20 min	30 min	15 min	
6	Trees	Drip	Sat Tu Th	Sat Tu Th	Sat Tu Th	Sat Tu Th	
			Off	20 min	30 min	20 min	
	 n times to be adjusted as n						

Note: All run times to be adjusted as necessary

### PRESCIPTIVE APPROACH

#### SAN MATEO COUNTY

(For 500 – 2,500 sq ft of new landscape area or aggregate new and rehabilitated landscape area OR 2,500 sq ft of rehabilitated landscape area)

# WELO COMPLIANCE NOTES

### Planting

- 1. A minimum 3-inch layer of mulch shall be applied on all exposed soil surfaces of planting areas except turf areas, creeping or rooting groundcovers, or direct seeding applications where mulch is contraindicated.
- 2. Turf not to exceed 25% of the landscape area in residential areas.
- 3. No turf permitted in non-residential areas.
- 4. Turf not permitted on slopes greater than 25%.
- 5. Turf is prohibited in parkways less than 10 feet wide.

#### Irrigation

- 1. An automatic weather-based or soil-moisture based irrigation controller shall be installed on the irrigation system.
- 2. Pressure regulators shall be installed on the irrigation system to ensure dynamic pressure of the system is within the manufacturer's recommended pressure range.
- 3. Manual shut-off valves shall be installed as close as possible to the point of connection of the water supply.
- 4. Areas less than 10 feet in width in any direction shall be irrigated with subsurface irrigation or other means that produces no runoff or overspray.
- 5. For non-residential projects with landscape areas of 1,000 sq.ft. or more, private submeter(s) to measure landscape water use shall be installed.
- 6. At the time of final inspection, the permit applicant must provide the owner of the property with a certificate of complete, certificate of installation, irrigation schedule of landscape and irrigation maintenance.
- 7. Unless contradicted by a soils test, compost at a rate of a minimum of four cubic yards per 1,000 sq. ft. of permeable area shall be incorporated to a depth of six inches into the soil.

Lot A



