
# BUILDING AND SITE IMPROVEMENTS 1450 EDGEWOOD RD (PARCEL 2)

APN 058-021-050

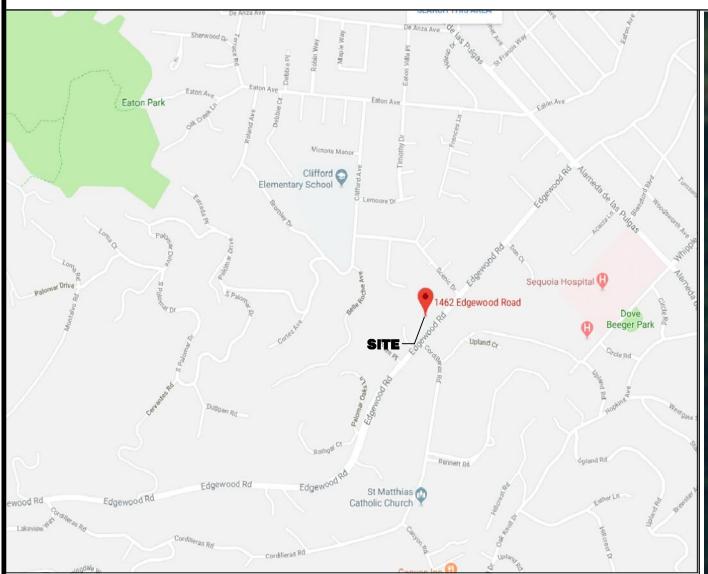

#### VICINITY MAP

**GEOTECHNICAL ENGINEER** 

**CONTACT:** WAYNE L. TING

**PHONE**: (510) 623-7768

**WAYNE TING & ASSOCIATES, INC.** 

ADDRESS: 42329 OSGOOD RD, UNIT A

FREMONT, CA 94539

#### **SCOPE OF WORK**

THE PROJECT SCOPE OF WORK INCLUDES THE REMOVAL THE EXISTING SITE IMPROVEMENTS AND CLEARING AS SHOWN HERIN AND CONSTRUCTION OF NEW SITE IMPROVEMENTS FOR A NEW RESIDENCE AND AN ACCESSORY DWELLING UNIT.

#### **OWNER INFORMATION:**

NAME: CHARLES AND ANNE CAMILLERI
ADDRESS: 1462 EDGEWOOD RD
REDWOOD CITY, CA 94062
PHONE: (650) 464-0980

#### CONSULTANT INFORMATION:

CIVIL ENGINEER
JET ENGINEERING

CONTACT: JAMES E. THOMPSON

ADDRESS: 1048 EL CAMINO REAL, SUITE C


REDWOOD CITY, CA 94063

**PHONE**: (650) 260-2755

ARCHITECTURE
LOUIE LEU ARCHITECT
CONTACT: LOUIE LEU

**PHONE**: (408) 399-2222

ADDRESS: 236 N. SANTA CLARA CRUZ AVE, SUITE 210. LOS GATOS, CA 95030

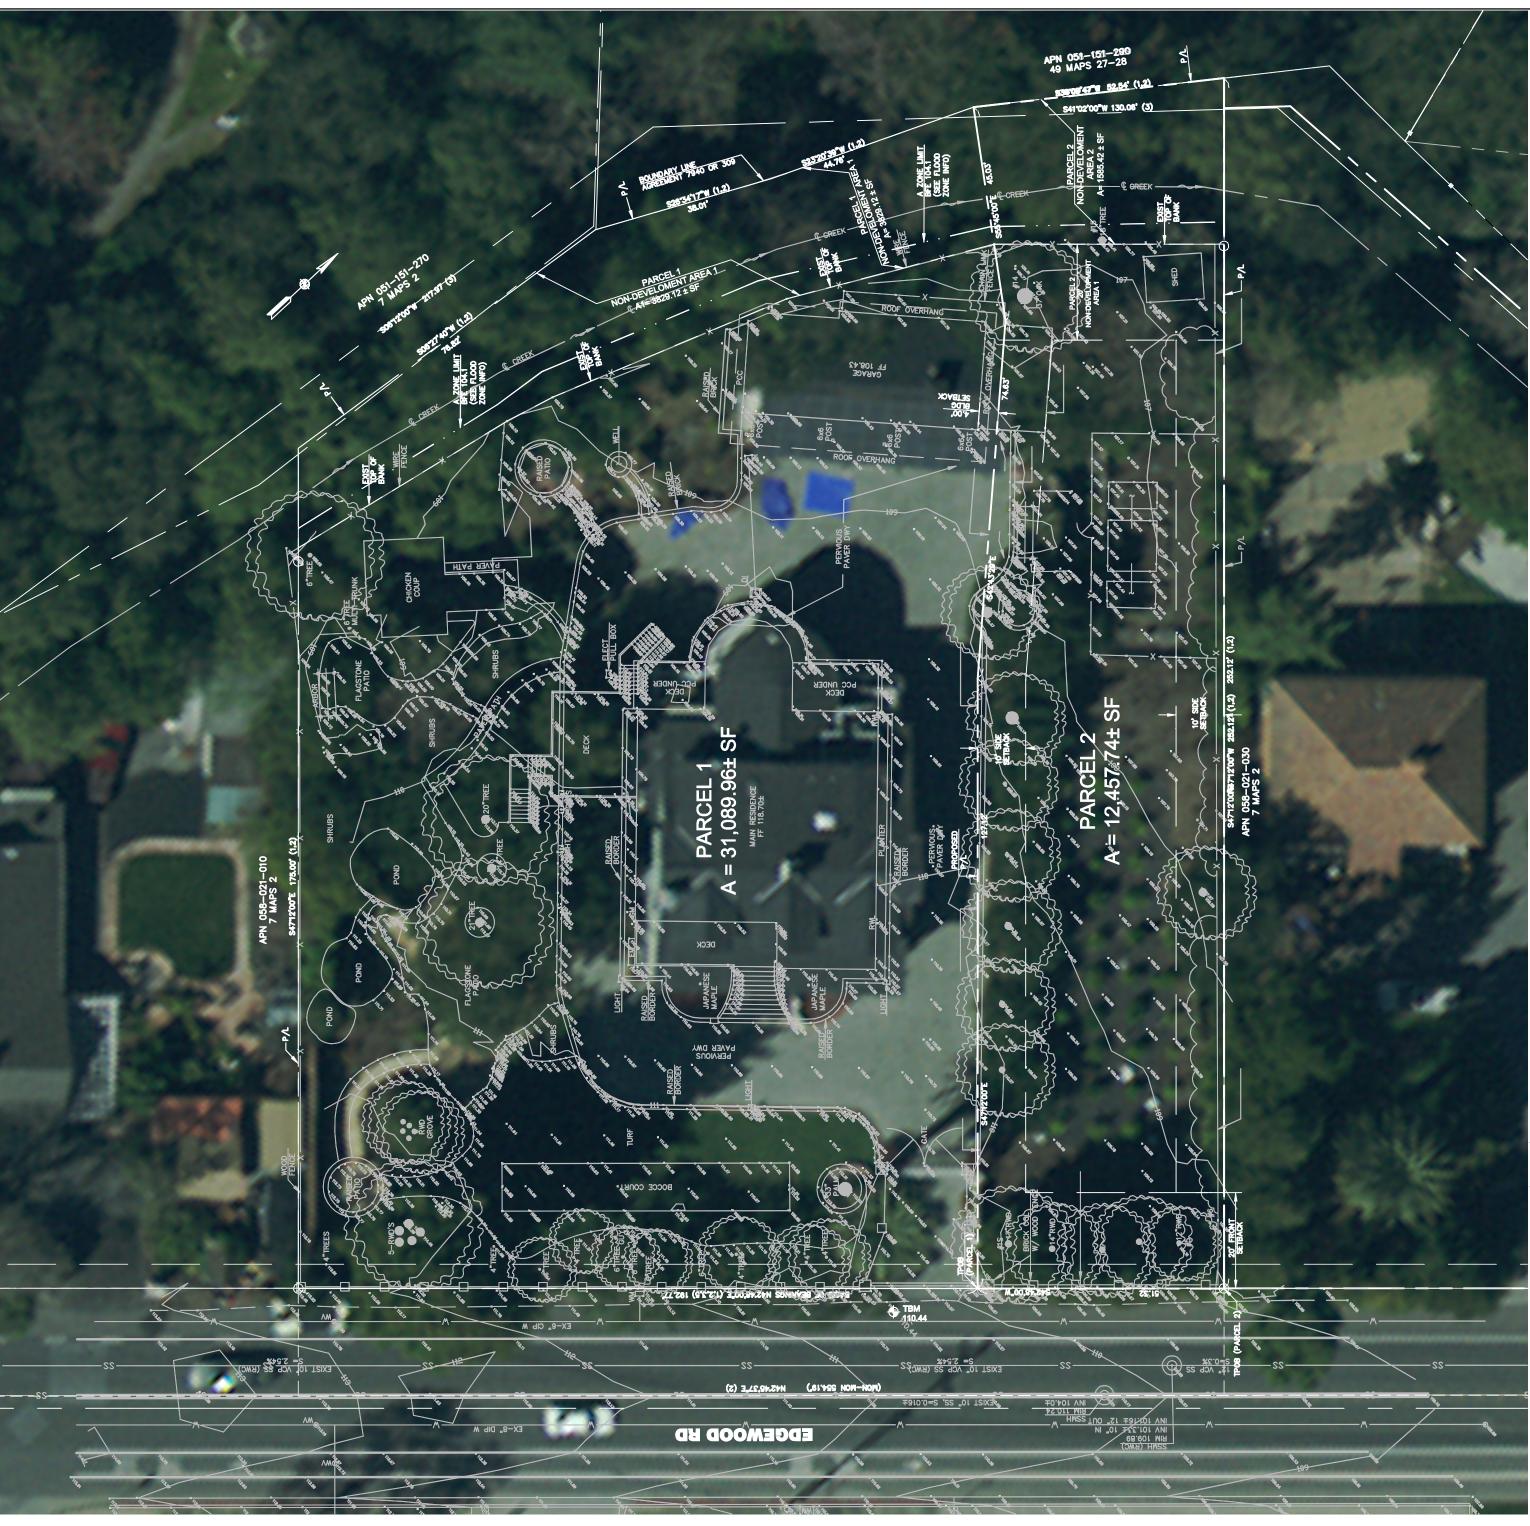

#### **EXSITING SITE PLAN**

#### **LEGEND**

**DESCRIPTION** 

PROPERTY LINE CENTERLINE SETBACK LINE **FENCE** FIRE HYDRANT MANHOLE VALVE AREA SPOT ELEVATION VALLEY GUTER SANITARY SEWER CLEANOUT STORM DRAIN INFILTRATION TRENC **TELEPHONE** PAVED INVERT OVERHEAD WIRE SWALE REMOVE TREE

**PROPOSED** 

#### **ABBREVIATIONS**

TREE PROTECTION FENCING

= AGGREGATE BASE = ASPHALT CONCRETE OC = ON CENTER= CATCH BASIN PCC = PORTLAND CEMENT CONCRETE = CONCRETE MASONRY UNIT CONC = CONCRETE PG = PROFILE GRADE CONN = CONNECTPKNG = PARKING P/L = PROPERTY LINE = DRAINAGE INLET PPUD = PERFORATED PIPE UNDER DRAIN PTDF = PRESSURE TREATED DOUGLAS FIR = ELECTRIC METER PVC = POLYVINYL CHLORIDE = EXISTING GRADE

RWL = RAINWATER LEADER

SD = STORM DRAIN

SS = SANITARY SEWER

TBM = TEMPORARY BENCHMARK

#### **SHEET INDEX**

= EDGE OF PAVEMENT

EVC = END VERTICAL CURVE

ELEV = ELEVATION

EXIST = EXISTING EW = EACH WAY

COVER SHEET - EXISTING SITE PLAN GENERAL CONSTRUCTION NOTES C2.0 TOPOGRAPHIC SURVEY AND DEMOLITION AND REMOVAL PLAN C4.0 SITE AND GRADING PLAN DRAINAGE AND UTILITY PLAN DRIVEWAY SECTION AND DETAILS C6.1 UTILITY PROFILES AND ELEVATIONS SITE DRAINAGE DETAILS SANITARY SEWER DETAILS C9.0 WATER AND SERVICE TRENCH DETAILS C10.0 ARBORIST REPORT LANDSCAPE PLAN AND DETAIL STORMWATER POLLUTION PREVENTION PLAN BEST MANAGEMENT PRACTICES

EC.1 EROSION CONTROL PLAN
EC.2 EROSION CONTROL DETAILS



# JET ENGINEERING

CONSULTING CIVIL ENGINEERS 1048 EL CAMINO REAL, SUITE C REDWOOD CITY, CA 94063 LANDS OF CAMILLERI 1462 EDGEWOOD RD

**REDWOOD CITY, CA 94062** 

**COVER SHEET** 

		REVISIONS		JOB NO.	R1462-E-18
NO.	DATE	DESCRIPTION	BY	DATE :	03/10/21
				DRAWN:	DC
				CHECKED:	JET
				SCALE: 1"	- 30'

SHEET NO.

#### SCOPE WORK

- 1. THE PROJECT SCOPE OF WORK INCLUDES THE REMOVAL THE EXISTING SITE IMPROVEMENTS AND CLEARING AS SHOWN HERIN AND CONSTRUCTION OF NEW SITE IMPROVEMENTS FOR A NEW RESIDENCE AND AN ACCESSORY DWELLING UNIT.
- 2. ONLY WORK DETAILED ON THESE PLANS IS APPROVED FOR CONSTRUCTION. ANY ADDITIONAL WORK REQUIRED NOT DETAILED ON THESE PLANS MUST BE SUBMITTED SEPARATELY AS A REVISION TO THE PROJECT. REVISIONS MAY REQUIRE NEW PLANS, PERMITS AND ADDITIONAL FEES.
- 3. THE ENGINEER SHALL NOT BE RESPONSIBLE NOR LIABLE FOR ANY UNAUTHORIZED CHANGES TO THESE PLANS. ALL PROPOSED CHANGES TO PLANS SHALL BE IN WRITING AND MUST BE APPROVED BY ENGINEER PRIOR TO PROCEEDING.
- 4. APPLICABLE CODES FOR THIS PROJECT:
- COUNTY OF SAN MATEO MUNICIPAL CODE.
- 2019 CALIFORNIA BUILDING CODE (2018 INTERNATIONAL BUILDING CODE)
- 2019 CALIFORNIA ADMINISTRATIVE CODE T24 PART 1
- 2019 CALIFORNIA BUILDING CODE T24, PART 2.1
   2019 CALIFORNIA BUILDING CODE T24, PART 2.2
- 2019 CALIFORNIA BUILDING CODE T24, PART 2.2
- 2019 CALIFORNIA RESIDENTIAL CODE T24, PART 2.5
- 2019 CALIFORNIA ELECTICAL CODE T24, PART 3
- 2019 CALIFORNIA MECHANICAL CODE T24, PART 4
- 2019 CALIFORNIA PLUMBING CODE T24, PART 5
- 2019 CALIFORNIA ENERGY CODE T24, PART 6
  2019 CALIFORNIA HISTORICAL BUILDING CODE T24, PART 8
- 2019 CALIFORNIA FIRE CODE T24, PART 9
- 2019 CALIFORNIA FIRE CODE 124, PART 9
   2019 CALIFORNIA EXISTING BUILDING CODE T24, PART 10
- 2019 CALIFORNIA GREEN BUILDING STANDARDS CODE T24, PART 11
- 2019 CALIFORNIA REFERENCED STANDARDS CODE T24, PART 12
   ALL OTHER STATE AND LOCAL LAWS, ORDINANCES AND REGULATIONS
- 5. INSPECTIONS MUST BE SCHEDULED AT LEAST 24 HOURS IN ADVANCE.
   INSPECTION REQUEST LINE, PRIOR TO 3 PM.
- 6. PERMIT EXPIRATION & RENEW AL
- ONCE A PERMIT IS ISSUED, AN INSPECTION IS REQUIRED WITHIN 180 DAYS AND EVERY 180 DAYS THEREAFTER OR THE PERMIT WILL EXPIRE. ADDITIONAL FEES ARE REQUIRED TO REINSTATE AN EXPIRED PERMIT. ALL EXPIRED PLANS MUST BE REVISED TO COMPLY WITH CURRENT CODE REQUIREMENTS.
- WORK IN THE PUBLIC RIGHT OF WAY.
   A SEPARATE ENCROACHMENT PERMIT IS REQUIRED FROM THE PUBLIC WORKS DEPARTMENT FOR ANY WORK IN THE CITY RIGHT OF WAY.

#### **GENERAL NOTES**

- 1. THE BOUNDARY INFORMATION IS BASED UPON THE FOLLOWING RECORD INFORMATION PORTION LOT 5, AS SHOWN ON THAT CERTAIN MAP ENTITLED "RECORD OF SURVEY OF THE LANDS OF CAMILLERI A PORTION OF LOT 5, "JOHSON SUBDIVISION, 7 MAPS 2 DESCRIBED IN 96151629 OR" FILED IN THE OFFICE OF THE COUNTY RECORDER OF SAN MATEO COUNTY, STATE OF CALIFORNIA, ON FEBRUARY 23, 1999 IN BOOK 19 OF MAPS AT PAGE 38
- 2. PROJECT BENCHMARK, CITY OF REDWOOD CITY BM70, ELEVATION 117.139' (NAVD 1988) DESCRIBED AS FOLLOWS: WHIPPLE AVE AT UPLAND RD TOP OF DISC ON CURB, AT INTERSECTION, SOUTH CURB RETURN, MID-POC.
- 3. TEMPORARY BENCHMARK (TBM) MAG NAIL SET IN EDGEWOOD RD, IN FRONT OF THE PROJECT SITE, ELEVATION 110.44'
- 4. PROJECT BENCHMARK HEREON ARE BASED UPON AN ASSUMED DATUM (NAVD)
  MAG NAIL SET IN EDGEWOOD RD, IN FRONT OF THE PROJECT SITE, ELEVATION 110.44'
- 5. TOPOGRAPHIC SURVEYS AND BOUNDARY SURVEYS PREPARED BY JET ENGINEERING DATED APRIL 20, 2018
- 6. ALL WORK SHALL BE DONE IN ACCORDANCE WITH THE CURRENT CALIFORNIA BUILDING CODE AND ALL APPLICABLE TOWN OF HILLSBOROUGHCODES AND ORDINANCES.
- 7. CONTRACTOR SHALL CONTACT UNDERGROUND SERVICE ALERT (USA) AT (800) 227-2600 AT LEAST 48 HOURS PRIOR TO STARTING WORK.
- 8. ANY AND ALL CONSTRUCTION STAGING, PARKING, STORAGE OF MATERIALS OR REQUIPMENT, ETC. SHALL OCCUR ON SITE.
- 9. IF A CONFLICT OCCURS DURING CONSTRUCTION THAT REQUIRES A CHANGE IN DESIGN, THE CONTRACTOR SHALL CONTACT THE ENGINEER FOR SOLUTIONPRIOR
- 10. THE ENGINEER SHALL NOT BE RESPONSIBLE NOR LIABLE FOR ANY UNAUTHORIZED CHANGES TO THESE PLANS. ALL PROPOSED CHANGES TO PLANS SHALL BE IN WRITING AND MUST BE APPROVED BY ENGINEER PRIOR TO PROCEEDING.
- 11. THE CONTRACTOR SHALL VISIT PROJECT SITE PRIOR TO BIDDING AND VERIFY ALL EXISTING CONDITIONS. FIELD VERIFY ALL DIMENSIONS PRIOR TO FABRICATION OR ORDERING OF ANY ITEMS. VERIFY ALL WORK TO BE DONE WITH THE OWNER PRIOR TO CONSTRUCTION. VERIFY WHICH ITEMS, FIXTURES, OR APPLICANCES SHALL BE SUPPLIED OR REUSED BY THE OWNER AND THE EXACT LOCATION OF SAID ITEMS.
- 12. NOISE SOURCES ASSOCIATED WITH DEMOLITION, CONSTRUCTION, REPAIR, REMODELING, OR GRADING OF ANY REAL PROPERTY SHALL BE LIMITED TO THE HOURS FROM 7:00 A.M. TO 6:00 P.M., WEEKDAYS AND 9:00 A.M. TO 5:00 P.M., SATURDAYS. SAID ACTIVITIES ARE PROHIBITED ON SUNDAYS, THANKSGIVING, AND CHRISTMAS (SAN MATEO ORDINANCE CODE SECTION 4.88.360).
- 13. THE CONTRACTOR SHALL TAKE CARE DURING DEMOLITION AND CONSTRUCTION NOT TO DAMAGE ANY EXISITNG CONSTRUCTION AND PLANTING WHICH IS TO REMAIN. ANY DAMAGE OF EXISTING CONDITIONS SHALL BE REPLACED AT NO COST TO OWNER. THE CONTRACTOR SHALL RESTORE ALL DAMAGED, REMOVED OR OTHERWISE DISTURBED WALLS, FENCES, SERVICES, UTILITIES, IMPROVEMETS OR FEATURES OF WHATEVER NATURE, DUE TO CONTRACTOR'S WORK.
- 14.ALL MATERIALS TO BE REMOVED SHALL BE DISPOSED OF AT AN APPROPRIATE LOCATION AWAY FROM THE SITE.
- 15.ALL WORK SHALL BE PERFORMED SO THAT THERE SHALL BE MINIMUM INTERFERENCE WITH NEIGHBORS.
- 16. CONTRACTOR SHALL PROVIDE ALL NECESSARY TEMPORARY SUPPORTS, SHORING AND BRACING REQUIRED DURING CONSTRUCTION. CONTRACTOR SHALL BE RESPONSIBLE FOR MAINTAINING STRUCTURAL INTEGRITY AND SAFETY.
- 17. CONTRACTOR SHALL CLEAN UP AND REMOVE FROM SITE ALL DEBRIS AND WASTE MATERIALS CREATED BY DEMOLITION AND CONSTRUCTION.
- 18.THESE PLANS ARE FOR GENERAL CONSTRUCTION PUPROSES ONLY. THEY ARE NOT EXHAUSTIVELY DETAILED NOR FULLY SPECIFIED. IT IS THE RESPONSIBILITY OF THE CONTRACTOR TO SELECT, VERIFY, RESOLVE, AND INSTALL ALL MATERIALS AND EQUIPMENT.

- 19. FINISHED GROUND SURFACES SHALL BE GRADED TO DRAIN THE FINISHED SITE PROPERLY. UNPAVED FINISHED GROUND SLOPE WITHIN FIVE FEET OF THE BUILDING OR STRUCTURE SHALL SLOPE AWAY AT 5%. ALL EXTERIOR HARD SURFACES (INCLUDING TERRACES) SHALL BE INSTALLED WITH A 1% MINIMUM SLOPE AND SHALL DRAIN AWAY FROM THE BUILDING AT 2% CROSS SLOPE. DRAINAGE SWALES SHALL HAVE A MINIMUM SLOPE OF 1.0%. MAXIMUM ALLOWABLE GRADED SLOPE IS 3 HORIZONTAL TO 1 VERTICAL (33%).
- 20. LOT GRADING SHALL CONFORM AT THE PROPERTY LINES AND SHALL NOT SLOPE TOWARD PROPERTY LINES IN A MANNER WHICH WOULD CAUSE STORM WATER TO FLOW ONTO NEIGHBORING PROPERTY.
- 21. NEW RAINWATER DOWNSPOUTS SHALL BE DISCHARGED TO A LANDSCAPED AREA THAT DIRECTS WATER AWAY FROM THE BUILDING (UNO).
- 22. ALL CONSTRUCTION STAKING SHALL BE DONE BY A REGISTERED CIVIL ENGINEER OR LICENSED LAND SURVEYOR.

#### STANDARD GRADING NOTES

- 1. ALL CLEARING, GRUBBING, EXCAVATIONS AND EARTHWORK SHALL BE IN ACCORDANCE WITH SECTION 16 "CLEARING AND GRUBBING" AND SECTION 19 "EARTHWORK" OF THE STATE STANDARD SPECIFICATIONS.
- 2. APROVAL OF THIS PLAN APPLIES ONLY TO THE EXCAVATION, PLACEMENT, AND COMPACTION OF NATURAL EARTH MATERIALS AND CONSTRUCTION OF EROSION CONTROL DEVICES SHOWN IN THIS PLAN SET. THIS APPROVAL DOES NOT CONFER ANY RIGHTS OF ENTRY TO EITHER PUBLIC PROPERTY OR THE PRIVATE PROPERTY OF
- 3. IT IS THE CONTRACTOR'S RESPONSIBILITY TO VERIFY THE LOCATIONS OF ALL EXISTING UNDERGROUND UTILITIES. CALL U.S.A. (UNDERGROUND SERVICE ALERT) 48 HOURS BEFORE DIGGING AT (800) 227-2600. LOCATIONS SHOWN ON THE PLANS WERE TAKEN FROM AVAILABLE RECORDS AND ARE APPROXIMATE AND SHOWN FOR GENERAL INFORMATION ONLY, AND MAY BE INCOMPLETE. RELOCATION OR REPAIR OF ANY DAMAGE TO UTILITIES OR PIPELINES AND PLUGGING OR REMOVAL OF ABANDONED LINES SHALL BE THE CONTRACTOR'S RESPONSIBILITY.
- 4. IT SHALL BE THE RESPONSIBILITY OF THE PERMITTEE TO IDENTIFY, LOCATE AND PROTECT ALL UNDERGROUND FACILITIES.
- 5. THE CONTRACTOR SHALL TAKE ALL NECESSARY PRECAUTIONS TO PRESERVE AND PROTECT ANY FENCES WHICH MAY BE REQUIRED TO REMAIN BY THE OWNER.
- 6. THE PERMITTEE SHALL MAINTAIN THE STREETS, SIDEWALKS AND ALL OTHER PUBLIC RIGHTS-OF-WAY IN A CLEAN, SAFE AND USABLE CONDITION. ALL SPILLS OF SOIL, ROCK OR CONSTRUCTION DEBRIS SHALL BE REMOVED FROM THE PUBLICLY OWNED PROPERTY DURING CONSTRUCTION AND UPON COMPLETION OF THE PROJECT. ALL ADJACENT PROPERTY, PRIVATE OR PUBLIC, SHALL BE MAINTAINED IN A CLEAN, SAFE AND USABLE CONDITION.
- 7. THIS PLAN DOES NOT AUTHORIZE REMOVAL OF TREES. THE CONTRACTOR SHALL TAKE ALL NECESSARY PRECAUTIONS TO PRESERVE AND PROTECT THOSE TREES WHICH ARE TO REMAIN.
- 8. ALL TEMPORARY EXCAVATION SHALL BE ADEQUATELY SHORED AS NECESSARY AND SHALL COMPLY WITH ALL APPLICABLE CAL/OSHA REQUIREMENTS.
- 9. ALL EXISTING CESSPOOLS, FOUNDATIONS, BASEMENTS, TANKS OR OTHER UNDER GROUND STRUCTURES SHALL BE REMOVED AND THE RESULTING DEPRESSIONS BACKFILLED AND COMPACTED UNDER THE OBSERVATION OF THE ENGINEER. ALL COSTS INVOLVED IN THIS WORK SHALL BE CONSIDERED AS INCLUDED IN THE CONTRACT PRICE FOR THE GRADING ITEMS UNLESS COVERED IN SEPARATE PAY ITEMS.
- 10.ALL GRADING SHALL CONFORM TO APPROVED SPECIFICATIONS PRESENTED HEREIN OR ATTACHED HERETO. ALL GRADING WORK SHALL BE OBSERVED AND APPROVED BY THE ENGINEER. THE ENGINEER SHALL BE NOTIFIED AT LEAST 48 HOURS BEFORE BEGINNING ANY GRADING. UNOBSERVED AND UNAPPROVED GRADING WORK SHALL BE REMOVED AND REPLACED UNDER OBSERVATION.
- 11. THE SITE AREA SHOULD BE STRIPPED OF ALL SURFACE VEGETATION AND SURFACE AND SUBSURFACE IMPROVEMENTS WITHIN THE PROPOSED PROJECT AREA. SURFACE VEGETATION AND TOPSOIL SHOULD BE STRIPPED TO A SUFFICIENT DEPTH TO REMOVE ALL MATERIAL GREATER THAN 3 PERCENT ORGANIC CONTENT BY WEIGHT. SURFACE STRIPPING SHOULD EXTEND ABOUT 2 TO 4 INCHES BELOW EXISTING GRADE IN VEGETATED AREAS. DEEPER EXCAVATIONS TO REMOVE SHRUB ROOTS MAY REQUIRE FURTHER EXCAVATION. TREES AND SHRUBS DESIGNATED FOR REMOVAL SHOULD HAVE THE ROOT BALLS AND ANY ROOTS GREATER THAN ½-INCH DIAMETER REMOVED COMPLETELY. MATURE TREES ARE ESTIMATED TO HAVE ROOT BALLS EXTENDING TO DEPTHS OF 2 TO 6 FEET, DEPENDING ON THE TREE SIZE.
- 12.THE CONTRACTOR IS RESPONSIBLE FOR MAINTAINING ALL TEMPORARY SLOPES AND PROVIDING TEMPORARY SHORING WHERE REQUIRED. TEMPORARY SHORING, BRACING, AND CUT/FILLS SHOULD BE PERFORMED IN ACCORDANCE WITH THE STRICTEST GOVERNMENT SAFETY STANDARDS.
- 13. ON-SITE SOILS WITH AN ORGANIC CONTENT LESS THAN 3 PERCENT BY WEIGHT MAY BE REUSED AS GENERAL FILL. GENERAL FILL SHOULD NOT HAVE LUMPS, CLODS OR COBBLE PIECES LARGER THAN 6 INCHES IN DIAMETER; 85 PERCENT OF THE FILL SHOULD BE SMALLER THAN 2-1/2 INCHES IN DIAMETER. MINOR AMOUNTS OF OVERSIZE MATERIAL (SMALLER THAN 12 INCHES IN DIAMETER) MAY BE ALLOWED PROVIDED THE OVERSIZED PIECES ARE NOT ALLOWED TO NEST TOGETHER AND THE COMPACTION METHOD WILL ALLOW FOR LOOSELY PLACED LIFTS NOT EXCEEDING 12 INCHES.
- 14. ALL FILLS, AND SUBGRADE AREAS WHERE FILL AND SLABS-ON-GRADE ARE PLANNED, SHOULD BE PLACED IN LOOSE LIFTS 8 INCHES THICK OR LESS AND COMPACTED IN ACCORDANCE WITH ASTM D1557 (LATEST VERSION) REQUIREMENTS. EACH LIFT OF FILL AND ALL SUBGRADE SHOULD BE FIRM AND UNYIELDING UNDER CONSTRUCTION EQUIPMENT LOADING IN ADDITION TO MEETING THE COMPACTION REQUIREMENTS TO BE APPROVED.
- 15. IF CONSTRUCTION, INCLUDING ANY VEGETATION REMOVAL, IS INITIATED DURING THE BIRD BREEDING SEASON (WHICH IS FROM FEBRUARY 1 THROUGH AUGUST 30), A SURVEY SHOULD BE CONDUCTED TO DETERMINE PRESENCE OR ABSENCE OF BIRD NESTS. IF ACTIVE NESTS ARE FOUND, A NO-WORK ZONE WITH A DISTANCE APPROPRIATE TO PROTECT THE NEST SHOULD BE ESTABLISHED UNTIL THE NEST IS NO LONGER ACTIVE (E.G., THE YOUNG FLEDGED), AND THEN CONSTRUCTION COULD CONTINUE WITHOUT RESTRICTION. IF NO ACTIVE NESTS ARE FOUND DURING THE SURVEY, THEN CONSTRUCTION MAY BEGIN AND CONTINUE UNTIL COMPLETED. IF CONSTRUCTION CEASES FOR MORE THAN A TWO-WEEK PERIOD, THEN ANOTHER SURVEY IS RECOMMENDED IN CASE A NEST IS ESTABLISHED DURING THAT PERIOD. IF CONSTRUCTION IS INITIATED BETWEEN SEPTEMBER 1 AND JANUARY 30, THE NON-BREEDING SEASON, NO SURVEYS FOR ACTIVE NESTS ARE RECOMMENDED AND WORK MAY PROGRESS WITHOUT RESTRICTION. NO ADVERSE EFFECTS WILL RESULT TO NESTING BIRDS IF THESE RECOMMENDATIONS ARE IMPLEMENTED.
- 16. THE APPLICANT SHALL ENSURE THAT IF DURING DEMOLITION OR CONSTRUCTION, ANY EVIDENCE OF ARCHAEOLOGICAL TRACES (HUMAN REMAINS, ARTIFACTS, CONCENTRATION OF SHALE, BONE, ROCK, ASH) IS UNCOVERED THEN ALL CONSTRUCTION AND GRADING WITHIN A 30-FOOT RADIUS SHALL BE HALTED, THE PLANNING DEPARTMENT SHALL BE NOTIFIED, AND THE APPLICANT SHALL HIRE A QUALIFIED ARCHAEOLOGIST TO ASSESS THE SITUATION AND RECOMMEND APPROPRIATE MEASURES. UPON REVIEW OF THE ARCHAEOLOGIST'S REPORT, THE COMMUNITY DEVELOPMENT DIRECTOR, IN CONSULTATION WITH THE APPLICANT AND ARCHAEOLOGIST, WILL DETERMINE STEPS TO BE TAKEN BEFORE DEMOLITION OR CONSTRUCTION MAY CONTINUE.

#### STORM DRAIN NOTES

- ALL STORM DRAINAGE PIPES 12" IN DIAMETER OR LARGER SHALL BE ADS N-12 HDPE DOUBLE WALL PIPE OR APPROVED EQUAL.
- 2. ALL STORM DRAINAGE PIPES LESS THAN 12" DIA SHALL BE PVC SDR35 OR APPROVED
- 3. ALL PVC STORM DRAIN PIPES SHALL HAVE A MINIMUM SLOPE 1% UNLESS OTHERWISE NOTED
- 4. ALL INFILTRATION TRENCHES (PERFORATED PIPE UNDERDRAINS SHALL HAVE MINIMUM SLOPE OF 0.5% UNLESS OTHERWISE NOTED.
- 5. CONNECT ALL NEW RAIN WATER LEADERS TO PVC SD PIPE OR INFILTRATION TRENCH WITH 4" STANDARD FITTINGS.
- 6. ALL AREA DRAINS SHALL BE NDS 12x12 CATCH BASINS WITH 3/4" GRATE OPENINGS (UON).
- 7. ALL FLOW WELLS SHALL HAVE A LOW PROFILE ADAPTER WITH A 12x12 SQUARE GRATE WITH 34" GRATE OPENINGS.

#### **UTILITY NOTES**

- 1. CONTRACTOR TO COORDINATE WITH PG&E TO OBTAIN NEW ELECTRICAL SERVICE DROP.
- 2. PROVIDE GAS SHUT-OFF VALVE PER LOCAL COUNTY ORDINANCE. THE VALVE SHALL BE LOCATED TO PROTECT THE ENTIRE BUILDING.
- 3. CONTRACTOR TO COORDINATE WITH PG&E TO PROVIDE GAS METER AND TO PROVIDE GAS SERVICE CONNECTION.
- 4. CONTRACTOR SHALL COORDINATE WITH WATER COMPANY TO CHECK WATER METER AND WATER SERVICE IS OF ADEQUATE SIZE.

#### GENERAL PLUMBING NOTES

- 1. ALL SANITARY DRAINAGE PIPES SHALL BE PVC SDR35 OR APPROVED EQUAL.
- 2. PROVIDE MINIMUM OF 1/4" PER FOOT (2%) SLOPE FOR HORIZONTAL SANITARY DRAINAGE PIPE PER, CPC SECTION 708 (UON).
- 3. ALL SANITARY DRAINAGE PIPE FITTINGS SHALL BE STANDARD AND LISTED.
- 4. SANITARY CLEANOUTS SHALL BE PLACED IN ACCORDANCE WITH THE PLANS AND EXTENDED TO GRADE PER CPC SECTION 707.0 CLEANOUTS. ALL CLEANOUTS SHALL HAVE STANDARD FITTINGS AND SHALL BE GAS AND WATERTIGHT.

#### GENERAL CONSTRUCTION BMPs NOTES

- 1. STORE, HANDLE, AND DISPOSE OF CONSTRUCTION MATERIALS AND WASTES PROPERLY, SO AS TO PREVENT THEIR CONTACT WITH STORMWATER.
- 2. CONTROL AND PREVENT THE DISCHARGE OF ALL POTENTIAL POLLUTANTS, INCLUDING PAVEMENT CUTTING WASTES, PAINTS, CONCRETE, PETROLEUM PRODUCTS, CHEMICALS, WASHWATER OR SEDIMENTS, AND NON-STORMWATER DISCHARGES TO STORM DRAINS AND WATERCOURSES.
- 3. USE SEDIMENT CONTROLS OR FILTRATION TO REMOVE SEDIMENT WHEN DEWATERING SITE AND OBTAIN ALL NECESSARY PERMITS.
- 4. AVOID CLEANING, FUELING, OR MAINTAINING VEHICLES ON-SITE, EXCEPT IN A DESIGNATED AREA WEHRE WASHWATER IS CONTAINED AND TREATED.
- 5. DELINEATE WITH FIELD MARKERS CLEARING LIMITS, EASEMENTS, SETBACKS, SENSITIVE OR CRITICAL AREAS, BUFFER ZONES, TREES AND DRAINAGE COURSES.
- 6. PROTECT ADJACENT PROPERTIES AND UNDISTURBED AREAS FROM CONSTRUCTION IMPACTS USING VEGETATIVE BUFFER STRIPS, SEDIMENT BARRIERS OR FILTERS, DIKES, MULCHING, OR OTHER MEASURES AS APPROPRIATE.
- 7. PERFORM CLEARING AND EARTH MOVING ACTIVITIES ONLY DURING DRY WEATHER.
- 8. LIMIT AND TIME APPLICATIONS OF PESTICIDES AND FERTILIZERS TO PREVENT POLLUTED RUNOFF
- 9. LIMIT CONSTRUCTION ACCESS ROUTES AND STABILIZE DESIGNATED ACCESS POINTS.

11. THE CONTRACTOR SHALL TRAIN AND PROVIDE INSTRUCTION TO ALL EMPLOYEES AND

SUBCONTRACTORS REGARDING THE CONSTRUCTION BMPs.

10. AVOID TRACKING DIRT OR OTHER MATERIALS OFF-SITE; CLEAN OFF-SITE PAVED AREAS AND SIDEWALKS USING DRY SWEEPING METHODS.





JET ENGINEERING


CONSULTING CIVIL ENGINEERS 1048 EL CAMINO REAL, SUITE C REDWOOD CITY, CA 94063 LANDS OF CAMILLERI
1462 EDGEWOOD RD


**REDWOOD CITY, CA 94062** 


**GENERAL CONSTRUCTION NOTES** 

		REVISIONS		JOB NO.	R1462-E-18
NO.	DATE	DESCRIPTION	BY	DATE :	03/10/21
				DRAWN:	DC
				CHECKED:	JET
				SCALE:	NTS

C2.0

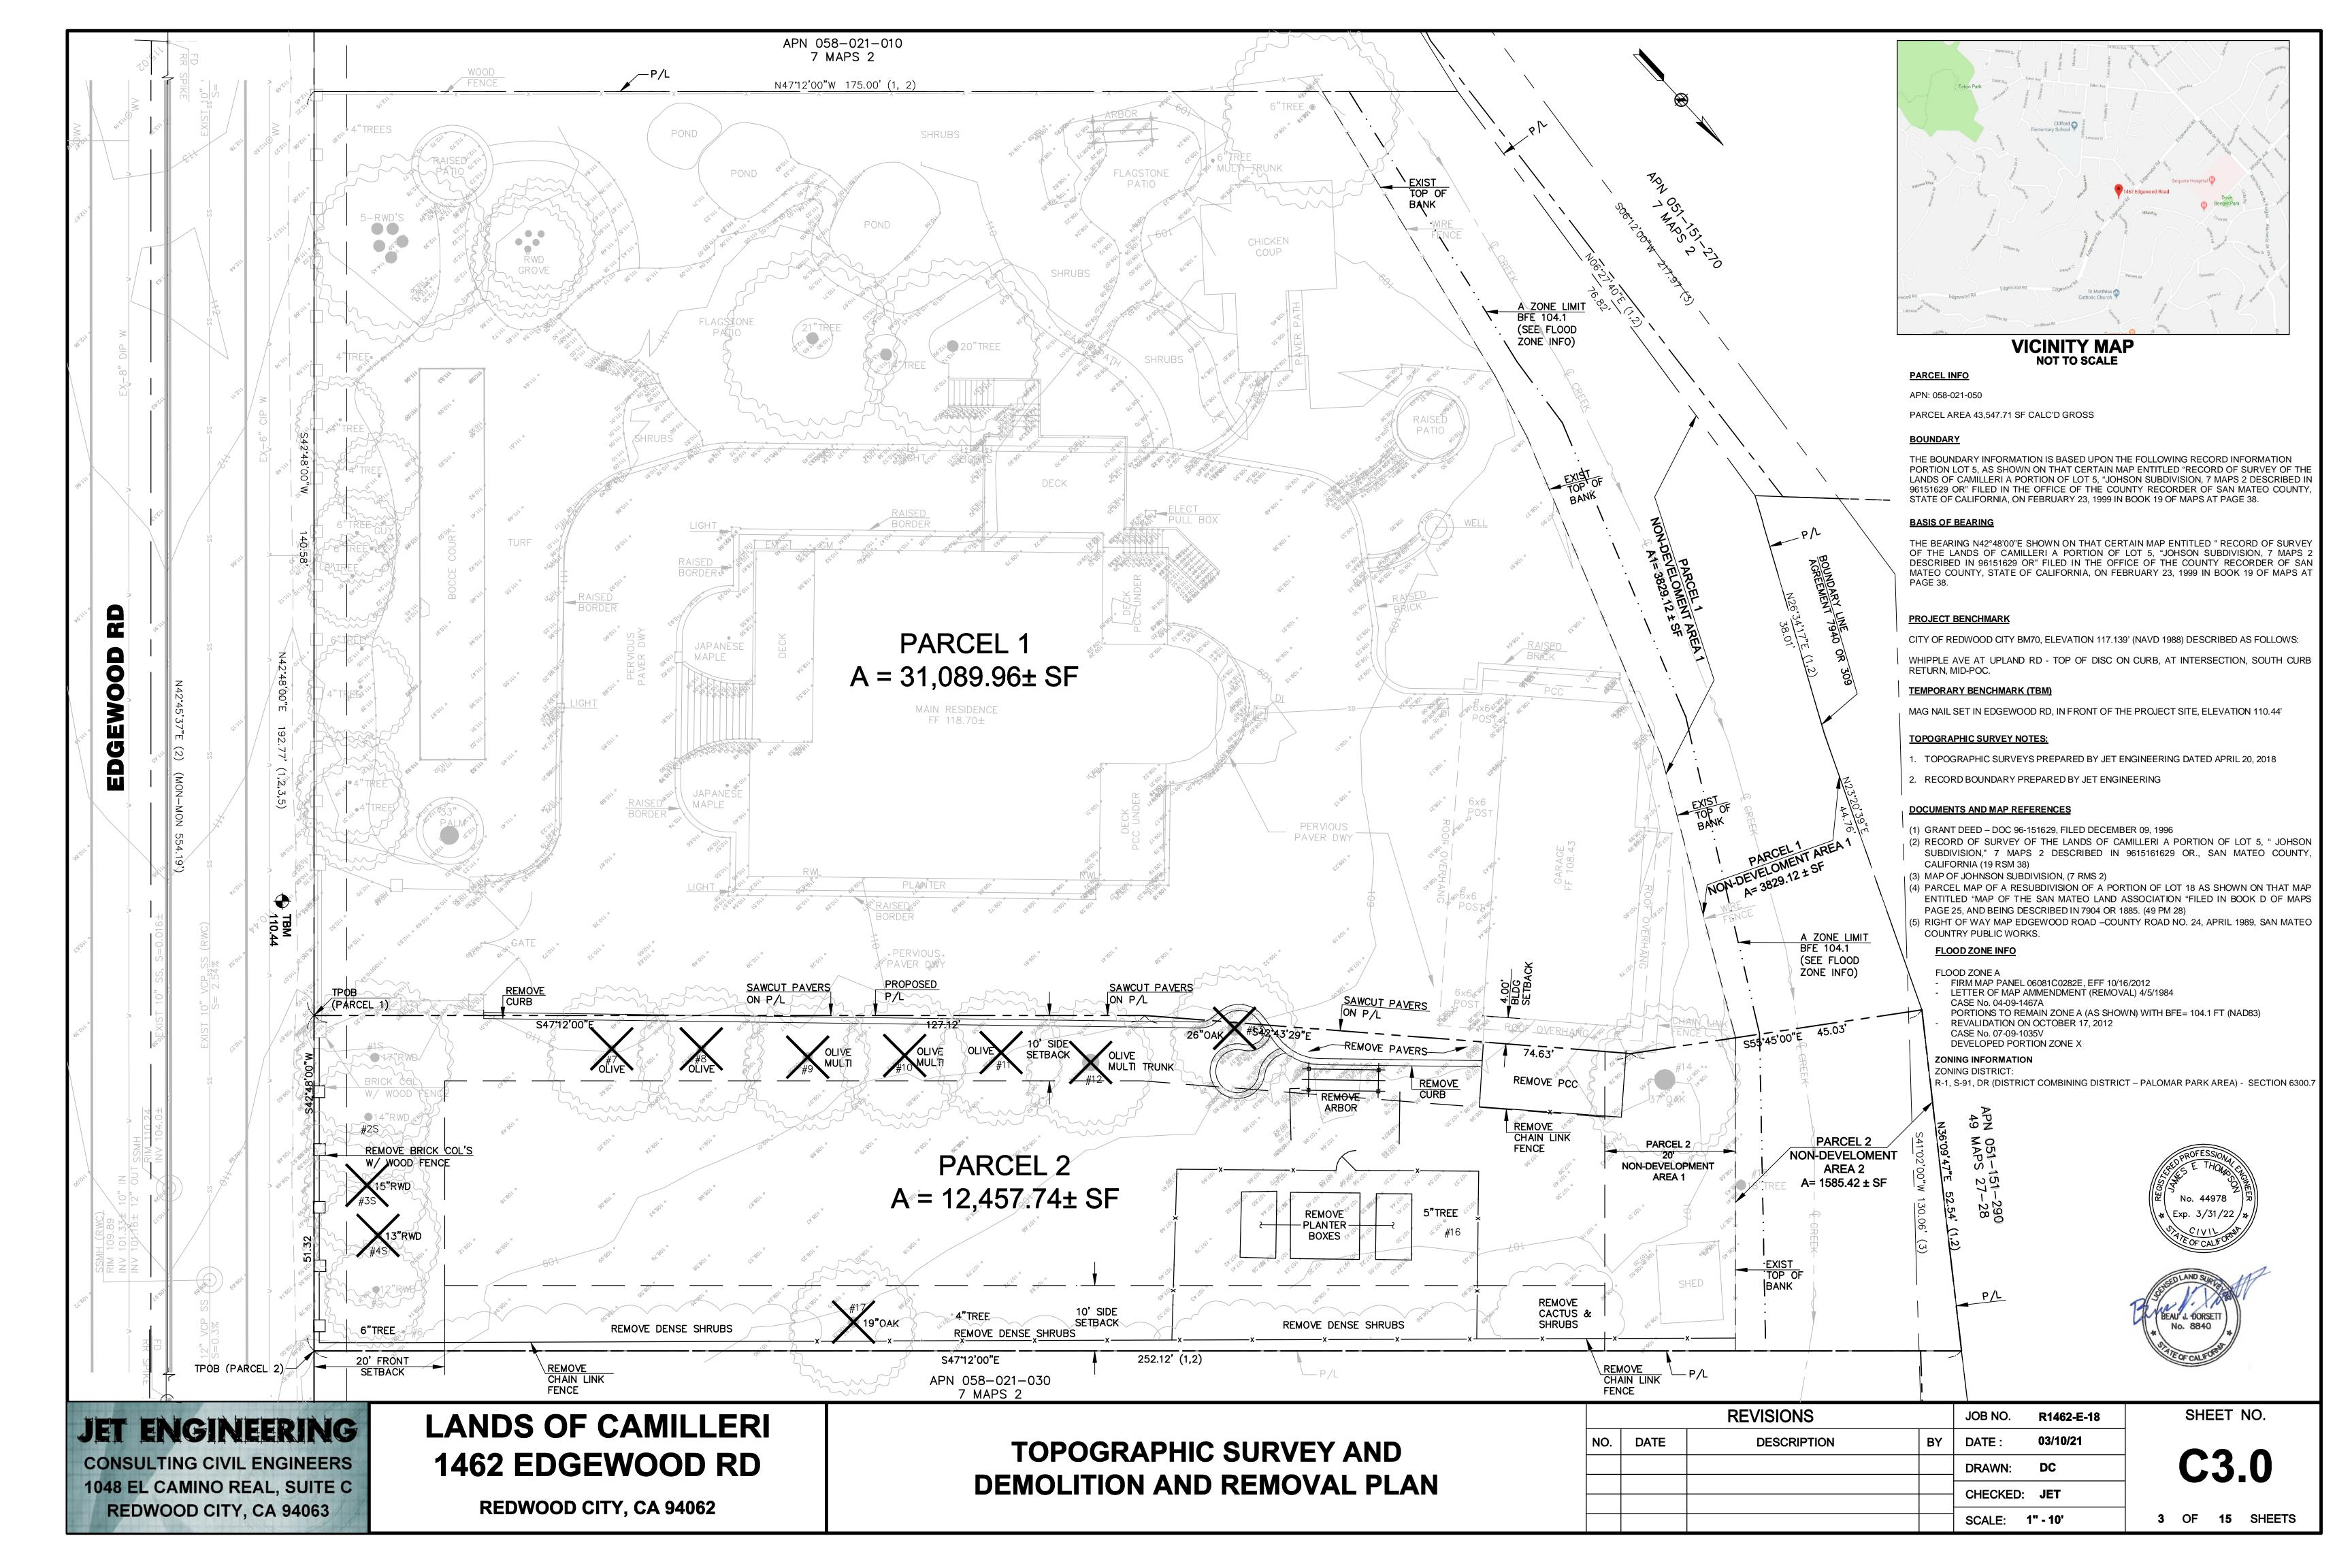

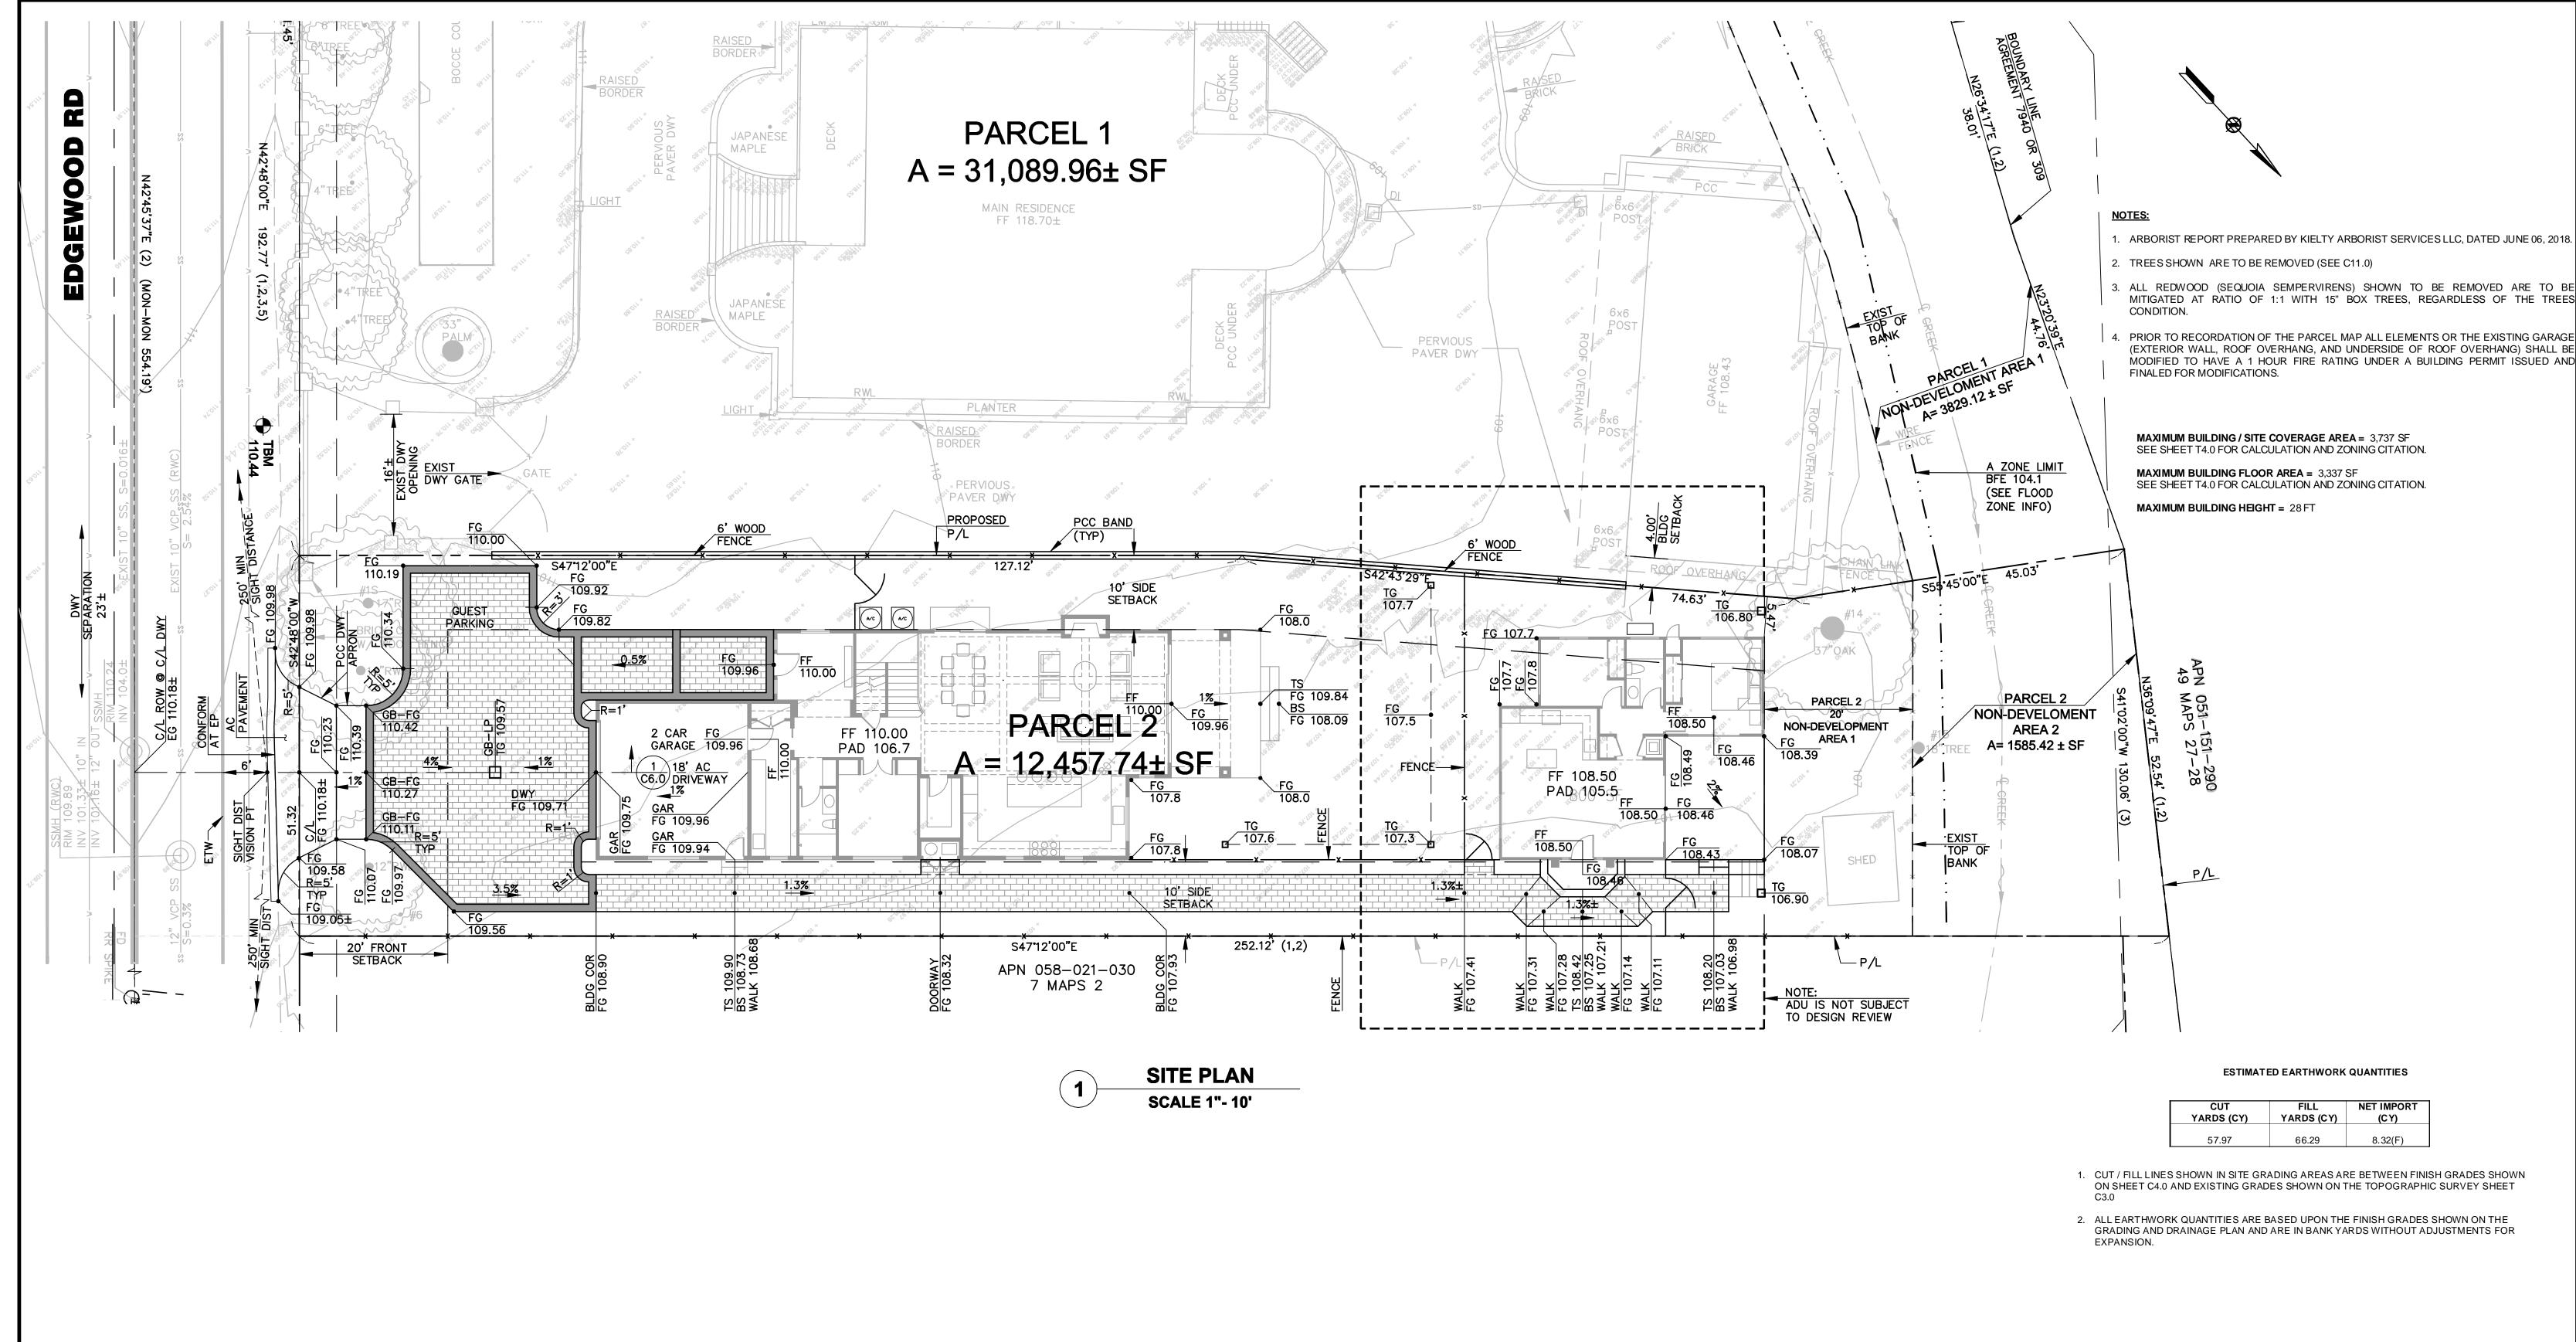

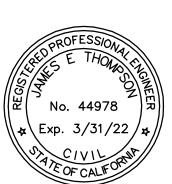

# JET ENGINEERING

CONSULTING CIVIL ENGINEERS
1048 EL CAMINO REAL, SUITE C
REDWOOD CITY, CA 94063


LANDS OF CAMILLERI
1462 EDGEWOOD RD

**REDWOOD CITY, CA 94062** 

PARCEL 2
SITE AND GRADING PLAN

		REVISIONS	JOB NO. <b>R1462-E-18</b>	
NO.	DATE	DESCRIPTION	BY	DATE: <b>03/10/21</b>
				DRAWN: DC
				CHECKED: <b>JET</b>
				SCALE: 1" - 10'

SHEET NO.

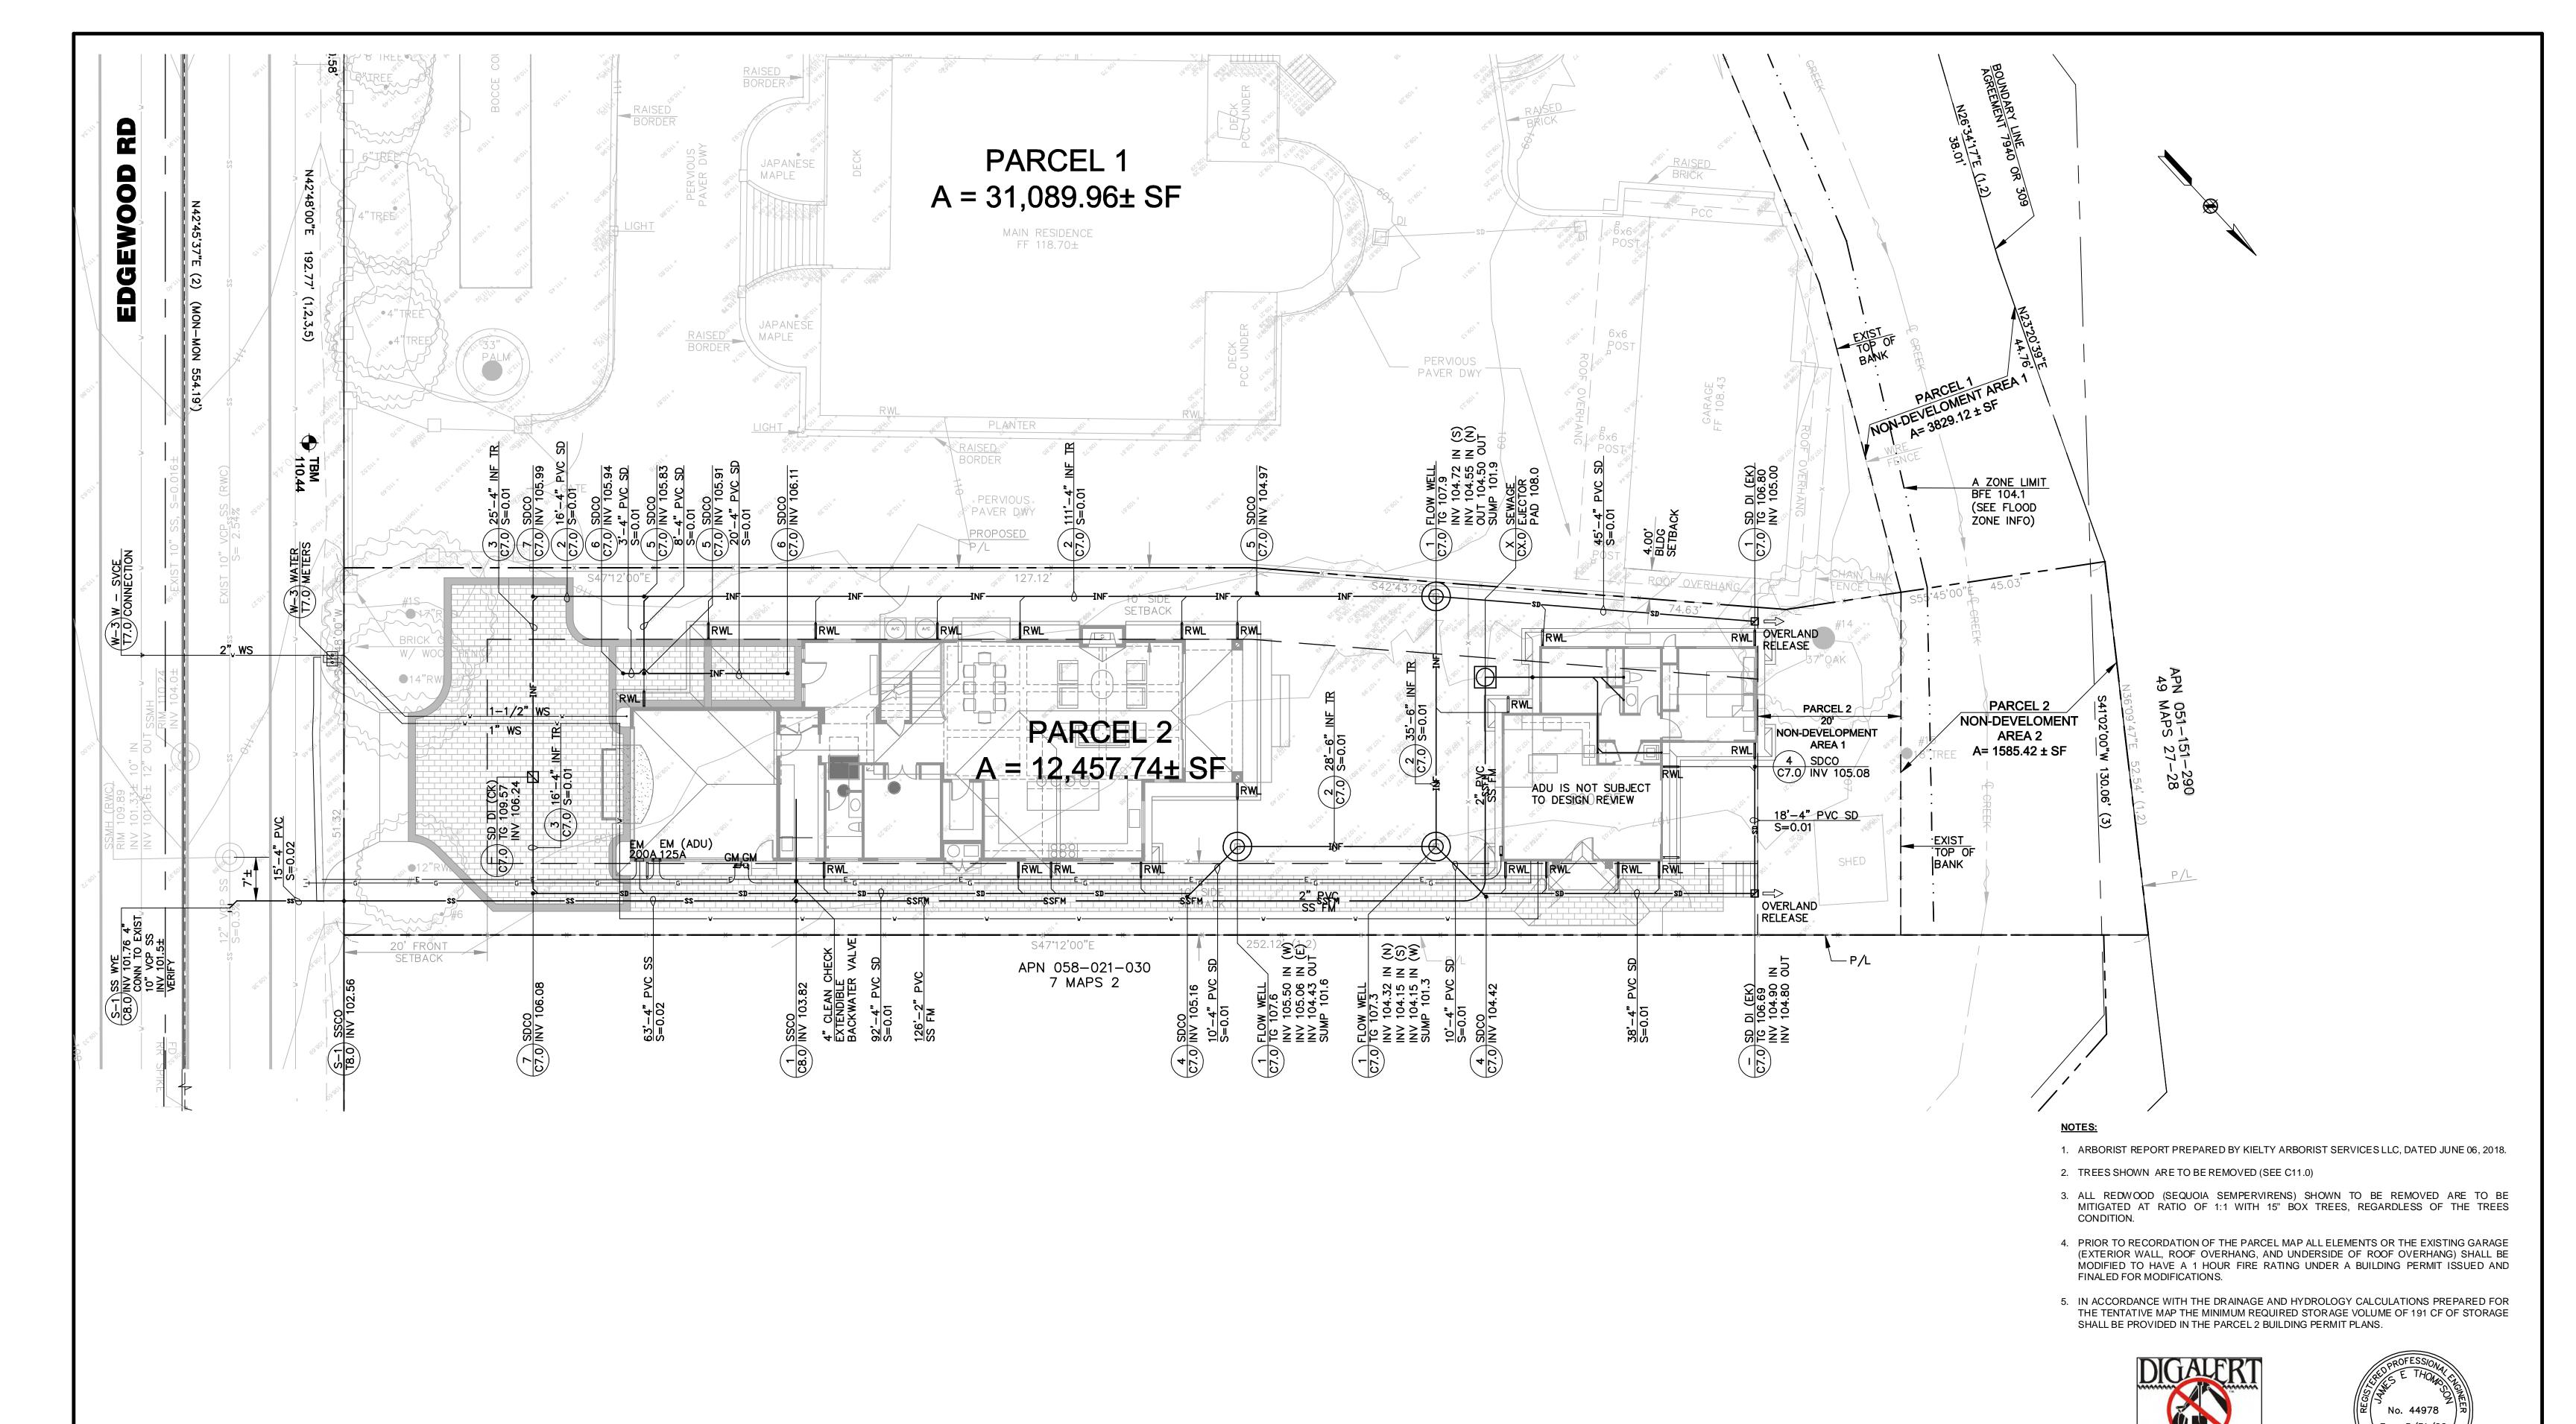

JET ENGINEERING

CONSULTING CIVIL ENGINEERS
1048 EL CAMINO REAL, SUITE C
REDWOOD CITY, CA 94063

LANDS OF CAMILLERI 1462 EDGEWOOD RD


**REDWOOD CITY, CA 94062** 

DRAINAGE AND UTILITY PLAN


		REVISIONS		JOB NO.	R1462-E-18
NO.	DATE	DESCRIPTION	BY	DATE:	03/10/21
				DRAWN:	DC
				CHECKED:	JET
				SCALE: 1	l" - 10'

800-227-2600


SHEET NO.

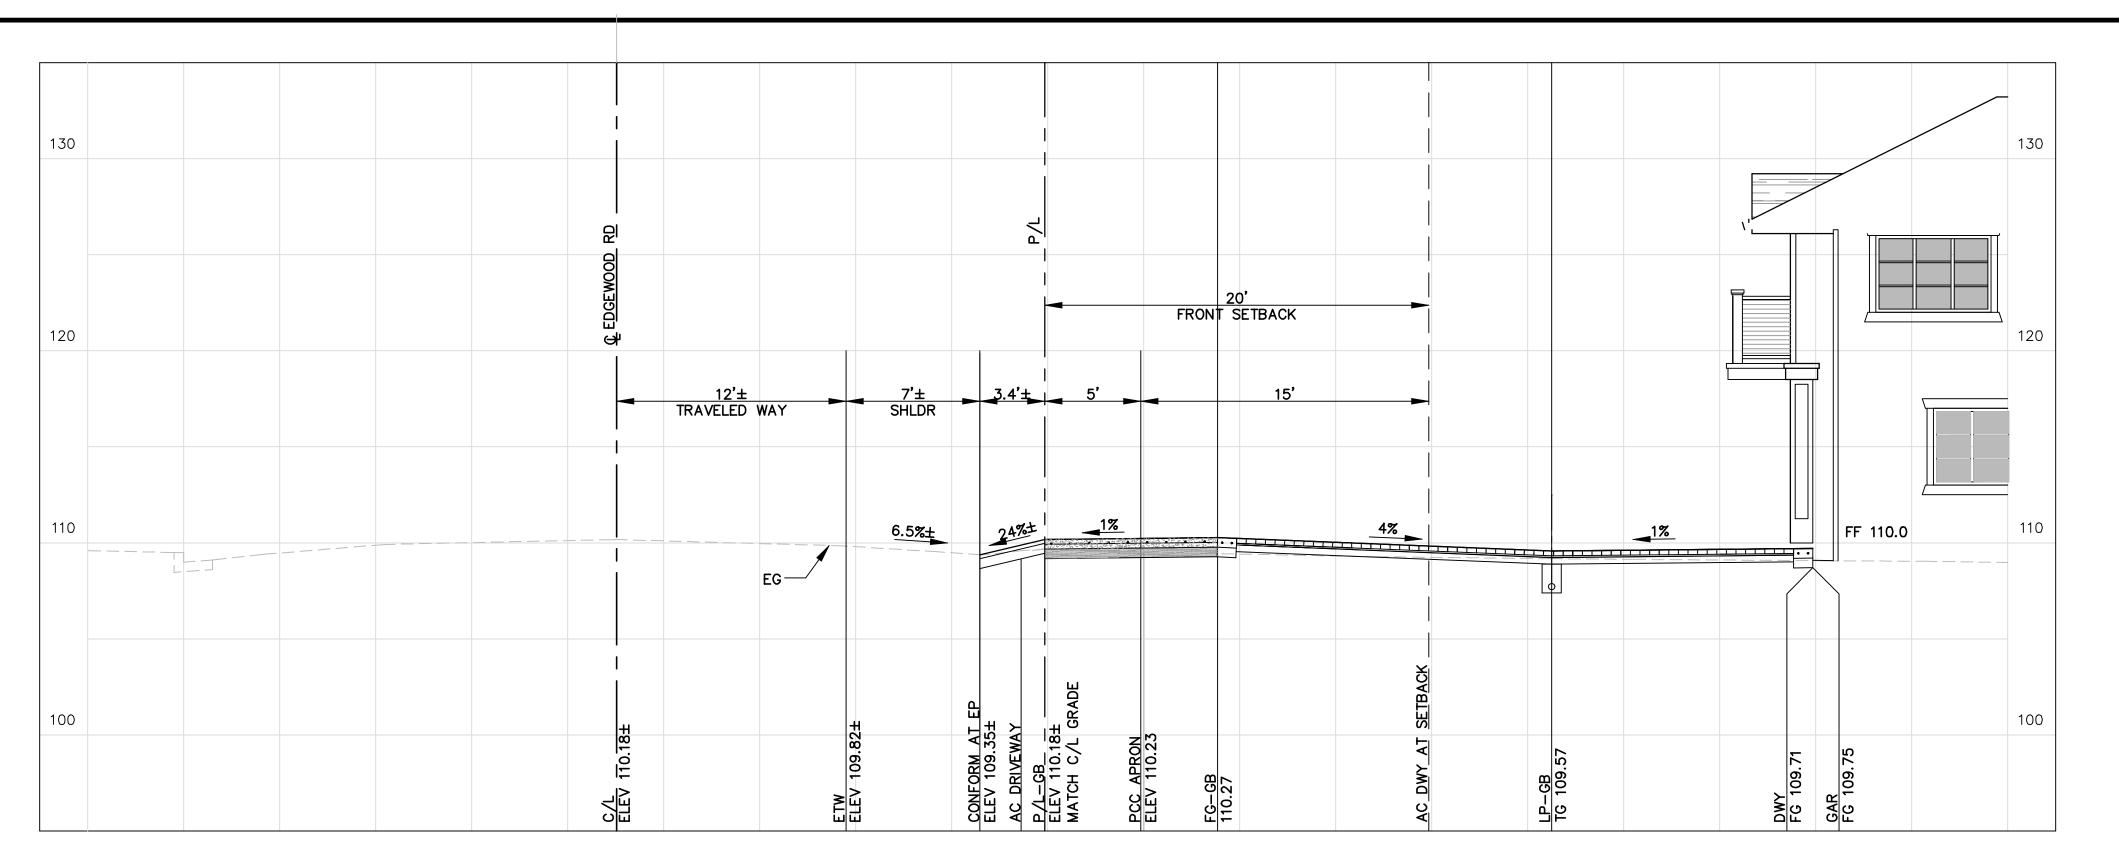




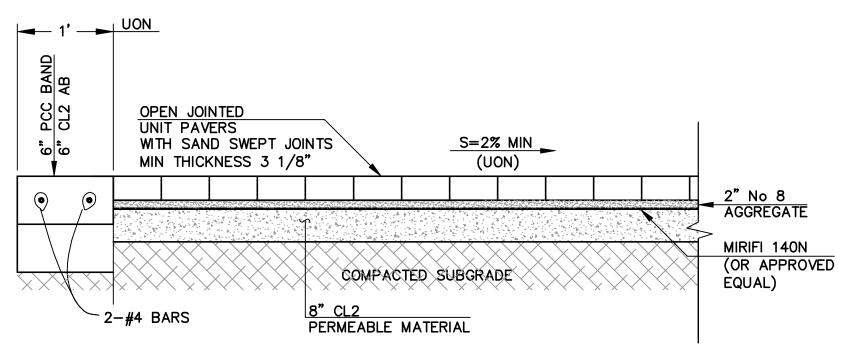


PERMEABLE PAVEMENT  $oldsymbol{(2)}$ **DWY SECTION SCALE 1"-1'** 

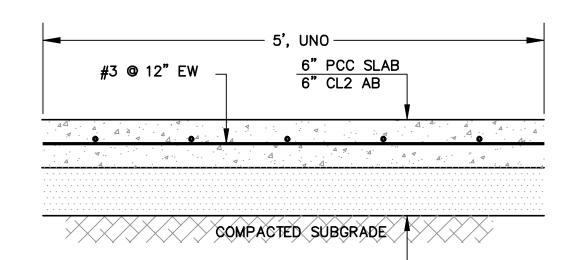


PCC DRIVEWAY APRON **SCALE 1"-1"** 

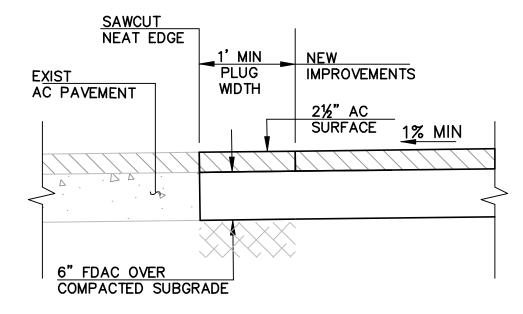


**AC DRIVEWAY SCALE 1"-1'** 

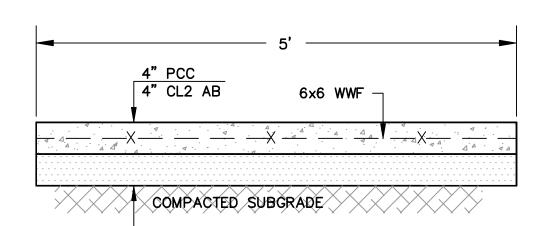

PCC WALK / PATIO **SCALE 1"-1'** 

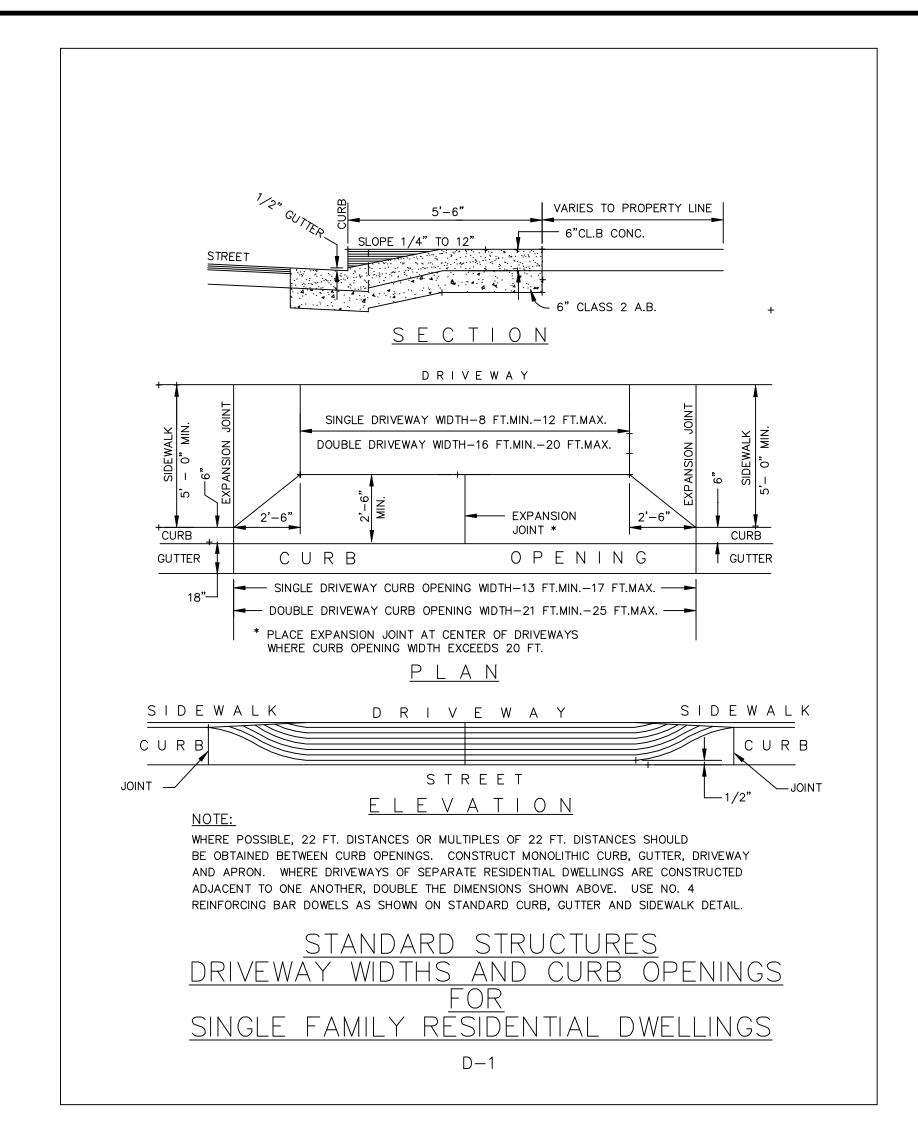

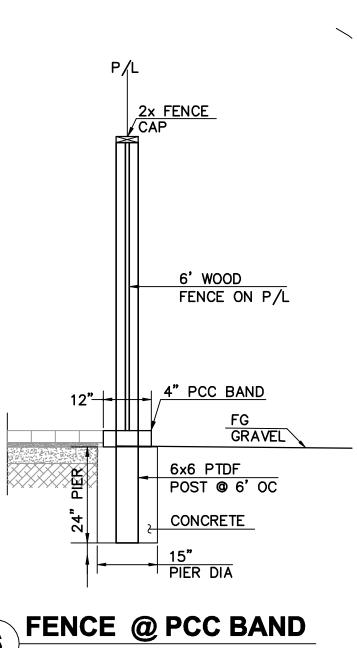

6 FENCE @ PCC BAND **SCALE 1"-1'** 



# JET ENGINEERING

**CONSULTING CIVIL ENGINEERS** 1048 EL CAMINO REAL, SUITE C **REDWOOD CITY, CA 94063** 


### LANDS OF CAMILLERI 1462 EDGEWOOD RD

**REDWOOD CITY, CA 94062** 

**DRIVEWAY SECTION AND DETAILS** 

		REVISIONS		JOB NO. <b>R1462-E-18</b>
NO.	DATE	DESCRIPTION	BY	DATE: 03/10/21
				DRAWN: DC
				CHECKED: <b>JET</b>
				SCALE: AS SHOWN

SHEET NO. **C6.0** 

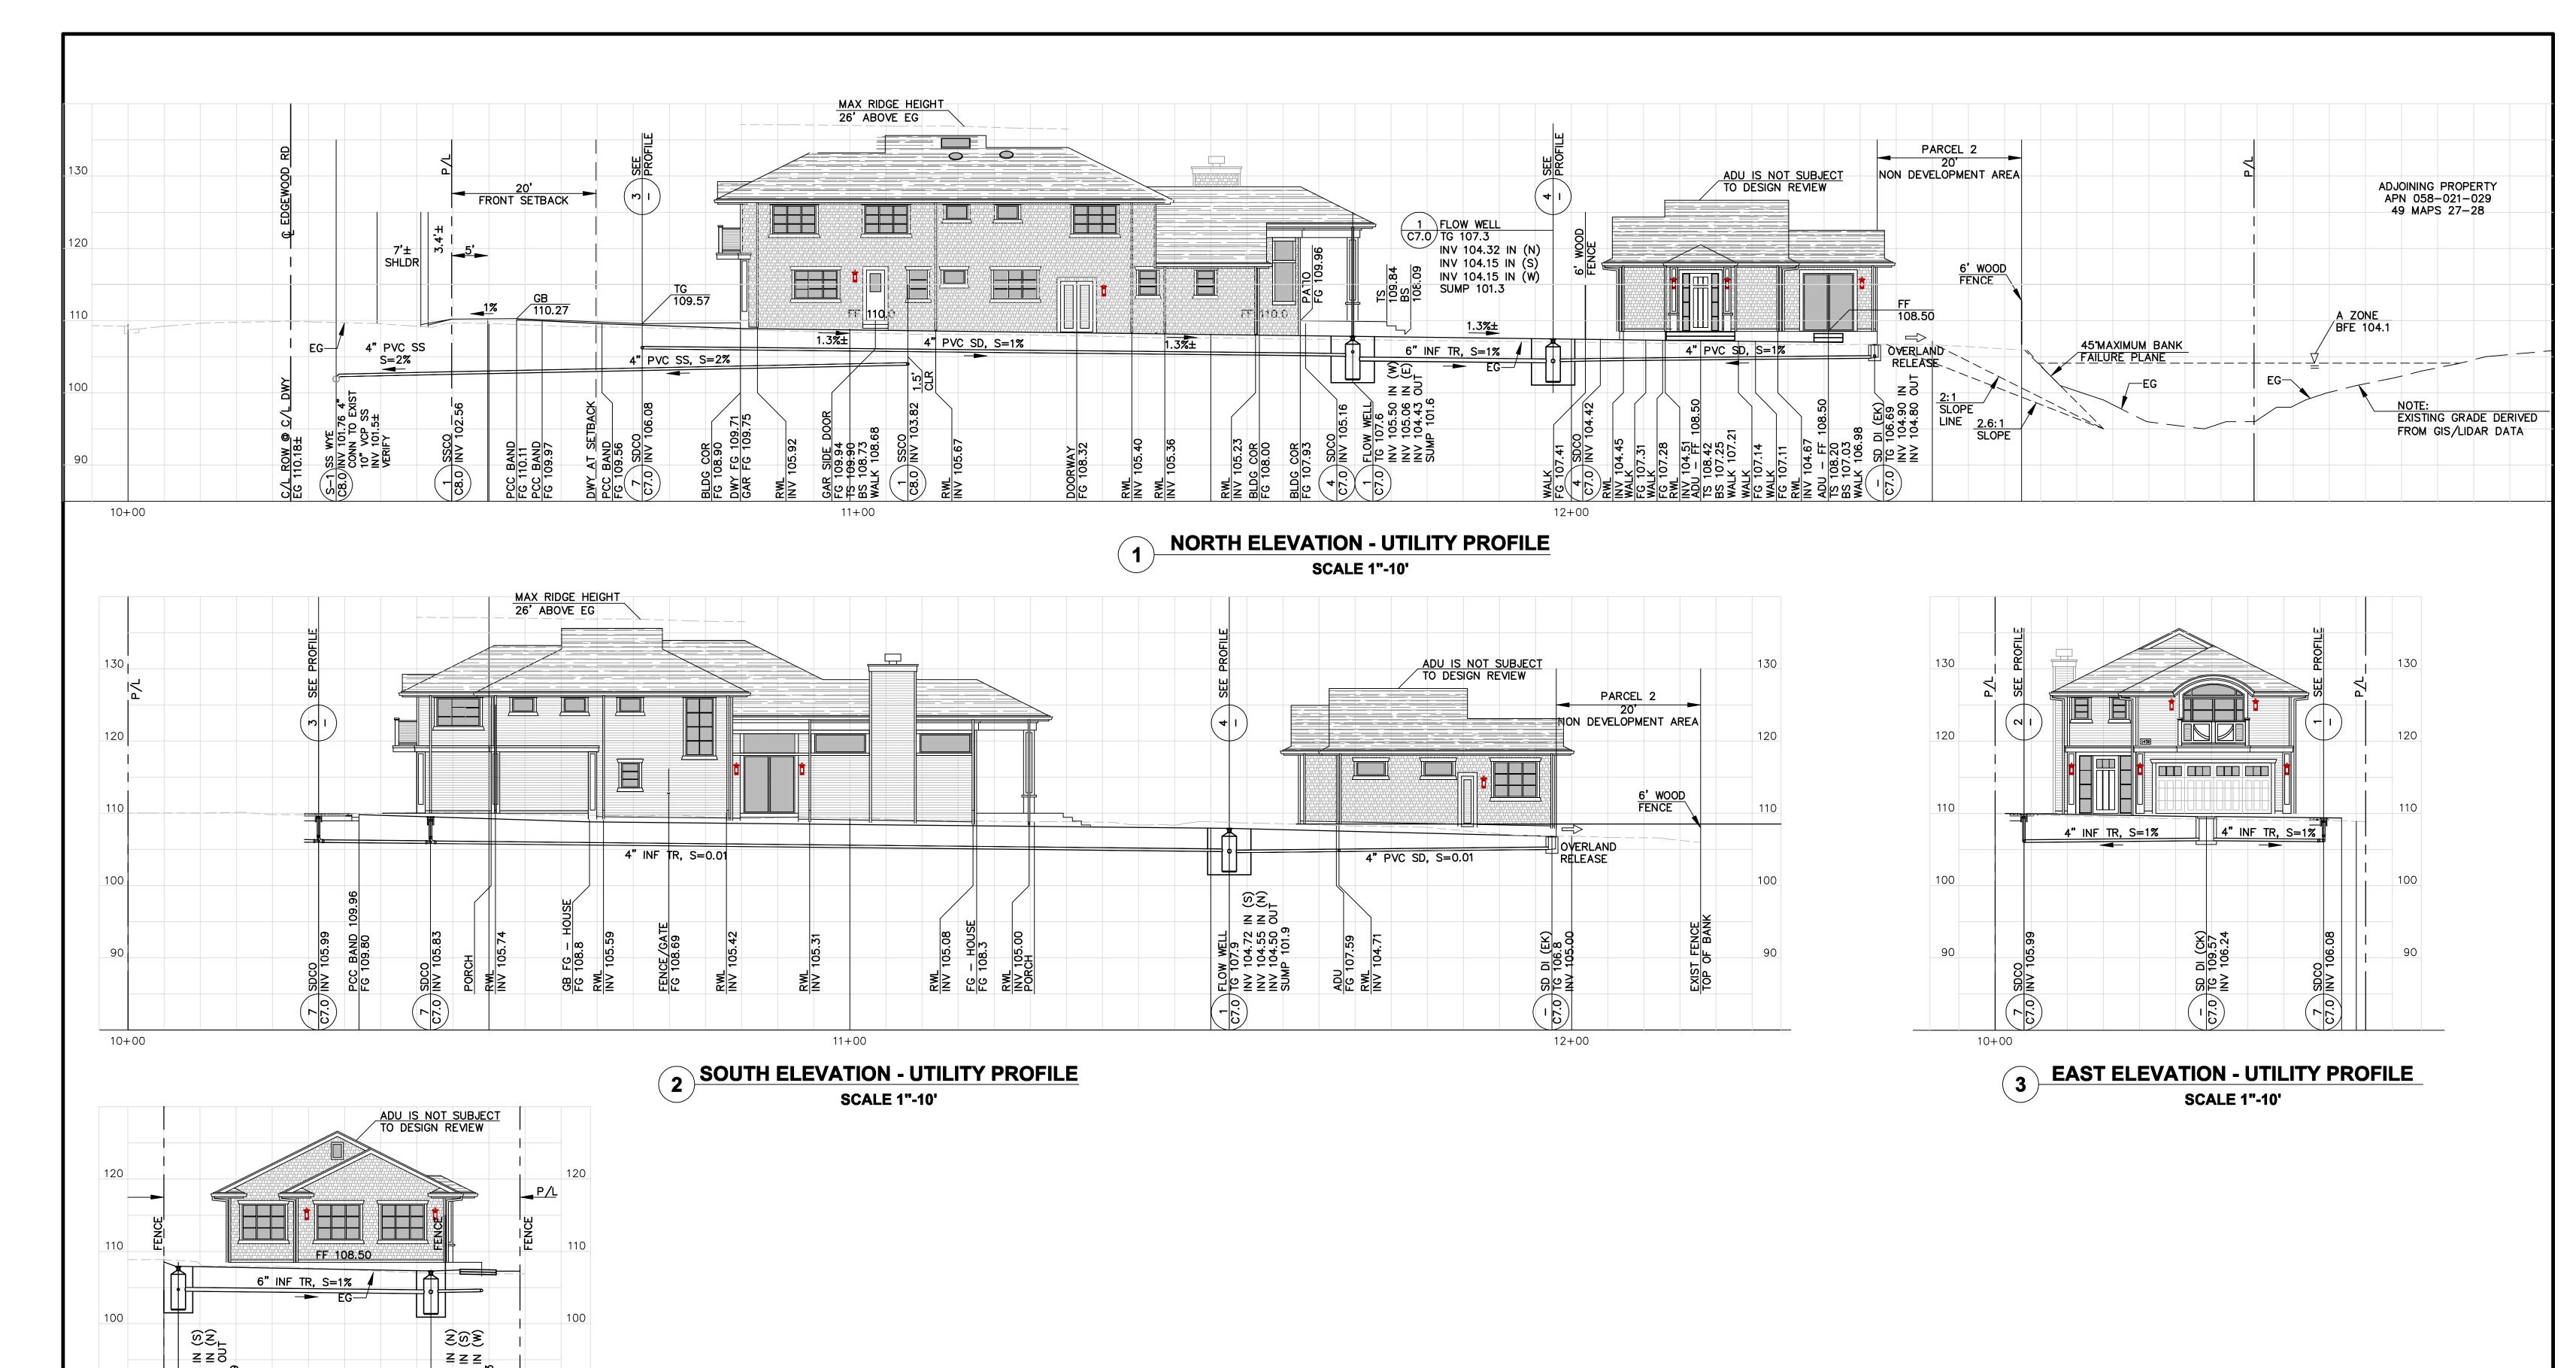





DIGALERI

**ADU SOUTH ELEVATION - UTILITY PROFILE SCALE 1"-10'** 

JET ENGINEERING

**CONSULTING CIVIL ENGINEERS** 1048 EL CAMINO REAL, SUITE C **REDWOOD CITY, CA 94063** 

LANDS OF CAMILLERI 1462 EDGEWOOD RD


**REDWOOD CITY, CA 94062** 

**UTILITY PROFILES AND ELEVATIONS** 

	REVISIONS				R1462-E-18
NO.	DATE	DESCRIPTION	BY	DATE:	03/10/21
				DRAWN:	DC
				CHECKED:	JET
				SCALE:	AS SHOWN

**C6.1** 

SHEET NO.

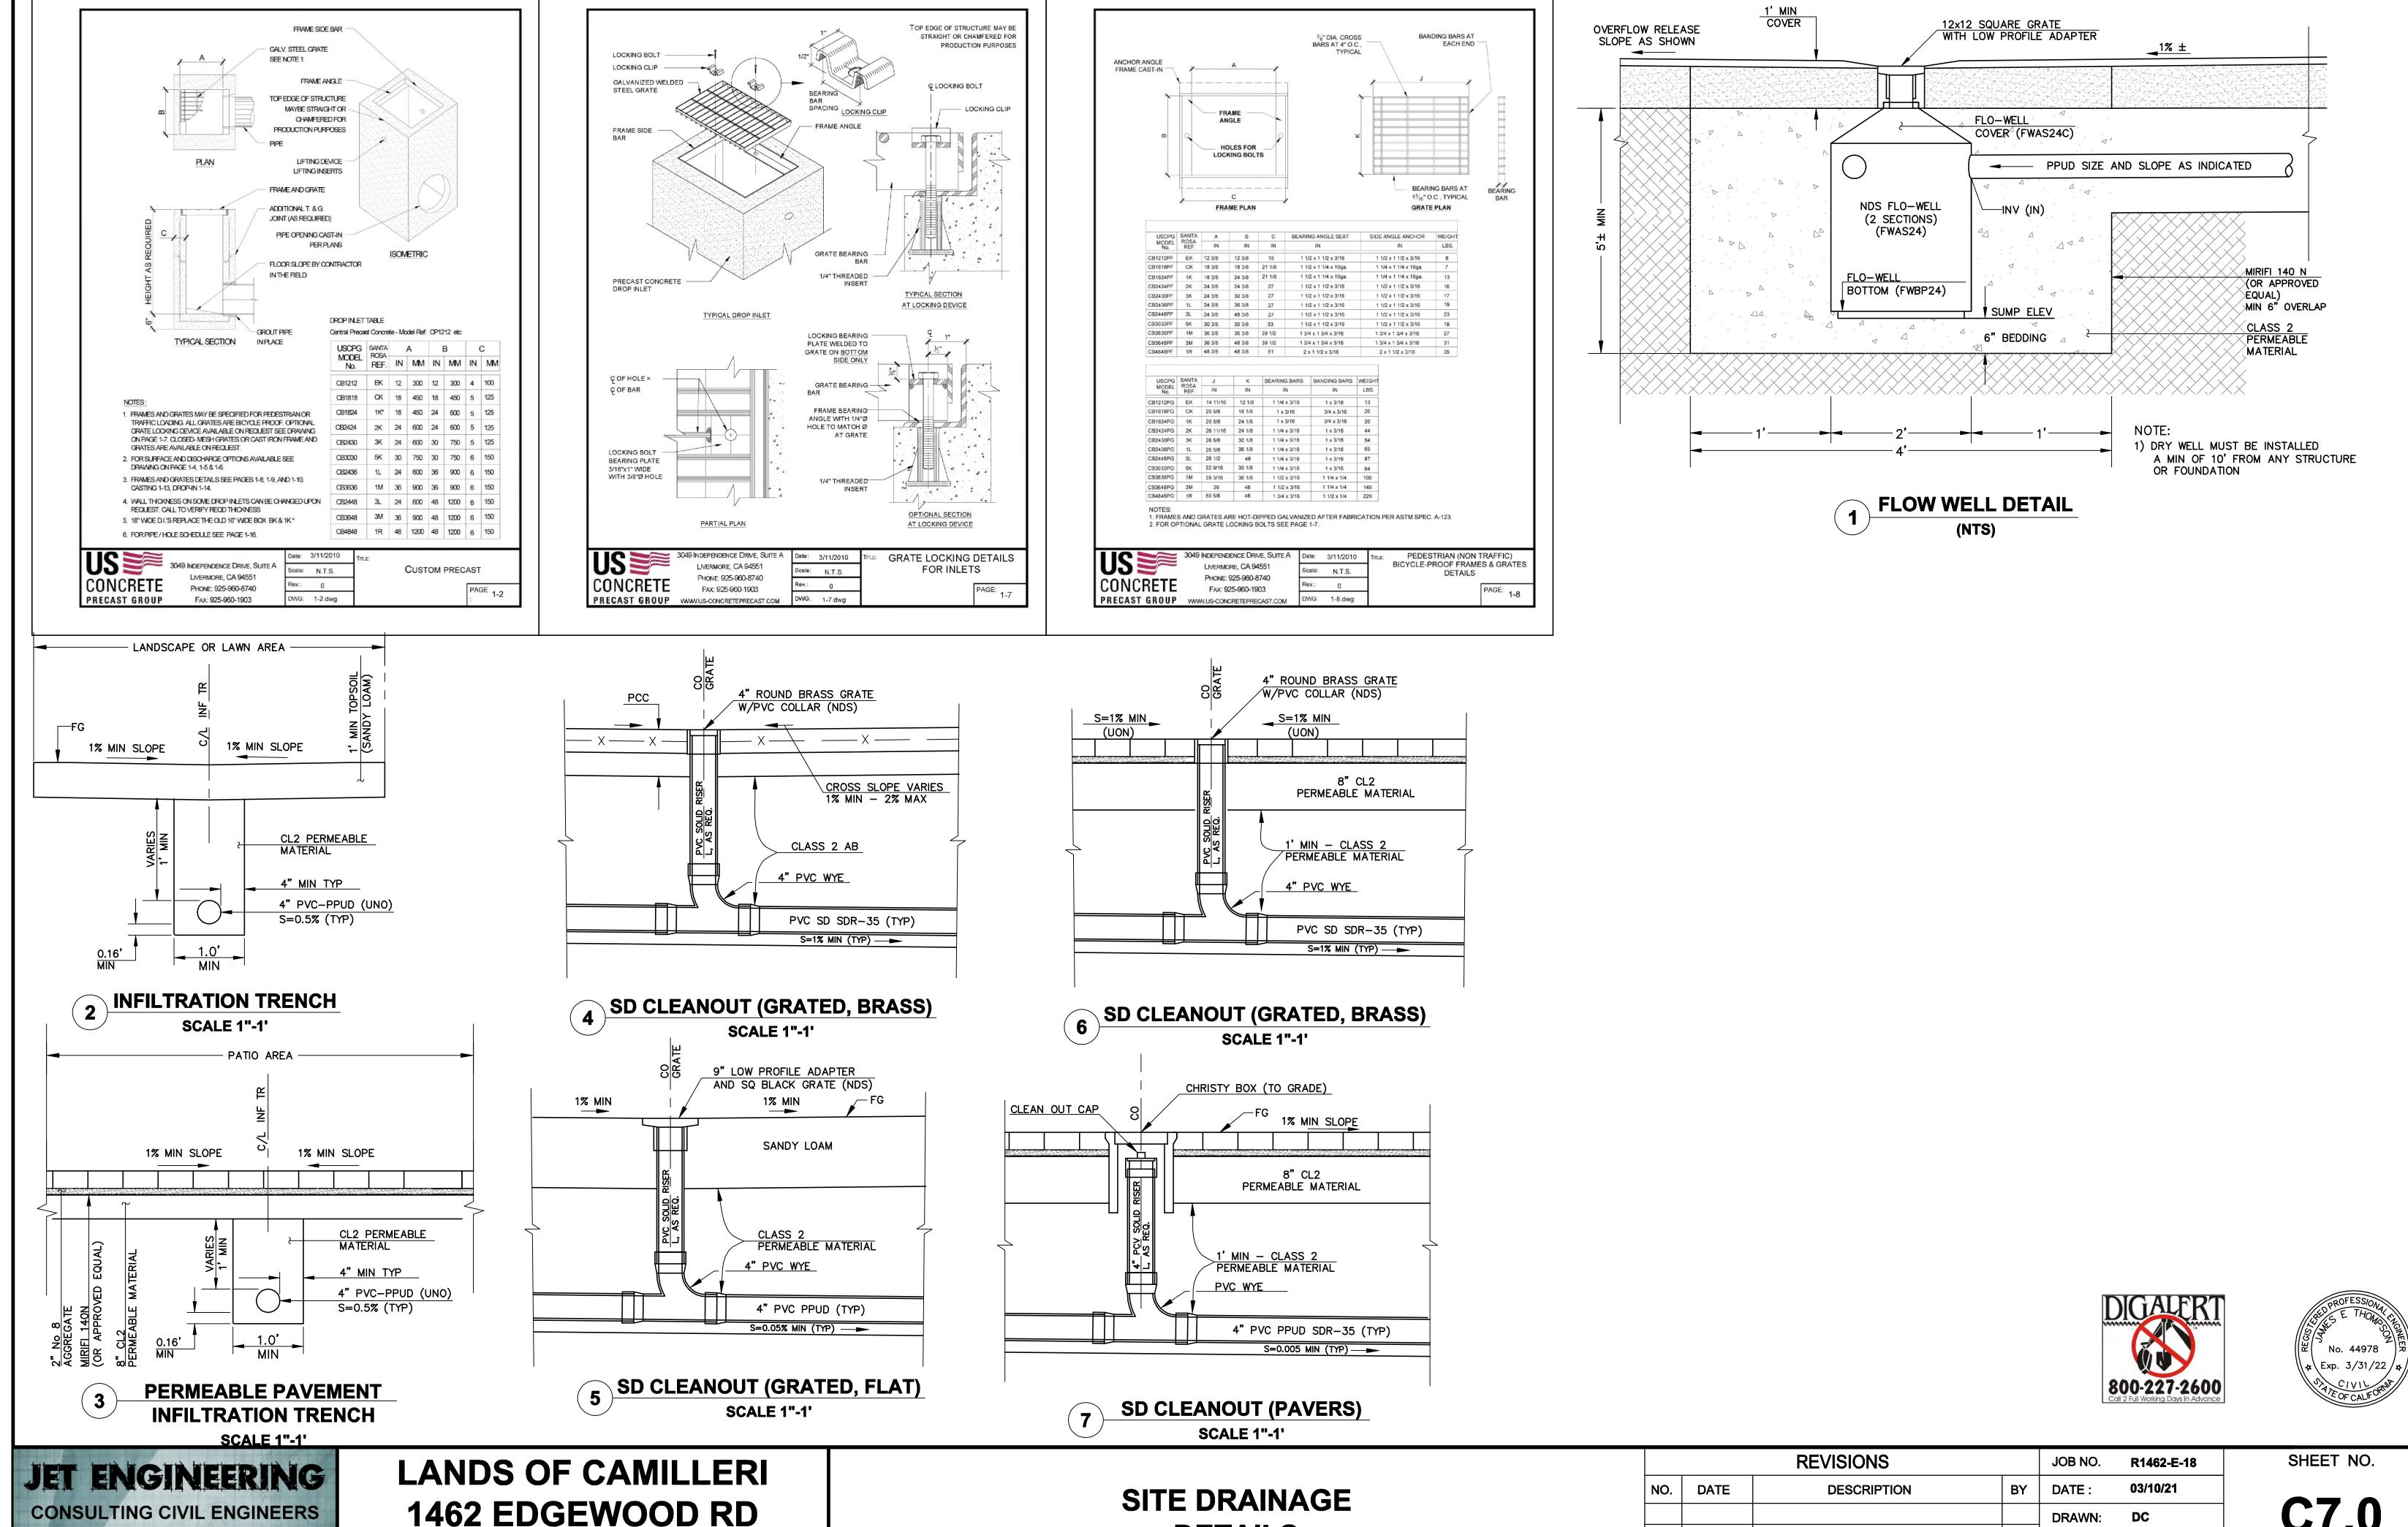

**DETAILS** 

1048 EL CAMINO REAL, SUITE C

**REDWOOD CITY, CA 94063** 


**REDWOOD CITY, CA 94062** 


C7.0

8 OF 15 SHEETS

CHECKED: **JET** 

SCALE: AS SHOWN

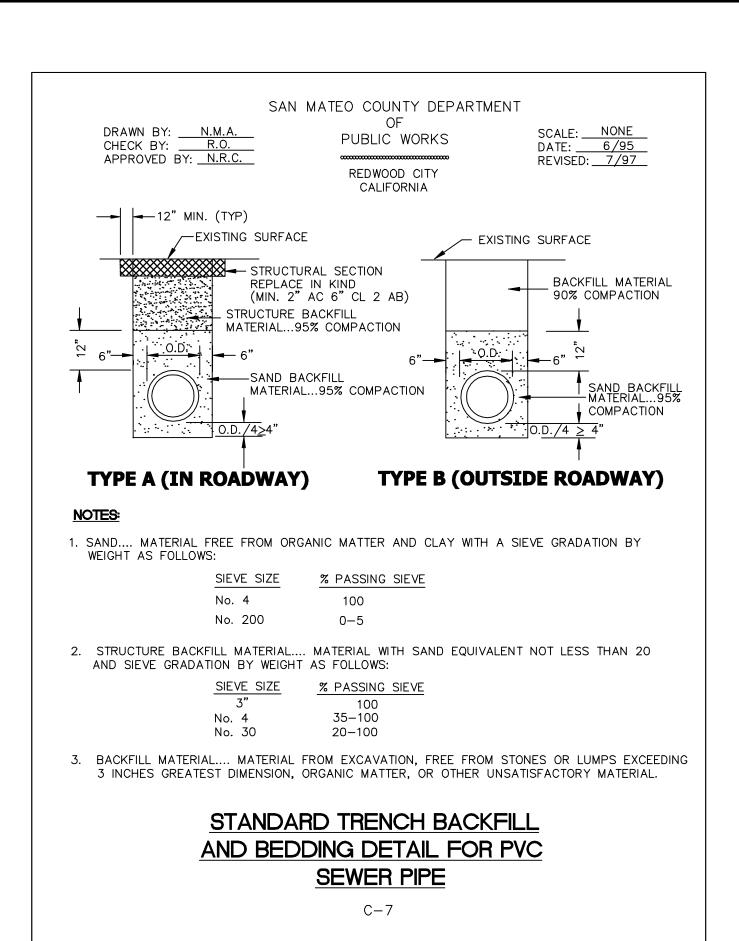

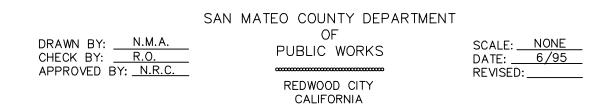

#### SAN MATEO COUNTY SEWER AND SANITATION DISTRICTS STANDARD SPECIFICATIONS

#### GENERAL NOTES

- 1. ALL REFERENCES TO "DISTRICT" IN THESE GENERAL NOTES SHALL MEAN THE APPROPRIATE COUNTY SEWER OR SANITATION DISTRICT.
- 2. THE APPROVAL OF THESE PLANS BY THE DISTRICT SHALL BE INTERPRETED TO MEAN THAT THE SANITARY SEWER DESIGN SHOWN ON THESE PLANS MEETS THE DISTRICT'S STANDARDS. THE DISTRICT'S APPROVAL IN NO WAY GUARANTEES ANY OTHER ASPECT OF THIS PLAN OR ITS ACCURACY RELATIVE TO ACTUAL FIELD CONDITIONS.
- 3. THE CONTRACTOR SHALL CONTACT THE DISTRICT AT 363-4765 OR 363-4100 TWO (2) WOKING DAYS IN ADVANCE OF BEGINNING ANY SANITARY SEWER WORK. THE CONTRACTOR SHALL THEREAFTER KEEP THE INSPECTOR FOR THE DISTRICT INFORMED OF HIS SCHEDULE FOR SANITARY SEWER WORK.
- 4. ALL SANITARY SEWER WORK CONSTRUCTED WITHOUT INSPECTION BY THE DISTRICT SHALL BE REMOVED AND RECONSTRUCTED WITH INSPECTION.
- 5. THE CONTRACTOR SHALL CONTACT UNDERGROUND SERVICE ALERT FORTY-EIGHT (48) HOURS IN ADVANCE OF BEGINNING ANY WORK.
- 6. THE CONTRACTOR SHALL FIELD VERIFY THE LOCATION OF ALL UTILITIES BEFORE BEGINNING ANY EXCAVATING.
- 7. THE CONTRACTOR SHALL OBTAIN ANY AND ALL PERMITS REQUIRED BY THE COUNTY OR CITY BEFORE BEGINNING ANY SANITARY SEWER WORK.
- 8. UPON THE COMPLETION OF CONSTRUCTION A COMPLETE SET OF REPRODUCIBLE "AS—CONSTRUCTED" PLANS SHALL BE PROVIDED TO THE DISTRICT.

SERVICE DURING CONSTRUCTION.

- 9. SANITARY SEWER SERVICE SHALL BE MAINTAINED AT ALL TIMES. THE CONTRACTOR SHALL USE WHATEVER MEANS ARE NECESSARY (E.G. PUMPS, ETC.) TO MAINTAIN THIS
- 10. PRIOR TO COMMENCING ANY SANITARY SEWER WORK IN OFF—SITE EASEMENTS THE CONTRACTOR SHALL PROVIDE THE DISTRICT WITH ADEQUATE EVIDENCE THAT ALL AFFECTED PROPERTY OWNERS (AND TENANTS WHERE APPLICABLE) WERE NOTIFIED WELL IN ADVANCE OF THE DATE WORK IN THESE EASEMENTS WAS TO BEGIN AND THAT THEY HAVE UPDATED THAT NOTICE IN A TIMELY MANNER WHEN THOSE DATES HAVE CHANGED.

C-13

#### SAN MATEO COUNTY DEPARTMENT

DRAWN BY: N.M.A.
CHECK BY: R.O.
APPROVED BY: N.R.C.

PUBLIC WORKS

REDWOOD CITY
CALIFORNIA

OF

SCALE: NONE
DATE: 6/95
REVISED: \_\_\_\_

#### SAN MATEO COUNTY SEWER AND SANITATION DISTRICTS STANDARD SPECIFICATIONS

#### TESTING REQUIREMENTS

- 1. ALL REFERENCES TO "DISTRICT" IN THESE TESTING REQUIREMENTS SHALL MEAN THE APPROPRIATE COUNTY SEWER OR SANITATION DISTRICT.
- 2. ALL REQUIRED CLEANING AND TESTING OF SANITARY SEWER MAINS AND LATERALS SHALL BE PERFORMED IN THE PRESENCE OF A REPRESENTATIVE OF THE DISTRICT.
- 3. ALL SANITARY SEWER MAINS BEING CONSTRUCTED SHALL BE CLEANED BY MEANS OF A HIGH SPEED JET RODDER PRIOR TO TESTING. VCP AND DIP SHALL BE TESTED FOR OBSTRUCTION BY BALL ROLLING.
- 4. ALL SANITARY SEWER MAINS BEING CONSTRUCTED SHALL PASS A LOW PRESSURE AIR TEST. EACH SECTION OF MAIN SHALL BE TESTED BETWEEN SUCCESSIVE MANHOLES. THE LOW PRESSURE AIR TEST SHALL BE CONDUCTED IN THE FOLLOWING MANNER.

A COMPRESSED AIR SUPPLY SHALL BE ATTACHED TO AN AIR FITTING ON THE MAIN AND THE AIR PRESSURE WITHIN THE LINE INCREASED TO FOUR (4) POUNDS PER SQUARE INCH. (PSI). AFTER THE AIR SUPPLY IS SECURELY TURNED OFF OR DISCONNECTED, THERE SHALL BE A TWO (2) MINUTE WAITING PERIOD BEFORE THE ACTUAL TEST PERIOD BEGINS TO ALLOW STABILIZATION OF AIR WITHIN THE MAIN.

IN NO CASE SHALL THE AIR PRESSURE WITHIN THE LINE BE LESS THAN 3.5 PSI AT THE BEGINNING OF THE TEST PERIOD. REFER TO THE CHART WHICH FOLLOWS FOR THE LENGTH OF THE TEST PERIOD. THE MINIMUM LENGTH OF TEST IS TWO (2) MINUTES). THE ALLOWABLE AIR PRESSURE LOSS DURING THE TEST PERIOD SHALL BE 1.0 PSI. A WRITTEN RECORD OF THE TEST SHALL BE SUBMITTED TO THE DISTRICT BY THE CONTRACTOR.

NOMINAL PIPE SIZE (inches)	LENGTH OF LINE (feet)	LENGTH OF TEST (minutes)
4 6 6 8 8 8 8 8 10 10 10	ALL 0 - 300 300 - 370 370 AND GREATER 0 - 170 170 - 210 210 - 250 250 - 290 290 AND GREATER 0 - 110 110 - 165 165 - 215 215 AND GREATER	2 2 2 1/2 3 2 2 1/2 3 3 1/2 3 3/4 2 3 4 4 3/4

SAN MATEO COUNTY DEPARTMENT

DRAWN BY: N.M.A.

CHECK BY: R.O.

APPROVED BY: N.R.C.

OF
PUBLIC WORKS

REDWOOD CITY
CALIFORNIA

SCALE: NONE
DATE: 6/95
REVISED: 4/97


#### SAN MATEO COUNTY SEWER AND SANITATION DISTRICTS STANDARD SPECIFICATIONS

#### PIPE AND FITTINGS

#### POLYVINYL CHLORIDE PIPE (PVC)


- 1. ALL PIPE AND FITTINGS SHALL CONFORM TO ASTM SPECIFICATIONS D3034, SDR 35.
- 2. ALL JOINTS SHALL BE A BELL AND SPIGOT ASSEMBLY WITH ELASTOMERIC SEALING GASKETS. SEALING GASKETS SHALL MEET THE REQUIREMENTS OF ASTM SPECIFICATION D1869. SOLVENT CEMENT JOINTS ARE NOT PERMITTED.
- 3. ALL PIPE ENTERING OR LEAVING A CONCRETE STRUCTURE SHALL HAVE A RUBBER WATERSTOP GASKET ATTACHED TO IT. THE WATERSTOP GASKET SHALL CONFORM TO THE PIPE MANUFACTURER'S SPECIFICATIONS. THE WATERSTOP GASKET SHALL BE SEATED FIRMLY AROUND THE PIPE EXTERIOR AND BE CAST INTO THE CONCRETE STRUCTURE.
- 4. ALL PIPE JOINTS SHALL BE MADE USING MANUFACTURED PVC COUPLINGS. BAND TYPE COMPRESSION COUPLINGS ARE NOT PERMITTED.


C-14

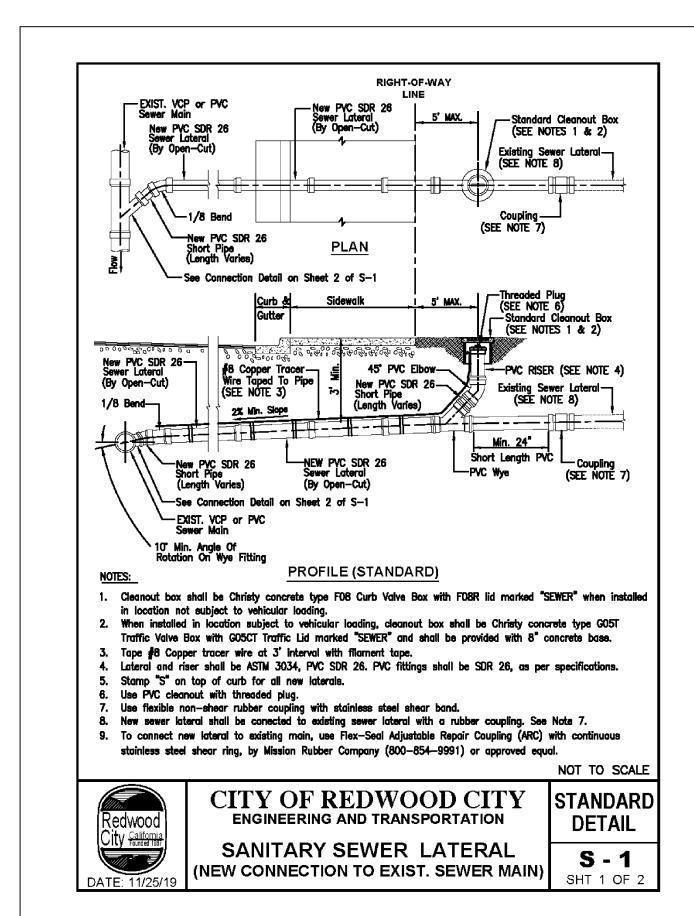


1048 EL CAMINO REAL, SUITE C

**REDWOOD CITY, CA 94063** 

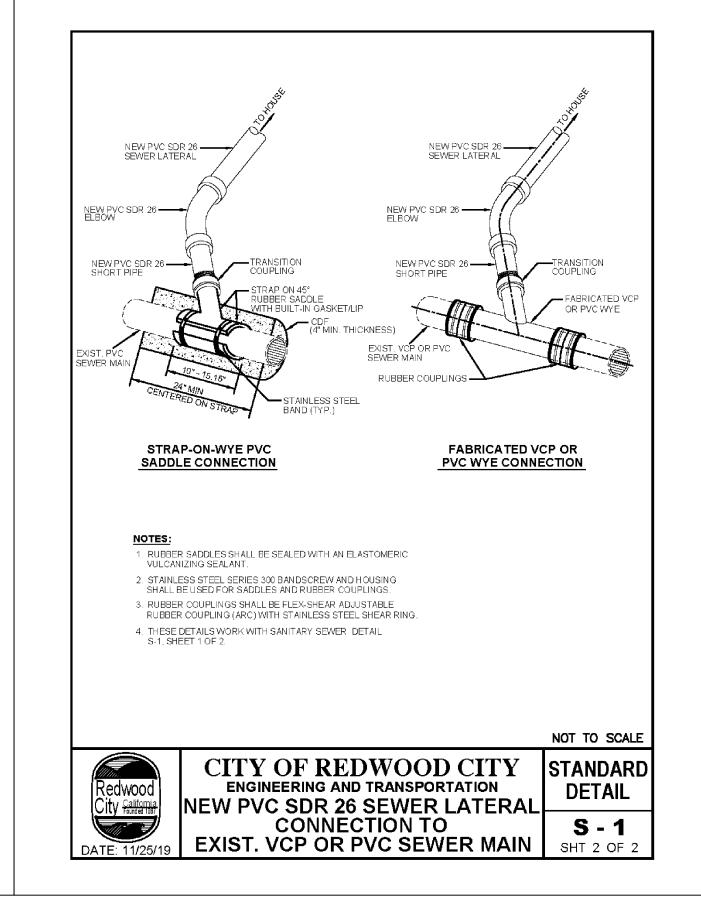


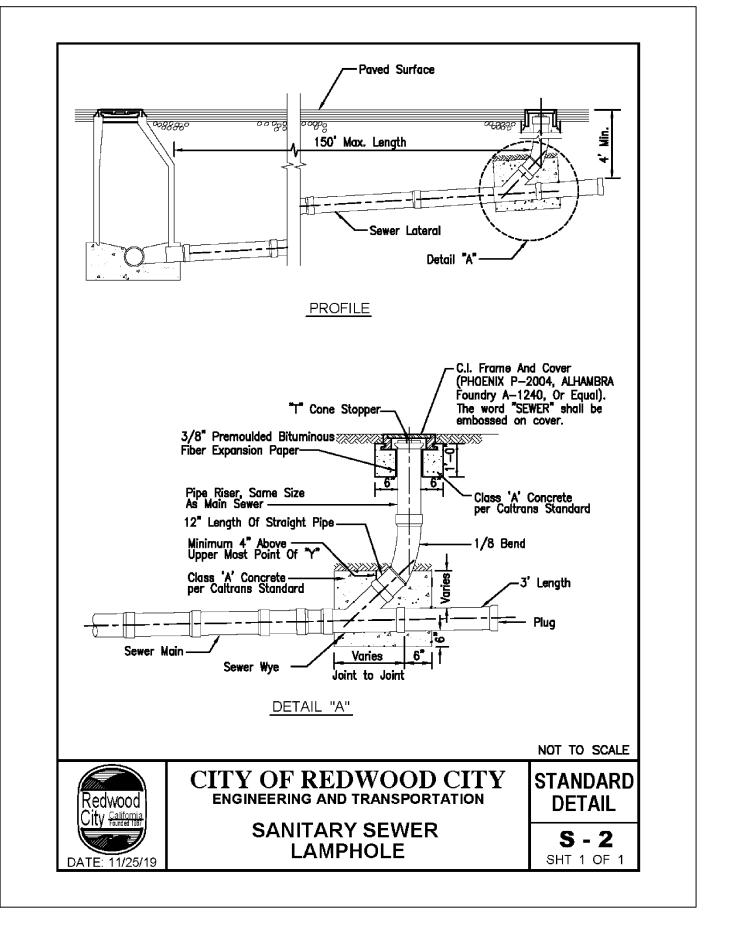

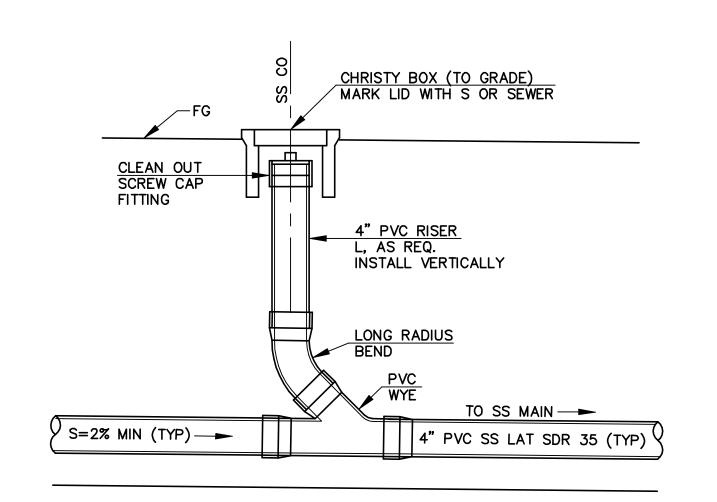





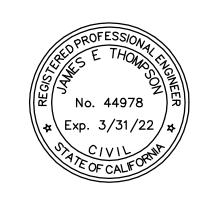

# JET ENGINEERING CONSULTING CIVIL ENGINEERS LANDS OF CAMILLERI 1462 EDGEWOOD RD


REDWOOD CITY, CA 94062


SANITARY SEWER DETAILS


		REVISIONS		JOB NO. <b>R1462-E-18</b>
NO.	DATE	DESCRIPTION	BY	DATE: 03/10/21
				DRAWN: DC
				CHECKED: <b>JET</b>
				SCALE: NTS


C8.0


SCALE: NTS 9 OF 15 SHEETS

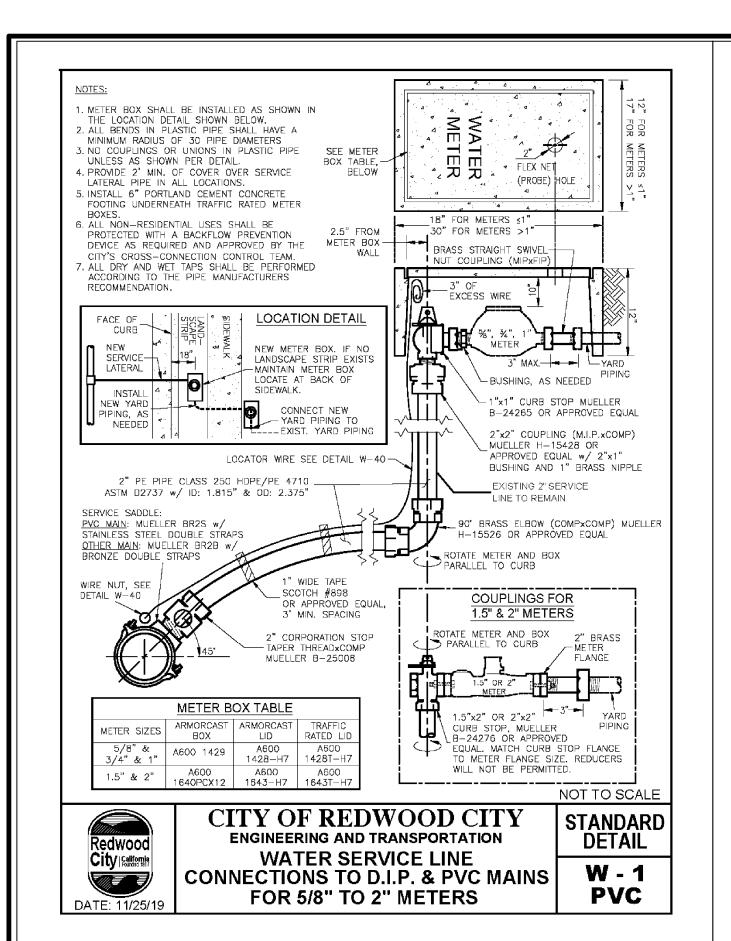


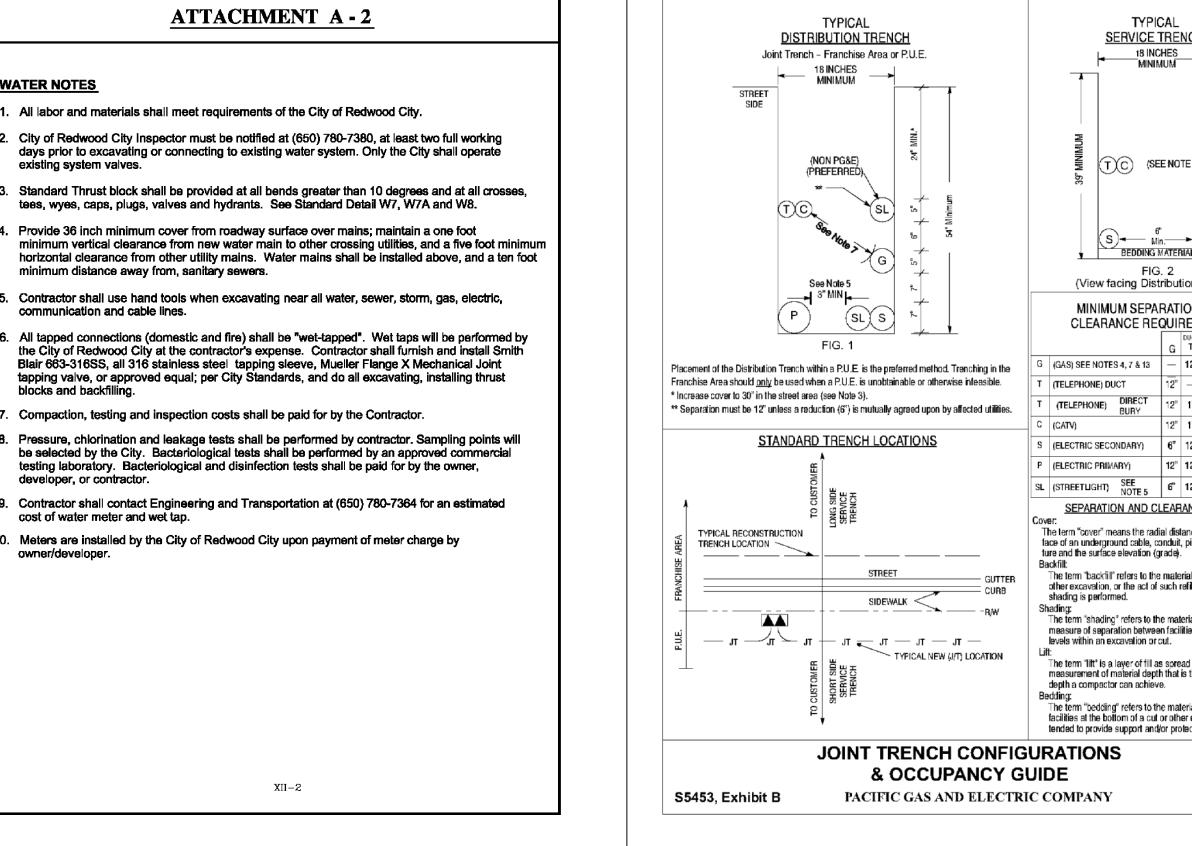

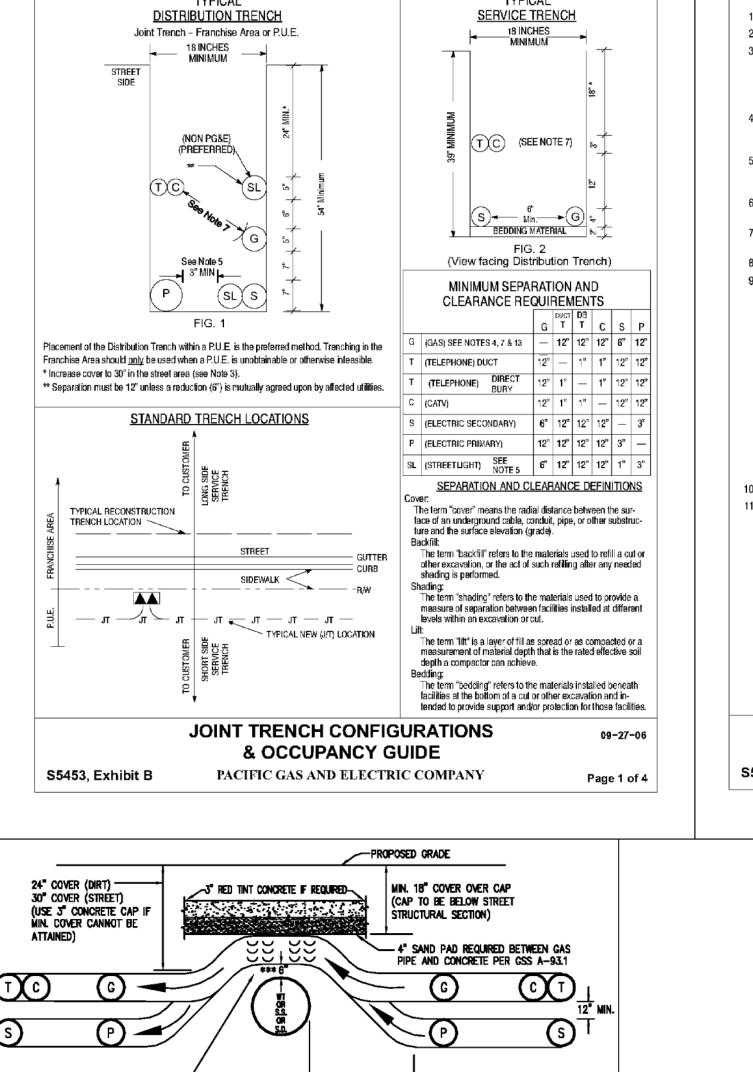

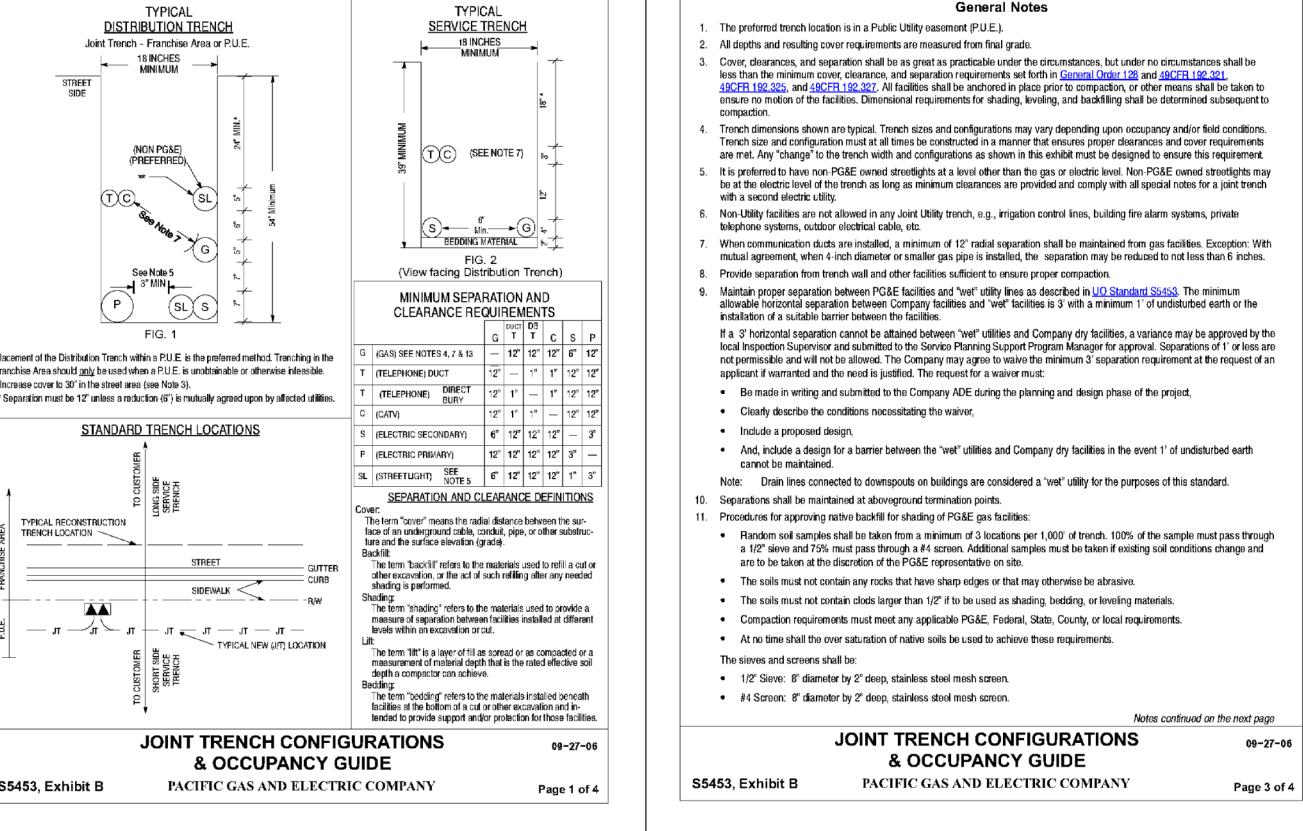

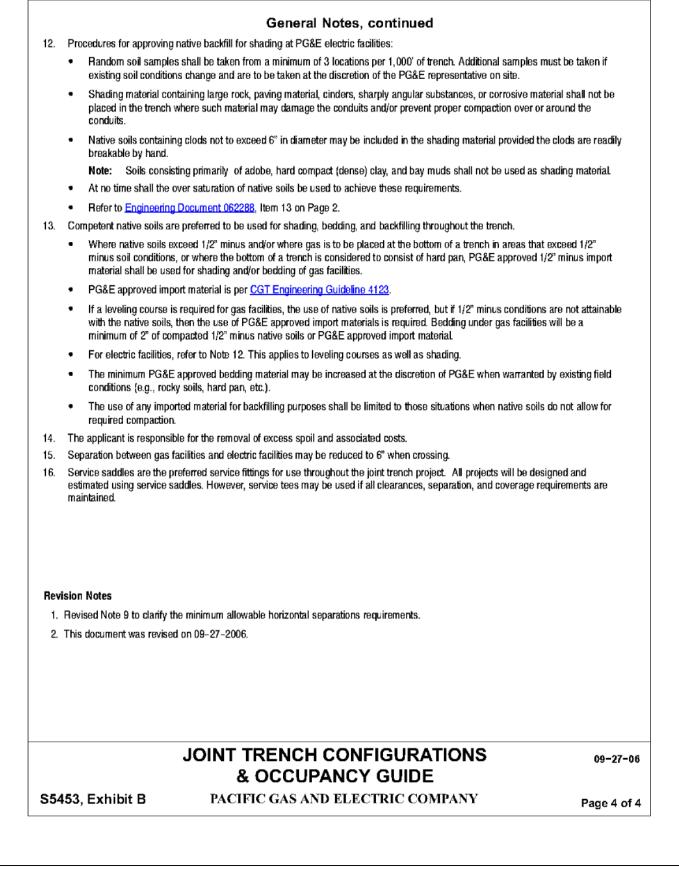

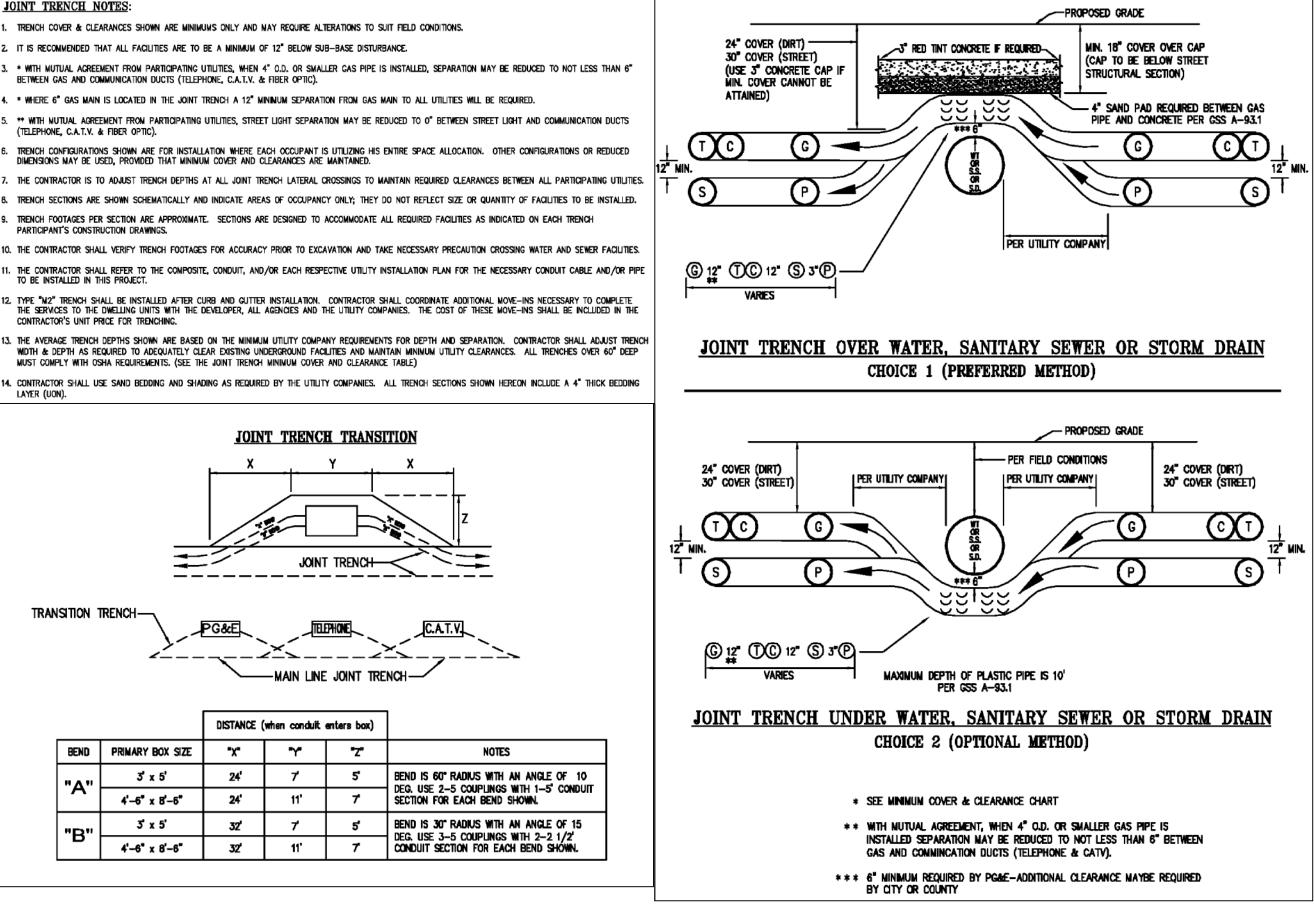

ATTACHMENT A - 2

2. City of Redwood City Inspector must be notified at (650) 780-7380, at least two full working

tees, wyes, caps, plugs, valves and hydrants. See Standard Detail W7, W7A and W8.

Contractor shall use hand tools when excavating near all water, sewer, storm, gas, electric,

Blair 663-316SS, all 316 stainless steel tapping sleeve, Mueller Flange X Mechanical Joint

tapping valve, or approved equal; per City Standards, and do all excavating, installing thrust

be selected by the City. Bacteriological tests shall be performed by an approved commercial

testing laboratory. Bacteriological and disinfection tests shall be paid for by the owner,

9. Contractor shall contact Engineering and Transportation at (650) 780-7364 for an estimated

XII-2

10. Meters are installed by the City of Redwood City upon payment of meter charge by

'. Compaction, testing and inspection costs shall be paid for by the Contractor.

Provide 36 inch minimum cover from roadway surface over mains: maintain a one foot

days prior to excavating or connecting to existing water system. Only the City shall operate

1. All labor and materials shall meet requirements of the City of Redwood City.

minimum distance away from, sanitary sewers.

communication and cable lines.

developer, or contractor.

cost of water meter and wet tap.

**WATER NOTES** 





# JET ENGINEERING

**CONSULTING CIVIL ENGINEERS** 1048 EL CAMINO REAL, SUITE C **REDWOOD CITY, CA 94063** 


LANDS OF CAMILLERI 1462 EDGEWOOD RD


**REDWOOD CITY, CA 94062** 

**WATER AND** SERVICE TRENCH DETAILS

		REVISIONS		JOB NO.	R1462-E-18
NO.	DATE	DESCRIPTION	BY	DATE :	03/10/21
				DRAWN:	DC
				CHECKED:	JET
				SCALE:	NTS

SHEET NO. C9.0

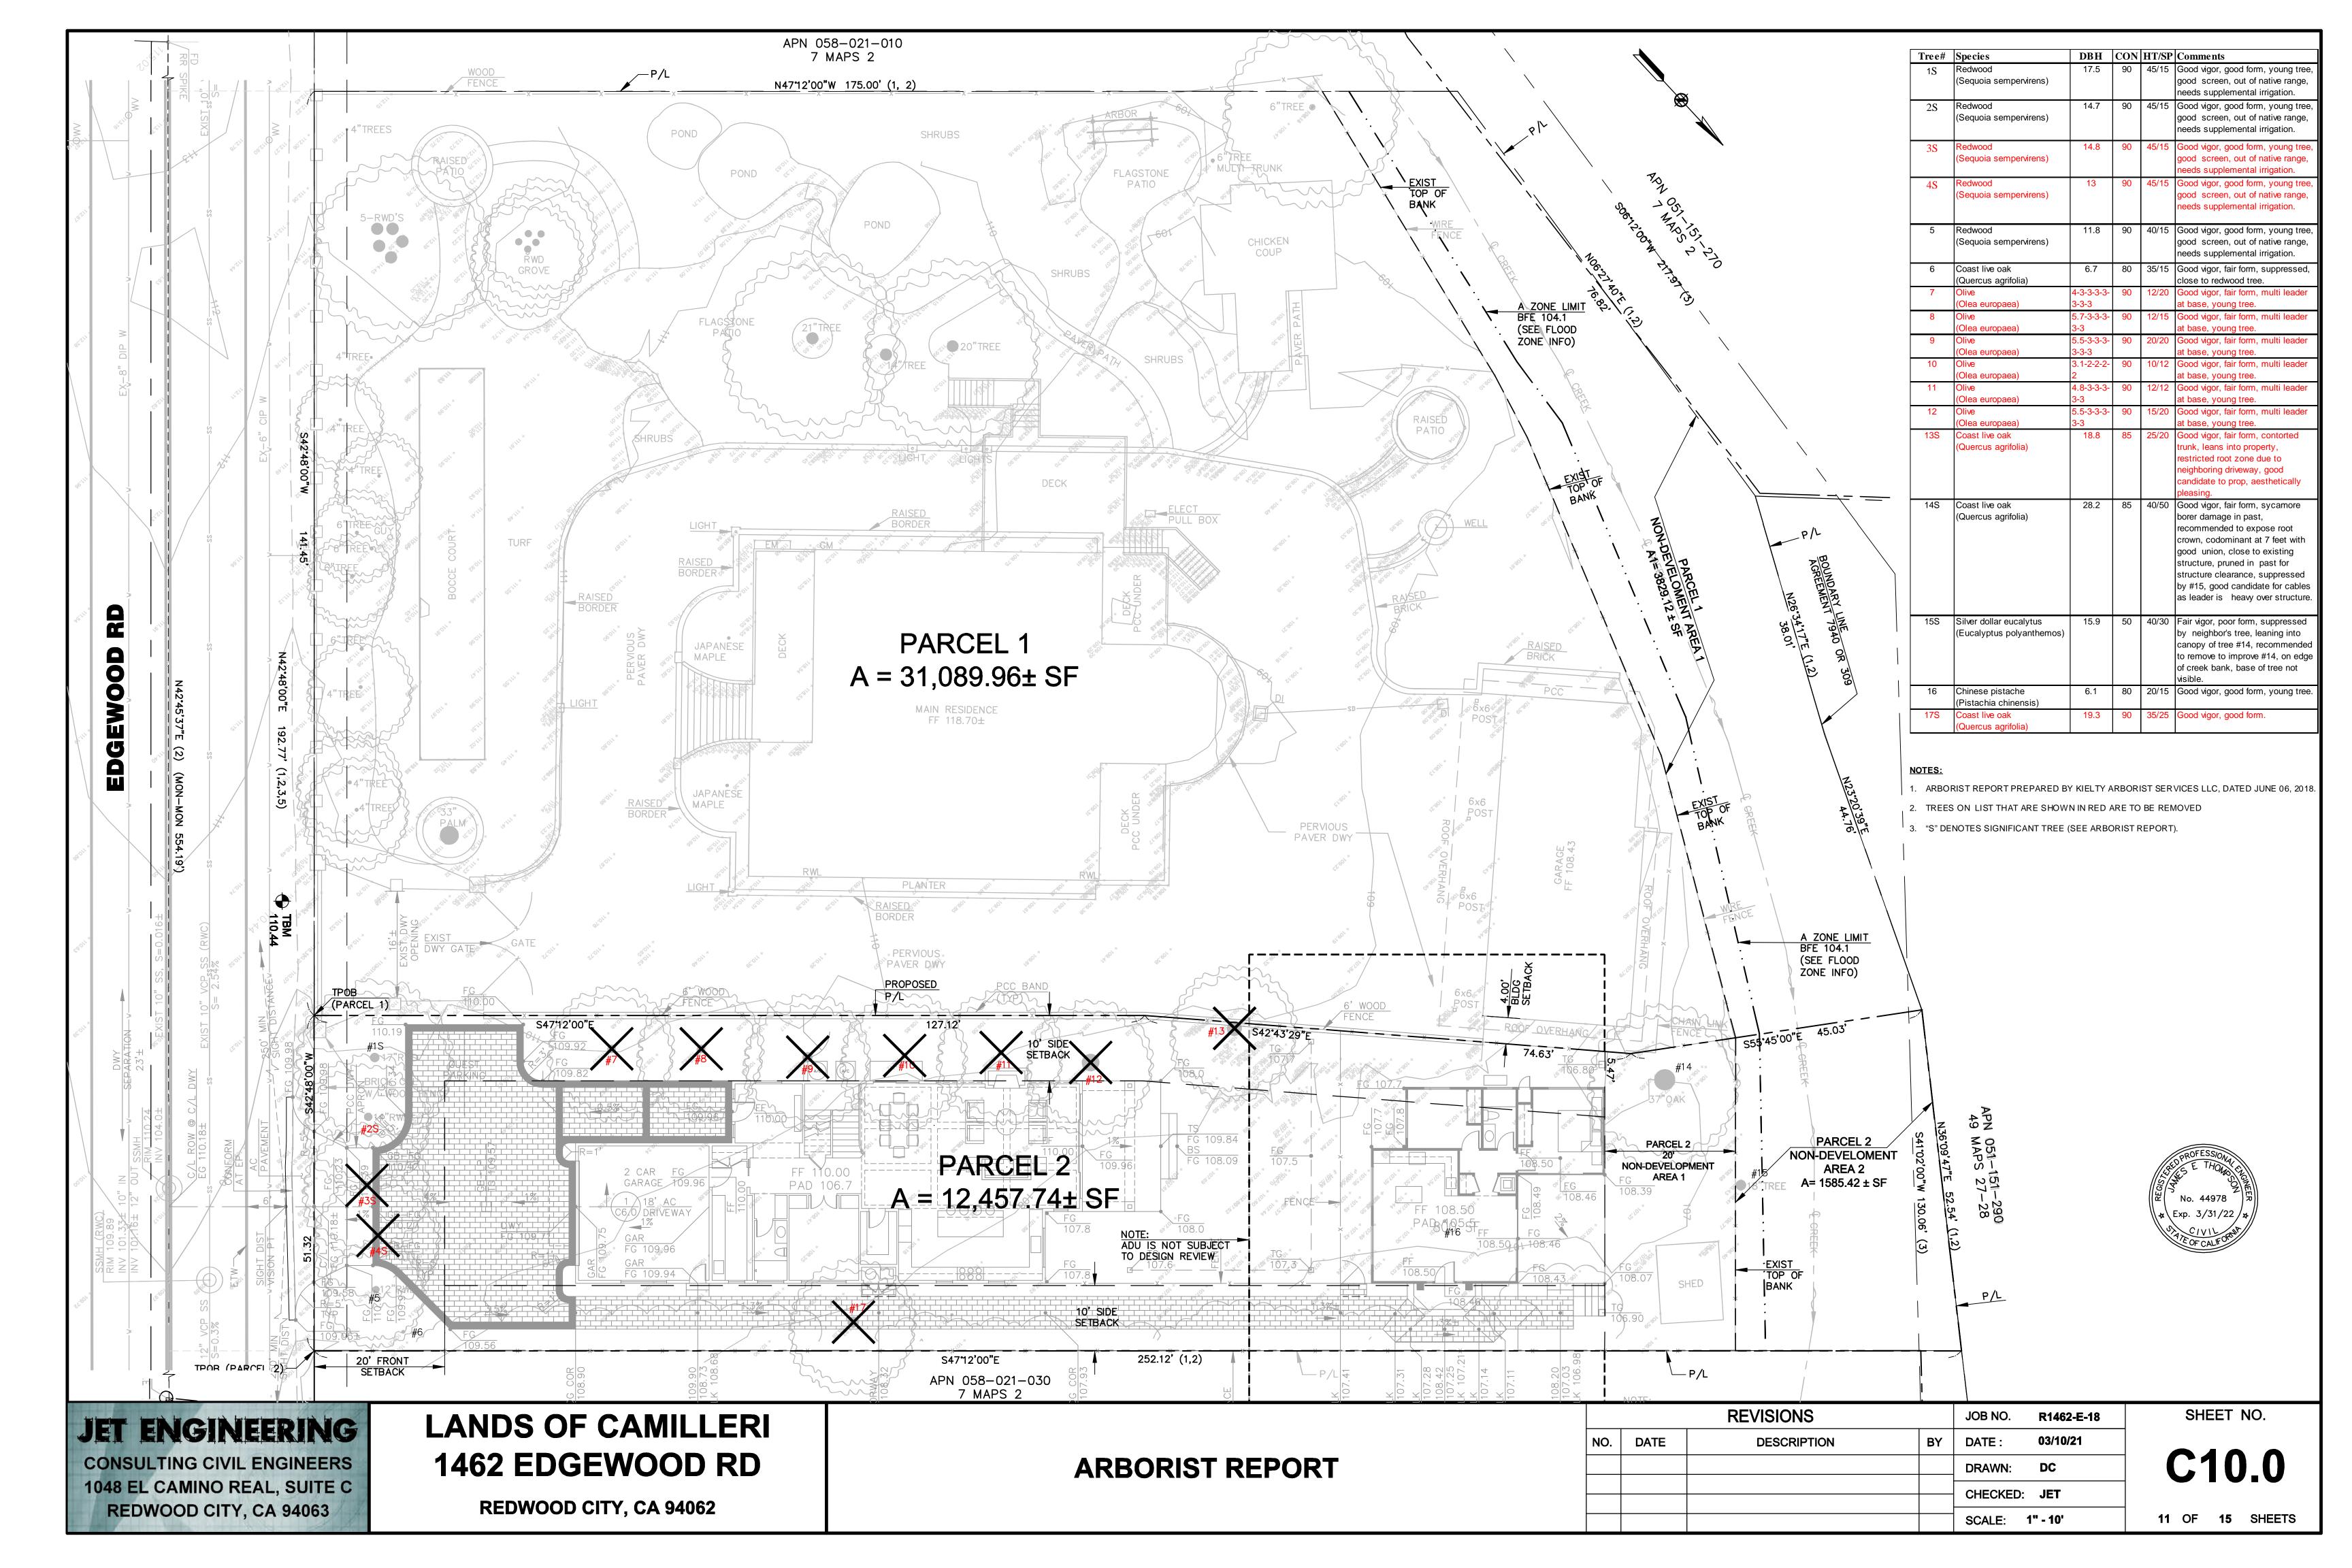

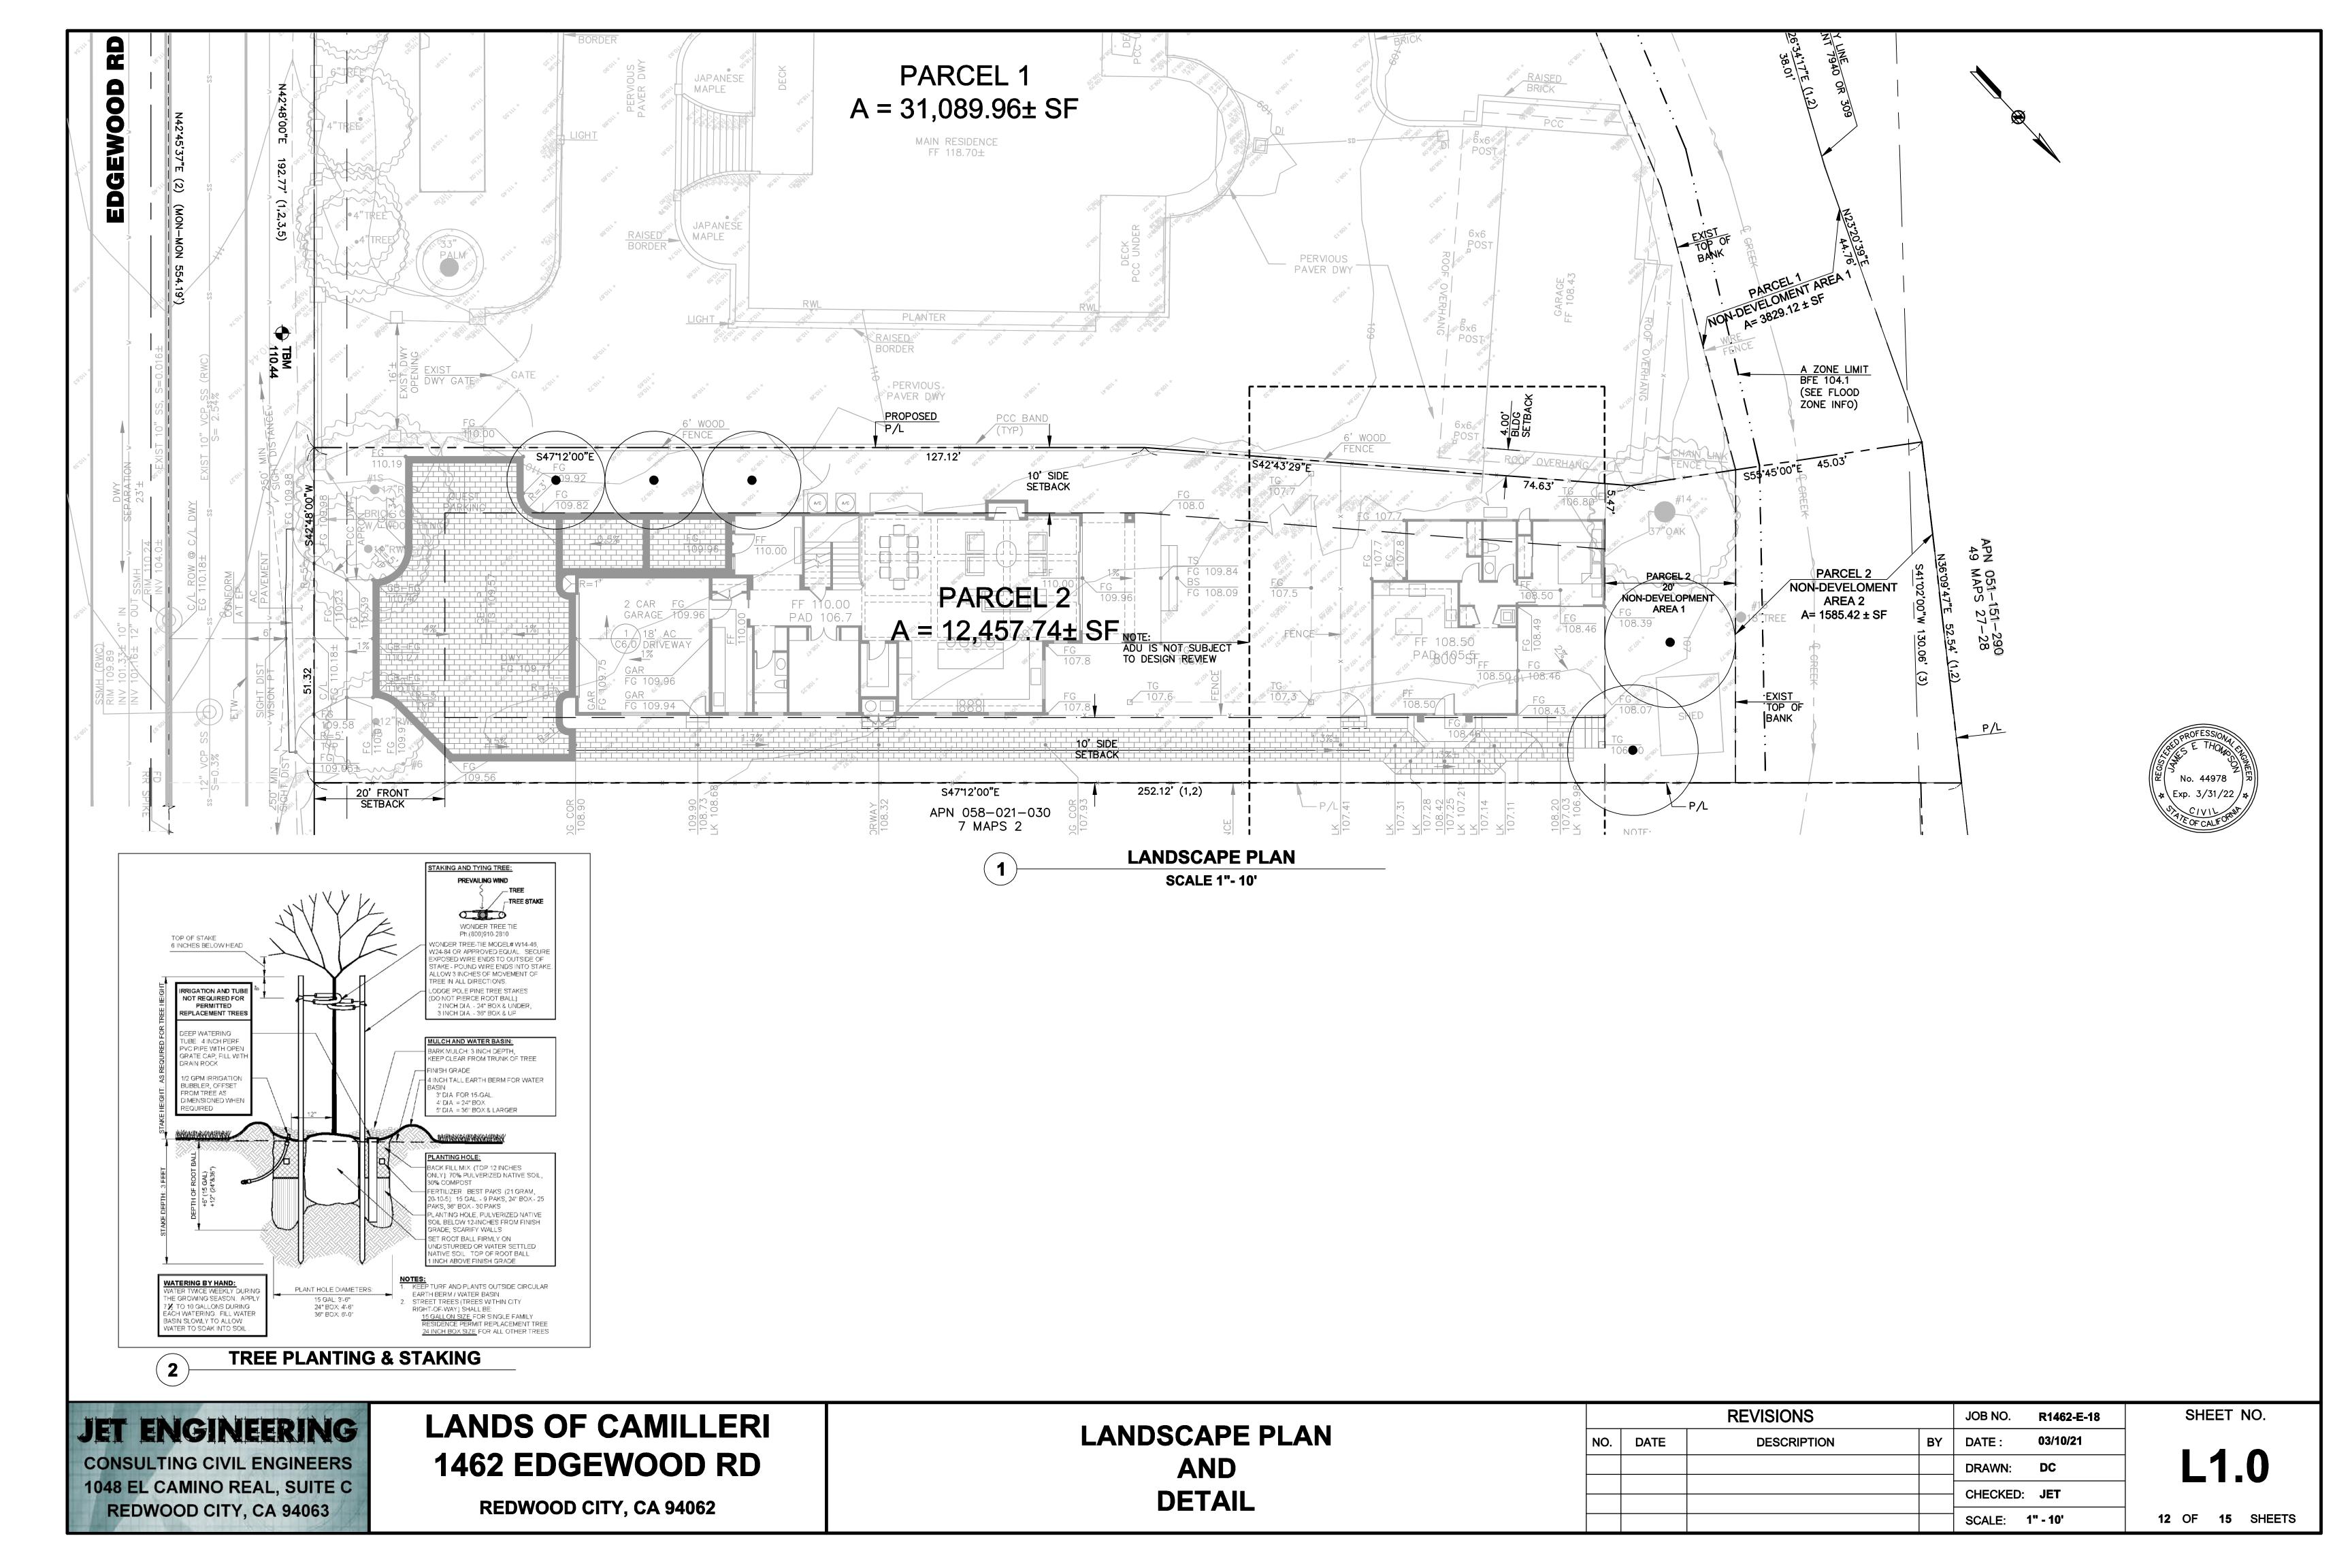




# Construction Best Management Practices (BMPs)

Construction projects are required to implement the stormwater best management practices (BMP) on this page, as they apply to your project, all year long.

Clean Water. Healthy Community.

#### Materials & Waste Management

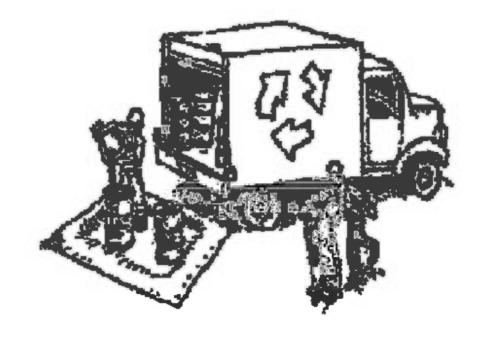

#### Non-Hazardous Materials

- ☐ Berm and cover stockpiles of sand, dirt or other construction material with tarps when rain is forecast or if not actively being used within 14 days.
- ☐ Use (but don't overuse) reclaimed water for dust control.

#### Hazardous Materials

- □ Label all hazardous materials and hazardous wastes (tuch as perticides, paints, thinners, solvents, fuel, oil, and antifreeze) in accordance with city, county, state and federal regulations.
- Store hazardous materials and wastes in water tight containers, store in appropriate secondary containment, and cover them at the end of every work day or during wet weather or when rain is forecast.
- ☐ Follow manufacturer's application instructions for hazardous materials and be careful not to use more than necessary. Do not apply chemicals outdoors when rain is forecast within 24 hours.
- ☐ Arrange for appropriate disposal of all hazardous wastes.

#### Waste Management

- ☐ Cover waste disposal containers securely with tarps at the end of every work day and during wet weather.
- ☐ Check waste disposal containers frequently for leaks and to make sure they are not overfilled. Never hose down a dumpster on the construction site.
- ☐ Clean or replace portable toilets, and inspect them frequently for leaks and spills.
- ☐ Dispose of all waster and debris properly. Recycle materials and wastes that can be recycled (such as asphalt, concrete, aggregate base materials, wood, gyp board, pipe, etc.)
- ☐ Dispose of liquid residues from paints, thinners, solvents, glues, and cleaning fluids as hazardous waste.

#### **Construction Entrances and Perimeter**

- ☐ Establish and maintain effective perimeter controls and stabilize all construction entrances and exits to sufficiently control erosion and sediment discharges from site and tracking off site.
- ☐ Sweep or vacuum any street tracking immediately and secure sediment source to prevent further tracking. Never hose down streets to clean up tracking.

# Equipment Management & Spill Control



#### Maintenance and Parking

- ☐ Designate an area, fitted with appropriate BMPs, for vehicle and equipment parking and storage.
- ☐ Perform major maintenance, repair jobs, and vehicle and equipment washing off site.
- ☐ If refueling or vehicle maintenance must be done onsite, work in a bernned area away from storm drains and over a drip pan or drop cloths big enough to collect fluids. Recycle or dispose of fluids as hazardous waste.
- ☐ If vehicle or equipment cleaning must be done onsite, clean with water only in a bermed area that will not allow rinse water to run into gutters, streets, storm drains, or surface waters.
- Do not clean vehicle or equipment onsite using soaps, solvents, degreasers, or steam cleaning equipment.

#### Spill Prevention and Control

- ☐ Keep spill cleanup materials (e.g., rags, absorbents and cat litter) available at the construction site at all times.
- Inspect vehicles and equipment frequently for and repair leaks promptly. Use drip pans to catch leaks until repairs are made.
- Clean up spills or leaks immediately and dispose of cleanup materials properly.
- Do not hose down surfaces where fluids have spilled. Use dry cleanup methods (absorbent materials, cat litter, and/or rags).
- Sweep up spilled dry materials immediately. Do not try to wash them away with water, or bury them.
- Clean up spills on dirt areas by digging up and properly disposing of contaminated soil.
- □ Report significant spills immediately. You are required by law to report all significant releases of hazardous materials, including oil. To report a spill: 1) Dial 911 or your local emergency response number, 2) Call the Governor's Office of Emergency Services Warning Center, (800) 852-7550 (24 hours).

#### **Earthmoving**




- Schedule grading and excavation work during dry weather.
- ☐ Stabilize all denuded areas, install and maintain temporary erosion controls (such as erosion control fabric or bonded fiber matrix) until vegetation is established.
- □ Remove existing vegetation only when absolutely necessary, and seed or plant vegetation for erosion control on slopes or where construction is not immediately planned.
- □ Prevent sediment from migrating offsite and protect storm drain inlets, gutters, ditches, and drainage courses by installing and maintaining appropriate BMPs, such as fiber rolls, silt fences, sediment basins, gravel bags, berms, etc.
- ☐ Keep excavated soil on site and transfer it to dump trucks on site, not in the streets.

#### Contaminated Soils

- ☐ If any of the following conditions are observed, test for contamination and contact the Regional Water Quality Control Board:
- Unusual soil conditions, discoloration, or odor.
- Abandoned underground tanks.
- Abandoned wells
- Buried barrels, debris, or trash.

#### Paving/Asphalt Work

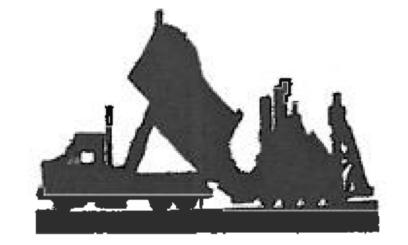

- Avoid paving and seal coating in wet weather or when rain is forecast, to prevent materials that have not cured from contacting stormwater runoff.
- ☐ Cover storm drain inlets and manholes when applying seal coat, tack coat, slurry seal, fog seal, etc.
- Collect and recycle or appropriately dispose of excess abrasive gravel or sand.
   Do NOT sweep or wash it into gutters.
- Do not use water to wash down fresh asphalt concrete pavement.

#### Sawcutting & Asphalt/Concrete Removal

- ☐ Protect nearby storm drain inlets when ☐ aw cutting. Use filter fabric, catch basin inlet filters, or gravel bags to keep slurry out of the storm drain system.
- Shovel, abosorb, or vacuum saw-cut slurry and dispose of all waste as soon as you are finished in one location or at the end of each work day (whichever is sooner!).
- ☐ If sawcut slurry enters a catch basin, clean it up immediately.

# Concrete, Grout & Mortar




- ☐ Store concrete, grout, and mortar away from storm drains or waterways, and on pallets under cover to protect them from rain, runoff, and wind.
- □ Whish out concrete equipment/trucks offsite or in a designated washout area, where the water will flow into a temporary waste pit, and in a manner that will prevent leaching into the underlying soil or onto surrounding areas. Let concrete harden and dispose of as garbage.
- When washing exposed aggregate, prevent washwater from entering storm drains. Block any inlets and vacuum gutters, hose washwater onto dirt areas, or drain onto a bermed surface to be pumped and disposed of properly.

#### Landscaping



- ☐ Protect stockpiled landscaping materials from wind and rain by storing them under tarps all year-round.
- Stack bagged material on pallets and under cover.
- ☐ Discontinue application of any erodible landscape material within 2 days before a forecast rain event or during wet weather.

#### **Painting & Paint Removal**

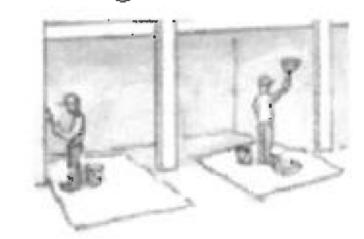


#### Painting Cleanup and Removal

- □ Never clean brushes or rinse paint containers into a street, gutter, storm drain, or stream.
- ☐ For water-based paints, paint out brushes to the extent possible, and rinse into a drain that goes to the sanitary sewer.

  Never pour paint down a storm drain.
- ☐ For oil-based paints, paint out brushes to the extent possible and clean with thinner or solvent in a proper container. Filter and reuse thinners and solvents. Dispose of excess liquids as hazardous waste.
- □ Paint chips and duat from non-hazardous dry stripping and sand blasting may be swept up or collected in plastic drop cloths and disposed of as trash.
- Chemical paint stripping residue and chips and dust from marine paints or paints containing lead, mercury, or tributyltin must be disposed of as hazardous waste. Lead based paint removal requires a statecertified contractor.

#### Dewatering

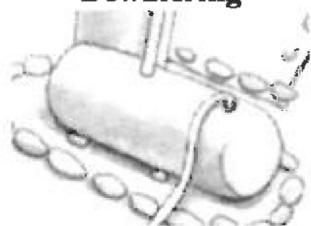

- Discharges of groundwater or captured runoff from dewatering operations must be properly managed and disposed. When possible send dewatering discharge to landscaped area or sanitary sewer. If discharging to the sanitary sewer call your local wastewater treatment plant.
- ☐ Divert run-on water from offsite away from all disturbed areas.
- □ When dewatering, notify and obtain approval from the local municipality before discharging water to a street gutter or storm drain. Filtration or diversion through a basin, tank, or sediment trap may be required.
- ☐ In areas of known or suspected contamination, call your local agency to determine whether the ground water must be tested. Pumped groundwater may need to be collected and hauled off-site for treatment and proper disposal.

# Storm drain polluters may be liable for fines of up to \$10,000 per day!

# JET ENGINEERING

CONSULTING CIVIL ENGINEERS 1048 EL CAMINO REAL, SUITE C REDWOOD CITY, CA 94063 LANDS OF CAMILLERI 1462 EDGEWOOD RD


**REDWOOD CITY, CA 94062** 

STORMWATER POLLUTION
PREVENTION PLAN
BEST MANAGEMENT PRACTICES

REVISIONS			JOB NO.	R1462-E-18	
NO.	DATE	DESCRIPTION	BY	DATE:	03/10/21
				DRAWN:	DC
				CHECKED:	JET
				SCALE:	ITS

EC.0

SHEET NO.

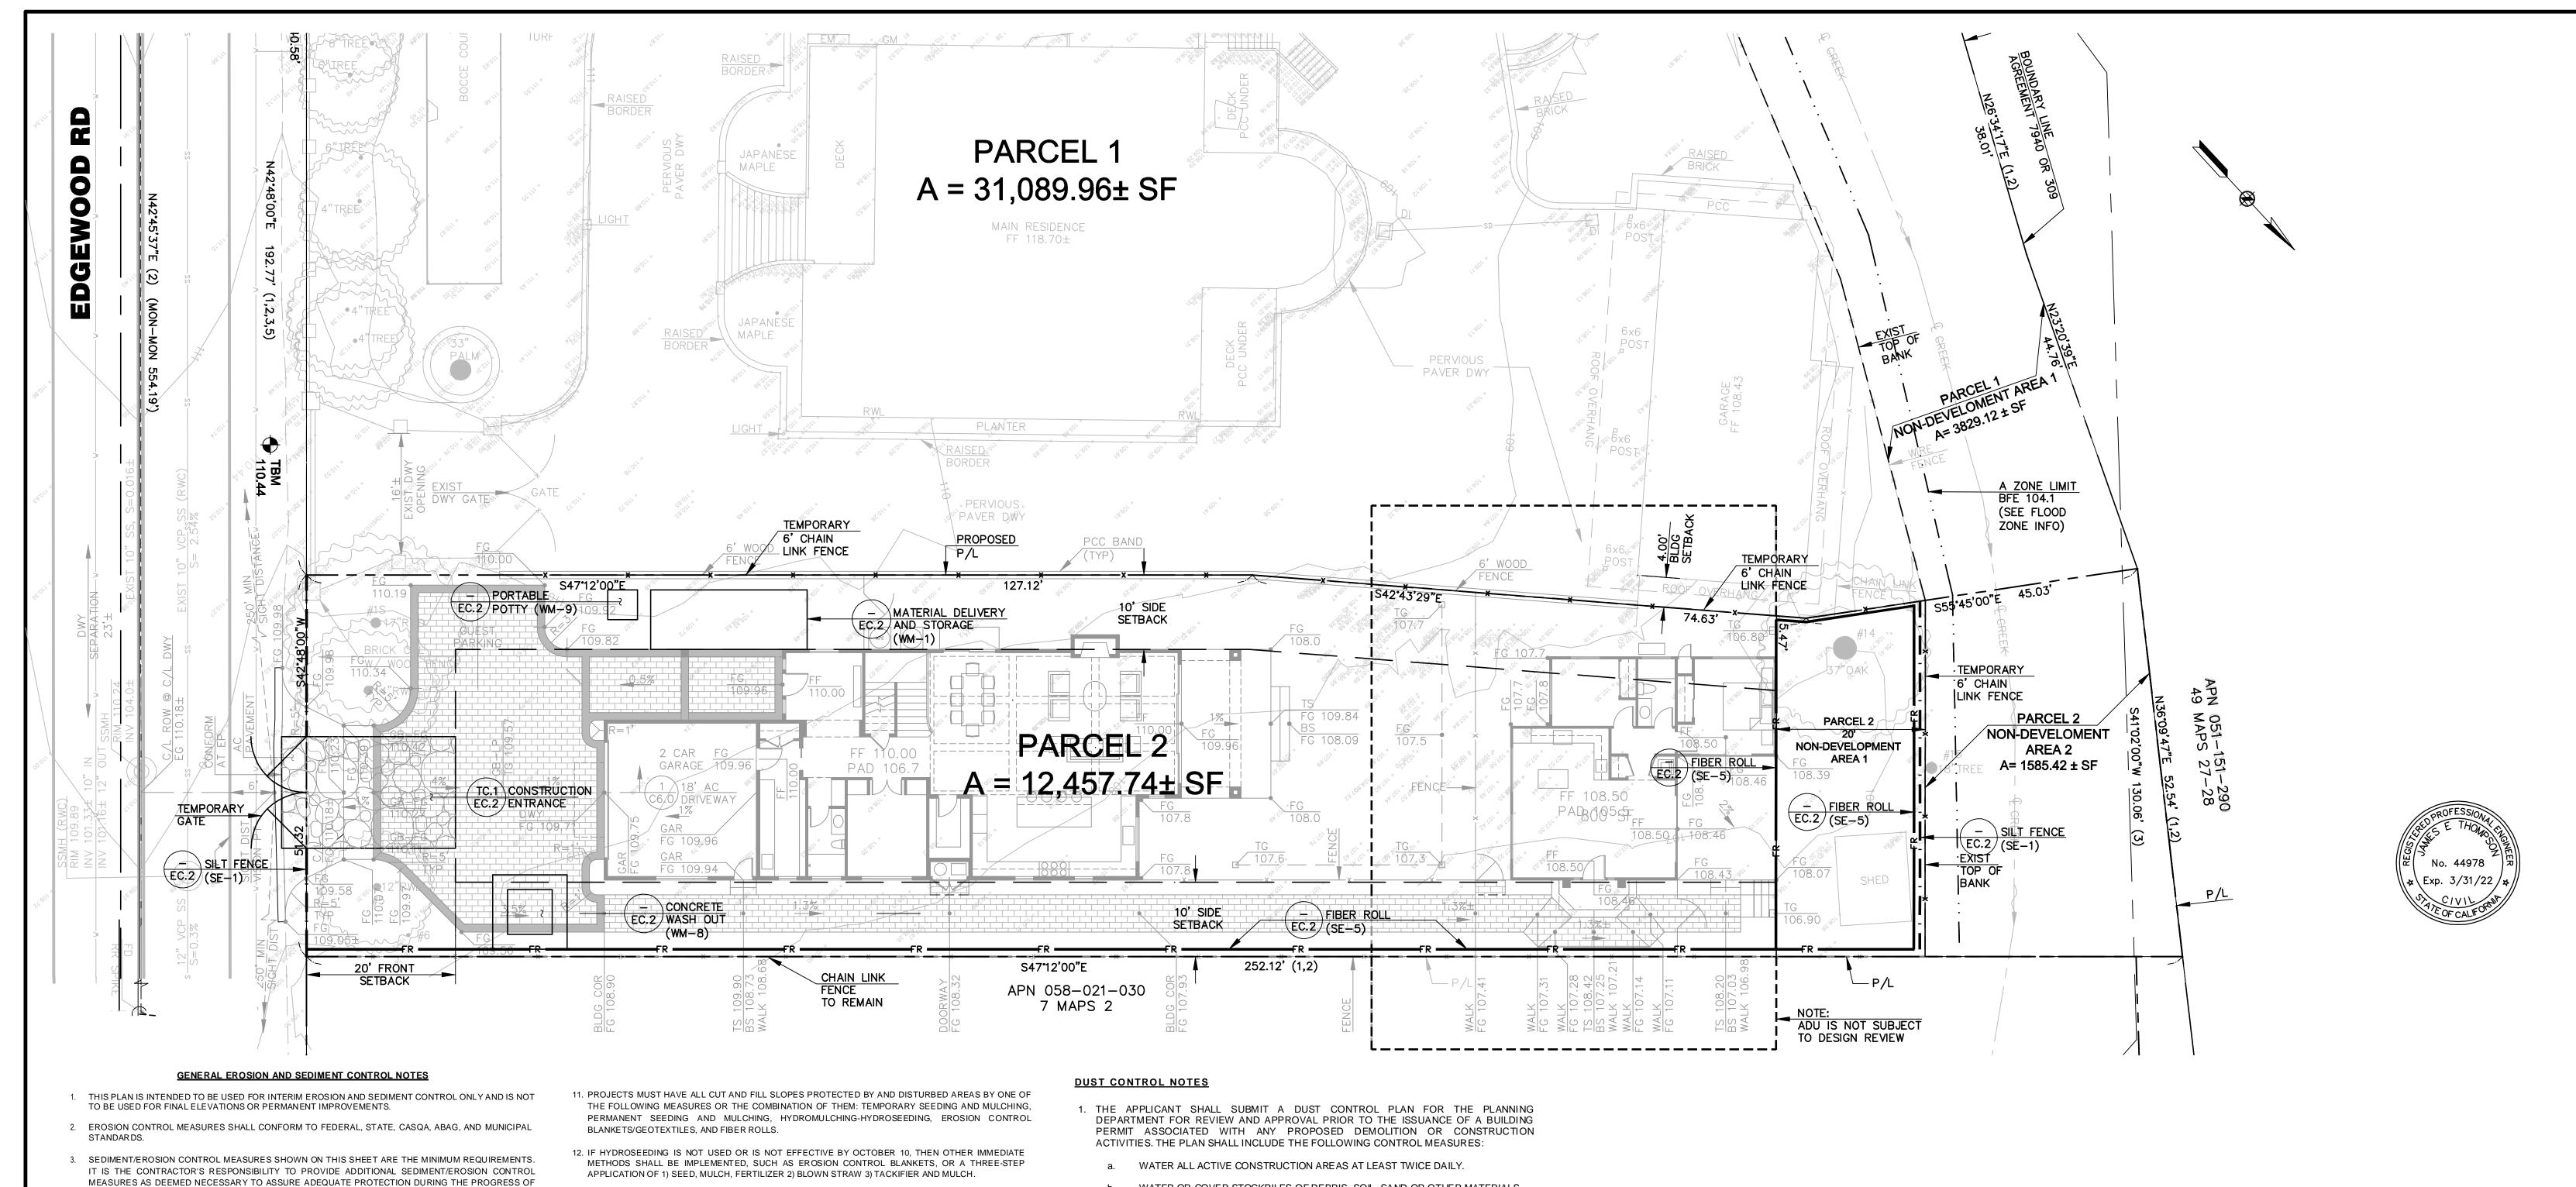

- CONSTRUCTION AND AT THE CONTRACTOR'S EXPENSE.

  4. THIS EROSION AND SEDIMENT CONTROL PLAN MAY NOT COVER ALL THE SITUATIONS THAT MAY ARISE DURING CONSTRUCTION DUE TO UNANTICIPATED FIELD CONDITIONS. VARIATIONS AND ADDITIONS MAY BE MADE TO THIS PLAN IN THE FIELD. NOTIFY THE ENGINEER OF ANY FIELD CHANGES. ADDITIONAL EROSION CONTROL MEASURES MAY BE REQUIRED AS DETERMINED BY THE ENGINEER,
- 5. THE FACILITIES SHOWN ON THIS PLAN ARE DESIGNED TO CONTROL EROSION AND SEDIMENT DURING THE RAINY SEASON, OCTOBER 1 TO APRIL 30. FACILITIES ARE TO BE OPERABLE PRIOR TO OCTOBER 1 OF ANY YEAR. GRADING OPERATIONS DURING THE RAINY SEASON WHICH LEAVE DENUDED SLOPES SHALL BE PROTECTED WITH EROSION CONTROL MEASURES IMMEDIATELY FOLLOWING GRADING ON THE SLOPES.
- 6. THIS PLAN COVERS ONLY THE FIRST WINTER FOLLOWING GRADING WITH ASSUMED SITE CONDITIONS AS SHOWN ON THE EROSION CONTROL PLAN. PRIOR TO SEPTEMBER 15, THE COMPLETION OF SITE IMPROVEMENT SHALL BE EVALUATED AND REVISIONS MADE TO THIS PLAN AS NECESSARY WITH THE APPROVAL OF THE CITY ENGINEER. PLANS ARE TO BE RESUBMITTED FOR APPROVAL PRIOR TO SEPTEMBER 1 OF EACH SUBSEQUENT YEAR UNTIL SITE IMPROVEMENTS ARE ACCEPTED BY THE
- 7. ALL MATERIALS NECESSARY FOR THE APPROVED EROSION CONTROL MEASURES SHALL BE ON SITE BY SEPTEMBER 15TH AND IN PLACE BY OCTOBER 1ST.
- 8. EROSION CONTROL SYSTEMS SHALL BE INSTALLED AND MAINTAINED THROUGHOUT THE RAINY SEASON, OR FROM OCTOBER 1ST THROUGH APRIL 30TH, WHICHEVER IS LONGER.
- 9. CONSTRUCTION ENTRANCES SHALL BE INSTALLED PRIOR TO COMMENCEMENT OF GRADING. ALL CONSTRUCTION TRAFFIC ENTERING ONTO THE PAVED ROADS MUST CROSS THE STABILIZED
- 10. INLET PROTECTION SHALL BE INSTALLED AT OPEN INLETS TO PREVENT SEDIMENT FROM ENTERING THE STORM DRAIN SYSTEM. INLETS NOT USED IN CONJUNCTION WITH EROSION CONTROL ARE TO BE BLOCKED TO PREVENT ENTRY OF SEDIMENT.

- 13. IN THE EVENT OF RAIN, ALL GRADING WORK IS TO CEASE IMMEDIATELY AND THE SITE IS TO BE SEALED IN ACCORDANCE WITH THE APPROVED EROSION CONTROL MEASURES AND APPROVED EROSION CONTROL PLAN.
- 14. THE CONTRACTOR SHALL BE RESPONSIBLE FOR CHECKING, MONITORING, AND REPAIRING EROSION CONTROL MEASURES AND SYSTEMS BEFORE, DURING AND AFTER EACH STORM. OWNER / CONTRACTOR SHALL BE RESPONSIBLE FOR MONITORING EROSION AND SEDIMENT CONTROL MEASURES PRIOR TO, DURING, AND AFTER STORM EVENTS.
- 15. PROJECTS SHALL PREVENT ANY ACCUMULATION OR DEPOSIT OF DIRT, MUD, SAND, ROCKS, GRAVEL OR DEBRIS ON THE SURFACE OF ANY STREET, ALLEY OR PUBLIC PLACE OR IN ANY PUBLIC STORM DRAIN SYSTEM.
- 16. FAILURE TO IMPLEMENT EROSION CONTROL MEASURES DURING PERIODS OF RAINFALL MAY RESULT IN A PROHIBITION OF ANY ADDITIONAL CONSTRUCTION DURING THE REMAINDER OF THE RAINY SEASON.
- WATER OR COVER STOCKPILES OF DEBRIS, SOIL, SAND OR OTHER MATERIALS THAT CAN BE BLOWN BY THE WIND.
- c. COVER ALL TRUCKS HAULING SOIL AND OTHER LOOSE MATERIALS OR REQUIRE ALL TRUCKS TO MAINTAIN AT LEAST TWO (2) FEET OF FREEBOARD.
- d. APPLY WATER THREE TIMES DAILY OR APPLY NON-TOXIC SOIL STABILIZERS ON ALL UNPAVED ACCESS ROADS, PARKING, AND STAGING AREAS AT CONSTRUCTION SITES. ALSO, HYDROSEED OR APPLY NON-TOXIC SOIL STABILIZERS TO INACTIVE CONSTRUCTIVE AREAS.
- e. SWEEP (PREFERABLY WITH WATER SWEEPERS) ALL PAVED ACCESS ROADS, PARKING, AND STAGING AREAS AT CONSTRUCTION SITES ON AN "AS NEEDED" BASIS.
- f. SWEEP ADJACENT PUBLIC STREETS (PREFERABLY WITH WATER SWEEPERS) IF VISIBLE SOIL MATERIAL IS CARRIED ONTO THEM.
- g. ENCLOSE, COVER, WATER OR APPLY NON-TOXIC SOIL BINDERS TO EXPOSED STOCKPILES (DIRT, SAND, ETC.) ON AN "AS NEEDED" BASIS.
- LIMIT TRAFFIC SPEEDS ON UNPAVED ROADS WITHIN THE PROJECT PARCEL TO 15 M.P.H.
   INSTALL SANDBAGS OR OTHER EROSION CONTROL MEASURES TO PREVENT SILT RUNOFF TO PUBLIC ROADWAYS AND/OR THE ADJACENT WATERWAY.

REPLANT VEGETATION IN DISTURBED AREAS AS QUICKLY AS POSSIBLE.

THE APPROVED PLAN SHALL BE IMPLEMENTED FOR THE DURATION OF ANY DEMOLITION OR CONSTRUCTION ACTIVITIES THAT GENERATE DUST AND OTHER AIRBORNE PARTICLES.

## JET ENGINEERING

THE BUILDING INSPECTOR OR BUILDING OFFICIALS.

MUNICIPALITY.

CONSULTING CIVIL ENGINEERS 1048 EL CAMINO REAL, SUITE C REDWOOD CITY, CA 94063 LANDS OF CAMILLERI 1462 EDGEWOOD RD

**REDWOOD CITY, CA 94062** 


#### **EROSION CONTROL PLAN**

1					
REVISIONS				JOB NO. R	21462-E-18
NO.	DATE	DESCRIPTION	BY	DATE: 0	3/10/21
				DRAWN: D	ОС
				CHECKED: J	ET
				SCALE: 1" -	10'


EC.1


**14** OF **15** SHEETS


SHEET NO.

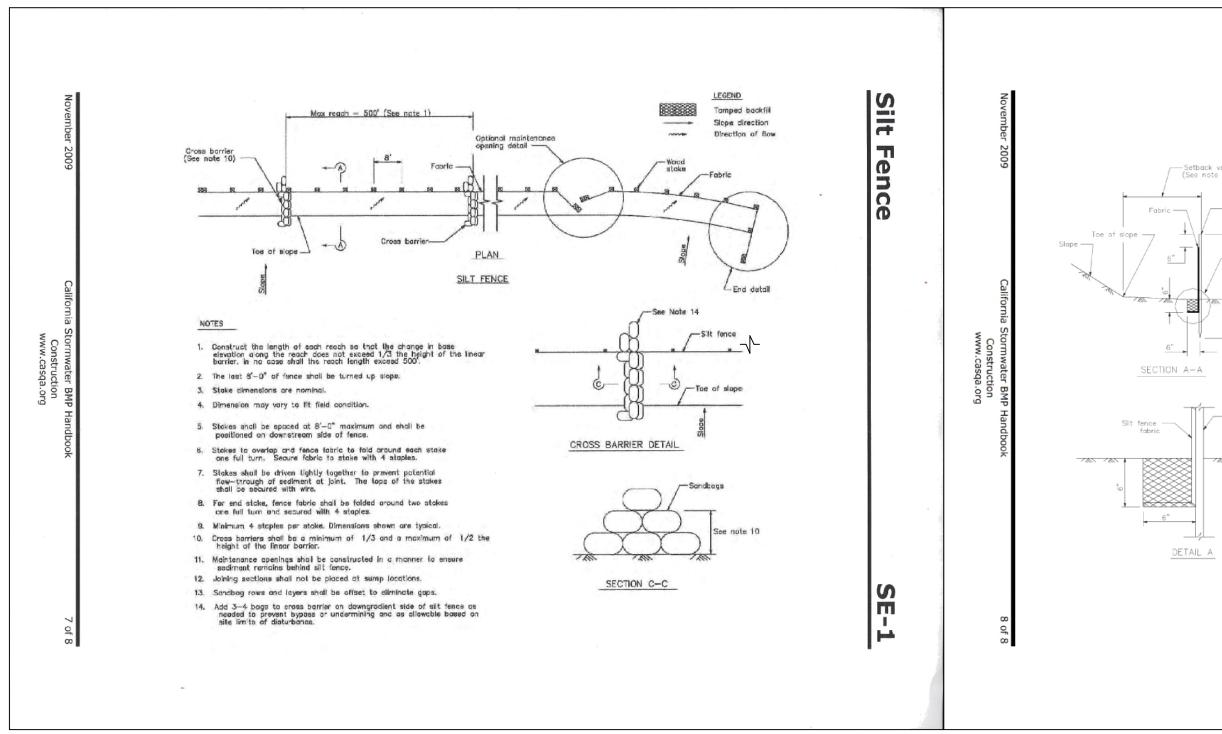


EC-15

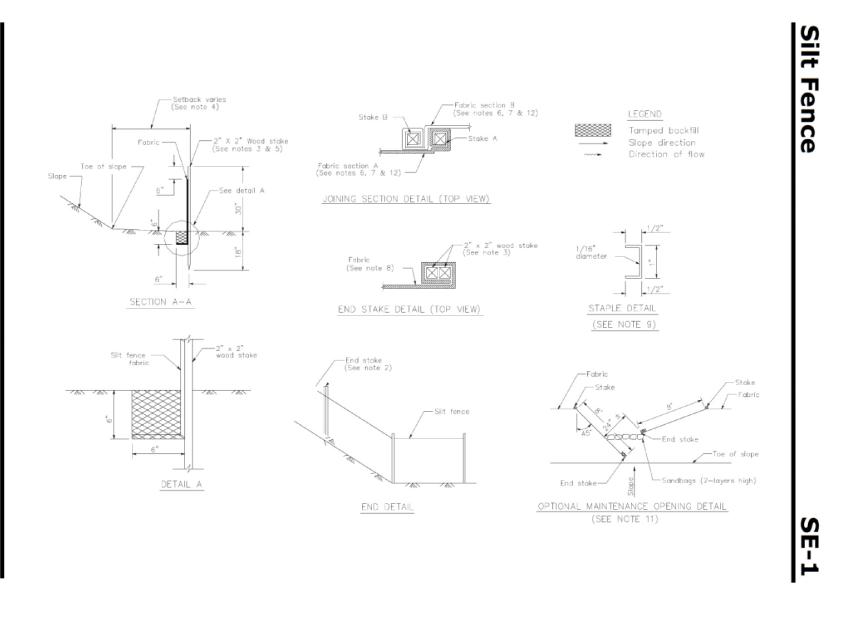


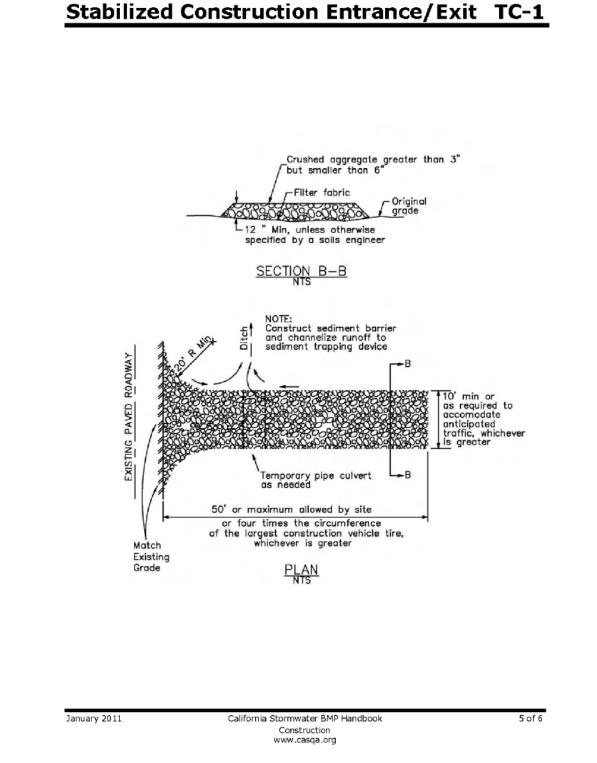


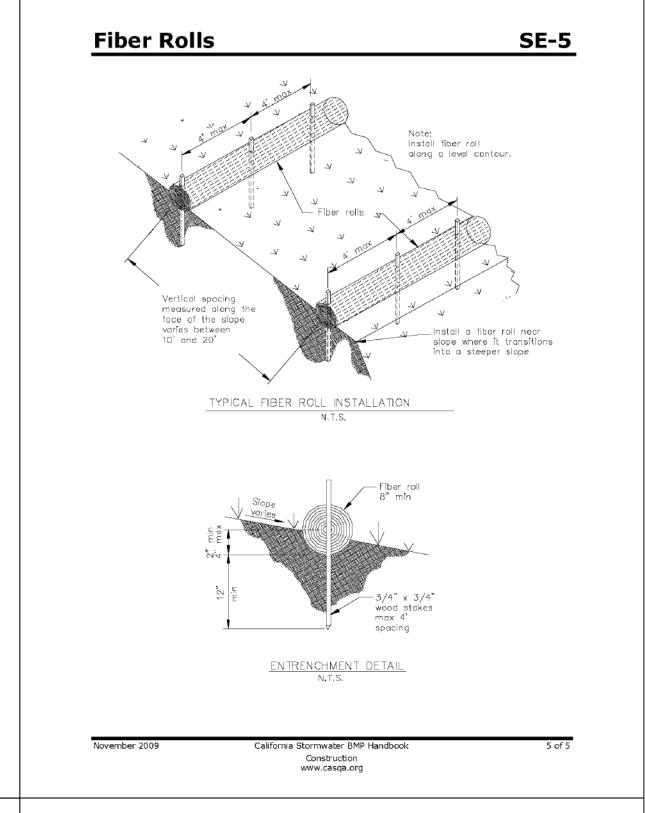


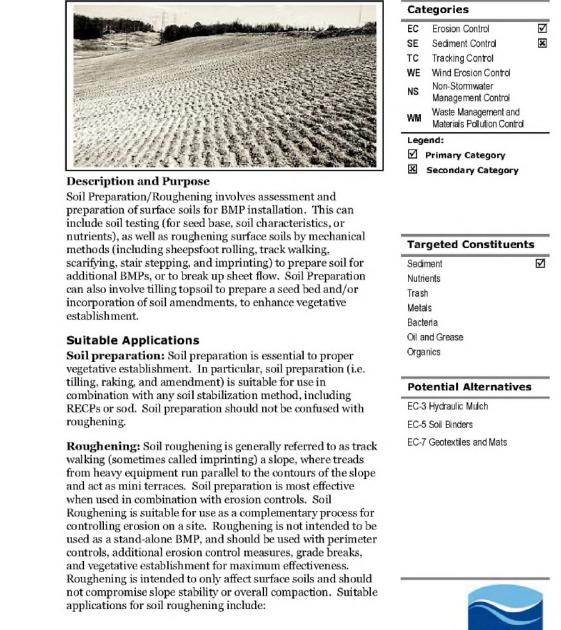


Soil Preparation/Roughening

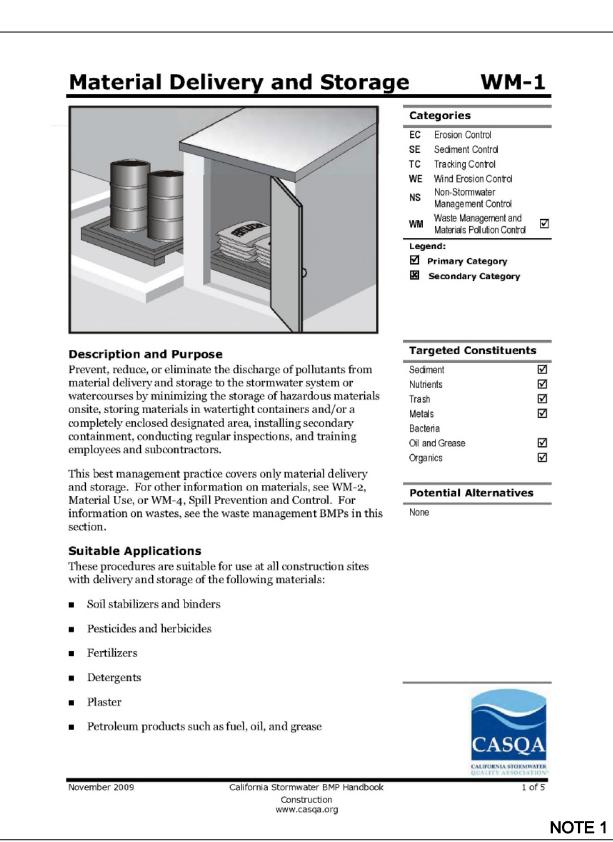

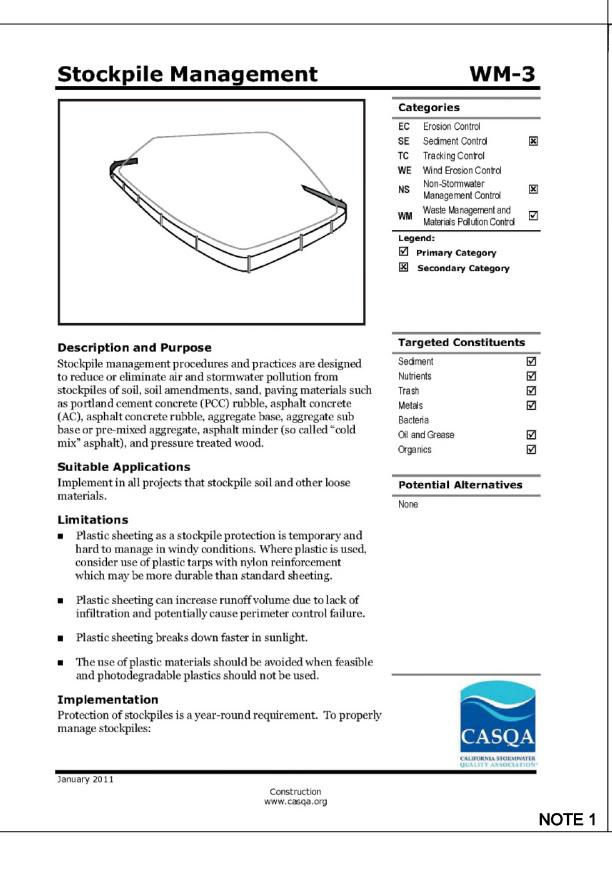


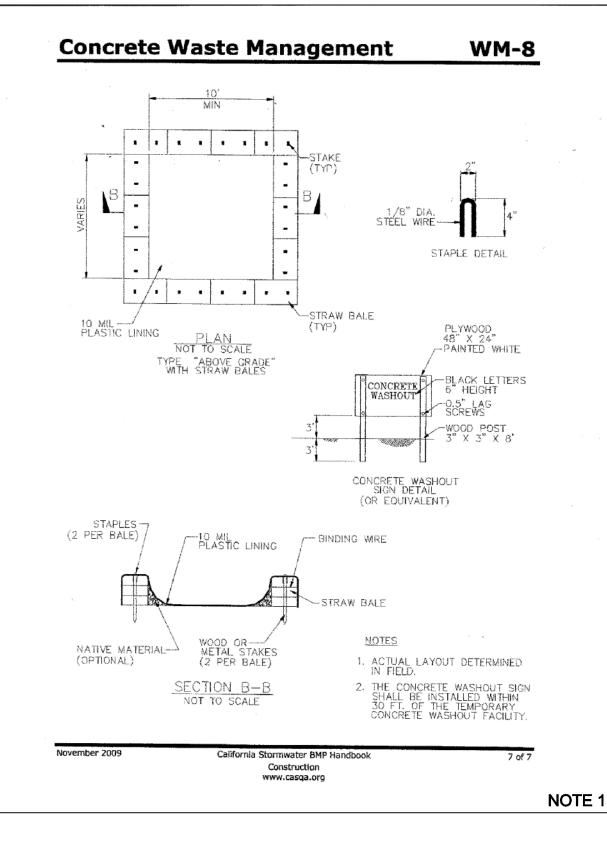

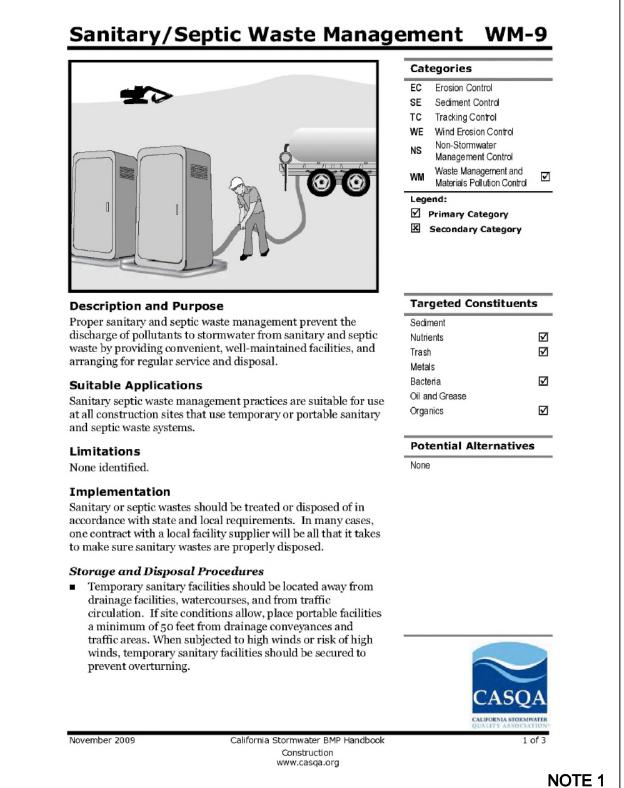

#### NOTES:

- 1. LOCATION TO BE DETERMINED IN FIELD BY CONTRACTOR, WITHIN EXIST FENCING.
- 2. ADDITIONAL INFORMATION INCLUDED IN PROJECT STORMWATER BMP BINDER.

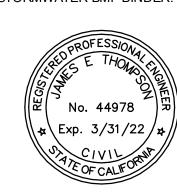

JET ENGINEERING
CONSULTING CIVIL ENGINEERS

1048 EL CAMINO REAL, SUITE C

**REDWOOD CITY, CA 94063** 

LANDS OF CAMILLERI 1462 EDGEWOOD RD

		REVISIONS		JOB NO. <b>R1462-E-18</b>
NO.	DATE	DESCRIPTION	BY	DATE: 03/10/21
				DRAWN: DC
				CHECKED: <b>JET</b>
				SCALE: NTS

EC.2

**15** OF **15** SHEETS

REDWOOD CITY, CA 94062

**EROSION CONTROL DETAILS** 

# November 2009 California Stormwater BMP Handbook Construction www.casqa.org

SIMILAR KIND.

ASSEMBLIES.

1. ALL WORK SHALL BE IN ACCORDANCE WITH THE CALIFORNIA CODE OF REGULATIONS

(TITLE 24) AND ALL OTHER LOCAL CODES AND ORDINANCES OF THE GOVERNING

THIS SHEET. IT IS THE INTENT OF THESE DOCUMENTS TO COMPLY THERETO.

CONTRACTOR DISCOVERS ANY DISCREPANCY BETWEEN THE DOCUMENTS, HE SHALL

COORDINATION OF WORK. INFORMATION SHOWN IN THE LARGEST GRAPHIC ARE

3. NOTATIONS MARKED "TYPICAL" (TYP.) SHALL BE CONSISTENT THROUGHOUT ALL SUCH

CONSTRUCTION CONDITIONS AND DIMENSIONS PRIOR TO ORDERING, FABRICATING. AND

CONTRACTOR SHALL PROMPTLY REQUEST FROM THE ARCHITECT CLARIFICATION PRIOR

MASONRY, FACE OF EXTERIOR STUDS, CENTERLINE OF STRUCTURAL COLUMNS AND

BEAMS, OR CENTERLINE OF INTERIOR STUDS, UNLESS OTHERWISE NOTED. CLEAR

FLOORING APPLIED TO THE STRUCTURAL FLOOR SUBSTRATE OF THE GROUND FLOOR

DATUM (MAIN ENTRANCE). CONTRACTOR SHALL INCLUDE REQUIRED DEPRESSIONS AND/OR PROJECTIONS IN ACHIEVING REQUIRED ELEVATIONS. CEILING HEIGHTS ARE

7. KEYNOTES USED ON THE DRAWINGS ARE FOR ASSEMBLIES, MATERIAL REFERENCES

REFERENCE NOMENCLATURE, SYMBOLS AND DRAWING INDICATIONS OF LIKE OR

INSTALLATION OF ANY ASSOCIATED WORK. IF DISCREPANCIES ARE FOUND, THE

INTENDED TO SUPPLEMENT INFORMATION OF SMALLER, PRECEDING REFERENCE

PROMPTLY REQUEST FROM THE ARCHITECT CLARIFICATION OF GOVERNING CRITERIA.

REFER TO THE ARCHITECTURAL DRAWINGS FOR EXACT PLACEMENT, ORIENTATION AND

2. ALL DRAWINGS ARE TO BE USED IN CONCERT WITH EACH OTHER. IF THE

4. <u>DO NOT SCALE THE DRAWINGS</u>. THE CONTRACTOR SHALL FIELD VERIFY

5. DIMENSIONS ARE RELATED SPECIFICALLY TO FACE OF CONCRETE, FACE OF

DIMENSIONS ARE INDICATED FROM FINISHED SURFACES OF MATERIALS OR

6. BUILDING ELEVATION REFERENCES ARE FROM DIRECT APPLICATION OF FINISH

REFERENCED TO FINISHED SURFACES UNLESS OTHERWISE NOTED.

TO COMMENCEMENT OF ASSOCIATED WORK.

AUTHORITY HAVING JURISDICTION, AND AS IDENTIFIED UNDER APPLICABLE CODES ON

EDGEWOOD COVERED PORCH PARCEL 2 NON-DEVELOPMENT PARCEL 2 F.F. 108.5' PATIO (NOT COVERED) IMPERMEABLE PAVING LESS THAN 15% SLOPE (E) GRADE @ SINGLE STORY 107.75' @´2ND STORY 107.9' 42" WIDE SIDEWALK REAR SETBACK PROPERTY LINE S47°12'00"E - 252.12' SITE PLAN CAMILLERI RESIDENCE 1450 EDGEWOOD RD. REDWOOD CITY, CA 94062 SHEET INDEX GENERAL NOTES PROJECT DIRECTORY

10. CONTRACTOR SHALL VERIFY, AT SITE, ALL EXISTING CONDITIONS PRIOR TO

OWNER IN ACCORDANCE WITH PROVISIONS OF THE SPECIFICATIONS.

SUBMITTAL OF BIDS. SITE VISITS DURING BIDDING SHALL BE COORDINATED WITH THE

11. CONTRACTOR SHALL PROTECT ALL EXISTING WORK. ANY DAMAGED WORK SHALL BE

12. CONTRACTOR(S) SHALL BE RESPONSIBLE FOR THEIR OWN CLEANUP AS WORK

14. EXISTING CONSTRUCTION SHOWN ON THE DRAWINGS WAS OBTAINED FROM THE

13. ALL WORK IS NEW UNLESS OTHERWISE NOTED.

TITLE 24, PART 1, CHAPTER 4, GROUP 1.

TITLE 24, AND APPROVED T. & I. SHEET.

SITE AT ALL TIMES.

4-343, PART 1, TITLE 24

WITH THE WORK.

REPLACED WITH THE SAME MATERIALS, INCLUDING MATCHING THE EXISTING COLORS

ORIGINAL CONSTRUCTION DRAWINGS. THESE ORIGINAL CONSTRUCTION DRAWINGS ARE

AVAILABLE AT THE ARCHITECT'S OFFICE FOR REVIEW. THE ORIGINAL CONSTRUCTION

CONDITIONS AND NOTIFY THE ARCHITECT OF ALL EXCEPTIONS BEFORE PROCEEDING

A. A COPY OF PARTS 1 AND 2, TITLE 24, C.C.R. SHALL BE KEPT ON THE JOB

C. ALL TESTS TO CONFORM TO THE REQUIREMENT OF SECTION 4-335, PART 1,

B. ALL CHANGE ORDERS AND ADDENDA TO BE SIGNED BY THE ARCHITECT AND THE

OWNER AND APPROVED. CHANGE ORDERS ARE NOT VALID UNTIL APPROVED.

D. TESTS OF MATERIALS AND TESTING LABORATORY SHALL BE IN ACCORDANCE WITH

SECTION 4-335 OF PART 1, TITLE 24, AND THE OWNER SHALL EMPLOY AND

PAY THE LABORATORY. COSTS OF RE-TEST MAY BE BACK CHARGED TO THE

E. THE CONTRACTOR SHALL PERFORM HIS DUTIES IN ACCORDANCE WITH SECTION

16. GRADING PLANS, DRAINAGE IMPROVEMENTS, ROAD AND ACCESS REQUIREMENTS, AND


ENVIRONMENTAL HEALTH CONSIDERATIONS SHALL COMPLY WITH LOCAL ORDINANCES.


DRAWINGS ARE NOT A PART OF THE CONSTRUCTION DOCUMENTS AND DO NOT

15. CONSTRUCTION SHALL BE ADMINISTERED PER CALIFORNIA CODE OF REGULATIONS

WARRANT EXISTING CONDITIONS. THE CONTRACTOR SHALL VERIFY ALL EXISTING

# PARCEL 2 NON-DEVELOPMENT

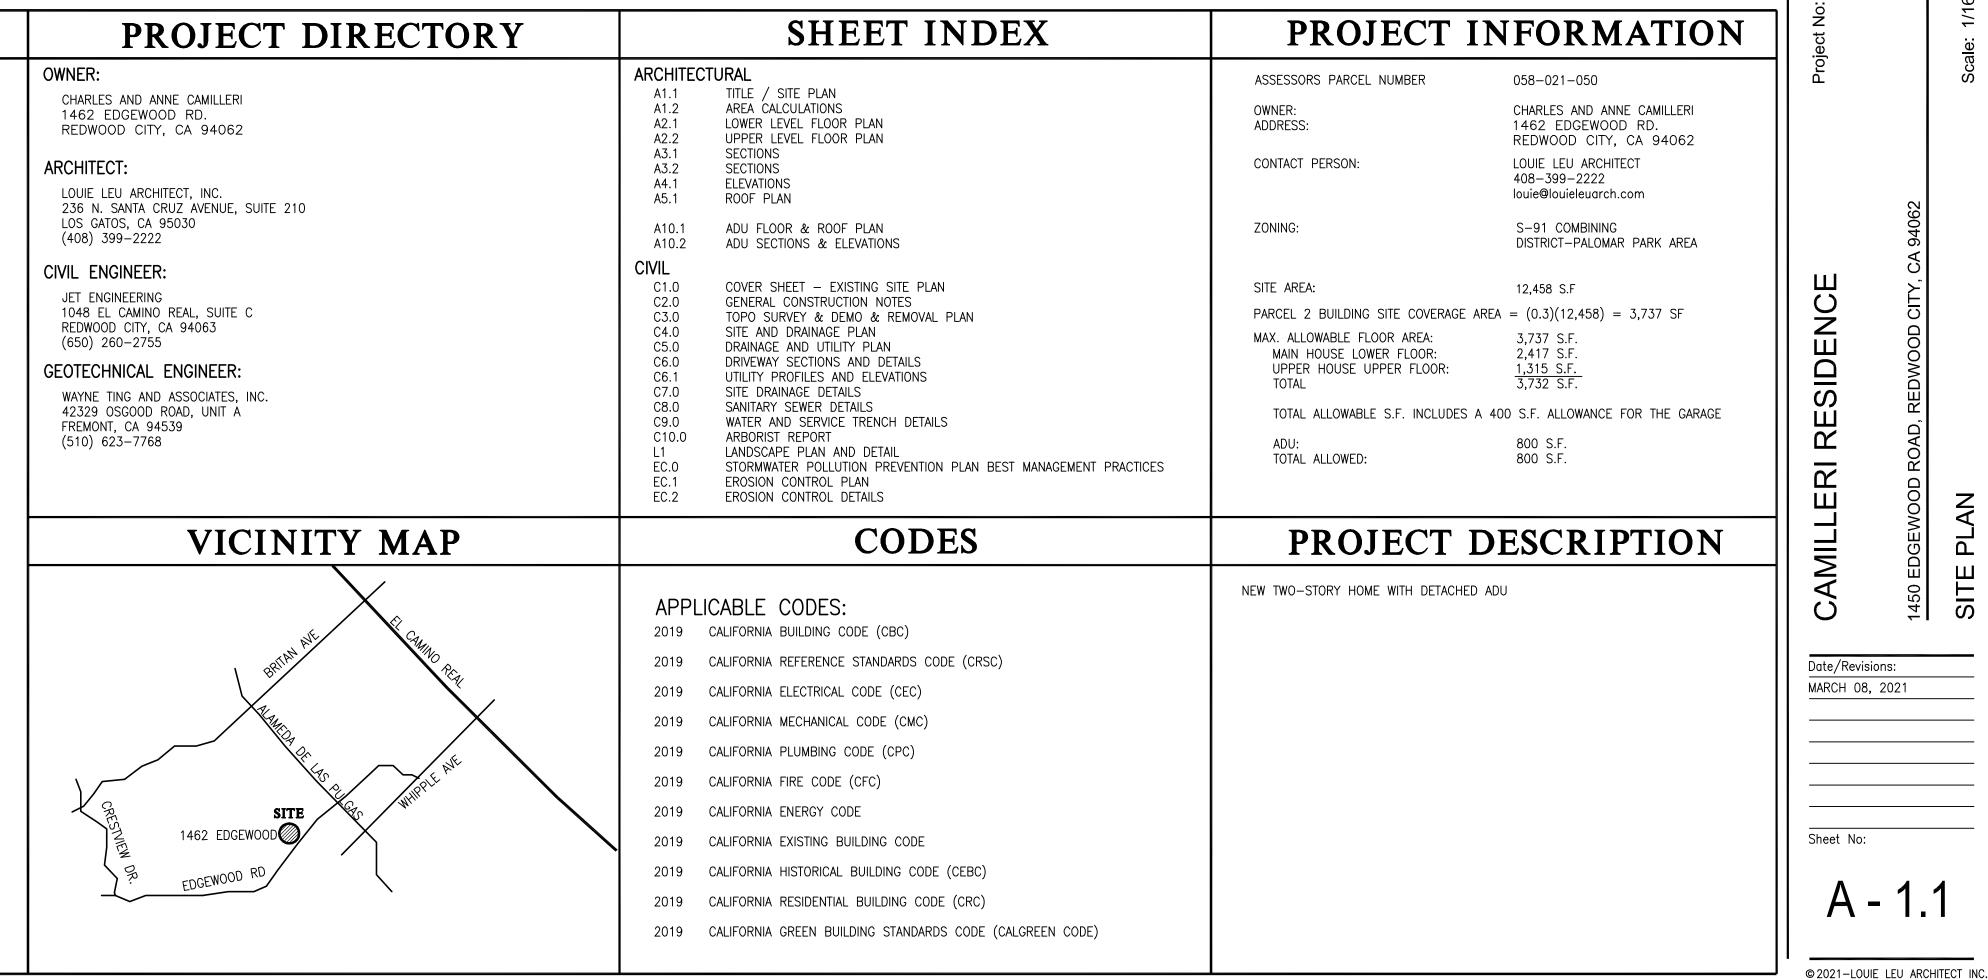

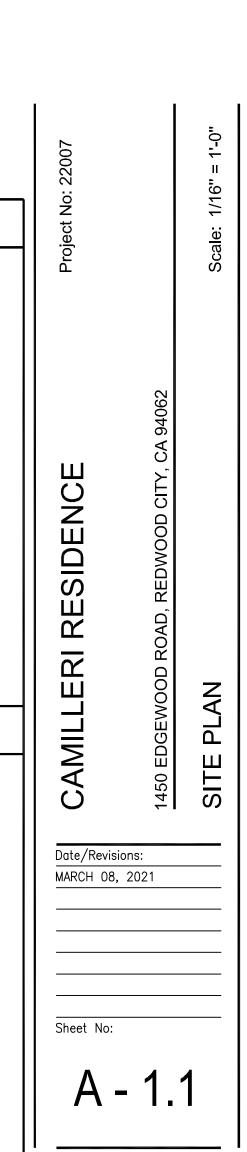

AREA CALCULATIONS

AREA

753 SQ. FT.

235 SQ. FT.

168 SQ. FT.

158 SQ. FT.

1,314 SQ. FT.

515 SQ. FT.

129 SQ. FT.

1072 SQ. FT.

528 SQ. FT.

13 SQ. FT.

160 SQ. FT.

2,417 SQ. FT.

1,314 SQ. FT.

2,417 SQ. FT. 3,731 SQ. FT.

3,731 SQ. FT. 3,737 SQ. FT.

CALCULATION

UPPER LEVEL FLOOR AREA

LOWER LEVEL FLOOR PLAN

TOTAL UPPER LEVEL FLOOR

TOTAL LOWER LEVEL FLOOR

TOTAL FLOOR AREA PROPOSED

MAXIMUM ALLOWABLE FLOOR AREA 3,337 SQ.FT • 400 SQ.FT GARAGE EXCLUSION

30'-1/2" X 21'-6"

24'-8 1/2" X 9'-6"

8'-9" X 19'-2 1/2"

TOTAL UPPER LEVEL

20'-11 1/2" X 21'-6"

13'-7 1/2" X 8'-6"

53'-7 1/2" X 20'-0"

47'-11 1/2" X 11'-0"

6'-6" X 1'-1 1/2"

TOTAL LOWER LEVEL

TOTAL

8'-0" X 20'-0"

13'-9 1/2" X 11'-5 1/2"


MARCH 08, 2021

© 2021-LOUIE LEU ARCHITECT INC.


ROOF BELOW ROOF BELOW


—HIGH CEILING ABOVE NOT COUNTED

#### UPPER LEVEL FLOOR PLAN

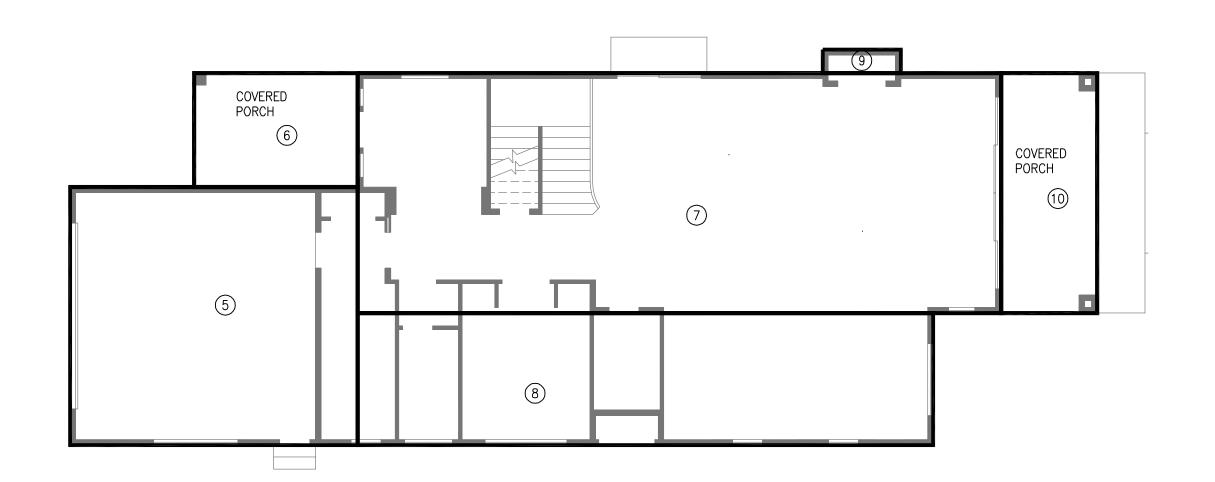

LOWER LEVEL FLOOR PLAN

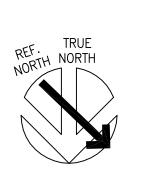

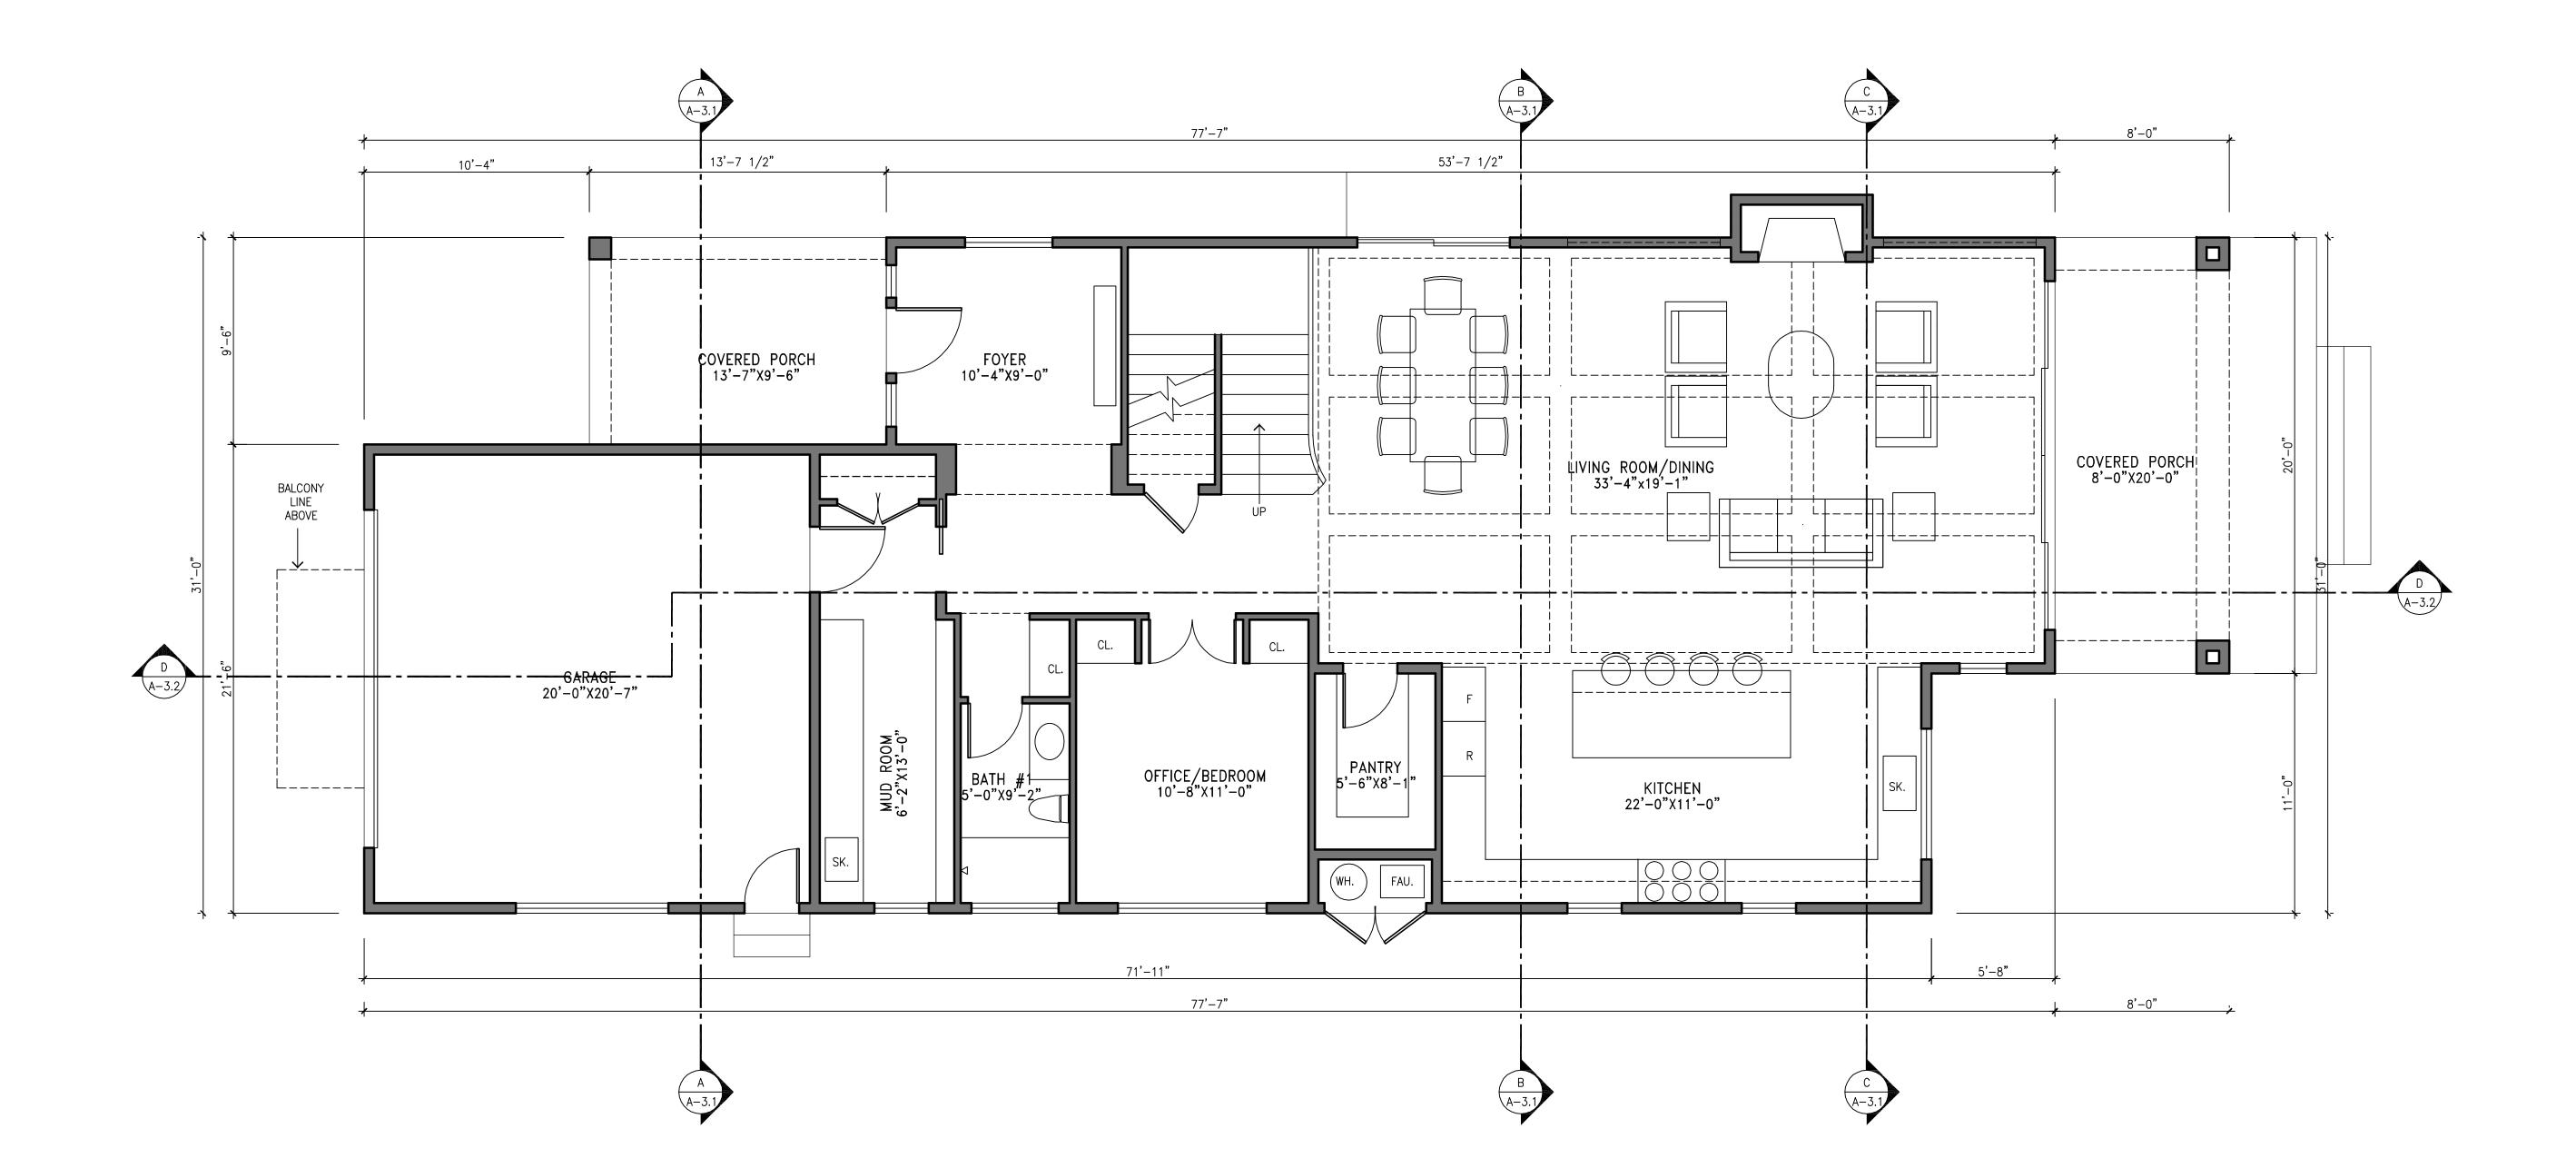



A No. C15688 A RENEWAL DATE CALIFORNIA

ГҮ, СА 94062

CAMILLERI RESIDENCE

1450 EDGEWOOD ROAD, REDW

Date/Revisions: MARCH 08, 2021


Sheet No:

A - 2.1

UPPER LEVEL FLOOR PLAN


43'-9 1/2"


33'-5 1/2"

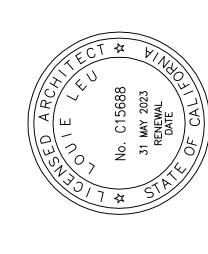

CAMILLERI RESIDENCE

Date/Revisions:

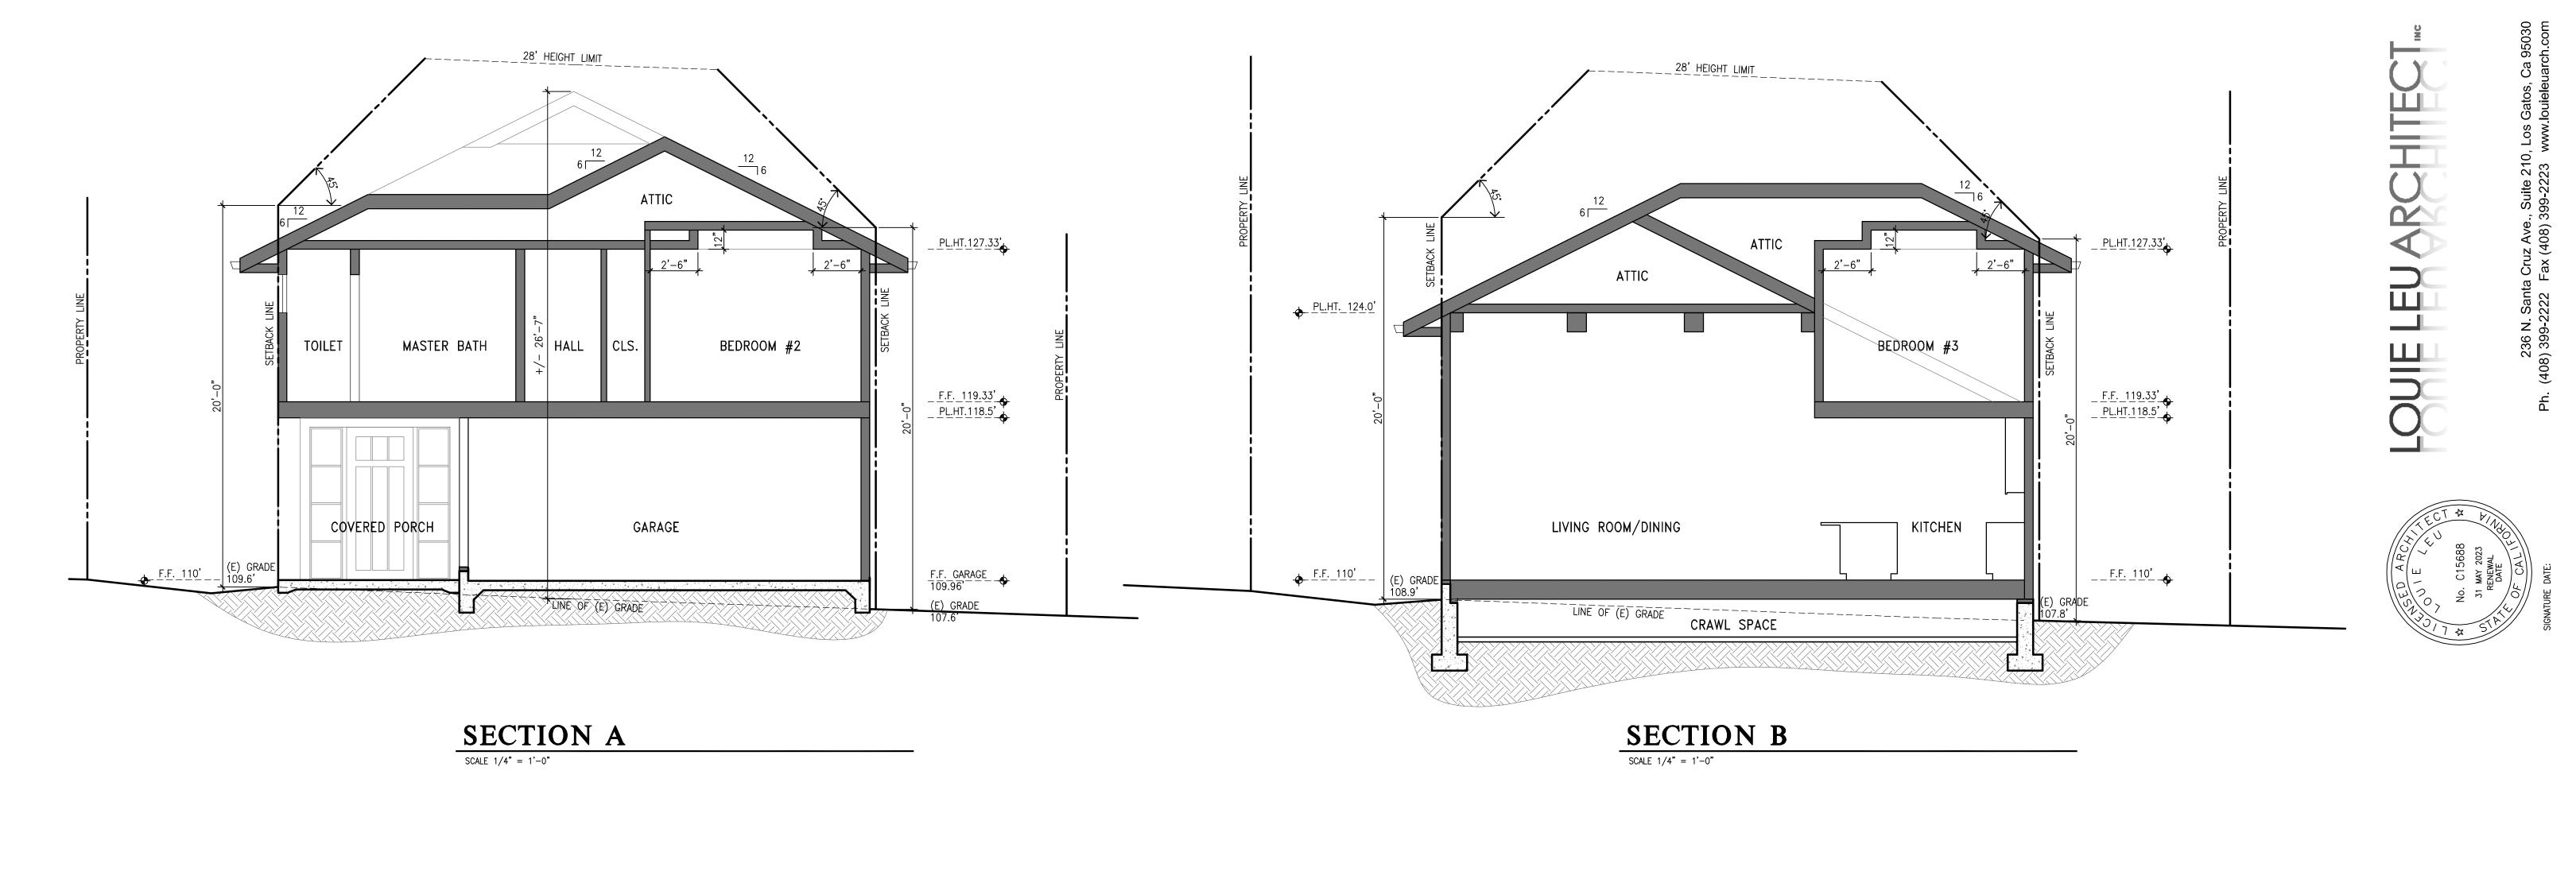

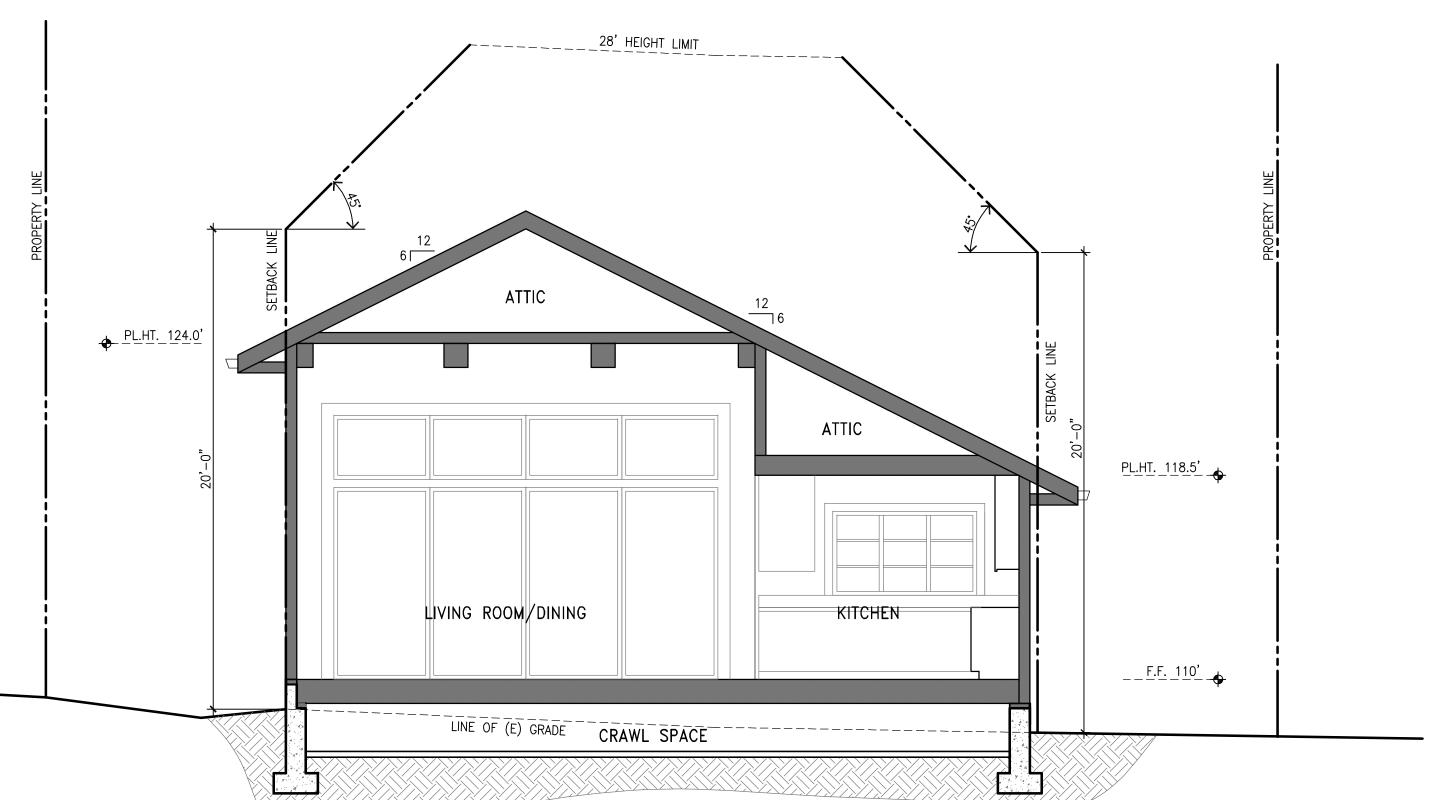

SECTION C


SCALE 1/4" = 1'-0"



- A. PROVIDE FIREBLOCKING IN SPACES OF WALLS AND PARTITIONS INCLUDING FURRED SPACES AT CEILING LEVELS @ 10' MAX. INTERVALS, HORIZONTALLY & VERTICALLY.
- B. SEE TITLE 24 ENERGY COMPLIANCE SHEET FOR INSULATION REQUIREMENTS.
- C. SEE STRUCTURAL DRAWINGS FOR ADDITIONAL INFORMATION
- D. CONTRACTOR TO HAVE BLDG. ELEVATION HEIGHTS SURVEYED BY R.C.E. OR LLS OF RECORD FOR CONFORMANCE W/ HEIGHT RESTRICTIONS, PRIOR TO COMMENCEMENT OF UPPER FLOOR WALL AND ROOF FRAMING.
- E. INSTALL RESILIENT CHANNEL AT BOTTOM OF FLOOR JOISTS WHERE CEILINGS OF LIVING SPACE IS DIRECTLY BELOW.
- F. ATTIC ACCESS FOR THE FURNACE SHALL BE MINIMUM 30"X30".

  DISTANCE FROM PASSAGEWAY OPENING ACCESS TO THE
  APPLIANCE HALL NOT EXCEED 20'.

  24' WIDE SOLID FLOORING ACCESS WAY IS REQUIRED.
  30"X30" WORKING PLATFORM OR GRADE SURFACE IN FRONT OF
  THE SERVICE SIDE OF THE APPLIANCE.
  A PERMANENT 120-VOLT RECEPTACLE OUTLET AND A LIGHTING
  FIXTURE TO BE INSTALLED NEAR THE APPLIANCE

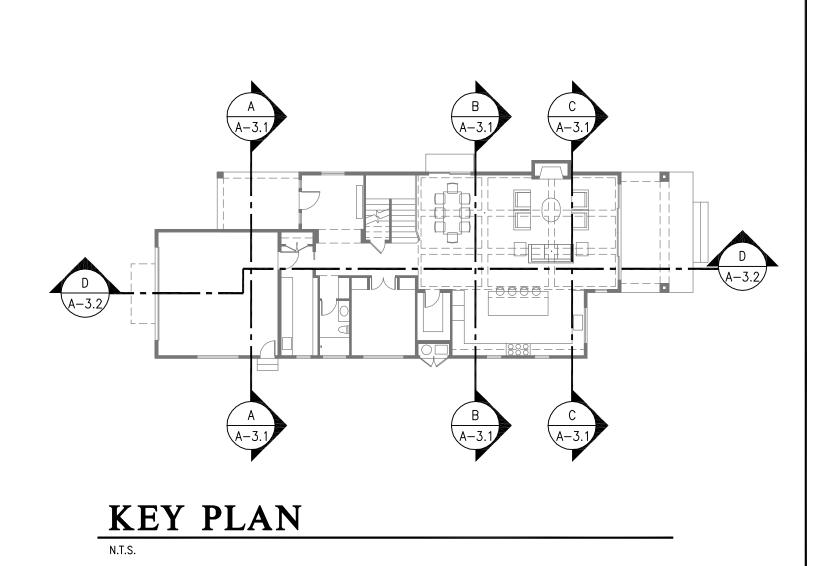


CAMILLERI RESIDENCE

Project No: 22007

1450 EDGEWOOD ROAD, REDWOOD CITY, CA 94062

Scale: 1/4" = 1'-0"

A - 3.1

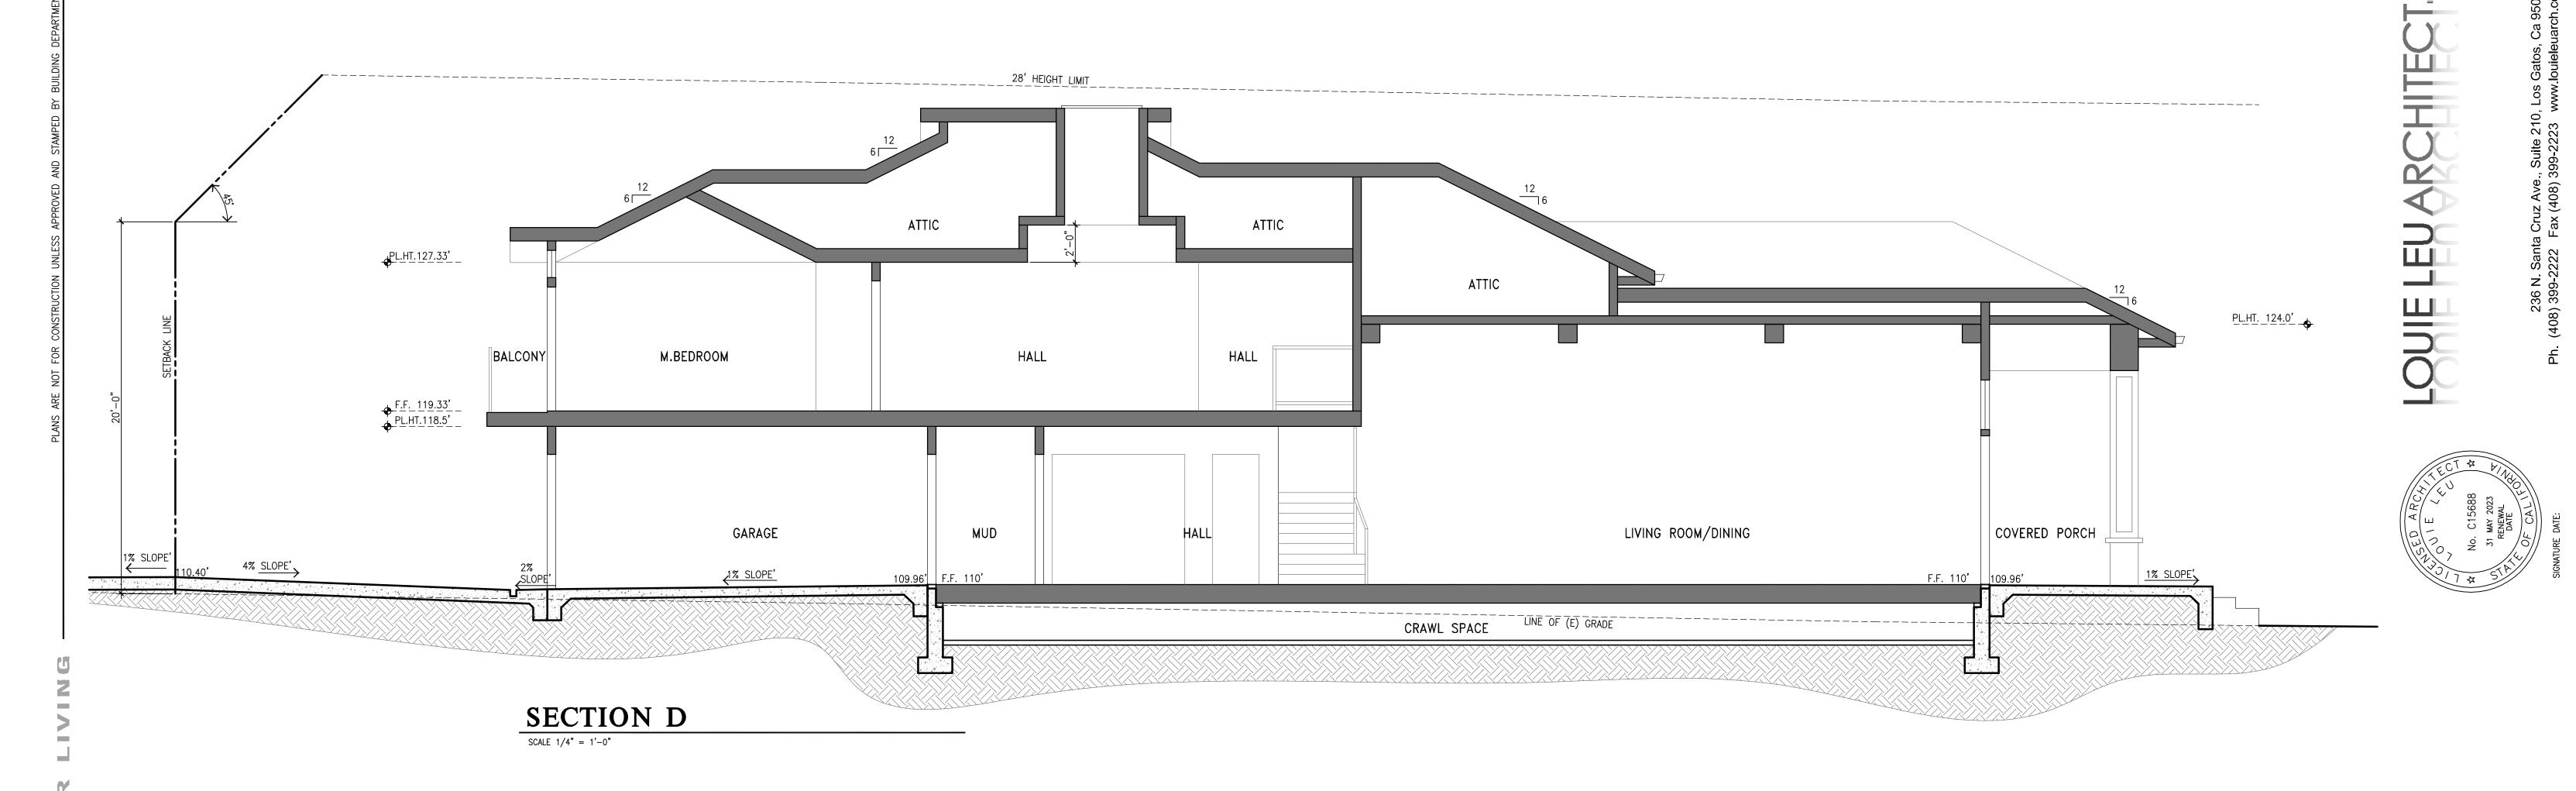


#### GENERAL NOTES

- A. PROVIDE FIREBLOCKING IN SPACES OF WALLS AND PARTITIONS INCLUDING FURRED SPACES AT CEILING LEVELS @ 10' MAX. INTERVALS, HORIZONTALLY & VERTICALLY.
- B. SEE TITLE 24 ENERGY COMPLIANCE SHEET FOR INSULATION REQUIREMENTS.
- C. SEE STRUCTURAL DRAWINGS FOR ADDITIONAL INFORMATION
- D. CONTRACTOR TO HAVE BLDG. ELEVATION HEIGHTS SURVEYED BY R.C.E. OR LLS OF RECORD FOR CONFORMANCE W/ HEIGHT RESTRICTIONS, PRIOR TO COMMENCEMENT OF UPPER FLOOR WALL AND ROOF FRAMING.
- E. INSTALL RESILIENT CHANNEL AT BOTTOM OF FLOOR JOISTS WHERE CEILINGS OF LIVING SPACE IS DIRECTLY BELOW.
- F. ATTIC ACCESS FOR THE FURNACE SHALL BE MINIMUM 30"X30".

  DISTANCE FROM PASSAGEWAY OPENING ACCESS TO THE
  APPLIANCE HALL NOT EXCEED 20'.


  24' WIDE SOLID FLOORING ACCESS WAY IS REQUIRED.
  30"X30" WORKING PLATFORM OR GRADE SURFACE IN FRONT OF
  THE SERVICE SIDE OF THE APPLIANCE.
  A PERMANENT 120-VOLT RECEPTACLE OUTLET AND A LIGHTING
  FIXTURE TO BE INSTALLED NEAR THE APPLIANCE

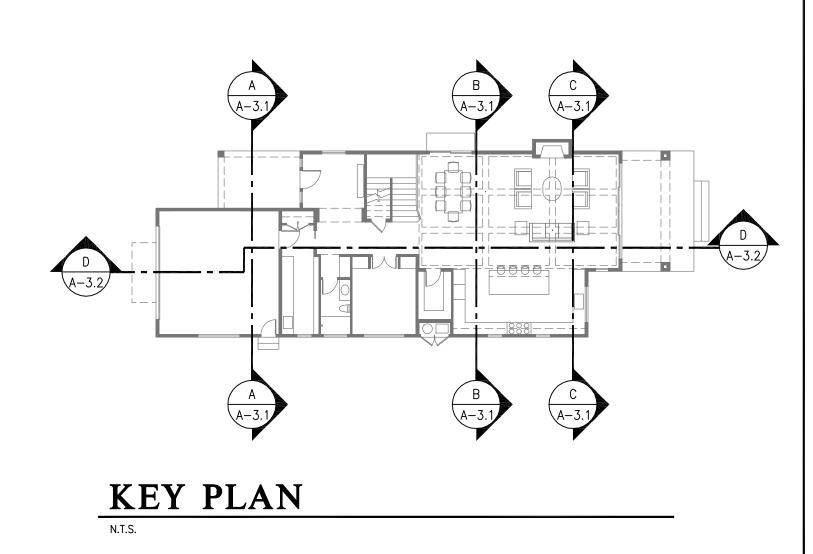

| CAMILLERI RESIDENCE | Project No: 22007 | 1450 EDGEWOOD ROAD, REDWOOD CITY, CA 94062 | Scale: 1/4" = 1'-0" | SECTIONS | Scale: 1/4" = 1'-0" |

© 2021-LOUIE LEU ARCHITECT INC.

P:\22007-Edgewood\Drawings\CAD\A3-Sections.dwg - 03.09.2021 - 10:01am

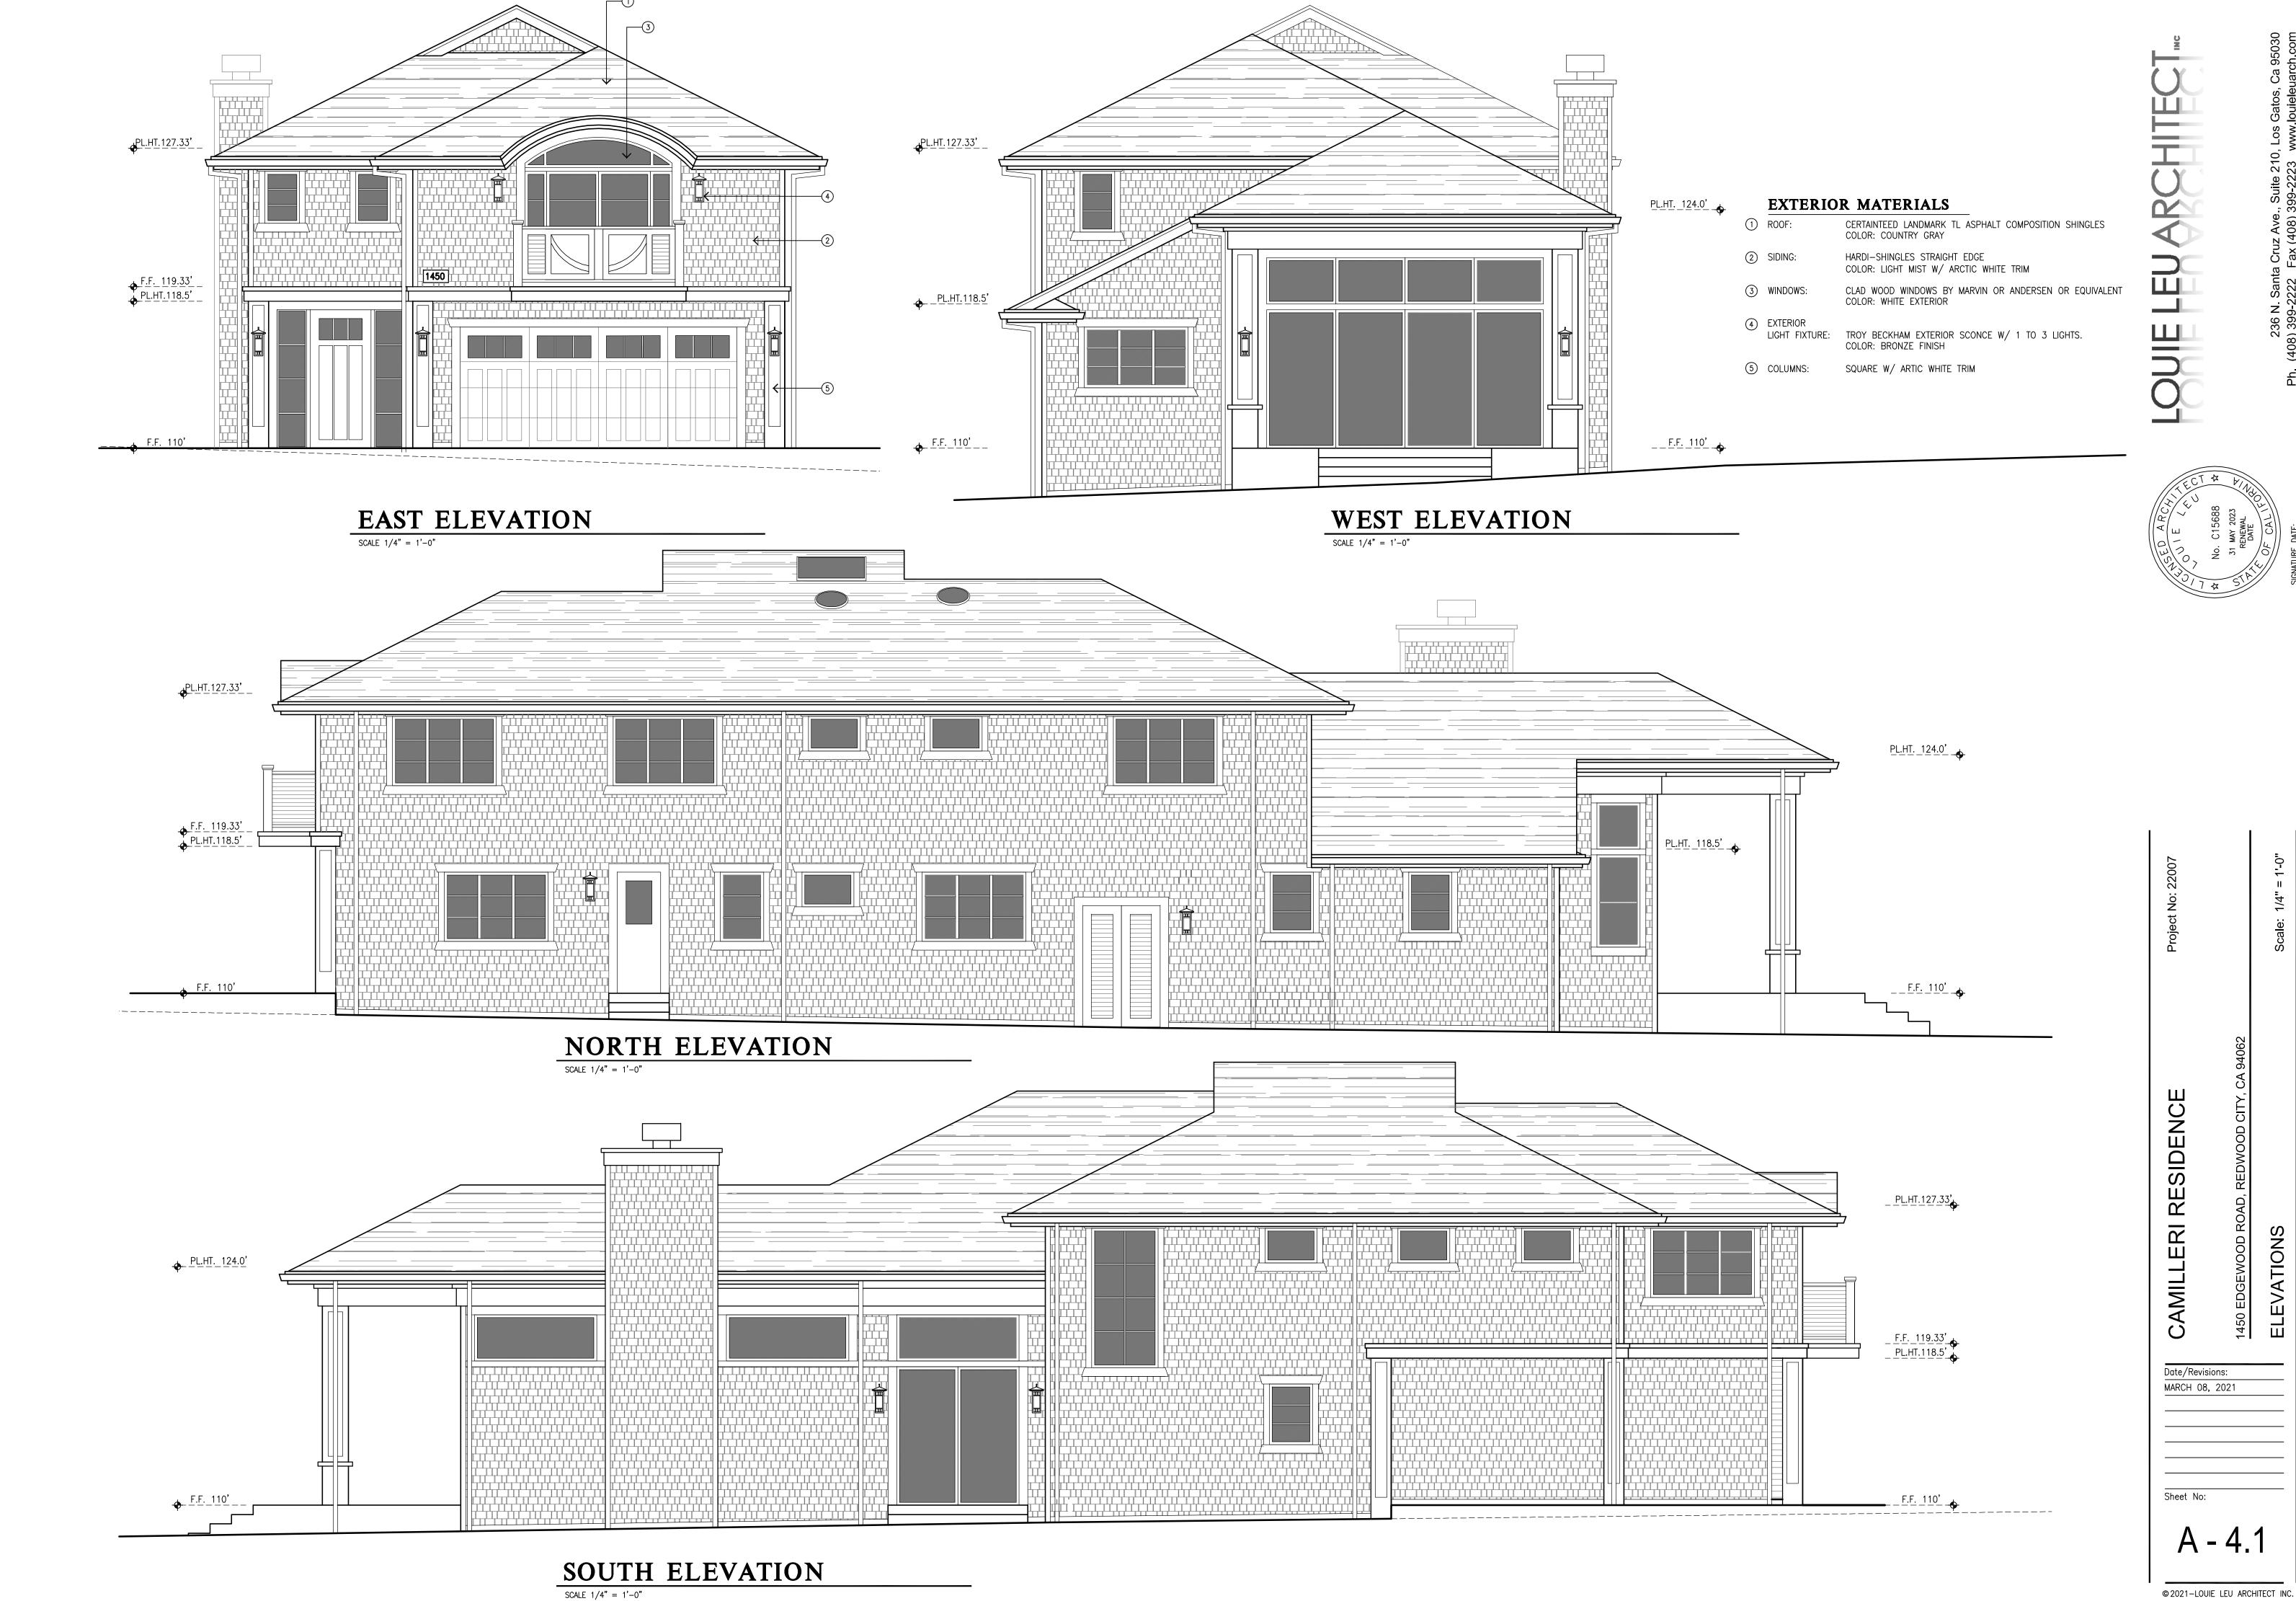

80 MIL. SINGLE PLY PVC ROOF BY IB ROOF SYSTEMS — CLASS ———

INSULATION SLOPE 1/4" FT. MIN.

GUTTER

·--<del>|-</del>------

'A' RATED O/ TAPERED

- CERTAINTEED LANDMARK TL ASPHALT COMPOSITION SHINGLES COLOR: COUNTRY GRAY

**KEY NOTES** 1 VELUX SKYLIGHT 4'-0" X 3'-0"


2 VELUX SUN-TUNNEL 14"

A. INSTALL "GRACE" ICE AND WATERSHIELD FLEXIBLE MEMBRANE FLASHING @ RIDGES, HIPS, EAVES, VALLEYS, SKYLIGHTS & ROOF PROTRUSIONS, A 36" WIDE, 72# CAP SHEET SHALL BE PLACED IN ALL VALLEYS PRIOR TO ANY OTHER UNDERLAYMENT ROOFING MATERIAL & AT LOW SLOPE ROOFS LESS THAN 3½":12 PITCH

- B. ALL ROOF DOWNSPOUTS AND DRAINS TO BE COLLECTED AND DISCHARGED TO A CLOSED PIPE SYSTEM, SEE CIVIL PLANS
- C. SEE TITLE 24 ENERGY COMPLIANCE SHEET FOR INSULATION REQUIREMENTS

**GENERAL NOTES - ROOF** 

- D. SEE STRUCTURAL DRAWINGS FOR ADDITIONAL INFORMATION
- FINISHED ROOFING MATERIAL SHALL BE INSTALLED AND COMPLETED PRIOR TO FRAME INSPECTION
- F. A LETTER FROM A LICENSED CIVIL ENGINEER OR SURVEYOR SHALL BE PROVIDED TO THE BUILDING DEPARTMENT AT THE TIME OF THE ROOF NAIL INSPECTION INDICATING THE BUILDING HEIGHT IS IN COMPLIANCE WITH
- LOCATION

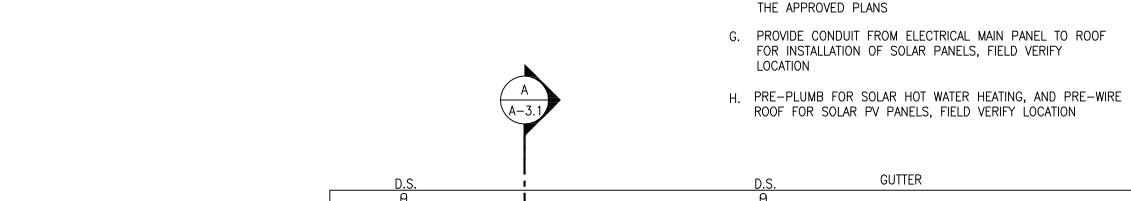


CRĬCKET

**ROOF PLAN** 


CAMILLERI RESIDENCE

Date/Revisions: MARCH 08, 2021

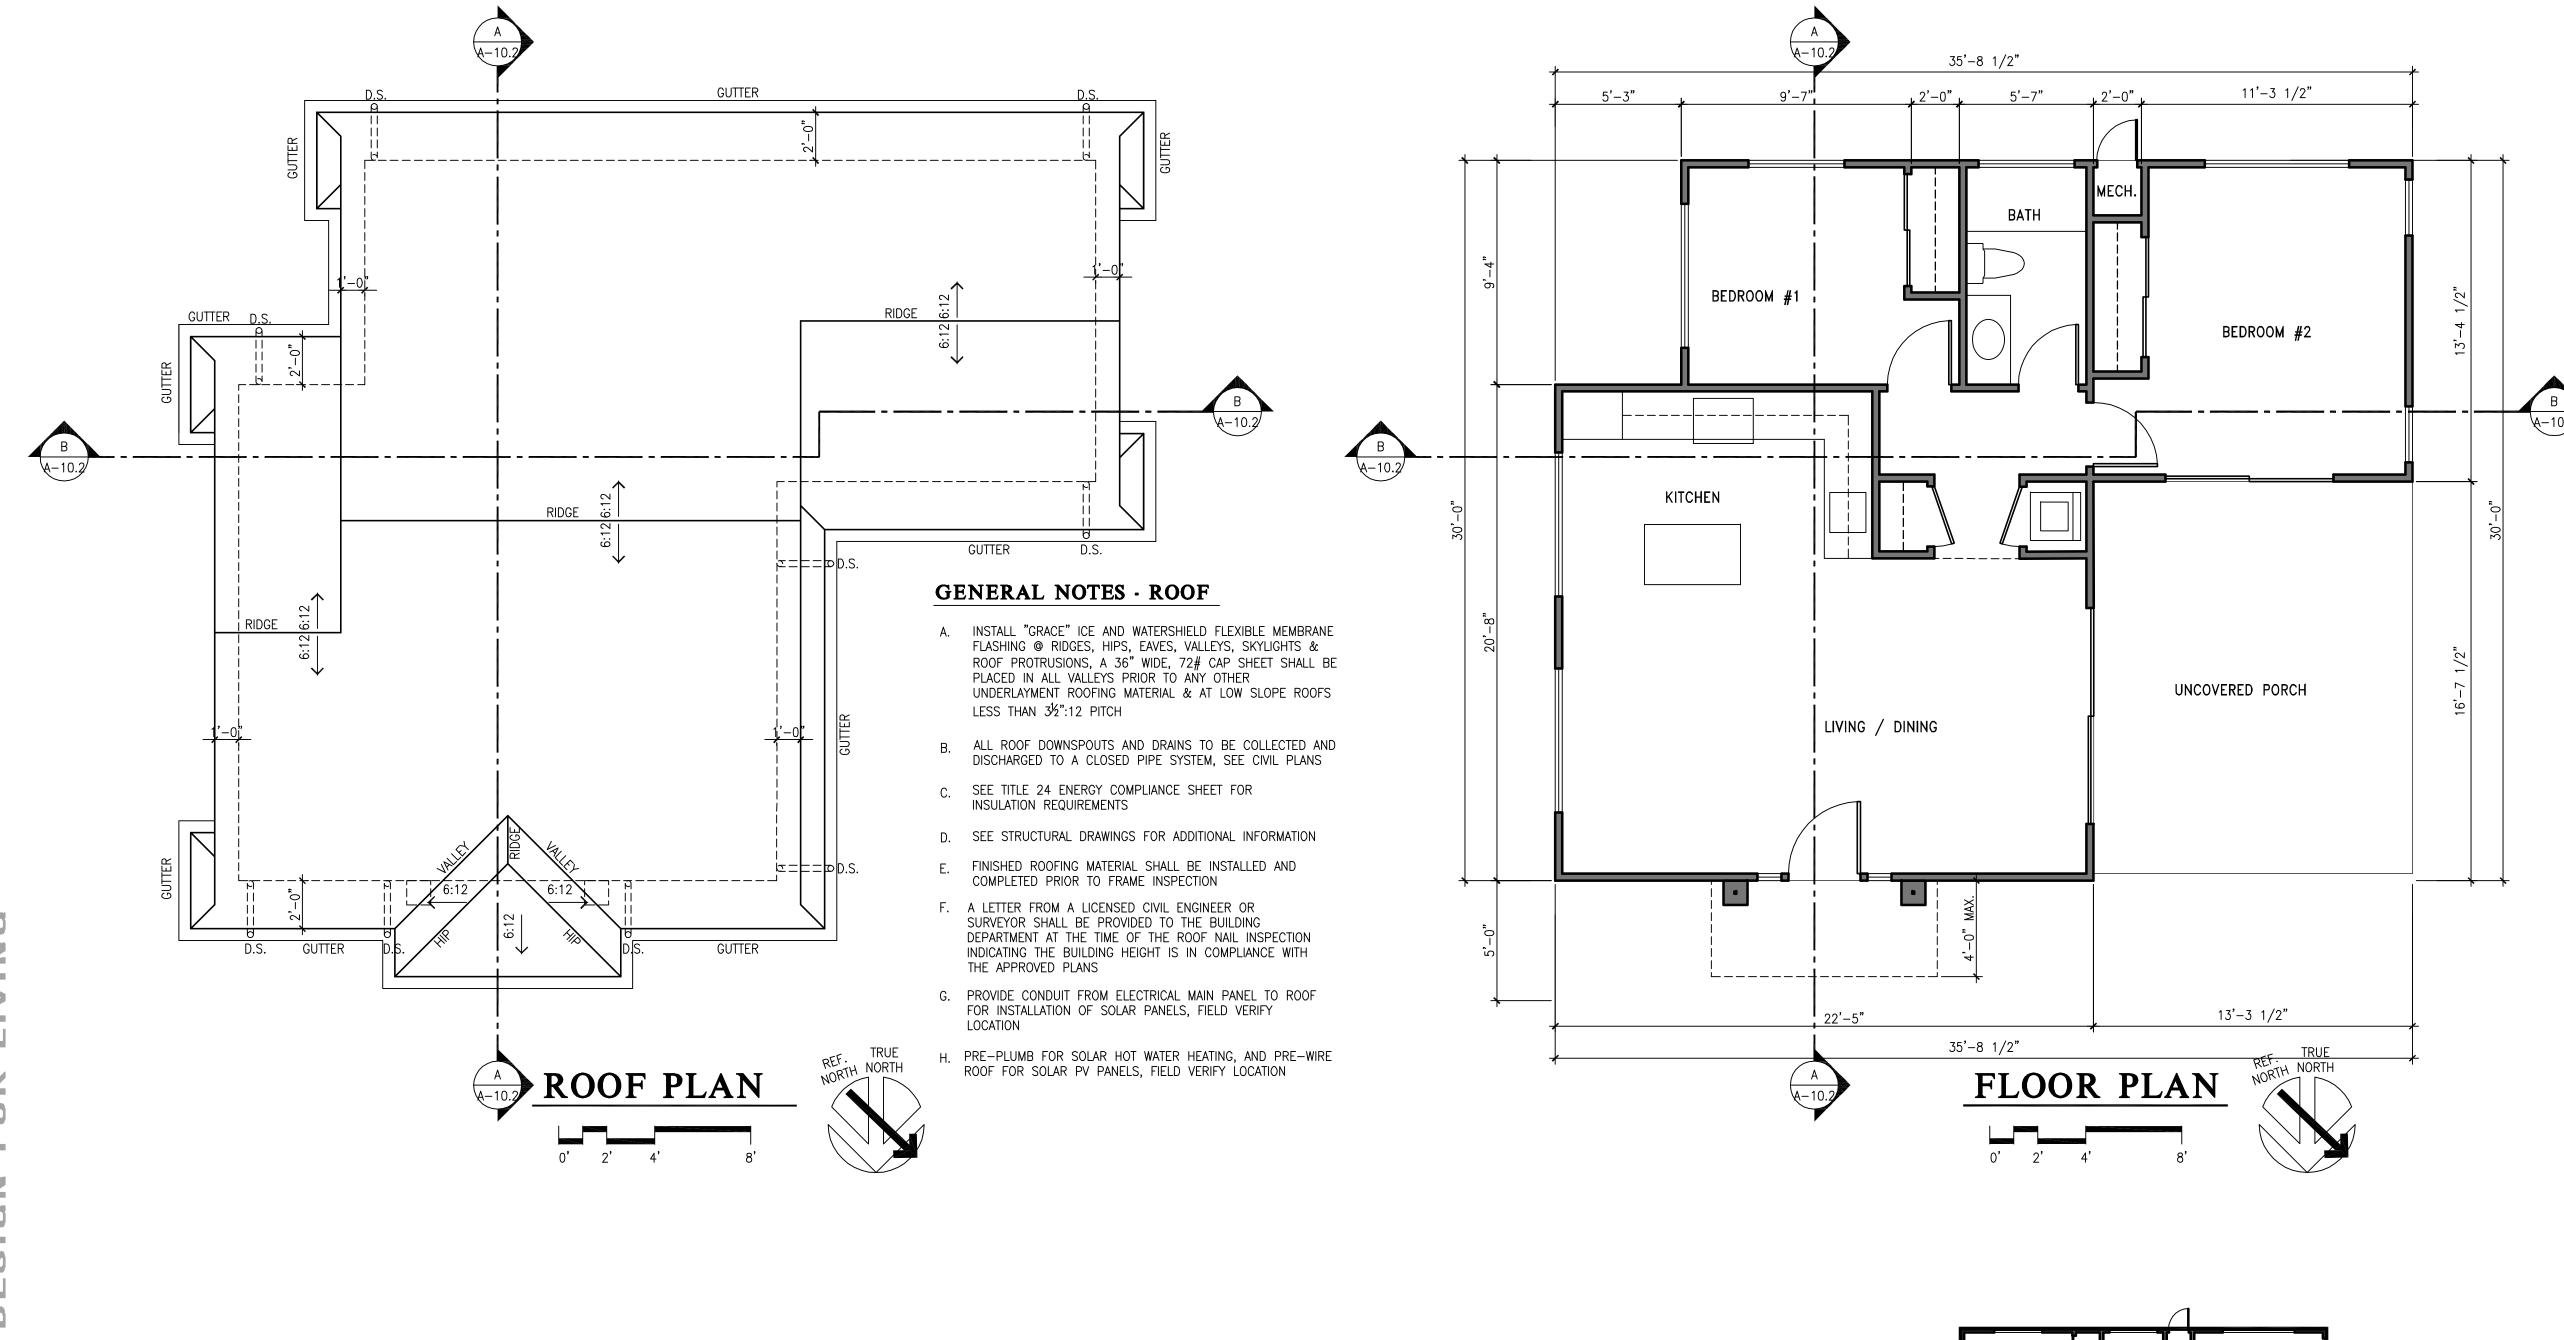



- A. LANDING AT EXT. DOORS SHALL BE THE WIDTH OF THE OPERABLE DOOR X 36" DEEP. THE LANDING SHALL NOT BE MORE THAN 7.75" BELOW THE TOP OF THE THRESHOLD. THRESHOLDS SHALL NOT EXCEED .5" MAX. DOWN FOR OUTWARD SWINGING DOORS, .75" FOR SLIDERS, AND 7.75" MAX. FOR INWARD SWING DOORS PER CRC SECTION R311
- B. ALL SLEEPING ROOMS TO BE PROVIDED WITH ONE EGRESS ESCAPE/ RESCUE WINDOW. EGRESS WINDOW SHALL HAVE A MINIMUM NET CLEAR OPENABLE AREA OF 5.7 SQ. FT. MIN. CLR. HT. OF 24" AND A MIN. CLEAR WIDTH OF 20". BOTTOM OF THE CLEAR OPENING SHALL NOT BE MORE THAN 44" ABOVE FINISHED FLOOR PER CRC SECTION R310
- C. PROVIDE ANTI-SCALD BALANCING VALVES @ SHOWERS & TUBS/SHOWER
- D. SEE TITLE 24 FOR INSULATION REQUIREMENTS
- E. ALL HOSE BIBBS TO HAVE BACKFLOW PREVENTERS, TYP.
- F. 5/8" GYP. BOARD TYP. ON ALL INTERIOR WALLS. 5/8" TYPE 'X'. LEVEL 5 SMOOTH FINISH EXCEPT LEVEL 4 @ GARAGE & UTILITY ROOMS
- G. PROVIDE 6" HIGH BUILDING NUMBERS CLEARLY VISIBLE AND LEGIBLE FROM THE ADJACENT PUBLIC WAY OR STREET PER CRC SECTION R309. LOCATION & STYLE TO BE FIELD VERIFIED
- H. SEE CAL-GREEN SHEETS GB-1 FOR WATER CONSERVING PLUMBING FIXTURES AND FITTING REQUIREMENTS
- J. NO DOMESTIC DISHWASHING MACHINE SHALL BE DIRECTLY CONNECTED TO A DRAINAGE SYSTEM OR FOOD WASTE DISPOSER WITHOUT THE USE OF AN APPROVED DISHWASHER AIR GAP FITTING ON THE DISCHARGE SIDE OF THE DISHWASHING MACHINE. LISTED AIR GAP'S SHALL BE INSTALLED WITH THE FLOOD—LEVEL (FL) MARKING AT OR ABOVE THE FLOOD LEVEL OF THE SINK OR DRAINBOARD, WHICHEVER IS HIGHER. CPC SECTION 807.3

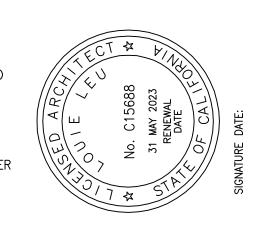

AREA CALCULATIONS

3 # CALCULATION AREA

FLOOR AREA CALCULATION

TAG #	CALCULATION	AREA
	ADU FLOOR AREA	
1	22'-6" X 20'-8"	465 SQ. FT.
2	30'-6" X 9'-3"	283 SQ. FT.
3	13'-4" X 4'-0"	52 SQ. FT.
	TOTAL ADU	800 SQ. FT.
	TOTAL ADU PROPOSED	800 SQ. FT.
	MAXIMUM ADU AREA ALLOWED	800 SQ. FT.

NOTE:
ADU IS NOT SUBJECT TO
DESIGN REVIEW

CAMILLERI RESIDENCE

Date/R	evisi	ons:	
MARCH	08,	2021	

A - 10.1

ATTIC **↓**SLOPED F.F. 118.5' KITCHEN BEDROOM #2 HALL ◆F.F.\_108.5′\_\_\_ LINE OF (E) GRADE CRAWL SPACE SECTION B

SCALE 1/4" = 1'-0"

#### GENERAL NOTES

- A. PROVIDE FIREBLOCKING IN SPACES OF WALLS AND PARTITIONS INCLUDING FURRED SPACES AT CEILING LEVELS @ 10' MAX. INTERVALS, HORIZONTALLY & VERTICALLY.
- B. SEE TITLE 24 ENERGY COMPLIANCE SHEET FOR INSULATION REQUIREMENTS.
- C. SEE STRUCTURAL DRAWINGS FOR ADDITIONAL INFORMATION
- D. CONTRACTOR TO HAVE BLDG. ELEVATION HEIGHTS SURVEYED BY R.C.E. OR LLS OF RECORD FOR CONFORMANCE W/ HEIGHT RESTRICTIONS, PRIOR TO COMMENCEMENT OF UPPER FLOOR WALL AND ROOF FRAMING.
- E. INSTALL RESILIENT CHANNEL AT BOTTOM OF FLOOR JOISTS WHERE CEILINGS OF LIVING SPACE IS DIRECTLY BELOW.
- ATTIC ACCESS FOR THE FURNACE SHALL BE MINIMUM 30"X30". DISTANCE FROM PASSAGEWAY OPENING ACCESS TO THE APPLIANCE HALL NOT EXCEED 20'. 24' WIDE SOLID FLOORING ACCESS WAY IS REQUIRED. 30"X30" WORKING PLATFORM OR GRADE SURFACE IN FRONT OF THE SERVICE SIDE OF THE APPLIANCE. A PERMANENT 120-VOLT RECEPTACLE OUTLET AND A LIGHTING FIXTURE TO BE INSTALLED NEAR THE APPLIANCE

CERTAINTEED LANDMARK TL ASPHALT COMPOSITION SHINGLES COLOR: COUNTRY GRAY

CLAD WOOD WINDOWS BY MARVIN OR ANDERSEN OR EQUIVALENT COLOR: WHITE EXTERIOR


NOTE: ADU IS NOT SUBJECT TO

DESIGN REVIEW


HARDI-SHINGLES STRAIGHT EDGE

\_\_\_<u>F.F.</u>\_1<u>18.5</u>′ \_\_ <u>F.F.</u> 108.5'


EAST ELEVATION

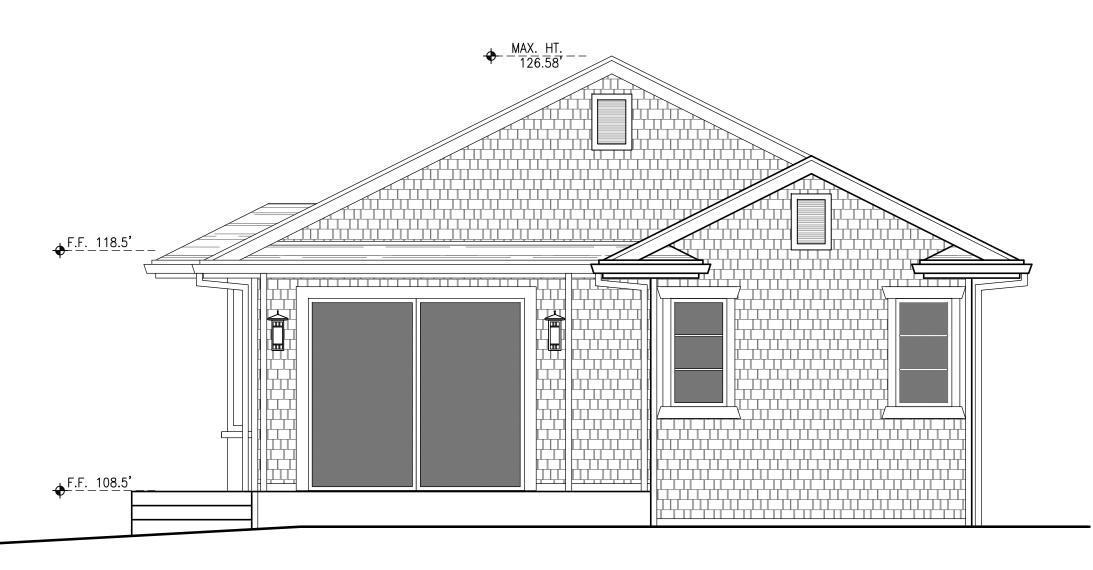

WEST ELEVATION

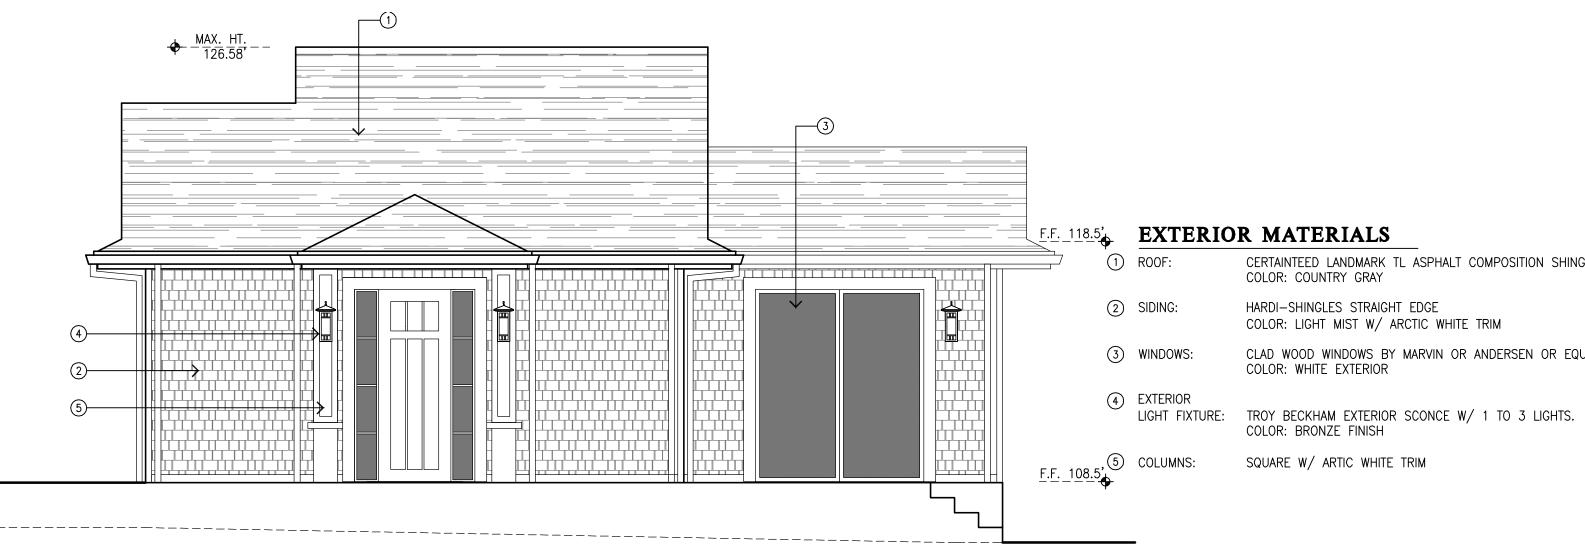

NORTH ELEVATION SCALE 1/4" = 1'-0"

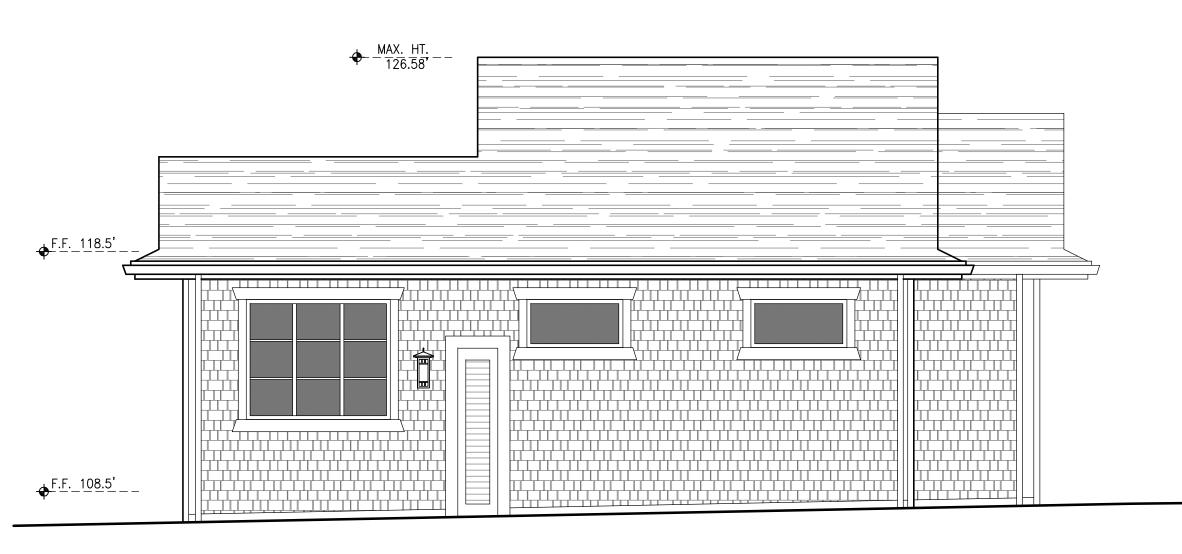

SOUTH ELEVATION

Date/Revisions: MARCH 08, 2021