COUNTY OF SAN MATEO PLANNING AND BUILDING

County Government Center

455 County Center, 2nd Floor Redwood City, CA 94063 650-363-4161 T planning.smcgov.org

July 26, 2021

Tim Patterson 3550 Cater Drive Apt.32 South San Francisco, CA 94080

Dear Tim Patterson:

SUBJECT: Coastside Design Review Committee Continuance

Cedar Avenue, Montara

APN 036-132-210; County File No. PLN 2019-00362

At its meeting of July 8, 2021, the San Mateo County Coastside Design Review Committee (CDRC) considered your application for a Design Review recommendation to allow the construction of a 2,450 sq. ft. two-story single-family residence with attached two-car, 480 sq. ft. garage on a legal 6,975 sq. ft. undeveloped parcel (PLN 2016-00222), associated with a staff-level Resource Management (RM) Permit, Coastal Development Permit (CDP) and a Variance to allow for 10-foot front and side setbacks, and a 12-foot rear setback, where a 50-foot front yard setback and 20-foot rear and side yard setbacks are required, due to the triangular shape of the parcel. The project includes minor grading and the proposed removal of 10 significant trees and is not appealable to the California Coastal Commission.

The CDRC was unable to make the findings for a design review approval based on certain design deficiencies. In order to resolve these deficiencies in the project's design, a more thorough review of the Local Coastal Program and "Standards for Design for One-Family and Two-Family Residential Development in the Midcoast" manual is required. As such, the CDRC recommended consideration of the following items:

- 1. Section 6565.20(D) ELEMENTS OF DESIGN; 1. Building Mass, Shape & Scale; c. Second Stories; Standards (a): Locate the primary portion of the second stories toward the center of the first story and away from the property lines wherever feasible (i.e., the master bedroom above the garage).
- 2. Section 6565.20(D) ELEMENTS OF DESIGN; 1. Building Mass, Shape & Scale; c. Second Stories; (2) Lowering the Eave Line; Standard: Consider bringing some portions of the roof down to the gutter or eave line of the first story roof to reduce the apparent mass of the building. It would be suggested to add dormers to break up the roof line.
- 3. Section 6565.20(D) ELEMENTS OF DESIGN; 1. Building Mass, Shape & Scale; d. Daylight Plane/Facade Articulation; Standards: New Residential development shall conform to either daylight plane or facade articulation options...: (1) Daylight Plane Option ... as approved by the Design Review Committee (follow description in Section 6565.20(D)1(d);Standards (1))



- (2): Facade Articulation Option Facade articulation shall be provided on all building sides and is subject to approval by the Design Review Committee. Facade articulation is intended to break up the appearance of shear walls through the placement of projecting and recessing architectural details.
- 4. Section 6565.20(D) ELEMENTS OF DESIGN; 4. Exterior Materials and Colors; Standard c. Quantity: Use a number of exterior materials and colors that is consistent with the neighborhood and architectural style of the house. Encourage the use of three or more colors, colors on larger homes to reduce the appearance of bulk by emphasizing architectural features and trim. Discourage the use of a single exterior material or color in a large unbroken surface.
- 5. Section 6565.20(E) ADDITIONAL SITE PLANNING AND DESIGN CONSIDERATIONS; Standards (1)(c): Vary in design style ... rooflines, finish materials ... to avoid overly repetitive appearance.
- 6. Section 6565.20(F) LANDSCAPING, PAVED AREAS, GENCES, LIGHTING AND NOISE; 1. Landscaping; Standards (f): All landscaping shall be drought-tolerant, and either native or non-invasive species.
- 7. Building height should be accurately indicated, measured from average finished grade to average roofline, to be less than 28 feet. This must be demonstrated on the elevations and on a cross section through the highest point of the structure.
- 8. Materials (including lighting) and colors must be shown on a rendered drawing and elevations.
- 9. Note the North orientation on all drawings.
- 10. Update Code dates on Sheet C1 to show 2019 vs 2016.
- 11. Show Front Porch Sconce on Architectural Elevation Sheet E1, as indicated on Electrical Sheet EL1.
- 12. Show Garage Door Lite on Electrical Sheet E1, as indicated on Architectural Elevation Sheet E1.
- 13. All lighting must be Dark Sky Compliant.
- 14. All drawings are required to be to scale.

As such, you were presented with the following available options at the end of the CDRC's deliberation of the project: (1) request for a recommendation from the CDRC on the plans presented or (2) request that the project be considered at the next meeting to provide you with ample time to consider and incorporate the elements recommended for project redesign. You chose the second option, and the CDRC directed staff to schedule your project for consideration at a later date.

Please contact Kelsey Lang, Project Planner, at klang@smcgov.org, if you have any questions.

To provide feedback, please visit the Department's Customer Survey at the following link: http://planning.smcgov.org/survey.

Sincerely,

Ruemel Panglao, Design Review Officer

RSP:KGL:mda – KGLFF0733_WMN.DOCX

TO: Kelsey Lang, Planner

FROM: Carolyn J. Lee, Esq., on behalf of Timothy Patterson, Owner

DATE: September 3, 2021

RE: Responses to Coastside Design Review Committee ("CDRC") Continuance

Letter dated July 26, 2021 Cedar Avenue, Montara

APN 036-132-201; County File No. PLN 2019-00362

Below please find responses to the CDRC's letter dated July 26, 2021, along with an enclosed set of revised plans, elevations, and color renderings.

Response to Comment #1-3:

Dormers were added to break up the roofline and sheer wall where possible. The architect has stated that the roof cannot be lowered without making the proportions of the house unattractive. The façade specifically addresses views of Oceans, Hills and vistas. There are no views compromised by this building. The proposed façade is quite similar to several existing neighborhood homes (see SE 1 Neighborhood Homes) and is similar to the example provided in the Standards for Design for One-Family and Two-Family Residential Development in the Midcoast.

FIGURE 1: Example provided in the Standards for Design for One-Family and Two-Family Residential Development in the Midcoast

Do This



This second story addition centered over the lower floor away from property lines appears less boxy.

Not This



This second story appears more boxy.

Not This



This second story located only over the garage appears out of balance.

FIGURE 2: Proposed Project



Response to Comment # 4:

Done. See SE 1 Color Rendering and SE 1 attachments for elevations and material samples.

Response to Comment # 5:

Done. Roofline has additional breakups added.

Response to Comment # 6:

Done. There is no San Mateo Midcoast recommended plant list. All plants are drought resistant and noninvasive. On the Landscape Plan, a link has been added regarding invasive species. The proposed plants have been taken from the San Francisco Coastal area list which has a similar environment to the site.

Response to Comment # 7:

Done. Elevations have been checked again by the architect. All elevations are below 28 feet.

Response to Comment # 8:

Done. See SE 1 Color Rendering and SE 1 attachments for elevations and material samples.

Response to Comment # 9:

Done. North orientation has been added to all drawings.

Response to Comment # 10:

Done. Code dates on architectural plans have been updated from 2016 to 2019.

Response to Comment # 11:

Done. Front Porch Sconce has been added to all drawings.

Response to Comment # 12:

Done. Garage Door Lite is on Electrical Sheet E1.


Response to Comment # 13:

Done. All lighting is Dark Sky Compliant.

Response to Comment # 14:

Done. All drawings are to scale.



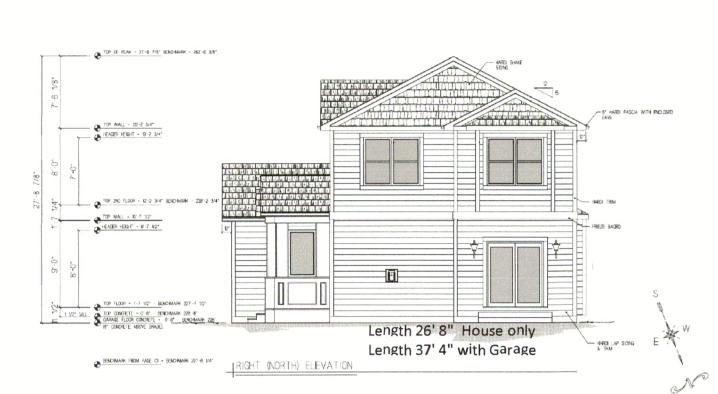


PROPERTY COVERAGE MEASUREMENTS BY PERCENTAGE:

TOTAL PROPERTY AREA: 6975 SQ. FEET

TOTAL LIVING AREA UNDER ROOF INCLUDING GARAGE AND PORCH 3010 SQ. FT
MAIN FLOOR: 1259 SQ. FT
SECOND FLOOR: 1191 SQ. FT
PORCH:88 SQ. FT
GARAGE: 471 SQ. FT
TOTAL: 1730 SQ. FT

FOOTPRINT PERCENTAGE OF PROPERTY COVERED BY ALL STRUCTURES: 26%

TOTAL PERCENTAGE OF PROPERTY TO ALL AREAS UNDER ROOF:
43%

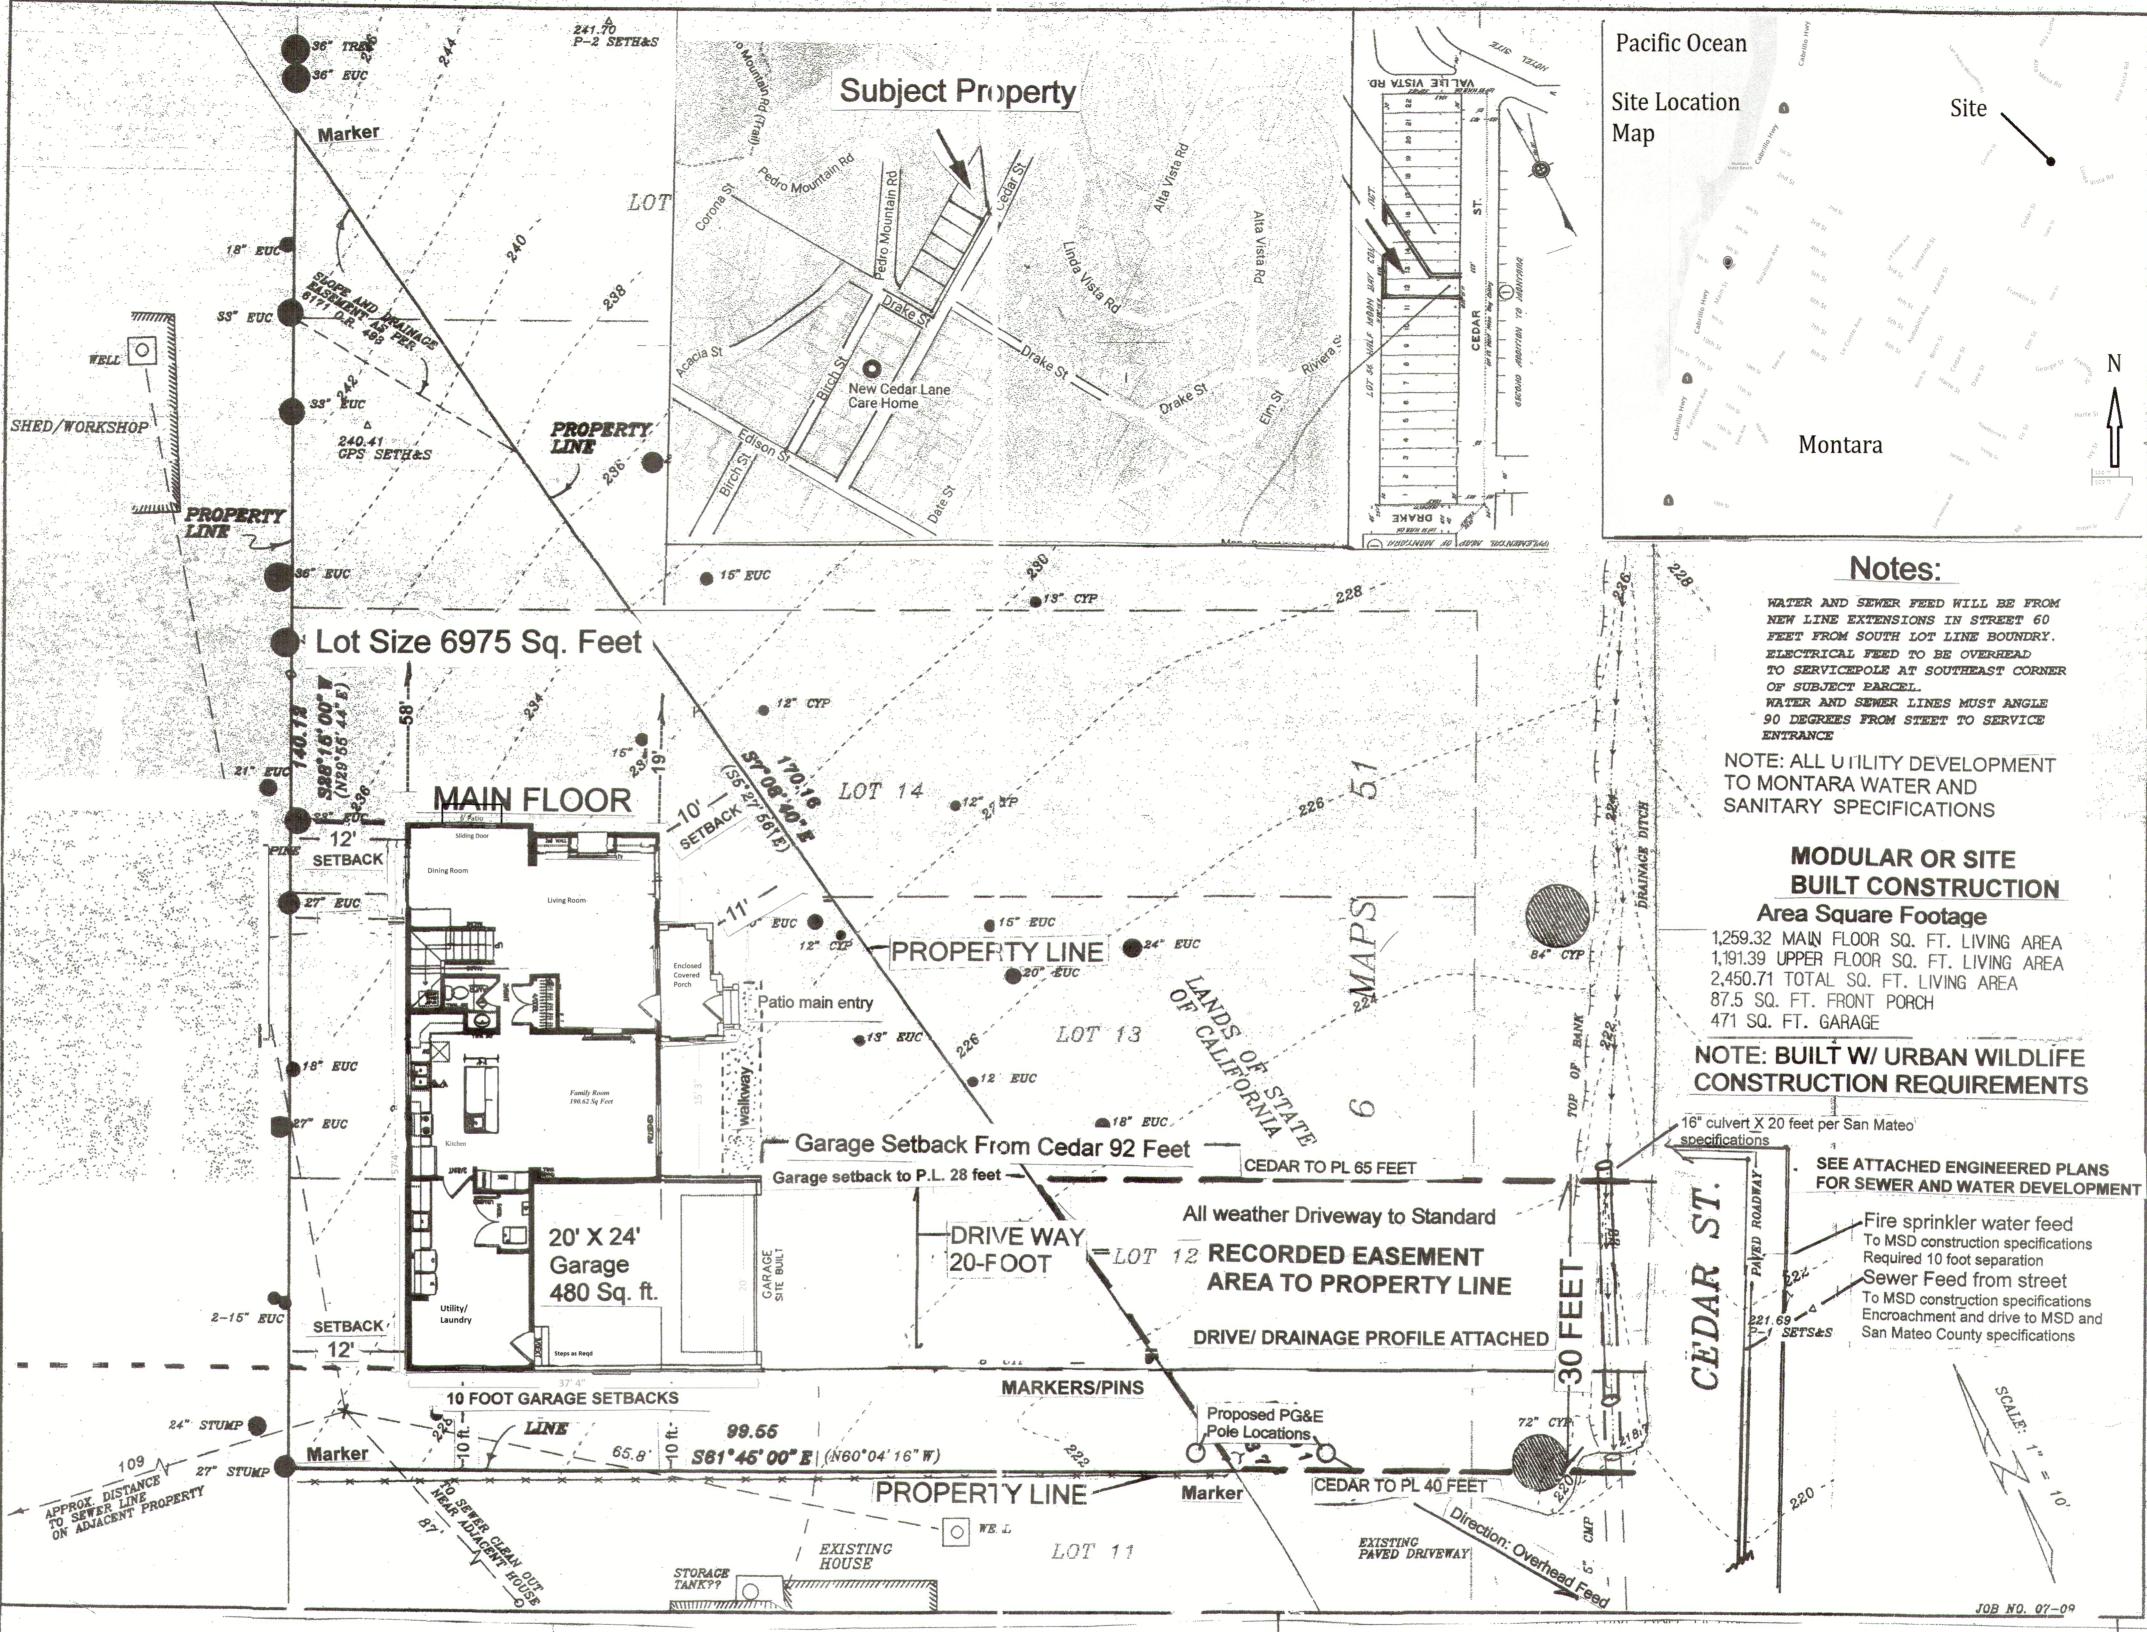

SITE PLAN

Scale 1"= 10 Feet

NEW CONSTRUCTION
SINGLE FAMILY RESIDENCE
TIM PATTERSON
CEDAR STREET
MONTARA, CA
036-132-210

PATTERSON SFD

Montara, California San Mateo County MANUFACTURER

SKYLIME

1720 E BEAMER STREET WOODLAND, CA. 95776 1-530-666-0974

SUBMITTAL CONSULTANT:
GAEA DESIGN
POWER HOUSE DESIGN GROUP
6608 DEVON DRIVE
LIBERTY TOWNSHIP, OH 45044
(513) 444.0519



AGENT/CONTACT
PETER EARNSHAW
AMERICAN DREAM HOMES
3120 SANTA ROSA AVE.
SANTA ROSA, CA 95407

DRAWN BY: LCL

DATE: 7.16.15

SCALE: NONE

REVISIONS:

NO: DATE: DESCRIPTION:

1.

APPROVAL STAMPS:

WNER/APPLICANT
M PATTERSON
50 CARTER DR. #32
OUTH SAN FRANCISCO,

SECTION VIEW

DRAWING NUMBER

SE1

SUBMITTAL INFORMATION

GENERAL NOTES

STATE: CALIFORNIA

CODES: 2019 CALIFORNIA RESIDENTIAL BLDG. CODE

2019 CALIFORNIA MECHANICAL CODE 2019 CALIFORNIA PLUMBING CODE 2019 CALIFORNIA ELECTRIC CODE

2019 CALIFORNIA ENERGY CODE (TITLE 24) 2019 CALIFORNIA GREEN BUILDING STDS. CODE

DESIGN CRITERIA

BUILDING TYPE: R-3

OCCUPANCY CATAGORY: II

SEISMIC DESIGN CATAGORY: E

CONSTRUCTION TYPE: 5B SPRINKLER PROTECTED

GRAVITY LOAD PARAMETERS

	LIVE	DEAD	SNOW	TOTAL
ROOF LOAD:	20 PSF	15 PSF		35 PSF
FLOOR LOAD:	40 PSF	15 PSF		55 PSF
WALL (INT):		10 PSF		10 PSF
WALL (EXT):		15 PSF		15 PSF

WIND DESIGN SPEED: 110 MPH (EXPOSURE C)

ROOF PITCH: 6/12

NOTE: BUILDING IS FIRE SPRINKLERED AND THE INSPECTIONS BY THE AHJ OF THE SPRINKLER SYSTEM INCLUDING A ROUGH INSPECTION AT FRAME INSPECTION AND A FINAL INSPECTION SHALL BE COMPLETED AND APPROVED PRIOR TO REQUESTING THE CORRESPONDING BUILDING INSPECTION.

SUBMITTAL DWG. INDEX

C1 - COVER PAGE E1 - ELEVATIONS E2 - ELEVATIONS

A1 - MAIN FLOOR FLOORPLAN
A2 - UPPER FLOOR FLOORPLAN
EL1 - MAIN FLOOR ELECTRIC LAYOUT
EL2 - UPPER FLOOR ELECTRIC LAYOUT

P1 - DWV/PLUMB SUPPLY SCHEMATICS

SE1 - SECTIONS AND DETAILS

SUBMITTAL SPRINKLER INDEX

SUPPLIED BY PLANT

SUBMITTAL HVAC INDEX

SUPPLIED BY PLANT

SUBMITTAL TITLE 24 INDEX

SUPPLIED BY PLANT



CALIFORNIA (WILDLAND-URBAN INTERFACE)

HOME WILL BE PLACED IN FIRE HAZARD SEVERITY ZONE SEE CBC NOTES FROM CHAPTER 7A ON PAGE SE1

THIS HOME AND ALL ITS ENTIRETY SHALL BE BUILT TO THE HCD REQUIREMENTS OF THE FACTORY-BUILT HOUSING PROGRAM IN THE FACTORY AND ON-SITE

STATE AND THIRD PARTY LABELS ON PAGE A1 & A2

SUBMITTAL STRUCTURAL INDEX

- ANY DEVIATIONS BY THE THIRD PARTY INSPECTOR TO THE SUBMITTED PLAN SET SHALL INCLUDE THE CORRESPONDING CODE REFERENCE IN THE WRITTEN DEVIATION.
- HCD GIVES AUTHORITY TO THE APPROVED THIRD PARTY INSPECTOR AND THE STATE OF CALIFORNIA INSPECTOR TO HAVE JURISDICTION OVER PLAN APPROVAL AND PLAN INSPECTORS. STATE STAMPED PLANS ARE FINAL AND CANNOT BE SUBJECT TO CHANGE BY LOCAL OR OTHER AGENCIES.
- PURSUANT TO SECTION 19981 (c) OF THE HEALTH & SAFETY CODE, NO FACTORY-BUILT HOUSING SHALL BE IN ANY WAY MODIFIED DURING INSTALLATION UNLESS APPROVED.

MANUFACTURER:

SUBMITTAL CONSULTANT:
GH DESIGN
POWER HOUSE DESIGN GROUP
6608 DEVON DRIVE
LIBERTY TOWNSHIP, OH 45044
(513) 444.0519



PROJECT NAME:
NEW MODULAR CONSTRUCTION
TIM PATTERSON
CEDAR STREET
MONTARA, CA

DRAWN BY: LCL

DATE: 4.27.17

SCALE: 1/4" = 1'-0"

REVISIONS:

NO: DATE: DESCRIPTION:

1. 7.31.17 REDLINES

2. 7.27.21 CODE UPDATE


APPROVAL STAMPS:

SHEET TITLE

COVER PAGE

DRAWING NUMBER

C1

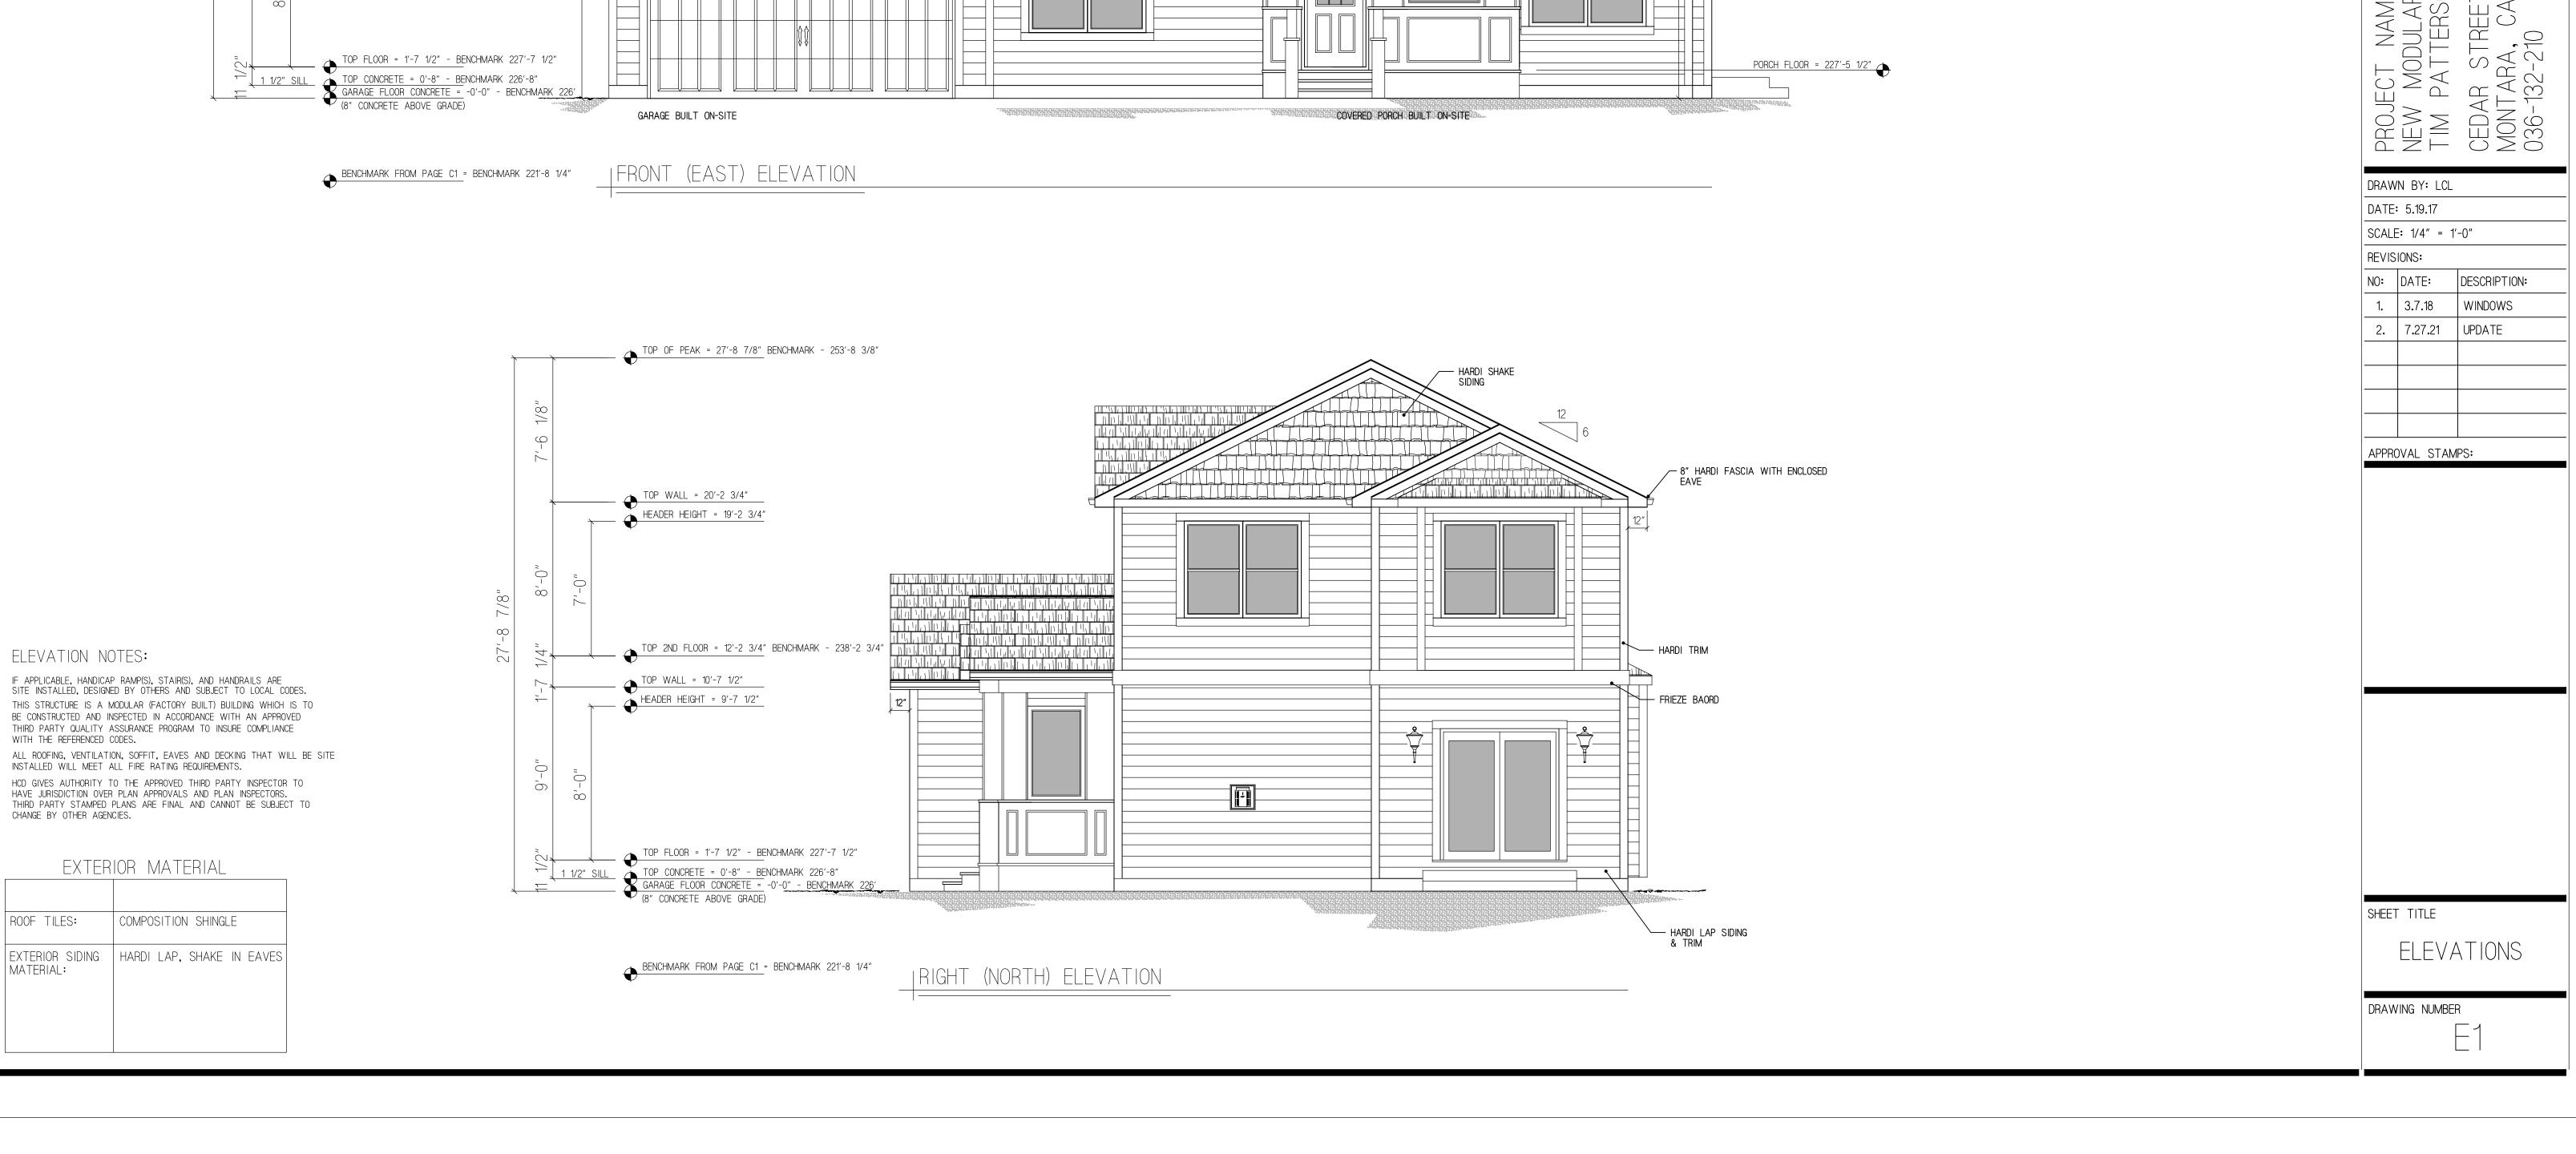

TOP OF PEAK = 27'-8 7/8" BENCHMARK - 253'-8 3/8" TOP WALL = 20'-2 3/4"

HEADER HEIGHT = 19'-2 3/4" TOP 2ND FLOOR = 12'-2 3/4" BENCHMARK - 238'-2 3/4" TOP WALL = 10'-7 1/2"


HEADER HEIGHT = 9'-7 1/2"


SUBMITTAL CONSULTANT: GH DESIGN POWER HOUSE DESIGN GROUP 6608 DEVON DRIVE LIBERTY TOWNSHIP, OH 45044 (513) 444.0519


GAEAA CHIESTOTAL DESIGN

CONSTRUCTION

MANUFACTURER:

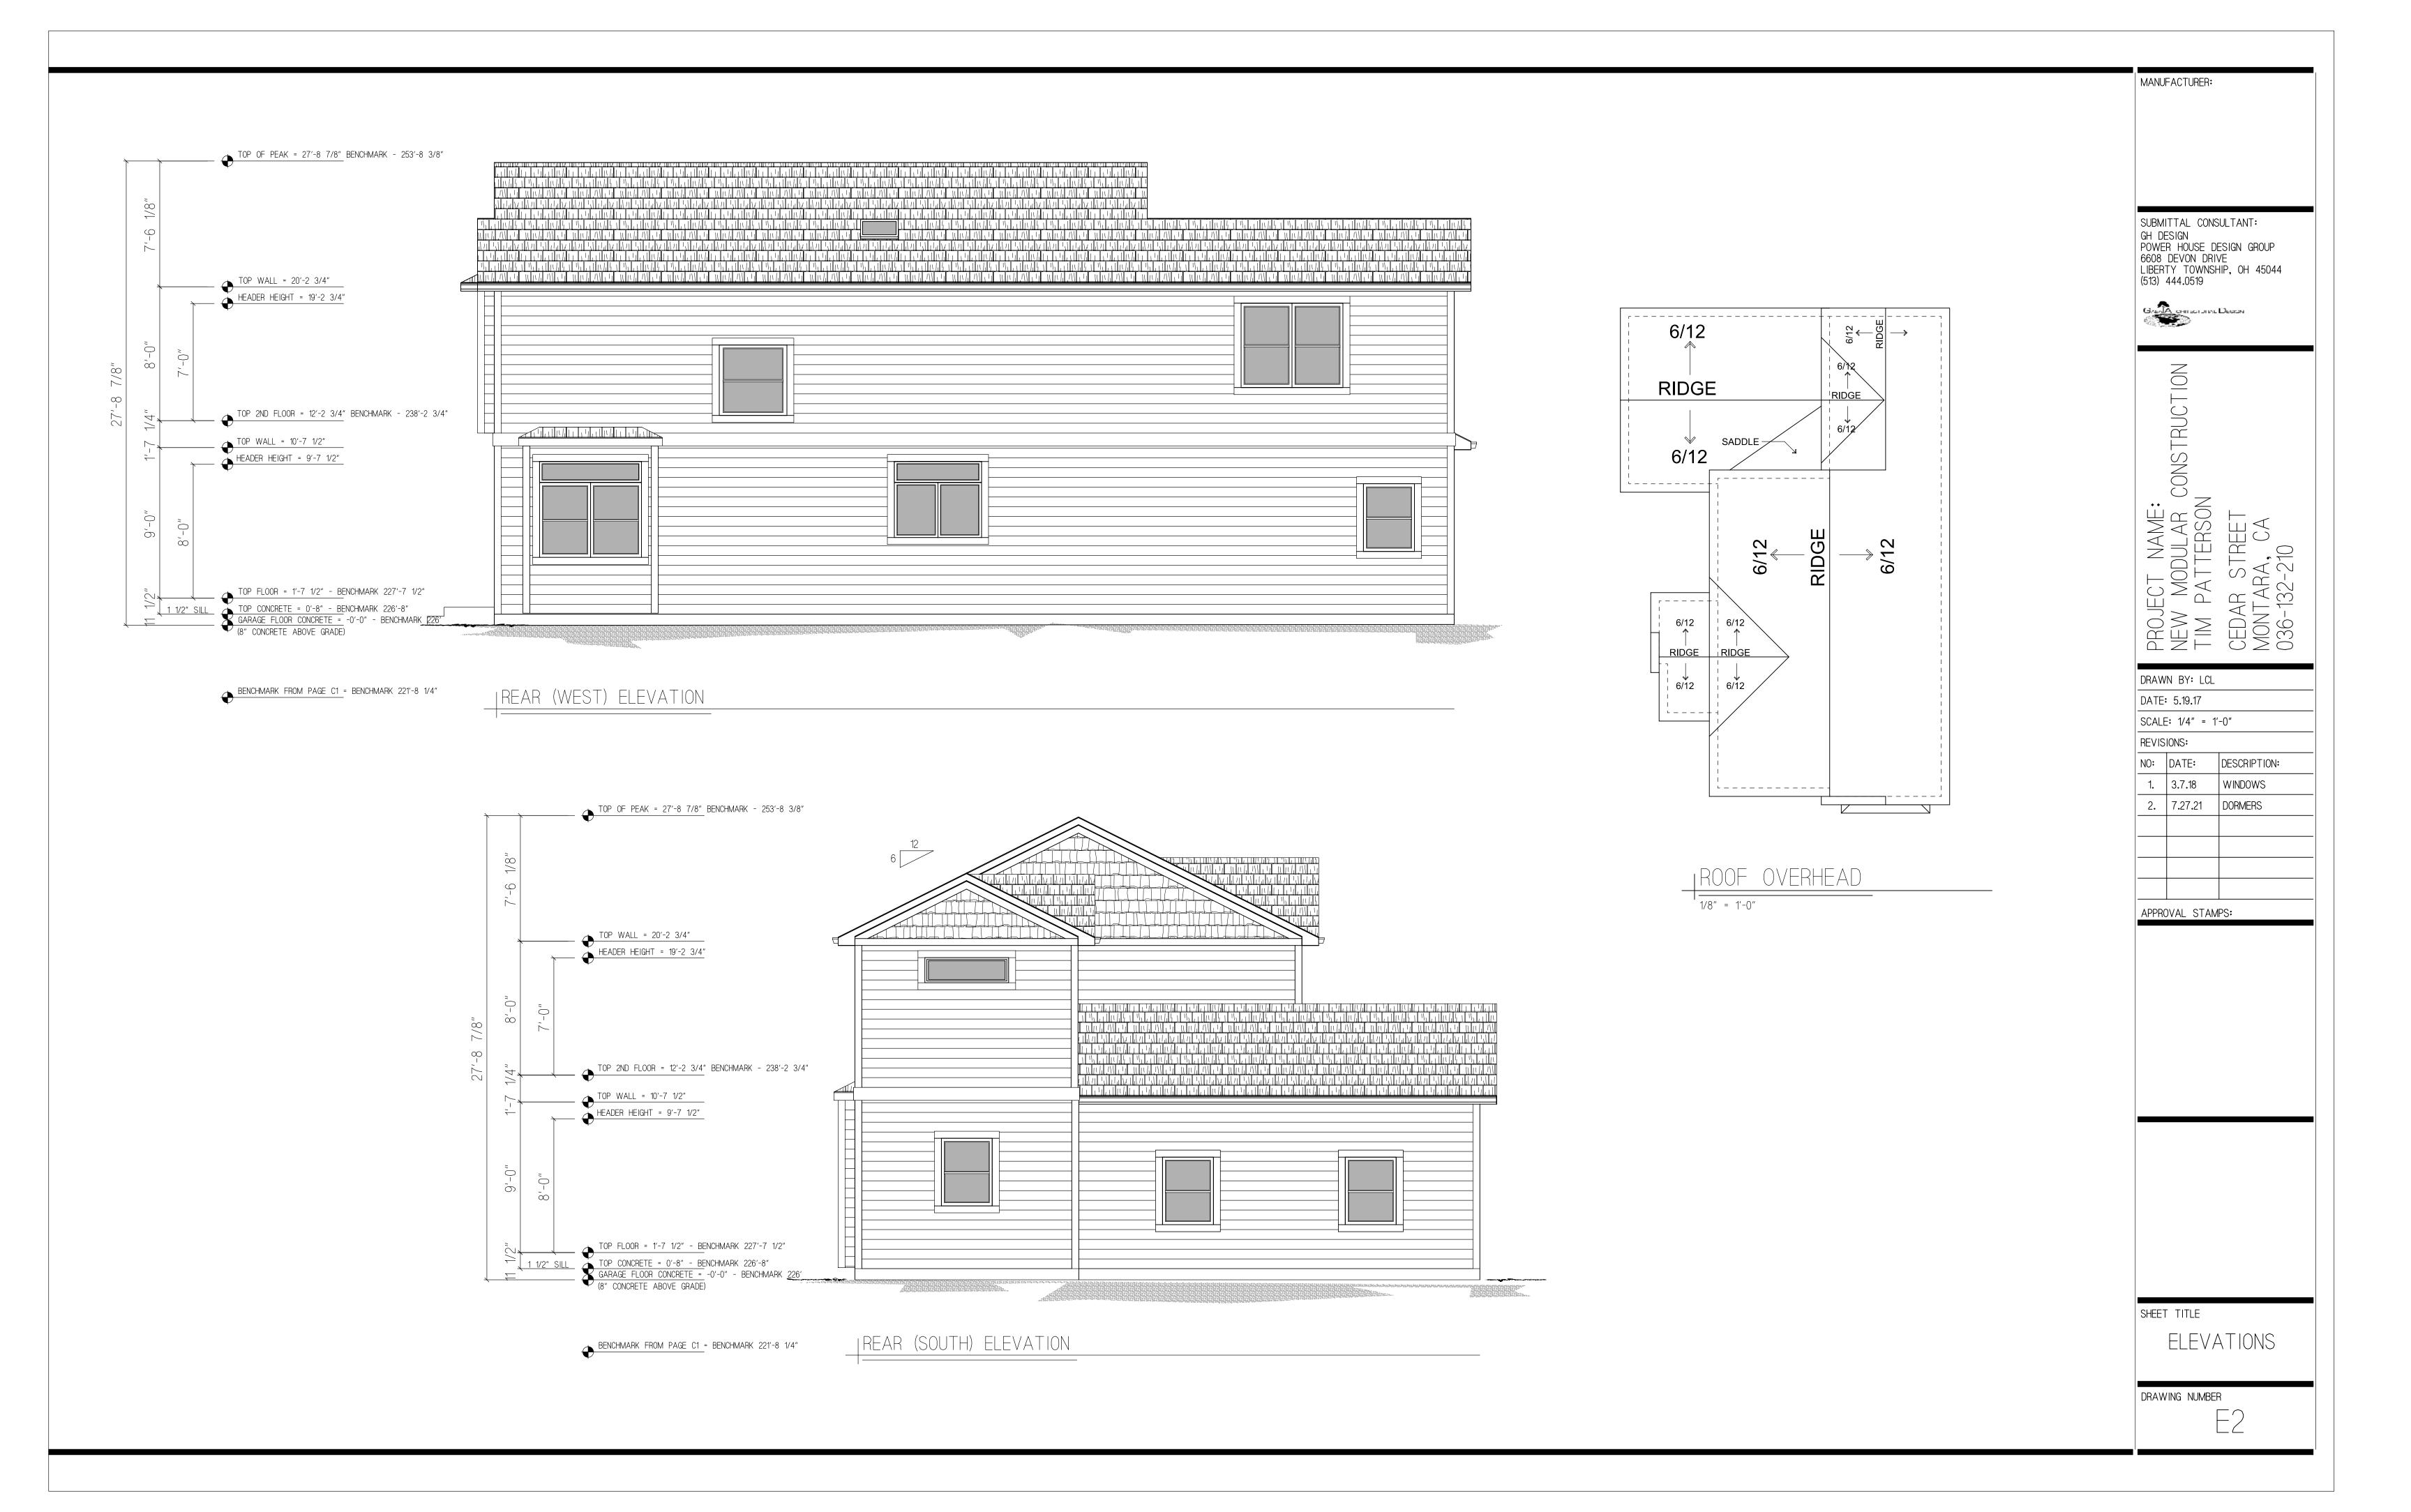

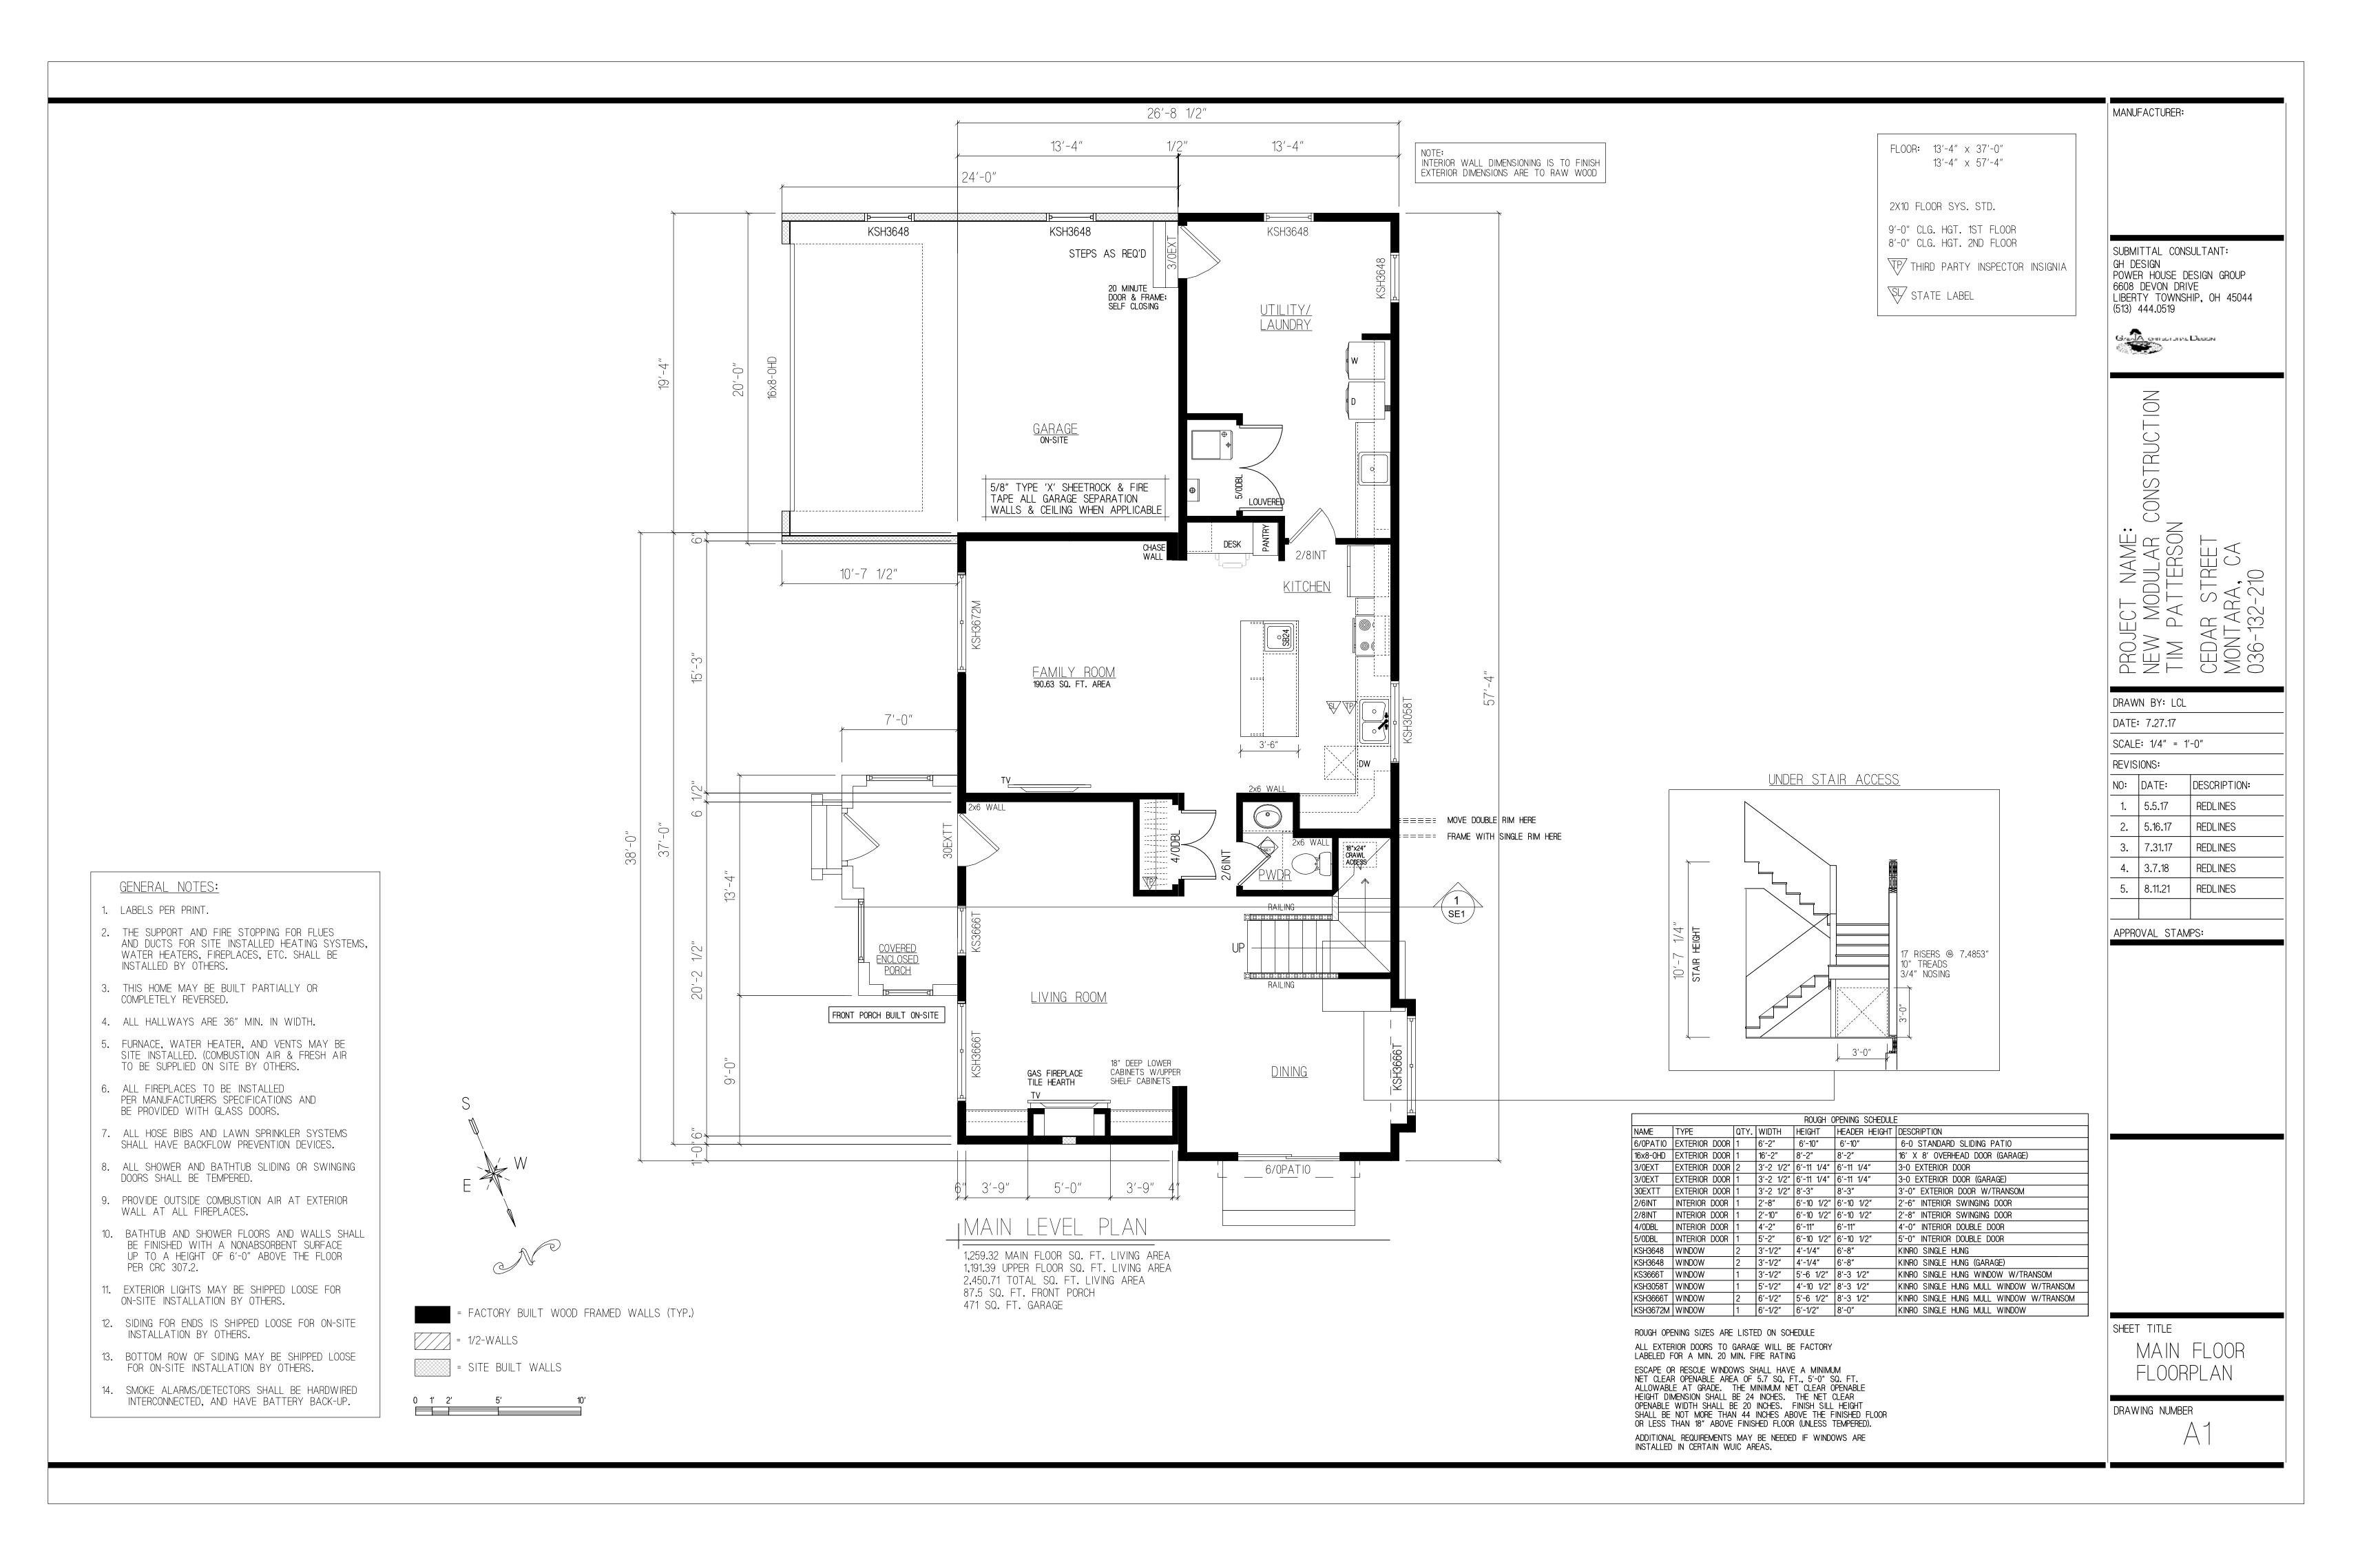

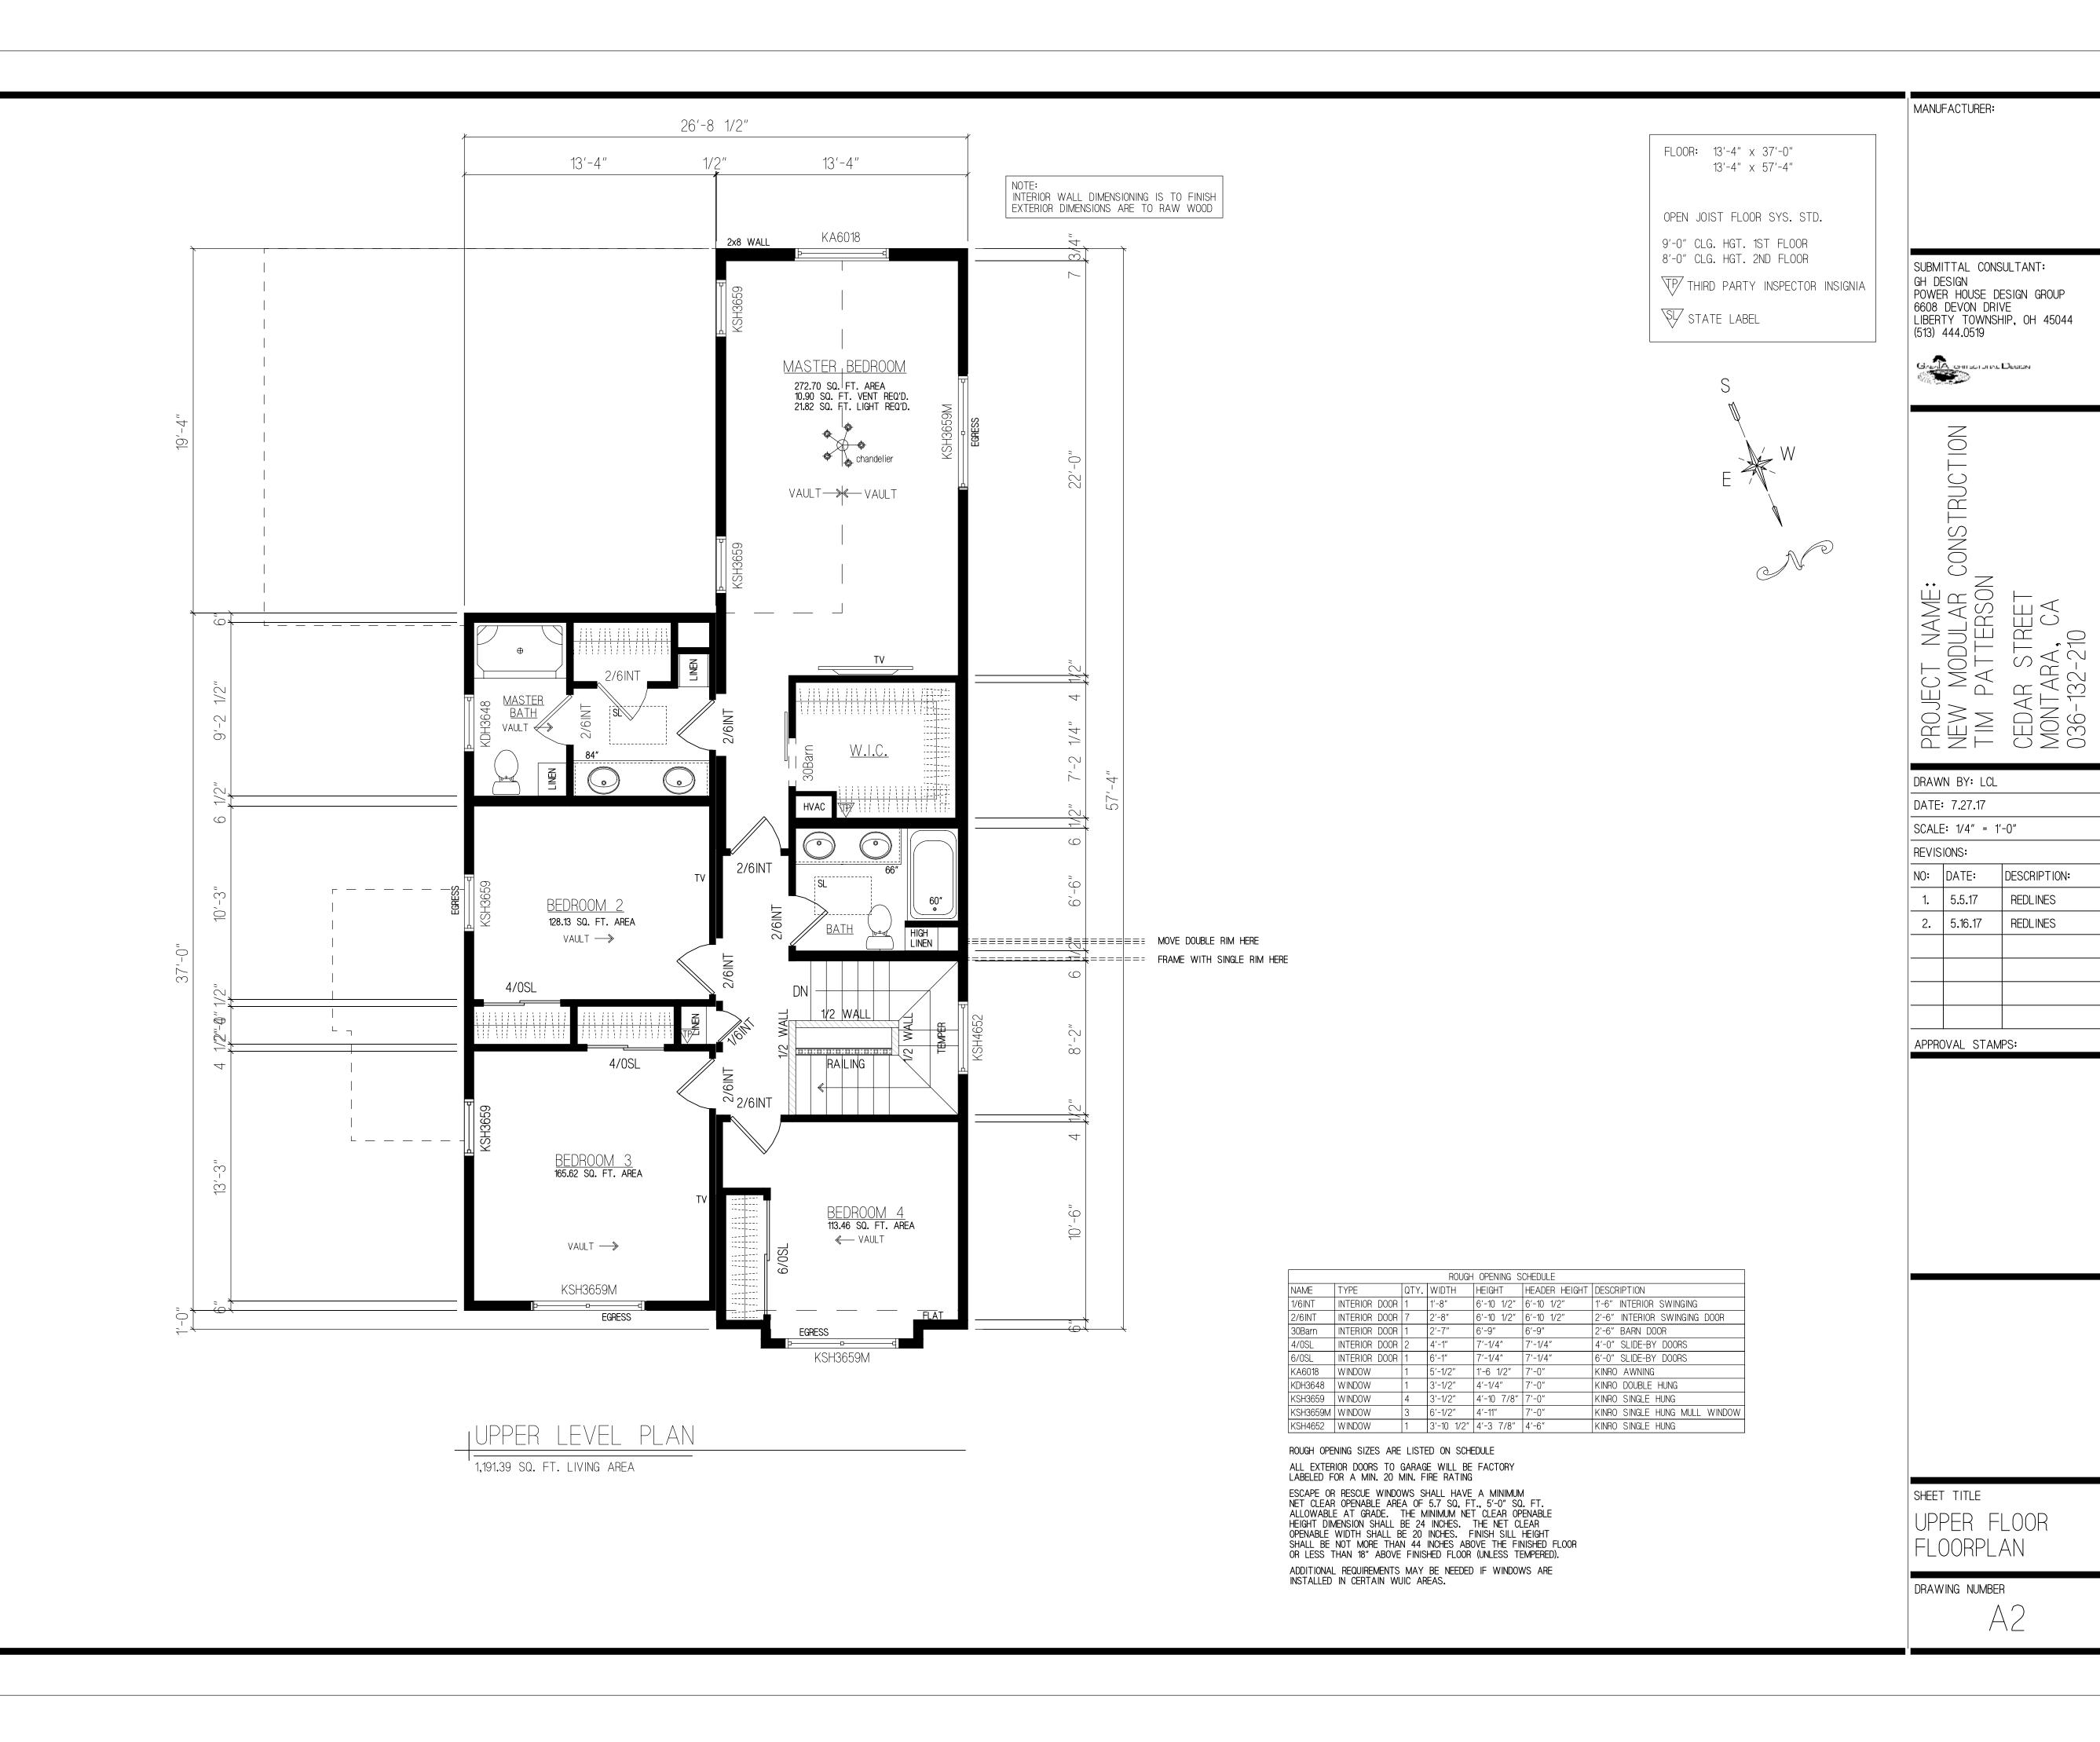

GENERAL NOTES:

INSTALLED BY OTHERS.

COMPLETELY REVERSED.

2. THE SUPPORT AND FIRE STOPPING FOR FLUES

3. THIS HOME MAY BE BUILT PARTIALLY OR

4. ALL HALLWAYS ARE 36" MIN. IN WIDTH.

TO BE SUPPLIED ON SITE BY OTHERS.

6. ALL FIREPLACES TO BE INSTALLED

BE PROVIDED WITH GLASS DOORS.

DOORS SHALL BE TEMPERED.

WALL AT ALL FIREPLACES.

PER CRC 307.2.

5. FURNACE, WATER HEATER, AND VENTS MAY BE SITE INSTALLED. (COMBUSTION AIR & FRESH AIR

PER MANUFACTURERS SPECIFICATIONS AND

7. ALL HOSE BIBS AND LAWN SPRINKLER SYSTEMS

SHALL HAVE BACKFLOW PREVENTION DEVICES.

8. ALL SHOWER AND BATHTUB SLIDING OR SWINGING

9. PROVIDE OUTSIDE COMBUSTION AIR AT EXTERIOR

10. BATHTUB AND SHOWER FLOORS AND WALLS SHALL

BE FINISHED WITH A NONABSORBENT SURFACE

UP TO A HEIGHT OF 6'-0" ABOVE THE FLOOR

11. EXTERIOR LIGHTS MAY BE SHIPPED LOOSE FOR

12. SIDING FOR ENDS IS SHIPPED LOOSE FOR ON-SITE

13. BOTTOM ROW OF SIDING MAY BE SHIPPED LOOSE

14. SMOKE ALARMS/DETECTORS SHALL BE HARDWIRED

INTERCONNECTED, AND HAVE BATTERY BACK-UP.


FOR ON-SITE INSTALLATION BY OTHERS.


ON-SITE INSTALLATION BY OTHERS.

INSTALLATION BY OTHERS.

AND DUCTS FOR SITE INSTALLED HEATING SYSTEMS, WATER HEATERS, FIREPLACES, ETC. SHALL BE

1. LABELS PER PRINT.

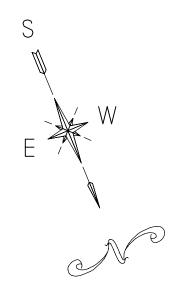

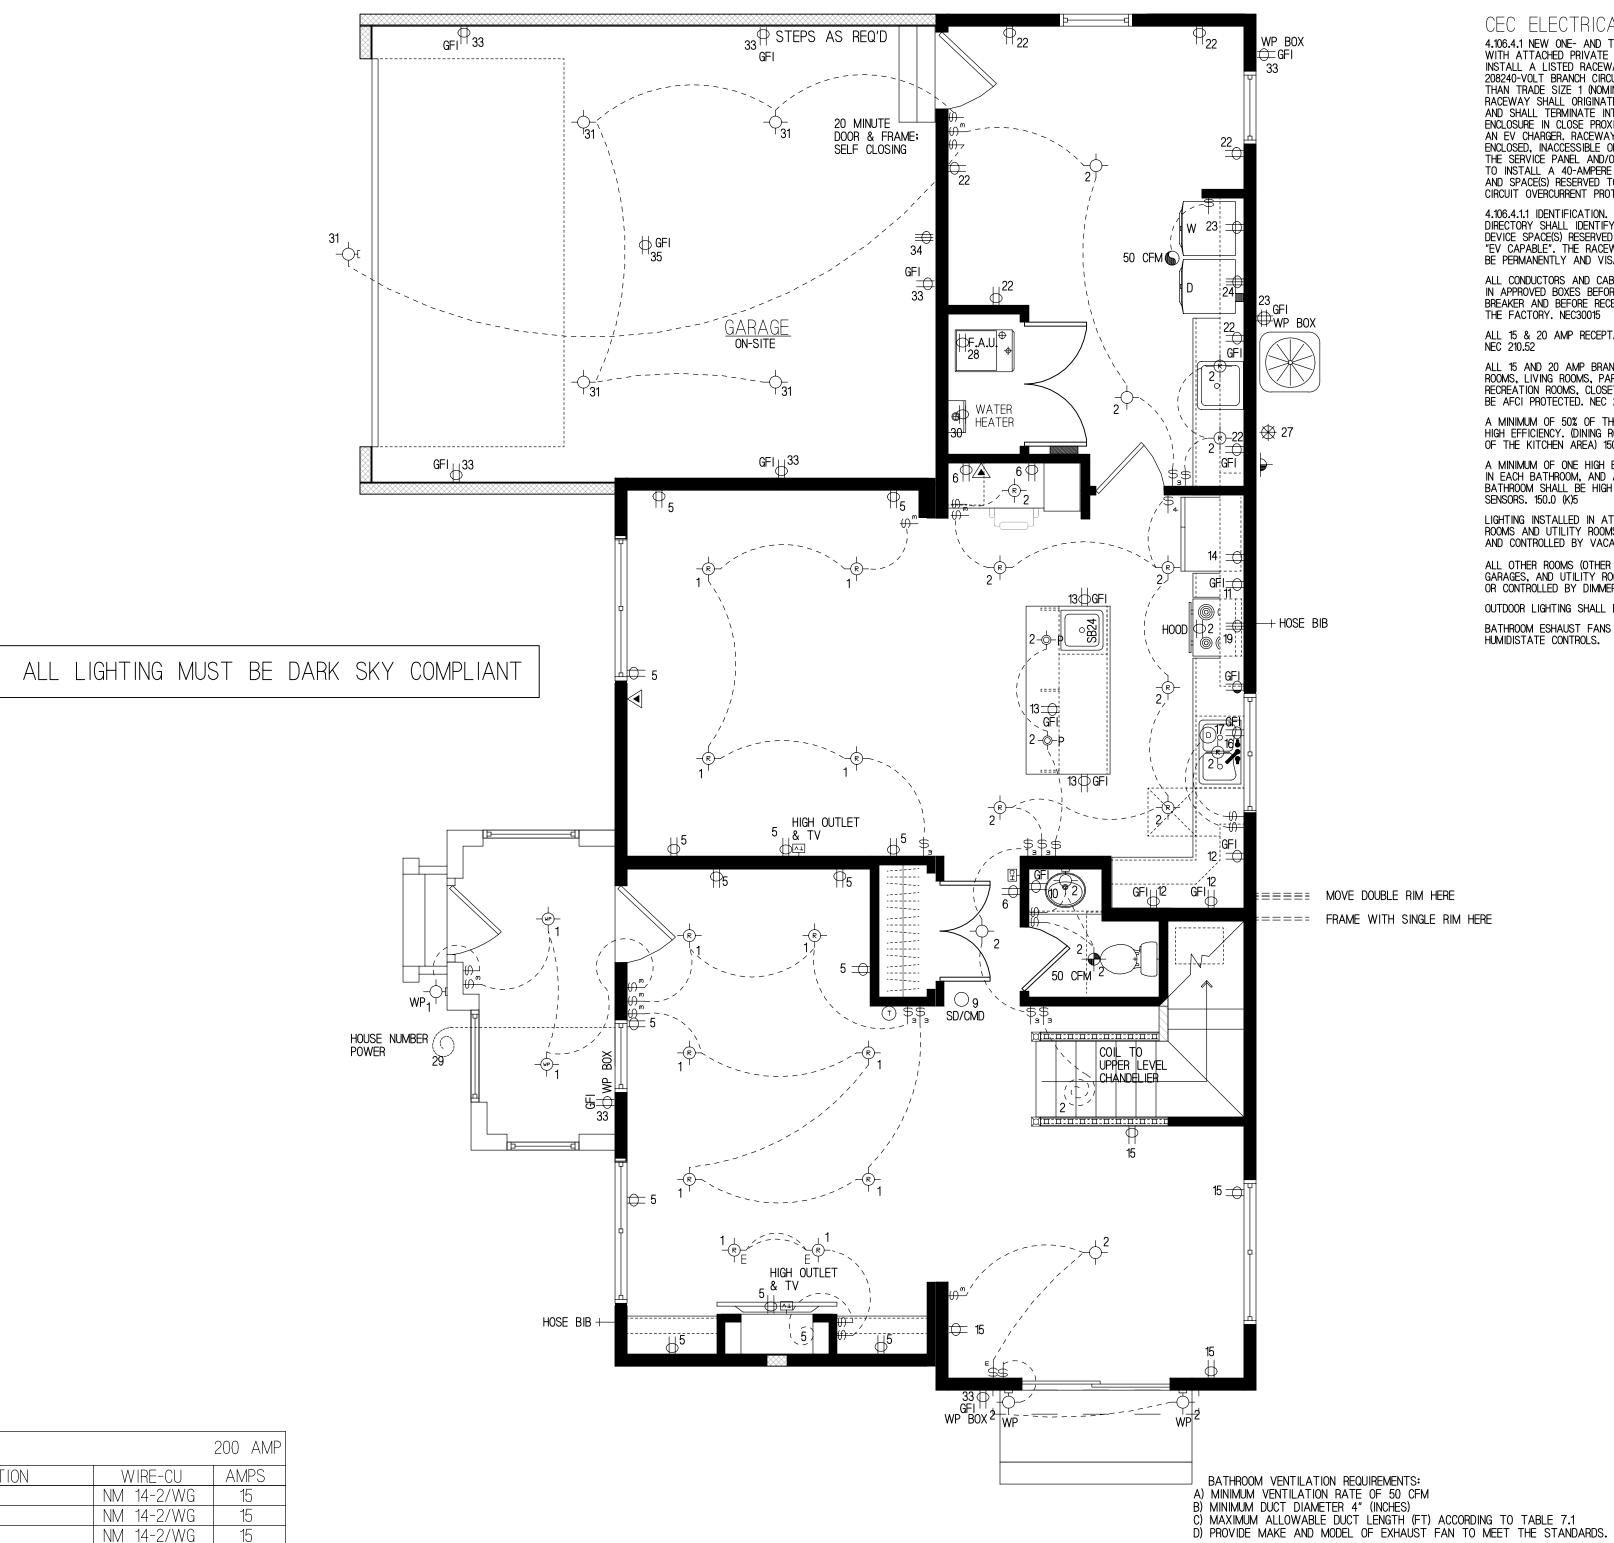

		ELECTRI	C CIR	CUIT	SCHEDULE		200 AMP
AMPS	WIRE-CU	DESCRIPTION	CIR	CUIT	DESCRIPTION	WIRE-CU	AMPS
15	NM 14-2/WG	MAIN LIGHTING	1	2	MAIN LIGHTING	NM 14-2/WG	15
15	NM 14-2/WG	UPPER LIGHTING	3	4	UPPER LIGHTING	NM 14-2/WG	15
15	NM 14-2/WG	MAIN RECPTS.	5	6	MAIN RECPTS.	NM 14-2/WG	15
15	NM 14-2/WG	UPPER RECPTS.	7	8	UPPER RECPTS.	NM 14-2/WG	15
15	NM 14-2/WG	SMOKE DETECTORS/CMD	9	10	BATH GFI'S	NM 12-2/WG	20
20	NM 12-2/WG	KITCHEN APPLIANCE	11	12	KITCHEN APPLIANCE	NM 12-2/WG	20
20	NM 12-2/WG	KITCHEN APPLIANCE	13	14	REFRIGERATOR	NM 12-2/WG	20
20	NM 12-2/WG	DINING ROOM	15	16	DISHWASHER	NM 12-2/WG	20
20	NM 12-2/WG	DISPOSAL	17	18	EXTRA		
40	NM 8-3/WG	ELECTRIC RANGE	19	20	EXTRA		
11 11	и и	и и	21	22	LAUNDRY ROOM	NM 12-2/WG	20
40	NM 8-2/WG	AC DISCONNECT	23	24	ELECTRIC DRYER	NM 10-3/WG	30
11 11	н н	п п	25	26	и и	н н	11 11
15	NM 14-2/WG	SPRINKLER POWER	27	28	GAS FAU	NM 12-2/WG	20
20	NM 12-2/WG	OPT. EXT. POWER	29	30	GAS WATER HEATER	NM 12-2/WG	20
15	NM 14-2/WG	GARAGE LIGHTING	31	32	CRAWLSPACE	NM 14-2/WG	15
20	NM 12-2/WG	GARAGE RECPTS.	33	34	ELECTRIC CAR CHARGER	NM 8-3/WG	40
15	NM 14-2/WG	GARAGE DOOR OPENER	35	36	и и	н н	11 11
			37	38			
			39	40			

NOTE: ALL GAS LINES TO BE DESIGNED, APPROVED, AND INSTALLED ON-SITE BY OTHERS TO ALL LOCAL AND ADOPTED CODES.

CEC ELECTRICAL NOTES:

4.106.4.1 NEW ONE- AND TWO-FAMILY DWELLINGS AND TOWNHOUSES WITH ATTACHED PRIVATE GARAGES. FOR EACH DWELLING UNIT, INSTALL A LISTED RACEWAY TO ACCOMODATE A DEDICATED 208240-VOLT BRANCH CIRCUIT. THE RACEWAY SHALL NOT BE LESS THAN TRADE SIZE 1 (NOMINAL 1-INCH INSIDE DIAMETER). THE RACEWAY SHALL ORIGINATE AT THE MAIN SERVICE OR SUBPANEL AND SHALL TERMINATE INTO A LISTED CABINET, BOX OR OTHER ENCLOSURE IN CLOSE PROXIMITY TO THE PROPOSED LOCATION OF AN EV CHARGER. RACEWAYS ARE REQUIRED TO BE CONTINUOUS AT ENCLOSED, INACCESSIBLE OR CONCEALED AREAS AND SPACES. THE SERVICE PANEL AND/OR SUBPANEL SHALL PROVIDE CAPACITY TO INSTALL A 40-AMPERE MINIMUM DEDICATED BRANCH CIRCUIT AND SPACE(S) RESERVED TO PERMIT INSTALLATION OF A BRANCH CIRCUIT OVERCURRENT PROTECTIVE DEVICE.

4.106.4.1.1 IDENTIFICATION. THE SERVICE PANEL OR SUBPANEL CIRCUIT DIRECTORY SHALL IDENTIFY THE OVERCURRENT PROTECTIVE DEVICE SPACE(S) RESERVED FOR FUTURE EV CHARGING AS "EV CAPABLE". THE RACEWAY TERMINATION LOCATION SHALL BE PERMANENTLY AND VISABLY MARKED AS "EV CAPABLE".

ALL CONDUCTORS AND CABLES MUST BE PROPERLY TERMINATED IN APPROVED BOXES BEFORE CONNECTING THE CIRCUIT TO THE BREAKER AND BEFORE RECEIVING FINAL INSPECTION APPROVAL IN THE FACTORY. NEC30015

ALL 15 & 20 AMP RECEPTACLES TO BE TAMPER RESISTANT. NEC 210.52

ALL 15 AND 20 AMP BRANCH CIRCUITS IN FAMILY ROOMS, DINING ROOMS, LIVING ROOMS, PARLORS, LIBRARIES, DENS, BEDROOMS, SUNROOMS, RECREATION ROOMS, CLOSETS, HALLWAYS, OR SIMILAR ROOMS SHALL BE AFCI PROTECTED, NEC 210,12(B)

A MINIMUM OF 50% OF THE KITCHEN LIGHTING IS REQUIRED TO BE HIGH EFFICIENCY. (DINING ROOMS AND NOOKS ARE CONSIDERED PART OF THE KITCHEN AREA) 150.0 (K)3

A MINIMUM OF ONE HIGH EFFICIENCY LUMINAIRE SHALL BE INSTALLED IN EACH BATHROOM, AND ALL OTHER LIGHTING INSTALLED IN EACH BATHROOM SHALL BE HIGH EFFICIENCY OR CONTROLLED BY VACANCY SENSORS. 150.0 (K)5

LIGHTING INSTALLED IN ATTACHED AND DETACHED GARAGES, LAUNDRY ROOMS AND UTILITY ROOMS SHALL BE HIGH EFFICIENCY LUMINAIRES AND CONTROLLED BY VACANCY SENSORS. 150.0 (K)6 ALL OTHER ROOMS (OTHER THAN KITCHENS, BATHROOMS, GARAGES, AND UTILITY ROOMS) SHALL BE HIGH EFFICIENCY LIGHTING OR CONTROLLED BY DIMMERS OR VACANCY SENSORS. 150.0 (K)7

OUTDOOR LIGHTING SHALL BE HIGH EFFICIENCY. BATHROOM ESHAUST FANS SHALL BE ENERGY STAR COMPLIANT WITH HUMIDISTATE CONTROLS.

WHOLE BUILDING VENTILATION REQUIREMENTS:

A) THE EXHAUST FAN WILL BE RATED FOR SOUND AT A MAXIMUM OF 1 SONE.

B) OPERATIONAL SWITCH MUST BE LABELED TO INFORM THE OCCUPANT THAT THE FAN WILL RUN CONTINUALLY.

C) PROVIDE THE LOCATION OF THE WHOLE BUILDING VENTILATION EXHAUST FAN AND SWITCH.

	ELECTRICAL LEGEND
-9	SWITCH
~	3-WAY SWITCH
Q 4	4-WAY SWITCH
	CEILING LIGHT
-R-	RECESSED LIGHT
-R-E	REC. EYE LIGHT
10-	WALL LIGHT
	BATH FAN
-	BATH FAN/LIGHT
0	110V OUTLET
#	220V OUTLET
	110V SWITCHED OUTLET
TV	TELEVISION
	TELEPHONE
SD	SMOKE DETECTOR
	SMOKE DETECTOR/CARBON MONOXIDE DETECTOR
T	THERMOSTAT
D	GARBAGE DISPOSAL
×	CEILING FAN/LIGHT
	ELECTRIC PANEL
CM	CARBON MONOXIDE DETECTOR
CH	CHIMES
GFI	GROUNDED OUTLET
WP	WEATHER PROOF
	CAT 5 PORT/TV COMBO
+	AC DISCONNECT
- \$ -	PUCK LIGHT (UNDER KITCHEN CABINET)
	1

→

PENDULUM LIGHT JUNCTION BOX

ELECTRICAL LEGEND
WITCH
-WAY SWITCH
-WAY SWITCH
EILING LIGHT
ECESSED LIGHT
EC. EYE LIGHT
VALL LIGHT
ATH FAN
ATH FAN/LIGHT
10V OUTLET
20V OUTLET
10V SWITCHED OUTLET
ELEVISION
ELEPHONE
MOKE DETECTOR
MOKE DETECTOR/CARBON MONOXIDE DETECTOR COMBO
HERMOSTAT
ARBAGE DISPOSAL
EILING FAN/LIGHT
LECTRIC PANEL
ARBON MONOXIDE DETECTOR
HIMES
ROUNDED OUTLET
VEATHER PROOF
AT 5 PORT/TV COMBO
C DISCONNECT
UCK LIGHT (UNDER KITCHEN CABINET)

COMBO	SUBMITTAL CONSULTANT: GAEA DESIGN POWER HOUSE DESIGN GROUP 6608 DEVON DRIVE LIBERTY TOWNSHIP, OH 45044 (513) 444.0519
COMBO	T NAME: MODULAR CONSTRUCTION ATTERSON STREET RA, CA

45044


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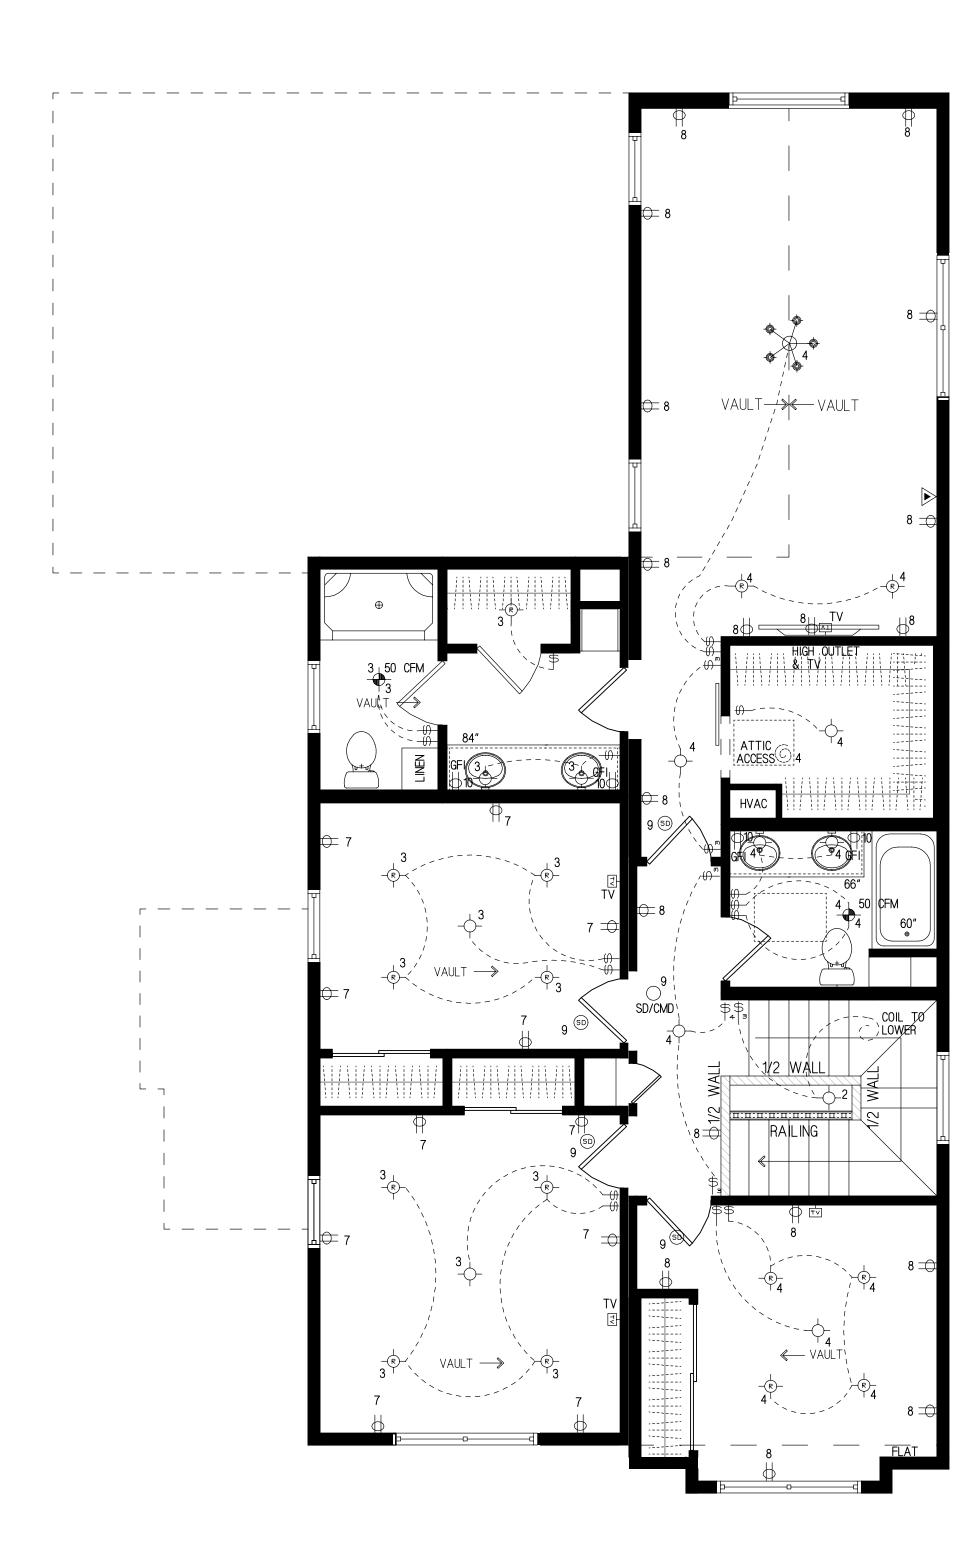
DRAWI	N BY: LCL	
DATE:	5,23,17	
SCALE	: NONE	
REVISI	IONS:	
NO:	DATE:	DESCRIPTION:
1.	3.7.18	REDLINES
2.	7.27.21	GARAGE LIGHT
APPRO	VAL STAM	PS:

2450 SQ. FT. @ 3 WATTS/SQ. FT.	7.3 K
3 - 20 AMP APPL. CIRCUITS	5.1 K\
LAUNDRY CIRCUIT	1.5 K\
ELECTRIC RANGE CIRCUIT	4.0 K\
ELECTRIC DRYER CIRCUIT	5.0 K\
STD. ELECTRIC WATER HEATER	5.5 K\
DISHWASHER	2.0 KV
DISPOSAL	.8 K\

TOTAL	31.2 KW
10 KW @ 100%	10.0
REMAINDER 40%	10.22
ASSUMED HVAC	20.00
TOTAL LOAD	38.70
38700 W/240 V.=161.25 AMPERES	
200 AMP SERVICE STANDARD	

SHEET TITLE
FIRST FLOOR
ELECTRIC PLAN
DRAWING NUMBER



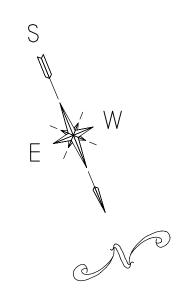

JUPPER LEVEL ELECTRIC PLAN

-ALL BRANCH CIRCUITS SUPPLYING 15 AND 20 AMP OUTLETS IN LIVING AREAS MUST BE AFCI PROTECTED -ALL SWITCHES IN LIVING AREAS TO HAVE DIMMER SWITCHES TYP PER TITLE 24.

	ELECTRICAL LEGEND
- ()	SWITCH
<u></u>	3-WAY SWITCH
()	4-WAY SWITCH
-	CEILING LIGHT
<u>R</u> -	RECESSED LIGHT
R-E	REC. EYE LIGHT
· 10	WALL LIGHT
	BATH FAN
-	BATH FAN/LIGHT
-	110V OUTLET
\rightleftharpoons	220V OUTLET
$\overline{\bullet}$	110V SWITCHED OUTLET
TV	TELEVISION
\bigcirc	TELEPHONE
SD	SMOKE DETECTOR
\bigcirc	SMOKE DETECTOR/CARBON MONOXIDE DETECTOR COMBO
T	THERMOSTAT
D	GARBAGE DISPOSAL
\times	CEILING FAN/LIGHT
	ELECTRIC PANEL
(CM)	CARBON MONOXIDE DETECTOR
ÇH.	CHIMES
⇒ GFI	GROUNDED OUTLET
WP	WEATHER PROOF
4	CAT 5 PORT/TV COMBO
#	AC DISCONNECT
ф -Ф-Р	PUCK LIGHT (UNDER KITCHEN CABINET)
-ф-Р	PENDULUM LIGHT
X	JUNCTION BOX

ELECTRICAL NOTES:

1. ALL CONDUCTORS WILL BE COPPER.

2. RECEPTACLE OUTLET SPACING CONFORMS TO 2016 CA. ELEC. CODE. 3. ALL RECEPTACLES PLACED IN CRAWL SPACE WILL BE GFCI. 4. SMOKE DETECTORS SHALL BE WIRED SO THAT ACTUATION OF ONE ALARM WILL ACTUATE ALL SMOKE DETECTOR ALARMS IN THE HOME. *IN MODELS WITH A BASEMENT, A JUNCTION BOX WILL BE INSTALLED UNDER THE FLOOR AND A SMOKE DETECTOR WILL BE SHIPPED

LOOSE FOR SITE INSTALLATION. 5. CEILING LIGHTS MAY BE REPLACED WITH CEILING FAN/LIGHT COMBINATIONS IF THEY ARE INSTALLED PER MANUFACTURERS INSTRUCTIONS AND CODE REQUIREMENTS.

6. LIGHTING FIXTURES INSTALLED IN CLOSETS WILL BE IN ACCORDANCE WITH THE 2013 CA. ELEC. CODE.

7. *LIGHTS AND ELECTRICAL CIRCUITS FOR BASEMENT, CRAWL SPACE, AND/OR GARAGE ARE TO BE PROVIDED ON SITE BY OTHERS. 8. SPACES ARE PROVIDED IN THE PANEL BOX FOR EXPANSION.

9. *ELECTRICAL INTERCONNECTION BETWEEN MODULES SHALL BE MADE IN THE BASEMENT OR CRAWL SPACE USING JUNCTION BOXES BY A QUALIFIED ELECTRICIAN ON SITE, JUNCTION BOXES AT THE MATE-LINES SHALL BE IDENTIFIED BY CIRCUIT.

10. ELECTRICAL BOXES SHALL BE LISTED FOR THE SPECIFIC PURPOSE. BOXES FOR FIXTURE ATTACHMENTS SHALL BE DESIGNED FOR THAT PURPOSE WITH PROPER FIXTURE ATTACHMENT MEANS, ALL FIXTURES SHALL BE ADEQUATELY SUPPORTED PER THE FIXTURE MANUFACTURERS INSTRUCTIONS AND THEIR LISTING REPORT.

11. THE METHOD OF MOUNTING FIXTURES AND WIRING INSTALLATION SHALL BE PER THE LISTING REPORT AND THE MANUFACTURERS INSTALLATION INSTRUCTIONS.

12. SMOKE DETECTORS SHALL BE INSTALLED OUTSIDE OF EACH SLEEPING AREA AND MUST BE INSTALLED IN EACH BEDROOM. AT LEAST ONE (1) SMOKE DETECTOR MUST BE INSTALLED ON EACH LEVEL, INCLUDING BASEMENTS. ALL SMOKE DETECTORS WITHIN A DWELLING UNIT SHALL BE AC/DC AND INTERCONNECTED TO PROVIDE SIMULTANEOUS

13. ALL BRANCH CIRCUITS THAT SUPPLY 125-V SINGLE PHASE, 15 & 20 AMP OUTLETS INSTALLED IN DWELLING LIVING AREAS SHALL BE PROTECTED BY AN ARC-FAULT CIRCUIT INTERRUPTER TO PROVIDE PROTECTION OF THE ENTIRE BRANCH CIRCUIT.

14. ALL 15 AND 20 AMP RECEPTACLES ARE TO BE TAMPER RESISTANT. 15. BATHROOM EXHAUST FANS SHALL BE CONTROLLED BY HUMIDISTAT.

	MANUFACTURER:
ECTRICAL LEGEND	
SWITCH	
SWITCH	
LIGHT	
D LIGHT	
E LIGHT	
IGHT	
AN	SUBMITTAL CONSULTANT:
AN/LIGHT	GAEA DESIGN
TLET	POWER HOUSE DESIGN GROUP 6608 DEVON DRIVE
JTLET	LIBERTY TOWNSHIP, OH 45044
TITCHED OUTLET	(513) 444.0519
ION	_
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DETECTOR	
DETECTOR/CARBON MONOXIDE DETECTOR COMBO	
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DISPOSAL	
FAN/LIGHT	\subseteq
PANEL	<u> </u>
MONOXIDE DETECTOR	
D OUTLET	
R PROOF	NSTRUCTION
PORT/TV COMBO	
ONNECT	


SCALE: 1/4" = 1'-0" REVISIONS: DESCRIPTION: NO: DATE: APPROVAL STAMPS:

DRAWN BY: LCL

DATE: 7.16.15

SHEET TITLE

DRAWING NUMBER

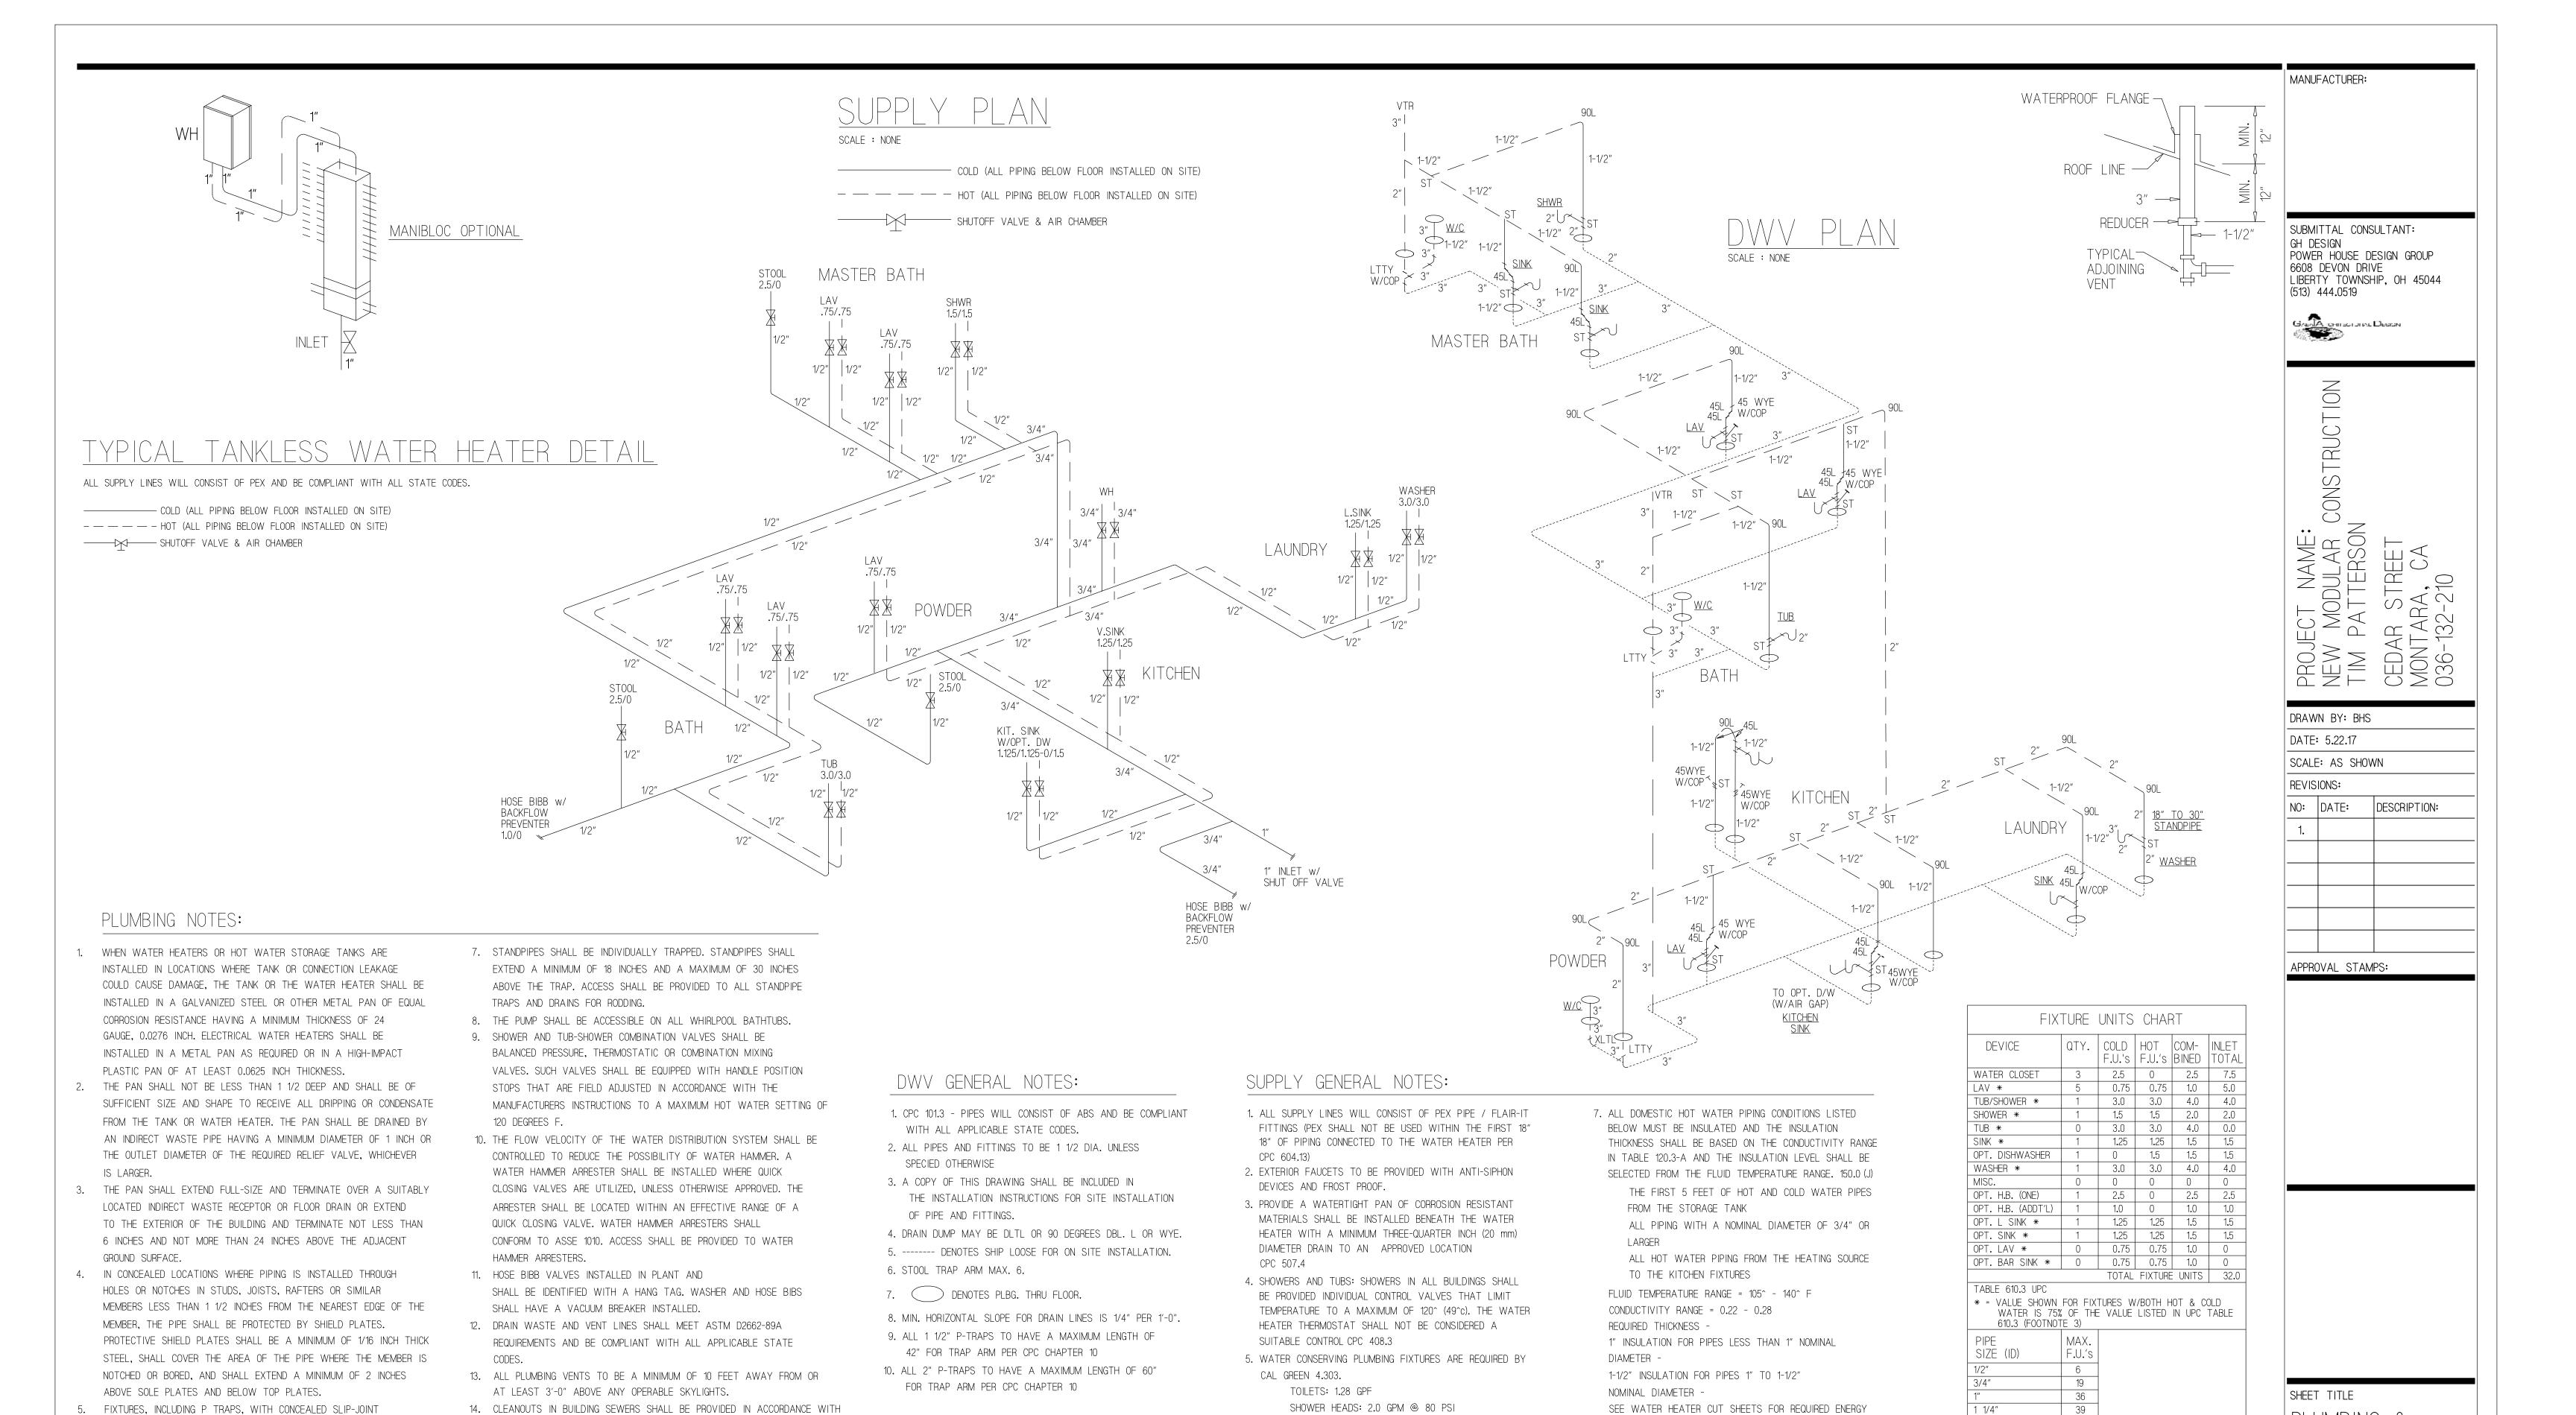

LAVY FAUCETS: 1.5 GPM @ 60 PSI

KITCHEN FAUCETS: 1.8 GPM @ 60 PSI

CONDITIONED SPACE OR OTHERWISE PROTECTED FROM

FREEZING IN ACCORDANCE WITH LOCAL ADOPTED CODES.

6. ALL COLD WATER PIPING SHALL BE LOCATED WITHIN

CPC 312.6

ALL PLUMBING BELOW SHIPPED FLOOR IS

INSTALLED ON SITE BY OTHERS.

THE RULES, REGULATIONS AND ORDINANCES OF THE CITY.

15. WATER DISTRIBUTION SYSTEM SUPPLY LINES WILL BE COMPLIANT WITH

ALL PLUMBING IS STUBBED THRU

ALL CLEANOUTS SHALL BE MAINTAINED WATERTIGHT.

ALL STATE CODES.

CONNECTIONS SHALL BE PROVIDED WITH ON ACCESS PANEL OR UTILITY

SPACE AT LEAST 12 INCHES IN ITS SMALLEST DIMENSION OR OTHER

APPROVED ARRANGEMENT SO AS TO PROVIDE ACCESS TO THE SLIP

6. THE DISCHARGE FROM AN AUTOMATIC CLOTHES WASHER SHALL BE

THROUGH AN AIR BREAK AND CONNECTED TO A STANDPIPE.

CONNECTIONS FOR INSPECTION AND REPAIR.

EFFICIENT WATER HEATER

R-12 OR GREATER, 150.0 J

8. STRAP WATER HEATER FOR SEISMIC RESTRAINT-CPC 507.2

9. STORAGE GAS WATER HEATERS WITH AN ENERGY FACTOR

INSULATION HAVING AN INSTALLED THERMAL RESISTANCE OF

EQUAL TO OR LESS THAN THE FEDERAL MINIMUM

STANDARDS SHALL BE EXTERNALLY WRAPPED WITH

WATER LINES

DRAWING NUMBER

PLUMBING &

TABLE 610.4 UPC

OF 55 FEET

3/4" METER SERVICE

1" BUILDING SERVICE

46-60 PSI PRESSURE - 80' MAX. LENGTH

RESIDENCE WILL HAVE A MINIMUM

FOR A MAXIMUM DEVELOPED LENGTH

DESIGN PRESSURE OF 40 PSI

CHAPTER 7A WUIC GUIDELINES NOTES:

THE EXPOSED UNDERSIDE OF ENCLOSED ROOF EAVES AND ROOF EAVE SOFFITS SHALL BE PROTECTED BY ONE OF THE 1 THROUGH 4 ITEMS AS FOR EXTERIOR WALLS OR HAVE BOXED IN SOFFITS MEETING SFM 7A-3 (R327.7.5) EXI FASCIA AND OTHER ARCHITECTURAL TRIM BOARDS.

EXTERIOR PORCH CEILINGS SHALL BE PROTECTED BY ONE OF THE 1 THROUGH 4 ITEMS AS FOR EXTERIOR WALLS OR HAE PORCH CEILING ASSEMBLIES MEETING SFM 7A-3 (R327.7.6). EX: ARCHITECTURAL TRIM BOARDS.

EXPOSED UNDERSIDE OF FLOOR PROJECTIONS SHALL BE PROTECTED BY ONE OF THE 1 THROUGH 4 ITEMS AS FOR EXTERIOR WALLS OR HAVE AN UNDERSIDE ASSEMBLY MEETING SFM 7A-3 EX: ARCHITECTURAL TRIM BOARDS.

THE UNDERFLOOR AREA OF OVERHANGS, OR ELEVATED BUILDINGS: AND UNDERSIDE OF APPENDAGES SHALL BE ENCLOSED TO GRADE OR THE UNDERSIDE SHALL BE PROTECTED BY ONE OF THE 1 THROUGH 4 ITEMS AS FOR EXTERIOR WALLS OR HAVE AN ASSEMBLY MEETING SFM 7A-3 (R327.7.8 & R327.7.9). EX: HEAVY-TIMBER STRUCTURAL COLUMS AND BEAMS DO NOT REQUIRE PROTECTION.

EXTERIOR GLAZING EXTERIOR WINDOWS, GLAXED DOORS, GLAZED OPENINGS WITHIN EXTERIOR DOORS AND STRUCTURAL GLASS VENEER SHALL BE CONSTRUCTED OF ONE OF THE FOLLOWING: NOTE - PROVIDE ON WINDOW SCHEDULE AND CALL OUT ON FLOOR

PLAN (R327.8.2)) 1. MULITPANE GLASS UNITS WITH A MINIMUM OF ONE TEMPERED PANE MEETING SECTION 2406 SAFETY GLAZING. 2. GLASS BLOCK UNITS.

. 20 MINUTE MINIMUM FIRE RATED WINDOW. 4. MEET SMF 12-7A-2.

CLASS B MINIMUM (SM CO DIV VII. SEC 9113; 2013 CLASS A IN VHFHSZ (2013 CRC R902.1.1) WHERE ROOF PROFILE ALLOWS FOR A SPACE BETWEEN THE ROOF COVERING THE DECK, THE SPACES SHALL BE CONSTRUCTED TO PREVENT THE INTRUSION OF FLAMES AND EMBERS, FIRE STOPPED

OR HAVE ONE LAYER OF NO. 72 ASTM D 3909 CAP SHEET

OVER THE COMBUSTIBLE DECKING. (R327.5.2) VALLEY SLFASHINGS MIN. 0.019-INCH (NO. 26 GALV.) CORROSION RESISTANT METAL OVER 36 INCH WIDE UNDERLAYMENT OF NO. 72 LB MINERAL-SURFACED NONPERFORATED ASTM D 3909 CAP SHEET. (R327.5.3) ROOF GUTTERS SHALL BE PROVIDED WITH THE MEANS TO PREVENT THE ACCUMULATION OF DEBRIS. (R327.5.4)

VENTILATION OPENINGS FOR ATTICS, ENCLOSED EAVE SOFFITS. ENCLOSED RAFTER SPACES AND UNDERFLOOR AREAS SHALL BE NON-COMBUSTIBLE. CORROSION RESISTANT, AND HAVE WIRE MESH WITH 1/16TH TO 1/8TH INCH (1.6-3.2 MM) OPENINGS OR ITS EQUIVALENT. (R327.6.2)

VENTS SHALL NOT BE INSTALLED IN EAVES AND CORNICES. EXCEPTIONS: 1. APPROVED FLAME AND EMBER RESISTANT VENTS. 2.1 ATTIC IS FULLY PROTECTED BY AN AUTOMATIC FIRE SPRINKLER SYSTEM. AND 2.2 EXTERIOR WALL AND UNDERSIDE OF EAVE IS NON-COMBUSTIBLE. AND IS MORE THAN 12 FT FROM GROUND, PATIO, PORCH, DECK OR SIMILAR SURFACE (R327.6.3)

EXTERIOR WALLS SHALL COMPLY WITH ONE OF THE FOLLOWING. (R327.7.3) 1. NON-COMBUSTABLE MATERIAL

IGNITION-RESISTANT MATERIA ONE LAYER OF 5/8TH TYPE X GYPSUM SHEATHING BEHIND

EXTERIOR COVERING 1-HOUR FIRE RESISTANT EXTERIOR WALL ASSEMBLY LOG WALL CONSTRUCTION.

WALL ASSEMBLIES MJEETING SFM 12-7A-1 OPEN ROOF EAVES: THE EXPOSED ROOF DECK ON THE UNDERSIDE OF THE ROOF EAVE SHALL COMPLY WITH ONE OF 1 THROUGH 4 AS FOR EXTERIOR WALLS ABOVE (R327.7.4). EX: 1.2" NOMINAL SOLID WOOD RAFTER TAILS. 2.2" NOMINAL SOLID ROOD BLOCKING BETWEEN RAFTER TAILS, 3, FASCIA AND OTHER ARCHITECTURAL TRIM BOARDS.

EXTERIOR DOOR ASSEMBLIES, INCLUDING GARAGE DOORS, SHALL COMPLY WITH ONE OF THE FOLLOWING (R327.8.3). 1. SURFACE OR CLADDING BE OF NON-COMBUSTIBLE, OR

IGNITION-RESISTANT MATERIAL. 2. CONSTRUCTED OF SOLID CORE WOOD HAVING STILES AND RAILS NOT LESS THAN 1-3/8" WITH INTERIOR FIELD PANEL THICKNESS NO LESS THAN 1-1/4" THICK.

3. HAVE A FIRE RESISTANT RATING OF NOT LESS THAN 20 MINUTES. 4. MEET SFM 22-7A-1

THE WALKING SURFACE MATERIAL OF DECKS, PORCHES,
BALCONIES AND STAIRS SHALL BE CONSTRUCTED OF ONE OF THE
FOLLOWING WHERE ANY PORTION OF SUCH SURFACE IS WITHIN 10 FT. OF THE STRUCTURE (R327.9.3).

1. IGNITION-RESISTANT MATERIALS THAT COMPLY WITH SFM 12-7A-4 AND 12-7A-5.

2. EXTERIOR FIRE-RETARDANT-TREATED WOOD. NONCOMBUSTIBLE MATERIAL. 4. MATERIAL COMPLYING WITH SFM 12-7A-4A WHEN ATTACHED TO A NONCOMBUSTIBLE OR IGNITION RESISTANT WALL COVERING, EX: WHEN DECKING SURFACE MATERIAL MEETS ASTM E 84. CLASS B FLAME SPREAD, ANY OTHER WALL MATERIAL THAT OTHERWISE COMPLIES WITH R327.7.3.


ACCESSORY STRUCTURE TRELLISES, ARBORS, PATIO COVERS, CARPORTS, GAZEBOS AND SIMILAR STRUCTURES ATTACHED TO APPLICABLE BUILDINGS AND DETACHED BUILDINGS WITHIN 50 FT SHALL BE CONSTRUCTED OF NONCOMBUSTIBLE OR IGNITION RESISTANT MATERIAL, (R327.10)

GENERAL NOTES

EXTERIOR JOINTS IN THE BUILDING ENVELOPE THAT ARE SOURCES OF AIR LEAKAGE SUCH AS ROUND WINDOWS AND DOOR FRAMES, BETWEEN WALLS AND FOUNDATIONS, BETWEEN WALLS AND ROOF/CEILING AND BETWEEN WALL PANELS, OPENINGS AT PENETRATIONS OF UTILITY SERVICES THROUGH WALLS, FLOORS, AND ROOFS AND ALL OTHER SUCH OPENINGS IN THE BUILDING ENVELOPE SHALL BE CAULKED, GASKETED, WEATHER STRIPPED, OR OTHERWISE SEALED IN AN APPROVED MANNER

SOFFIT VENTS AND RIDGE VENTS EQUAL TO 1/150 OF TOTAL ROOF AREA (THIS FACTOR MAY BE REDUCED TO 1/300 WHEN A VAPOR BARRIER OF 1 PERM OR LESS IS INSTALLED IN ATTIC)

CONSTRUCTION WILL BE COMPLIANT WITH ALL STATE CODES

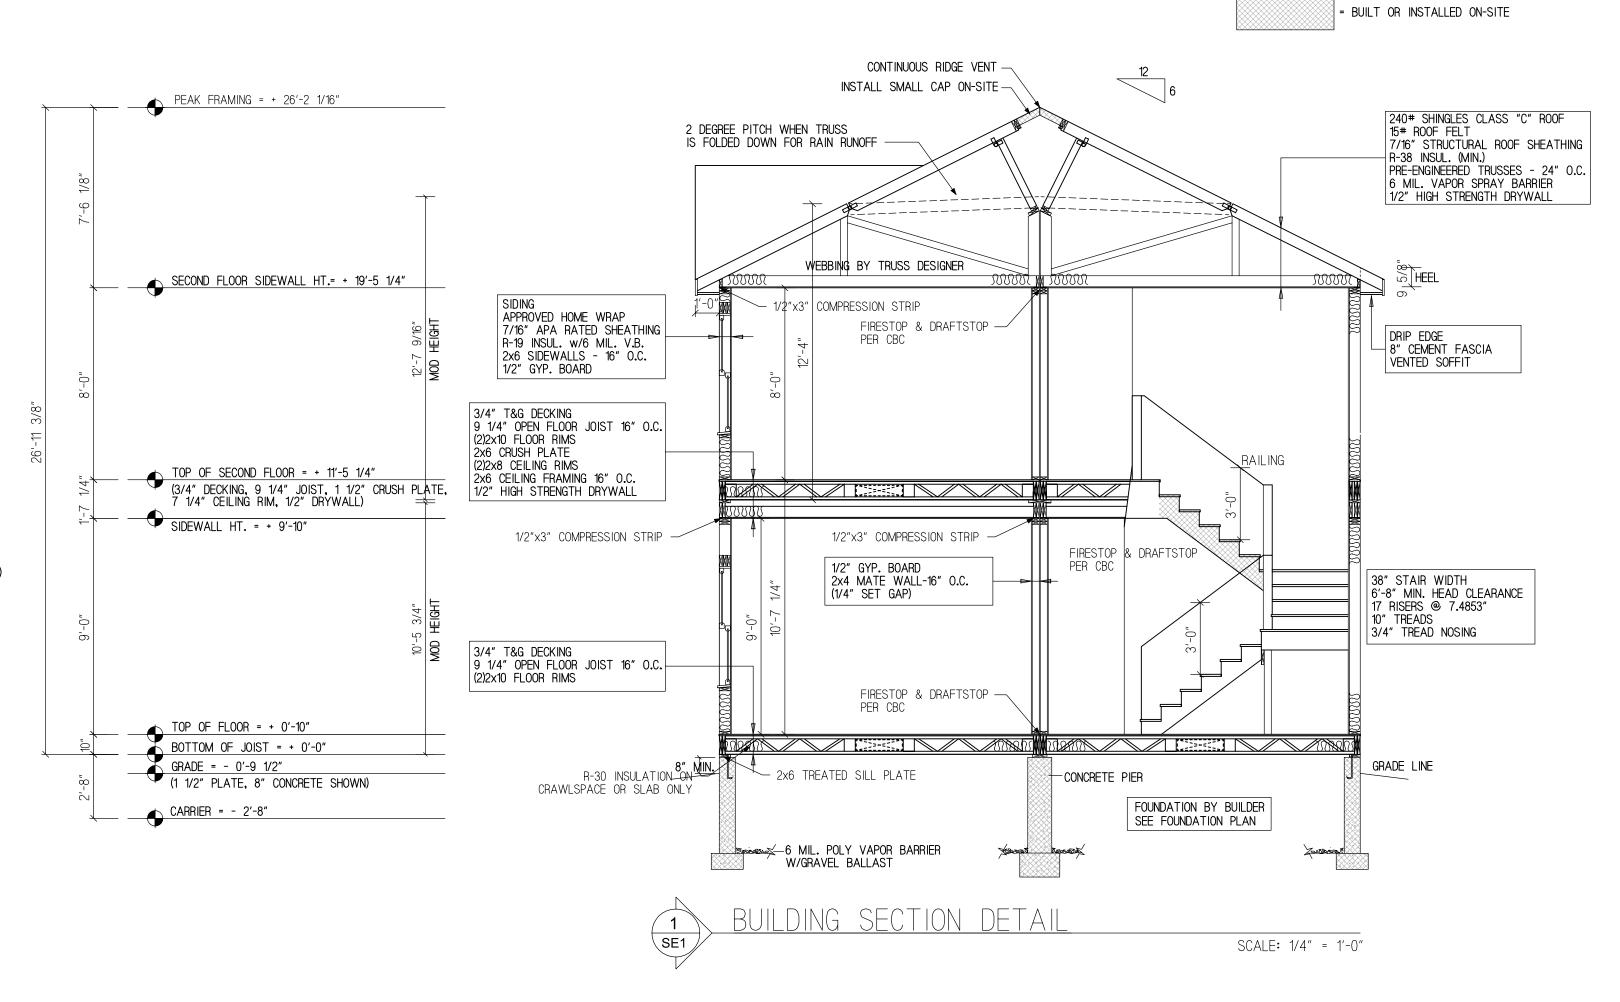

CRAWLSPACE VENTING ATTIC VENTING

1/150 PER SQ. FT. CRAWLSPACE VENTING
LOCATION CUT THROUGH RIM AFTER BUILDING SET IF CRAWLSPACE IS NOT CONDITIONED IF CRAWSPACE IS CONDITIONED AND A 6 MIL POLYETHYLENE VAPOR BARRIER IS USED ON THE CRAWLSPACE FLOOR, 1/1500 PER SQ. FT. OF VENTING IS REQUIRED.

LOCATE CLOSE TO CORNERS & EVENLY DISTRIBUTED TO PROVIDE CROSS VENTILATION

EAVE VENTS AND RIDGE VENTS

ROOF AREA (THIS FACTOR MAY

BE REDUCED TO 1/300 WHEN

A .6 MIL VAPOR BARRIER OF

EAVE VENTING SUBJECT

TO WUIC GUIDELINES IF

1 PERM OR LESS IS INSTALLED

EQUAL TO 1/150 OF TOTAL

PRESCRIPTIVE INSULATION REQUIREMENTS

APPLICABLE.

R-38 INSULATION TO BE PROVIDED IN ATTIC R-19 INSULATION TO BE PROVIDED IN EXTERIOR FRAMED WALLS R-30 INSULATION TO BE PROVIDED BETWEEN FLOOR JOISTS OVER UNCONDITIONED SPACE AND AREAS OVER OUTDOOR AIR (OPT. IN-PLANT INSTALLATION)

FRAMING NOTES:

1. STUD TO PLATE 2x6 3-10d, 2x4 2-10d,

2. DOUBLE 2x6 OR 2x4 TWO ROWS 2d @16" STAGGERED.

3. FLOOR RIM AND BEAM PLYS TO BE FASTENED WITH 3 ROWS 10d NAILS @ 12".

4. HEADER PLYS TO BE FASTENED WITH 3 ROWS 10d @8". 5. HEADERS TO BE (3) 2x W/1/2" OSB FILLERS.

6. MINIMUM TOP PLATE LAP TO BE 48".

7. STUD GRADE TO BE SPF#2 OR BETTER.

8. PLATE GRADE TO BE SPF#2 OR BETTER.

9. RIM GRADE TO BE SPF#2 OR BETTER. 10. HEADER GRADE TO BE SPF#2 OR BETTER.

11. ROOF TRUSSES PLACED @ 24" O.C.

12. 9 1/4" FLOOR TRUSSES PLACED @ 16" O.C.

NOT GREATER THAN 200. CRC R302.9.2- WALL AND CEILING FINISHES SHALL HAVE A SMOKED-DEVELOPED INDEX CRC R312.1.2- REQUIRED GUARDS SHALL BE NOT LESS THAN 42 INCHES HIGH MEASURED VERTICALLY ABOVE THE ADJACENT WALKING SURFACE, ADJACENT FIXED SEATING OR THE LINE CONNECTING THE LEADING EDGES OF THE TREADS. (REVISED ITEM 35 ON SE1) CRC R806,2 THE TOTAL NET FREE VENTILATING AREA SHALL NOT BE LESS THAN 1/50 OF THE AREA OF THE SPACE VENTILATED EXCEPT THAT REDUCTION OF THE TOTAL AREA TO 1/300 IS PERMITTED PROVIDED THAT AT LEAST 50% AND NOT MORE THAN 80% OF THE REQUIRED VENTILATION AREA IS PROVIDED BY VENTILATORS LOCATED IN THE UPPER PORTION OF THE SPACE TO VENTILATED AT LEAST 3" ABOVE THE EAVE OR CORNICE OR 1/300 WHEN A CLASS I OR II VAPOR BARRIER IS INSTALLED ON THE WARM-IN-WINTER SIDE OF THE CEILING. PROVIDE ATTIC VENTILATION CALCULATIONS WITH THE SIZE AND NUMBER OF VENTS.

CRC R302.9.1- WALL AND CEILING FINISHES SHALL HAVE A FLAME SPREAD INDEX OF

RESUME OF SITE WORK

All work provided by others

- Complete foundation and structural tie-downs. Design and construction of foundation system and tie downs done by others and is subject to local jurisdiction having authority.
- Attach modules to foundation per approved foundation design package.
- Bridge sheathing at mate lines as required per structural drawing.
- Complete flue pipes for furnace and water heater.
- Complete moisture protection connections between modules at roof, walls, and
- Interconnect fresh water plumbing at mateline in the crawl space
- Install waste and water manifolds in crawl space as required.
- Connect HVAC flex duct under floor per HVAC design provided with this package.
- Install air conditioning equipment including compressor, coolant lines and electrical connections as required by the local authority.
- Supply and install all gas line piping materials, manifolds and risers as required by the local authority.
- Complete electrical connections between the modules.
- Connect electrical service to the panel on home as required by local authority.
- Interconnect fire sprinkler system through access panels.
- Connect water, sewer, gas, and fire sprinkler service to home as required by local authority.
- Perform required test for electrical, plumbing, mechanical, and fire sprinklers as required by the local authority.
- Complete interior trim, finishing gypsum board, repairing cracks, adjusting doors, and installing carpets and other flooring as needed.
- Complete mod line structural connections per structural drawings.

MANUFACTURER:

SUBMITTAL CONSULTANT: GH DESIGN POWER HOUSE DESIGN GROUP 6608 DEVON DRIVE LIBERTY TOWNSHIP, OH 45044 (513) 444.0519




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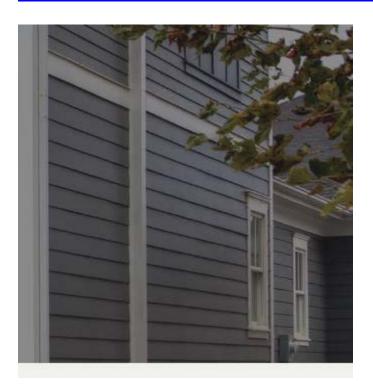








LAP SIDING TYPE https://www.jameshardie.com/products/hardieplank-lap-siding

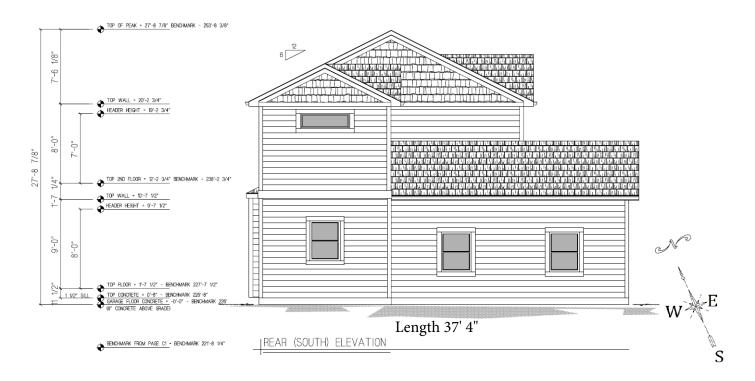

SHINGLE TYPE/ COLOR

https://www.homedepot.com/p/GAF-Timberline-Natural-Shadow-Charcoal-Algae-Resistant-Architectural-Shingles-33-33-sq-ft-per-Bundle-21-pieces-0601180/100658149



GARAGE DOOR STYLE/ WIND/ FIRE RATED/STEEL


https://www.clopaydoor.com/classic

STEEL INSULATED GARAGE DOORS



PAINT BODY COLOR

https://www.ppgpaints.com/color/color-families/neutrals/ufo

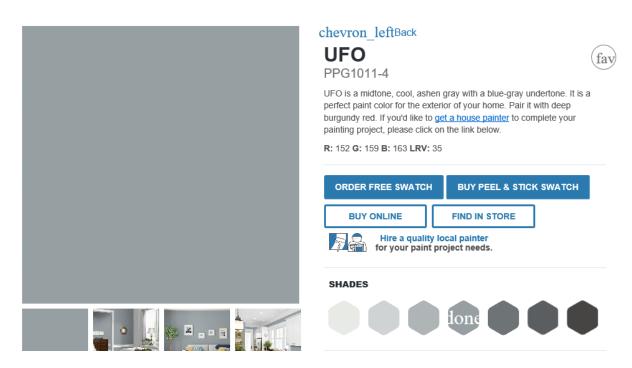

PAINT COLOR TRIM


https://www.ppgpaints.com/color/color-families/neutrals/delicate-white



STEEL DOORS (TYPICAL STEEL CLAD)

https://www.homedepot.com/p/36-in-x-80-in-6-Panel-Primed-Premium-Steel-Front-Door-Slab-THDJW166100317/202036386

Internet #202036386 Model #THDJW166100317 Store SKU #776781

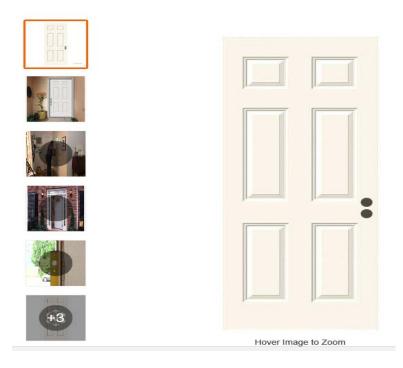

KINRO WINDOWS (TYPICAL)

Kinro 30" x 60" White Vinyl Vertical Sliding Window, Item # KVS3060V | Standard Features

- Vinyl construction provides high thermal performance
- Frame and sash corners are welded for added strength and water tight corners
- Deep pocket sill for added window strength and weather resistance
- Spiral balance system provides near effortless sash operation
- Frame designed with multiple hollow areas for maximum strength and energy efficiency
- Bottom window sash can be removed for easy cleaning on any level of the home
- Reinforcement bars in the meeting rails provide added strength
- Positive integral lock at the meeting rail for increased home security and weather resistance
- Dual weather seal to reduce drafts and enhance energy efficiency
- Nominal 3/4" insulating glass provides superior thermal performance
- Integral "J" trim eliminates the need for additional exterior frame accessories and covers the raw edge of the siding for a clean appearance
- Flush mount pre-punched flange for easy installation.
- Made in the USA

Specifications: Note: will meet WUI standards, Window Type Single Hung

Manufacturer Color/Finish White,

Rough Opening Width (Inches) 30.25, Rough Opening Height (Inches) 60.25

Mounting Flange Width (Inches)1.25

Manufacturer's Warranty (Parts) 5 Year Limited, Manufacturer's Warranty (Labor) N/A

Removable Screen Yes U-Factor 0.49

Solar Heat Gain Coefficient 0.63 Visible Transmittance 0.68
Tilting Top Sash No Tilting Bottom Sash Yes

Internal Grids No HUD Compliant Yes

AAMA Compliant to West Coast Guidelines Yes



https://www.lampsplus.com/products/sage-ridge-12-and-three-quarter-inch-high-dark-sky-outdoor-wall-light 48261.html



Sage Ridge 12 3/4" High Dark Sky Outdoor Wall Light - #48261 | Lamps Plus

Elegant scroll accents and a vintage rust finish bring a warm Mediterranean style to your home's exterior with this outdoor wall light by Minka. 12 3/4" high x 6 1/2" wide. Extends 8 1/4" from the wall. Uses one maximum 60 watt standard-medium base A-15 bulb (not included). Style # 48261 at Lamps Plus.

www.lampsplus.com

https://www.lampsplus.com/products/ripley-collection-9-inch-high-dark-sky-outdoor-wall-light k8377.html



Ripley Collection 9" High Dark Sky Outdoor Wall Light

This outdoor wall light design by Kichler is simple and refined.

Additional Info:

The Ripley Collection of outdoor lighting brings clean lines to a rustic look. An old bronze finish warms the smooth cone shape of this outdoor wall light. All of Kichler's Ripley Collection fixtures are Dark Sky compliant.

KICHLER.

www.lampsplus.com

LANDSCAPE PLAN

EXISTING TREE LINE (SEE ARBOR SHEET)

GARBAGE ST

SCALE: 12' PER INCH

LAYER DECOR BLOCK WALL 140.12 S28°15'00'W PAVER STEPS EJ Maple 15 G **EXISTING TREE NEW TREES** W/ PERIMETER GARDEN COMPOSITE DECK SLDENTRY LOW SHRUBS J,K,L,M NEW TREE Crepe Myrtle 15 gal **FESCUE GROUND COVER** FRONT ENTRY BENCH GARDEN BACKYARD ENTRY GATE

BORDER GRASS

NEW TREE FEATURE W/ PERENNIAL FLOWERS

STAMPED CONCRETE WALKWAY

All plants, including fruit plants, are drought tolerant, and either native or noninvasive species.

Notes: San Mateo Midcoast has no recommended plant list. Plants chosen were picked from the SFDPW suggested plant list for coastal and fog areas.

For California invasive species list see htttps://www.cal-ipc.org/plants/inventory

plants are 2 to 3 gallons unless otherwise noted.

ormium 'Jack Pratt'

Acanthus mollis

Bear's Breech

Agave attenuata 'Nova'

Arctostaphylos 'Emerald

Groundcover Manzanita

Arctostaphylos uva ursi

'Radiant'

Radiant Bearberry

Calamagrostis

Pacific Reed Grass

Coprosma 'Verde Vista'

Correa 'Dusky Bells'

Australian fuschia


Delosperma cooperi

Hardy iceplant

Dietes iridioides

African Iris

Photo

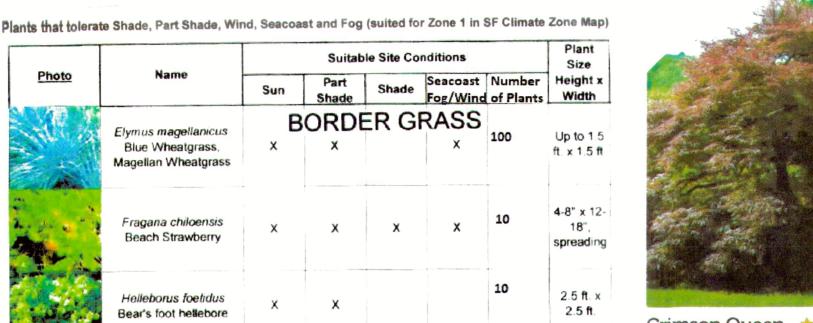

1.5 ft. x

2-4 ft. x 3-

8-14" x 3-

Suitable Site Conditions

Fog/Wind Plants

Crimson Queen ★★★★☆
Japanese Maple



Purple Ghost Japanese Maple Alternative option



1 tree to be planted

Emperor Japanes ****☆ 1 tree to be planted



★★★☆ 31 Reviews Zones: 8-11 (Patio 4-11) Improved Dwarf Meyer Lemon Trees 1 tree to be



Ornamental crabapple Alternative option

Crape myrtle TREE OPTIONS




1 tree to be planted only







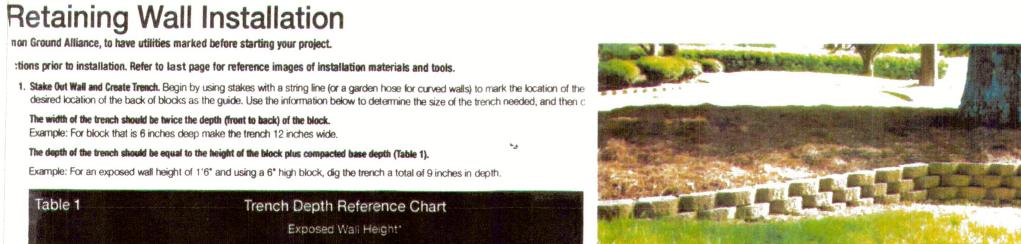

"Seville," "Delmar" and "Captiva," and the least shade-tolerant is "Floratam." St. Augustine is a

good solution for a lawn that includes both full sun and full shade. Palmetto does well in partial or

dappled shade. In north coastal climates, try Colonial bentgrass or tall fescue in partial shade and

Table 1	Trench Depth Reference Chart Exposed Wall Height					
	≦ 1'6"		2'		≥ 3'	
Block Height	Compacted Base Depth	Total Trench Depth	Compacted Base Depth	Total Trench Depth	Compacted Base Depth	Total Trench Depth
67/51	3"	9"	4 °	10"	6"	12"
5 .	3*	8*	4"	9*	N/A	N/A
4.	3"	7*	N/A	N/A	N/A	N/A
3"	3"	6"	N/A	N/A	N/A	N/A

CEDAR

Coastal weather provides a relatively kind

Coastal Conditions

Grass Sod for Shade

environment for grass: not too hot, not too cold and

choice for shady beach properties because it is also

creeping red fescue or velvet bentgrass in full shade.

not too dry. St. Augustine and Manilagrass top the

list for full shade sites and zoysiagrass is a good

salt-tolerant. The best St. Augustine varieties are



St. Augustine 3

This wall is stepped up to fit the contours of the slope.

Harmony 500 sq.

Augustine Sod ... ft. St. Augustine inch Grass

PATTERSON SFD


Montara, California San Mateo County

NEW CONSTRUCTION SINGLE FAMILY RESIDENCE TIM PATTERSON **CEDAR STREET**

MONTARA, CA

036-132-210

Recommended Wood Fence Detail

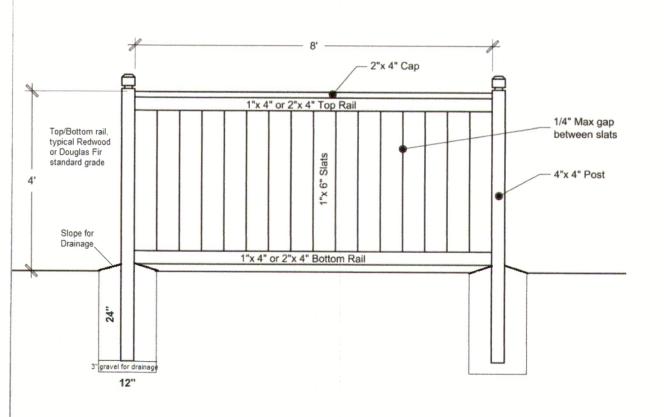

4-FT HIGH FENCE DETAIL

The construction of wood fences, six feet or less in height and not supporting any othe superimposed loads such as those resulting from the self weight of chain link fences, g etc., does not require a building permit.

Wood Fences

Details for typical board fences are shown on pages 1 and 2. Additional requirements a


- Wood posts shall be of naturally durable or preservative-treated wood (CBC 23) Wood posts shall be No. 2 foundation-grade redwood, or pressure-treated Dou
- Preservative treatment must be applied to the ends of wood posts buried in the Set posts/pipes in 12-inch diameter concrete footing extending at least 24 inche undisturbed natural ground or properly compacted fill. Footings should be place inches of loose gravel. Wood posts should extend through concrete footings to
- Use galvanized nails or screws at all wood-to-wood connections.

SECTION 6412. Fences, walls and hedges shall be subject to the following regulations, except as provided in Section 6412.1:


- (a) Fences, walls, and hedges not exceeding four (4) feet in height may occupy any
- (b) Fences, walls, and hedges not exceeding six (6) feet in height may occupy any side or rear yard area, provided:
 - That they do not extend into any required front yard.
 - 2. That, in the case of a corner lot, they do not extend into the side yard required along a side street or into that portion of the rear yard abutting such side street which is equal to the width of the side yard required on said side
- On any parcel of land having a street frontage of one hundred (100) feet or more, and located in any "S" District requiring a minimum building site of twenty thousand (20,000) square feet or more, fences, hedges, or walls not exceeding six (6) feet in height may be erected in any part of the yard area, except as limited by Paragraph (d).
- On any corner lot, the maximum height of fences, walls, hedges, and growth located within fifty (50) feet of the intersected street lines shall not exceed four (4) feet in height; provided that nothing in this section shall prevent any fence, wall, or hedge from occupying any portion of the lot area that a main residence may occupy under the terms of this Part.
- Where trees are located within fifty (50) feet on the intersected street lines, the main trunks of such trees shall be trimmed free of branches to a height of seven and a half (7.5) feet above the curb grade.




Note: This rendering is proportionately and accurately scaled to the engineering drawings.

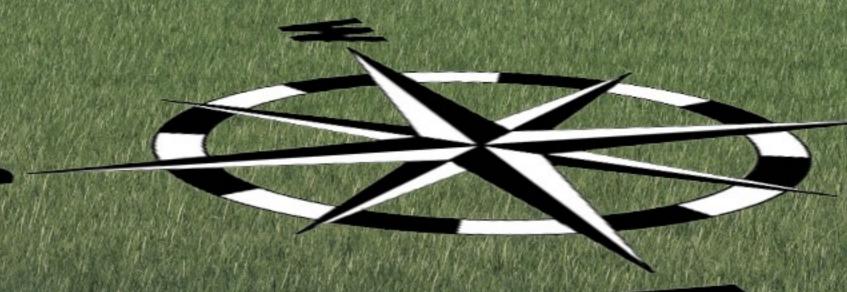


NORTH

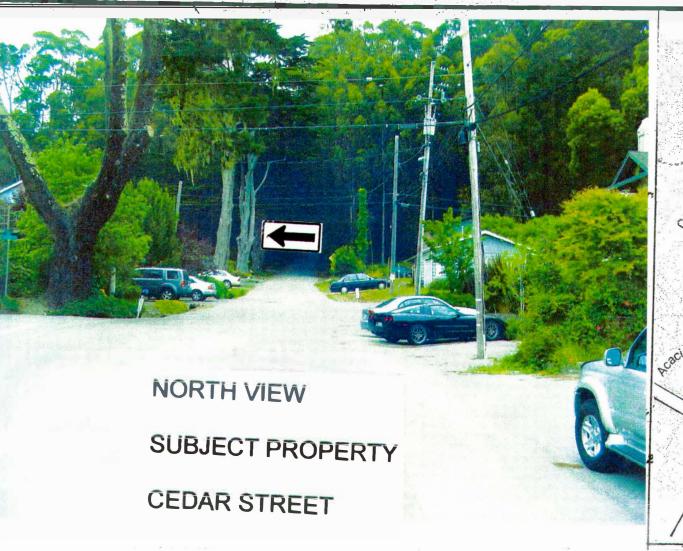

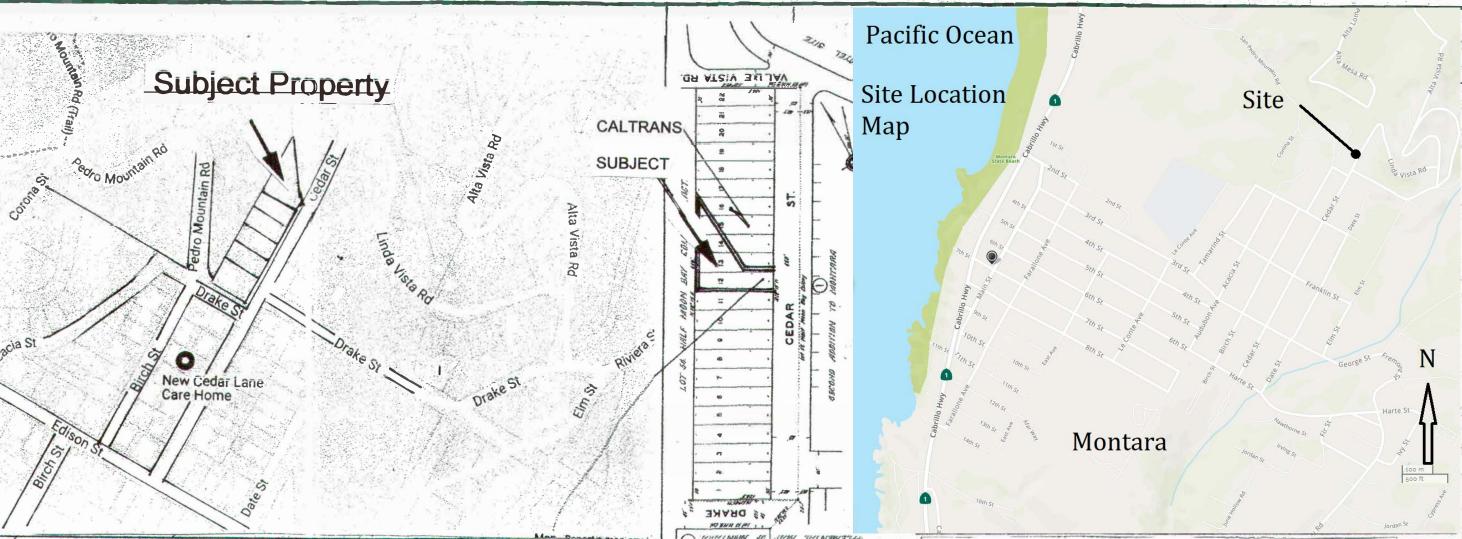




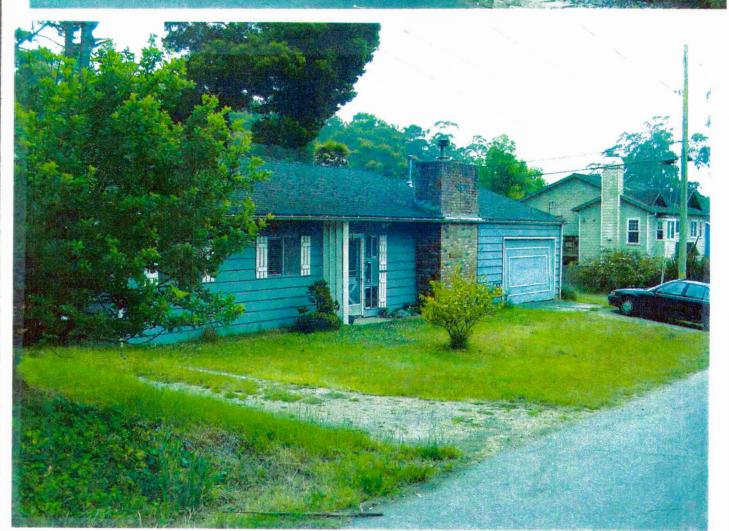

Neighborhood Homes



CEDAR STREET HOMES WITHIN 500'

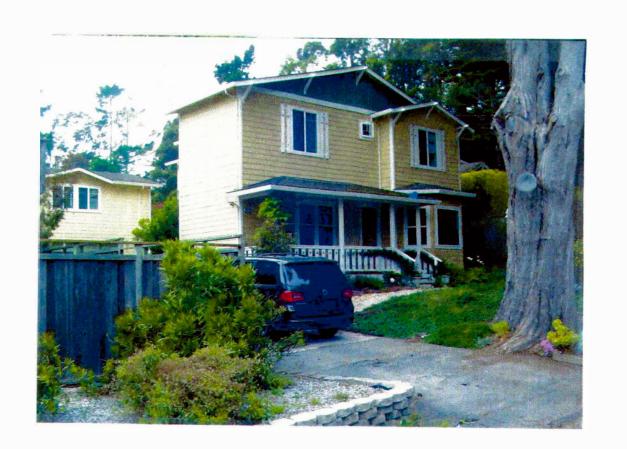



Adjacent Home on South Property Line



NEW CONSTRUCTION SINGLE FAMILY RESIDENCE TIM PATTERSON CEDAR STREET MONTARA, CA 036-132-210

PATTERSON SFD

Montara, California San Mateo County

MANUFACTURER:

1720 E BEAMER STREET WOODLAND, CA. 95776 1-530-666-0974

SUBMITTAL CONSULTANT: GAEA DESIGN
POWER HOUSE DESIGN GROUP
6608 DEVON DRIVE
LIBERTY TOWNSHIP, OH 45044
(513) 444.0519



DRAWN BY: LCL

DATE: 7.16.15 SCALE: NONE

REVISIONS:

DATE: DESCRIPTION:

APPROVAL STAMPS:

SHEET TITLE SECTION VIEW

DRAWING NUMBER

SE1