NEW RESIDENCE

THE SHARMA FAMILY

989 OCEAN BLVD. MOSS BEACH CALIFORNIA 94038

Geurse Conceptual Designs, Inc.



405 bayswater ave. Burlingame, california 94010 tel: 650.703.6197 e:mail: jgeurse@gmail.com

SIGNATURE BOX: NAME: JESSE GEURSE DATE: OCTOBER 29, 2020

BUILD. MAINT. + OPERATION (2019 CGC §4.410) AN OPERATION AND MAINTENANCE MANUAL WILL BE PROVIDED AT FINAL INSPECTION. 2019 CGC §4.410.1 • FOR BUILDINGS WITH MORE THAN 4 MULTI-FAMILY UNITS PROVIDE FOR RECYCLING. 2019 CGC §4.410.2 BUILDING DEPT. GENERAL NOTES ANY HIDDEN CONDITIONS REQUIRE WORK TO BE PERFORMED BEYOND THE SCOPE OF THE BUILDING PERMIT ISSUED FOR THESE PLANS MAY REQUIRE FURTHER CITY APPROVALS INCLUDING REVIEW BY THE PLANNING COMMISSION. THE BUILDING OWNER, PROJECT DESIGNER, AND /OR CONTRACTOR MUST SUBMIT A REVISION TO THE CITY FOR ANY WORK NOT GRAPHICALLY ILLUSTRATED IN THESE PLANS PRIOR TO PERFORMING VERIFICATION (2019 CGC §703)

POLLUTANT CONTROL (2019 CGC §4.504)

UPON REQUEST, VERIFICATION OF COMPLIANCE WITH THIS CODE MAY INCLUDE CONSTRUCTION DOCUMENTS, PLANS, SPECIFICATIONS, BUILDER

OR INSTALLER CERTIFICATION, INSPECTION REPORTS, OR OTHER METHODS ACCEPTABLE TO THE BUILDING DIVISION THAT WILL SHOW

- AT THE TIME OF ROUGH INSTALLATION, DURING STORAGE ON THE CONSTRUCTION SITE, AND UNTIL FINAL STARTUP OF THE HVAC EQUIPMENT, ALL DUCT AND OTHER RELATED AIR DISTRIBUTION COMPONENTS OPENINGS WILL BE COVERED WITH TAPE, PLASTIC, SHEET METALS, OR OTHER METHODS ACCEPTABLE TO THE ENFORCING AGENCY TO REDUCE THE AMOUNT OF WATER, DUST, OR DEBRIS THAT MAY ENTER THE SYSTEM.
- ADHESIVES, SEALANTS, AND CAULKS USED ON THE PROJECT SHALL FOLLOW LOCAL AND REGIONAL AIR POLLUTION OR AIR QUALITY MANAGEMENT DISTRICT STANDARDS. 2019 CGC §4.504.2.1
- PAINTS AND COATINGS WILL COMPLY WITH VOC LIMITS. 2019 CGC §4.504.2.2

SUBSTANTIAL CONFORMANCE WITH THE 2019 CODE REQUIREMENTS.

2019 CGC §703.1

- A FROSOL PAINTS AND COATINGS WILL MEET THE PRODUCT-WEIGHTED MIR LIMITS FOR ROC, AND COMPLY WITH PERCENT VOC BY WEIGHT OF DOCUMENTATION SHALL VERIFY PRODUCT LIMITS, REGULATION 8, RULE 49. 2019 CGC §4.504.2.3 COMPLIANCE FOR VOC FINISH MATERIALS. 2019 CGC §4.504.2.4
- CARPET SYSTEMS WILL MEET CALGREEN TESTING AND PRODUCT REQUIREMENTS. 2019 CGC §4.504.3
- WHERE RESILIENT FLOORING IS INSTALLED, AT LEAST 80% OF THE FLOOR AREA RECEIVING RESILIENT FLOORING WILL COMPLY WITH THE CALIFORNIA GREEN BUILDING CODE REQUIREMENTS. 2019 CGC §4.504.4
- HARDWOOD PLYWOOD, PARTICLEBOARD, AND MEDIUM DENSITY FIBERBOARD COMPOSITE WOOD PRODUCTS SHALL COMPLY WITH THE LOW FORMALDEHYDE EMISSION STANDARDS. 2019 CGC §4.504.5

S.M. COUNTY PLANNING AND BLDG. LOCATION

SAN MATEO COUNTY PLANNING & BUILDING DEPARTMENT COUNTY OFFICE BUILDING 455 COUNTY CENTER, 2ND FLOOR REDWOOD CITY, CA 94063 PHONE: (650) 363-4161 FAX: (650) 363-4849

S.M. COUNTY PLANNING AND BLDG. HOURS

DEVELOPMENT REVIEW CENTER HOURS: MONDAY THRU FRIDAY PLANNING COUNTER: 7:30 AM ~ 5:00 PM, CALL (650) 363-1825 BUILDING COUNTER: 7:30 AM ~ 5:00 PM, CALL (650) 599-7311 FOR AUTOMATED INSPECTION SCHEDULING SYSTEM, CALL (650) 306-8415 PUBLIC WORKS COUNTER: 7:30 AM ~ 5:00 PM, CALL (650) 363-4161 APPOINTMENTS ARE TEMPORARILY UNAVAILABLE UNTIL FURTHER NOTICE

- DESIGN/ARCHITECTURE BY: GEURSE CONCEPTUAL DESIGNS, INC 405 BAYSWATER AVENUE BURLINGAME, CA. 94010 PHONE:(650) 703-6197 E:MAIL: JGEURSE@GMAIL.COM
- GRADING AND DRAINING (CIVIL ENG.) BY: OSUNA ENGINEERING, INC. PROJECT MANAGER JESUS OSUNA PHONE: (408) 721-2100 EXT. 105 FAX. (408)721-1333

PROJECT TEAM

• LANDSCAPING BY: TAPROOT GARDEN DESIGN TOPAZE & PATRICK MCCAFFERY (408) 728-7689 ORGANIC@TAPROOTGARDENS.COM

JESUS@OSUMAENGINEERING.CO,

- STRUCTURAL ENGINEERING BY: **GPM ENGINEERS** MOHAMMED GENIDY 3340 WALNUT AVE. SUITE 292 FREMON, CA 94538
- GEOTECNICAL ENGINEERING BY: FRANK LEE 10 KOOTENAI COURT FREMONT, CA 94539 (510) 277-2945
- GEOLOGY BY: LOURICHARDS P.O.BOX 2085 MOUNTAIN VIEW, CA 94042 (650) 967-1000

(510) 377-7866

- FIRE PROTECTION BY: RYANHOLLAN 4437 OLIVE RANCH ROAD GRANITE BAY. CA 95746
- SOLOR DESIGN BY: SANTA CRUZ RENEWABLES 2360 ORCHARD STREET, #22 SOQUEL, CA 95073

8206 CARIBOU PEAK WAY

ELK GROVE, CA 95758

(530) 400-8593 **ENERGY ANALYTICA**

(916) 214-7051

• SURVEY BY: **BQTLAND SURVEYING** 871 WOODSIDE WAY SAN MATEO, CA 94401 (650) 212-1030

NIETHER GEURSE CONCEPTUAL DESIGNS, INC. OR THE PROJECT ENGINEERS SHALL BE RESPOSIBLE FOR ANY ACTIONS TAKEN. BY ANYONE ON THE PROJECT IF THAT PERSON HAS KNOWLEGDE OF ANY CALCULATIONS OR SPECIFI- CATIONS UNTIL GEURSE CONCEPTUAL DESIGNS, INC. PRINCIPALS OR PROJECT ENGINEERS HAVE BEEN NOTIFIED. UPON NOTIFICATION THE PARTIES INVOLVED WILL CORRECT THE DISCREPANCY, MAKE THE NECESSARY INCLUSIONS OR MORE CLEARLY EXPLAIN THE INTENT OF THE DRAWINGS, CALCULATIONS OR

DISCLAIMER

- THE CONTRACT DRAWINGS AND SPECIFICATIONS REPRESENT THE FINISHED STRUCTURE UNLESS OTHERWISE SHOWN, THEY DO NOT INDICATE THE METHOD OF CONSTRUCTION. THE CONTRACTOR SHALL SUPERVISE AND DIRECT ALL WORK AND SHALL BE SOLELY RESPONSIBLE FOR ALL CONST. MEANS, METHODS, TECHNIQUES, SEQUENCES AND PROCEDURES NECESSARY TO COMPLETE THE PROJECT.
- THE CONTRACTOR SHALL ALSO PROVIDE ALL MEASURES NECESSARY TO PROTECT THE STRUCTURE DURING CONSTRUCTION OBSERVATION VISITS TO THE PROJECT SITE BY FIELD REPRESENTATIVES OF GEURSE CONCEPTUAL DESIGNS, INC. AND PROJECT ENGINEERS SHALL NOT INCLUDE INSPECTION OF PROTECTIVE OF THE CONTRACTOR. ANY SUPPORT SERVICES PERFORMED BY GEURSE CONCEPTUAL DESIGNS, INC. PRINCIPALS AND THE PROJECT ENGINEERS DURING CONSTRUCTION SHALL BE DISTINGUISHED FROM CONTINUOUS AND DETAILED INSPECTION WHICH ARE FURNISED BY OTHERS. THE SUPPORT SERVICES PERFORMED BY GEURSE CONCEPTUAL DESIGNS, INC. AND THE ENGINEERS, WHEATHER OF MATERIAL OR WORK, AND WHEATHER PERFORMED PRIOR TO , DURING, OR AFTER COMPLETION OF CONSTRUCTION ARE PERFORMED SOLELY FOR THE PURPOSE OF ASSISTING IN QUALITY CONTROL AND IN ACHIEVING CONFOR-MANCE WITH THE CONTRACT DRAWINGS AND SPECIFICATIONS. HOWEVER, THEY DO NOT GUARANTEE
- ALL SUB-CONTRACTORS ARE RESPONSIBLE FOR COMPLIANCE OF ALL APPLICABLE CODES AND REGULATIONS REGARDLESS OF WHAT IS SHOWN ON DRAWINGS. ALL WORK SHALL BE PERFORMED IN ACCORDANCE WITH STANDARD BUILDING CODES BY GOVERNING JURISDICTIONS OF APPLICABLE CODES. THE BUILDER OF THIS STRUCTURE SHALL BE TOTALLY RESPONSIBLE FOR VERIFYING ALL DIMENSIONS AND DIMENSIONS TAKE PRECEDENCE OVER ANY SCALED DIMENSIONS. THE CONTRACTOR AND ALL SUB-CONTRACTORS SHALL CHECK ALL DRAWINGS FURNISHED TO THEM IMMEDIATELY UPON RECEIPT AND SHALL PROMPTLY NOTIFY THE CONCERNING PARTIES OF ANY PROBLEMS, DETAILS, OR DISCREPANCIES. THE CONTRACTOR AND ALL SUB-CONTRACTORS SHALL COMPARE ALL DRAWINGS AND VERIFY THE FIGURES IN ALL CONDITIONS, DIMENSIONS, AND DETAILS. ANY DISCREPANCIES SHALL BE CORRECTED PRIOR TO THE COMMENCEMENT OF ANY WORK IN THE AREA OF QUESTION. THE CONTRACTOR AND ANY EFFECTED

- CONTRACTORS PERFORMANCE AND SHALL NOT BE CONSTRUED AS SUPERVISION OF CONSTRUCTION.
- SUB-CONTRACTORS SHALL BE RESPONSIBLE FOR ANY ERRORS WHICH MAY HAVE BEEN OMITTED THEREBY.

- PROJECT: NEW 2 STORY RESIDENCE OWNERS: RAJ SHARMA LOCATION: 989 OCEAN BLVD. MOSS BEACH, CA 94038
- LOT#: APN 037-278-090 ZONING: R-1/S-105 SITE AREA: 4,761 SQ. FT.
- ALLOWABLE 10' EXTENSION OF GARAGE INTO FRONT SETBACK: 210 SQ. F ACTUAL EXTENSION OF GARAGE INTO FRONT SETBACK TOTAL MAX BUILDING FOOTPRINT (INCLUDING GARAGE EXT.): 1,527 SQ. FT.

PROJECT DATA

- FRONT SETBACK: 10'-0" SIDE SETBACKS: BACK SETBACK: 20'-0" 28'-0" MAX, BUILDING HT. 33'~0". MAX. INTRUSION HT.: 27'-6" BUILDING HEIGHT:
- LIVING AREAS:

DESIGN BUILDING FOOT PRINT:

- GARAGE: FIRST FLOOR: 1,104 SQ.FT. SECOND FLOOR: TOTAL FHA AREA (48% of Site): 2,284 SQ. FT.
- BUILDING FOOTPRINT: 1,494 SQ. FT. PARCEL COVERAGE OF IMPERVIOUS AREA (ALLOWED 10% X 4,761 SQ. FT. = 467 SQ. FT.
- PATIO: 220 SQ. FT. 52 SQ.FT. FRONT PORCH: TOTAL = 272 SQ. FT. DRIVEWAY (PERVIOUS PAVERS): 425 SQ.FT
- EST. EXCAVATION:
- **BASEMENT** OCU. YD. TOTAL EXCAVATION: 0 CU. YD.

- DESCRIPTION
- TITLE SHEET + PROJECT DATA
- SITE MANAGEMENT / GREEN BUILDING CONSTRUCTION BEST MANAGEMENT

PRACTICES (BMP'S)

SHEET INDEX

SURVEY

(32% OF SITE)

1,494 SQ. FT.

- SITE PLAN
- ARCHITECTURE
- SITE PLAN FIRST LEVEL FLOOR PLAN FIRST LEVEL FLOOR AREA CALCULATION PLAN
- A.2 SECOND LEVEL FLOOR PLAN A.2.SF SECOND LEVEL FLOOR AREA CALCULATION PLAN
- A.3 ROOFPLAN **EXTERIOR ELEVATIONS**
- **EXTERIOR ELEVATIONS EXTERIOR 3D RENDERINGS** EXTERIOR 3D RENDERINGS
- EXTERIOR 3D RENDERINGS

MOSS BEACH

VICINITY MAP **SUBJECT PROPERTY**



Point

PROJECT DESCRIPTION

NEW 2 STORY RESIDENCE:

FIRST LEVEL: 3 BEDROOM, 2 BATH, 1/2 BATH, FOYER, + 2 CAR GARAGE SECOND LEVEL: FAMILY, ROOM, KITCHEN, DINING AREA, REAR BALCANY AND FRON DECK


CODE COMPLIANT

THESE PLANS ARE TO COMPLY TO THE FOLLOWING CODES, ORDINANCES, RULES AND REGULATIONS;

- 2019 CALIFORNIA BUILDING CODE
- 2019 CALIFORNIA RESIDENTIAL CODE
- 2019 CALIFORNIA ELECTRICAL CODE
- 2019 CALIFORNIA MECHANICAL
- 2019 CALIFORNIA FIRE CODE • 2019 CALIFORNIA PLUMBING CODE
- 2019 CALIFORNIA GREEN BUILDING CODE
- 2019 CALIFORNIA ENERGY EFFICIENCY STANDARDS
- COUNTY OF SAN MATEO MUNICIPAL CODE, ETC.
- ALL OTHER STATE, MUNICIPAL, AND LOCAL ORDINANCES, CODES, RULES AND REGULATIONS.
- AS AMENDED BY THE STATE OF CALIFORNIA BUILDING CODE

/ 5-18-2021 JFG CDRC-MEETING COMMENTS 4-1-2021 JFG PLANNING DESIGN REVIEW SUBMISSION NO. DATE

IT IS THE RESPONSIBILITY OF THE CONTRACTOR TO VERIFY ALL FIELD CONDITIONS AND COMPARE THEM WITH THE CONSTRUCTION DOCUMENTS BEFORE COMMENCING ACTIVITIES, ERRORS, OMMISSIONS OR ANY OTHER INCONSISTENCIES DISCOVERED SHALL IMMEDIATELY BE REPORTED TO THE DESIGNER.

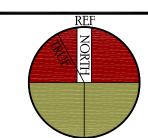

NEW RESIDENCE MR. + MRS. SHARMA 989 OCEAN BLVD. MOSS BEACH, CALIFORNIA 94038

> DRAWING TITLE TITLE SHEET AND PROJECT DATA

DATE JOB NO. SCALE: AS SHOWN DRAWN ELEASED TO REVIEWED

DRAWING NO.




Clean Water. Healthy Community.

Construction Best Management Practices (BMPs)

Construction projects are required to implement the stormwater best management practices (BMP) on this page, as they apply to your project, all year long.

Materials & Waste Management

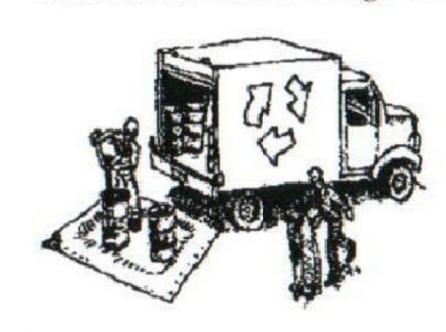

Non-Hazardous Materials

- ☐ Berm and cover stockpiles of sand, dirt or other construction material with tarps when rain is forecast or if not actively being used within
- ☐ Use (but don't overuse) reclaimed water for dust control.

Hazardous Materials

- ☐ Label all hazardous materials and hazardous wastes (such as pesticides, paints, thinners, solvents, fuel, oil, and antifreeze) in accordance with city, county, state and federal regulations.
- ☐ Store hazardous materials and wastes in water tight containers, store in appropriate secondary containment, and cover them at the end of every work day or during wet weather or when rain is forecast.
- ☐ Follow manufacturer's application instructions for hazardous materials and be careful not to use more than necessary. Do not apply chemicals outdoors when rain is forecast within 24 hours.
- ☐ Arrange for appropriate disposal of all hazardous wastes.

Waste Management

- ☐ Cover waste disposal containers securely with tarps at the end of every work day and during wet weather.
- ☐ Check waste disposal containers frequently for leaks and to make sure they are not overfilled. Never hose down a dumpster on the construction site.
- ☐ Clean or replace portable toilets, and inspect them frequently for leaks and spills.
- ☐ Dispose of all wastes and debris properly. Recycle materials and wastes that can be recycled (such as asphalt, concrete, aggregate base materials, wood, gyp board, pipe, etc.)
- ☐ Dispose of liquid residues from paints, thinners, solvents, glues, and cleaning fluids as hazardous waste.

Construction Entrances and Perimeter

- ☐ Establish and maintain effective perimeter controls and stabilize all construction entrances and exits to sufficiently control erosion and sediment discharges from site and tracking off site.
- ☐ Sweep or vacuum any street tracking immediately and secure sediment source to prevent further tracking. Never hose down streets to clean up tracking.

Equipment Management & Spill Control




Maintenance and Parking

- Designate an area, fitted with appropriate BMPs, for vehicle and equipment parking and storage.
- Perform major maintenance, repair jobs, and vehicle and equipment washing off site.
- ☐ If refueling or vehicle maintenance must be done onsite, work in a bermed area away from storm drains and over a drip pan or drop cloths big enough to collect fluids. Recycle or dispose of fluids as hazardous waste.
- If vehicle or equipment cleaning must be done onsite. clean with water only in a berned area that will not allow rinse water to run into gutters, streets, storm drains, or surface waters.
- Do not clean vehicle or equipment onsite using soaps, solvents, degreasers, or steam cleaning equipment.

Spill Prevention and Control

- ☐ Keep spill cleanup materials (e.g., rags, absorbents and cat litter) available at the construction site at all times.
- ☐ Inspect vehicles and equipment frequently for and repair leaks promptly. Use drip pans to catch leaks until repairs are made.
- Clean up spills or leaks immediately and dispose of cleanup materials properly.
- Do not hose down surfaces where fluids have spilled. Use dry cleanup methods (absorbent materials, cat litter, and/or rags).
- Sweep up spilled dry materials immediately. Do not try to wash them away with water, or bury them.
- Clean up spills on dirt areas by digging up and properly disposing of contaminated soil.
- Report significant spills immediately. You are required by law to report all significant releases of hazardous materials, including oil. To report a spill: 1) Dial 911 or your local emergency response number, 2) Call the Governor's Office of Emergency Services Warning Center, (800) 852-7550 (24 hours).

Earthmoving

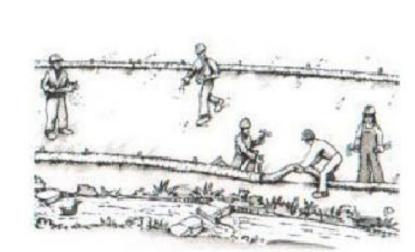


- ☐ Schedule grading and excavation work during dry weather.
- ☐ Stabilize all denuded areas, install and maintain temporary erosion controls (such as erosion control fabric or bonded fiber matrix) until vegetation is established.
- ☐ Remove existing vegetation only when absolutely necessary, and seed or plant vegetation for erosion control on slopes or where construction is not immediately planned.
- ☐ Prevent sediment from migrating offsite and protect storm drain inlets, gutters, ditches, and drainage courses by installing and maintaining appropriate BMPs, such as fiber rolls, silt fences, sediment basins, gravel bags, berms, etc.
- ☐ Keep excavated soil on site and transfer it to dump trucks on site, not in the streets.

Contaminated Soils

- ☐ If any of the following conditions are observed, test for contamination and contact the Regional Water Quality Control Board:
- Unusual soil conditions, discoloration, or odor.
- Abandoned underground tanks.
- Abandoned wells
- Buried barrels, debris, or trash.


Paving/Asphalt Work

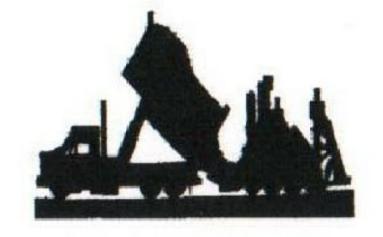

- Avoid paving and seal coating in wet weather or when rain is forecast, to prevent materials that have not cured from contacting stormwater runoff.
- ☐ Cover storm drain inlets and manholes when applying seal coat, tack coat, slurry seal, fog seal, etc.
- ☐ Collect and recycle or appropriately dispose of excess abrasive gravel or sand. Do NOT sweep or wash it into gutters.
- ☐ Do not use water to wash down fresh asphalt concrete pavement.

Sawcutting & Asphalt/Concrete Removal

- ☐ Protect nearby storm drain inlets when saw cutting. Use filter fabric, catch basin inlet filters, or gravel bags to keep slurry out of the storm drain system.
- ☐ Shovel, abosorb, or vacuum saw-cut slurry and dispose of all waste as soon as you are finished in one location or at the end of each work day (whichever is sooner!).
- ☐ If sawcut slurry enters a catch basin, clean it up immediately.

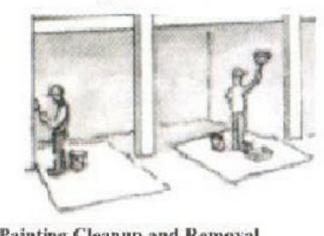

Painting Cleanup and Removal

Concrete, Grout & Mortar

Application

☐ Store concrete, grout, and mortar away

☐ Wash out concrete equipment/trucks

offsite or in a designated washout

that will prevent leaching into the

■ When washing exposed aggregate,

and disposed of properly.

area, where the water will flow into a

temporary waste pit, and in a manner

Let concrete harden and dispose of as

prevent washwater from entering storm

gutters, hose washwater onto dirt areas, or

drain onto a bermed surface to be pumped

Landscaping

☐ Protect stockpiled landscaping materials

☐ Stack bagged material on pallets and

☐ Discontinue application of any erodible

landscape material within 2 days before a

forecast rain event or during wet weather.

tarps all year-round.

under cover.

from wind and rain by storing them under

drains. Block any inlets and vacuum

underlying soil or onto surrounding areas.


rain, runoff, and wind.

garbage.

from storm drains or waterways, and on


pallets under cover to protect them from

- ☐ Never clean brushes or rinse paint drain, or stream.
- ☐ For water-based paints, paint out brushes to the extent possible, and rinse into a drain that goes to the sanitary sewer. Never pour paint down a storm drain.
- the extent possible and clean with thinner reuse thinners and solvents. Dispose of excess liquids as hazardous waste.
- dry stripping and sand blasting may be swept up or collected in plastic drop cloths and disposed of as trash.
- and dust from marine paints or paints containing lead, mercury, or tributyltin must be disposed of as hazardous waste. Lead based paint removal requires a statecertified contractor.

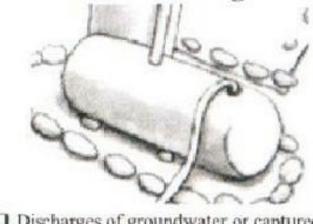


- runoff from dewatering operations must possible send dewatering discharge to landscaped area or sanitary sewer. If local wastewater treatment plant.
- ☐ Divert run-on water from offsite away from all disturbed areas.
- ☐ When dewatering, notify and obtain approval from the local municipality or storm drain. Filtration or diversion through a basin, tank, or sediment trap may be required.
- to be collected and hauled off-site for

Painting & Paint Removal

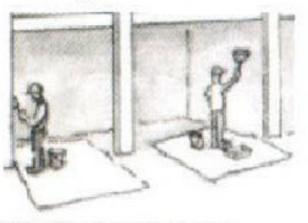

- containers into a street, gutter, storm
- For oil-based paints, paint out brushes to
- or solvent in a proper container. Filter and ☐ Paint chips and dust from non-hazardous
- Chemical paint stripping residue and chips

Dewatering

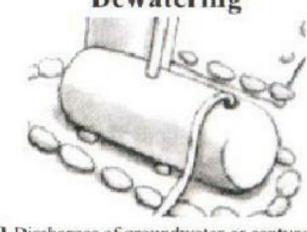

- Discharges of groundwater or captured be properly managed and disposed. When discharging to the sanitary sewer call your
- before discharging water to a street gutter
- ☐ In areas of known or suspected contamination, call your local agency to determine whether the ground water must be tested. Pumped groundwater may need treatment and proper disposal.

405 bayswater ave. Burlingame, california 94010

Geurse Conceptual Designs, Inc.



SIGNATURE BOX:

tel: 650.703.6197 e:mail: jgeurse@gmail.com

DATE: OCTOBER 29, 202




MOSS BEACH

5-18-2021 JFG CDRC-MEETING COMMENTS JFG PLANNING DESIGN REVIEW SUBMISSION 4-1-2021 NO. DATE

REVISIONS

IT IS THE RESPONSIBILITY OF THE CONTRACTOR TO VERIFY ALL FIELD CONDITIONS AND COMPARE THEM WITH THE CONSTRUCTION DOCUMENTS BEFORE COMMENCING ACTIVITIES, ERRORS, OMMISSIONS OR ANY OTHER INCONSISTENCIES DISCOVERED SHALL IMMEDIATELY BE REPORTED TO THE DESIGNER.

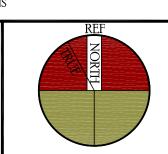


NEW RESIDENCE for MR. + MRS. SHARMA 989 OCEAN BLVD. MOSS BEACH, CALIFORNIA 94038


DRAWING TITLE CONSTRUCTION BEST MANAGEMENT PRACTICES


AART ASSINK JOB NO. CALE: AS SHOWN DRAWN REVIEWED


DRAWING NO.


Storm drain polluters may be liable for fines of up to \$10,000 per day!

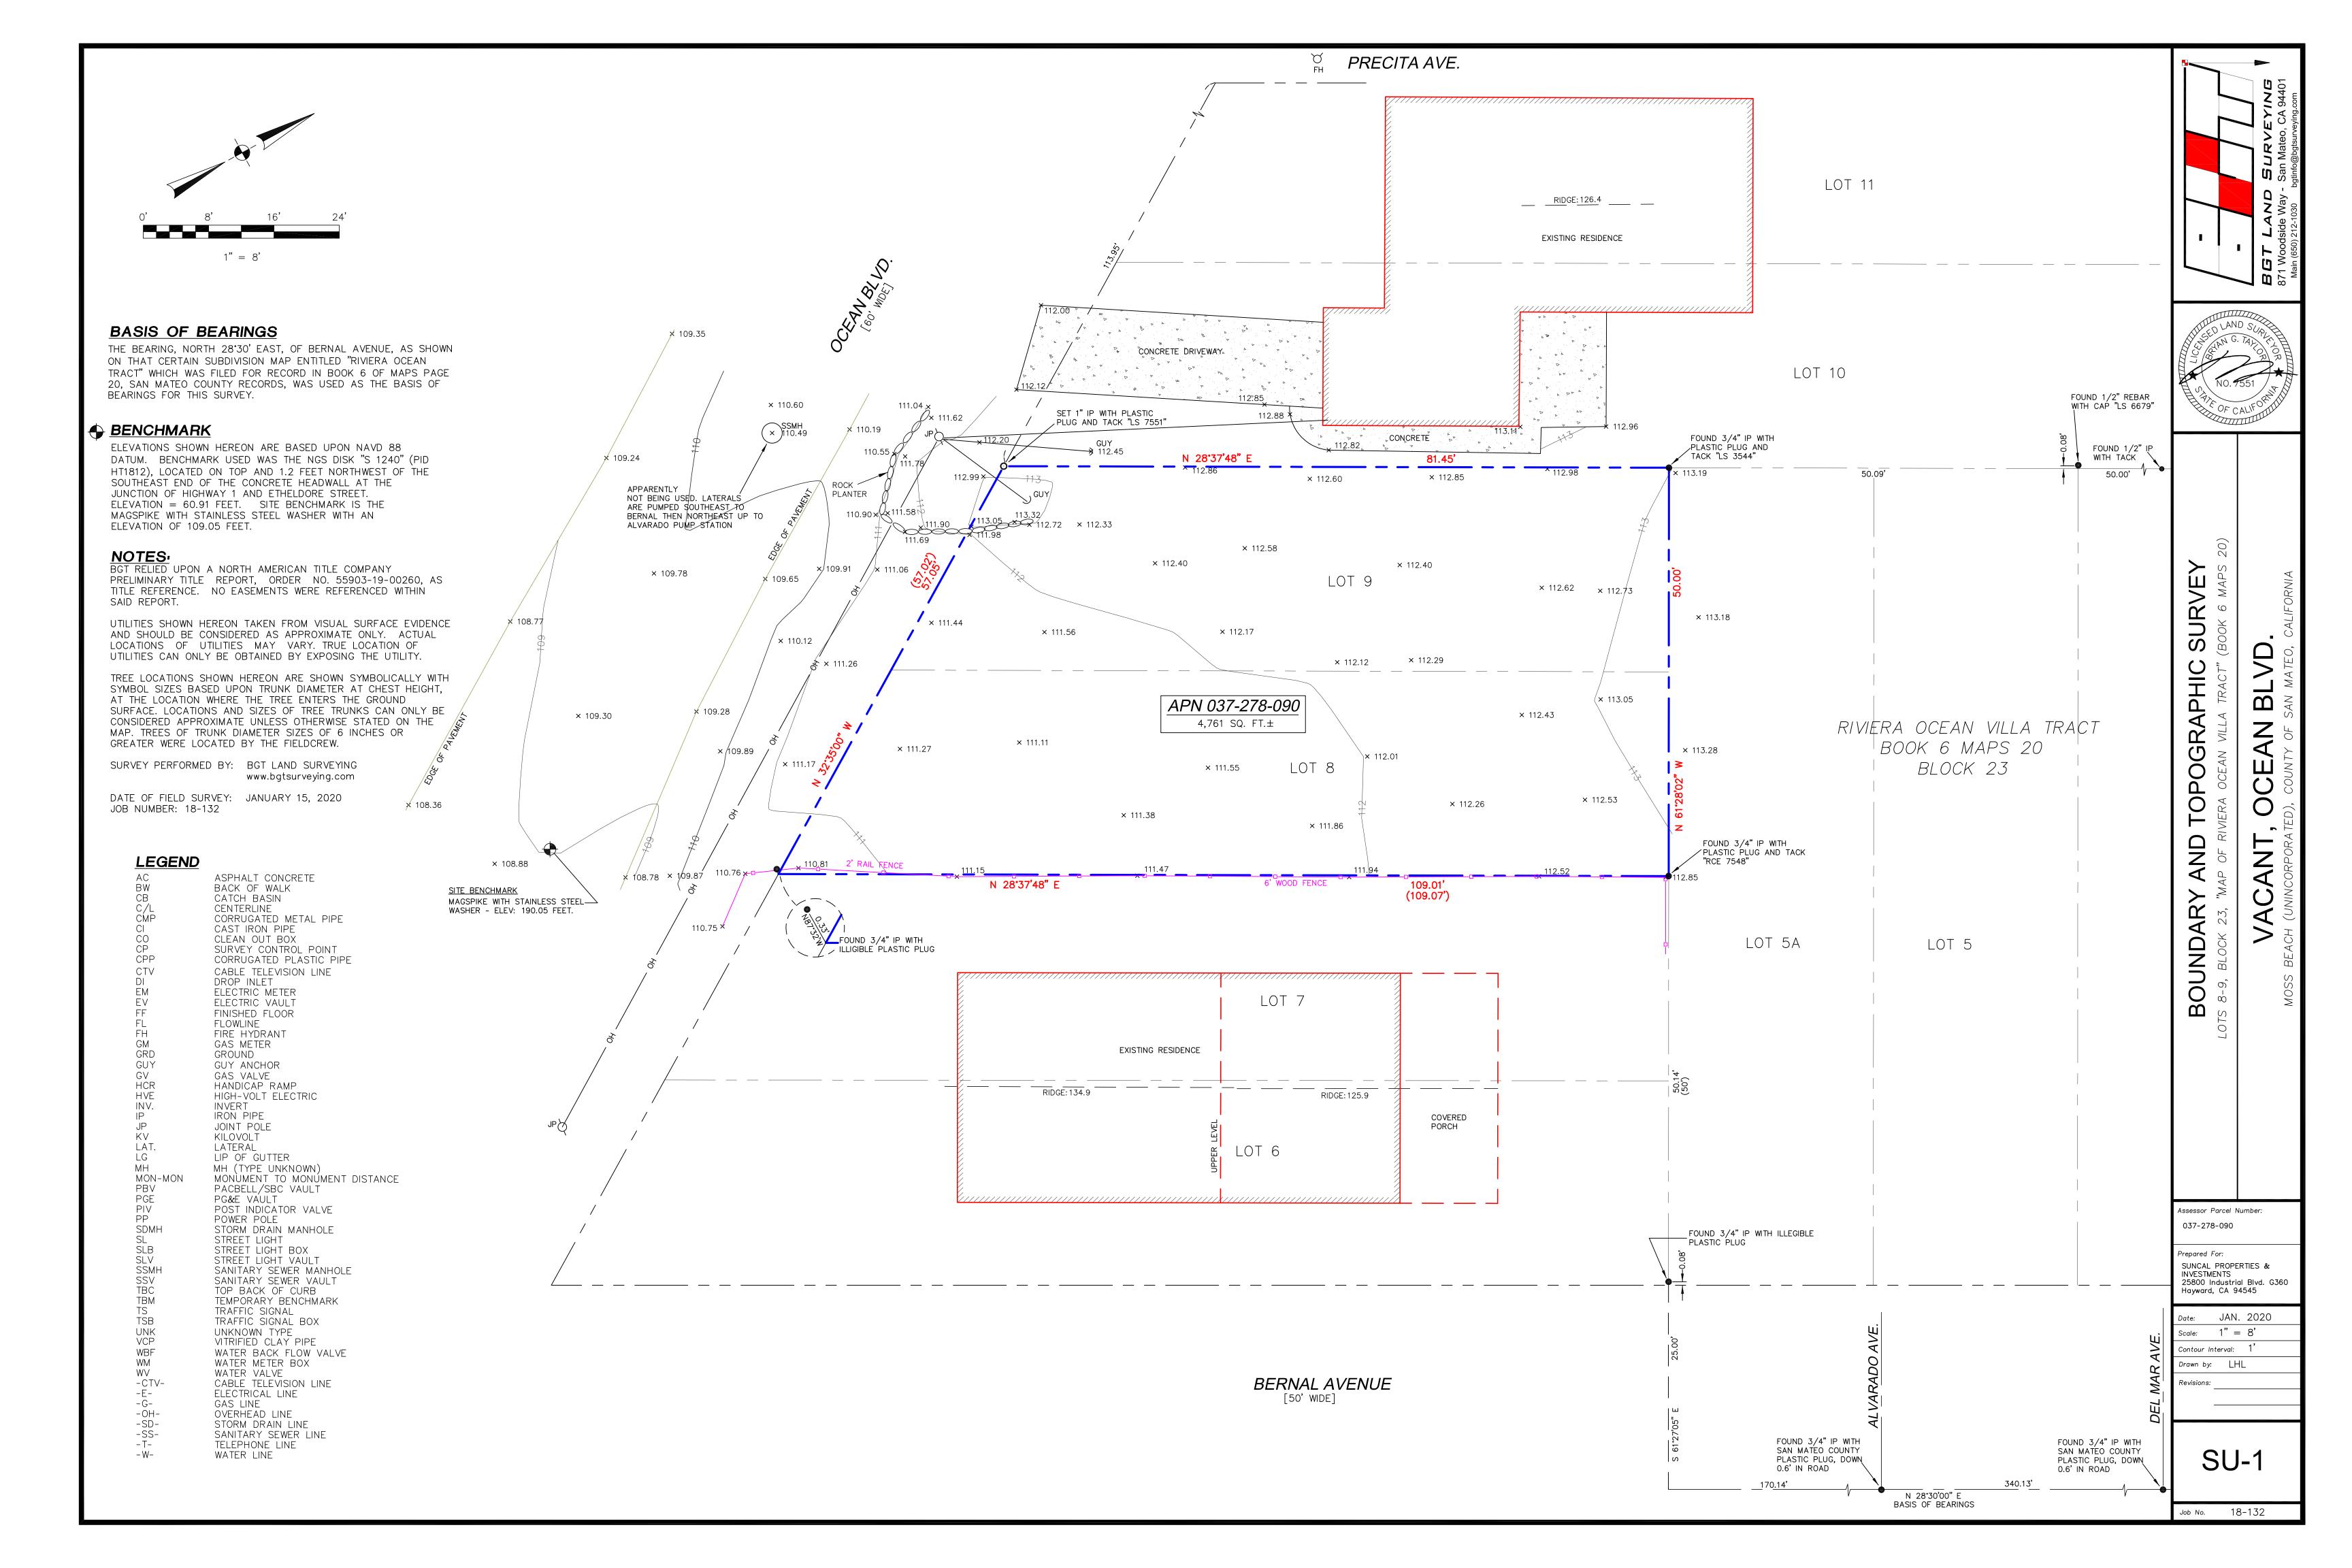


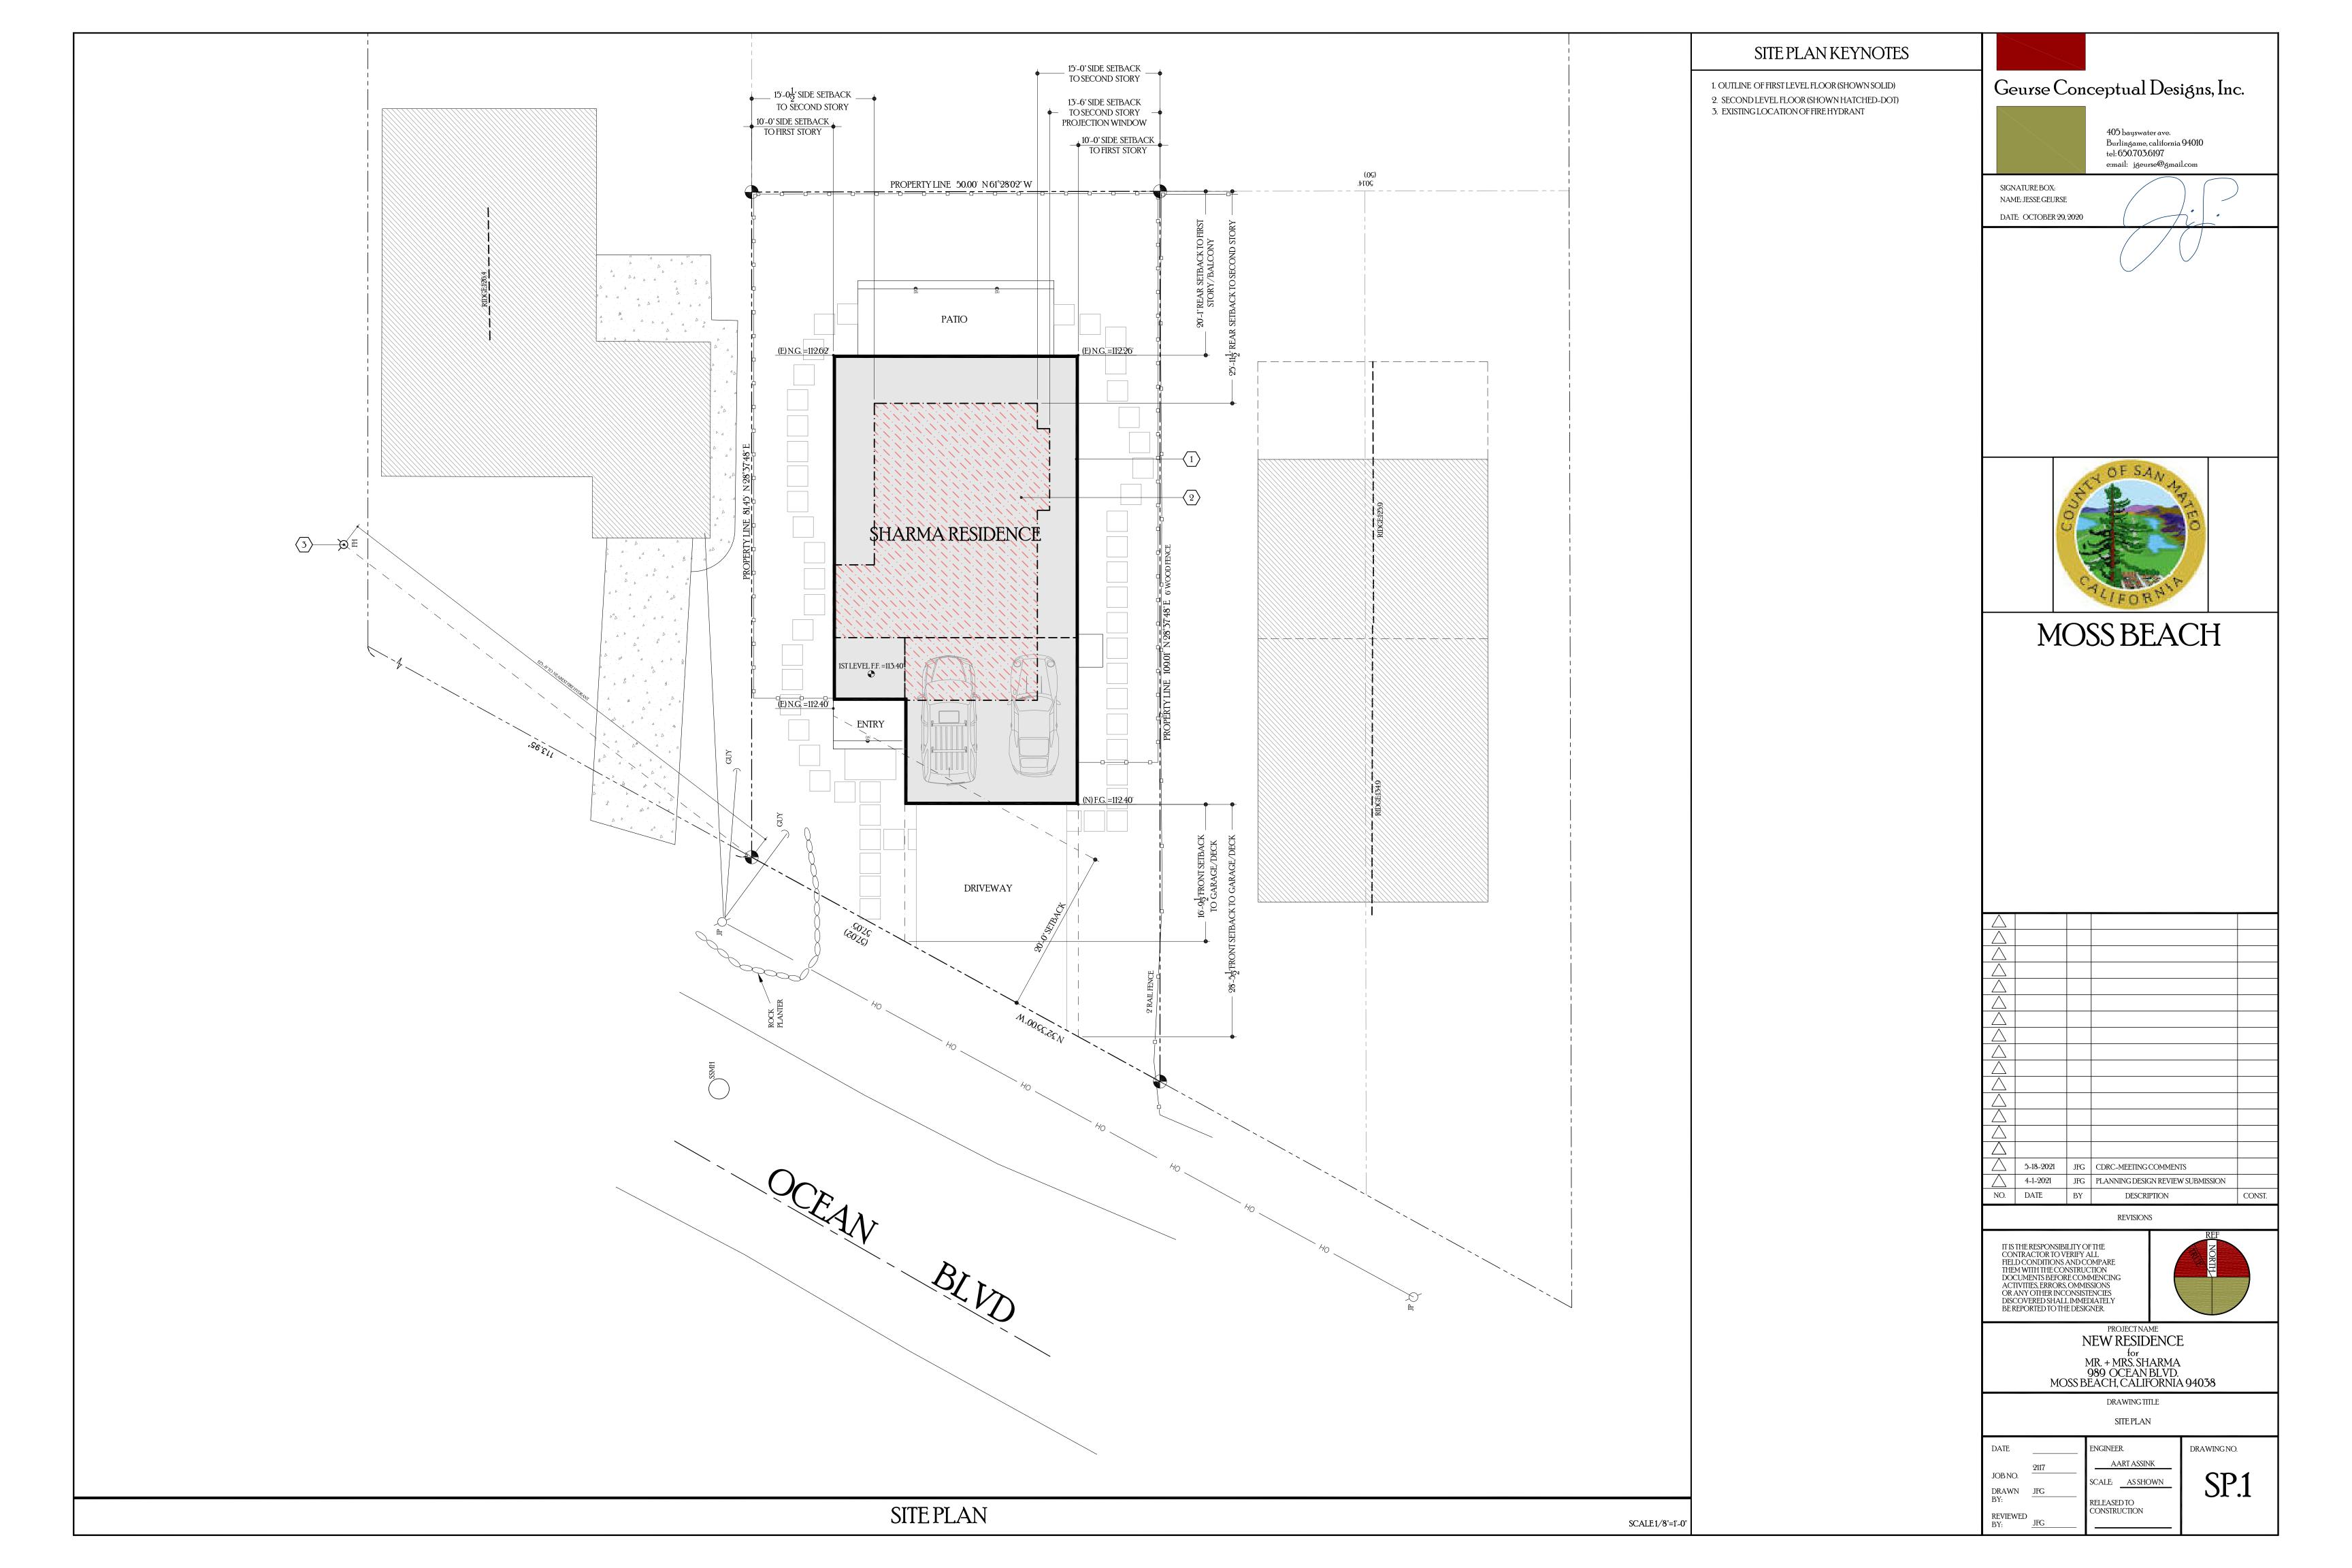

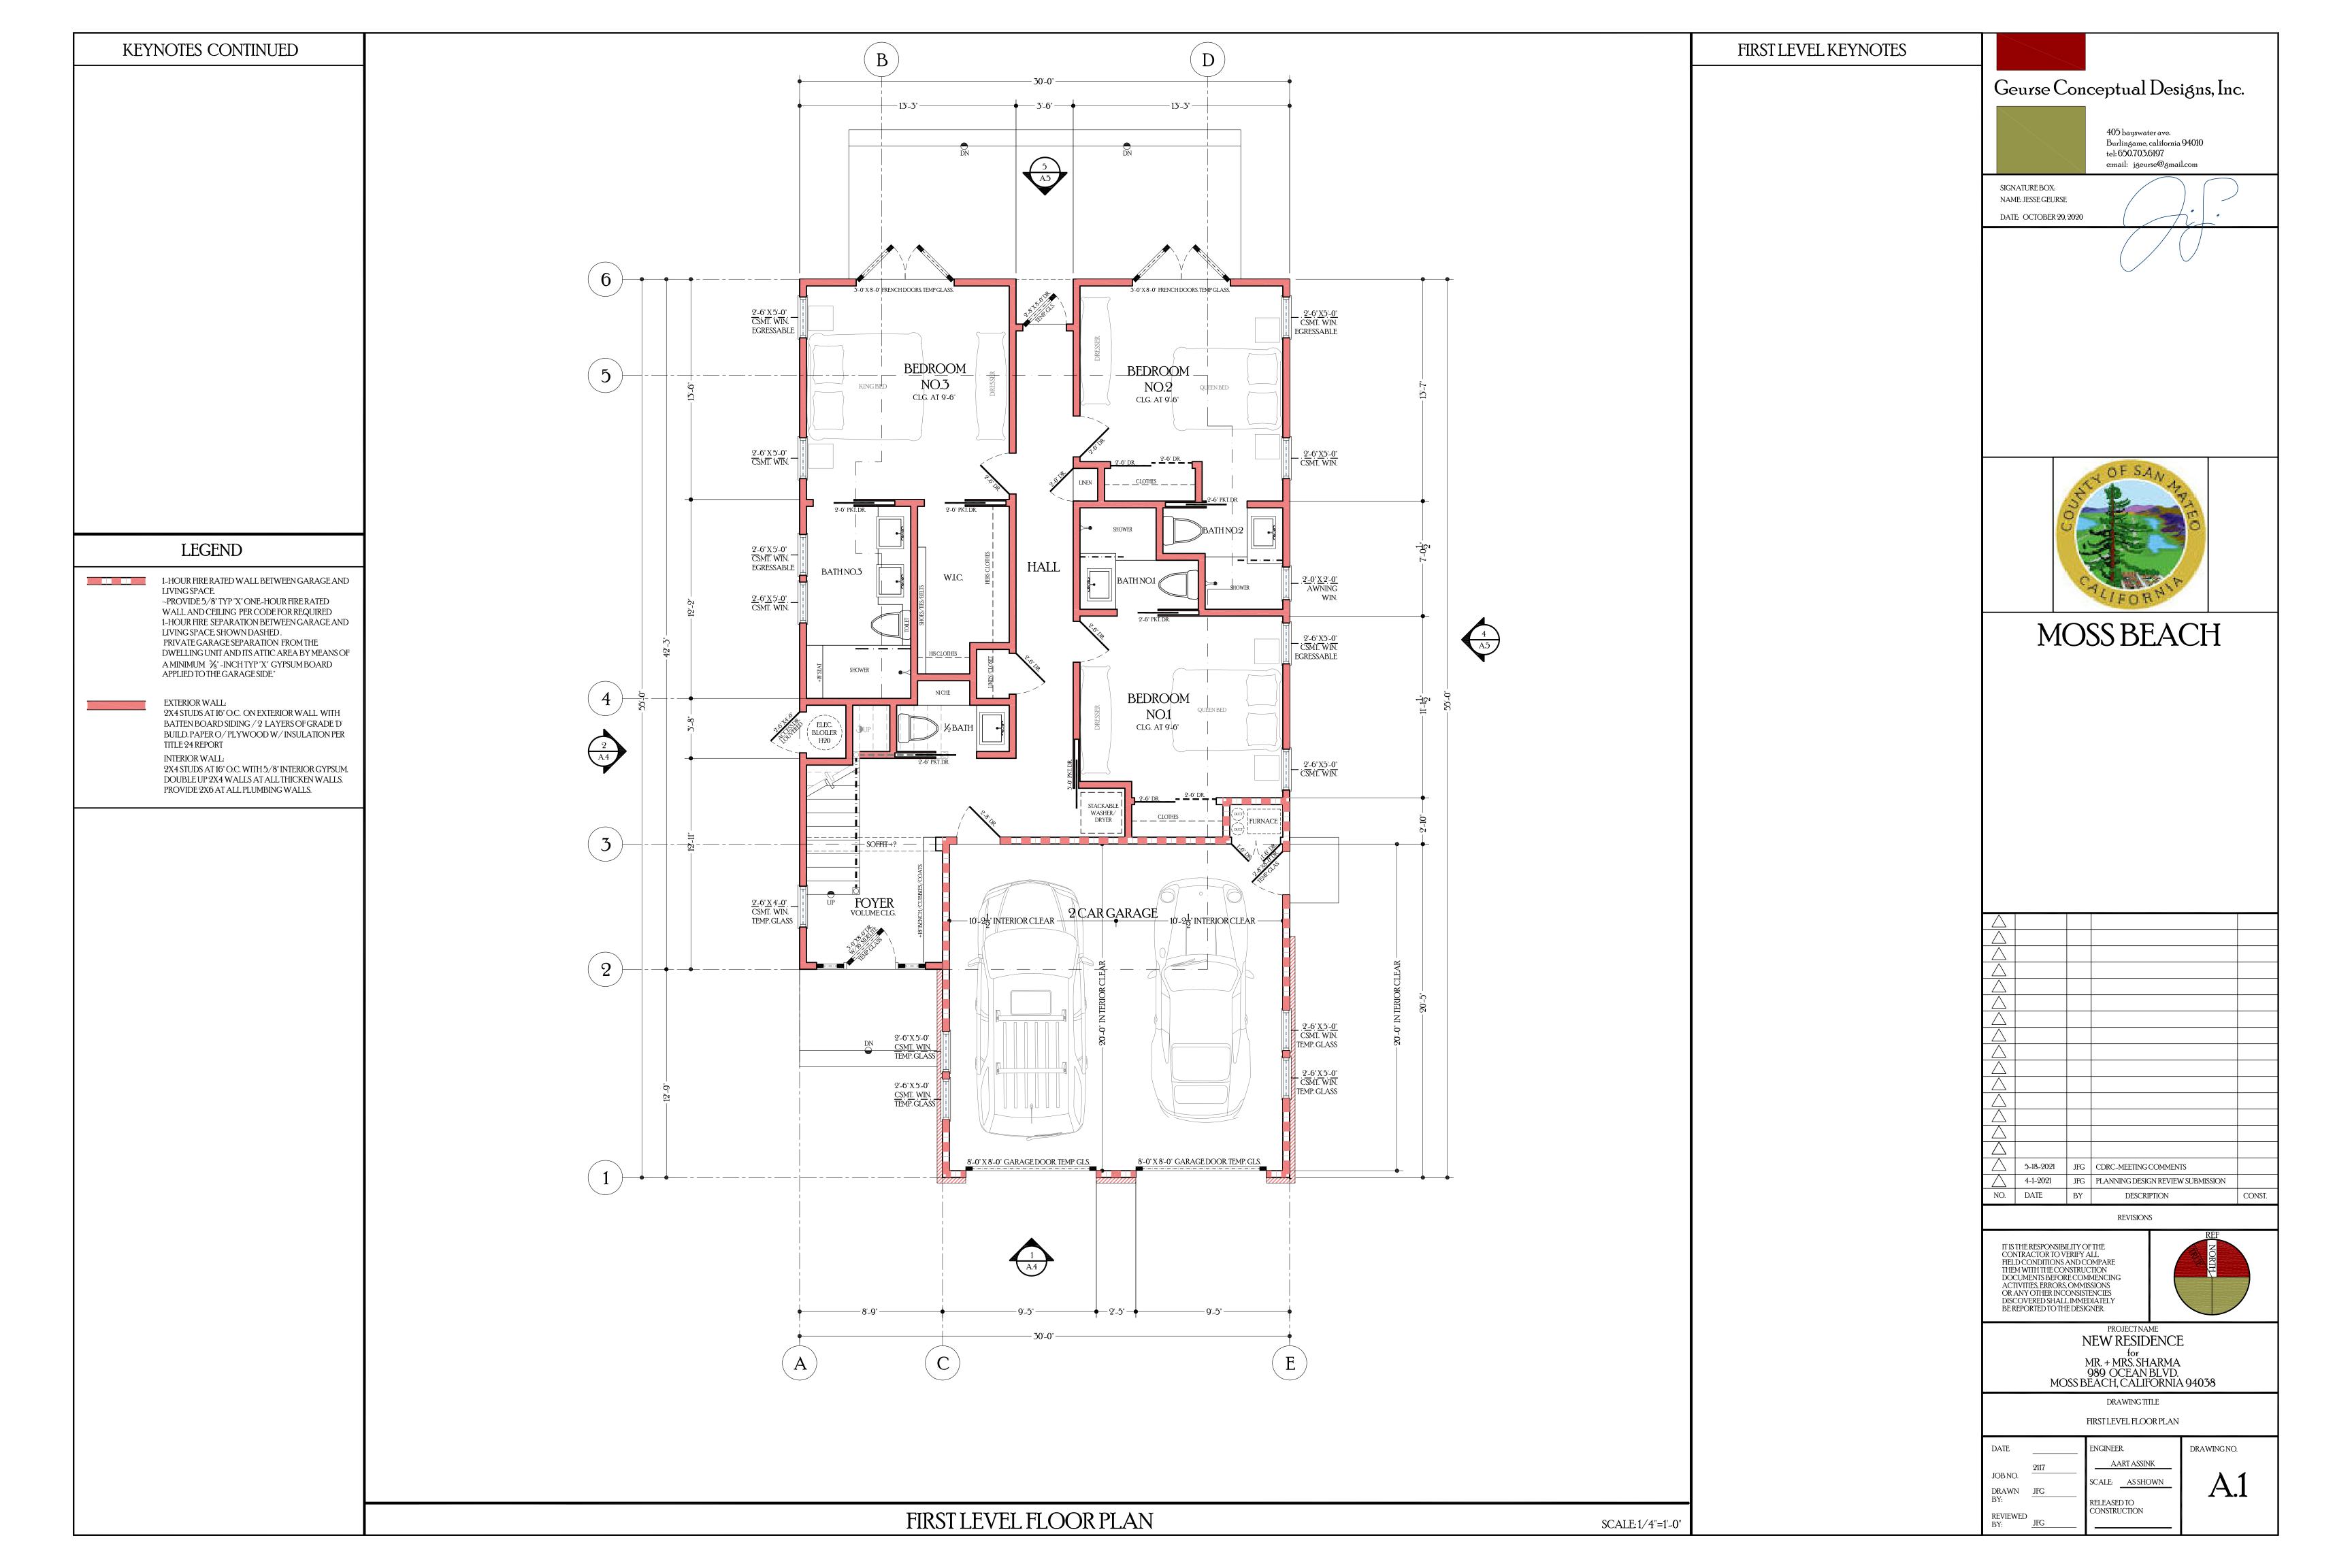

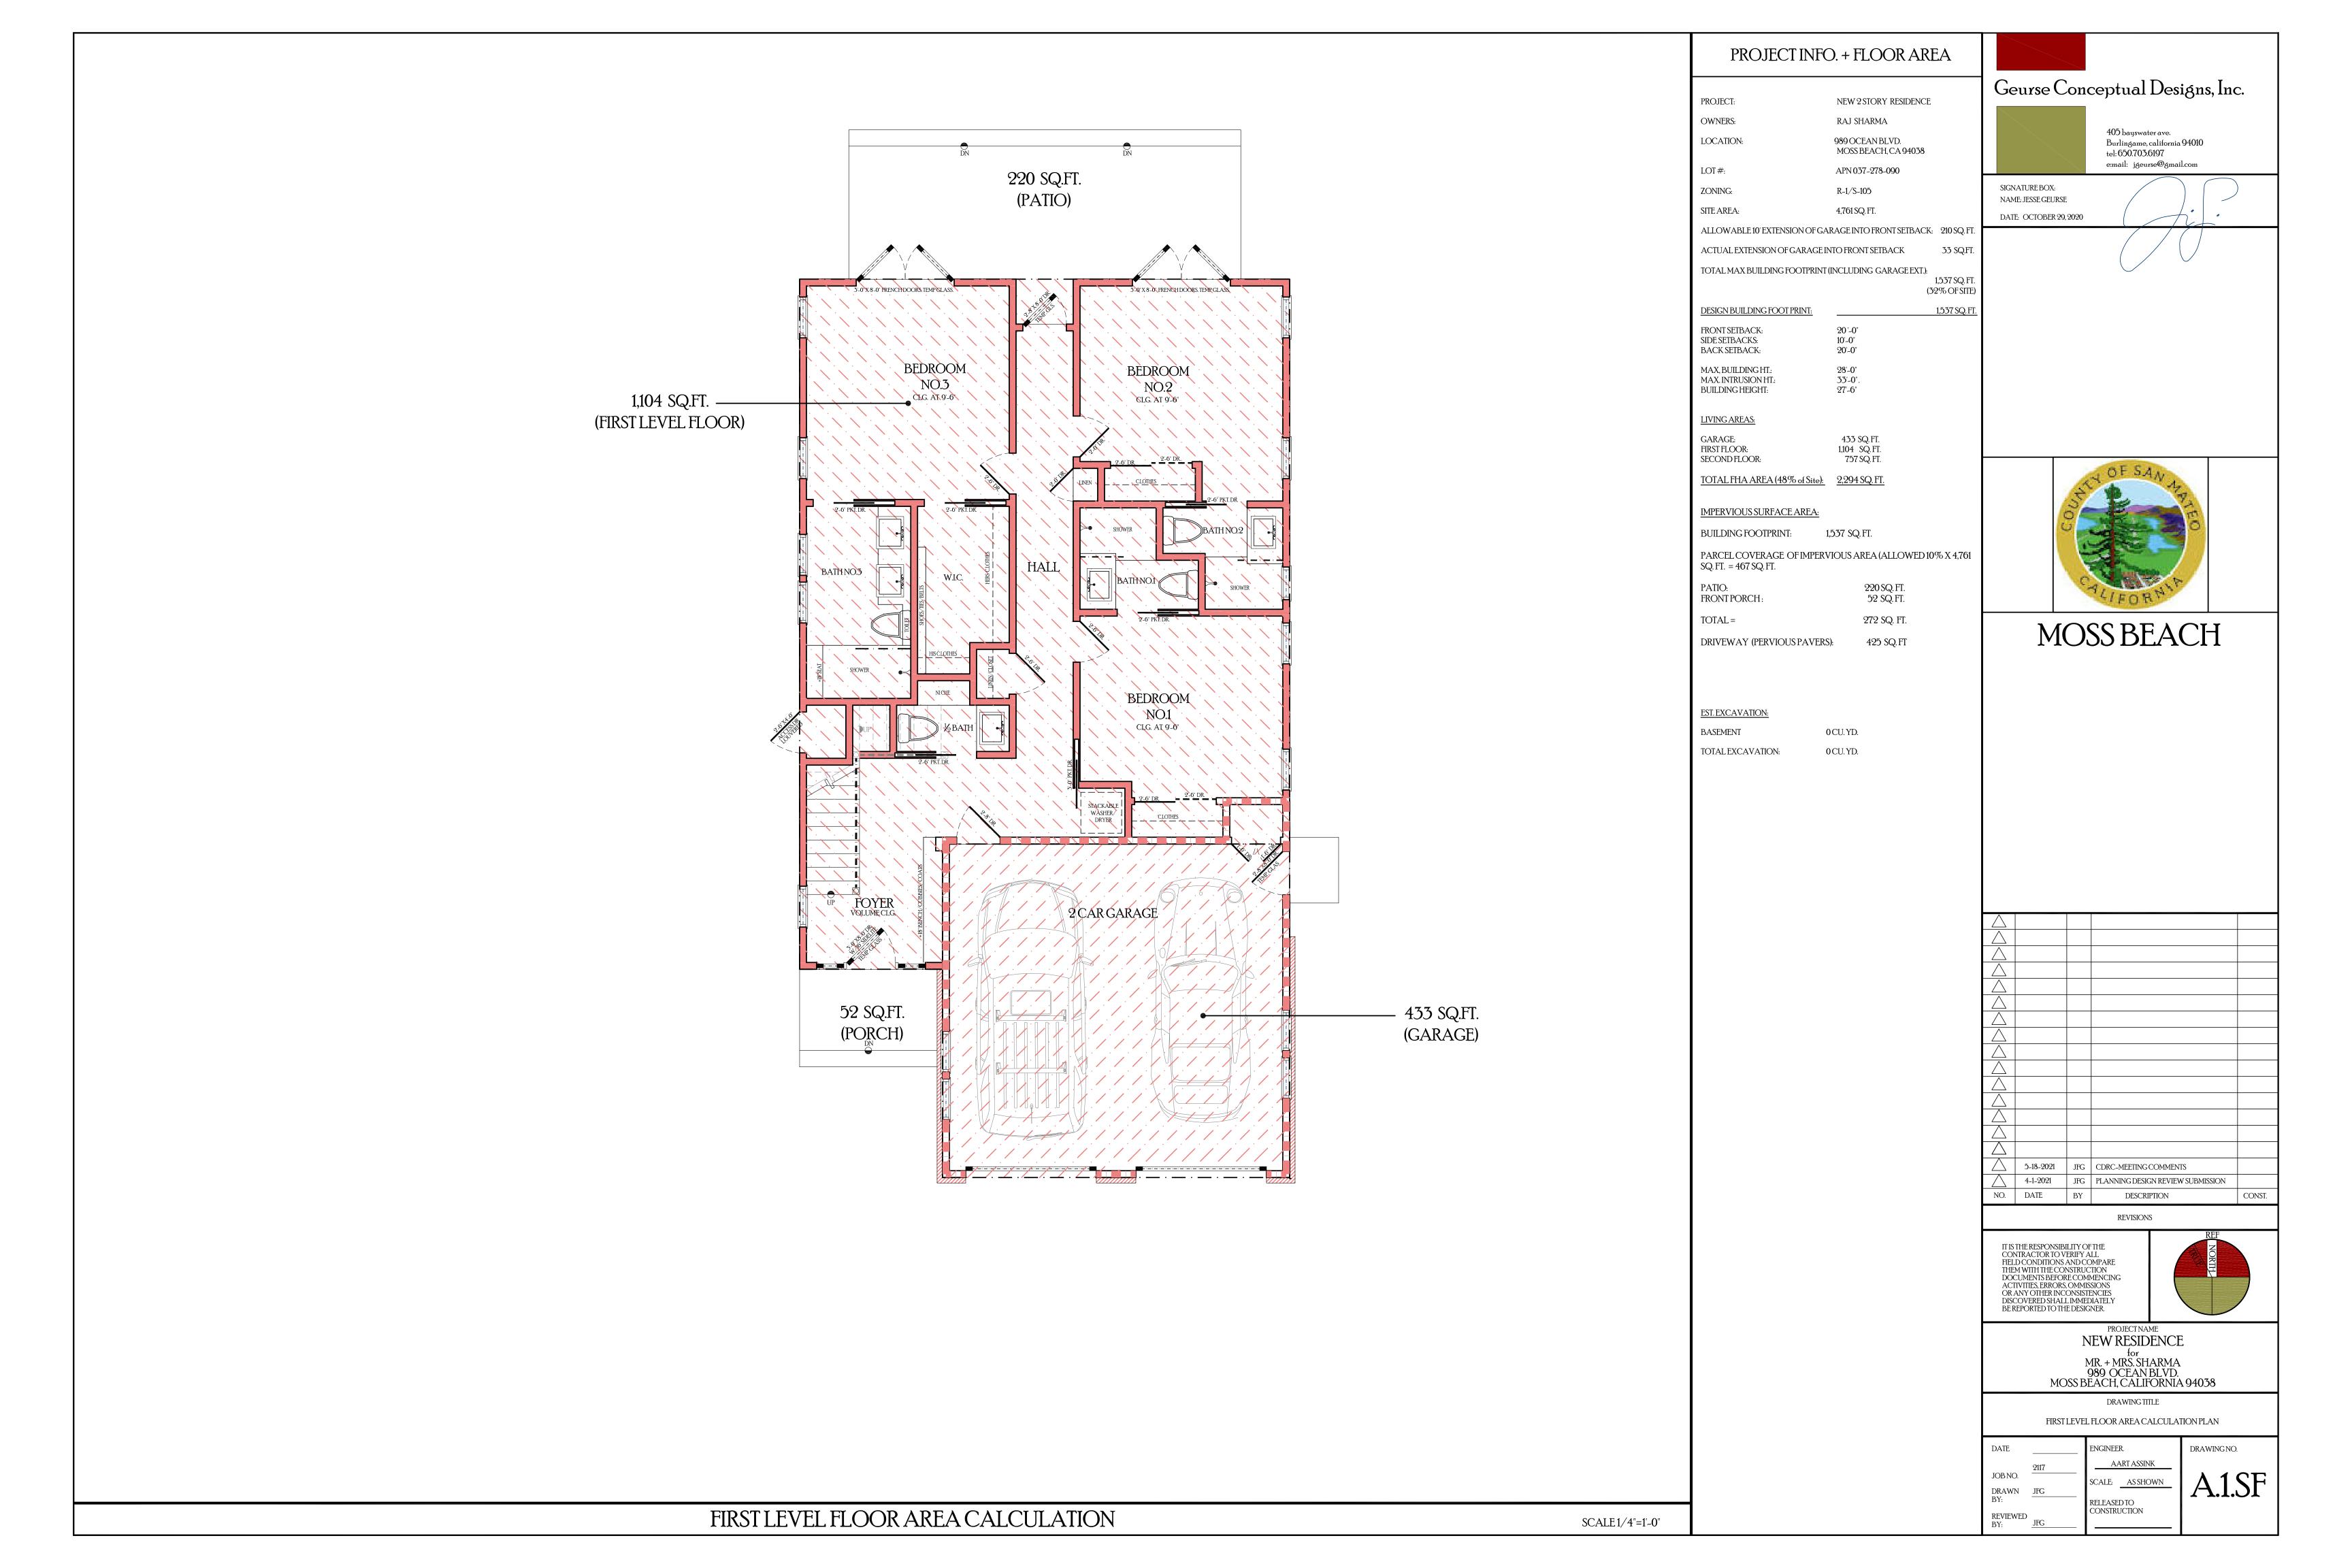

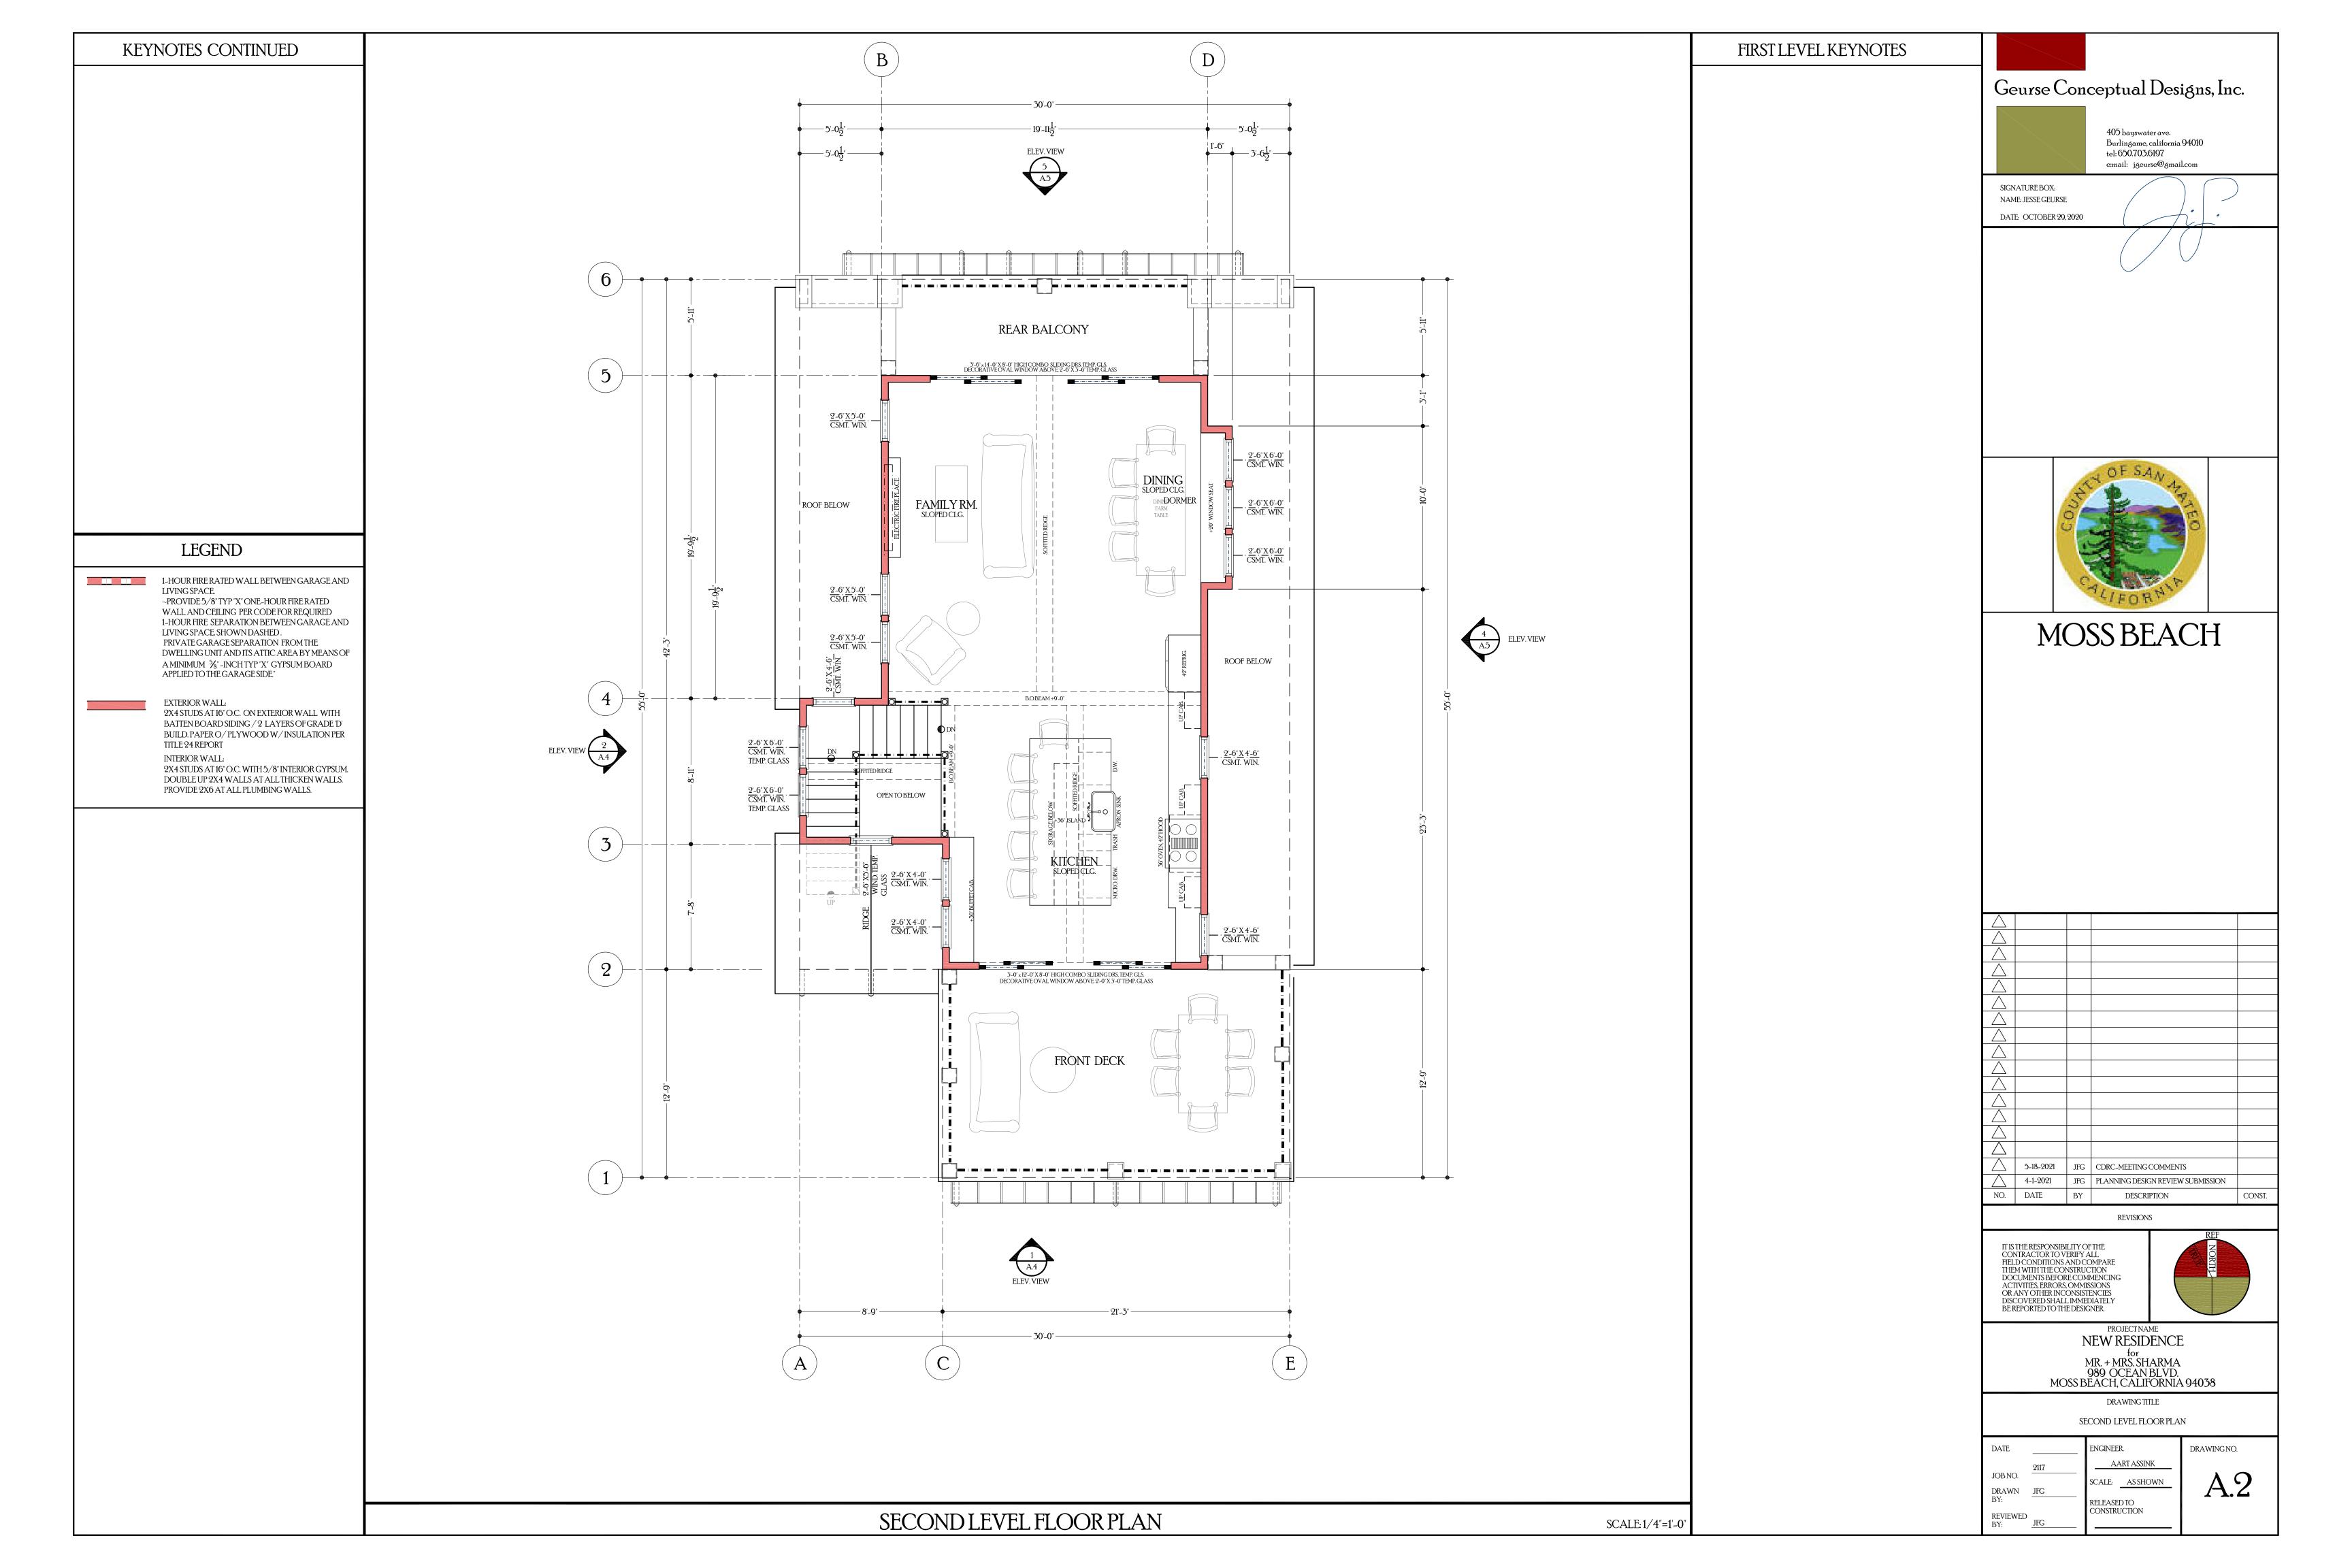

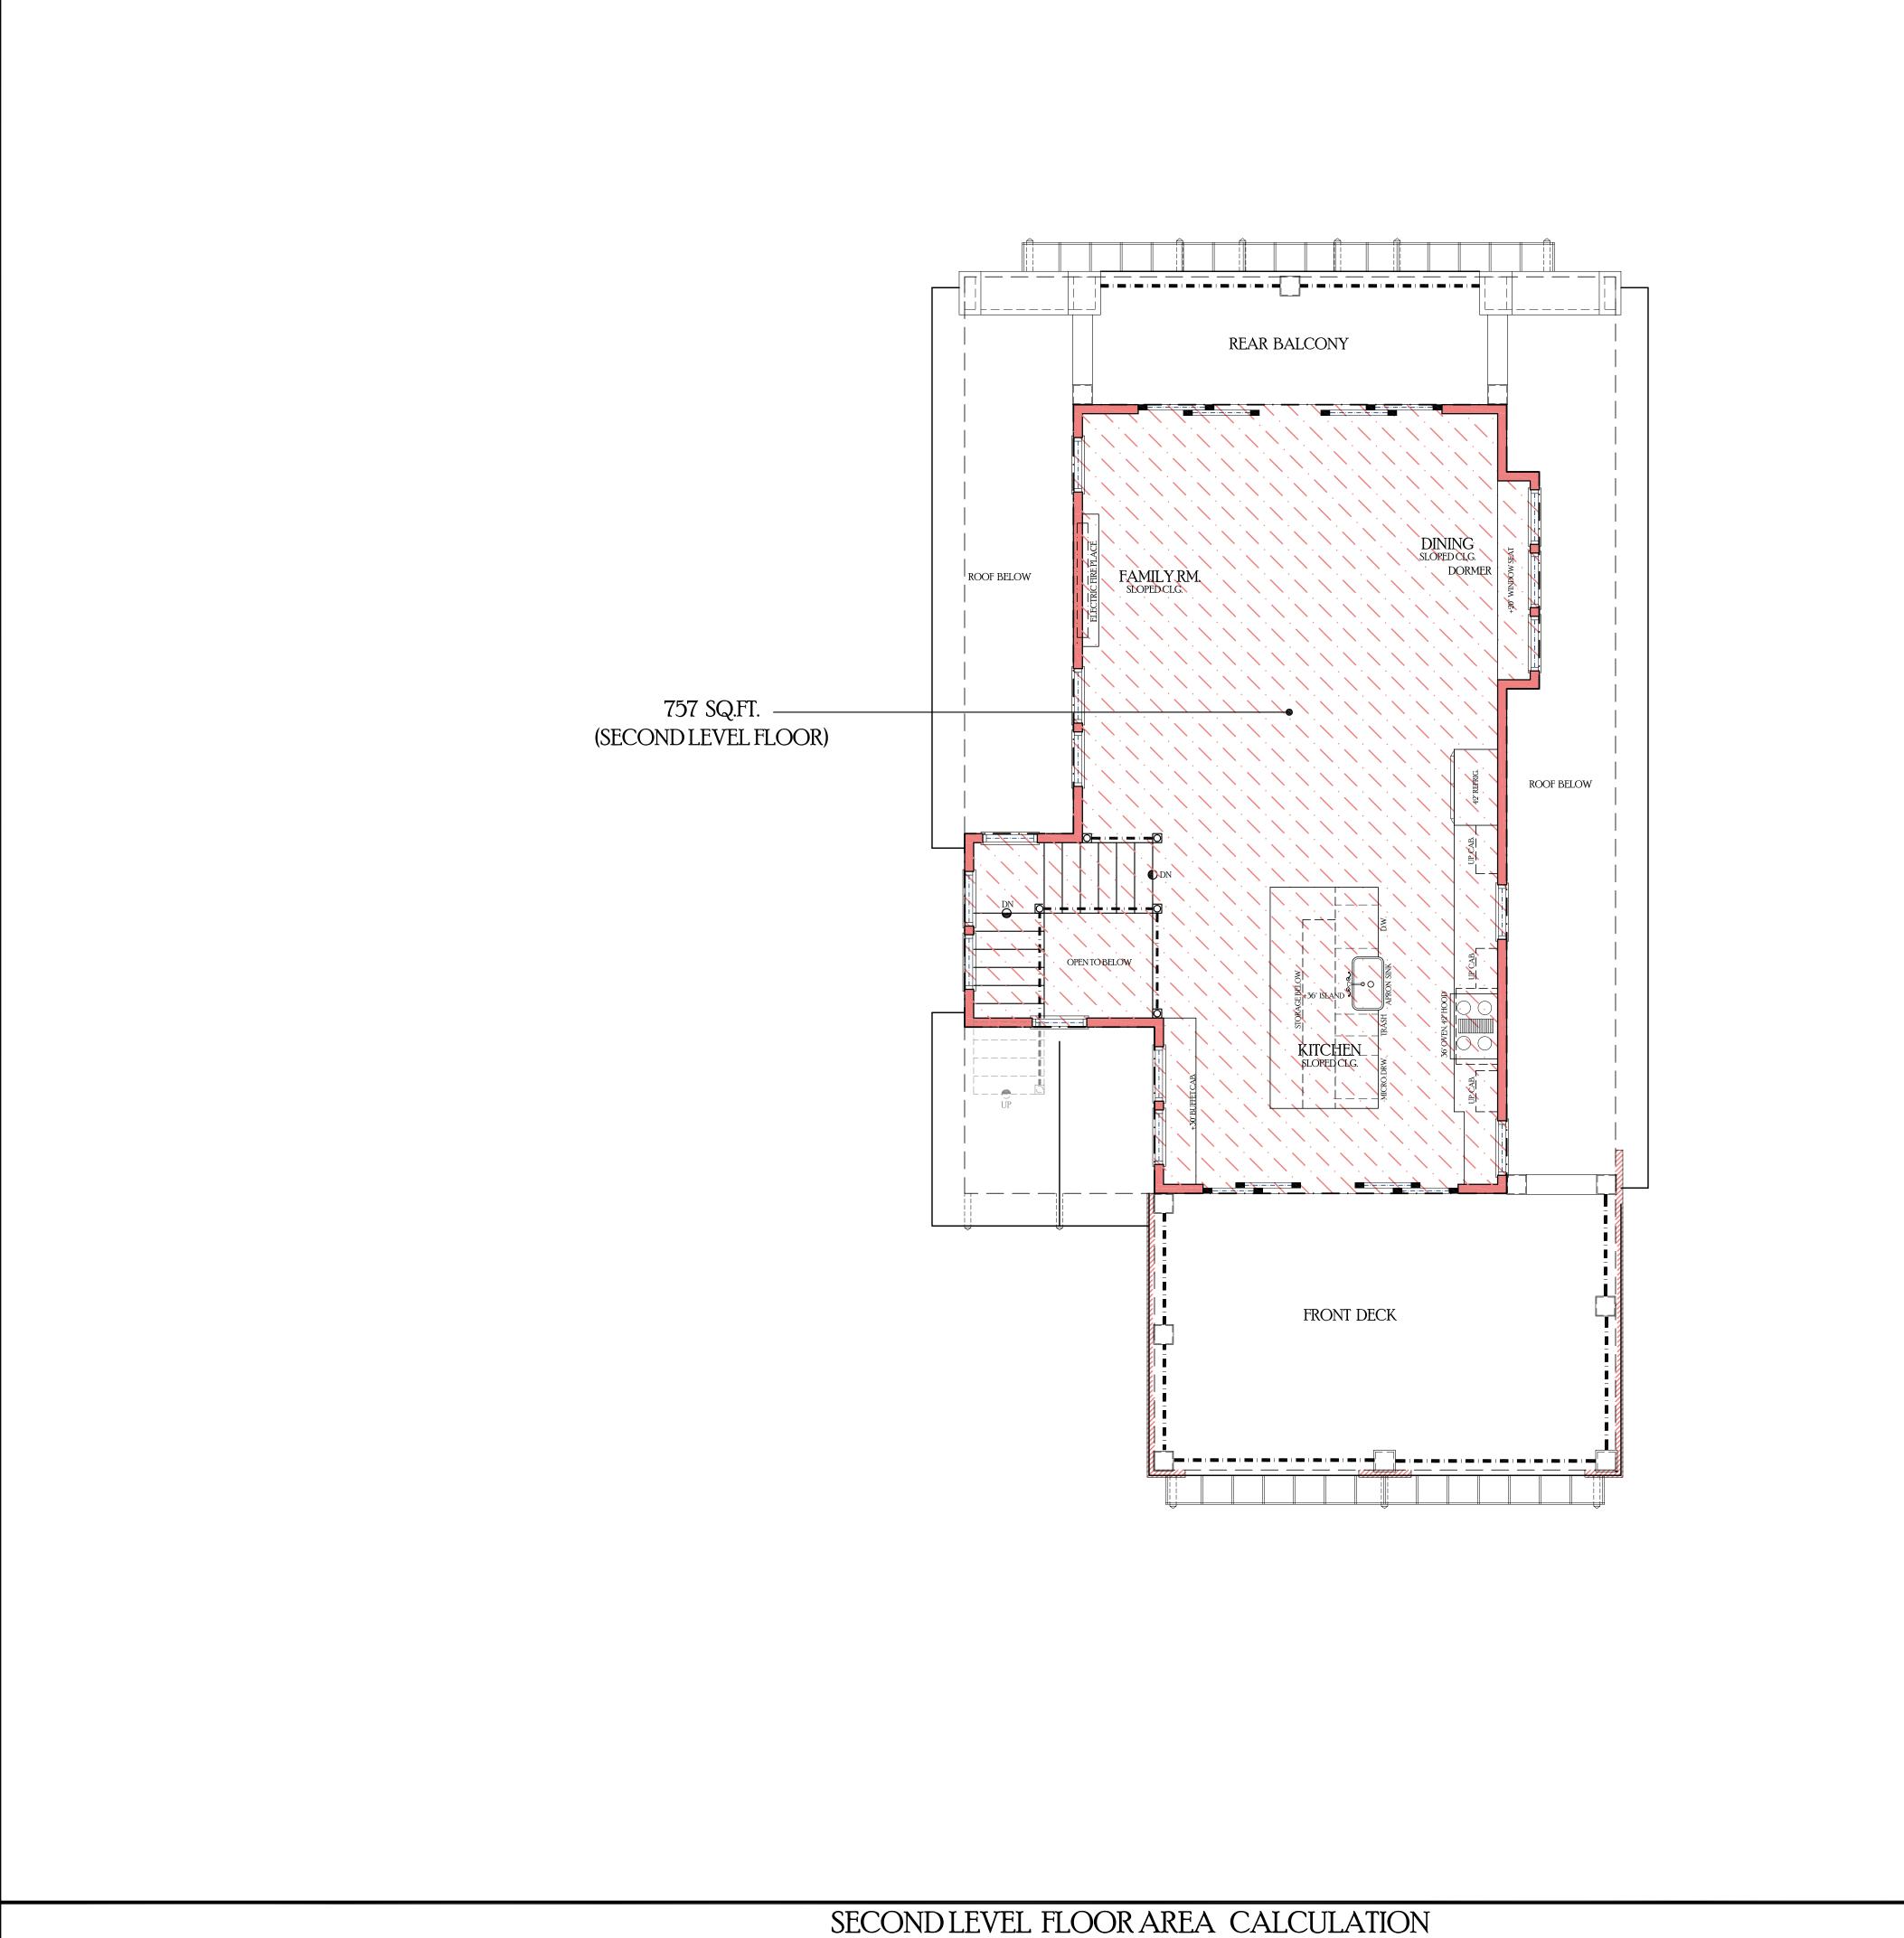

PROJECT INFO. + FLOOR AREA

PROJECT: NEW 2 STORY RESIDENCE OWNERS: RAJ SHARMA 989 OCEAN BLVD. MOSS BEACH, CA 94038 LOCATION:

LOT#: APN 037-278-090 ZONING: R-1/S-105 SITE AREA: 4,761 SQ. FT.

ALLOWABLE 10' EXTENSION OF GARAGE INTO FRONT SETBACK: 210 SQ. FT. ACTUAL EXTENSION OF GARAGE INTO FRONT SETBACK TOTAL MAX BUILDING FOOTPRINT (INCLUDING GARAGE EXT.):

1,537 SQ. FT. (32% OF SITE)

27'-6"

DESIGN BUILDING FOOT PRINT: FRONT SETBACK: SIDE SETBACKS: 20'-0" 10'-0" BACK SETBACK: 20'-0" 28'-0" 33'-0". MAX, BUILDING HT.: MAX. INTRUSION HT.:

LIVING AREAS:

BUILDING HEIGHT:

GARAGE: FIRST FLOOR: 433 SQ.FT. 1,104 SQ.FT. SECOND FLOOR: 757 SQ. FT.

<u>TOTAL FHA AREA (48% of Site):</u> 2,294 SQ. FT.

IMPERVIOUS SURFACE AREA:

BUILDING FOOTPRINT: 1,537 SQ.FT.

PARCEL COVERAGE OF IMPERVIOUS AREA (ALLOWED 10% X 4,761

PATIO: 220 SQ. FT. 52 SQ. FT. FRONT PORCH: TOTAL = 272 SQ. FT. DRIVEWAY (PERVIOUS PAVERS): 425 SQ.FT

EST. EXCAVATION:

BASEMENT OCU. YD. TOTAL EXCAVATION:

Geurse Conceptual Designs, Inc.



405 bayswater ave. Burlingame, california 94010 tel: 650.703.6197 e:mail: jgeurse@gmail.com

SIGNATURE BOX: NAME: JESSE GEURSE DATE: OCTOBER 29, 2020






MOSS BEACH

\triangle				
\triangle				
\triangle	5-18-2021	JFG	CDRC-MEETING COMMENTS	
	4-1-2021	JFG	PLANNING DESIGN REVIEW SUBMISSION	
NO.	DATE	BY	DESCRIPTION	CONST.
REVISIONS				

IT IS THE RESPONSIBILITY OF THE CONTRACTOR TO VERIFY ALL FIELD CONDITIONS AND COMPARE THEM WITH THE CONSTRUCTION DOCUMENTS BEFORE COMMENCING ACTIVITIES, ERRORS, OMMISSIONS OR ANY OTHER INCONSISTENCIES DISCOVERED SHALL IMMEDIATELY BE REPORTED TO THE DESIGNER.

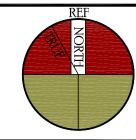


PROJECT NAME
NEW RESIDENCE for MR. + MRS. SHARMA 989 OCEAN BLVD. MOSS BEACH, CALIFORNIA 94038


DRAWING TITLE SECOND LEVEL FLOOR AREA CALCULATION PLAN


JOB NO. DRAWN BY:

REVIEWED BY:

DRAWING NO. SCALE: AS SHOWN CONSTRUCTION

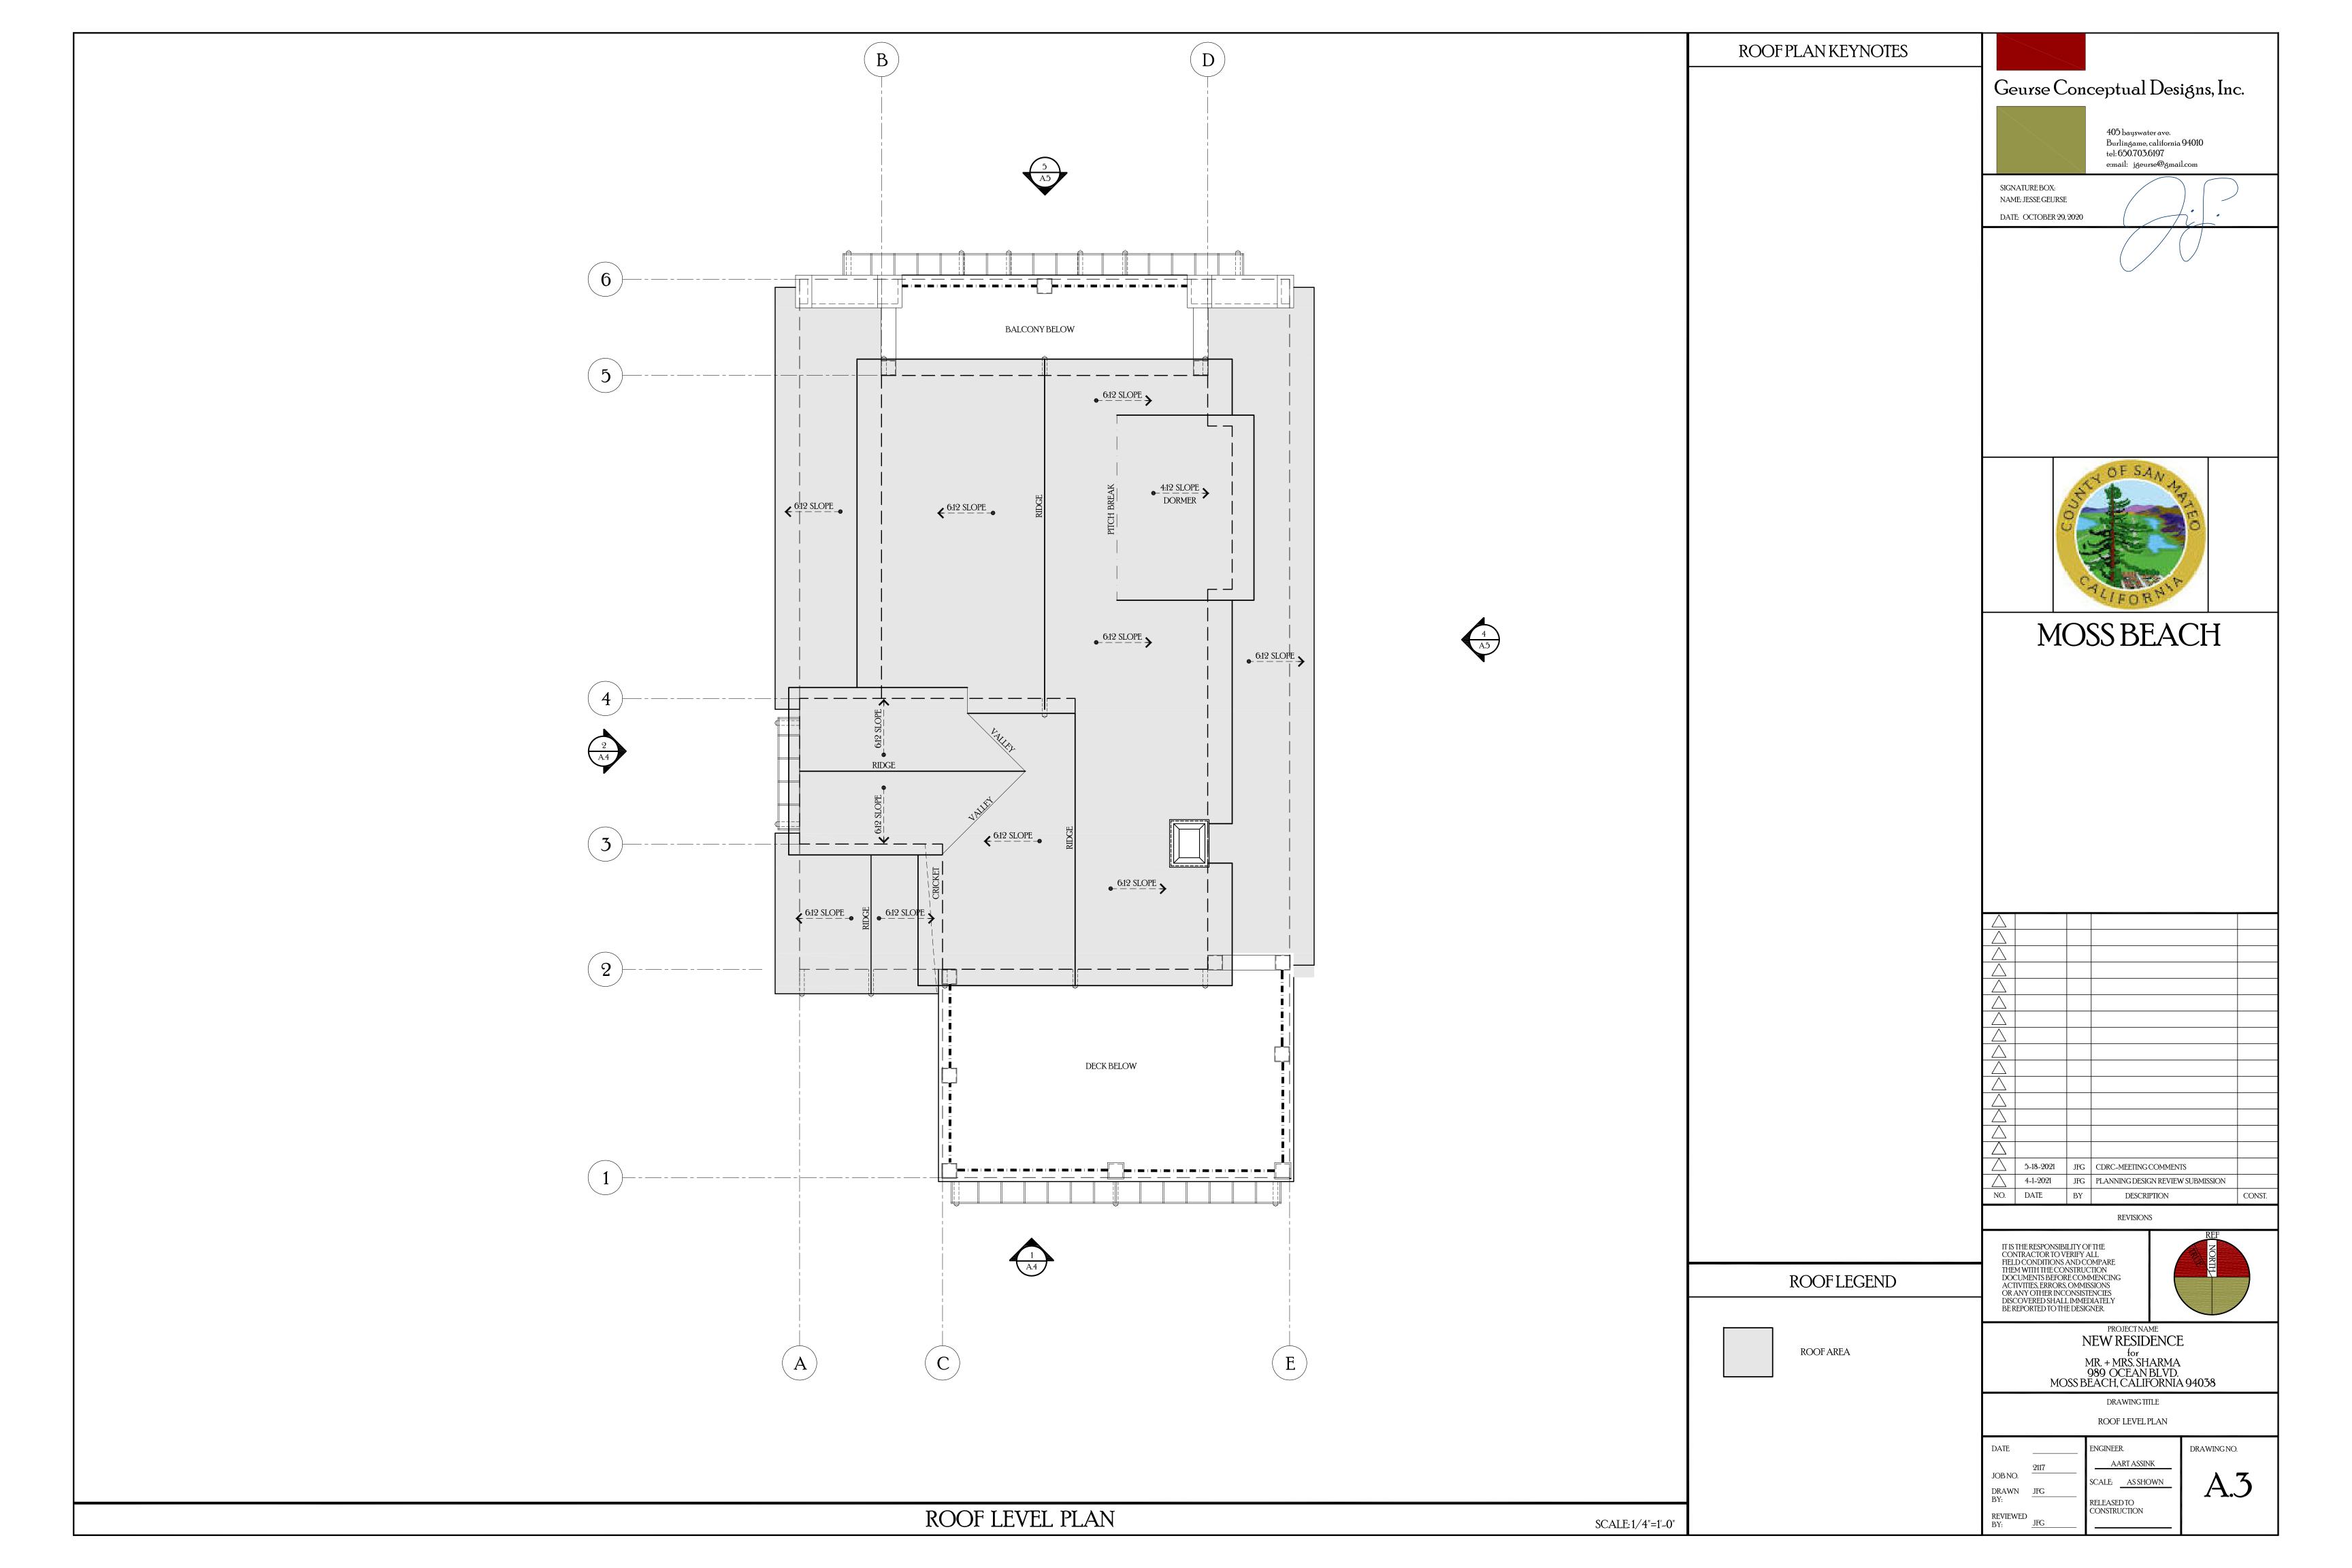

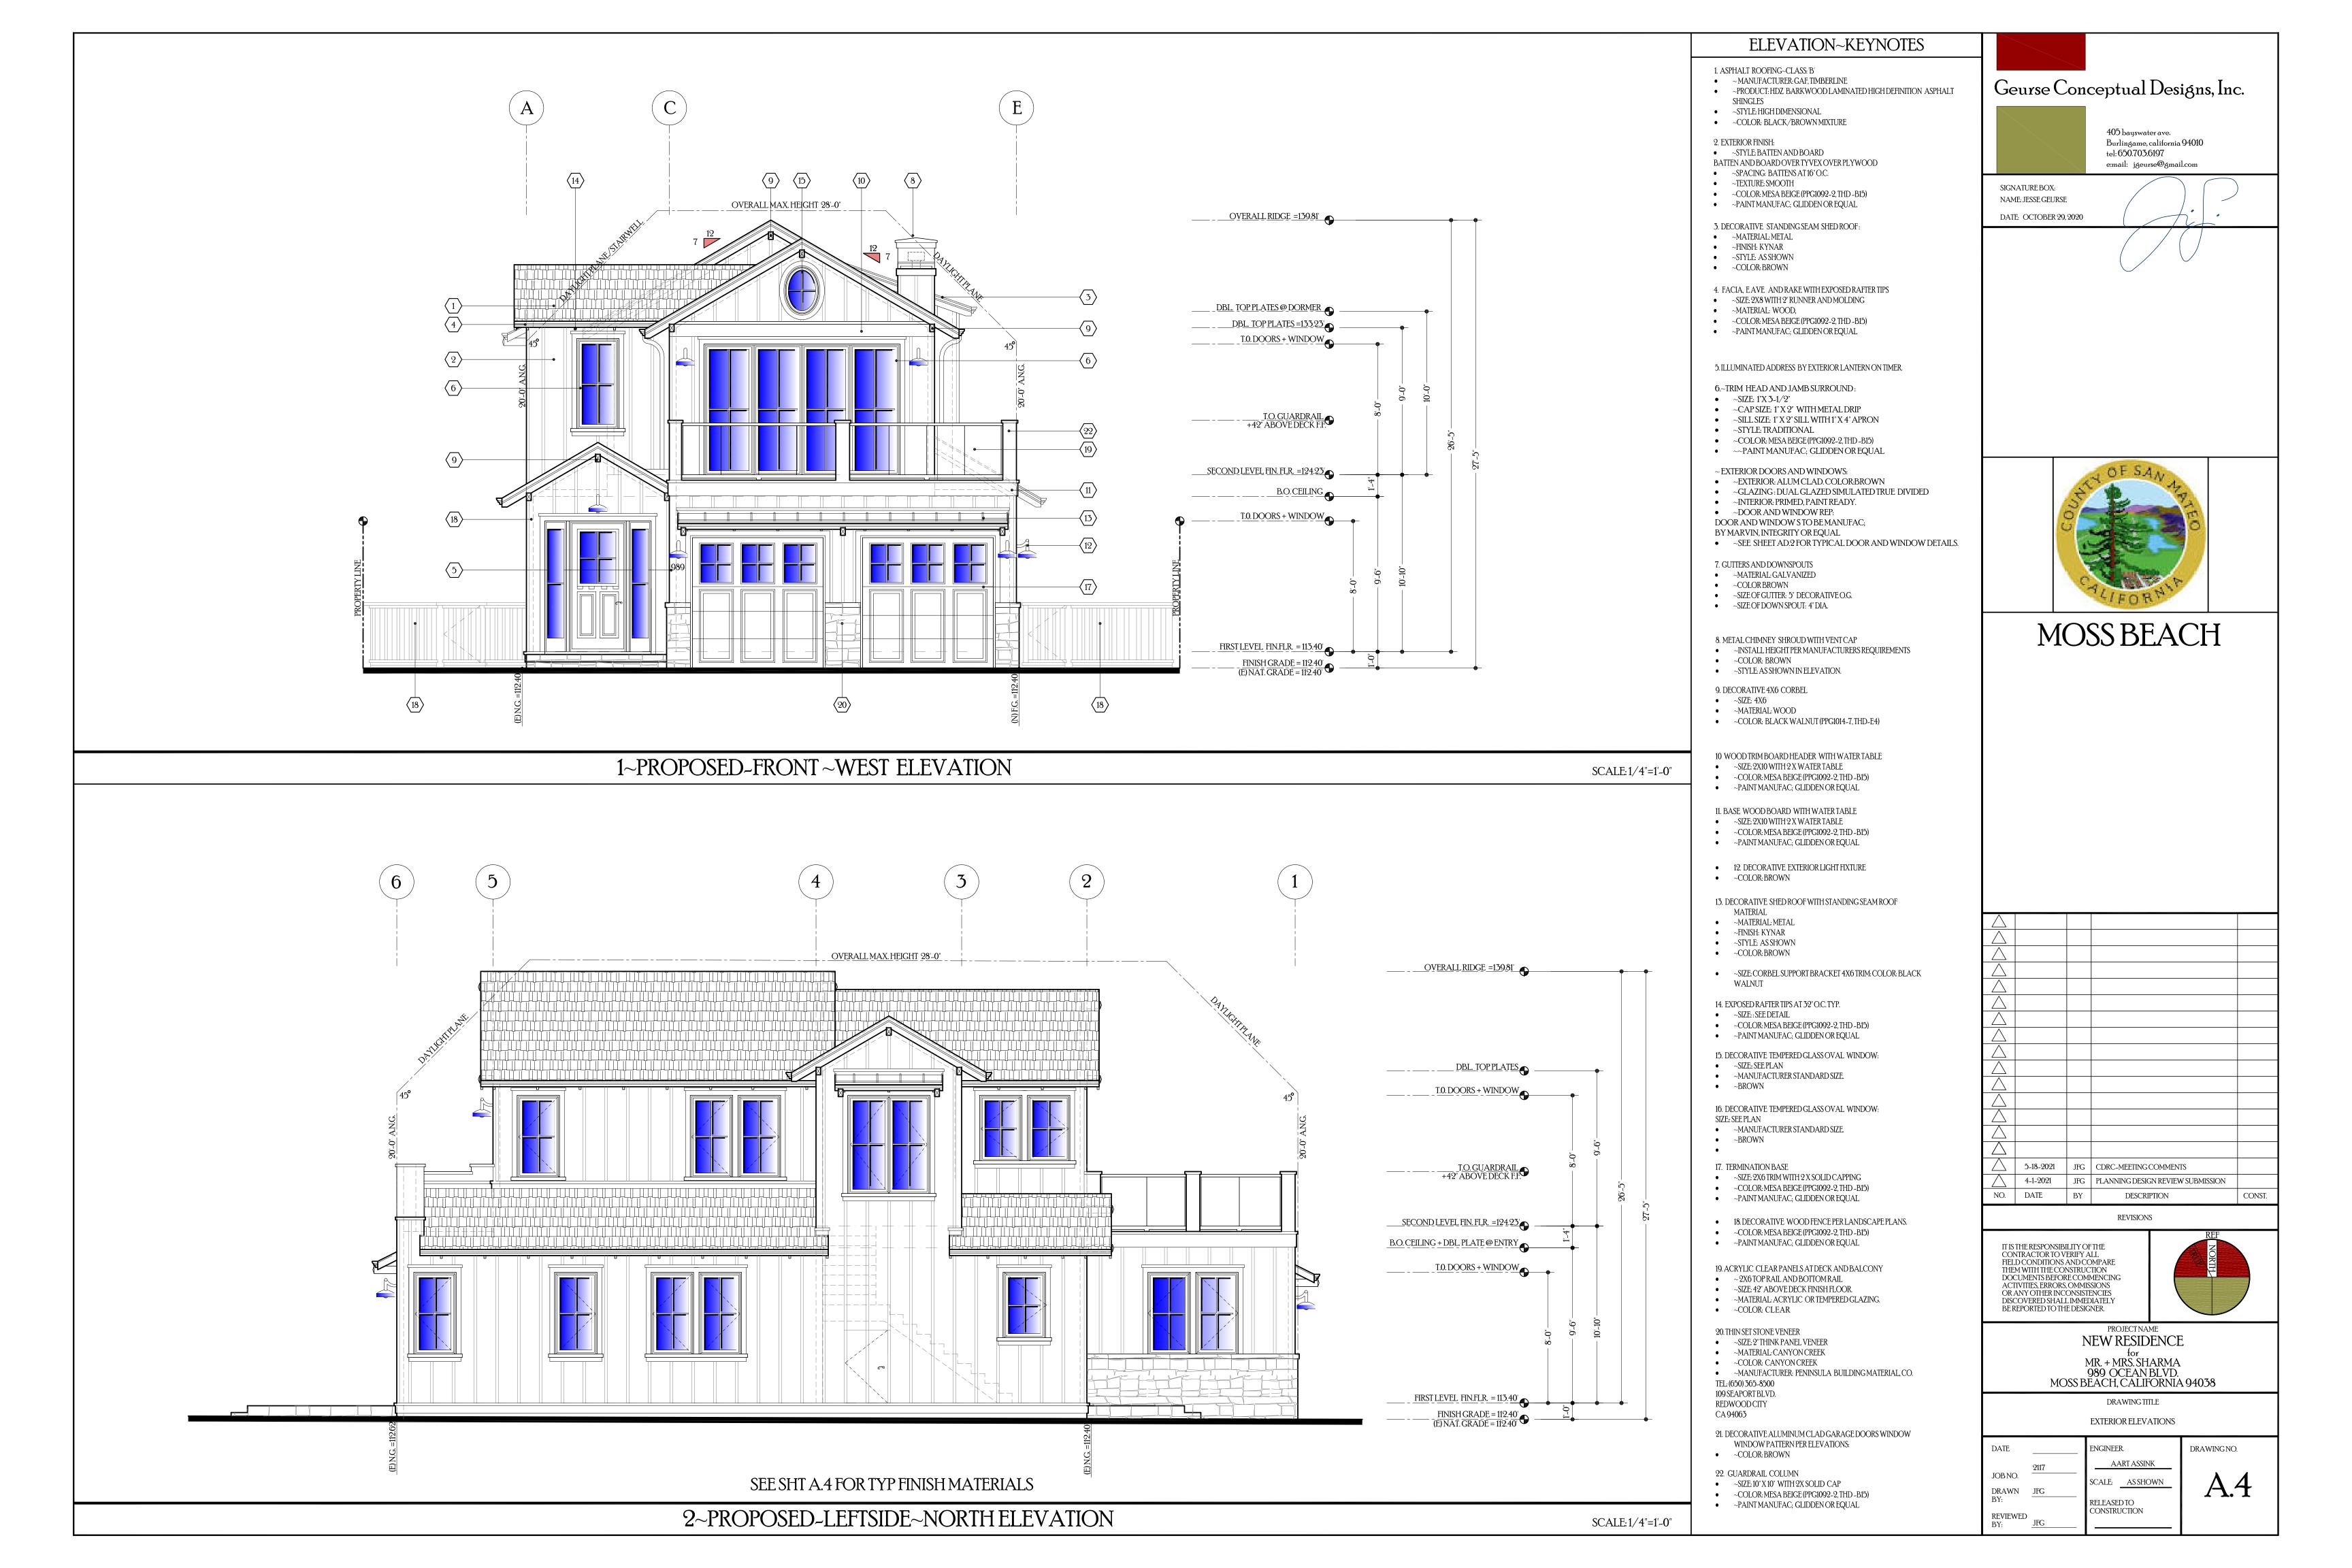

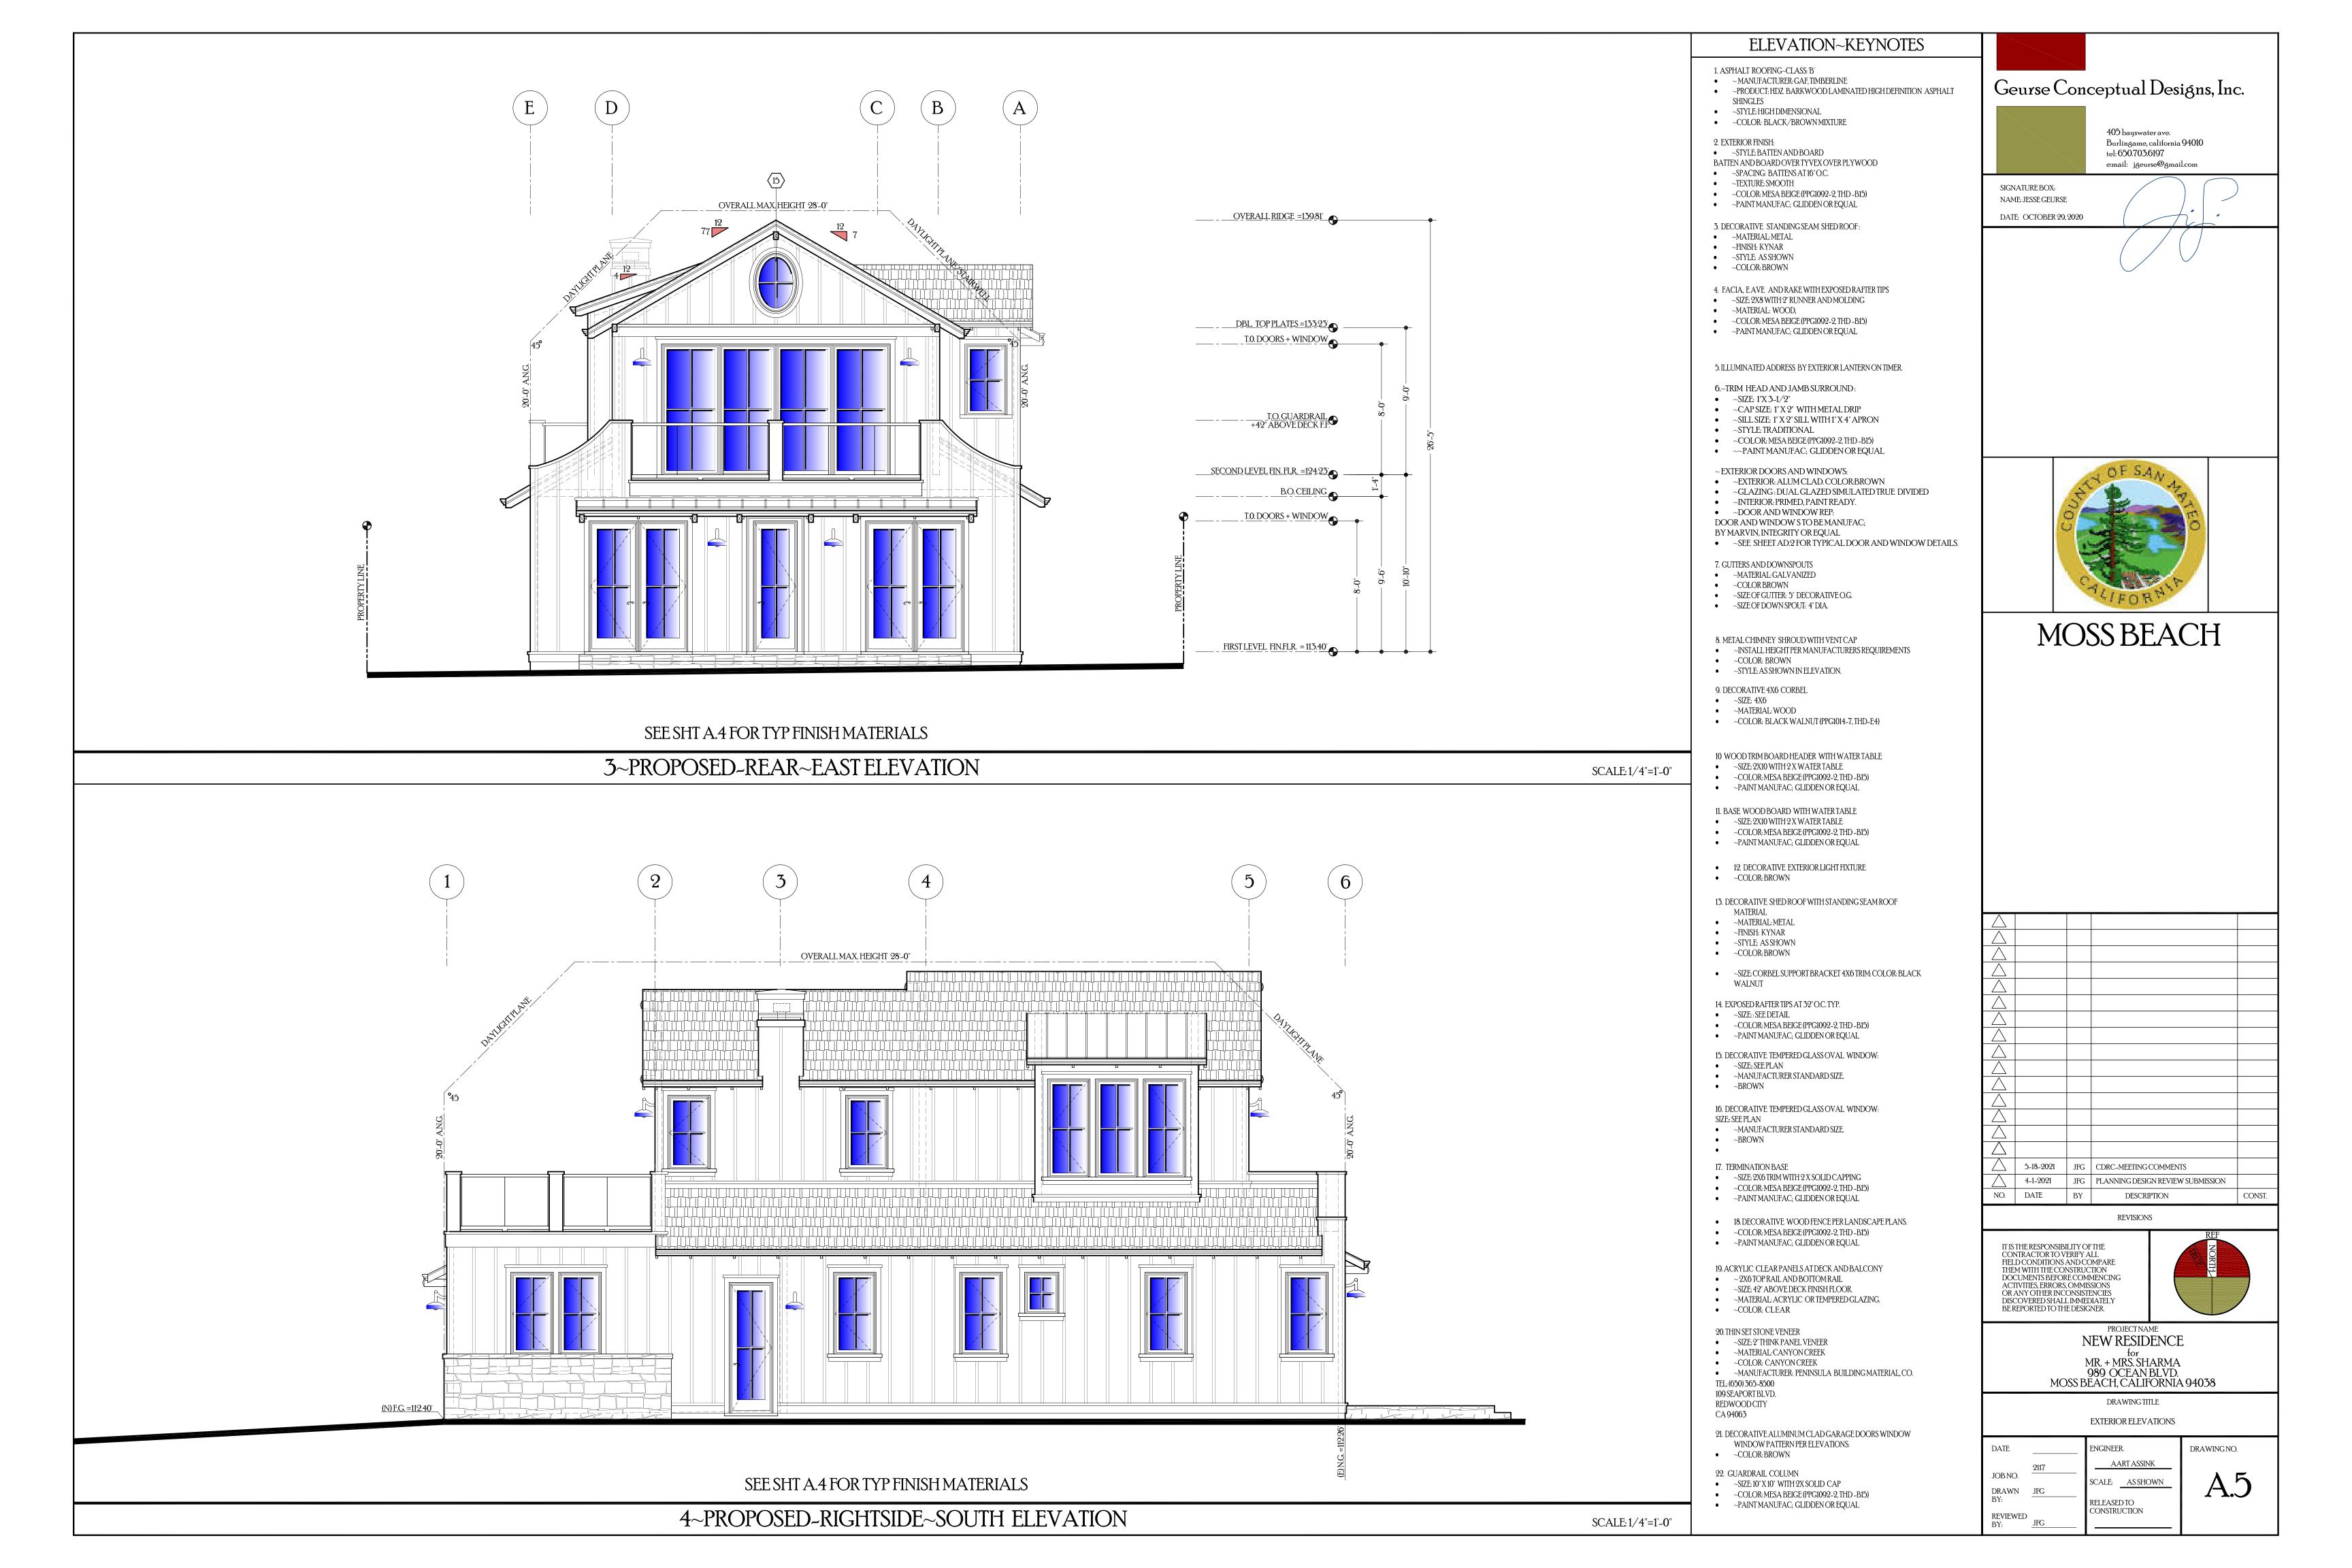



PROPOSED_FRONT_LEFTSIDE_BIRDS EYE



ELEVATION~KEYNOTES

1. ASPHALT ROOFING~CLASS: 'B'

• ~MANUFACTURER: GAF, TIMBERLINE • ~PRODUCT: HDZ BARKWOOD LAMINATED HIGH DEFINITION ASPHALT SHINGLES

• ~STYLE: HIGH DIMENSIONAL

• ~COLOR: BLACK/BROWN MIXTURE

2. EXTERIOR FINISH: • ~STYLE: BATTEN AND BOARD

BATTEN AND BOARD OVER TYVEX OVER PLYWOOD

 ~SPACING: BATTENS AT 16" O.C. ~TEXTURE: SMOOTH

 ~COLOR: MESA BEIGE (PPG1092-2, THD -B15) • ~PAINT MANUFAC; GLIDDEN OR EQUAL

3. DECORATIVE STANDING SEAM SHED ROOF:

• ~MATERIAL: METAL

• ~FINISH: KYNAR • ~STYLE: AS SHOWN • ~COLOR: BROWN

4. FACIA, E AVE AND RAKE WITH EXPOSED RAFTER TIPS

 ~SIZE: 2X8 WITH 2" RUNNER AND MOLDING • ~MATERIAL: WOOD,

 ~COLOR: MESA BEIGE (PPG1092-2, THD -B15) ~PAINT MANUFAC; GLIDDEN OR EQUAL

5. ILLUMINATED ADDRESS BY EXTERIOR LANTERN ON TIMER.

6.~TRIM HEAD AND JAMB SURROUND:

~SIZE: 1"X 3-1/2"~CAP SIZE: 1" X 2" WITH METAL DRIP

• ~SILL SIZE: 1" X 2" SILL WITH 1" X 4" APRON • ~STYLE: TRADITIONAL

 ~COLOR: MESA BEIGE (PPG1092-2, THD -B15) • ~PAINT MANUFAC; GLIDDEN OR EQUAL

~ EXTERIOR DOORS AND WINDOWS: • ~EXTERIOR: ALUM CLAD. COLOR:BROWN

~GLAZING: DUAL GLAZED SIMULATED TRUE DIVIDED

 ~INTERIOR: PRIMED, PAINT READY. • ~DOOR AND WINDOW REP:

DOOR AND WINDOW S TO BE MANUFAC; BY MARVIN, INTEGRITY OR EQUAL

~SEE SHEET AD.2 FOR TYPICAL DOOR AND WINDOW DETAILS.

7. GUTTERS AND DOWNSPOUTS

• ~MATERIAL: GALVANIZED ~COLOR BROWN

• ~SIZE OF GUTTER: 5" DECORATIVE O.G. ~SIZE OF DOWN SPOUT: 4" DIA.

8. METAL CHIMNEY SHROUD WITH VENT CAP

• ~INSTALL HEIGHT PER MANUFACTURERS REQUIREMENTS

~COLOR: BROWN~STYLE: AS SHOWN IN ELEVATION.

9. DECORATIVE 4X6 CORBEL ~SIZE: 4X6

SCALE: NOT TO SCALE

• ~MATERIAL: WOOD • ~COLOR: BLACK WALNUT (PPG1014-7, THD-E4)

10 WOOD TRIM BOARD HEADER WITH WATER TABLE

• ~SIZE: 2X10 WITH 2 X WATER TABLE ~COLOR: MESA BEIGE (PPG1092-2, THD -B15)

11. BASE WOOD BOARD WITH WATER TABLE

~PAINT MANUFAC; GLIDDEN OR EQUAL

~SIZE: 2X10 WITH 2 X WATER TABLE

 ~COLOR: MESA BEIGE (PPG1092-2, THD -B15) ~PAINT MANUFAC; GLIDDEN OR EQUAL

• 12. DECORATIVE EXTERIOR LIGHT FIXTURE ~COLOR: BROWN

13. DECORATIVE SHED ROOF WITH STANDING SEAM ROOF

MATERIAL

• ~MATERIAL: METAL ~FINISH: KYNAR

• ~STYLE: AS SHOWN • ~COLOR: BROWN

 ~SIZE: CORBEL SUPPORT BRACKET 4X6 TRIM: COLOR: BLACK WALNUT

14. EXPOSED RAFTER TIPS AT 32" O.C. TYP.

~SIZE::SEE DETAIL

 ~COLOR: MESA BEIGE (PPG1092-2, THD -B15) ~PAINT MANUFAC; GLIDDEN OR EQUAL

15. DECORATIVE TEMPERED GLASS OVAL WINDOW:

 ~SIZE:: SEE PLAN ~MANUFACTURER STANDARD SIZE.

• ~BROWN

16. DECORATIVE TEMPERED GLASS OVAL WINDOW: SIZE:: SEE PLAN

 ~MANUFACTURER STANDARD SIZE. ~BROWN

17. TERMINATION BASE

 ~SIZE: 2X6 TRIM WITH 2 X SOLID CAPPING ~COLOR: MESA BEIGE (PPG1092-2, THD -B15)

• ~PAINT MANUFAC; GLIDDEN OR EQUAL

• 18. DECORATIVE WOOD FENCE PER LANDSCAPE PLANS.

 ~COLOR: MESA BEIGE (PPG1092-2, THD -B15) ~PAINT MANUFAC; GLIDDEN OR EQUAL

19. ACRYLIC CLEAR PANELS AT DECK AND BALCONY

• $\sim 2X6$ TOP RAIL AND BOTTOM RAIL

 ~SIZE: 42" ABOVE DECK FINISH FLOOR. ~MATERIAL: ACRYLIC OR TEMPERED GLAZING. • ~COLOR: CLEAR

20. THIN SET STONE VENEER

• ~SIZE: 2" THINK PANEL VENEER

• ~MATERIAL: CANYON CREEK ~COLOR: CANYON CREEK

~MANUFACTURER: PENINSULA BUILDING MATERIAL, CO.

TEL: (650) 365-8500 109 SEAPORT BLVD. REDWOOD CITY CA 94063

> 21. DECORATIVE ALUMINUM CLAD GARAGE DOORS WINDOW WINDOW PATTERN PER ELEVATIONS:

• ~COLOR: BROWN

SCALE: NOT TO SCALE

22. GUARDRAIL COLUMN

• ~SIZE: 10" X 10" WITH 2X SOLID CAP ~COLOR: MESA BEIGE (PPG1092-2, THD -B15) • ~PAINT MANUFAC; GLIDDEN OR EQUAL

Geurse Conceptual Designs, Inc.



DATE: OCTOBER 29, 2020


405 bayswater ave. Burlingame, california 94010 tel: 650.703.6197 e:mail: jgeurse@gmail.com

SIGNATURE BOX: NAME: JESSE GEURSE





MOSS BEACH

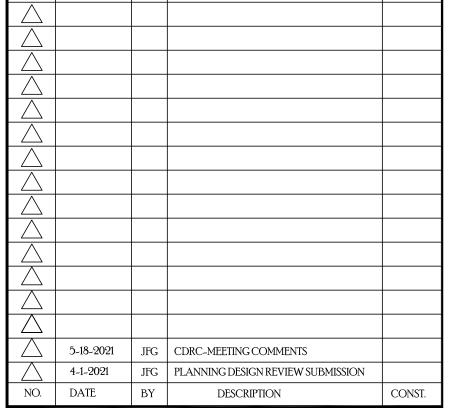


REVISIONS

IT IS THE RESPONSIBILITY OF THE CONTRACTOR TO VERIFY ALL FIELD CONDITIONS AND COMPARE THEM WITH THE CONSTRUCTION DOCUMENTS BEFORE COMMENCING
ACTIVITIES, ERRORS, OMMISSIONS
OR ANY OTHER INCONSISTENCIES
DISCOVERED SHALL IMMEDIATELY
BE REPORTED TO THE DESIGNER.

JOB NO.

REVIEWED

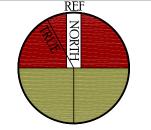

NEW RESIDENCE for MR. + MRS. SHARMA 989 OCEAN BLVD. MOSS BEACH, CALIFORNIA 94038

> DRAWING TITLE EXTERIOR 3D RENDERING

ENGINEER. DRAWING NO. AART ASSINK

SCALE: AS SHOWN DRAWN JFG RELEASED TO CONSTRUCTION

PROPOSED_FRONT_LEFTSIDE



PROPOSED_REAR~RIGHTSIDE



PROPOSED-FRONT-RIGHTSIDE

109 SEAPORT BLVD.

REDWOOD CITY CA 94063

• ~MATERIAL: CANYON CREEK

 ~COLOR: CANYON CREEK TEL: (650) 365-8500

• ~COLOR: BROWN

• ~SIZE: 10" X 10" WITH 2X SOLID CAP • ~COLOR: MESA BEIGE (PPG1092-2, THD -B15)

ELEVATION~KEYNOTES

1. ASPHALT ROOFING~CLASS: 'B'

• ~MANUFACTURER: GAF, TIMBERLINE • ~PRODUCT: HDZ BARKWOOD LAMINATED HIGH DEFINITION ASPHALT SHINGLES

• ~STYLE: HIGH DIMENSIONAL • ~COLOR: BLACK/BROWN MIXTURE

2. EXTERIOR FINISH: • ~STYLE: BATTEN AND BOARD

BATTEN AND BOARD OVER TYVEX OVER PLYWOOD ~SPACING: BATTENS AT 16" O.C. ~TEXTURE: SMOOTH ~COLOR: MESA BEIGE (PPG1092-2, THD -B15)

• ~PAINT MANUFAC; GLIDDEN OR EQUAL

3. DECORATIVE STANDING SEAM SHED ROOF:

• ~MATERIAL: METAL • ~FINISH: KYNAR • ~STYLE: AS SHOWN

• ~COLOR: BROWN 4. FACIA, EAVE AND RAKE WITH EXPOSED RAFTER TIPS

• ~SIZE: 2X8 WITH 2" RUNNER AND MOLDING • ~MATERIAL: WOOD,

 ~COLOR: MESA BEIGE (PPG1092-2, THD -B15) ~PAINT MANUFAC; GLIDDEN OR EQUAL

5. ILLUMINATED ADDRESS BY EXTERIOR LANTERN ON TIMER.

6.~TRIM HEAD AND JAMB SURROUND:

~SIZE: 1"X 3-1/2"~CAP SIZE: 1" X 2" WITH METAL DRIP • ~SILL SIZE: 1" X 2" SILL WITH 1" X 4" APRON

• ~STYLE: TRADITIONAL ~COLOR: MESA BEIGE (PPG1092-2, THD -B15) • ~PAINT MANUFAC; GLIDDEN OR EQUAL

~ EXTERIOR DOORS AND WINDOWS: • ~EXTERIOR: ALUM CLAD. COLOR:BROWN

~GLAZING: DUAL GLAZED SIMULATED TRUE DIVIDED

 ~INTERIOR: PRIMED, PAINT READY. ~DOOR AND WINDOW REP: DOOR AND WINDOW S TO BE MANUFAC;

BY MARVIN, INTEGRITY OR EQUAL ~SEE SHEET AD.2 FOR TYPICAL DOOR AND WINDOW DETAILS.

7. GUTTERS AND DOWNSPOUTS • ~MATERIAL: GALVANIZED

~COLOR BROWN

• ~SIZE OF GUTTER: 5" DECORATIVE O.G. • ~SIZE OF DOWN SPOUT: 4" DIA.

8. METAL CHIMNEY SHROUD WITH VENT CAP • ~INSTALL HEIGHT PER MANUFACTURERS REQUIREMENTS

~COLOR: BROWN~STYLE: AS SHOWN IN ELEVATION.

9. DECORATIVE 4X6 CORBEL ~SIZE: 4X6

SCALE: 1/4"=1'-0"

• ~MATERIAL: WOOD • ~COLOR: BLACK WALNUT (PPG1014-7, THD-E4)

10 WOOD TRIM BOARD HEADER WITH WATER TABLE

• ~SIZE: 2X10 WITH 2 X WATER TABLE ~COLOR: MESA BEIGE (PPG1092-2, THD -B15)

11. BASE WOOD BOARD WITH WATER TABLE

~PAINT MANUFAC; GLIDDEN OR EQUAL

• ~SIZE: 2X10 WITH 2 X WATER TABLE

 ~COLOR: MESA BEIGE (PPG1092-2, THD -B15) ~PAINT MANUFAC; GLIDDEN OR EQUAL

• 12. DECORATIVE EXTERIOR LIGHT FIXTURE ~COLOR: BROWN

13. DECORATIVE SHED ROOF WITH STANDING SEAM ROOF

MATERIAL

• ~MATERIAL: METAL ~FINISH: KYNAR

• ~STYLE: AS SHOWN • ~COLOR: BROWN

 ~SIZE: CORBEL SUPPORT BRACKET 4X6 TRIM: COLOR: BLACK WALNUT

14. EXPOSED RAFTER TIPS AT 32" O.C. TYP.

 ~SIZE::SEE DETAIL ~COLOR: MESA BEIGE (PPG1092-2, THD -B15)

~PAINT MANUFAC; GLIDDEN OR EQUAL

15. DECORATIVE TEMPERED GLASS OVAL WINDOW: ~SIZE:: SEE PLAN

 ~MANUFACTURER STANDARD SIZE. • ~BROWN

16. DECORATIVE TEMPERED GLASS OVAL WINDOW: SIZE:: SEE PLAN

 ~MANUFACTURER STANDARD SIZE. ~BROWN

17. TERMINATION BASE

 ~SIZE: 2X6 TRIM WITH 2 X SOLID CAPPING ~COLOR: MESA BEIGE (PPG1092-2, THD -B15) • ~PAINT MANUFAC; GLIDDEN OR EQUAL

18. DECORATIVE WOOD FENCE PER LANDSCAPE PLANS.

~COLOR: MESA BEIGE (PPG1092-2, THD -B15)

~PAINT MANUFAC; GLIDDEN OR EQUAL

19. ACRYLIC CLEAR PANELS AT DECK AND BALCONY • \sim 2X6 TOP RAIL AND BOTTOM RAIL

~SIZE: 42" ABOVE DECK FINISH FLOOR.

 ~MATERIAL: ACRYLIC OR TEMPERED GLAZING. • ~COLOR: CLEAR

20. THIN SET STONE VENEER

• ~SIZE: 2" THINK PANEL VENEER

~MANUFACTURER: PENINSULA BUILDING MATERIAL, CO.

21. DECORATIVE ALUMINUM CLAD GARAGE DOORS WINDOW WINDOW PATTERN PER ELEVATIONS:

22. GUARDRAIL COLUMN

~PAINT MANUFAC; GLIDDEN OR EQUAL

Geurse Conceptual Designs, Inc.




SIGNATURE BOX:

405 bayswater ave. Burlingame, california 94010 tel: 650.703.6197 e:mail: jgeurse@gmail.com

NAME: JESSE GEURSE DATE: OCTOBER 29, 2020




MOSS BEACH

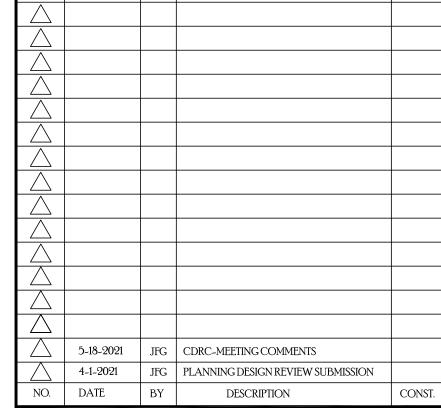

REVISIONS

IT IS THE RESPONSIBILITY OF THE CONTRACTOR TO VERIFY ALL FIELD CONDITIONS AND COMPARE THEM WITH THE CONSTRUCTION DOCUMENTS BEFORE COMMENCING
ACTIVITIES, ERRORS, OMMISSIONS
OR ANY OTHER INCONSISTENCIES
DISCOVERED SHALL IMMEDIATELY
BE REPORTED TO THE DESIGNER.

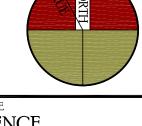

PROJECT NAME
NEW RESIDENCE for MR. + MRS. SHARMA 989 OCEAN BLVD. MOSS BEACH, CALIFORNIA 94038 **DRAWING TITLE**

EXTERIOR 3D RENDERING

ENGINEER. DRAWING NO. AART ASSINK SCALE: AS SHOWN DRAWN JFG RELEASED TO CONSTRUCTION

JOB NO.

REVIEWED

SCALE: 1/4"=1'-0"



PROPOSED-REAR SCALE: 1/4"=1'-0"



PROPOSED-REAR~LEFTSIDE SCALE: 1/4"=1'-0"

ELEVATION~KEYNOTES

1. ASPHALT ROOFING~CLASS: 'B'

• ~ MANUFACTURER: GAF, TIMBERLINE ~PRODUCT: HDZ BARKWOOD LAMINATED HIGH DEFINITION ASPHALT

SHINGLES • ~STYLE: HIGH DIMENSIONAL

• ~COLOR: BLACK/BROWN MIXTURE

2. EXTERIOR FINISH:

• ~STYLE: BATTEN AND BOARD BATTEN AND BOARD OVER TYVEX OVER PLYWOOD

 ~SPACING: BATTENS AT 16" O.C. ~TEXTURE: SMOOTH

 ~COLOR: MESA BEIGE (PPG1092-2, THD -B15) • ~PAINT MANUFAC; GLIDDEN OR EQUAL

3. DECORATIVE STANDING SEAM SHED ROOF:

• ~MATERIAL: METAL

~FINISH: KYNAR~STYLE: AS SHOWN • ~COLOR: BROWN

4. FACIA, EAVE AND RAKE WITH EXPOSED RAFTER TIPS

• ~SIZE: 2X8 WITH 2" RUNNER AND MOLDING • ~MATERIAL: WOOD,

 ~COLOR: MESA BEIGE (PPG1092-2, THD -B15) ~PAINT MANUFAC; GLIDDEN OR EQUAL

5. ILLUMINATED ADDRESS BY EXTERIOR LANTERN ON TIMER.

6.~TRIM HEAD AND JAMB SURROUND:

~SIZE: 1"X 3-1/2"~CAP SIZE: 1" X 2" WITH METAL DRIP • ~SILL SIZE: 1" X 2" SILL WITH 1" X 4" APRON

• ~STYLE: TRADITIONAL ~COLOR: MESA BEIGE (PPG1092-2, THD -B15)

• ~PAINT MANUFAC; GLIDDEN OR EQUAL

~ EXTERIOR DOORS AND WINDOWS:

• ~EXTERIOR: ALUM CLAD. COLOR:BROWN ~GLAZING: DUAL GLAZED SIMULATED TRUE DIVIDED

~INTERIOR: PRIMED, PAINT READY.

• ~DOOR AND WINDOW REP: DOOR AND WINDOW S TO BE MANUFAC;

BY MARVIN, INTEGRITY OR EQUAL ~SEE SHEET AD.2 FOR TYPICAL DOOR AND WINDOW DETAILS.

7. GUTTERS AND DOWNSPOUTS • ~MATERIAL: GALVANIZED

 ~COLOR BROWN • ~SIZE OF GUTTER: 5" DECORATIVE O.G.

• ~SIZE OF DOWN SPOUT: 4" DIA.

8. METAL CHIMNEY SHROUD WITH VENT CAP

• ~INSTALL HEIGHT PER MANUFACTURERS REQUIREMENTS

~COLOR: BROWN~STYLE: AS SHOWN IN ELEVATION.

9. DECORATIVE 4X6 CORBEL ~SIZE: 4X6

• ~MATERIAL: WOOD

• ~COLOR: BLACK WALNUT (PPG1014-7, THD-E4)

10 WOOD TRIM BOARD HEADER WITH WATER TABLE

• ~SIZE: 2X10 WITH 2 X WATER TABLE ~COLOR: MESA BEIGE (PPG1092-2, THD -B15)

~PAINT MANUFAC; GLIDDEN OR EQUAL

11. BASE WOOD BOARD WITH WATER TABLE

• ~SIZE: 2X10 WITH 2 X WATER TABLE

 ~COLOR: MESA BEIGE (PPG1092-2, THD -B15) ~PAINT MANUFAC; GLIDDEN OR EQUAL

• 12. DECORATIVE EXTERIOR LIGHT FIXTURE ~COLOR: BROWN

13. DECORATIVE SHED ROOF WITH STANDING SEAM ROOF

MATERIAL

• ~MATERIAL: METAL ~FINISH: KYNAR

• ~STYLE: AS SHOWN • ~COLOR: BROWN

 ~SIZE: CORBEL SUPPORT BRACKET 4X6 TRIM: COLOR: BLACK WALNUT

14. EXPOSED RAFTER TIPS AT 32" O.C. TYP.

 ~SIZE::SEE DETAIL ~COLOR: MESA BEIGE (PPG1092-2, THD -B15)

~PAINT MANUFAC; GLIDDEN OR EQUAL

15. DECORATIVE TEMPERED GLASS OVAL WINDOW: ~SIZE:: SEE PLAN ~MANUFACTURER STANDARD SIZE.

• ~BROWN 16. DECORATIVE TEMPERED GLASS OVAL WINDOW:

SIZE:: SEE PLAN ~MANUFACTURER STANDARD SIZE.

• ~BROWN

17. TERMINATION BASE

 ~SIZE: 2X6 TRIM WITH 2 X SOLID CAPPING ~COLOR: MESA BEIGE (PPG1092-2, THD -B15)

• ~PAINT MANUFAC; GLIDDEN OR EQUAL

18. DECORATIVE WOOD FENCE PER LANDSCAPE PLANS.

 ~COLOR: MESA BEIGE (PPG1092-2, THD -B15) ~PAINT MANUFAC; GLIDDEN OR EQUAL

19. ACRYLIC CLEAR PANELS AT DECK AND BALCONY

• \sim 2X6 TOP RAIL AND BOTTOM RAIL

 ~SIZE: 42" ABOVE DECK FINISH FLOOR. ~MATERIAL: ACRYLIC OR TEMPERED GLAZING. • ~COLOR: CLEAR

20. THIN SET STONE VENEER

• ~SIZE: 2" THINK PANEL VENEER

• ~MATERIAL: CANYON CREEK

 ~COLOR: CANYON CREEK ~MANUFACTURER: PENINSULA BUILDING MATERIAL, CO. TEL: (650) 365-8500

21. DECORATIVE ALUMINUM CLAD GARAGE DOORS WINDOW WINDOW PATTERN PER ELEVATIONS:

• ~COLOR: BROWN

109 SEAPORT BLVD.

REDWOOD CITY CA 94063

22. GUARDRAIL COLUMN

• ~SIZE: 10" X 10" WITH 2X SOLID CAP • ~COLOR: MESA BEIGE (PPG1092-2, THD -B15) • ~PAINT MANUFAC; GLIDDEN OR EQUAL

Geurse Conceptual Designs, Inc.




405 bayswater ave. Burlingame, california 94010 tel: 650.703.6197 e:mail: jgeurse@gmail.com

SIGNATURE BOX: NAME: JESSE GEURSE DATE: OCTOBER 29, 2020



MOSS BEACH

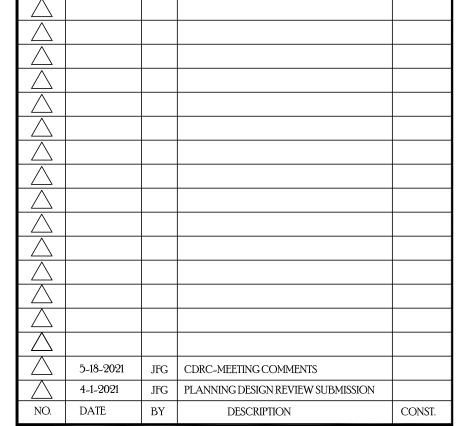


REVISIONS

IT IS THE RESPONSIBILITY OF THE CONTRACTOR TO VERIFY ALL FIELD CONDITIONS AND COMPARE THEM WITH THE CONSTRUCTION DOCUMENTS BEFORE COMMENCING
ACTIVITIES, ERRORS, OMMISSIONS
OR ANY OTHER INCONSISTENCIES
DISCOVERED SHALL IMMEDIATELY
BE REPORTED TO THE DESIGNER.

JOB NO.

DRAWN JFG

REVIEWED

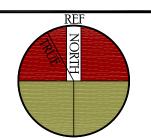

PROJECT NAME
NEW RESIDENCE for MR. + MRS. SHARMA 989 OCEAN BLVD. MOSS BEACH, CALIFORNIA 94038

> DRAWING TITLE EXTERIOR 3D RENDERING

> > DRAWING NO.

AART ASSINK SCALE: AS SHOWN RELEASED TO CONSTRUCTION