

County Government Center 455 County Center, 2nd Floor Redwood City, CA 94063 650-363-4161 T 650-363-4849 F www.planning.smcgov.org

December 6, 2019

Jen Jacinto 303 Twin Dolphin Drive Redwood City, CA 94065

Dear Mr. Jacinto:

SUBJECT: Coastside Design Review Continuance

1120 Columbus Drive, El Granada

APN 047-275-050; County File No. PLN 2017-00296

At its November 14, 2019 meeting, the San Mateo County Coastside Design Review Committee (CDRC) considered your application for a Design Review Permit to allow a Major Modification to a residence (2,428 sq. ft.) previously recommended for approval by the CDRC on February 8, 2018 and approved by the Planning Department on March 2, 2018. The proposed modification includes raising the ground level elevation of the rear yard by 4.5 to 5 feet, removing and replacing the approved trees and bushes in the rear year with low ground cover, removing the approved rear yard landscape wall, reducing the quantity of side yard landscaping, orienting the rear deck stairs towards the left side yard, and adding metal railings along the side yard retaining walls. The project would involve 450 cubic yards (c.y.) of grading (285 c.y. cut, 165 c.y. fill), an increase of 165 c.y. of fill from the original approval. This project qualifies for a Coastal Development Permit Exemption and is not appealable to the California Coastal Commission. Due to the associated staff level Grading Permit, the CDRC will not render a decision, but will make a recommendation regarding the project's compliance with the Design Review Standards.

The CDRC was unable to make the findings for a design review approval based on certain design deficiencies. In order to resolve these deficiencies in the project's design, a more thorough review of "Standards for Design for One-Family and Two-Family Residential Development in the Midcoast" manual is required. As such, requirements from the CDRC for further project redesign are as follows:

1. Recommendations Discussed Include:

- a. Submit plans to include as-built plans that clearly illustrate deviations from the approved plan set. Deviations shall be shown in clouding and tagging notations.
- b. A survey of the as-built conditions that clearly illustrates the new grades and extent of grading that occurred on the neighboring (Adams) property shall be provided.



- c. Revised Civil and architectural drawings to reflect as-built conditions shall be provided. These drawings shall include the intended design, the retaining walls, proposed cut and fill quantities, the finished grade from both the subject property and the Adams property, updated erosion control measures, and any changes to the drainage plan.
- d. Provide a copy of the agreement with the adjacent property owner (Ms. Erica Adams) to the left permitting access and grading on the adjacent property.
- e. An arborist report shall be required. The report shall assess all trees on the property and all adjacent trees that have been affected by construction activities. The report shall clearly discuss the health of the trees, how (or if) the trees have been impacted by the development and provide recommended tree protection measures.

As such, you were presented with the following available options at the end of the CDRC's deliberation of the project: (1) request for a decision from the CDRC on the plans presented or (2) request that the project be considered at the next meeting to provide you with ample time to consider and incorporate the elements recommended for project redesign. You chose the second option, and the CDRC directed staff to schedule your project for consideration at a later date.

Please contact Laura Richstone, Project Planner, at 650/363-1829 or lrichstone@smcgov.org, if you have any questions.

To provide feedback, please visit the Department's Customer Survey at the following link: http://planning.smcgov.org/survey.

Sincerely,

Dennis P. Aguirre Design/Review Officer

cc: Bahram Abolmoluki, Owners

Bruce Chan, Member Landscape Architect

Katie Kostiuk, Member Architect

Chris Johnson, El Granada Community Representative

Ed Abell, Interested Member of the Public

DPA:LAR;cmc - LARDD0631 WCN.DOCX

URBAN - model: WS-W11

LED Outdoor Sconce Luminiare










Fixture Type:			
Catalog Number:			
Project:			
Location:			
	 	8"	

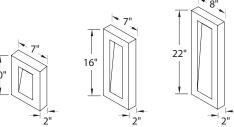

PRODUCT DESCRIPTION

Like urban renewal, the Urban sconce gives new life to the conventional step baffle. Form follows function in this simplified indirect wall sconce. Clean styling and robust LED performance are combined in this modern dark sky luminaire.

FEATURES

- ETL & cETL listed for wet locations. IP65
- Interior light and down light
- · Low profile design
- Replaceable LED module
- · 277V option available special order
- 50,000 hour potential life
- Color Temp: 3000K
- CRI: 85

SPECIFICATIONS

Construction: Aluminum.

Power: No driver or transformer required.

Light Source: High output LED.

Dimming: Dims to 10% with an electronic low voltage (ELV) dimmer.

Mounting: Mounts directly to junction box.

Finish: Black (BK), Bronze (BZ), Graphite (GH), White (WT).

Standards: ETL & cETL listed. ADA compliant. Dark Sky friendly. IP65. Wet location.

ORDER NUMBER

					LED	Photometric	
Model	Heig	ht	Watt	# of LEDs	Lumens	Lumens	Finish
WS-W11		16"		3 4 5	720 960 1200	370 490 610	BK Black BZ Bronze GH Graphite WT White



Example: WS-W1116-GH

For 277V special order, add an "F" before the finish: WS-W1116F-GH


REPLACEMENT GLASS

Model	Fixture Description	
RPL-GLA-1110-01	WS-W1110	Top Lens
RPL-GLA-1110-02	VV3-VV1110	Bottom Lens
RPL-GLA-1116-01	WS-W1116	Top Lens
RPL-GLA-1116-02	VV3-VV1110	Bottom Lens
RPL-GLA-1122-01	WS-W1122	Top Lens
RPL-GLA-1122-02	VV3-VV1122	Bottom Lens

Back Plate Dimensions:

Model	el Dimension	
WS-W1110	10"L x 7"W x 2"H	
WS-W1116	18"L x 7"W x 2"H	
WS-W1122	22"L x 8"W x 2"H	

modernforms.com Phone (800) 526.2588 Fax (800) 526.2585 **Headquarters/Eastern Distribution Center** 44 Harbor Park Drive Port Washington, NY 11050 Central Distribution Center 1600 Distribution Ct Lithia Springs, GA 30122 Western Distribution Center 1750 Archibald Avenue Ontario, CA 91760

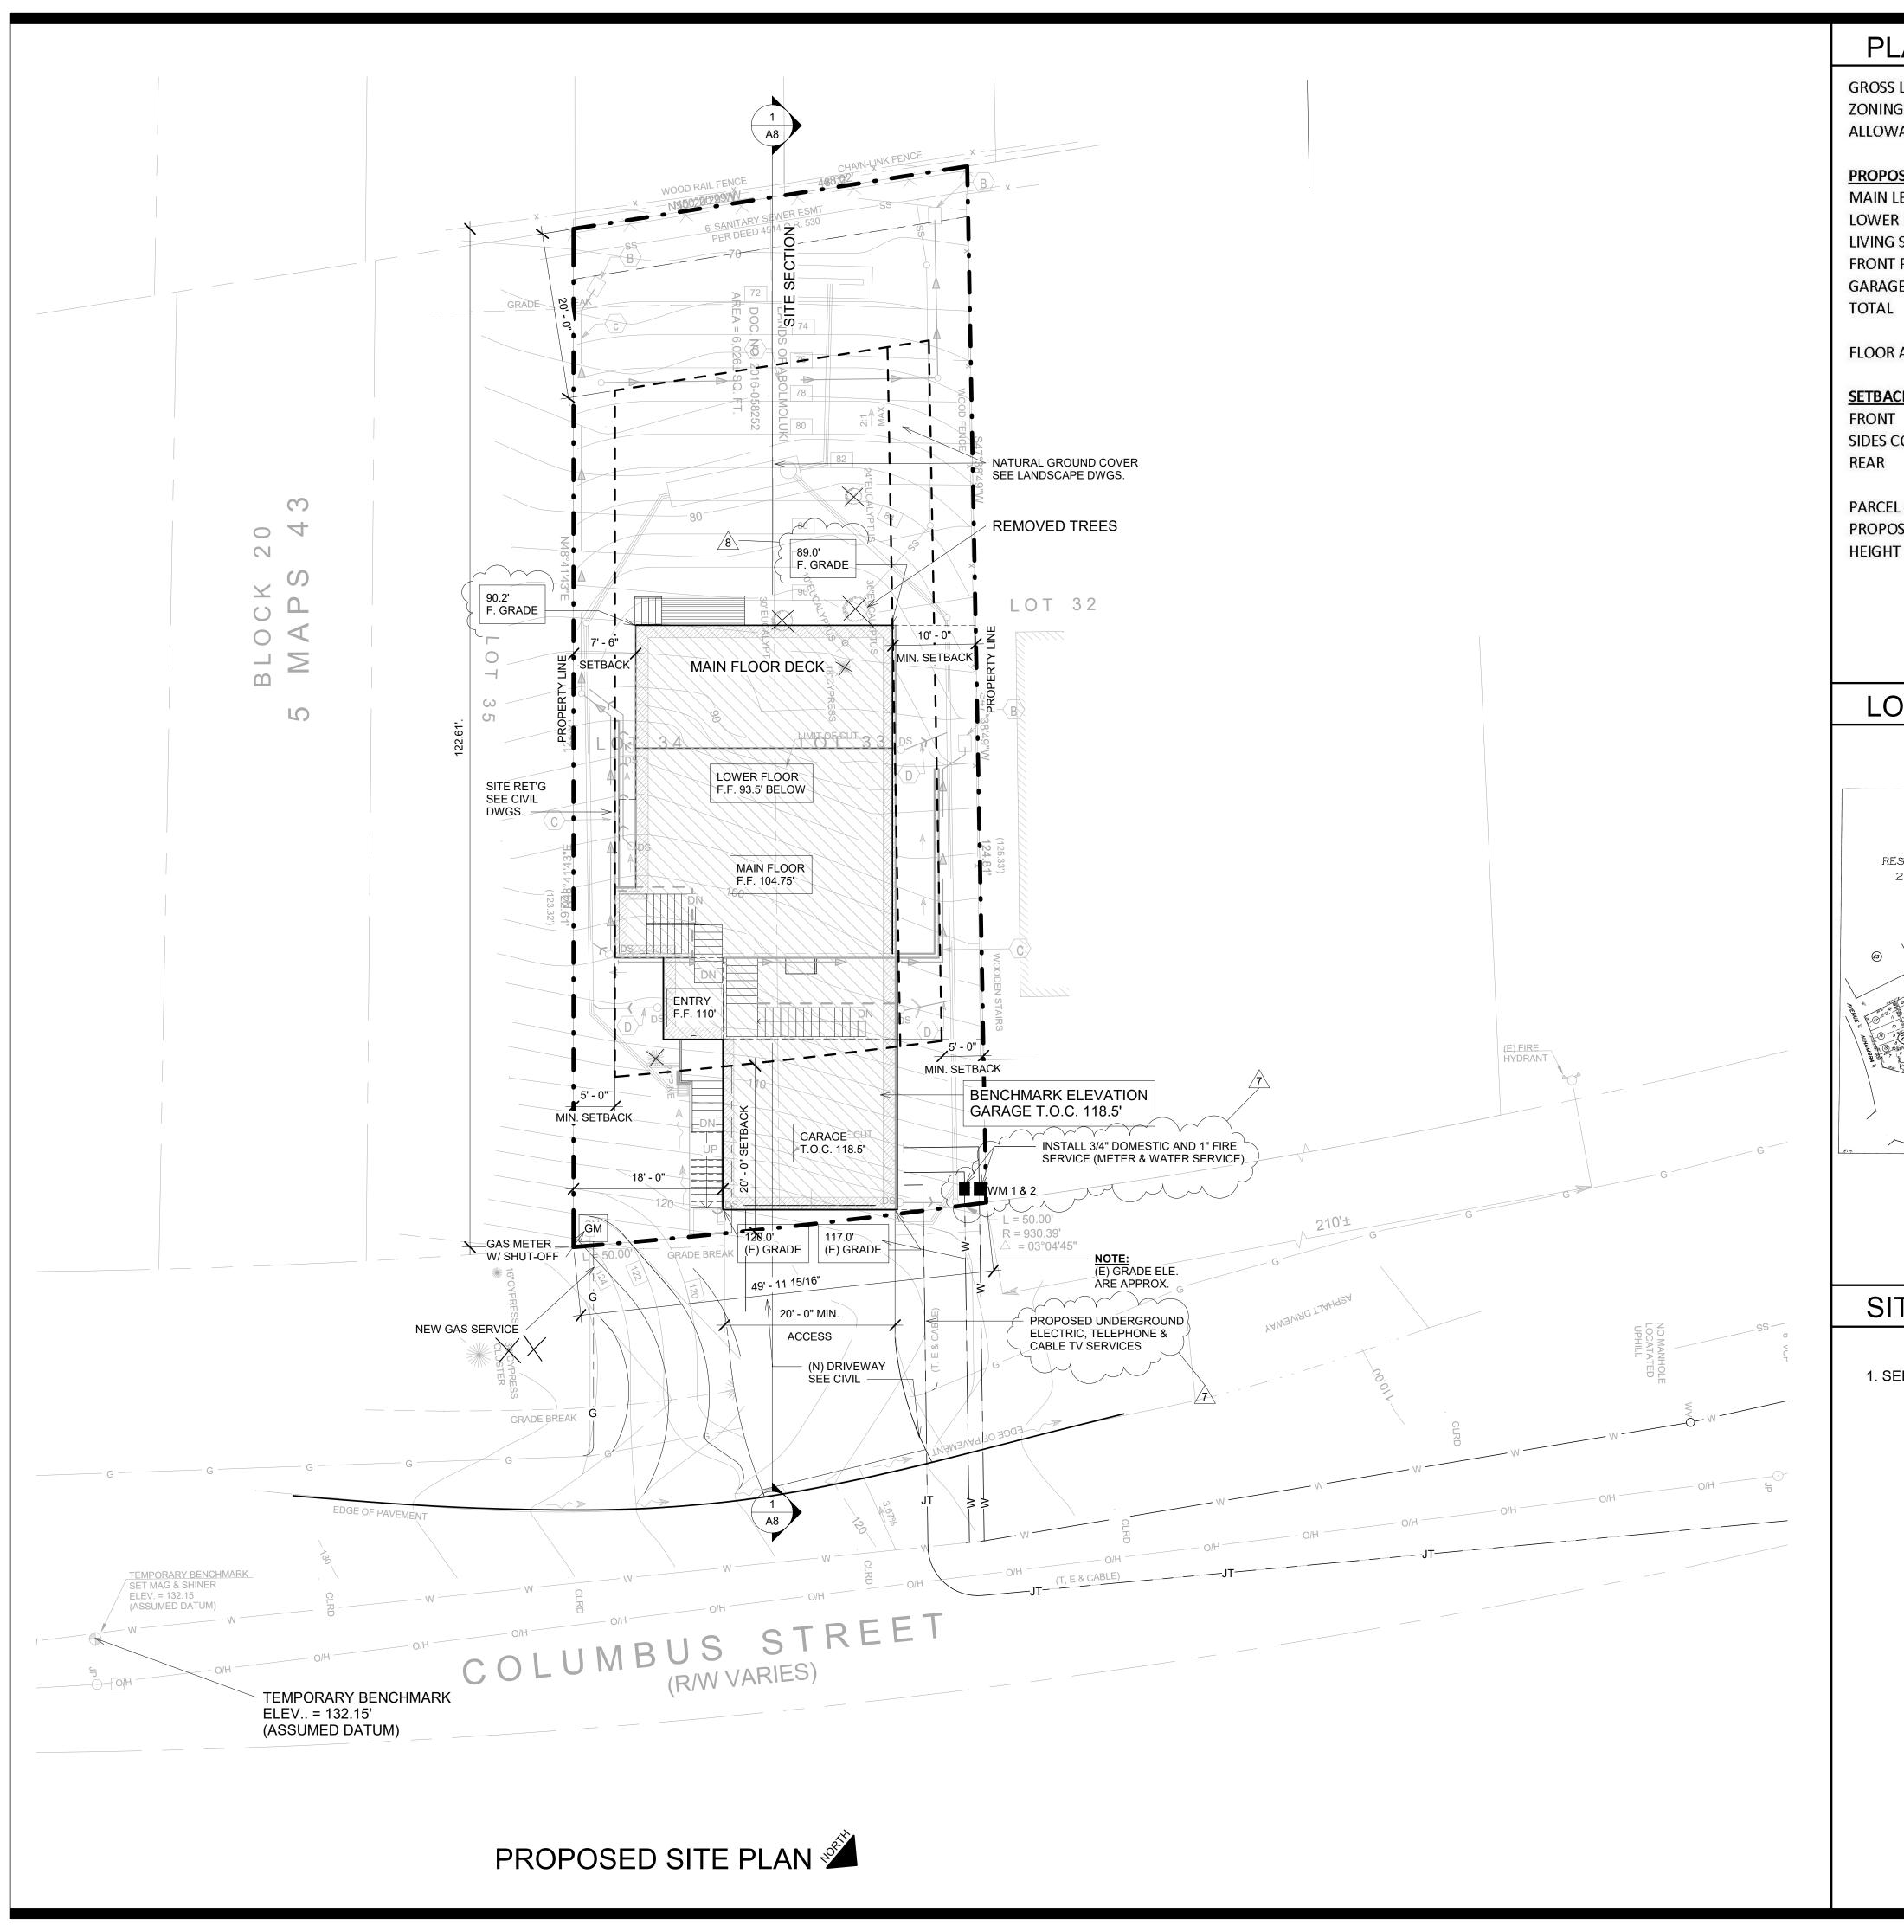

PLANNING DATA **GROSS LOT AREA** 6026 SF ZONING-S-17 COMBING DISTRICT(MID COAST) ALLOWABLE FLOOR AREA 3193.78 SF **PROPOSED FLOOR AREAS** MAIN LEVEL 1081 SF **LOWER LEVEL** 1281 SF LIVING SUBTOTAL 2362 SF FRONT PORCH 25 SF **GARAGE** 437 SF 2824 SF 46.86% FLOOR AREA RATIO **SETBACKS** 20' 5' MIN. SIDES COMBINED TOTAL OF 15' 20' PARCEL COVERAGE 35% MAX. 2109.1 SF PROPOSED COVERAGE 2074 SF 34.4% **HEIGHT LIMIT** 28'

RESIDENTIAL DESIGN SOLUTIONS

406 LA JOLLA AVENUE SAN MATEO, CA 94403 (650) 218-8161

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LIC. # 48803

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LOCATION MAP



ABOLMOLUKI RESIDENCE

APN 047-275-050 COLUMBUS ST. EL GRANADA, CA.

SITE PLAN NOTES

1. SEE CIVIL DRAWINGS FOR ALL SITE GRADING ETC. TYPICAL.

		DESCRIPTION	DATE	BY
	1	PLANNING	8-24-17	CR
SN	2	PLANNING 2	9-25-17	CR
REVISIONS	3	PLANNING 3	12-15-17	CR
ZEV	4	PLANNING 4	1-2-18	CR
	5	PLAN CHECK RESPONSES	7-1-18	CR
	6			
	7	OWNER REVISION	10/21/19	CR
	8	OWNER REVISION	5/20/20	CR

DATE10/8/18

Drawing Number

Scale
1" = 10'-0"

A



FIRE COAS

1191 MAIN STREET HALF MOON BAY, CA 94019

August 15, 2017

Jen Jacinto 680 Walnut Street San Carlos, CA 94070

Dear Applicant,

After reviewing the planning application for a new Single Family Residence with an attached garage at 0 Columbus Street, Assessor's Parcel Number 047-275-050 in El Granada (San Mateo County Permit No. PLN2017-00296) I offer the following comments/conditions, which will be applied to this project:

TELEPHONE (650) 726-5213 FAX (650) 726-0132

Your building plans have been <u>conditionally approved</u> subject to the following conditions completed prior to a final inspection by the fire department. It is your responsibility to make contact with the fire department if you do not understand any of the following project conditions.

- Smoke Detectors which are hard wired: As per the California Building Code, State Fire Marshal regulations, and Coastside Fire District Ordinance 2016-01, the applicant is required to install State Fire Marshal approved and listed smoke detectors which are hard wired, interconnected, and have battery backup. These detectors are required to be placed in each new and recondition sleeping room and at a point centrally located in the corridor or area giving access to each separate sleeping area. In existing sleeping rooms, areas may have battery powered smoke alarms. A minimum of one detector shall be placed on each floor. Smoke detectors shall be tested and approved prior to the building final.
- Add note to plans smoke alarm/detector are to be hardwired, interconnected, or with battery back-up. Smoke alarms to be installed per manufactures instruction and NFPA 72
- Add note: Escape or rescue windows shall have a minimum net clear openable area of 5.7 square feet, 5.0 sq. ft. allowed at grade. The minimum net clear openable height dimension shall be 24 inches. The net clear openable width dimension shall be 20 inches. Finished sill height shall be not more than 44 inches above the finished floor.

0 Columbus St EG pln.docx

- Identify rescue windows in each bedroom and verify that they meet all requirements. Add this to plans.
- Occupancy Separation: As per the 2016 CBC, Section 406.1.4, a one-hour occupancy separation wall shall be installed with a solid core, 20-minute fire rated, self-closing door assembly w/ smoke gasket between the garage and the residence. All electrical boxes installed in rated walls shall be metal or protected.
- Address Numbers: As per Coastside Fire District Ordinance 2016-01, building identification shall be conspicuously posted and visible from the street. (TEMPORARY ADDRESS NUMBERS SHALL BE POSTED PRIOR TO COMBUSTIBLES BEING PLACED ON SITE). The letters/numerals for permanent address signs shall be 4 inches in height with a minimum 3/4-inch stroke. Such letters/numerals shall be internally illuminated and facing the direction of access. Finished height of bottom of address light unit shall be greater than or equal to 6 feet from finished grade. When the building is served by a long driveway or is otherwise obscured, a 6 inch by 18 inch green reflective metal sign with 3 inch reflective Numbers/ Letters similar to Hy-Ko 911 or equivalent shall be placed at the entrance from the nearest public roadway. See Fire Ordinance for standard sign.
- Roof Covering: As per Coastside Fire District Ordinance 2016-01, the roof covering of every new building or structure, and materials applied as part of a roof covering assembly, shall have a minimum fire rating of Class "B" or higher as defined in the current edition of the California Building Code.
- **Vegetation Management:** The Coastside Fire District Ordinance 2016-01, the 2016 California Fire Code and Public Resources Code 4291.
 - O A fuel break of defensible space is required around the perimeter of all structures to a distance of not less than 30 feet and may be required to a distance of 100 feet or to the property line. In SRA (State Responsible Area) the fuel break is 100 feet or to the property line.
 - Trees located within the defensible space shall be pruned to remove dead and dying portions, and limbed up 6 to 10 feet above the ground. New trees planted in the defensible space shall be located no closer than 10 feet to adjacent trees when fully grown or at maturity.
 - o Remove that portion of any existing tree, which extends within 10 feet of the outlet of a chimney or stovepipe or is within 5 feet of any structure.
- Fire Access Roads: The applicant must have a maintained asphalt surface road for ingress and egress of fire apparatus. The San Mateo County Department of Public Works, the Coastside Fire District Ordinance 2016-01, and the California Fire Code shall set road standards. As per the 2016 CFC, dead-end roads exceeding 150 feet shall be provided with a turnaround in accordance with Half Moon Bay Fire District specifications. As per the 2007 CFC, Section Appendix

D, road width shall not be less than 20 feet. Fire access roads shall be installed and made serviceable prior to combustibles being placed on the project site and maintained during construction. Approved signs and painted curbs or lines shall be provided and maintained to identify fire access roads and state the prohibition of their obstruction. If the road width does not allow parking on the street (20 foot road) and on-street parking is desired, an additional improved area shall be developed for that use.

- Fire apparatus access roads to be an approved all weather surface. Grades 15% or greater to be surfaced w/ asphalt, or brushed concrete. Grades 15 % or greater shall be limited to 150 ft. in length with a minimum of 500 ft. between the next section. For roads approved less than 20 ft., 20 ft. wide turnouts shall be on each side of 15% or greater section. No grades over 20%. (Plan and profile required) CFC 503
- **Fire Hydrant:** As per 2016 CFC, Appendix B and C, a fire district approved fire hydrant (Clow 960) must be located within 500 feet of the proposed single-family dwelling unit measured by way of drivable access. As per 2016 CFC, Appendix B the hydrant must produce a minimum fire flow of 1,000 gallons per minute at 20 pounds per square inch residual pressure for 2 hours. Contact the local water purveyor for water flow details.
- Automatic Fire Sprinkler System: As per San Mateo County Building Standards and Coastside Fire District Ordinance Number 2016-01, the applicant is required to install an automatic fire sprinkler system throughout the proposed or improved dwelling and garage. All attic access locations will be provided with a pilot head on a metal upright. All areas that are accessible for storage purposes shall be equipped with fire sprinklers including closets and bathrooms. The only exception is small linen closets less than 24 square feet with full depth shelving. The plans for this system must be submitted to the San Mateo County Planning and Building Division or The City of HMB. A building permit will not be issued until plans are received, reviewed and approved. Upon submission of plans, the County or City will forward a complete set to the Coastside Fire District for review. The fee schedule for automatic fire sprinkler systems shall be in accordance with Half Moon Bay Ordinance No. 2006-01. Fees shall be paid prior to plan review.
- Installation of underground sprinkler pipe shall be flushed and visually inspected by Fire District prior to hook-up to riser. Any soldered fittings must be pressure tested with trench open.
- Exterior bell and interior horn/strobe: are required to be wired into the required flow switch on your fire sprinkler system. The bell, horn/strobe and flow switch, along with the garage door opener are to be wired into a separate circuit breaker at the main electrical panel and labeled.

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- Add note to the title page that the building will be protected by an automatic fire sprinkler system.
- All fire conditions and requirements must be incorporated into your building plans, (see attached conditions) prior to building permit issuance. It is your responsibility to notify your contractor, architect and engineer of these requirements.

Our review is not construed as encompassing the structural integrity of the facility nor abrogating more restrictive requirements by other agencies having responsibility. Final acceptance is subject to field inspection and necessary tests.

If you have any questions regarding the above conditions, please call the administration office during normal working hours.

Respectfully,
Randy Amores
Deputy Fire Marshal
CAL FIRE/Coastside Fire Protection District

cc: San Mateo County Planning & Building File

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RESIDENTIAL DESIGN SOLUTIONS

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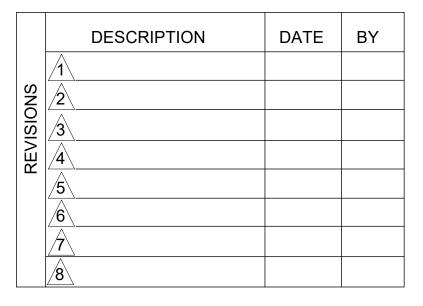
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ABOLMOLUKI RESIDENCE APN 047-275-050 COLUMBUS ST.

EL GRANADA, CA



DATE

10/8/18


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Project Number

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ABOLMOLUKI RESIDENCE APN 047-275-050 COLUMBUS ST.

EL GRANADA, CA.

	DESCRIPTION	DATE	BY
	1 PLANNING	8-24-17	CR
SNC	2 PLANNING 2	9-25-17	CR
REVISIONS	3 PLANNING 3	12-15-1	CR
ZEV	4	7	
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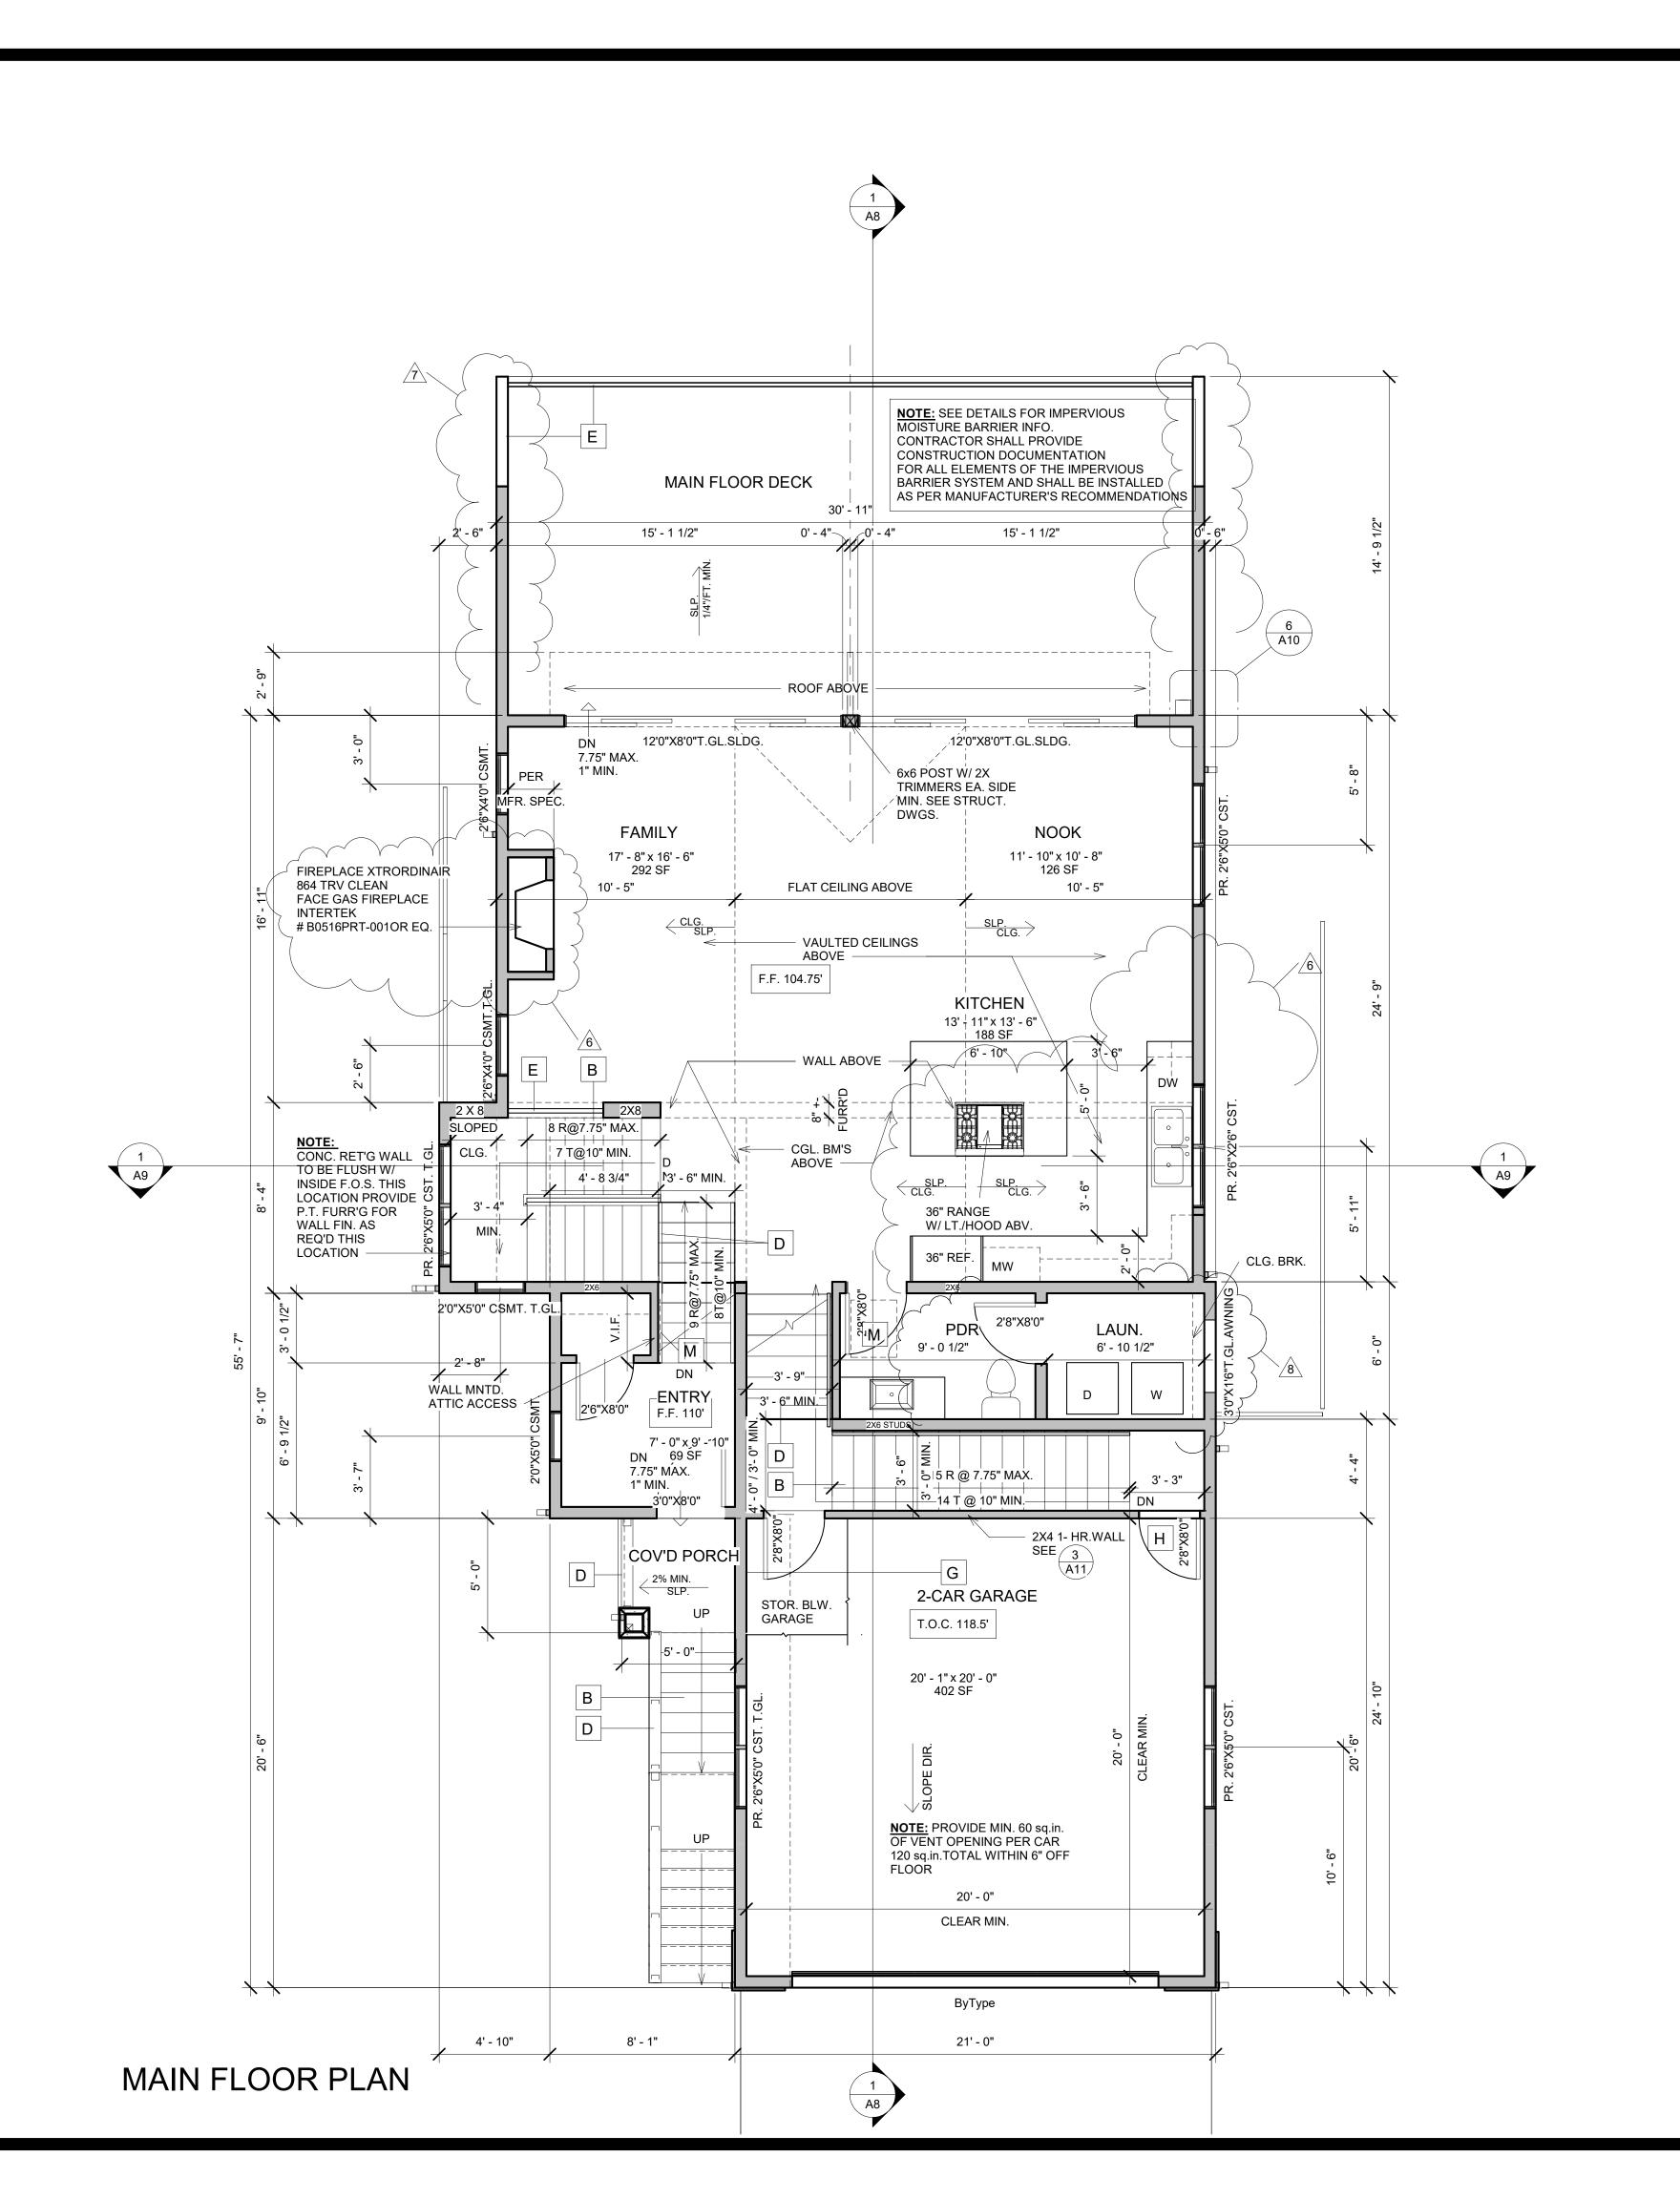
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10/8/18	

Drawing Number

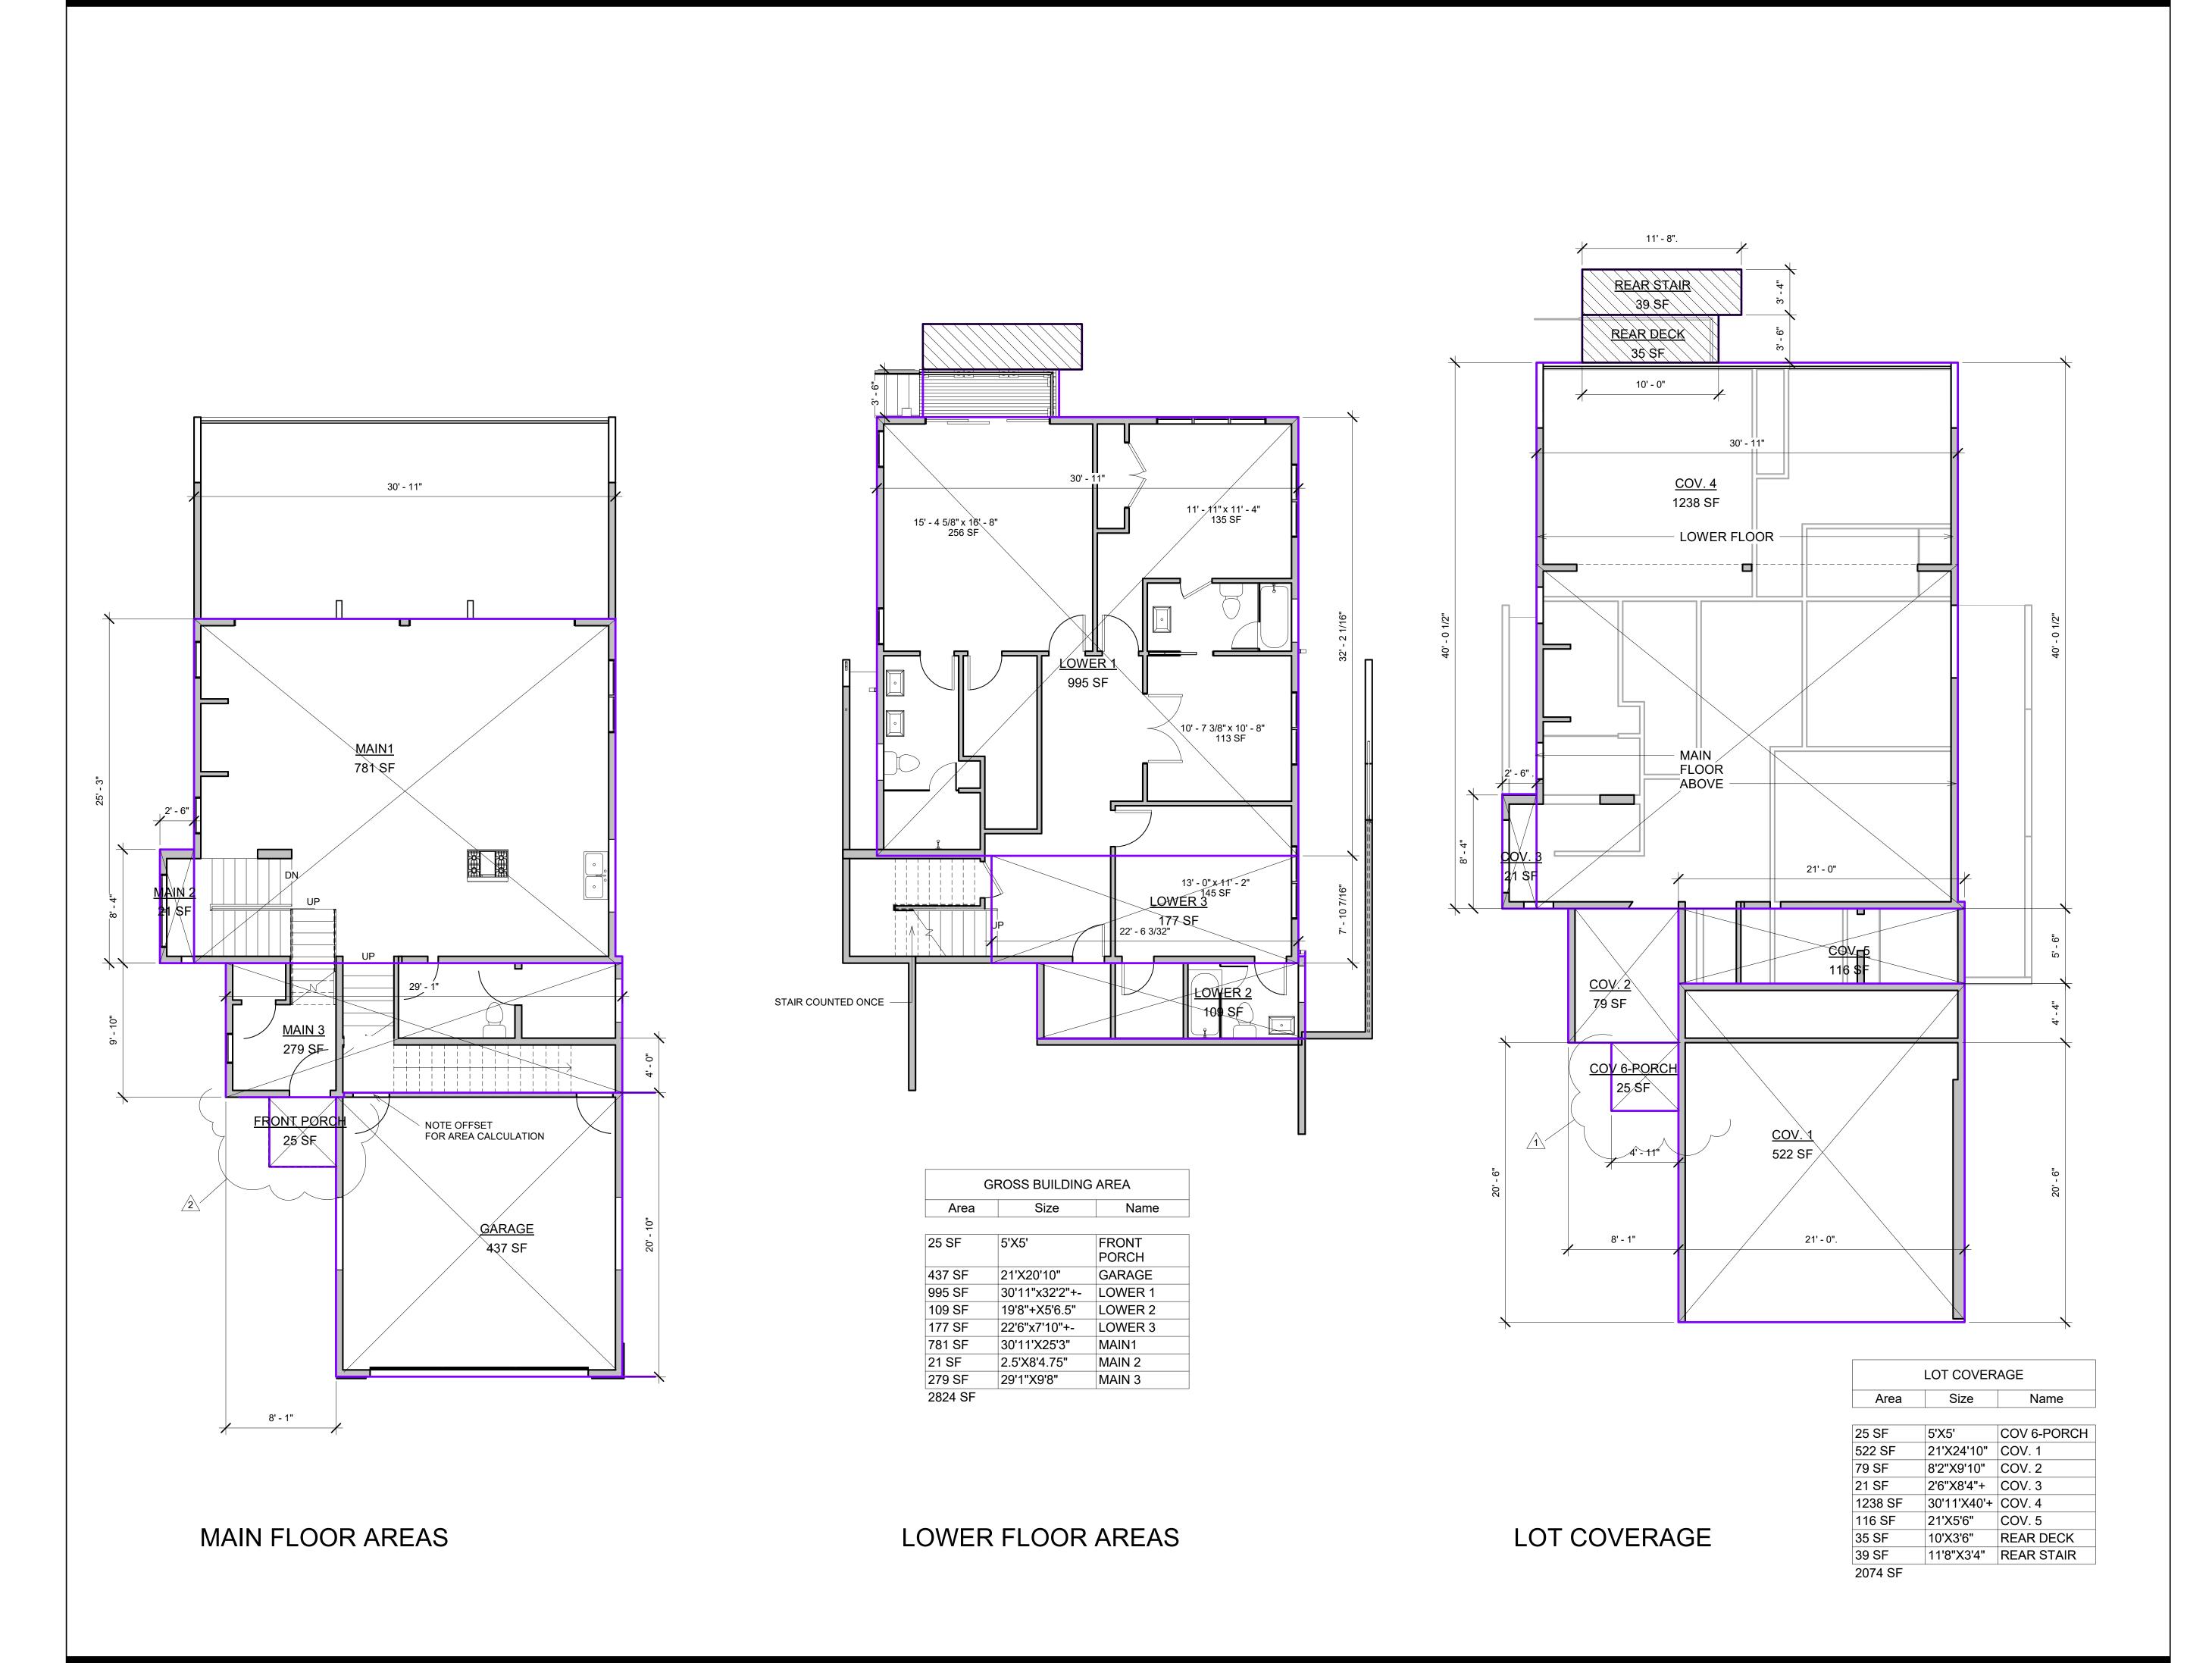Scale

Project Number

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CONDENSED PLAN SYMBOLS:

- A PROVIDE SWIMMING POOL BARRIERS AT ALL DOORS WITH DIRECT ACCESS TO SWIMMING POOL, WITH AN AUDIBLE ALARM W/ A DISCONNECT MOUNTED 54" ABOVE THRESHOLD OR APPROVED SELF-CLOSING SELF LATCHING DEVICE (CRC AG105.2.29
- B STAIR RISERS AND TREADS: MAXIMUM RISER HEIGHT SHALL BE 7.75", MINIMUM TREAD SHALL BE 10" NOSING TO BE 3/4" MIN. 1 1/4" MAX.
- C HEADROOM CLEARANCE ABOVE ANY STAIR RUN SHALL BE 6' 8" MIN.
- D HANDRAILS-STAIR WITH MORE THAN 4 OR MORE RISERS SHALL HAVE AT LEAST ONE HANDRAIL AND HANDRAIL EXTENSIONS SHALL NOT BE PLACED LESS THAN 34" NOR MORE THAN 38" ABOVE LANDING AND NOSING OF TREADS. HANDGRIPS SHALL BE 1 1/4 " MIN 2" MAX. CROSS DIM. AREA PER CRC-R311.7.8.
- E GUARDRAILS-42" MIN. HEIGHT TO BE PLACED ALONG OPEN SIDES OF WALKING AREAS, STARS AND LANDINGS LOCATED 30" ABOVE FLOOR OF EXTERIOR GRADE.
- F ALL UNDER STAIR AREAS USED AS STORAGE OR IS ACCESSIBLE SHALL BE PROTECTED W/ ½" GYP. BD. (MIN.) ON ALL SURFACES. (CRC-R302.7).
- G GARAGE WALLS AND CEILINGS SEPARATING THE GARAGE AND THE DWELLING UNIT SHALL HAVE 1 LAYER (MIN.) OF 1/2" GYP. BD. APPLIED ON THE GARAGE SURFACE (ALL SURFACES) CEILINGS BELOW HABITABLE ROOMS IN THE GARAGE SHALL BE PROTECTED BY LAYER OF 5/8" TYPE "X" GYP. BD. (CRC-R302.6).
- H DOORS TO THE GARAGE SHALL BE 1 3/8" MIN. SOLID CORE (RATED) W/ CLOSER IF
- I GARAGE SLABS ARE TO SLOPED TOWARDS GARAGE DOORS 1/8" PER FOOT MIN. OR AS PER CIVIL DRAWINGS
- J TEMPERED GLASS ENCLOSURE WITH MIN. 2'- 0" DOOR AS SELECTED.
- K NEW OR RECONFIGURED SHOWER STALLS SHALL BE MIN. FINISHED INTERIOR OF 1,024 S.I. AND CAPABLE OF ENCOMPASSING A 30" DIM. CIRCLE
- L SHOWER STALLS AND BATHTUBS INSTALLED SHALL HAVE WALLS FINISHED WITH A NON-ABSORBENT SURFACE TO A MINIMUM OF 6' 0" ABOVE THE FLOOR (CBC 1210 & R307.2).
- M 22" X 30" ATTIC ACCESS PANEL IF THE ATTIC CONTAINS MECHANICAL EQUIPMENT SIZE IS TO BE 30" X 30" OR AS REQUIRED FOR EQUIPMENT REMOVAL.
- N 18" X 24" UNDER FLOOR ACCESS PANEL W/ WEATHER STRIPPING AND OR LOCKING MECHANISM.

NOTE: SEE WINDOW AND DOOR NOTES SHEET GN AND TITLE 24 FOR WINDOW U VALES



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ABOLMOLUKI RESIDENCE APN 047-275-050 COLUMBUS ST. EL GRANADA, CA.

	DESCRIPTION	DATE	BY
	1 PLANNING	8-24-17	CR
SNO	PLANNING 2	9-25-17	CR
ISIC	3 PLANNING 3	12-15-17	CR
REVISIONS	4		
_	5 PLAN CHECK RESPONSES	7-1-18	CR
	6 OWNER	1-28-19	CR
	OWNER REVISION	10-21-19	CR
	8 OWNER REVISION	7-26-20	CR


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10/8/18

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Scale
1/4" = 1'-0"

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CONDENSED PLAN SYMBOLS:

- A PROVIDE SWIMMING POOL BARRIERS AT ALL DOORS WITH DIRECT ACCESS TO SWIMMING POOL, WITH AN AUDIBLE ALARM W/ A DISCONNECT MOUNTED 54" ABOVE THRESHOLD OR APPROVED SELF-CLOSING SELF LATCHING DEVICE (CRC AG105.2.29
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NOTE: SEE WINDOW AND DOOR NOTES SHEET GN AND TITLE 24 FOR WINDOW U VALES

CRAWL SPACE VENTING:

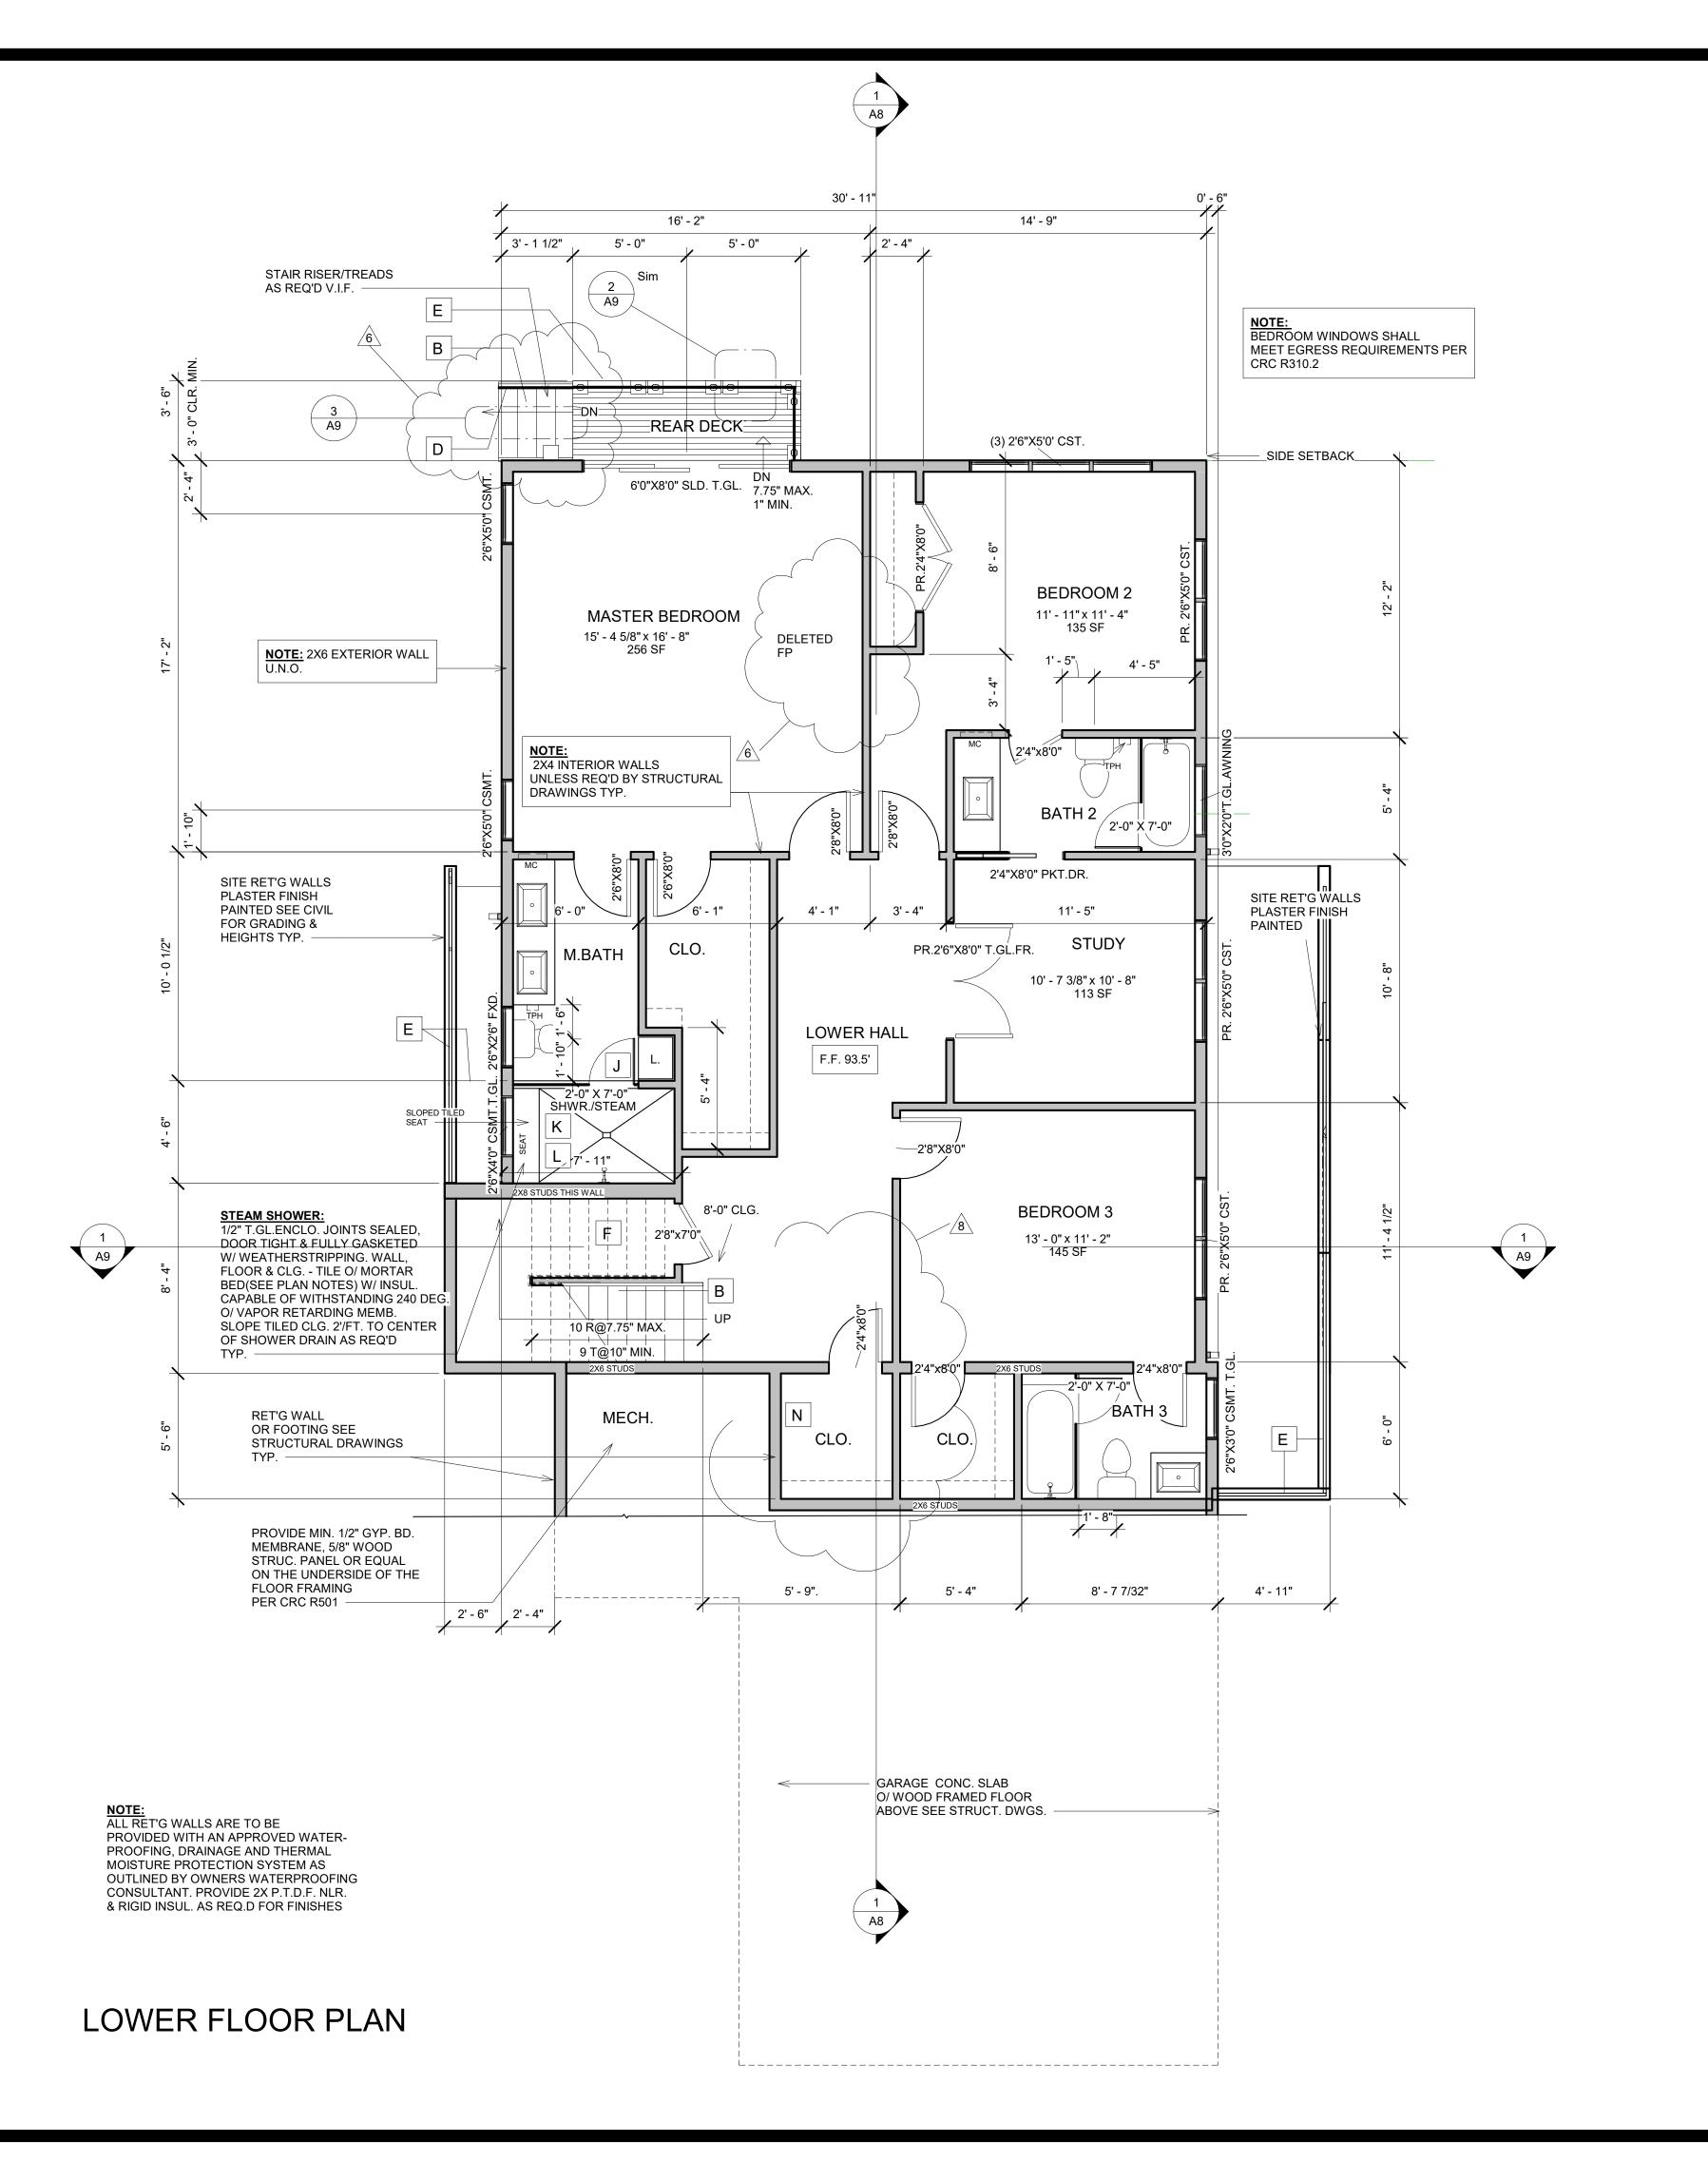1/1500 X UNDERFLOOR AREA = REQUIRED VENTILATION

X 1300 SF UNDERFLOOR AREA = 0.87 SF VENTING REQUIRED

EA. 8"X14" LOUVERED FOUNDATION VENT IS APPROXIMATELY .45 SF/65 SI MFR. AS SELECTED 3/4" THICK G.I. W/ 1/4"MESH MIN.

0.87 SF REQUIRED VENTING
0.45 SF
2 # OF VENTS REQUIRED MIN.

PER CRC R408

NOTE: PROVIDE A MECHANICAL IN-LINE CABINET

FAN UNIT WITH A HUMIDISTAT CONTROLED FAN

LOCATE AND PROVIDE POWER AS REQURED.

NOTE: VENTING TO BE 3'-0" MIN. FROM BLDG. CORNERS TYP.



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ABOLMOLUKI RESIDENCE APN 047-275-050 COLUMBUS ST. EL GRANADA, CA.

	DESCRIPTION	DATE	BY
	1 PLANNING	8-24-17	CR
SNS	2 OWNER REVISIONS	10-25-17	CR
REVISIONS	PLANNING 3	12-15-17	CR
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	6 OWNER REVISION	7/31/19	CR
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	8 OWNER REVISION	7-26-20	CR

DATE


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ABOLMOLUKI RESIDENCE APN 047-275-050 COLUMBUS ST.


EL GRANADA, CA.

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ABOLMOLUKI RESIDENCE APN 047-275-050 COLUMBUS ST. EL GRANADA, CA.

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SNO	2	PLANNING 2	9-25-17	CR
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SEV	4			
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	6	OWNER REVISION	7/31/19	CR
	7	OWNER REVISION	10/21/19	CR
	8	OWNER REVISION	5/20/20	CR
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DATE


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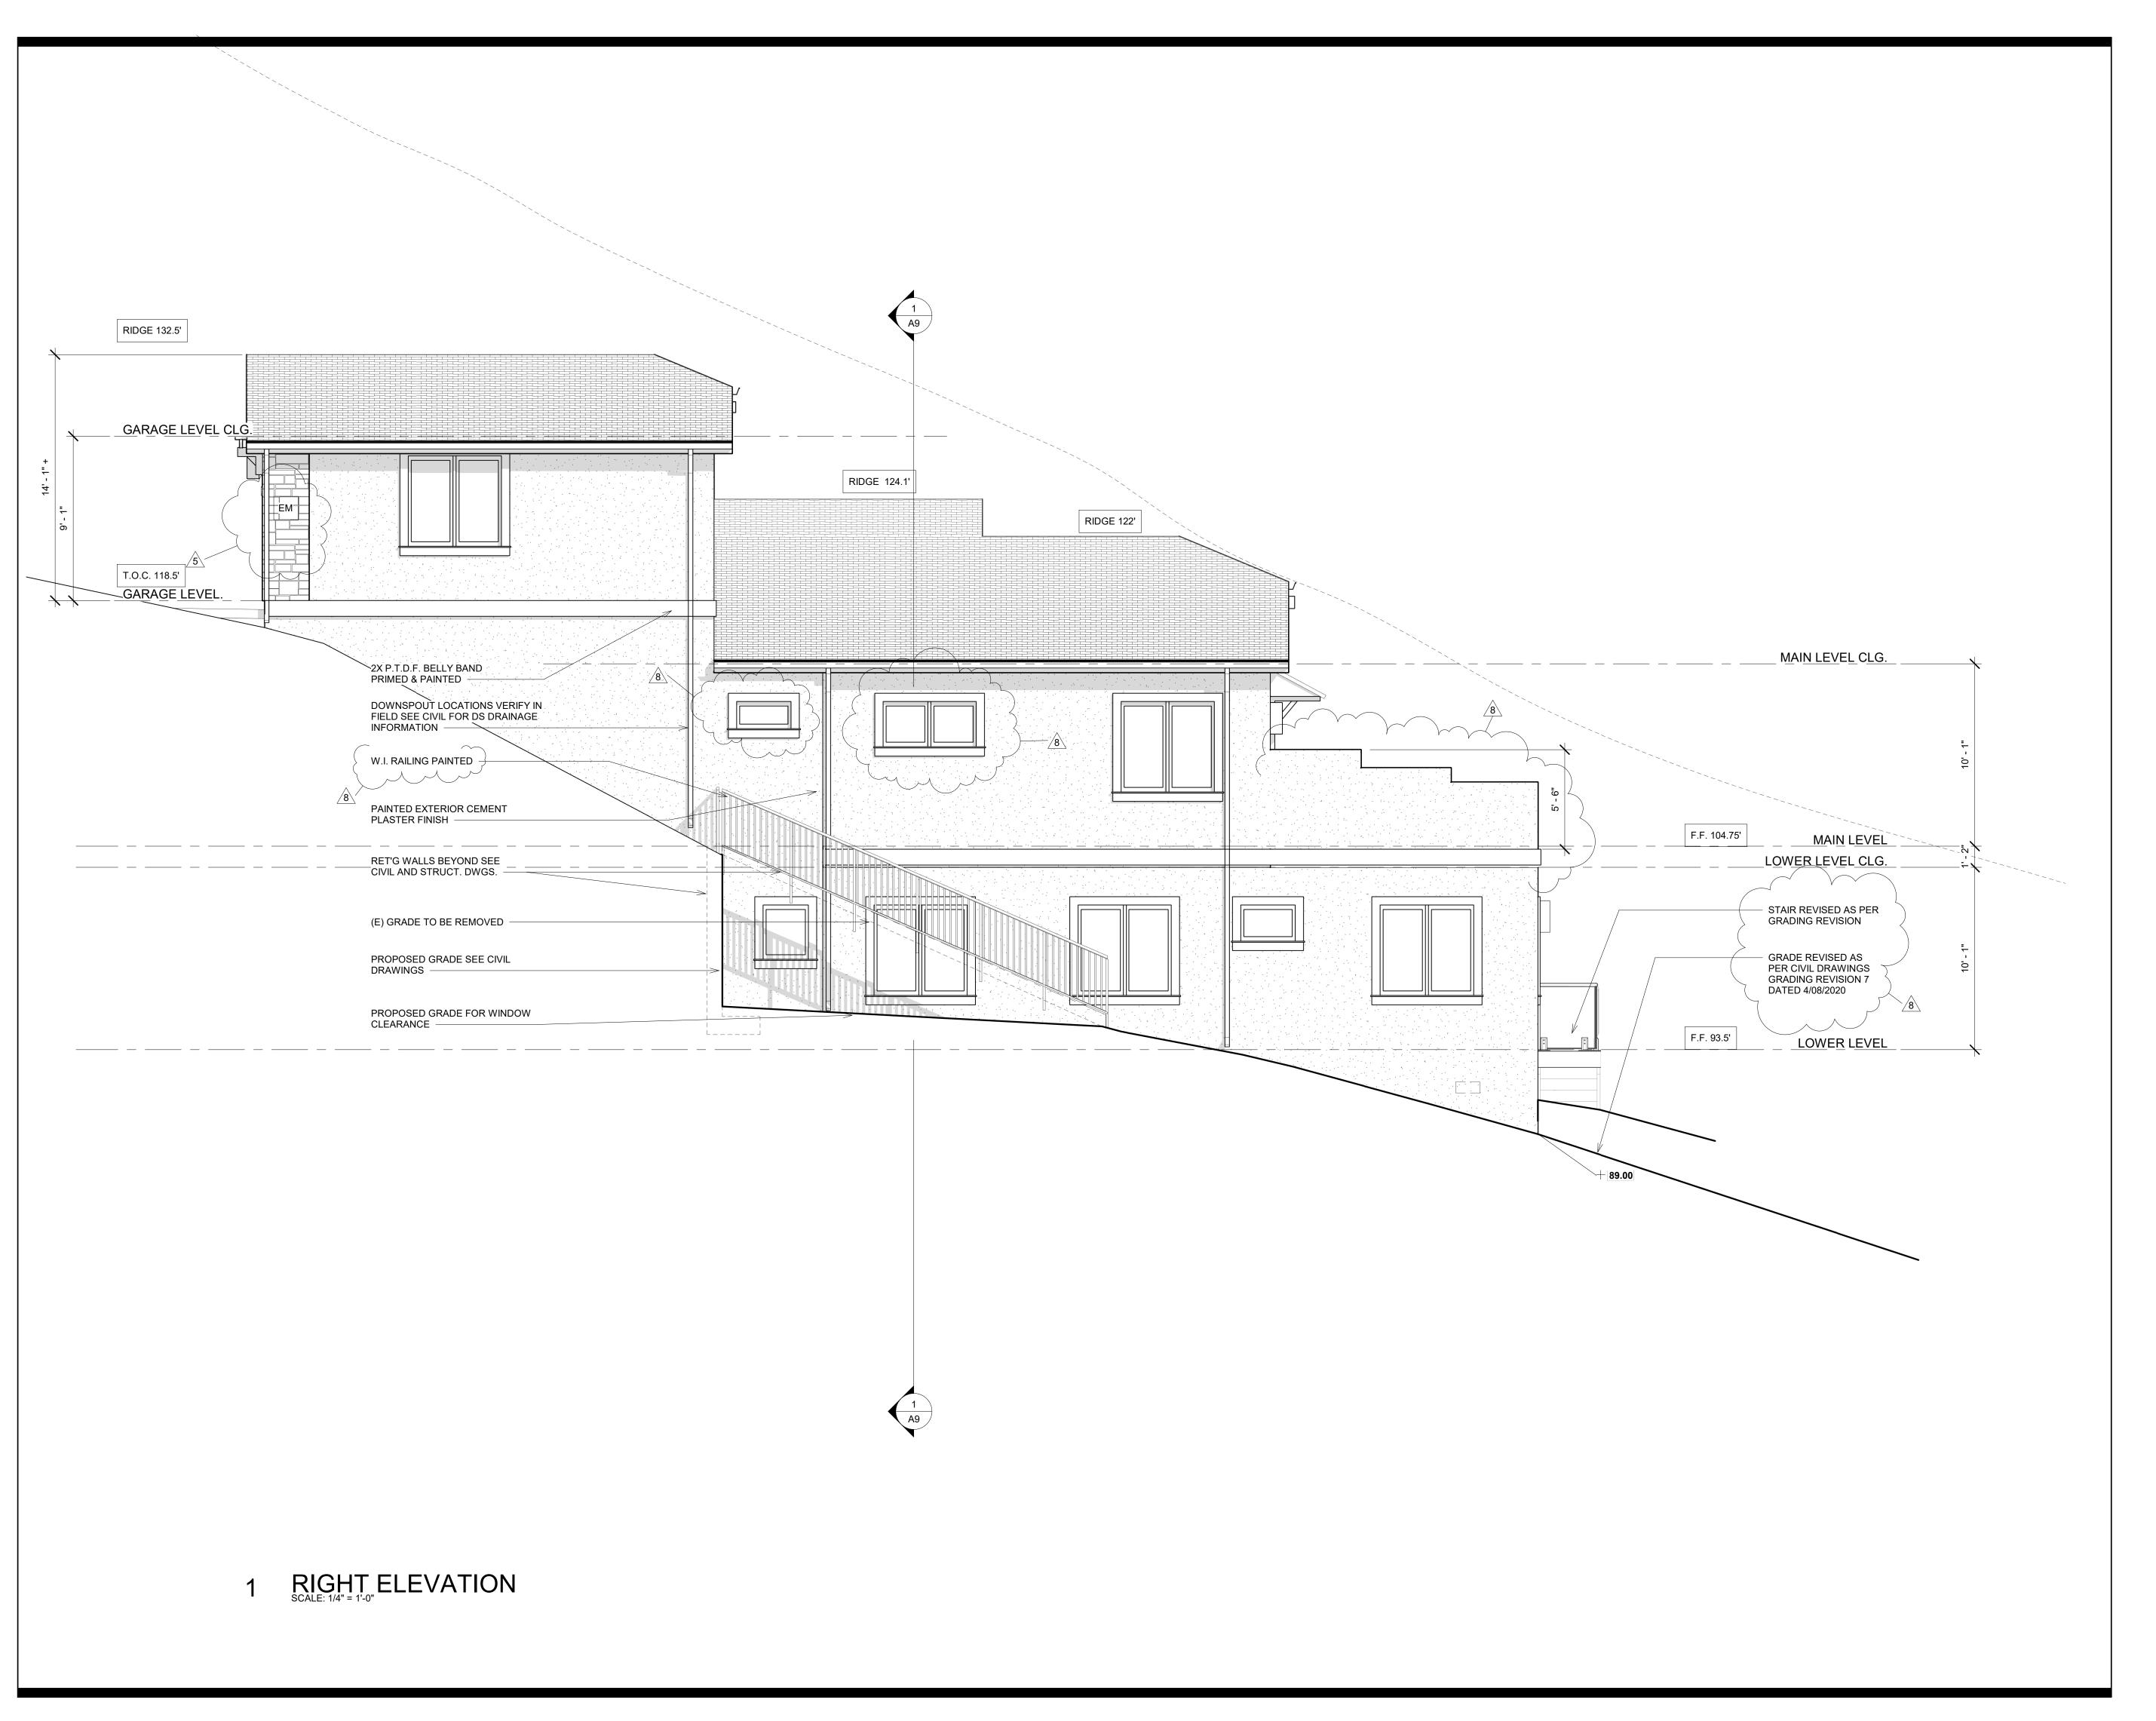
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	DESCRIPTION	DATE	BY
	1 PLANNING	8-24-17	CR
SN	<u>/2</u> \		
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	6 OWNER REVISION	7/31/19	CR
	OWNER REVISION	10/21/19	CR
	8 OWNER REVISION	5/20/20	CR
		•	

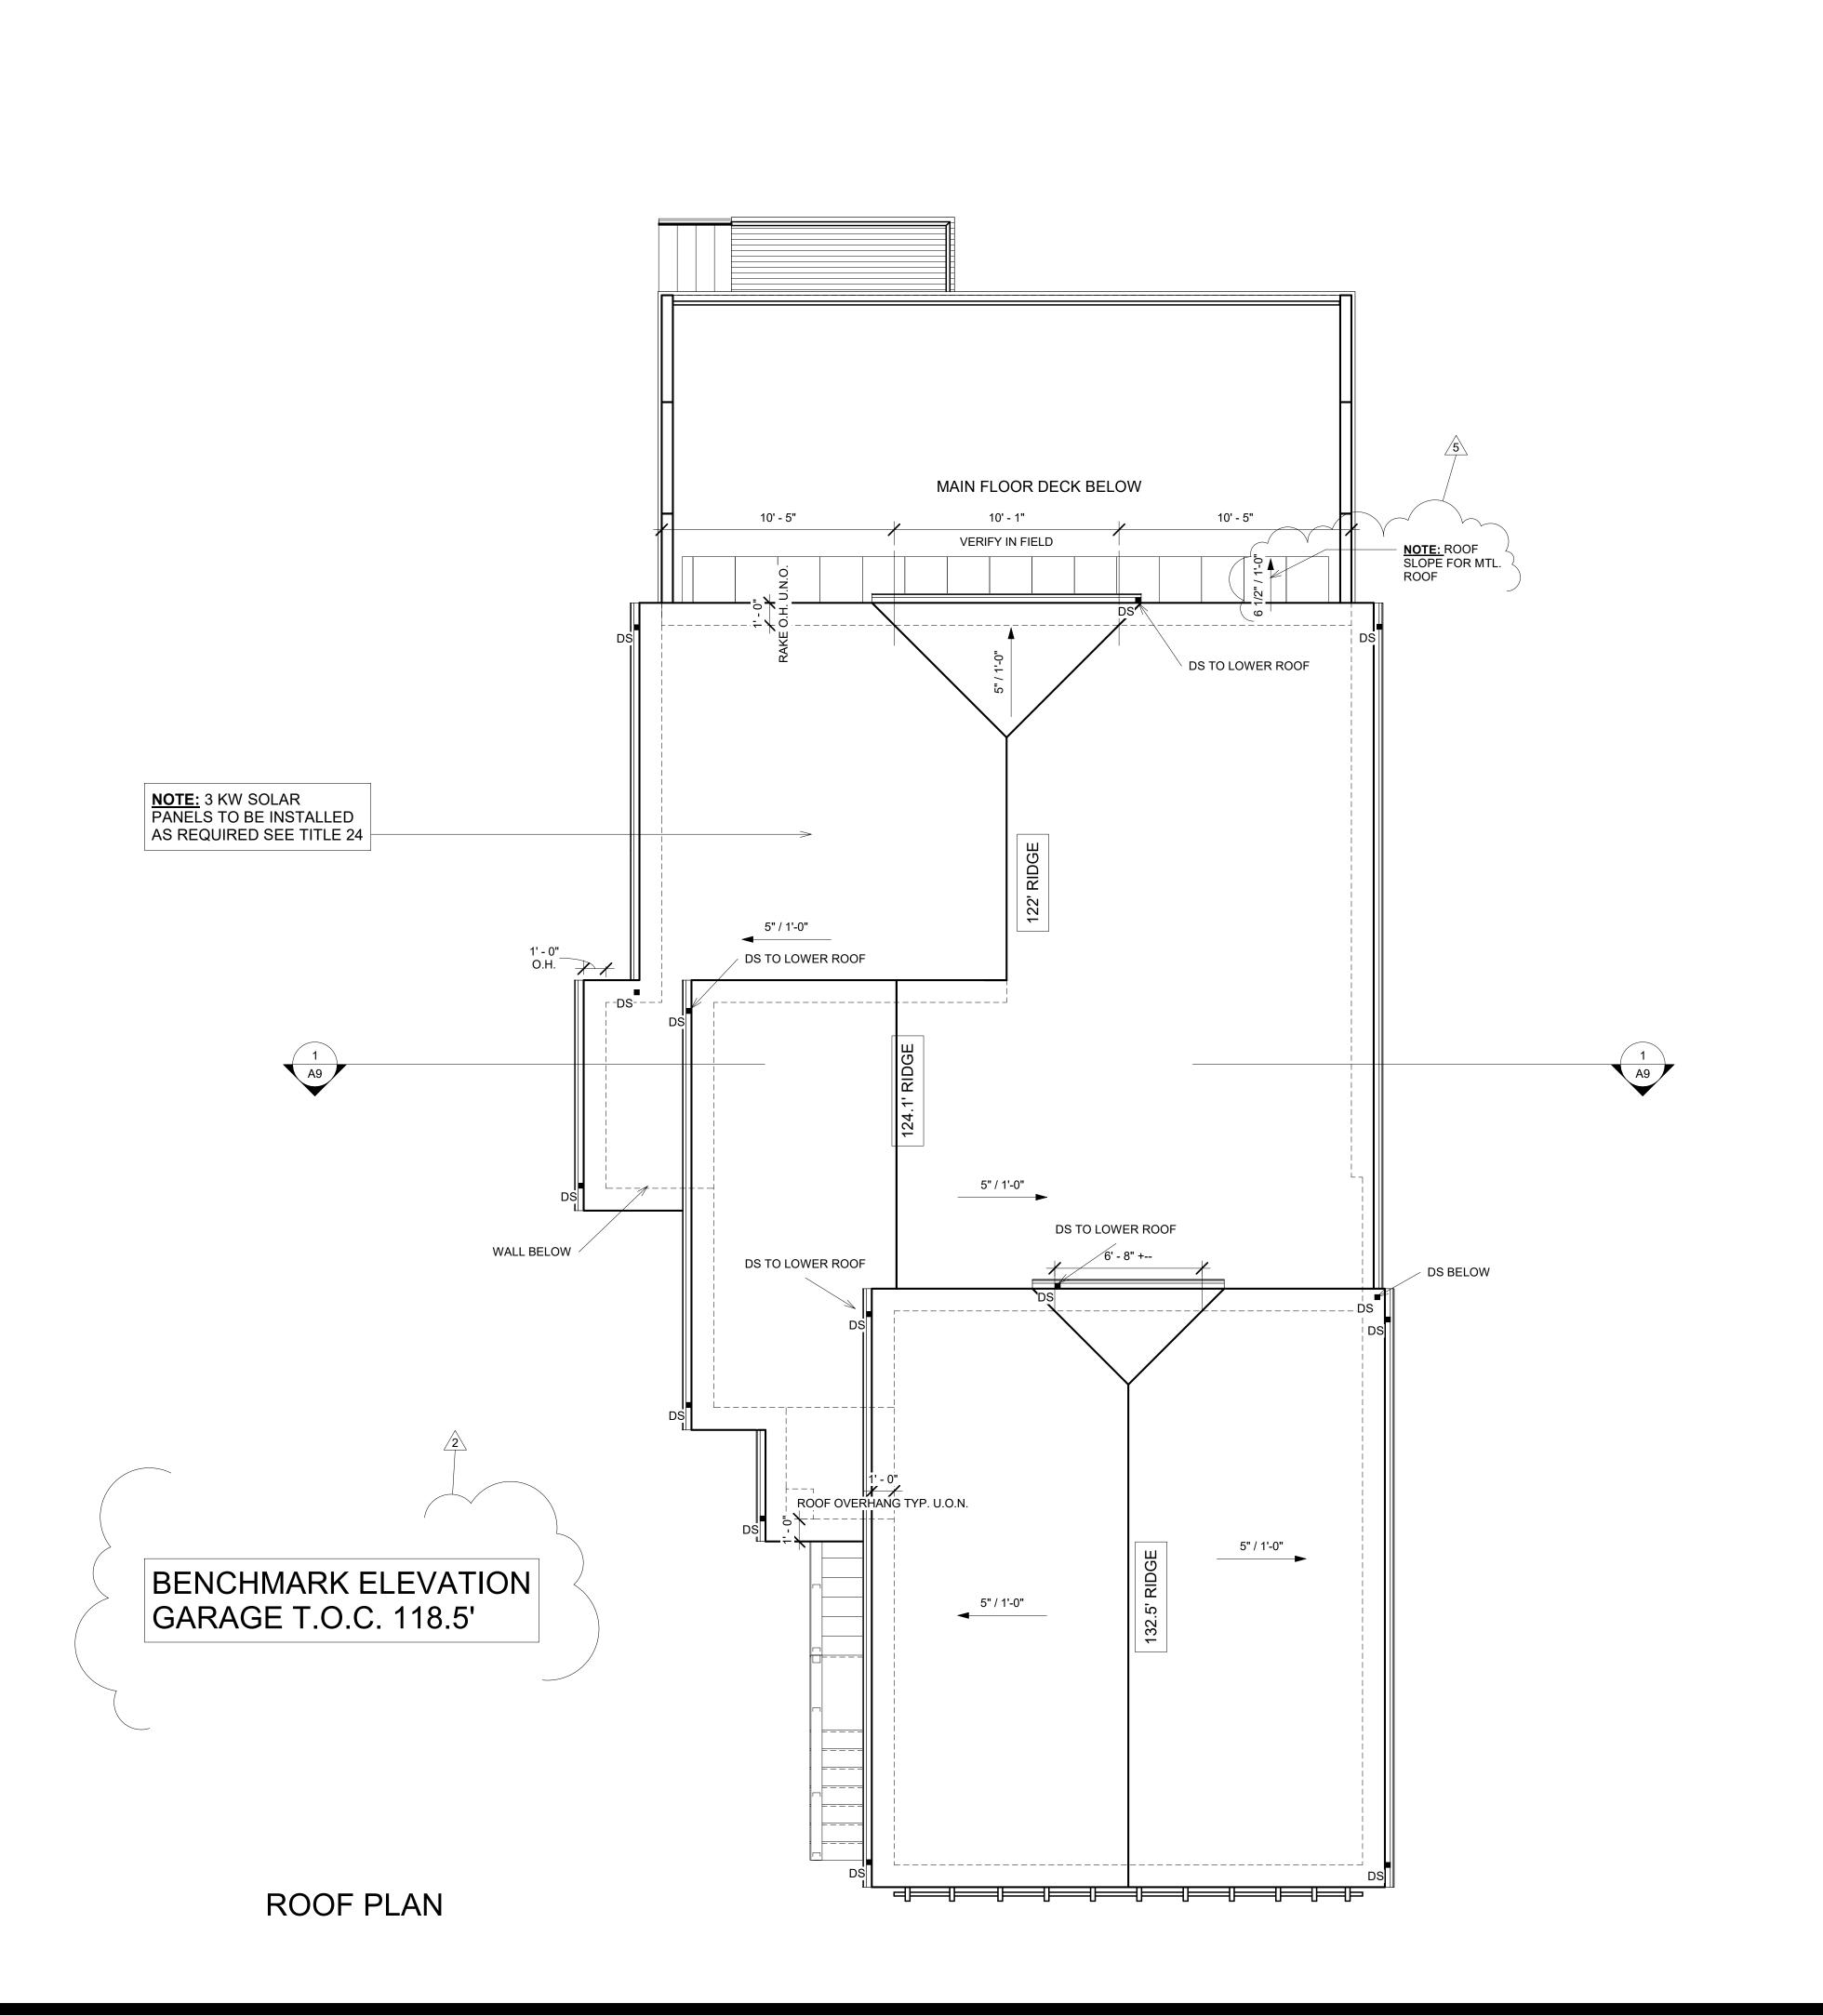DATE 10/8/18 Drawing Number

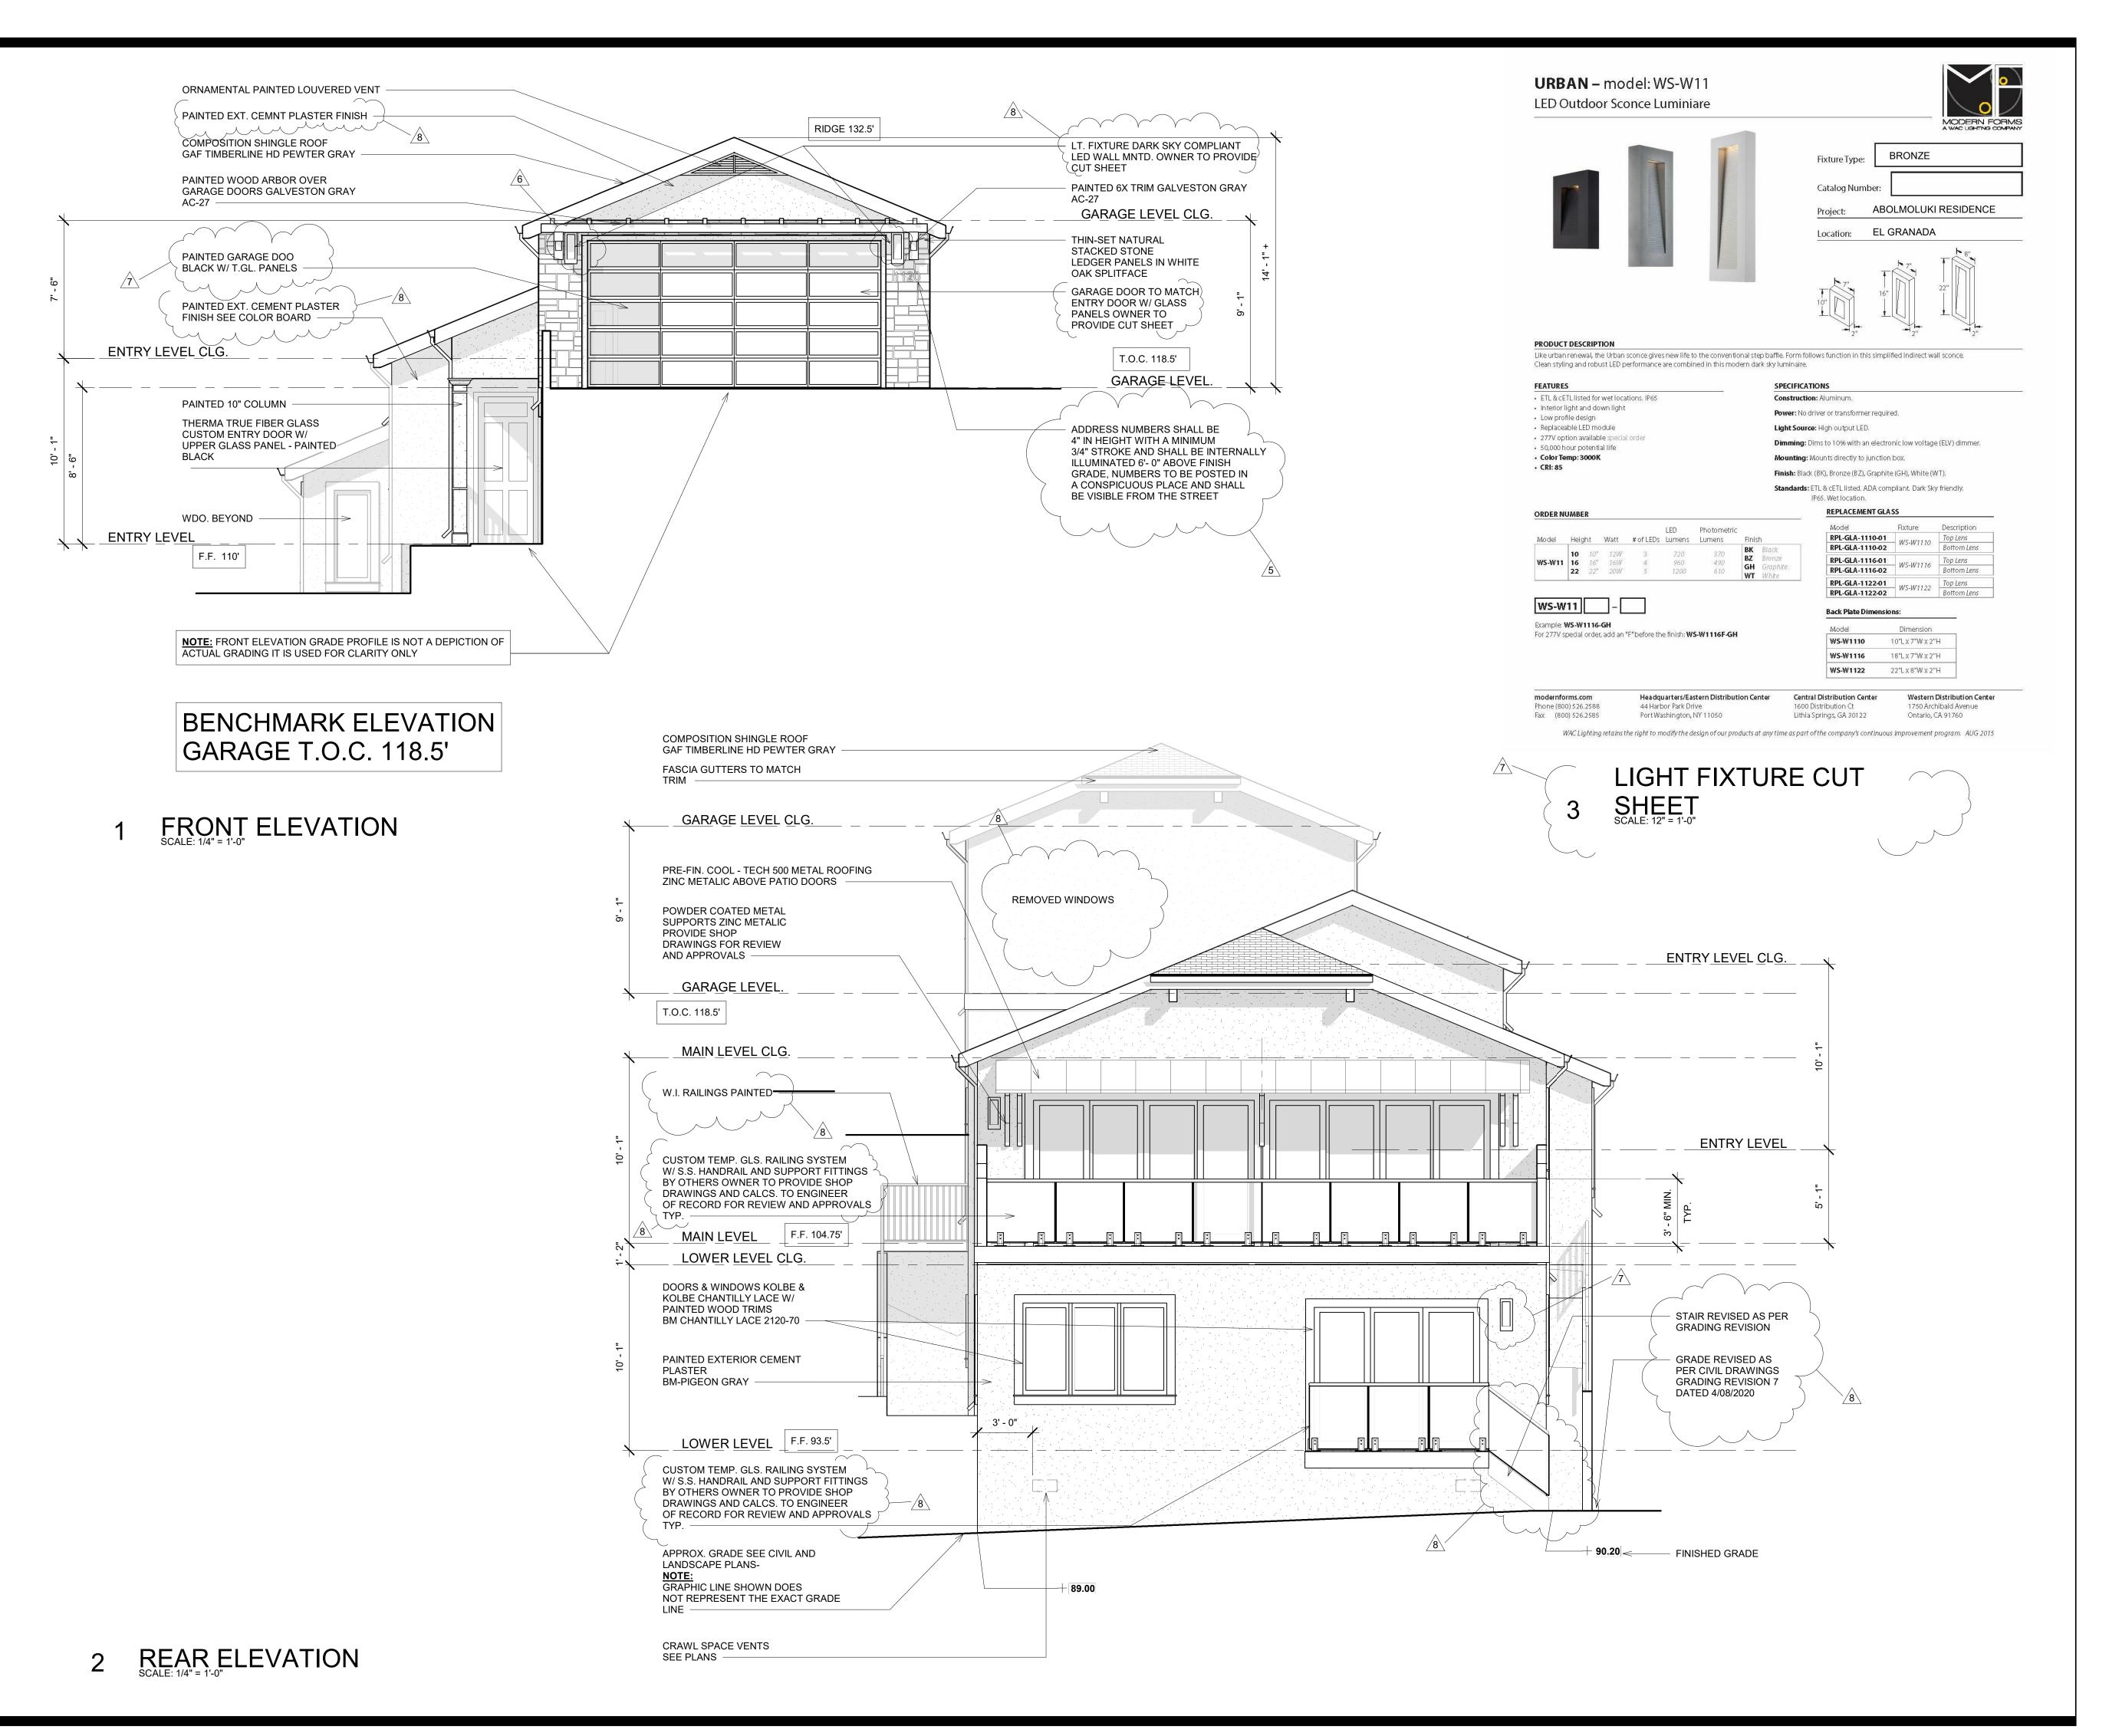Scale

A



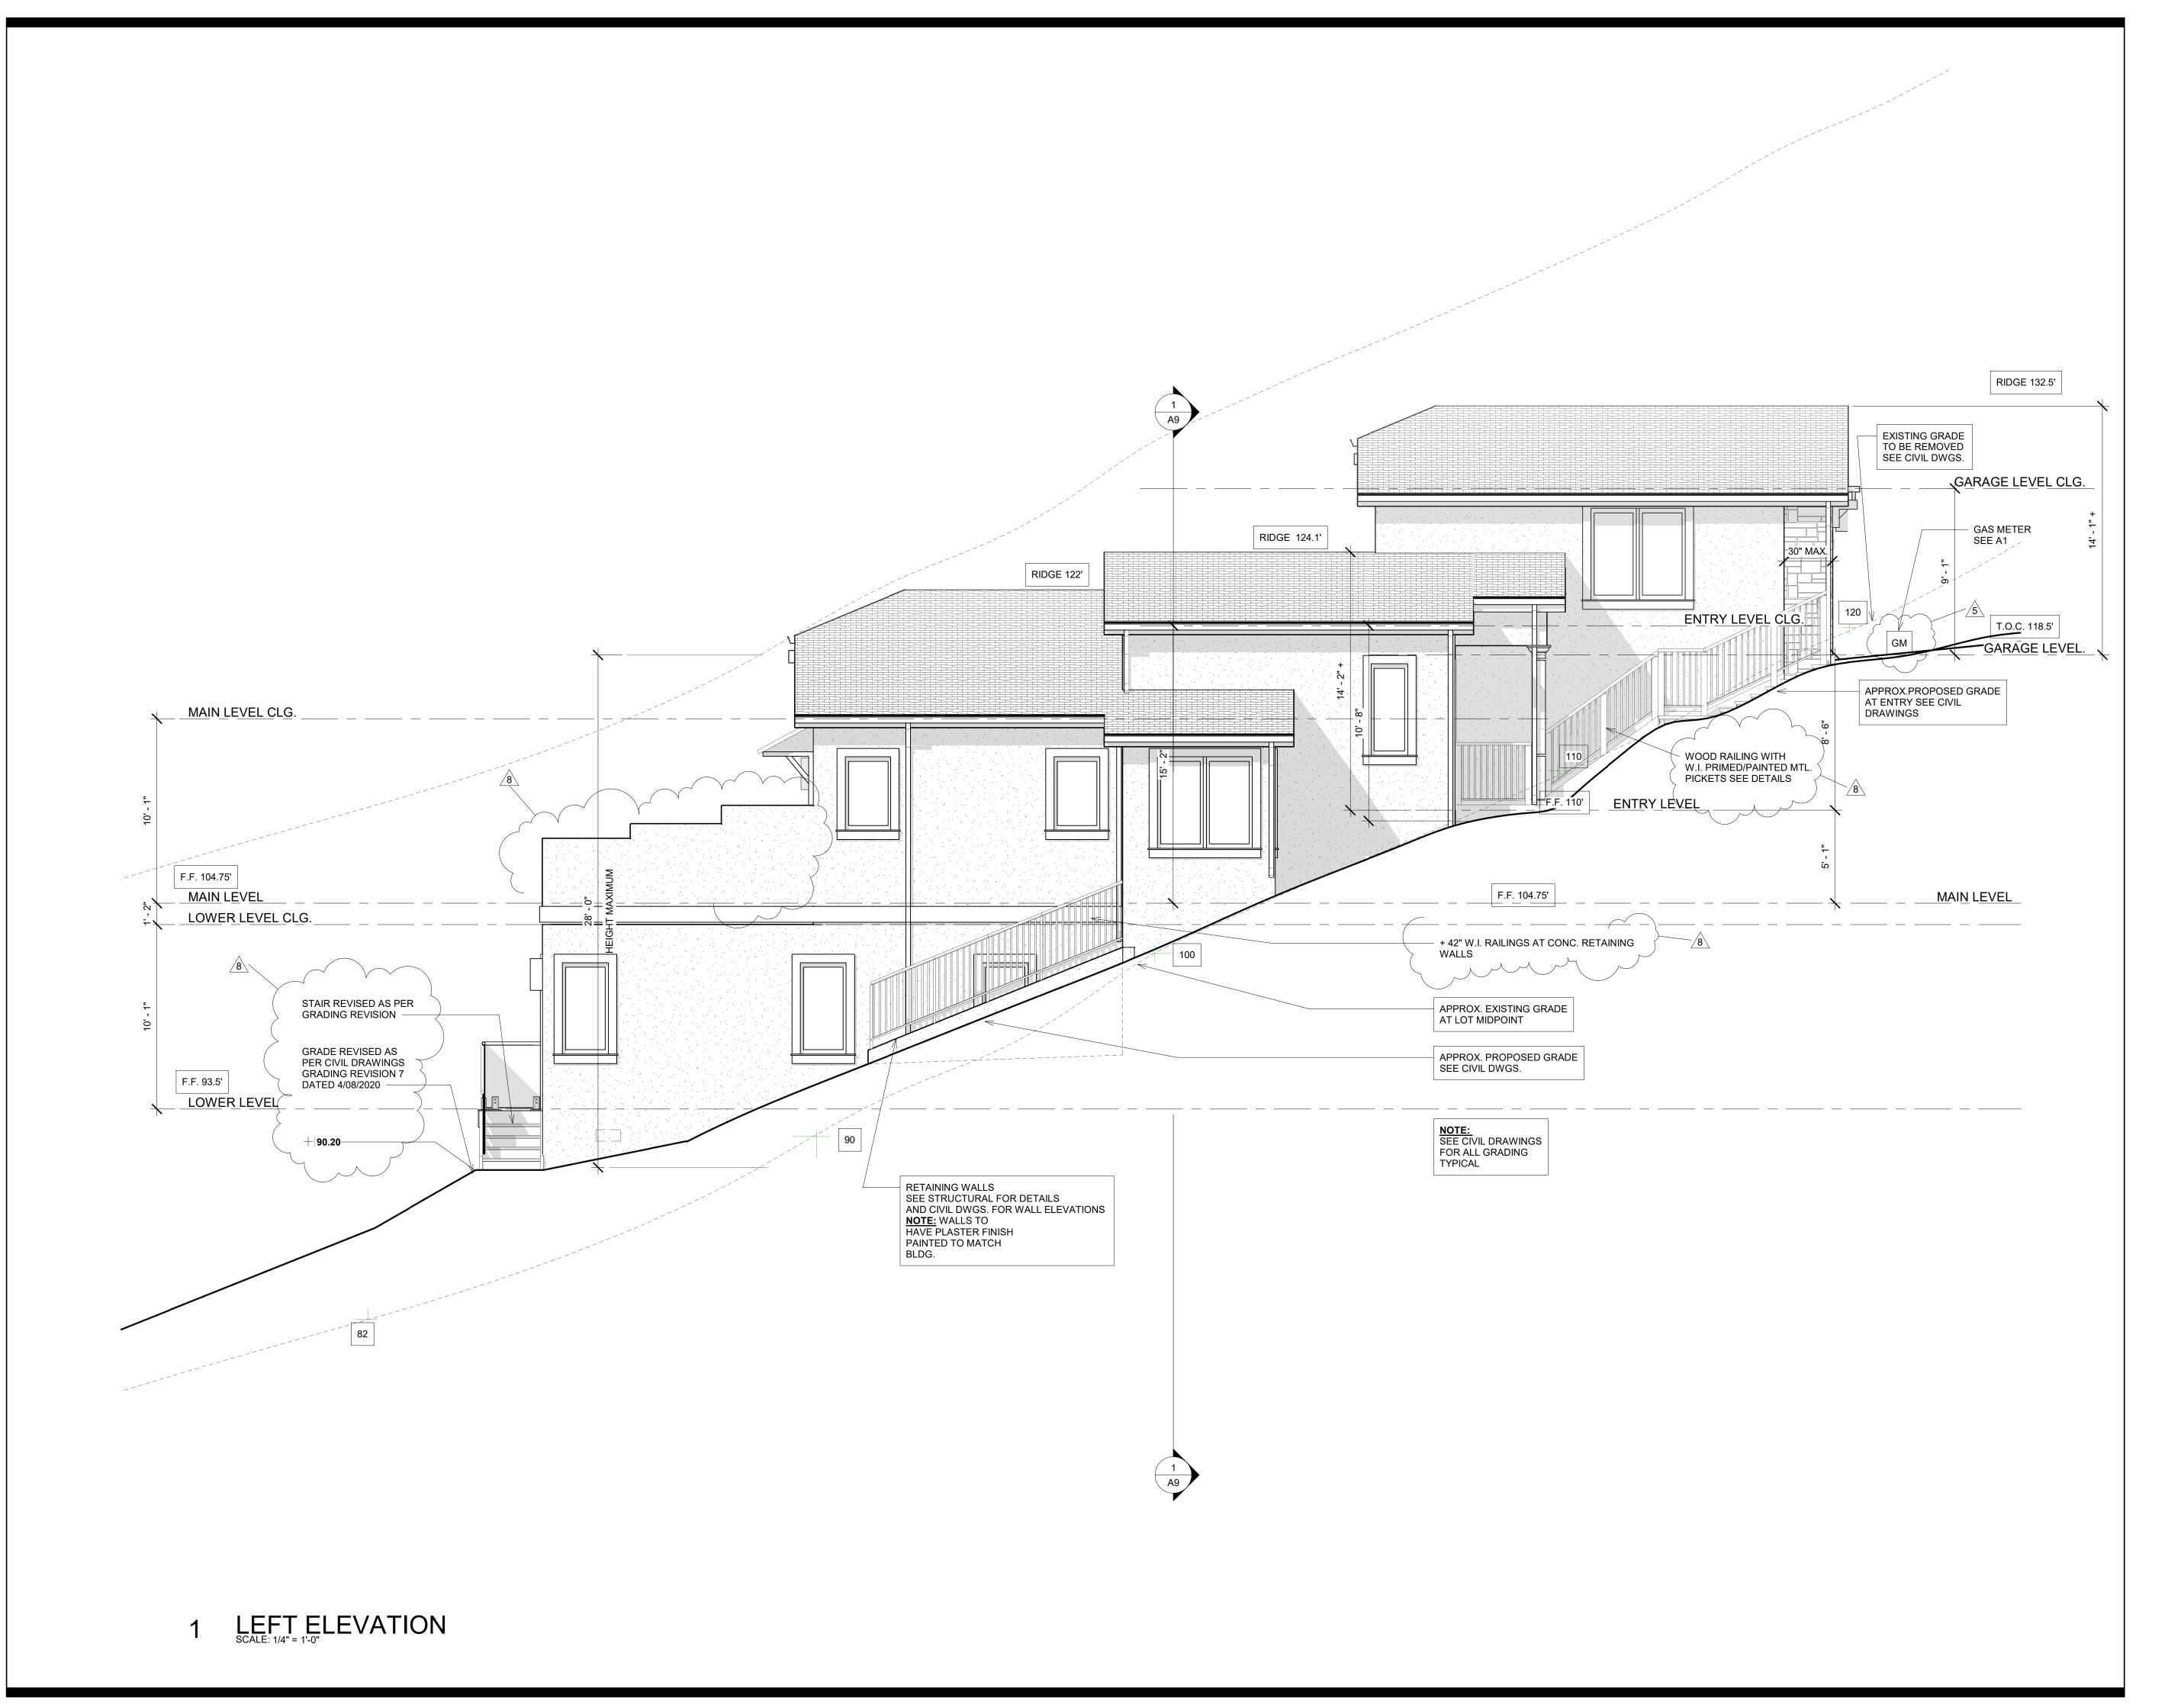

406 LA JOLLA AVENUE SAN MATEO, CA 94403 (650) 218-8161 EMAIL RDS@CHRISTIANRUFFAT.COM

WEB CHRISTIANRUFFAT.COM



ABOLMOLUKI RESIDENCE APN 047-275-050 COLUMBUS ST.


EL GRANADA, CA.

	DESCRIPTION	DATE	BY
	1 PLANNING	8-24-17	CR
SNS	<u></u>		
SIC	3		
REVISIONS	4		
	5 PLAN CHECK RESPONSES	7-1-18	CR
	6 OWNER REVISION	7/31/19	CR
	OWNER REVISION	10/21/19	CR
	8 OWNER REVISION	5/20/20	CR

DATE 10/8/18

Drawing Number

Scale

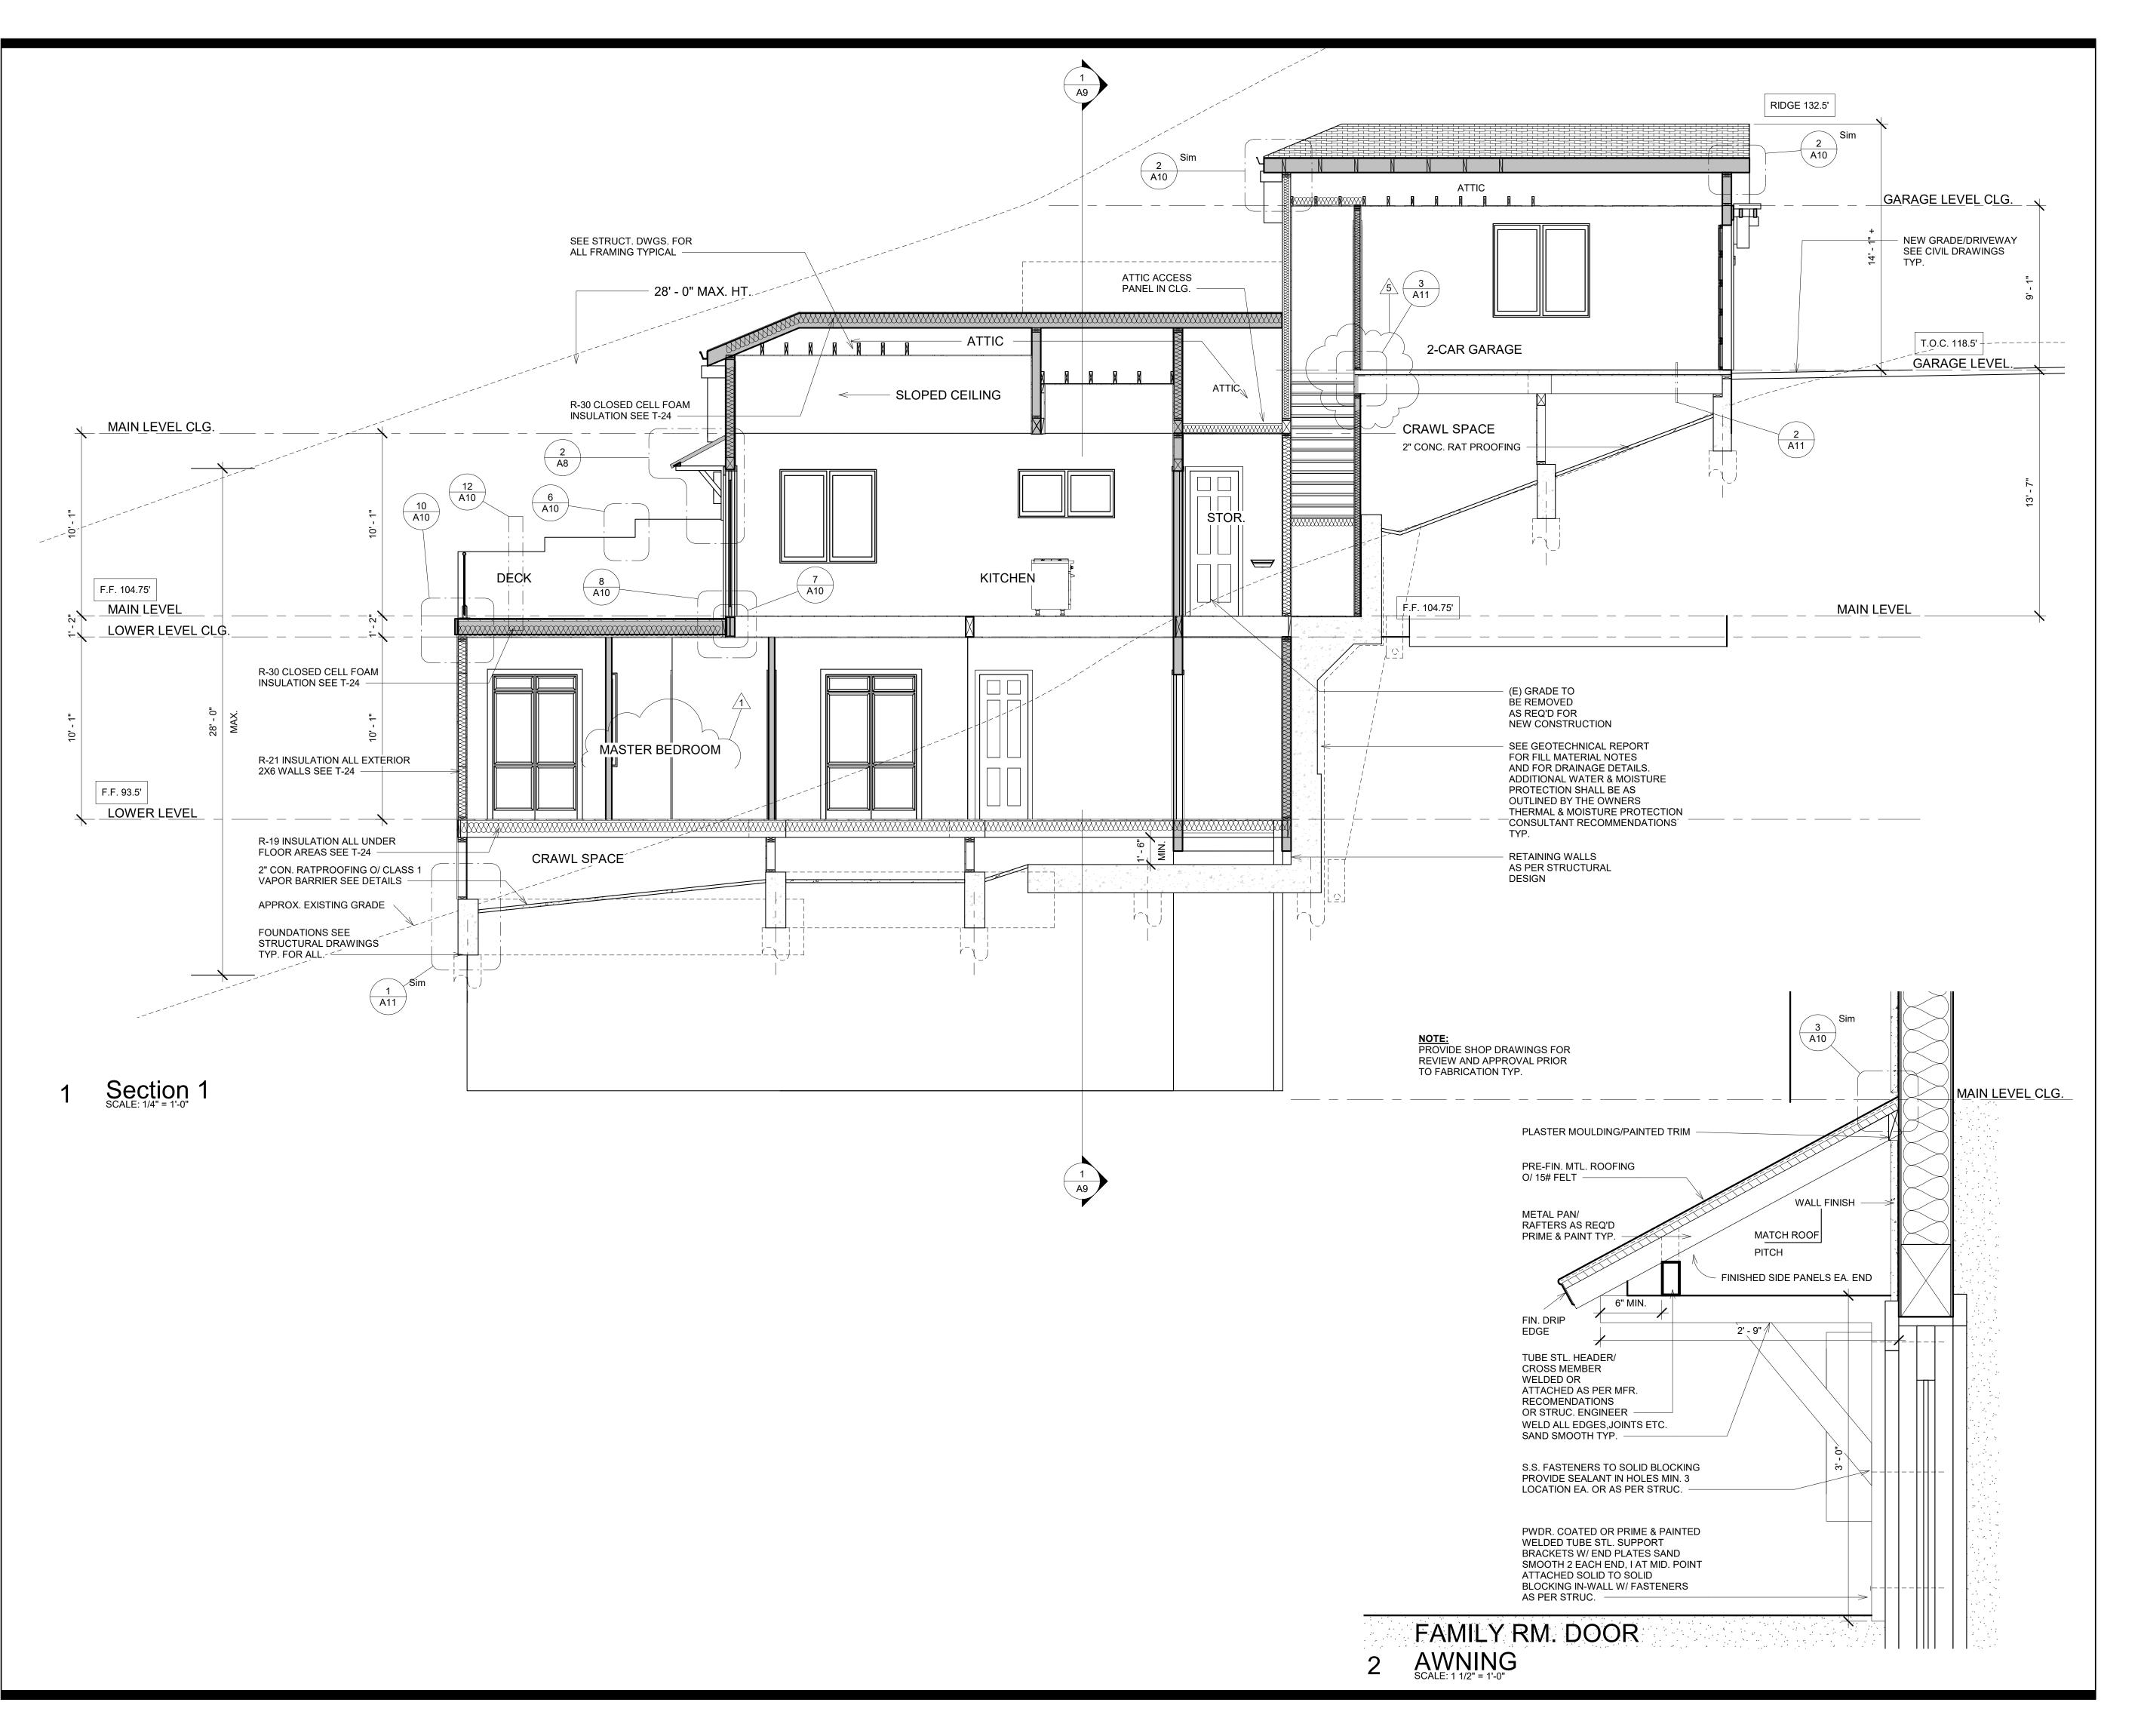



EMAIL RDS@CHRISTIANRUFFAT.COM

WEB CHRISTIANRUFFAT.COM
LIC. # 48803



ABOLMOLUKI RESIDENCE APN 047-275-050 COLUMBUS ST. EL GRANADA, CA.


	DESCRIPTION	DATE	BY
	/1 PLANNING	8-24-17	CR
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"	<u>/</u> 5\		
	<u>/6\</u>		
	OWNER REVISION	10/21/19	CR
	<u>/8\</u>		

DATE 10/8/18 **Drawing Number**


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As indicated


F

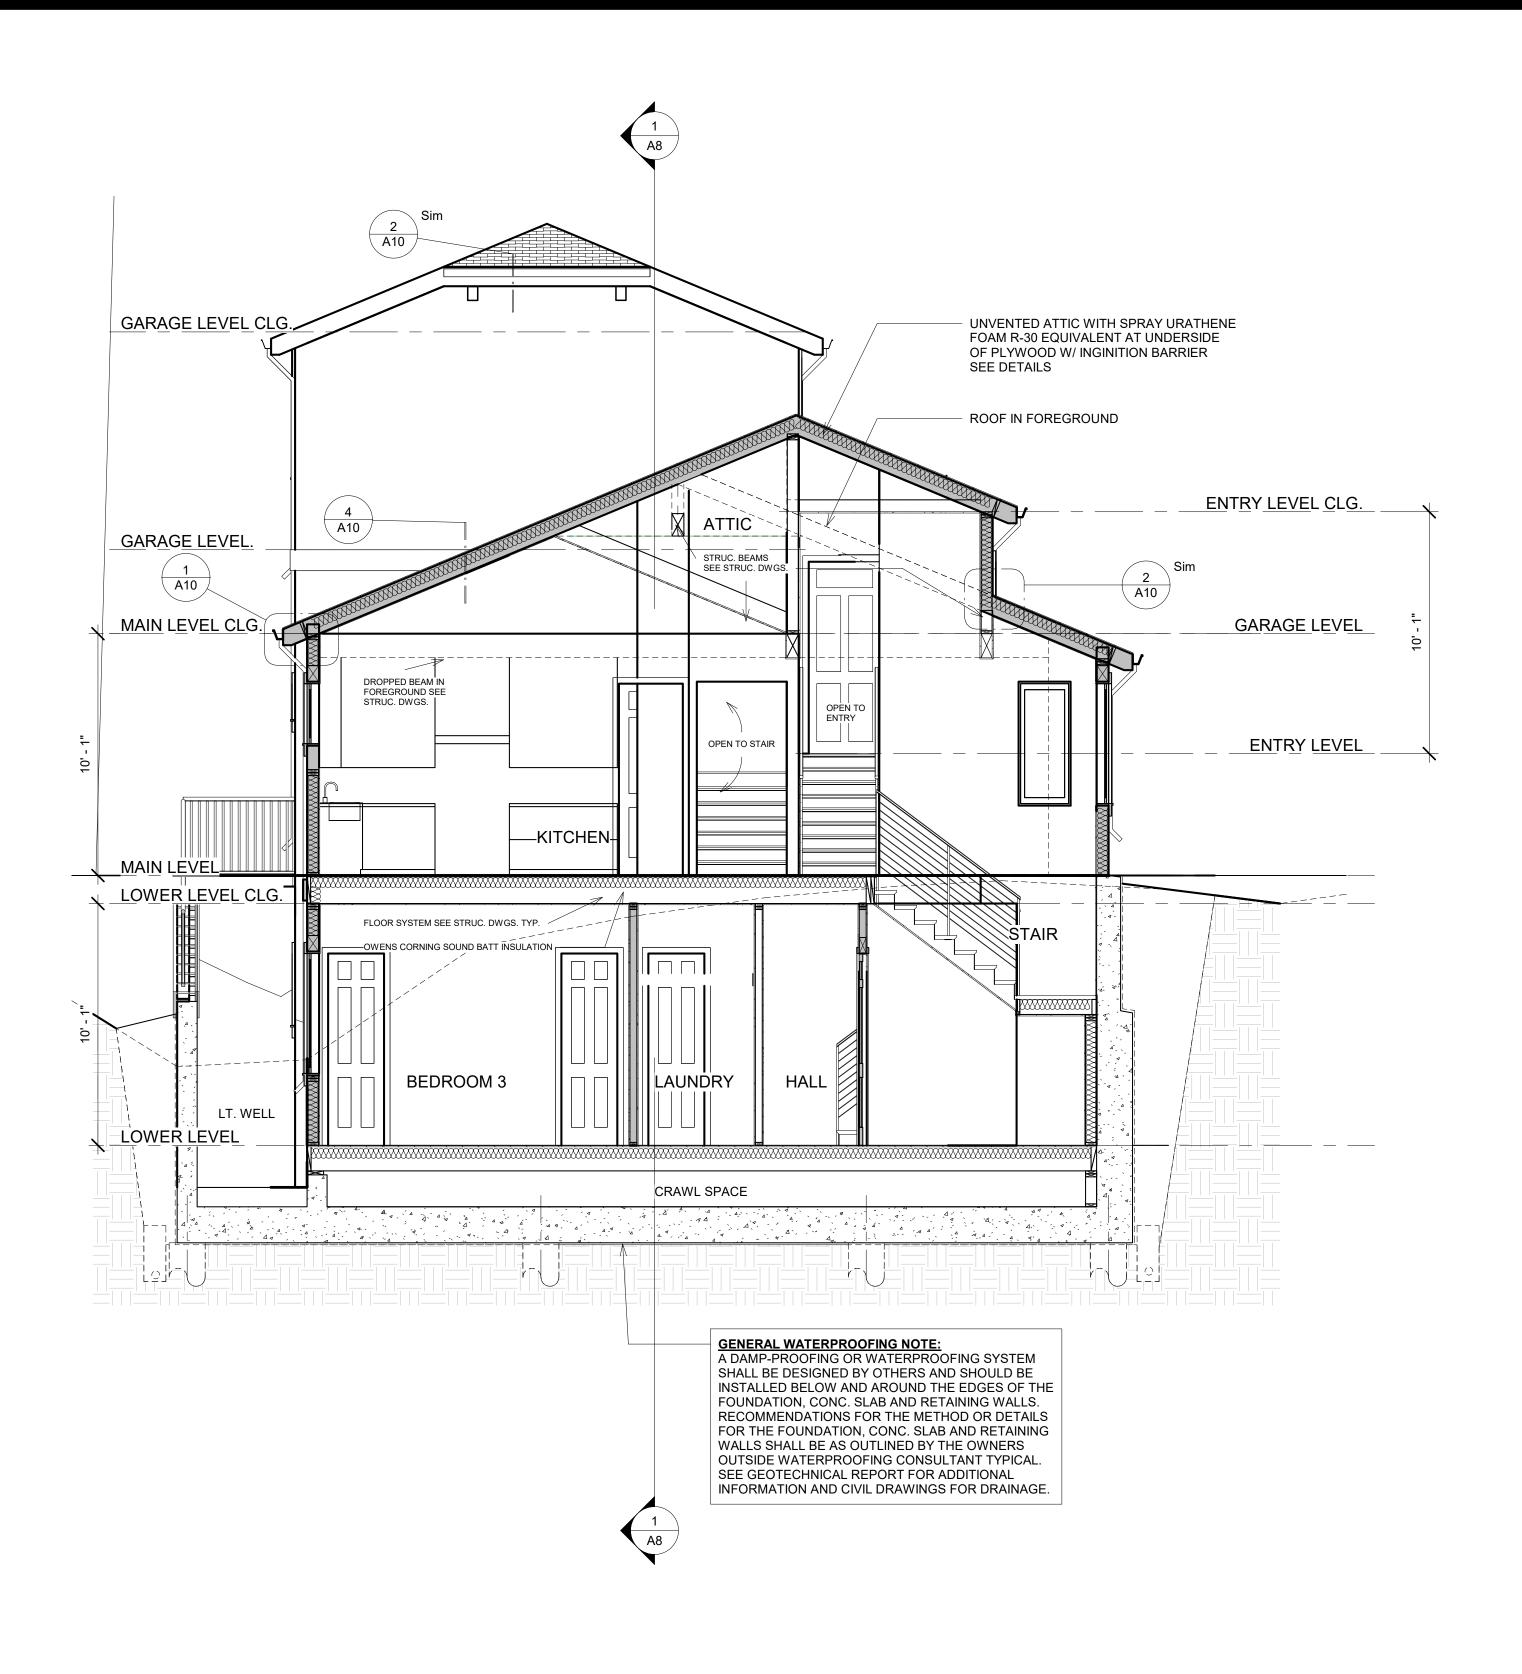

1 Section 2

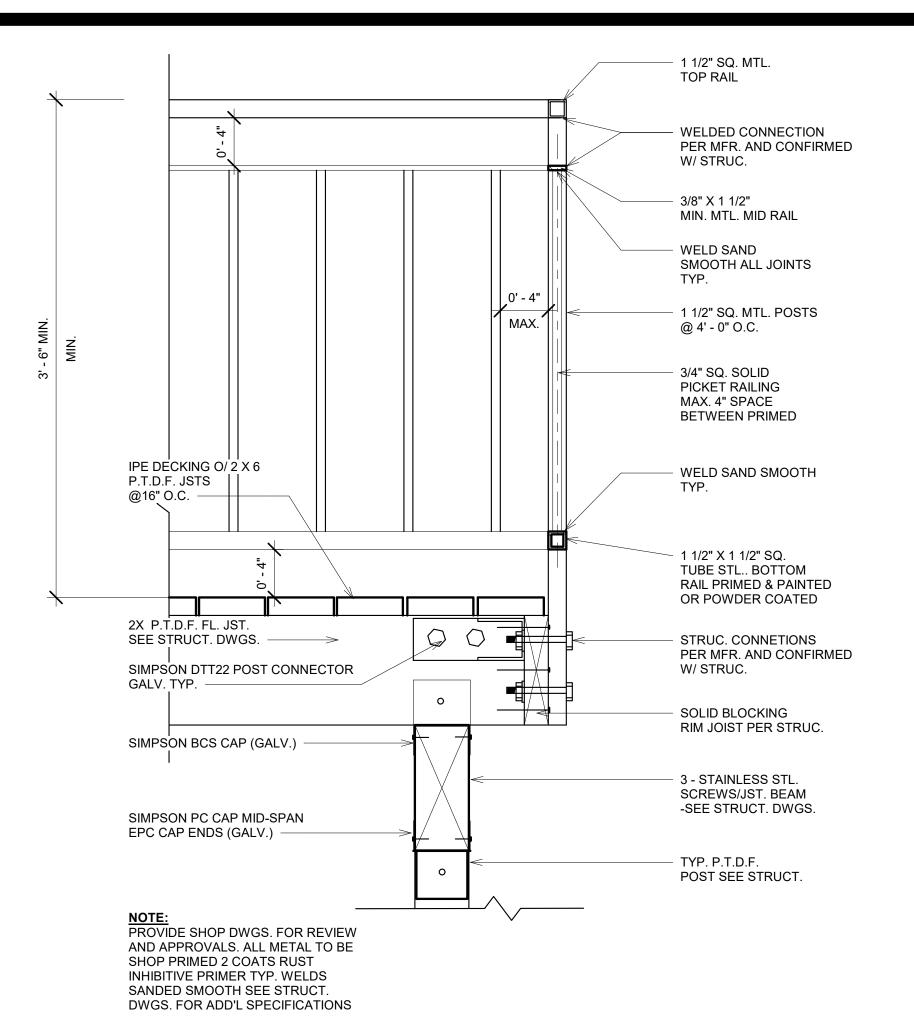

EXTERIOR WOOD RAILING WITH METAL PICKETS

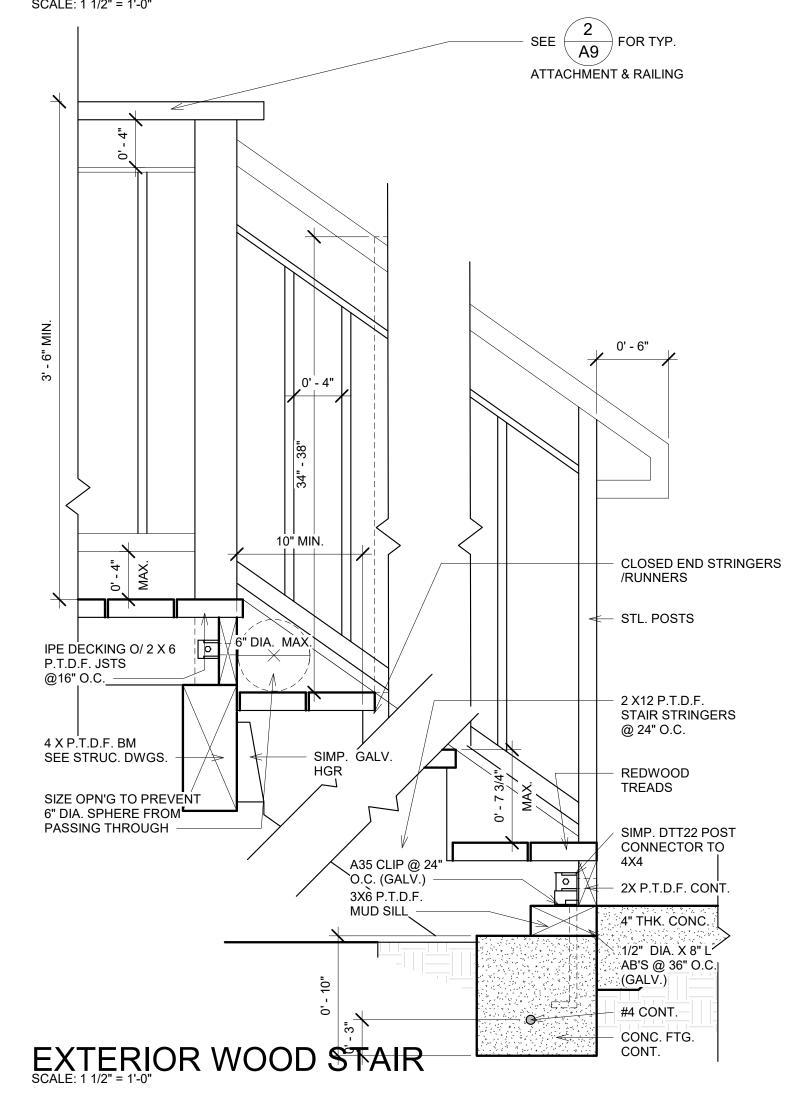



406 LA JOLLA AVENUE
SAN MATEO, CA 94403
(650) 218-8161
EMAIL RDS@CHRISTIANRUFFAT.COM
WEB CHRISTIANRUFFAT.COM



ABOLMOLUKI RESIDENCE APN 047-275-050 COLUMBUS ST.


EL GRANADA, CA.

	DESCRIPTION	DATE	BY
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SIONS	<u>/2\</u>		
REVISIONS	<u>/</u> 3\		
	5		
	<u>∕</u> 6\		
	<u>/7\</u>		
	<u>8</u>		

DATE	Drawing Number
10/8/18	

Scale
As indicated

A9

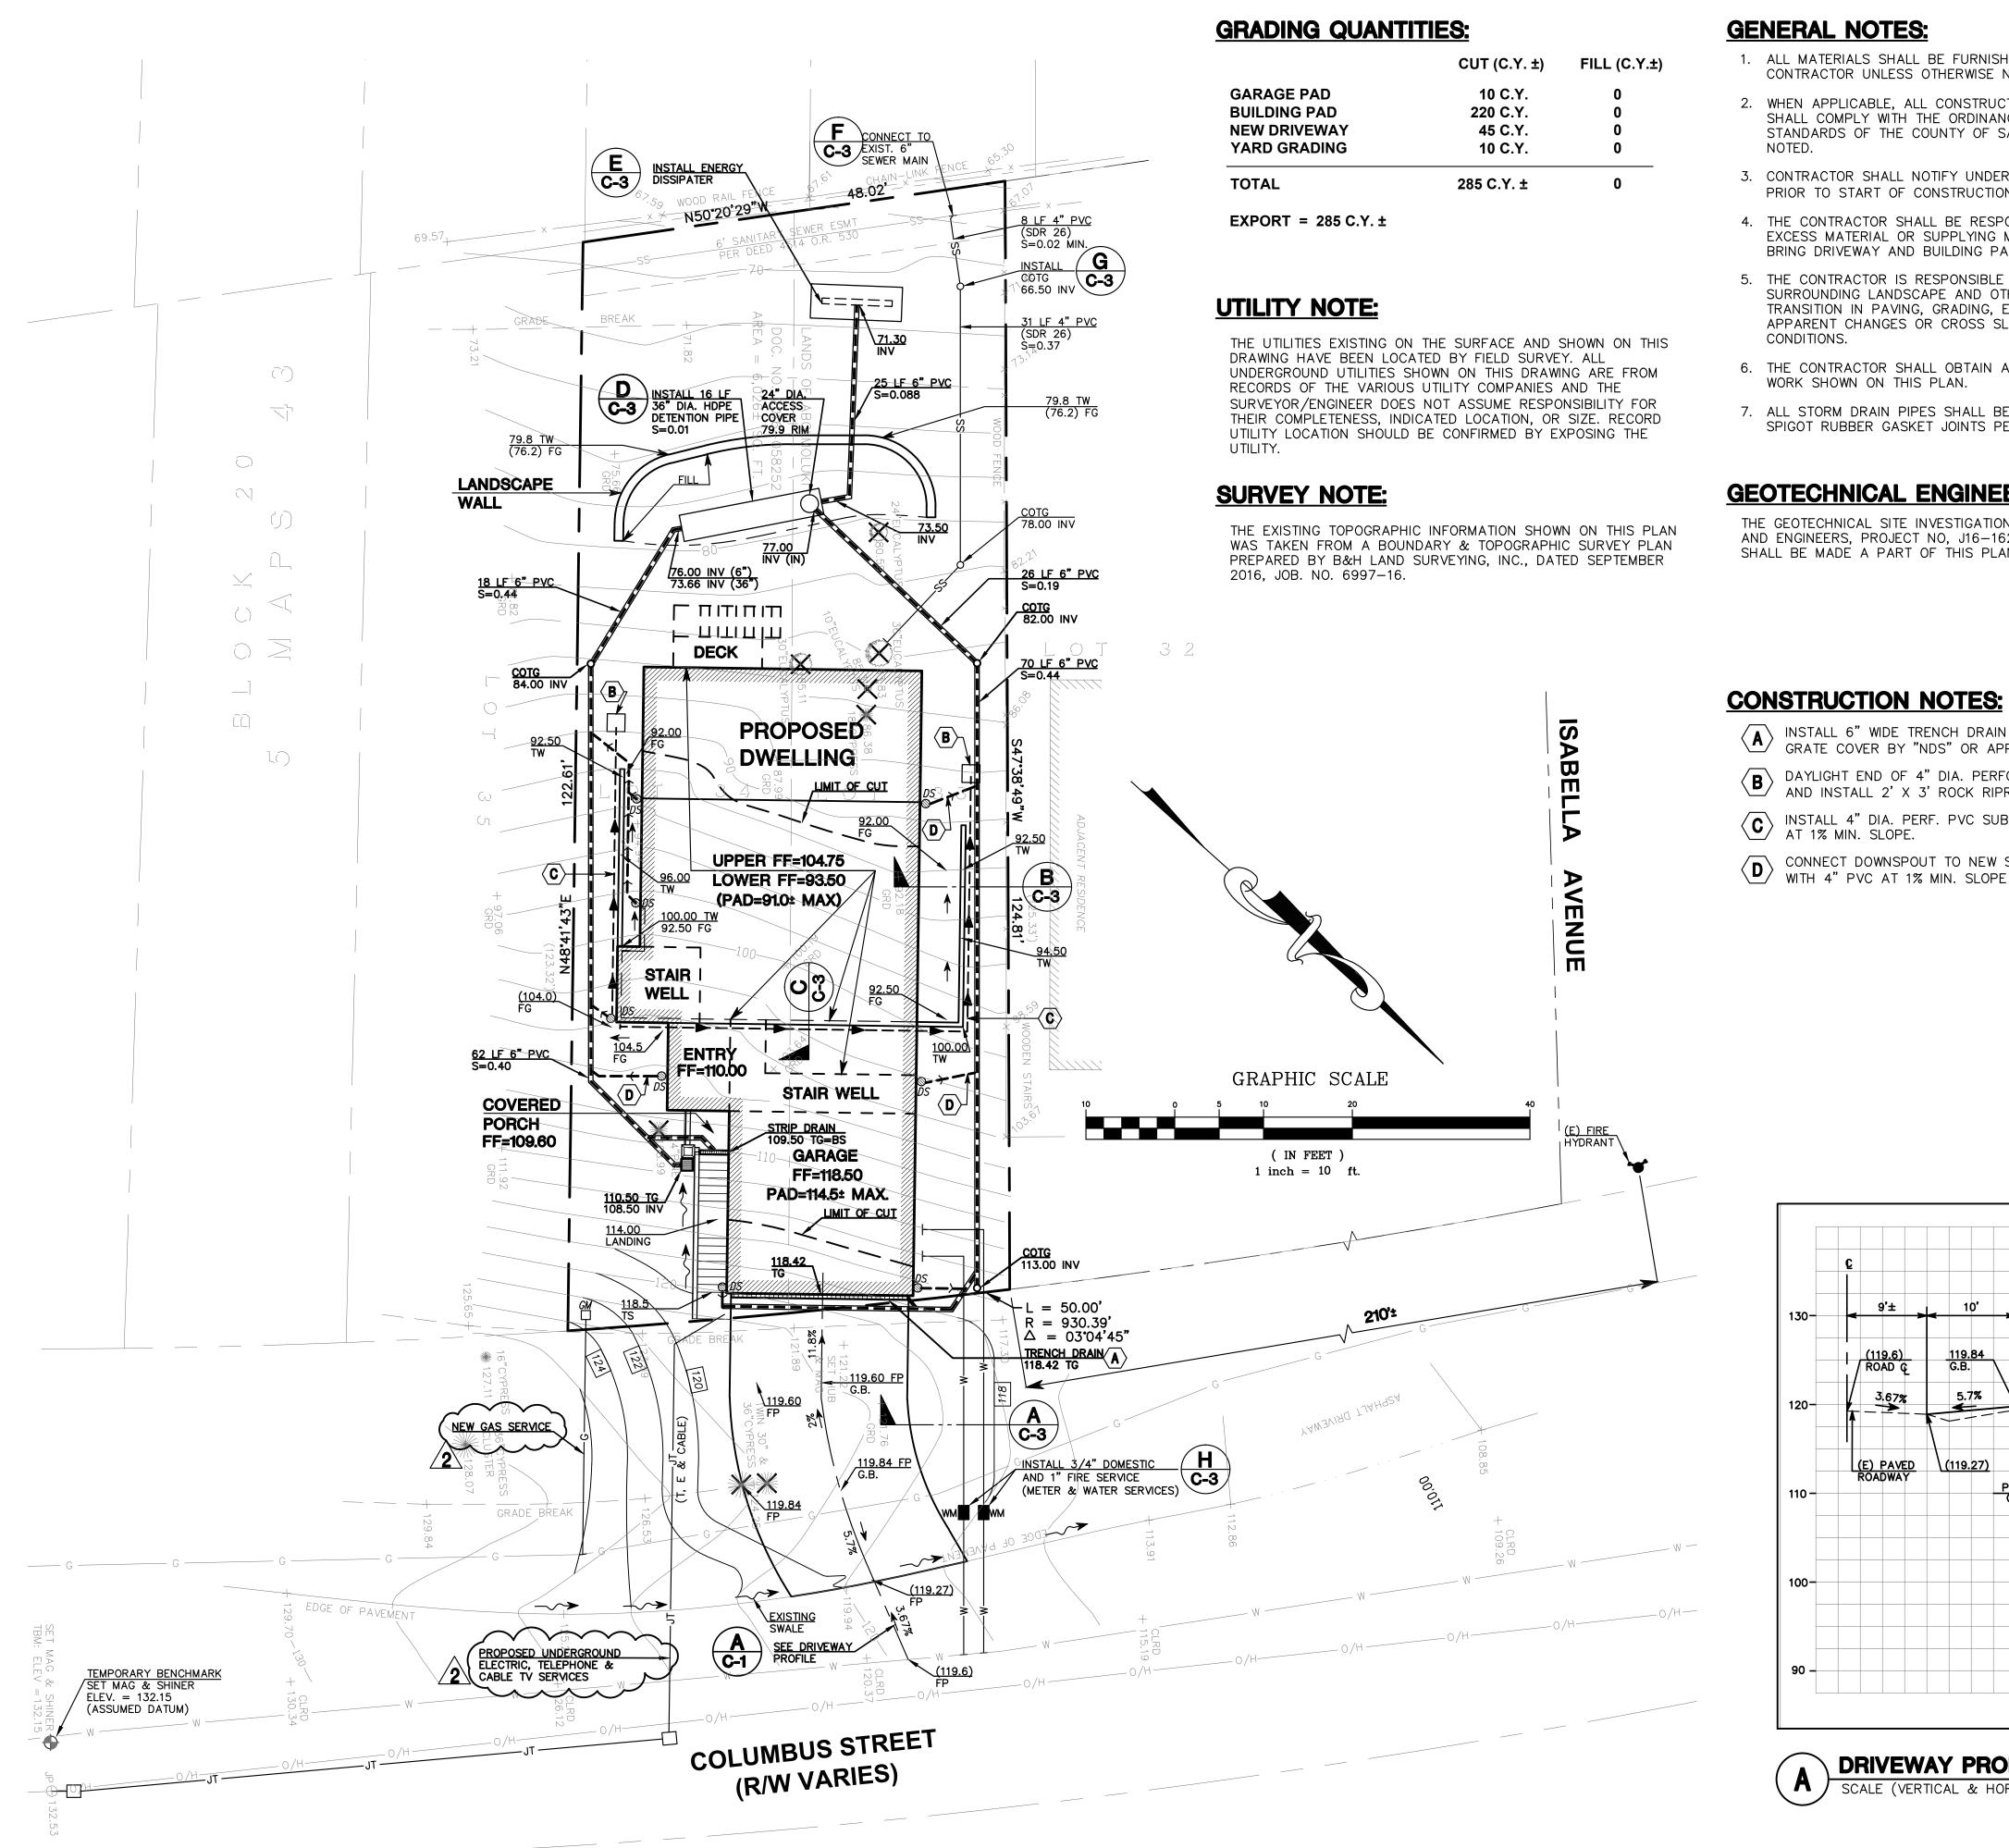

GENERAL NOTES:

- 1. ALL MATERIALS SHALL BE FURNISHED BY AND INSTALLED BY THE CONTRACTOR UNLESS OTHERWISE NOTED.
- 2. WHEN APPLICABLE, ALL CONSTRUCTION MATERIALS AND METHODS SHALL COMPLY WITH THE ORDINANCES, SPECIFICATIONS AND STANDARDS OF THE COUNTY OF SAN MATEO, UNLESS OTHERWISE
- 3. CONTRACTOR SHALL NOTIFY UNDERGROUND SERVICE ALERT (U.S.A.) PRIOR TO START OF CONSTRUCTION. PHONE (800) 642-2444.
- 4. THE CONTRACTOR SHALL BE RESPONSIBLE FOR DISTRIBUTING ANY EXCESS MATERIAL OR SUPPLYING MATERIAL FOR DEFICIENCIES TO BRING DRIVEWAY AND BUILDING PADS TO REQUIRED GRADE.
- 5. THE CONTRACTOR IS RESPONSIBLE FOR MATCHING EXISTING SURROUNDING LANDSCAPE AND OTHER IMPROVEMENTS WITH A SMOOTH TRANSITION IN PAVING, GRADING, ETC., AND TO AVOID ABRUPT OR APPARENT CHANGES OR CROSS SLOPES, LOW SPOTS OR HAZARDOUS CONDITIONS.
- 6. THE CONTRACTOR SHALL OBTAIN ALL NECESSARY PERMITS FOR ALL WORK SHOWN ON THIS PLAN.
- 7. ALL STORM DRAIN PIPES SHALL BE PVC SDR 35 WITH BELL AND SPIGOT RUBBER GASKET JOINTS PER ASTM D3034 OR BETTER.

GEOTECHNICAL ENGINEER'S NOTE:

THE GEOTECHNICAL SITE INVESTIGATION REPORT PREPARED BY J. YANG AND ENGINEERS, PROJECT NO, J16-1625, DATED JANUARY 25, 2017, SHALL BE MADE A PART OF THIS PLAN.


- INSTALL 6" WIDE TRENCH DRAIN WITH TRAFFIC RATED GRATE COVER BY "NDS" OR APPROVED EQUAL.
- B DAYLIGHT END OF 4" DIA. PERFORATED PVC PIPE AND INSTALL 2' X 3' ROCK RIPRAP DISSIPATER. AND INSTALL 2' X 3' ROCK RIPRAP DISSIPATER.
- (C) INSTALL 4" DIA. PERF. PVC SUBDRAIN PIPE AT 1% MIN. SLOPE. AT 1% MIN. SLOPE.
- CONNECT DOWNSPOUT TO NEW STORM DRAIN PIPE WITH 4" PVC AT 1% MIN. SLOPE (TYPICAL).

DRIVEWAY PROFILE

SCALE (VERTICAL & HORIZONTAL): 1"=10"

GRADING PLAN LEGEND:

BS	BOTTOM OF STEP
COTG	CLEANOUT TO GRADE
DS ∅	DOWNSPOUT
FF	FINISH FLOOR
FG	FINISH GRADE
FL	FLOWLINE
FP	FINISH PAVE
GB	GRADE BREAK
INV	INVERT
TG	TOP OF GRATE
TS	TOP OF STEP
TW	TOP OF WALL
WM	WATER METER
SS	SANITARY SEWER LINE
	WATER LINE
120	NEW CONTOUR
JT	JOINT TRENCH
G	GAS LINE
	NEW STORM DRAIN LINI

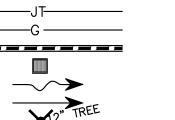

NEW DRAIN INLET SWALE SURFACE RUNOFF FLOW DIRECTION EXIST. TREE TO BE REMOVED


EXIST. GRADE



(M)

SURVEY LEGEND:

GARAGE FF=118.50

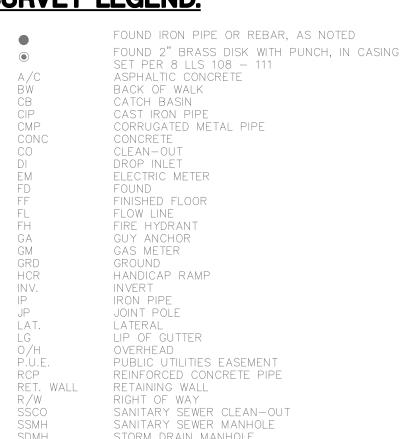


FF=104.75


DESIGNED BY: CHECKED BY:

SCALE: DATE: 08/24/18 DRAWING NO. 4452-GRAD

Originally Approved Grading Plans (2018) C-1

(M) $\overline{\mathbb{Q}}$ \triangleleft \bigcirc $\widetilde{\mathbb{M}}$ \square

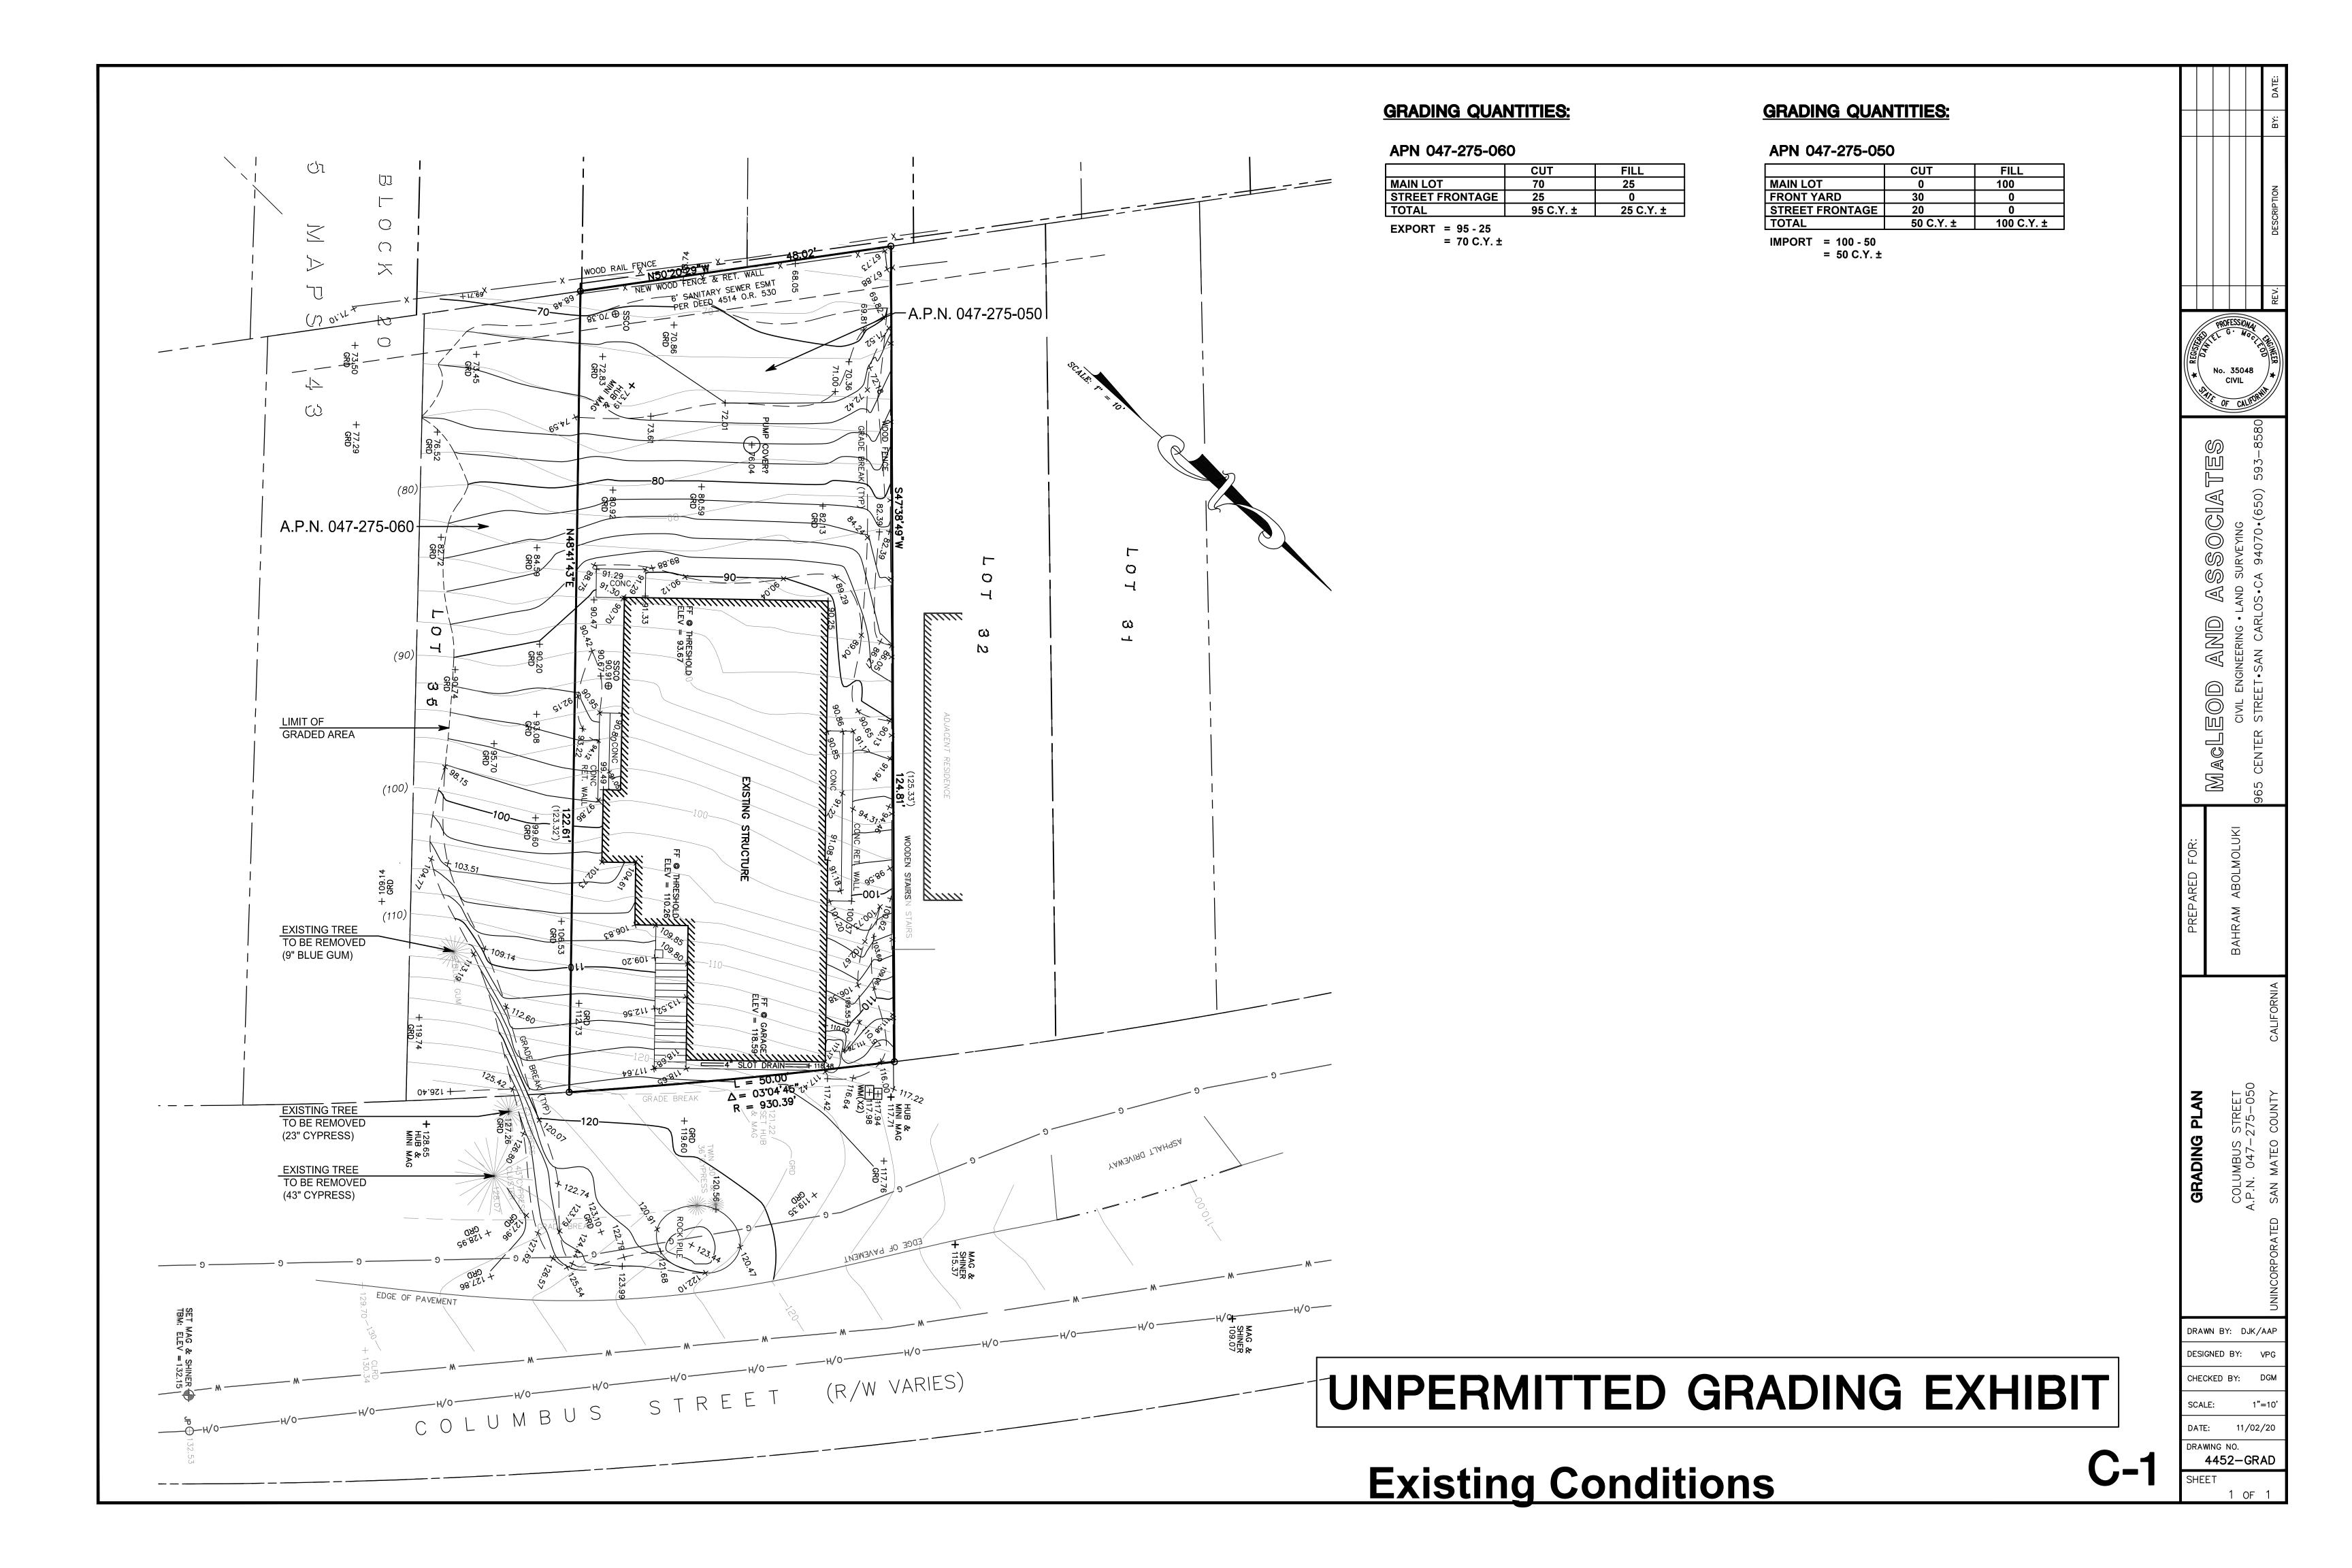

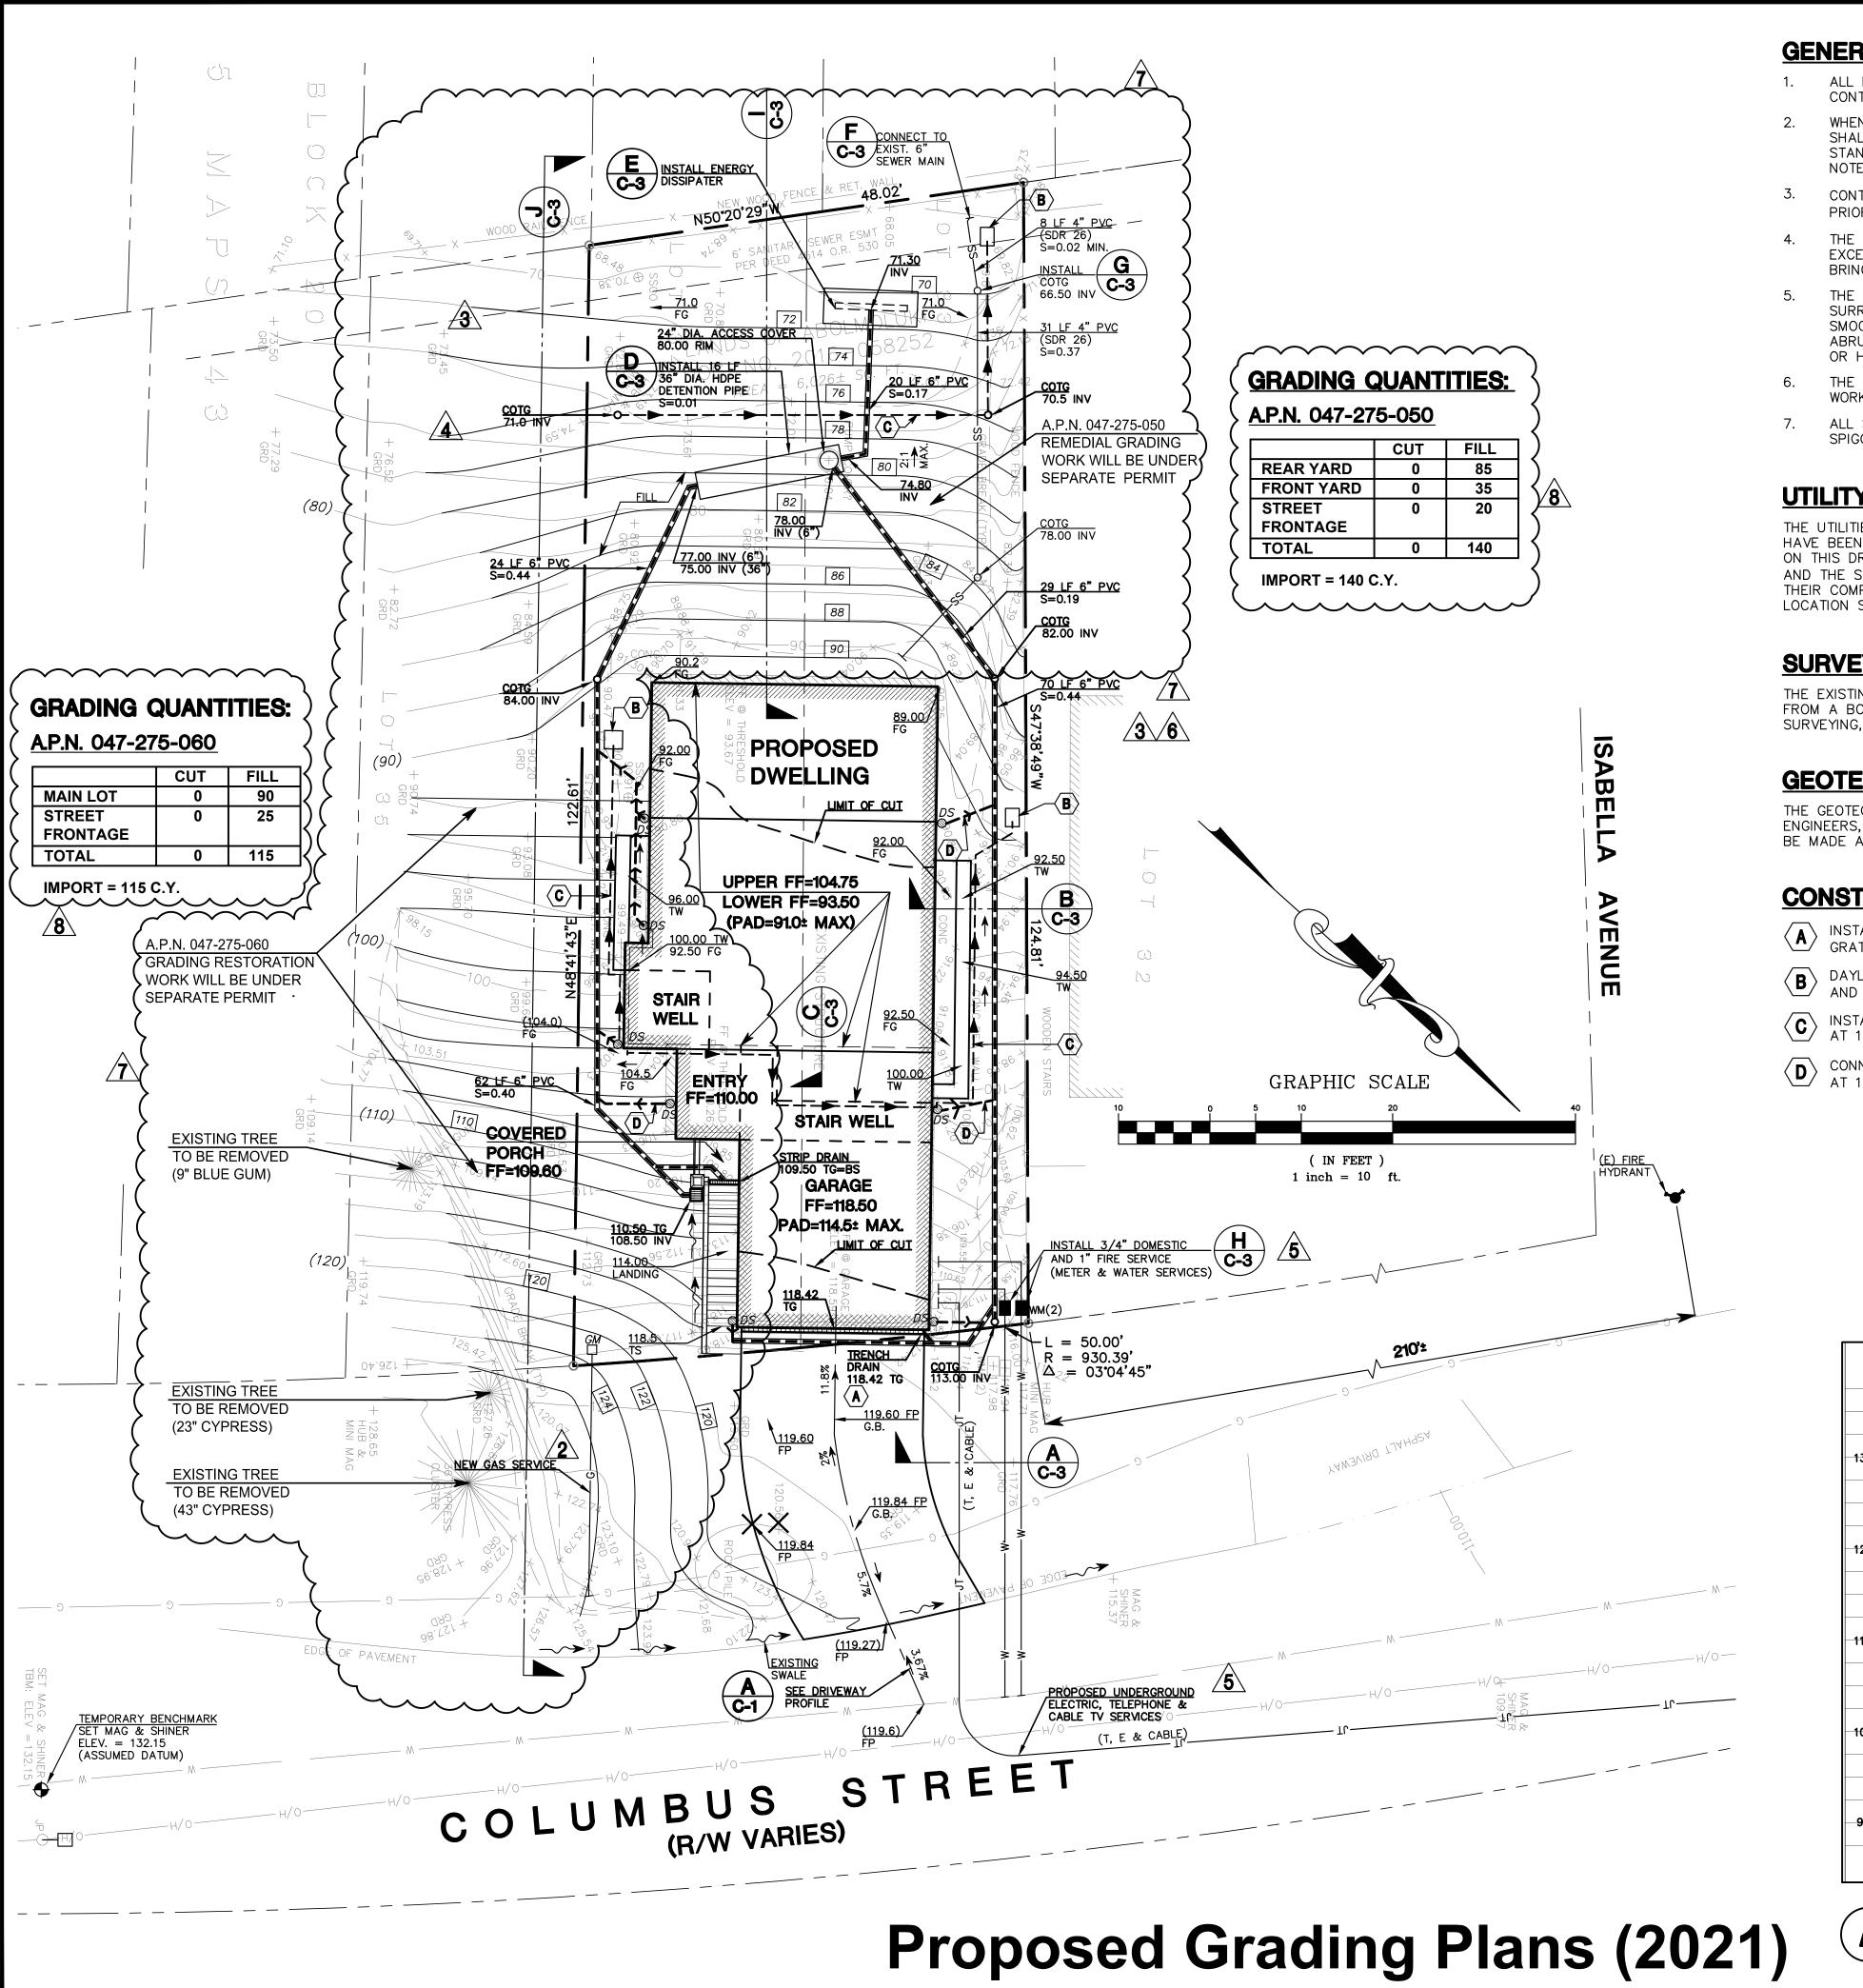

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- THE CONTRACTOR SHALL OBTAIN ALL NECESSARY PERMITS FOR ALL WORK SHOWN ON THIS PLAN.
- 7. ALL STORM DRAIN PIPES SHALL BE PVC SDR 35 WITH BELL AND SPIGOT RUBBER GASKET JOINTS PER ASTM D3034 OR BETTER.

UTILITY NOTE:

THE UTILITIES EXISTING ON THE SURFACE AND SHOWN ON THIS DRAWING HAVE BEEN LOCATED BY FIELD SURVEY. ALL UNDERGROUND UTILITIES SHOWN ON THIS DRAWING ARE FROM RECORDS OF THE VARIOUS UTILITY COMPANIES AND THE SURVEYOR/ENGINEER DOES NOT ASSUME RESPONSIBILITY FOR THEIR COMPLETENESS, INDICATED LOCATION, OR SIZE. RECORD UTILITY LOCATION SHOULD BE CONFIRMED BY EXPOSING THE UTILITY.

SURVEY NOTE:

THE EXISTING TOPOGRAPHIC INFORMATION SHOWN ON THIS PLAN WAS TAKEN FROM A BOUNDARY & TOPOGRAPHIC SURVEY PLAN PREPARED BY B&H LAND SURVEYING, INC., DATED SEPTEMBER 2016, JOB. NO. 6997-16.

GEOTECHNICAL ENGINEER'S NOTE:


THE GEOTECHNICAL SITE INVESTIGATION REPORT PREPARED BY J. YANG AND ENGINEERS, PROJECT NO, J16-1625, DATED JANUARY 25, 2017, SHALL BE MADE A PART OF THIS PLAN.

CONSTRUCTION NOTES:

- INSTALL 6" WIDE TRENCH DRAIN WITH TRAFFIC RATED GRATE COVER BY "NDS" OF APPROVED FOUND GRATE COVER BY "NDS" OR APPROVED EQUAL
- B DAYLIGHT END OF 4" DIA. PERFORATED PVC PIPE AND INSTALL 2' X 3' ROCK RIPRAP DISSIPATER. AND INSTALL 2' X 3' ROCK RIPRAP DISSIPATER.
- C INSTALL 4" DIA. PERF. PVC SUBDRAIN PIPE AT 1% MIN. SLOPE. AT 1% MIN. SLOPE.
- CONNECT DOWNSPOUT TO NEW STORM DRAIN PIPE WITH 4" PVC AT 1% MIN. SLOPE (TYPICAL).

GRADING PLAN I FGFND-

<u>ADING PLAN LEGE</u>	<u>ND:</u>
SS COTG	BOTTOM OF STEP CLEANOUT TO GRADE
)S Ø	DOWNSPOUT
F	FINISH FLOOR
-G	FINISH GRADE
·L	FLOWLINE
⁻ P	FINISH PAVE
BB .	GRADE BREAK
VV	INVERT
⁻ G	TOP OF GRATE
S	TOP OF STEP
TW .	TOP OF WALL
VM	WATER METER
SS	SANITARY SEWER LINE
	WATER LINE
120	NEW CONTOUR
	JOINT TRENCH

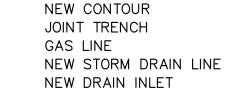


SURFACE RUNOFF FLOW DIRECTION EXIST. TREE TO BE REMOVED EXIST. GRADE


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8 1-0 0 4 6

SURVEY LEGEND:

GARAGE FF=118.50



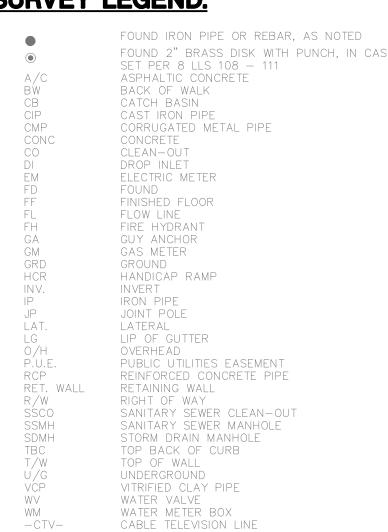


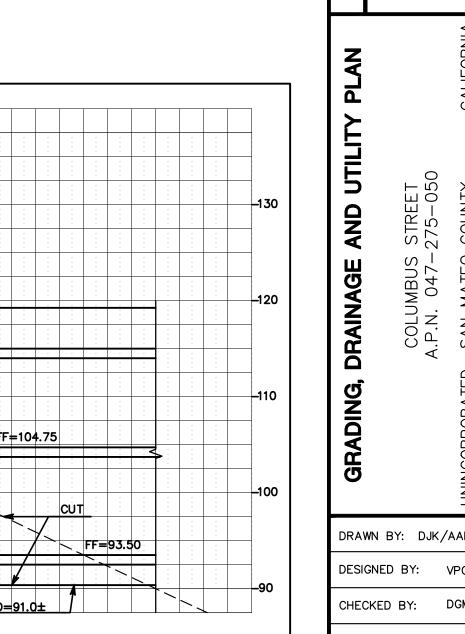

DATE: 08/24/18

4452-GRAD

RAWING NO.

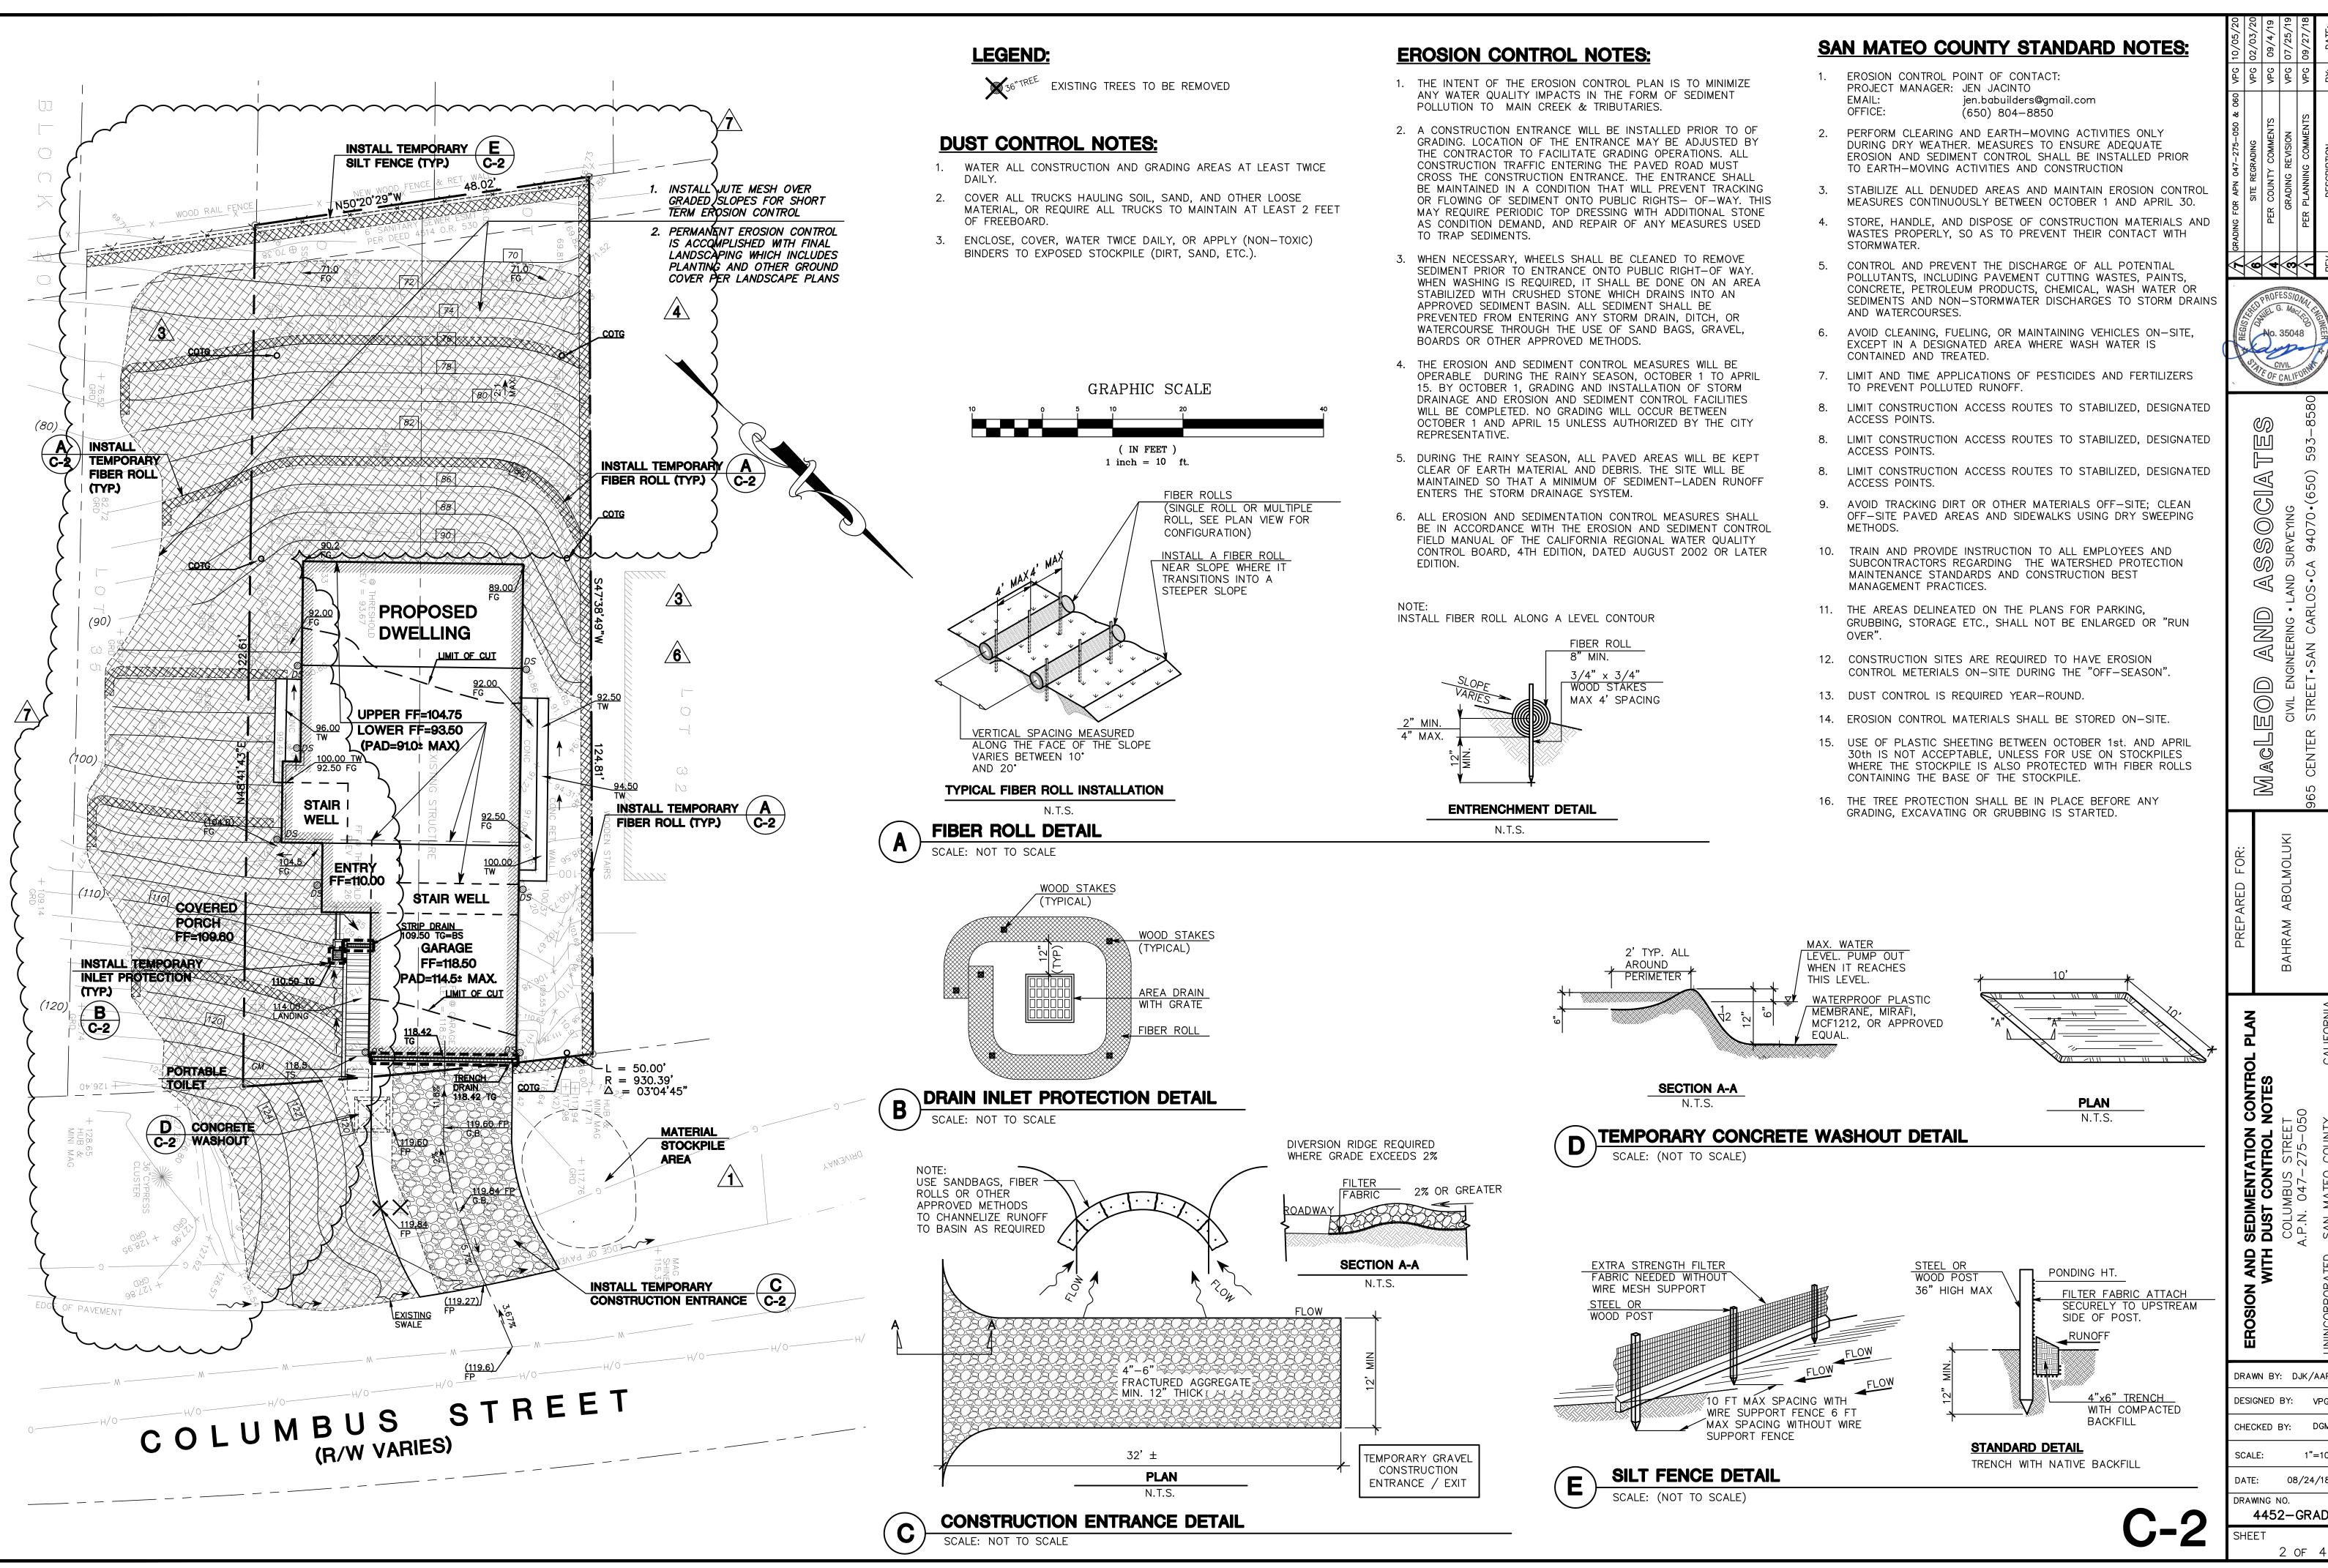


No. 35048

DRAWN BY: DJK/AAF

DESIGNED BY: VP(CHECKED BY: DGM

DATE: 08/24/18

4452-GRAD

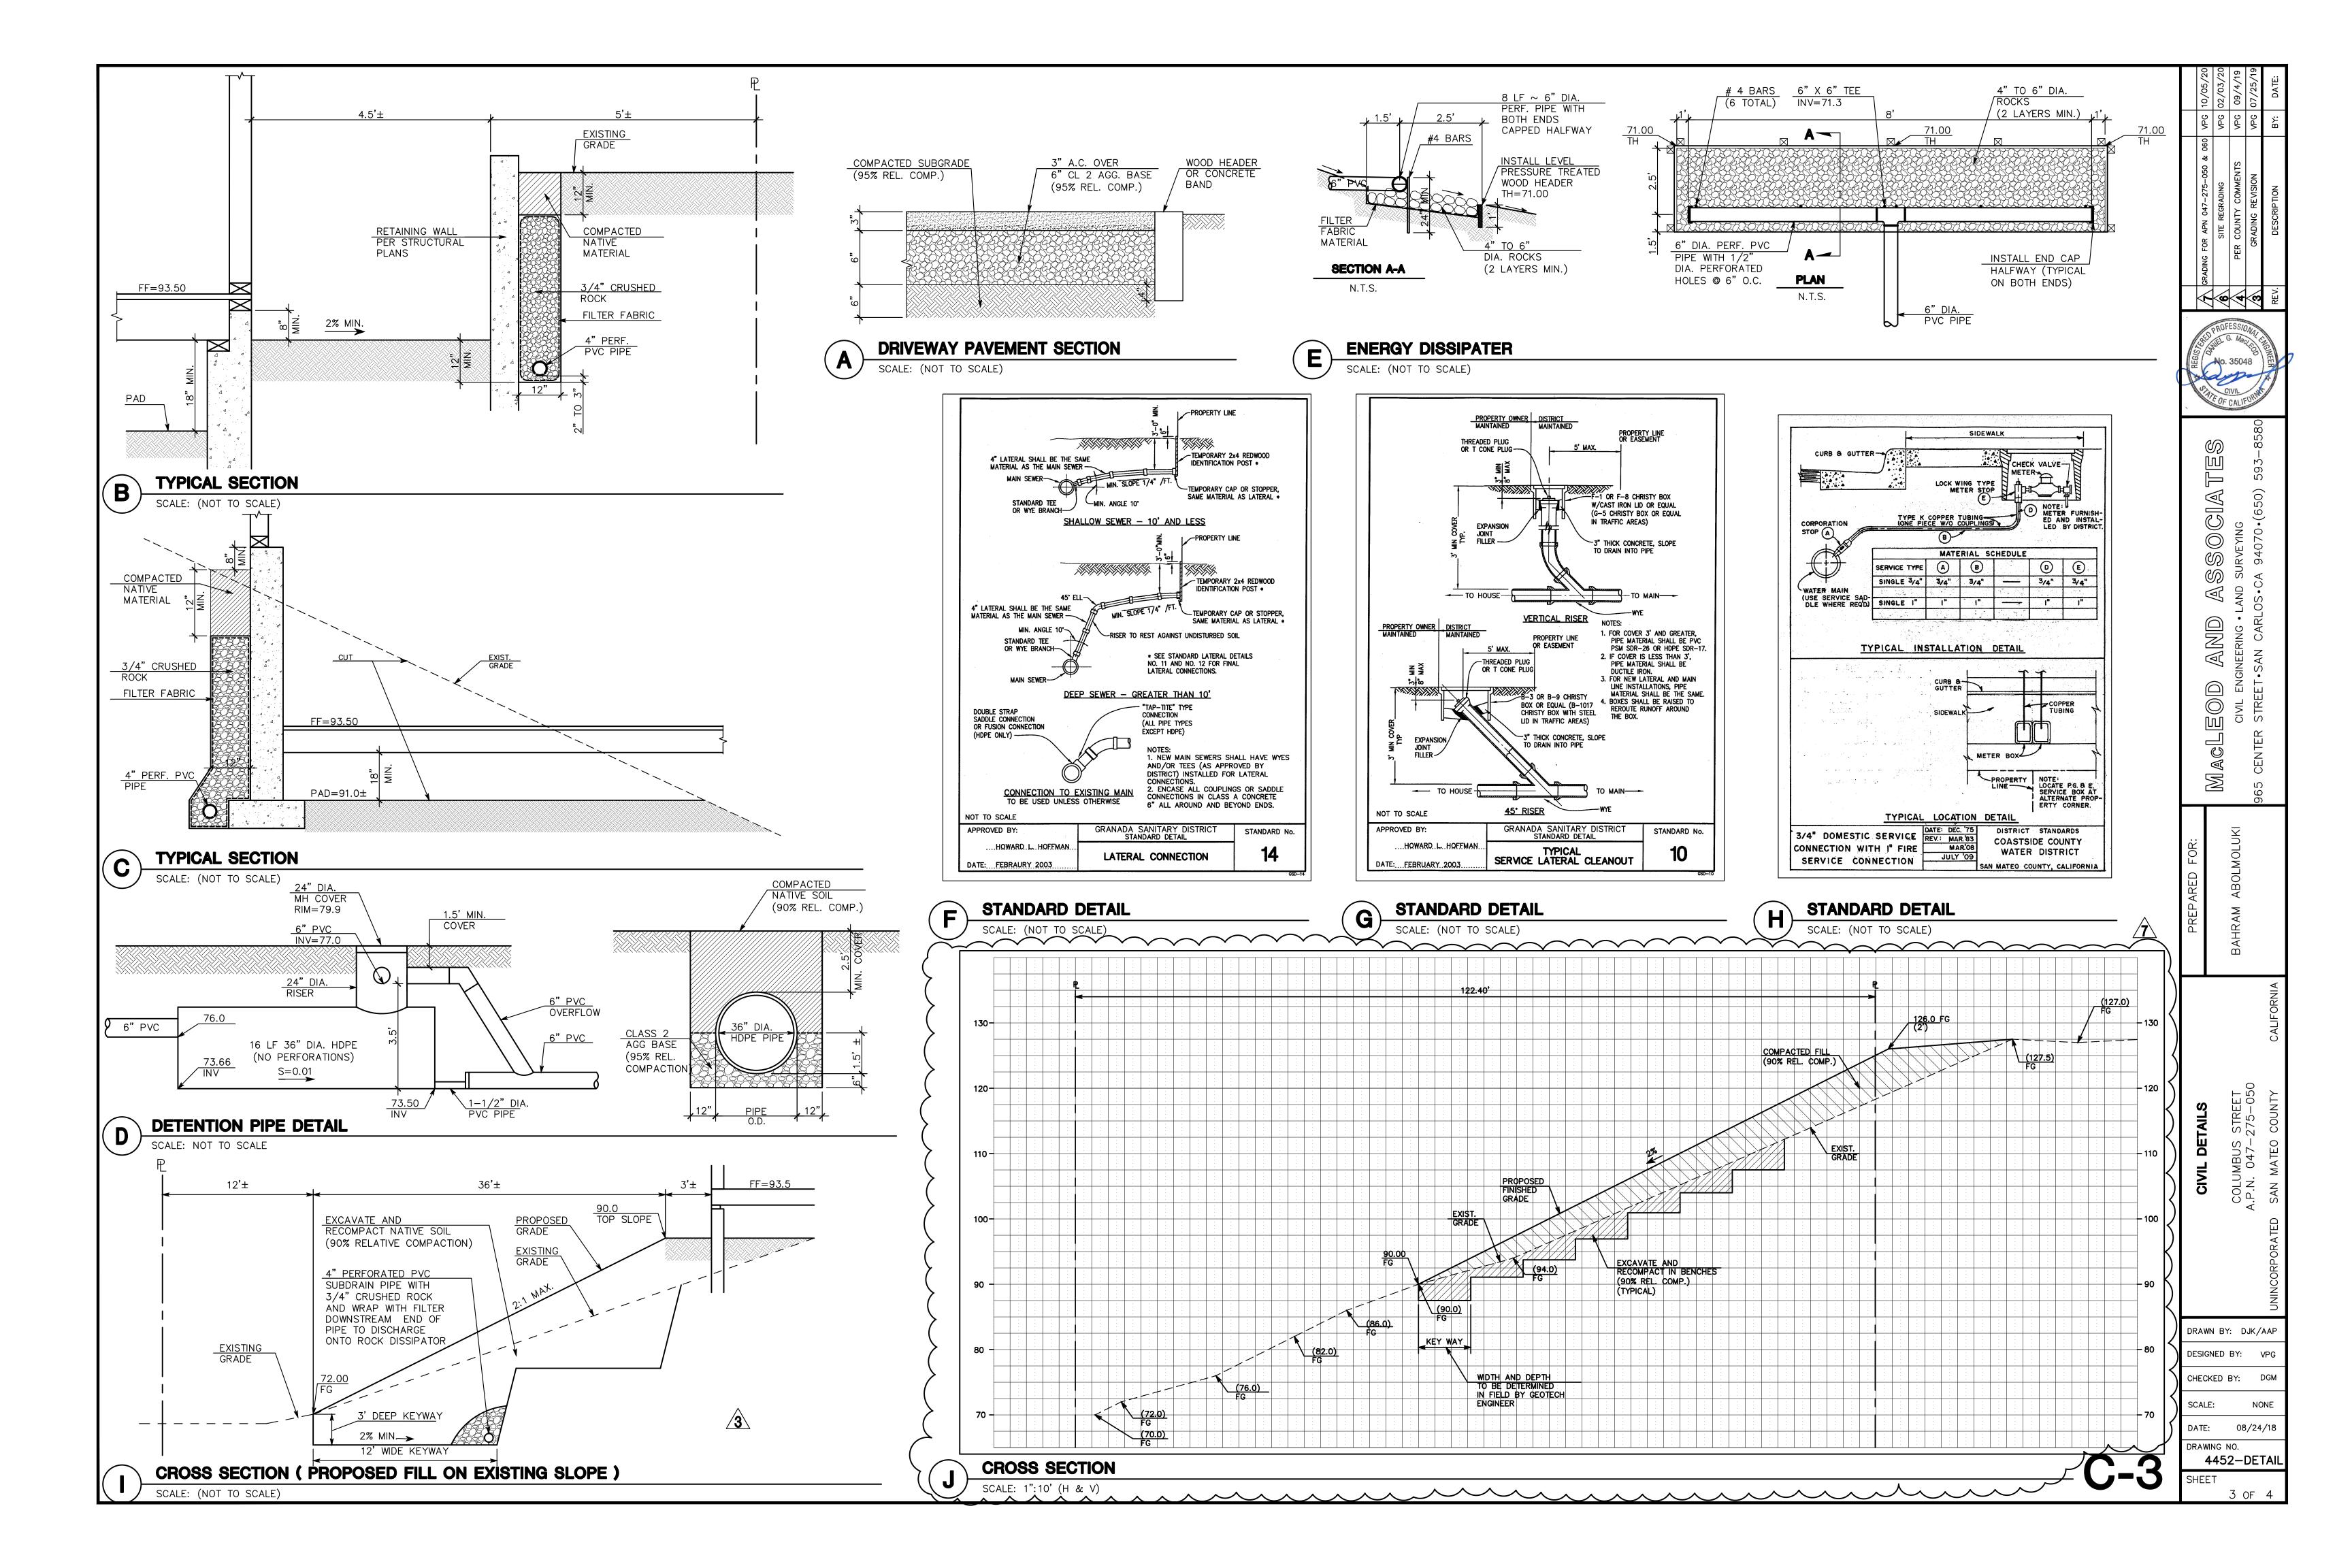




Construction Best Management Practices (BMPs)

Construction projects are required to implement the stormwater best management practices (BMP) on this page, as they apply to your project, all year long.

Clean Water. Healthy Community.

Materials & Waste Management

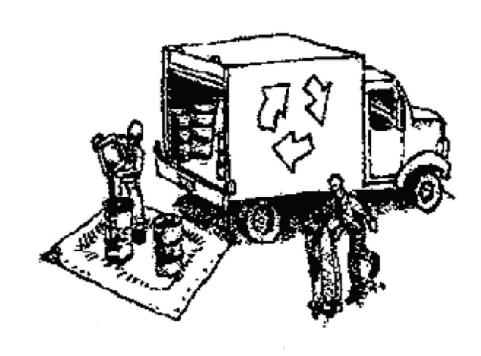

Non-Hazardous Materials

- ☐ Berm and cover stockpiles of sand, dirt or other construction material with tarps when rain is forecast or if not actively being used within 14 days.
- ☐ Use (but don't overuse) reclaimed water for dust control.

Hazardous Materials

- ☐ Label all hazardous materials and hazardous wastes (such as pesticides, paints, thinners, solvents, fuel, oil, and antifreeze) in accordance with city, county, state and federal regulations.
- ☐ Store hazardous materials and wastes in water tight containers, store in appropriate secondary containment, and cover them at the end of every work day or during wet weather or when rain is forecast.
- ☐ Follow manufacturer's application instructions for hazardous materials and be careful not to use more than necessary. Do not apply chemicals outdoors when rain is forecast within 24 hours.
- ☐ Arrange for appropriate disposal of all hazardous wastes.

Waste Management

- Cover waste disposal containers securely with tarps at the end of every work day and during wet weather.
- ☐ Check waste disposal containers frequently for leaks and to make sure they are not overfilled. Never hose down a dumpster on the construction site.
- ☐ Clean or replace portable toilets, and inspect them frequently for leaks and spills.
- ☐ Dispose of all wastes and debris properly. Recycle materials and wastes that can be recycled (such as asphalt, concrete, aggregate base materials, wood, gyp board, pipe, etc.)
- ☐ Dispose of liquid residues from paints, thinners, solvents, glues, and cleaning fluids as hazardous waste.

Construction Entrances and Perimeter

- ☐ Establish and maintain effective perimeter controls and stabilize all construction entrances and exits to sufficiently control erosion and sediment discharges from site and tracking off site.
- ☐ Sweep or vacuum any street tracking immediately and secure sediment source to prevent further tracking. Never hose down streets to clean up tracking.

Equipment Management & Spill Control




Maintenance and Parking

- ☐ Designate an area, fitted with appropriate BMPs, for vehicle and equipment parking and storage.
- ☐ Perform major maintenance, repair jobs, and vehicle and equipment washing off site.
- ☐ If refueling or vehicle maintenance must be done onsite, work in a bermed area away from storm drains and over a drip pan or drop cloths big enough to collect fluids. Recycle or dispose of fluids as hazardous waste.
- ☐ If vehicle or equipment cleaning must be done onsite, clean with water only in a bermed area that will not allow rinse water to run into gutters, streets, storm drains, or surface waters.
- ☐ Do not clean vehicle or equipment onsite using soaps, solvents, degreasers, or steam cleaning equipment.

Spill Prevention and Control

- ☐ Keep spill cleanup materials (e.g., rags, absorbents and cat litter) available at the construction site at all times.
- ☐ Inspect vehicles and equipment frequently for and repair leaks promptly. Use drip pans to catch leaks until repairs are made.
- ☐ Clean up spills or leaks immediately and dispose of cleanup materials properly.
- ☐ Do not hose down surfaces where fluids have spilled. Use dry cleanup methods (absorbent materials, cat litter, and/or rags).
- ☐ Sweep up spilled dry materials immediately. Do not try to wash them away with water, or bury them.
- ☐ Clean up spills on dirt areas by digging up and properly disposing of contaminated soil.
- ☐ Report significant spills immediately. You are required by law to report all significant releases of hazardous materials, including oil. To report a spill: 1) Dial 911 or your local emergency response number, 2) Call the Governor's Office of Emergency Services Warning Center, (800) 852-7550 (24 hours).

Earthmoving

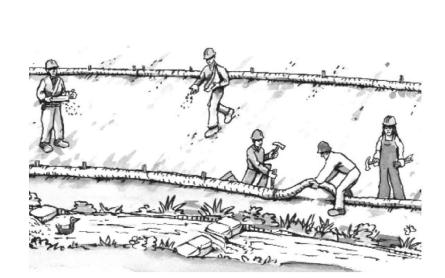

- ☐ Schedule grading and excavation work during dry weather.
- ☐ Stabilize all denuded areas, install and maintain temporary erosion controls (such as erosion control fabric or bonded fiber matrix) until vegetation is established.
- ☐ Remove existing vegetation only when absolutely necessary, and seed or plant vegetation for erosion control on slopes or where construction is not immediately planned.
- ☐ Prevent sediment from migrating offsite and protect storm drain inlets, gutters, ditches, and drainage courses by installing and maintaining appropriate BMPs, such as fiber rolls, silt fences, sediment basins, gravel bags, berms, etc.
- ☐ Keep excavated soil on site and transfer it to dump trucks on site, not in the streets.

Contaminated Soils

- ☐ If any of the following conditions are observed, test for contamination and contact the Regional Water Quality Control Board:
- Unusual soil conditions, discoloration, or odor.
- Abandoned underground tanks.
- Abandoned wells
- Buried barrels, debris, or trash.

Paving/Asphalt Work



- Avoid paving and seal coating in wet weather or when rain is forecast, to prevent materials that have not cured from contacting stormwater runoff.
- ☐ Cover storm drain inlets and manholes when applying seal coat, tack coat, slurry seal, fog seal, etc.
- ☐ Collect and recycle or appropriately dispose of excess abrasive gravel or sand. Do NOT sweep or wash it into gutters.
- ☐ Do not use water to wash down fresh asphalt concrete pavement.

Sawcutting & Asphalt/Concrete Removal


- ☐ Protect nearby storm drain inlets when saw cutting. Use filter fabric, catch basin inlet filters, or gravel bags to keep slurry out of the storm drain system.
- ☐ Shovel, abosorb, or vacuum saw-cut slurry and dispose of all waste as soon as you are finished in one location or at the end of each work day (whichever is sooner!).
- ☐ If sawcut slurry enters a catch basin, clean it up immediately.



Concrete, Grout & Mortar


- ☐ Store concrete, grout, and mortar away from storm drains or waterways, and on pallets under cover to protect them from rain, runoff, and wind.
- ☐ Wash out concrete equipment/trucks offsite or in a designated washout area, where the water will flow into a temporary waste pit, and in a manner that will prevent leaching into the underlying soil or onto surrounding areas. Let concrete harden and dispose of as
- ☐ When washing exposed aggregate, prevent washwater from entering storm drains. Block any inlets and vacuum gutters, hose washwater onto dirt areas, or drain onto a bermed surface to be pumped and disposed of properly.

Landscaping

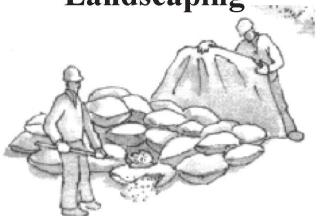

- ☐ Protect stockpiled landscaping materials from wind and rain by storing them under tarps all year-round.
- ☐ Stack bagged material on pallets and under cover.
- ☐ Discontinue application of any erodible landscape material within 2 days before a forecast rain event or during wet weather.


Painting & Paint Removal

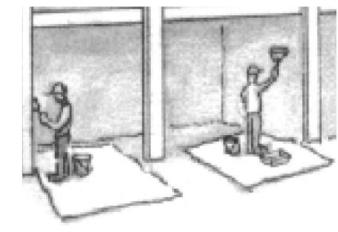

Painting Cleanup and Removal

- ☐ Never clean brushes or rinse paint drain, or stream.
- ☐ For water-based paints, paint out brushes to the extent possible, and rinse into a drain that goes to the sanitary sewer.
- ☐ For oil-based paints, paint out brushes to reuse thinners and solvents. Dispose of excess liquids as hazardous waste.
- ☐ Paint chips and dust from non-hazardous dry stripping and sand blasting may be swept up or collected in plastic drop cloths and disposed of as trash.
- and dust from marine paints or paints containing lead, mercury, or tributyltin must be disposed of as hazardous waste. certified contractor.

Dewatering

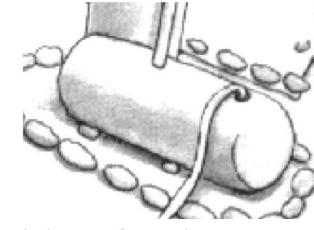

- runoff from dewatering operations must possible send dewatering discharge to landscaped area or sanitary sewer. If local wastewater treatment plant.
- from all disturbed areas.
- approval from the local municipality or storm drain. Filtration or diversion through a basin, tank, or sediment trap may be required.
- contamination, call your local agency to determine whether the ground water must be tested. Pumped groundwater may need to be collected and hauled off-site for treatment and proper disposal




ASSOCIATES

AND

ACLEOD

 \square

- containers into a street, gutter, storm
- Never pour paint down a storm drain.
- the extent possible and clean with thinner or solvent in a proper container. Filter and
- ☐ Chemical paint stripping residue and chips Lead based paint removal requires a state-

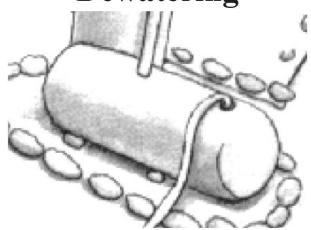


- ☐ Discharges of groundwater or captured be properly managed and disposed. When discharging to the sanitary sewer call your
- ☐ Divert run-on water from offsite away
- ☐ When dewatering, notify and obtain before discharging water to a street gutter
- ☐ In areas of known or suspected

Storm drain polluters may be liable for fines of up to \$10,000 per day!

DESIGNED BY: CHECKED BY: DGM SCALE: DATE: 08/24/18 DRAWING NO. 4452-CBMPP

DRAWN BY:

STRUCTION BEST MANAG
PRACTICES PLAN
COLUMBUS STREET
A D N 047-275-050

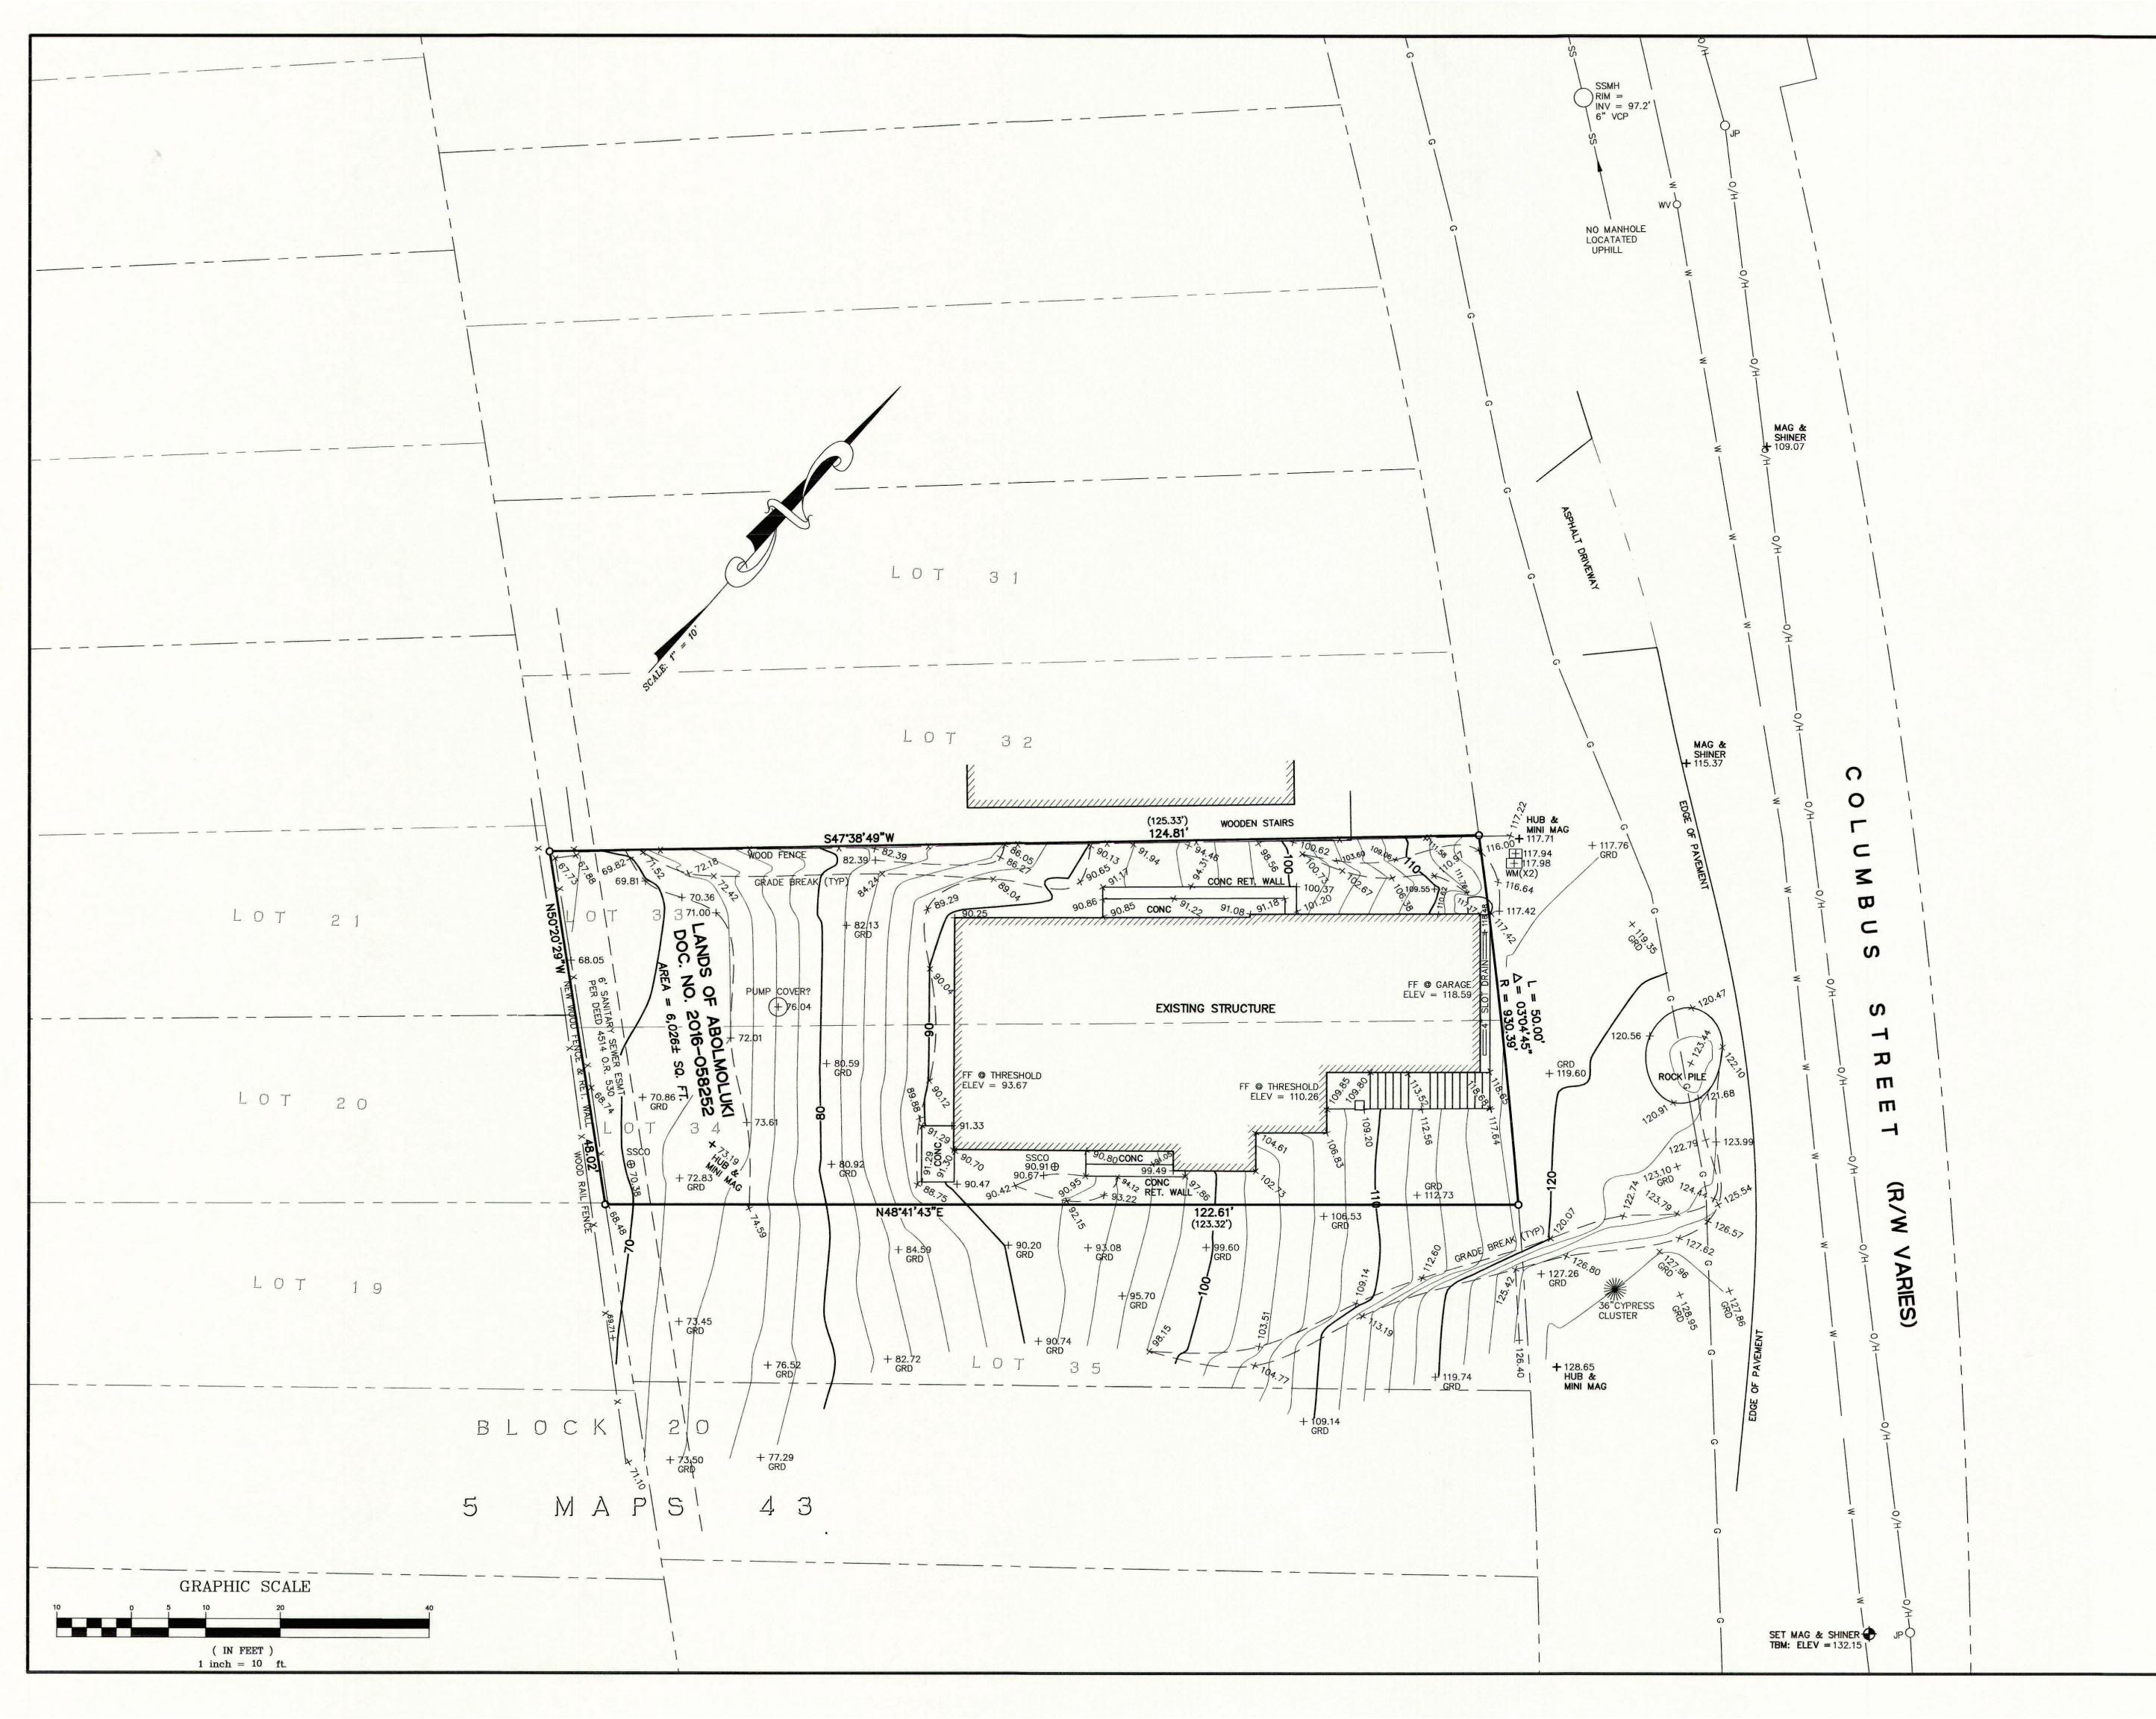

BOUNDARY NOTE:

MONUMENTS HAVE BEEN SET AT THE PROPERTY CORNERS, AS SHOWN HEREON, AND A RECORD OF SURVEY HAS BEEN FILED WITH THE COUNTY OF SAN MATEO IN VOL. 43 OF LLS MAPS AT PAGE 73.

BASIS OF ELEVATIONS:

ELEVATIONS ARE BASED UPON AN ASSUMED DATUM.

TBM: SET MAG NAIL AND SHINER ALONG COLUMBUS STREET, AS SHOWN. ELEVATION = 132.15'

BASIS OF BEARINGS:

THE BEARING S43*47'30"W BETWEEN TWO FOUND BRASS DISK MONUMENTS, AS SHOWN ON THAT CERTAIN RECORD OF SURVEY FILED IN VOLUME 8 OF L.L.S. MAPS AT PAGES 108—111, WAS USED AS THE BASIS OF BEARINGS FOR THIS SURVEY.

LEGEND:

O SET 3/4" IP WITH PLASTIC PLUG "LS 7701" AND TACK PER 43 LLS 73

A/C
BW
BACK OF WALK
CB
CATCH BASIN
CIP
CAST IRON PIPE
CMP
CORRUGATED METAL PIPE
CONC
CONCRETE
CO
CLEAN—OUT
DI
DROP INLET
EM
ELECTRIC METER
FD
FOUND
FF
FINISHED FLOOR
FL
FL
FIRE HYDRANT
GA
GM
GAS METER
GRD
GROUND
HCR
HANDICAP RAMP
NV.
INVERT
P
IRON PIPE
JP
JOINT POLE
LAT.
LATERAL
LG
O/H
OVERHEAD
P.U.E.
PUBLIC UTILITIES EASEMENT
RCP
RET. WALL
RYM
RIGHT OF WAY
SSCO
SANITARY SEWER CLEAN—OUT
SSMH
SANITARY SEWER MANHOLE
STORM DRAIN MANHOLE
TOP BACK OF CURB
TOP BACK OF CURB
TOP OF WALL
U/G
UNDERGROUND
VCP
VITRIFIED CLAY PIPE
WV
WATER VALVE
WM
WATER METER BOX
CAST WALE
WATER METER BOX
CABLE TELEVISION LINE
ELECTRICAL LINE
GAS LINE
STORM DRAIN LINE
TELEPHONE LINE
WATER LINE

UTILITY NOTE:

THE UTILITIES EXISTING ON THE SURFACE AND SHOWN ON THIS DRAWING HAVE BEEN LOCATED BY FIELD SURVEY. ALL UNDERGROUND UTILITIES SHOWN ON THIS DRAWING ARE FROM RECORDS OF THE VARIOUS UTILITY COMPANIES AND THE SURVEYOR DOES NOT ASSUME RESPONSIBILITY FOR THEIR COMPLETENESS, INDICATED LOCATION, OR SIZE. RECORD UTILITY LOCATION SHOULD BE CONFIRMED BY EXPOSING THE UTILITY.



12/23/19

AS BUILT SURVEY

LANDS OF ABOLMOLUKI DOCUMENT # 2016-058252 O.R. LOTS 33 AND 34, BLOCK 20 "PLAT OF SUBDIVISION NO. 1 OF GRANADA" VOLUME 5 OF MAPS AT PAGE 43

ASSESSOR'S PARCEL NUMBER: 047-275-050

(1120 COLUMBUS STREET, EL GRANADA)

UNINCORPORATED SAN MATEO COUNTY CALIFORNIA

SCALE: 1" = 10' DECEMBER, 2019


B & H SURVEYING, INC.

PROFESSIONAL LAND SURVEYING

901 WALTERMIRE ST.

BELMONT, CA 94002

OFFICE (650) 637-1590

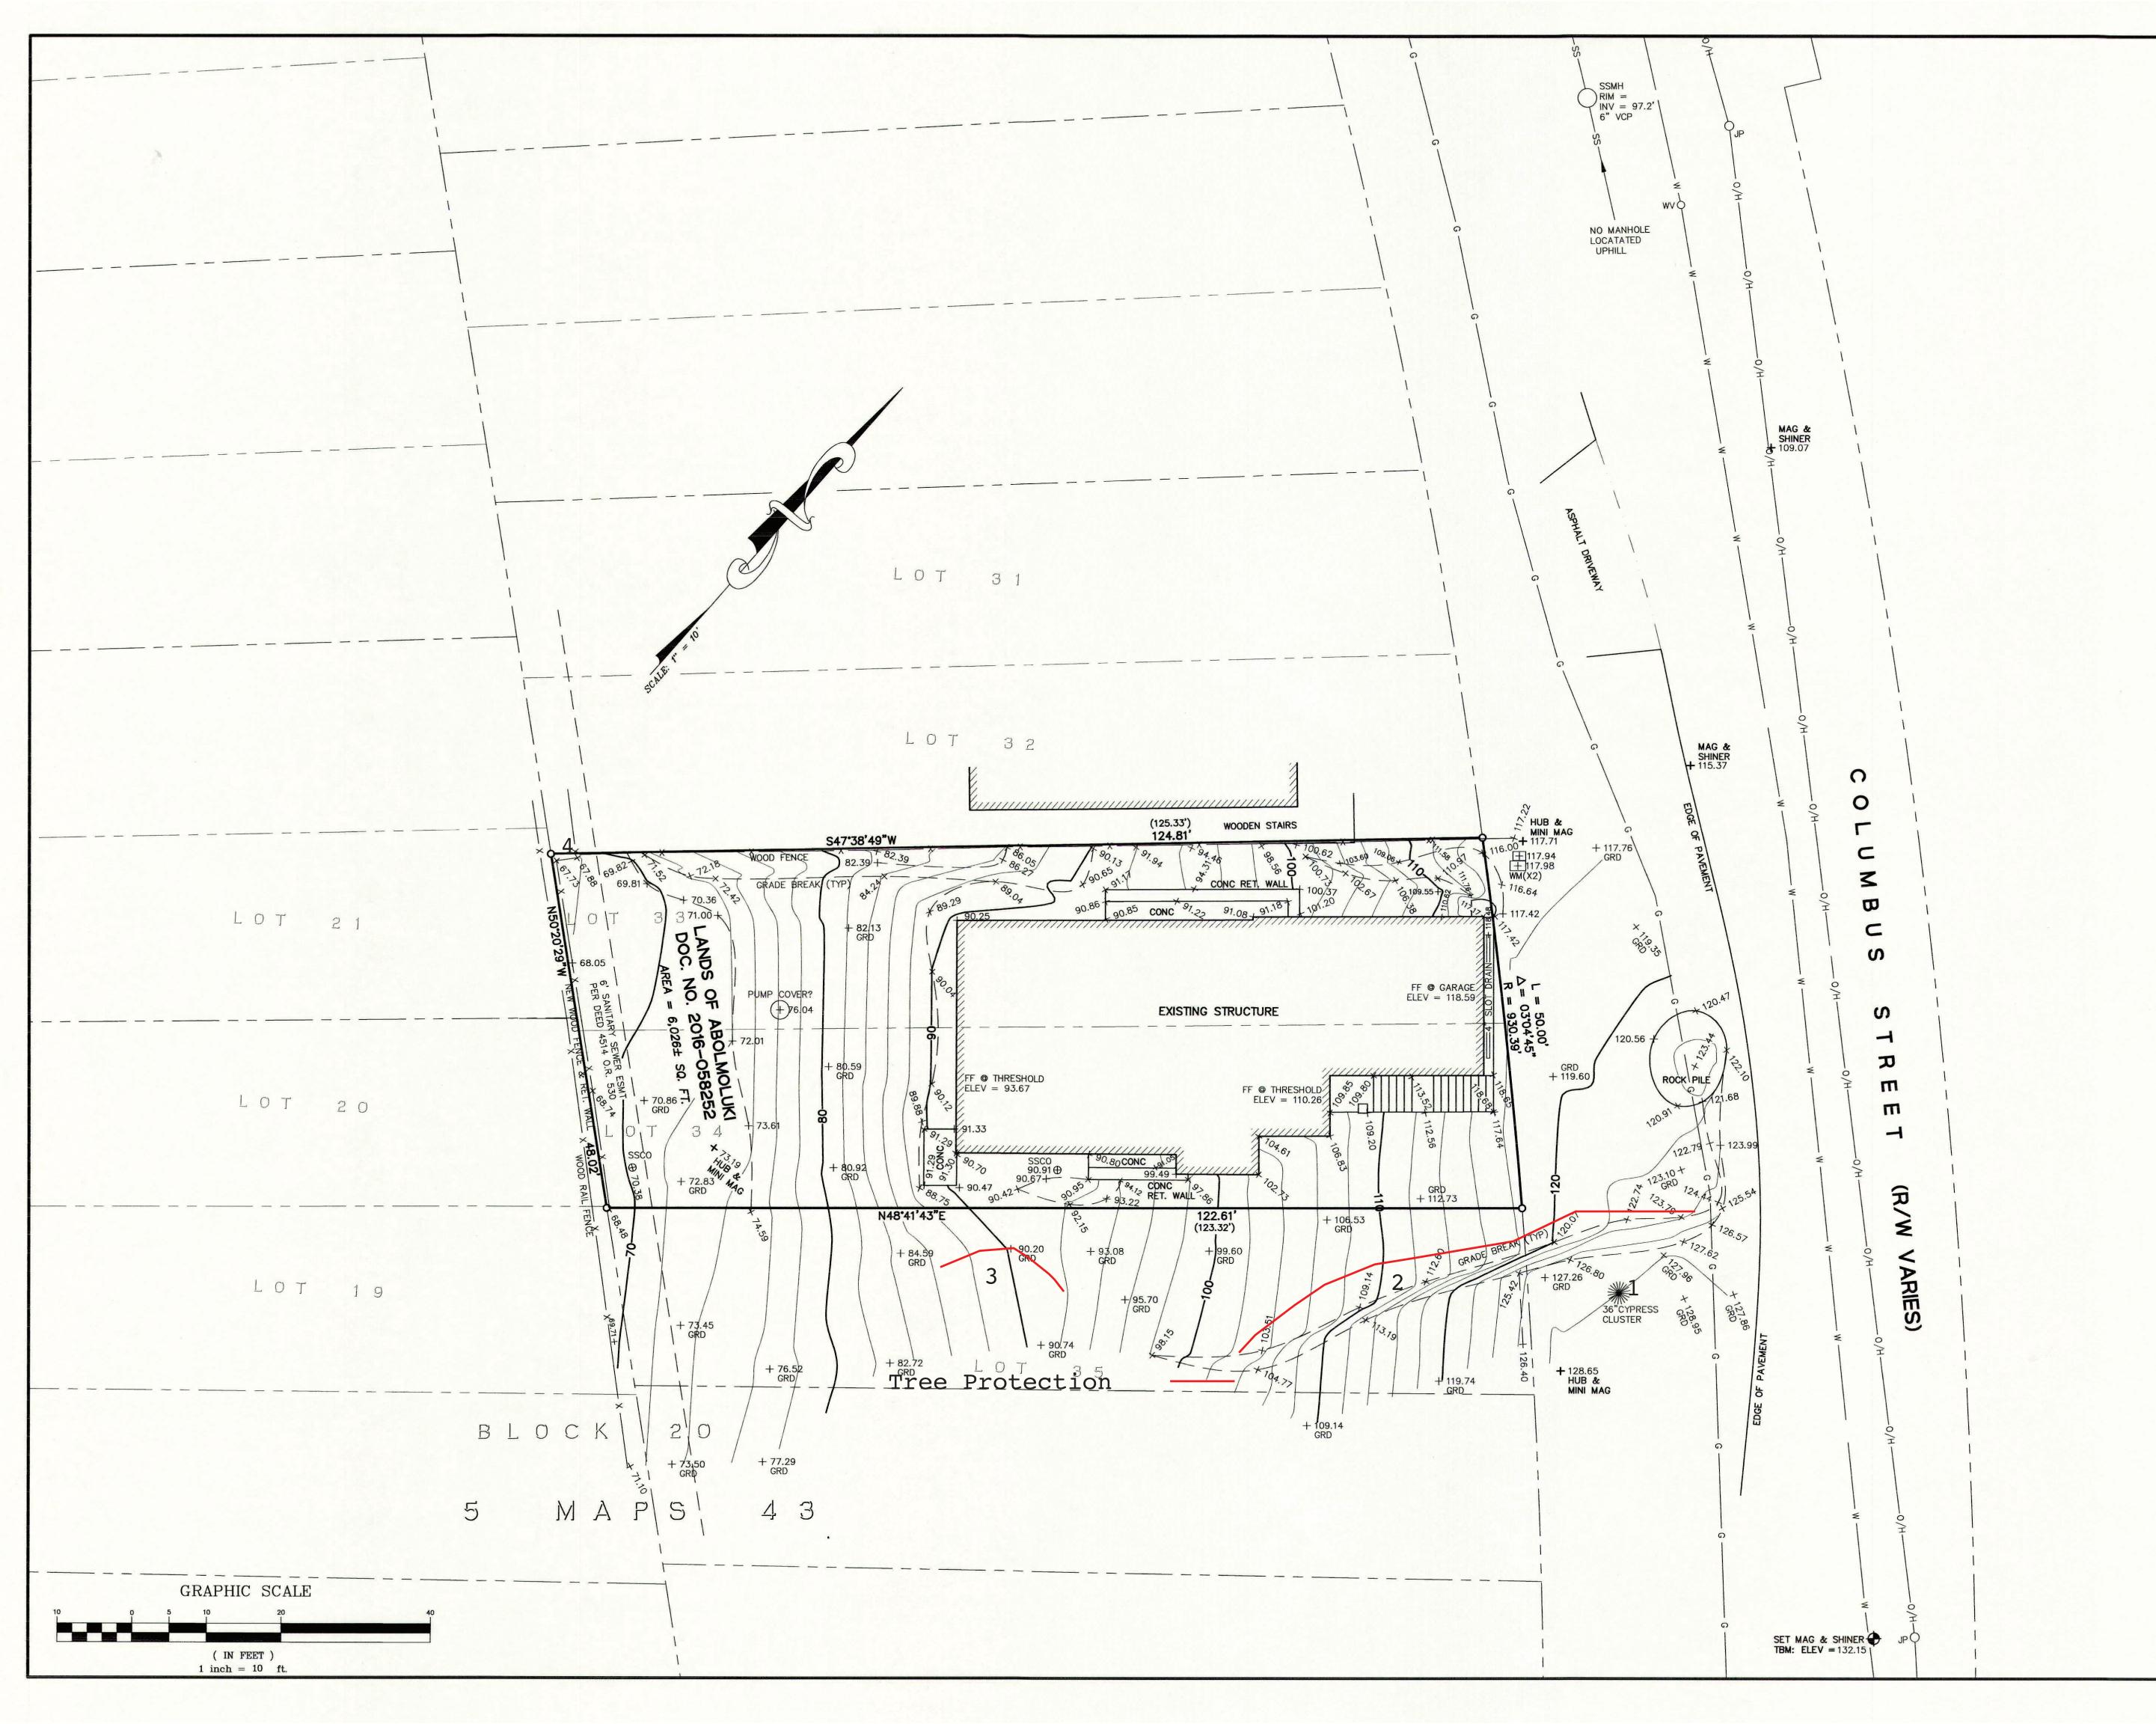

BOUNDARY NOTE:

MONUMENTS HAVE BEEN SET AT THE PROPERTY CORNERS, AS SHOWN HEREON, AND A RECORD OF SURVEY HAS BEEN FILED WITH THE COUNTY OF SAN MATEO IN VOL. 43 OF LLS MAPS AT PAGE 73.

BASIS OF ELEVATIONS:

ELEVATIONS ARE BASED UPON AN ASSUMED DATUM.

TBM: SET MAG NAIL AND SHINER ALONG COLUMBUS STREET, AS SHOWN. ELEVATION = 132.15'

BASIS OF BEARINGS:

THE BEARING S43'47'30"W BETWEEN TWO FOUND BRASS DISK MONUMENTS, AS SHOWN ON THAT CERTAIN RECORD OF SURVEY FILED IN VOLUME 8 OF L.L.S. MAPS AT PAGES 108—111, WAS USED AS THE BASIS OF BEARINGS FOR THIS SURVEY.

LEGEND:

O SET 3/4" IP WITH PLASTIC PLUG "LS 7701" AND TACK PER 43 LLS 73

UTILITY NOTE:

THE UTILITIES EXISTING ON THE SURFACE AND SHOWN ON THIS DRAWING HAVE BEEN LOCATED BY FIELD SURVEY. ALL UNDERGROUND UTILITIES SHOWN ON THIS DRAWING ARE FROM RECORDS OF THE VARIOUS UTILITY COMPANIES AND THE SURVEYOR DOES NOT ASSUME RESPONSIBILITY FOR THEIR COMPLETENESS, INDICATED LOCATION, OR SIZE. RECORD UTILITY LOCATION SHOULD BE CONFIRMED BY EXPOSING THE UTILITY.



12/23/19

AS BUILT SURVEY

LANDS OF ABOLMOLUKI DOCUMENT # 2016-058252 O.R. LOTS 33 AND 34, BLOCK 20 "PLAT OF SUBDIVISION NO. 1 OF GRANADA" VOLUME 5 OF MAPS AT PAGE 43

ASSESSOR'S PARCEL NUMBER: 047-275-050


(1120 COLUMBUS STREET, EL GRANADA)
UNINCORPORATED SAN MATEO COUNTY CALIFORNIA


SCALE: 1" = 10'


B & H SURVEYING INC


B & H SURVEYING, INC. PROFESSIONAL LAND SURVEYING

901 WALTERMIRE ST. BELMONT, CA 94002 OFFICE (650) 637-1590

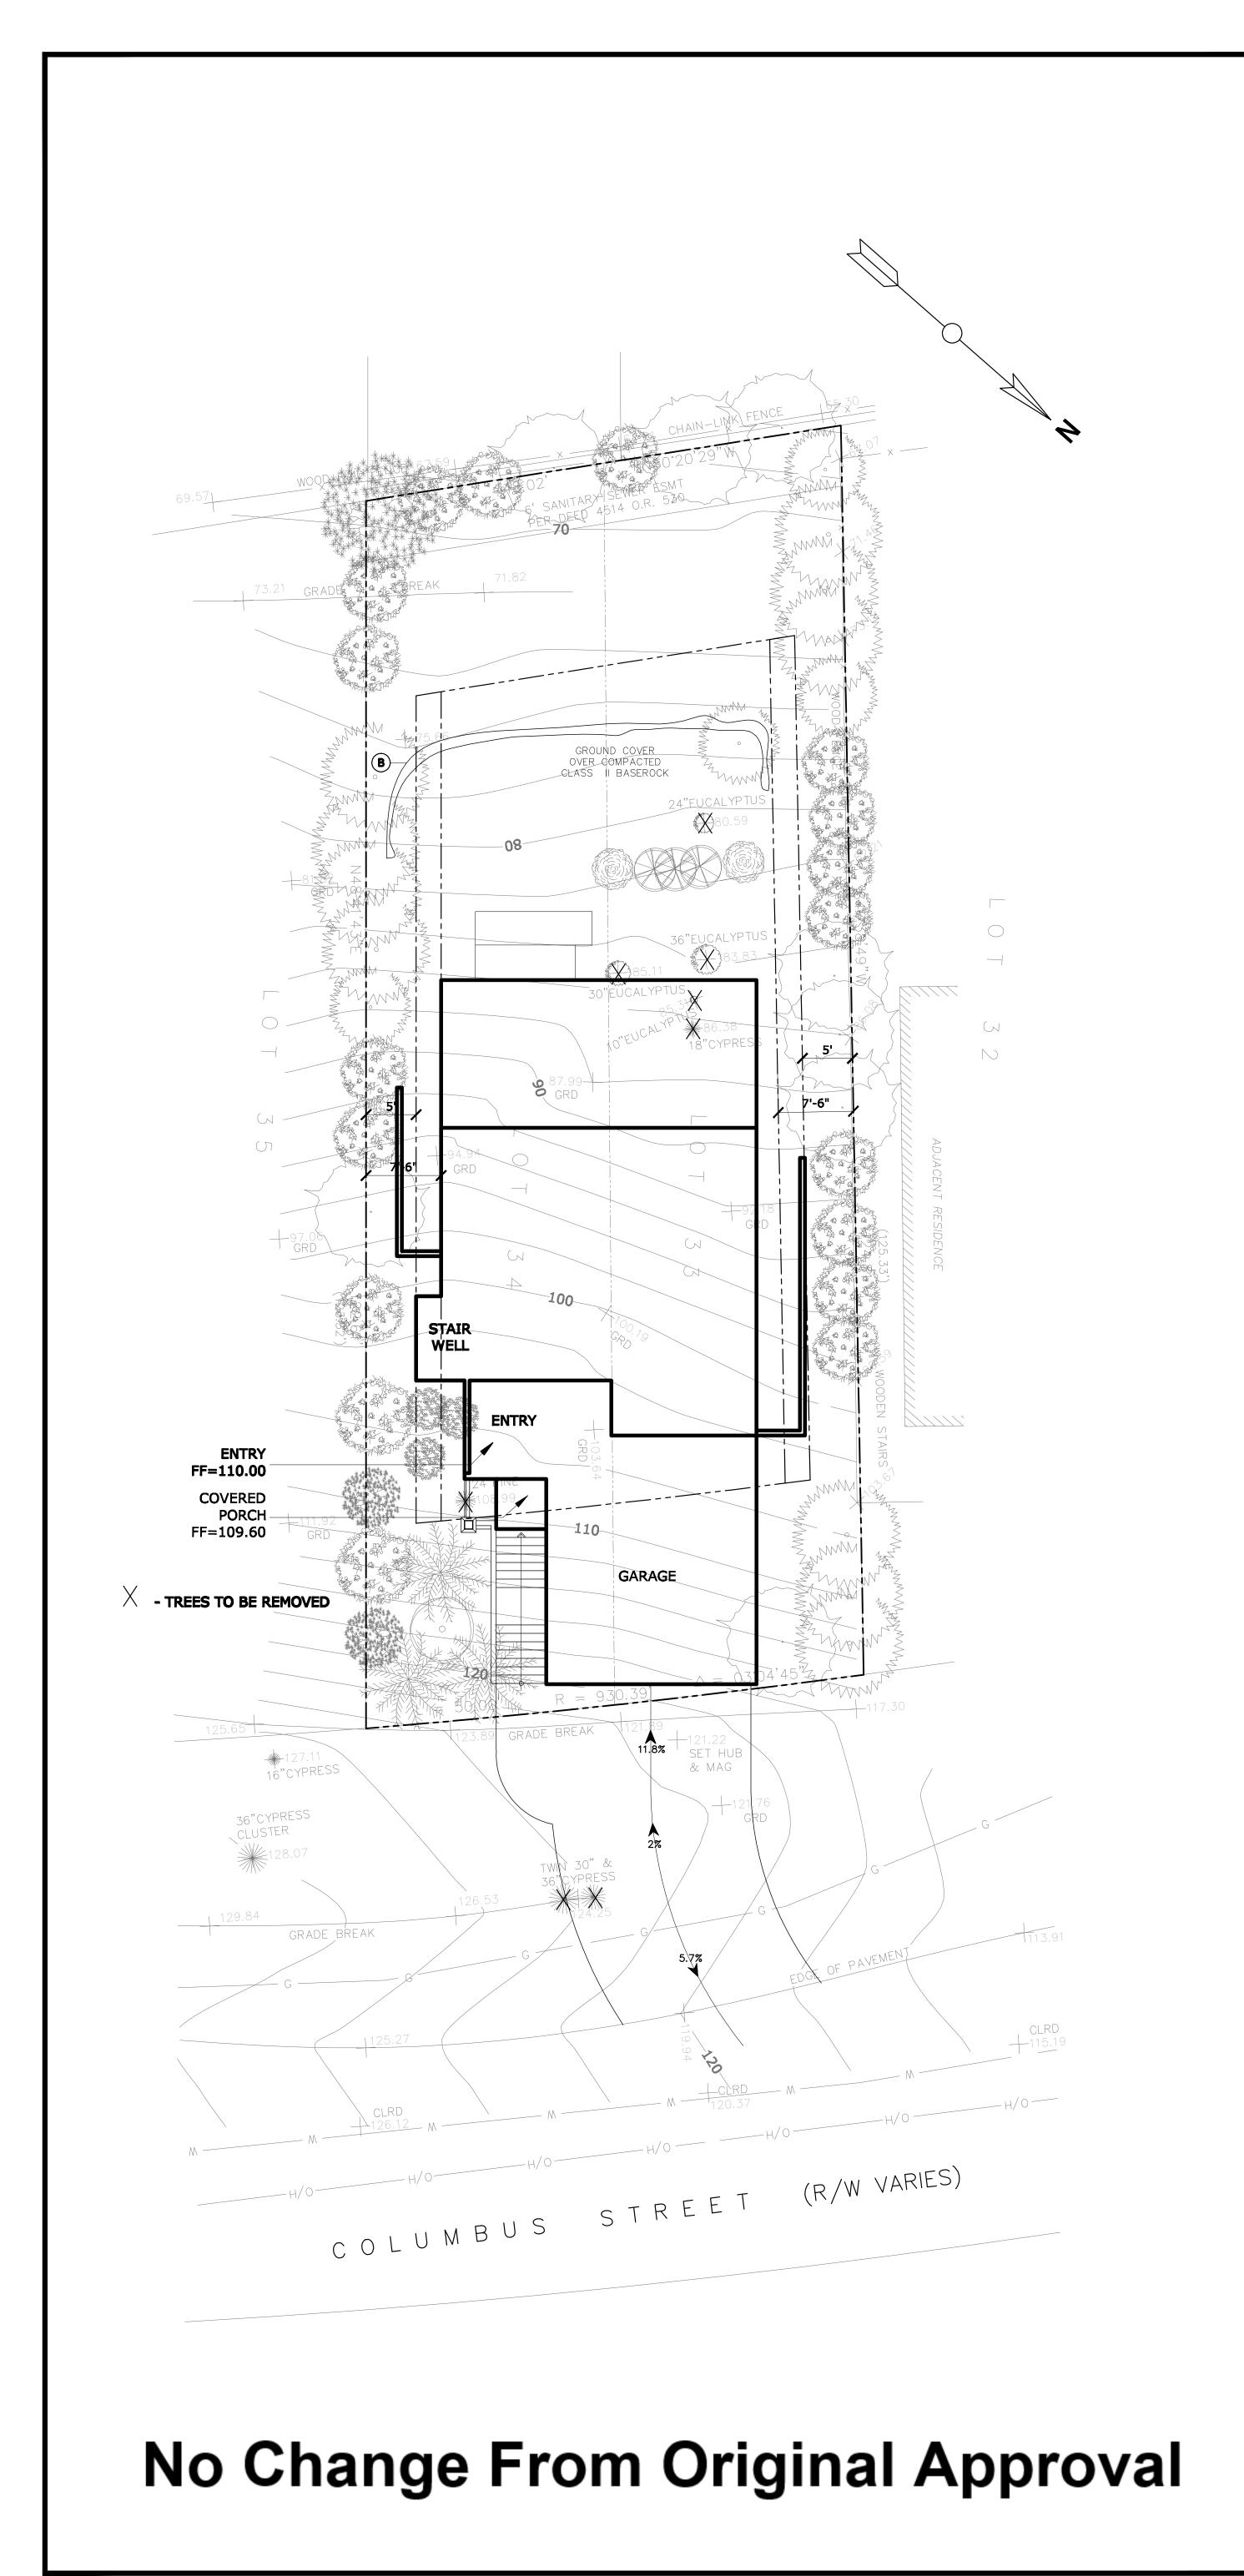

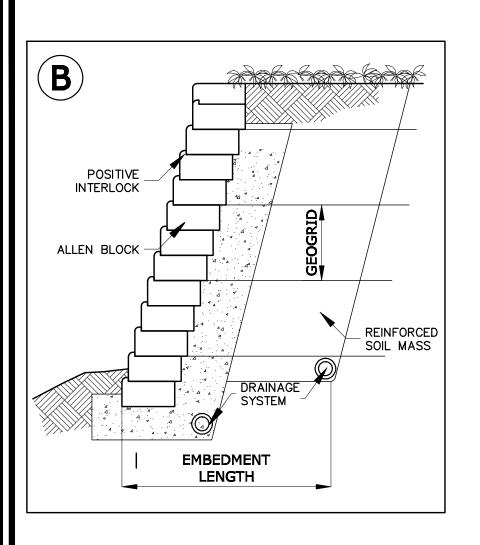

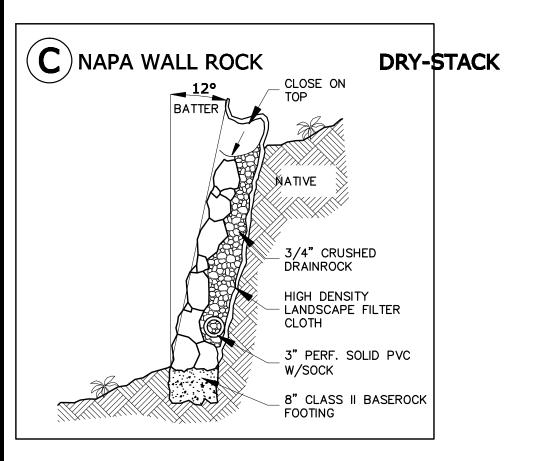

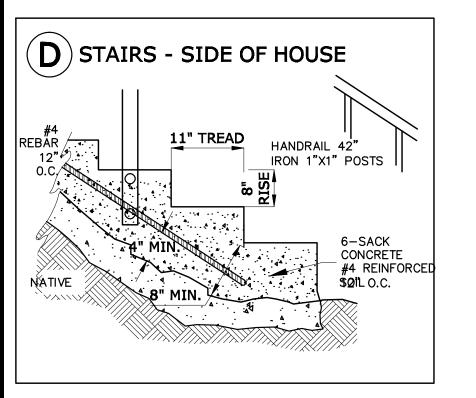

LANDSCAPE HARDSCAPE **CALCULATIONS**

Total Lot Area: 6,026 ft2 Structure: 2,700 ft2 Landscaped Area, Lot: 3,326 ft2 Landscaped Area, R.O.W.: 0 ft2 Total Landscaped Area: 3,326 ft2 **Total Irrigated Landscape Area:**

1,676ft2

Total Front Hardscape: 917 ft2

(All planted areas minus no-irrigate meadow)

Front Permeable: 750 ft2 Paver Driveway & Wall footings Front Impervious: 167 ft2 Stairs, Porch & Driveway footing

Total Back & Side Hardscape: 60 ft2 Back Permeable: 60 ft2 Wall footing Back Impervious:

Total Hardscape coverage: 977ft2 Total Landscaped Area: 3,326 ft2 = % Covered: 29% coverage 810 ft2 Permeable = 24% permeable

Construction Notes:

Concrete Staircase: Side of house: set on #4 steel Reinforced concrete steps: 7 3/4" rise, 11" tread. Handrail 1"x1" steel posts


Napa Wall Rock Retaining Walls: Front Yard: Installed Over 8" Class II base rock footing: Construct Napa Wall Rock Dry-Stack retain Rocks interlock and are constructed w/ 12 Degree batter, drain installed behind wall 3" Perforated pipe w/ 3/4" drain-rock to

Paver Driveway: Install concrete driveway Pavers (style to be determined) over Compacted Class II base rock. Edges to Retained w/ #4 steel reinforced concrete Footings forming 8" thick x 4" above driveway paver grade

Engineered Block Retaining Wall: Back Yard: 4.0' tall Block Wall Installed Over 8" Class II base rock footing: Construct Allen Block or similar manufactured Retaining wall blocks set w/ Geogrid. and are constructed w/ 12 Degree batter, drain installed behind wall 3" Perforated pipe w/ 3/4" drain-rock to Daylight.

Artscapes Landscape Design & Construction 340 Arlington Road Redwood City, CA License #732452

SCALE: DATE: **REVISION TABLE** 08/23/2018 **Scott Soden** APN 047-275-050 NUMBER DATE **REVISED BY** DESCRIPTION Artscapes Landscape Design Phone: 650-839-1704 COLUMBUS ST. 1'0" Cell 650-823-5824 EL GRANADA, CA.

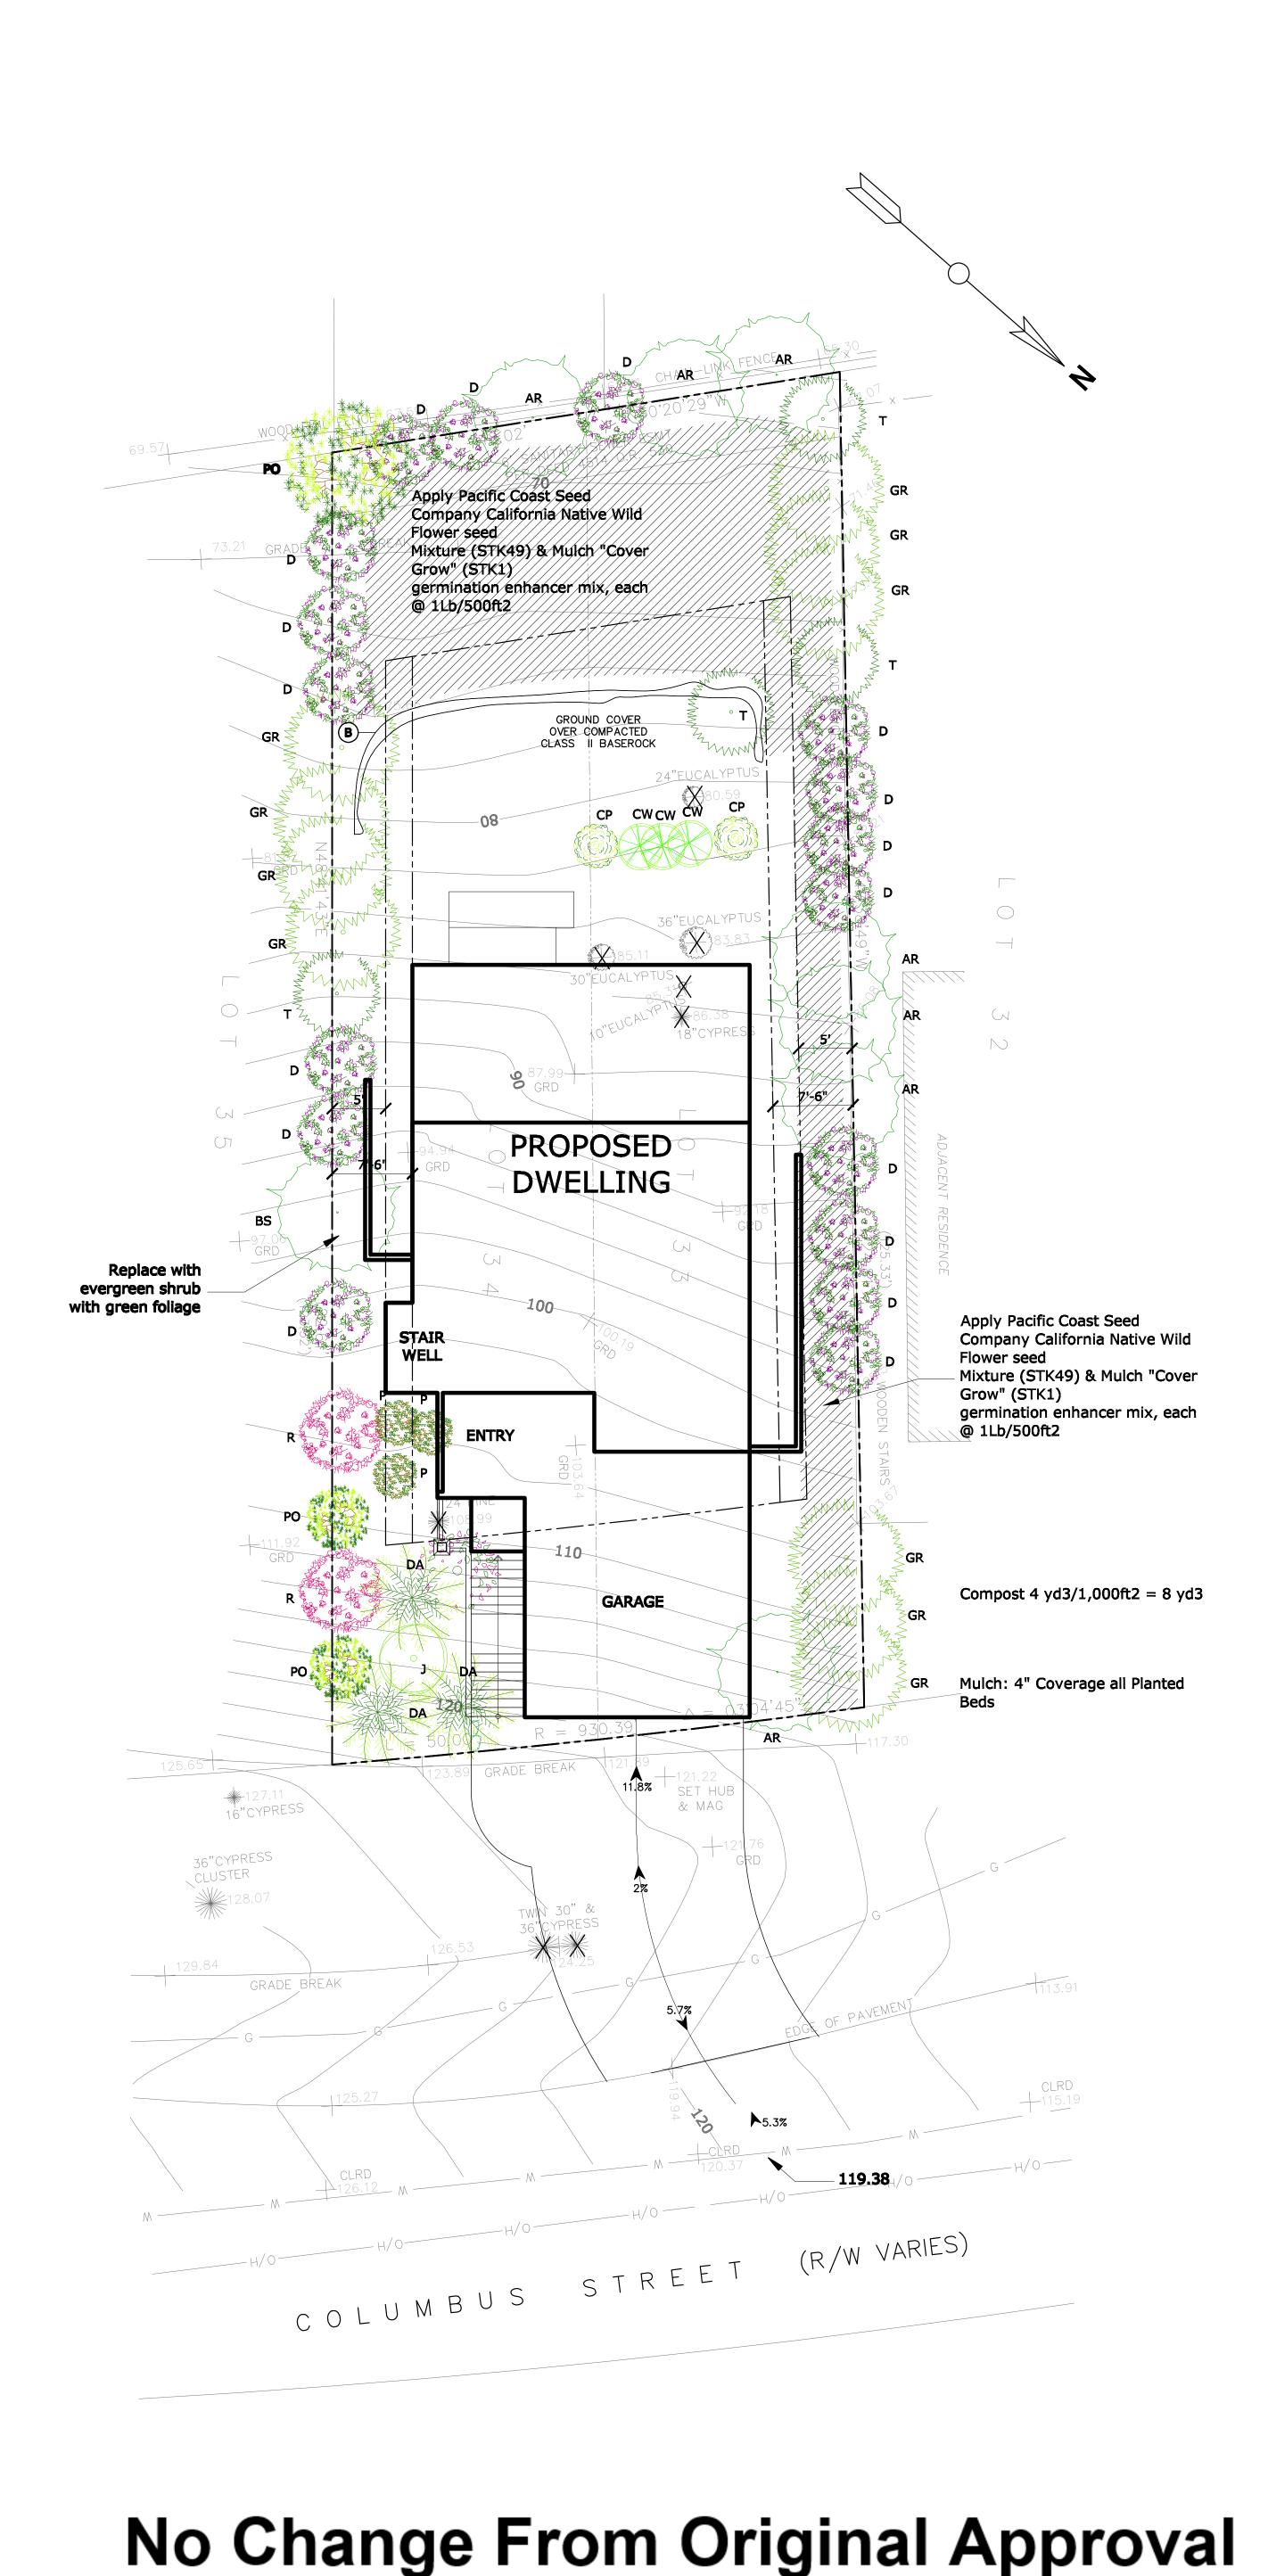

PLANT LEGEND:

Tall Screen Plants: R- Rhododendron Red, Pink, Purple 15gal (2) PO- Podocarpus henkelii, 15gal (3) Tb- Tibouchina urvilleana, 15gal (1) Ar - Arbutus Marina standard, 15gal (9) T- Toyon, 15gal (3) GR- Greveila "Red Hooks", 5gal (10) D- Dodonaea purpurea, 15gal (17) BS- Buxus Sempervirens, 15gal (1)

Foundation Plants: W- Woodwardia fimbriata, 5gal P- Polystichum munitum, 1gal (3) SC- Salvia Cacafolia, 1gal CW- Correa Wyn's Wonder 5gal (3) LO- Loropetalum Hines Purple 5gal CP- Colenma 'Monterey Rose', 5gal CG- Coleonema Golden 5gal GS- grevillea 'superb', 5 gal

Border Plants: CA - Campanula Perskiania, Flat WS- Wild Strawberry (Chiloensis) Flat MZ- Arctostaphylos Emerald Carpet 1gal (37)


Focal Plants: DA- Dickensonia antartica 15gal (3) J - Acer Japonica, 'Emperor 1', 24" Box (1)


This is a WELO Compliant Landscape:


- Compost: (4) yd3/1,000ft2 to a depth of 6" to all planted areas. - Plant Water Use: Install climated adapted plants that require occassional, little or no summer water (average WUCOLS plant factor 0.3) for 75% of the plants used. - Mulch: 3" layer of mulch on all exposed soil surfaces of planting areas. - Turf, (Sod Rolls): Total turf area does not exceed 25% of the landscape area. - Landscape Water Meter: A Landscape privately owned dedicated water meter shall be installed and maintained by the owner. - A weather based irrigation computer shall be used to control the irrigation system.

No Change From Original Approval

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	ATE 8/2	NUMBER DATE REVISED BY DESCRIPTION	Artscapes Landscape Design	APN 047-275-050	
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	018		Cell 650-823-5824	EL GRANADA, CA.	

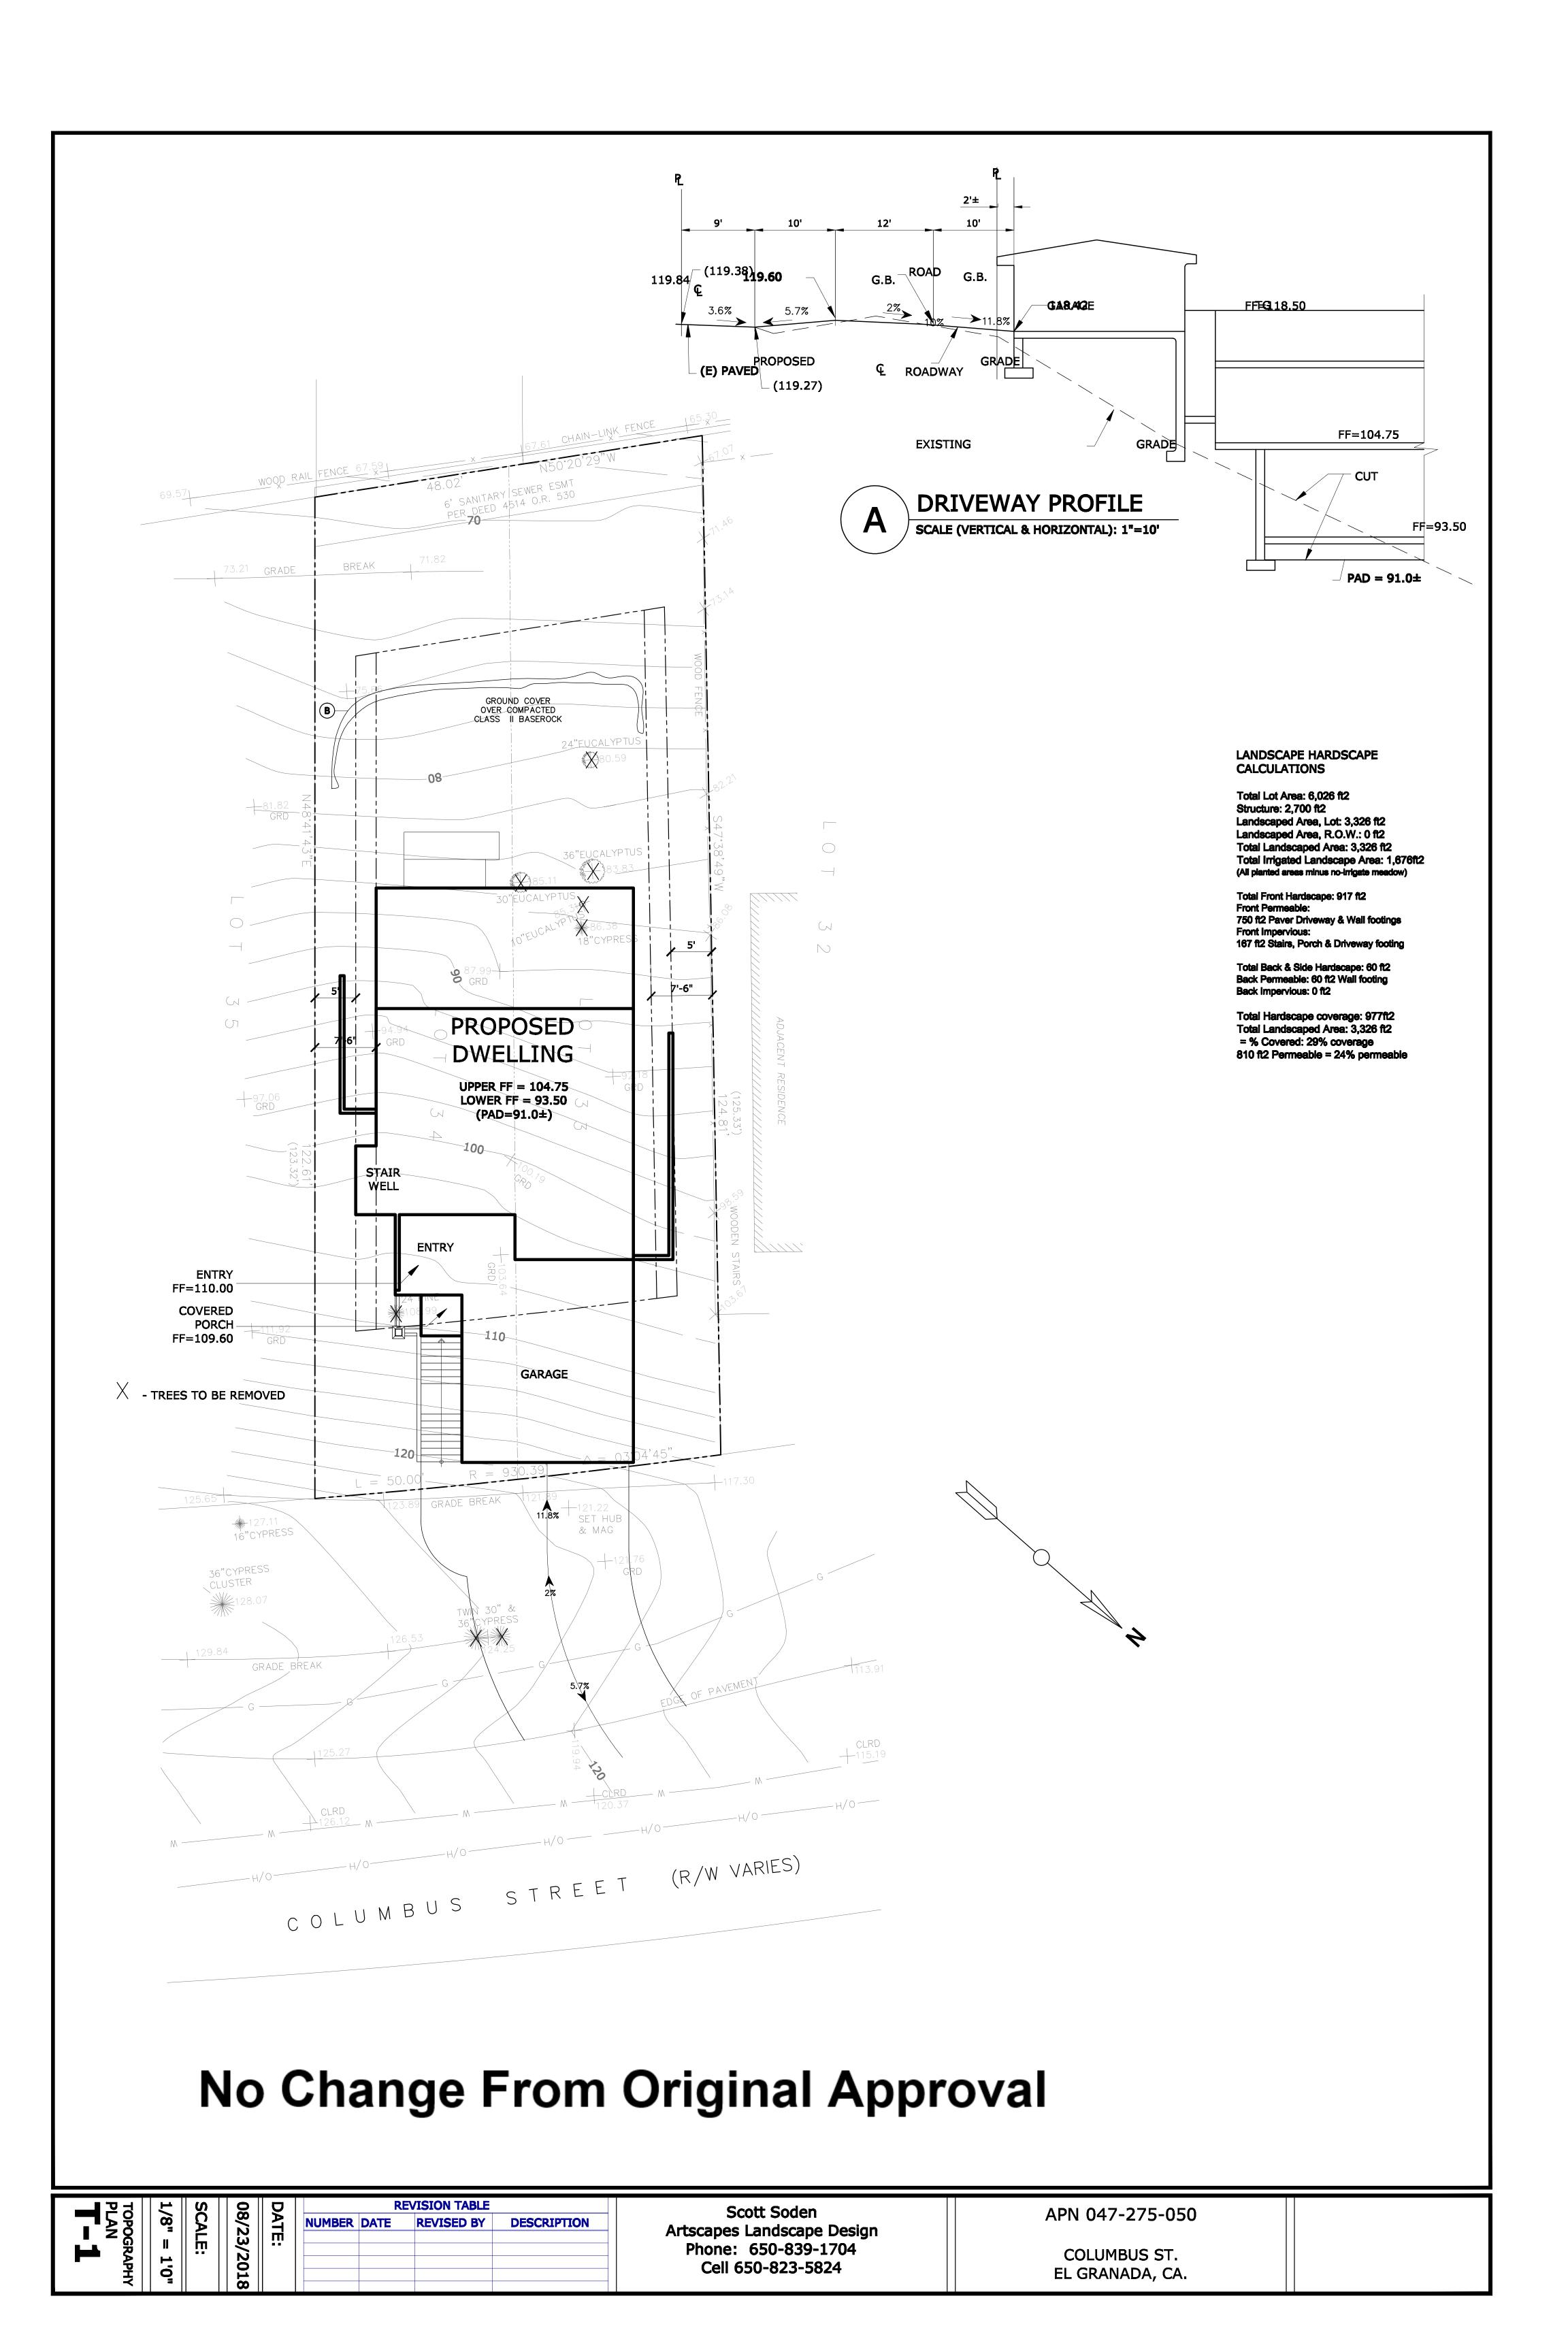

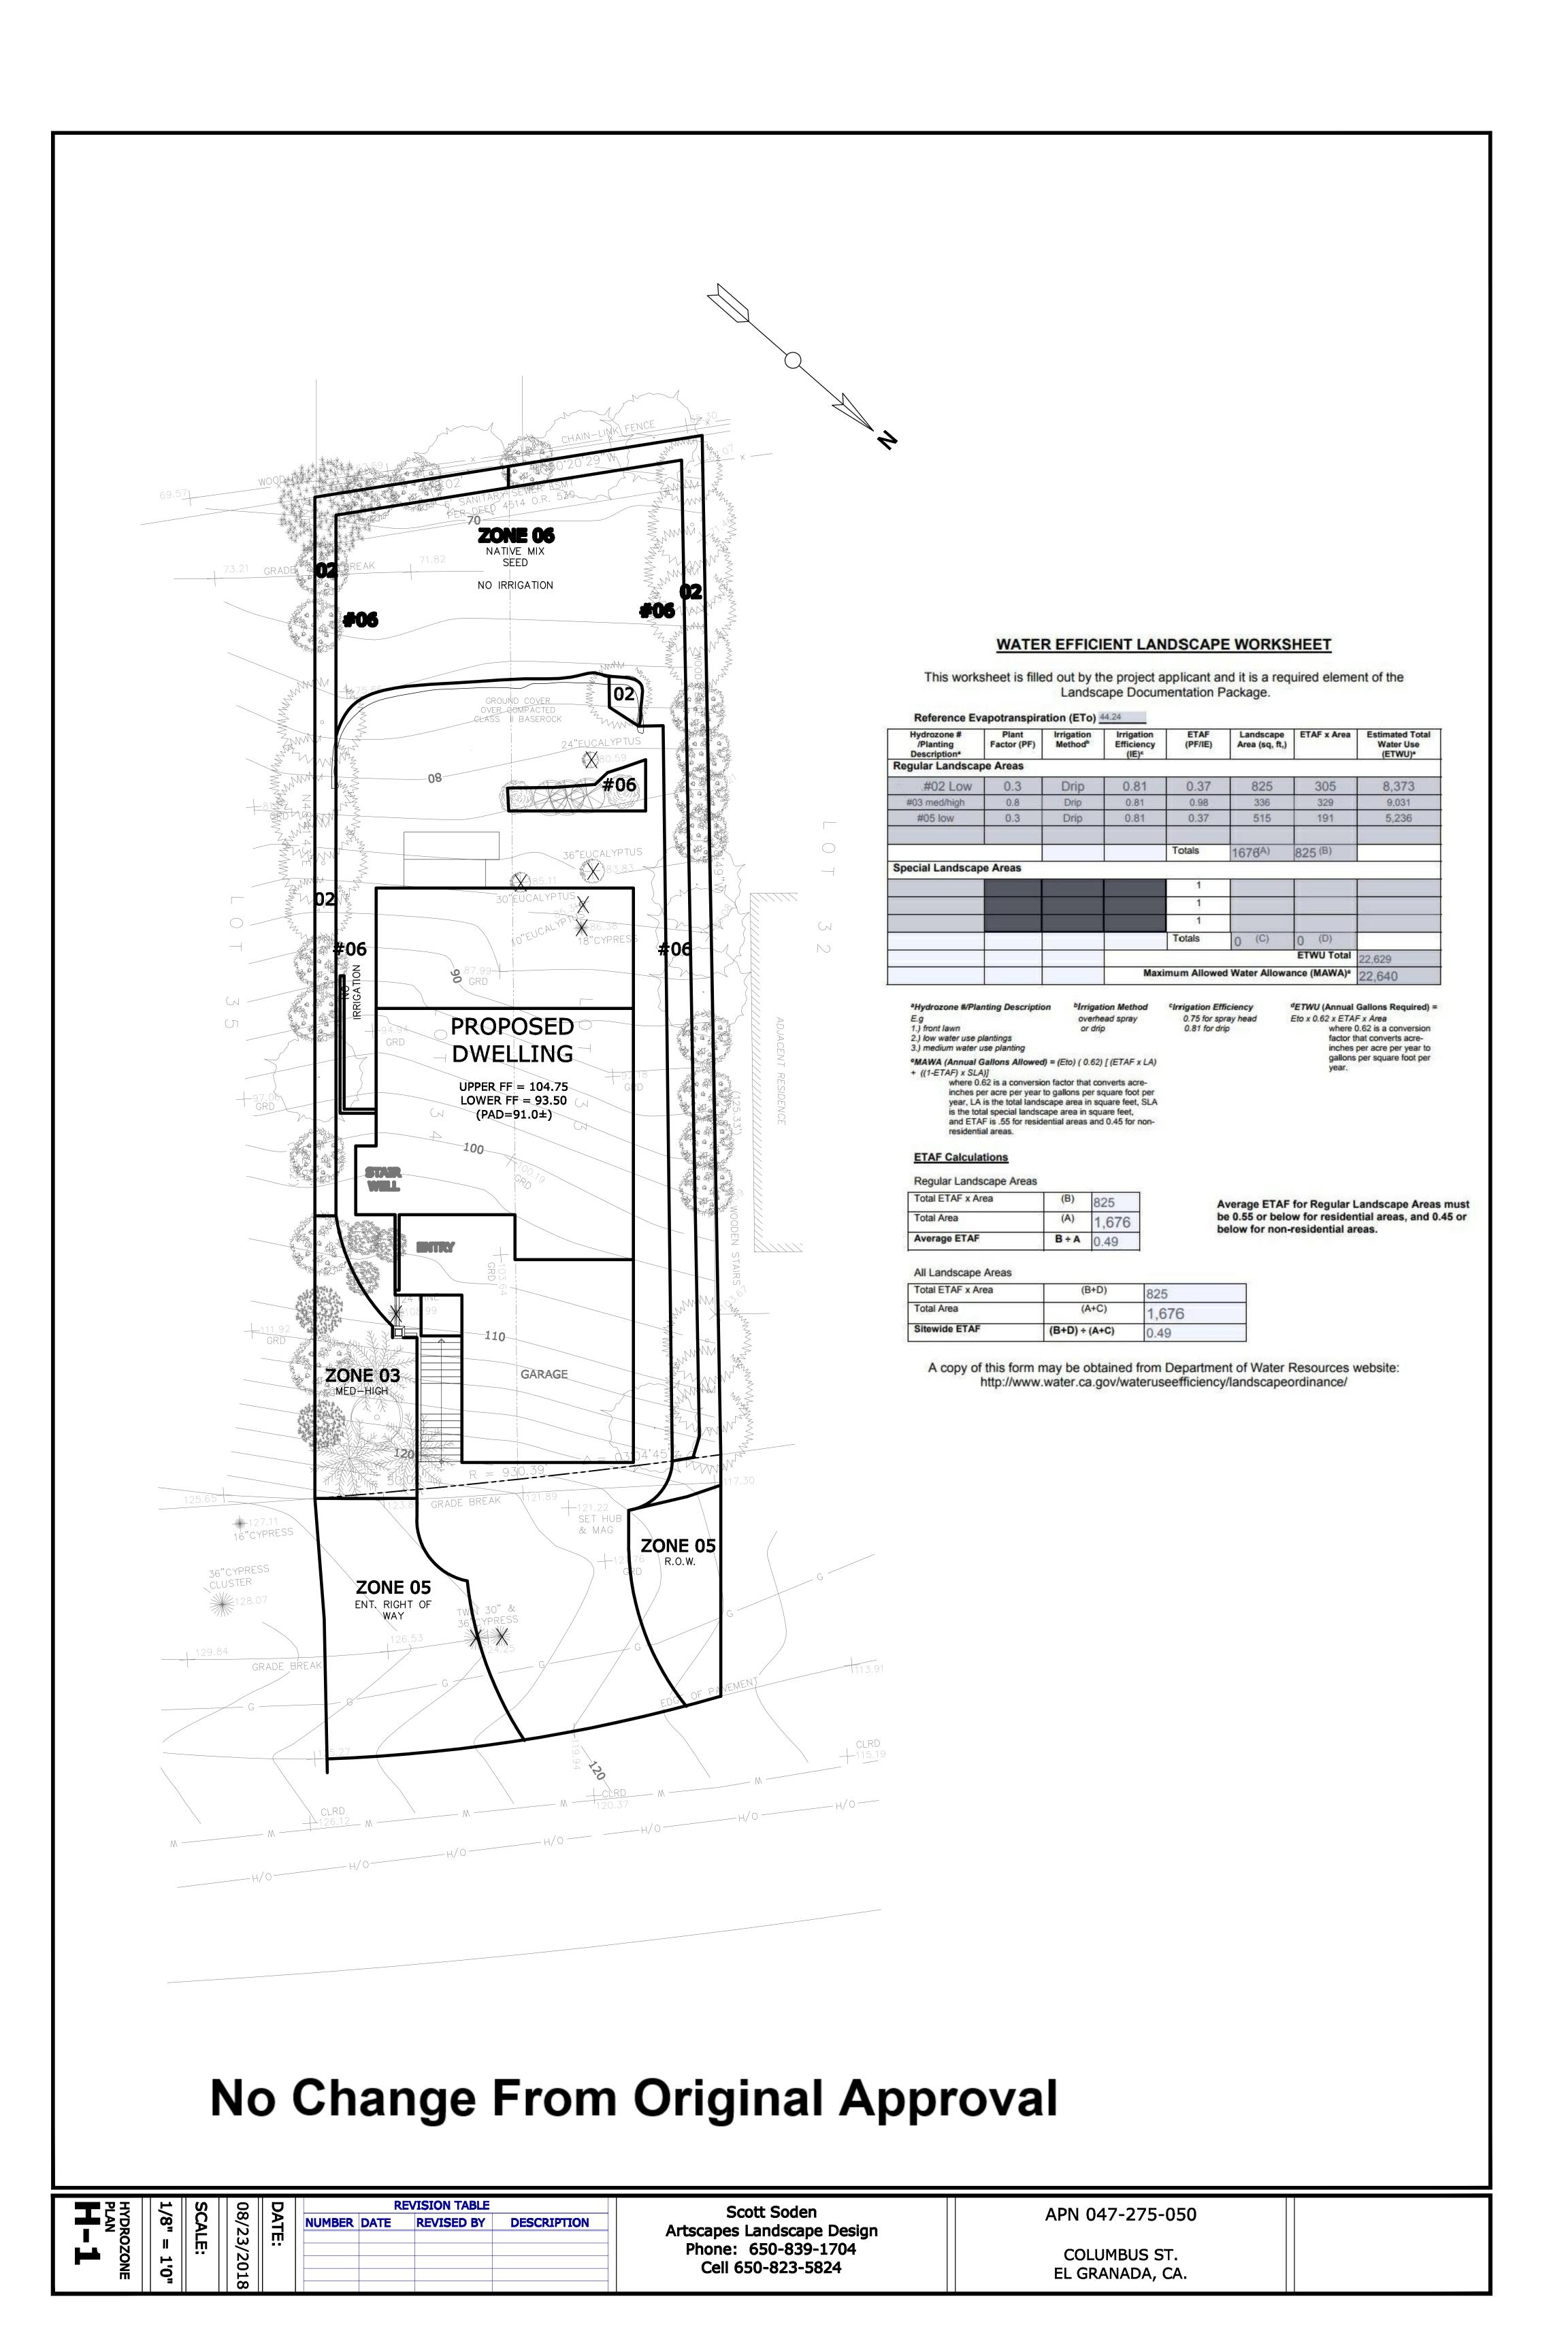

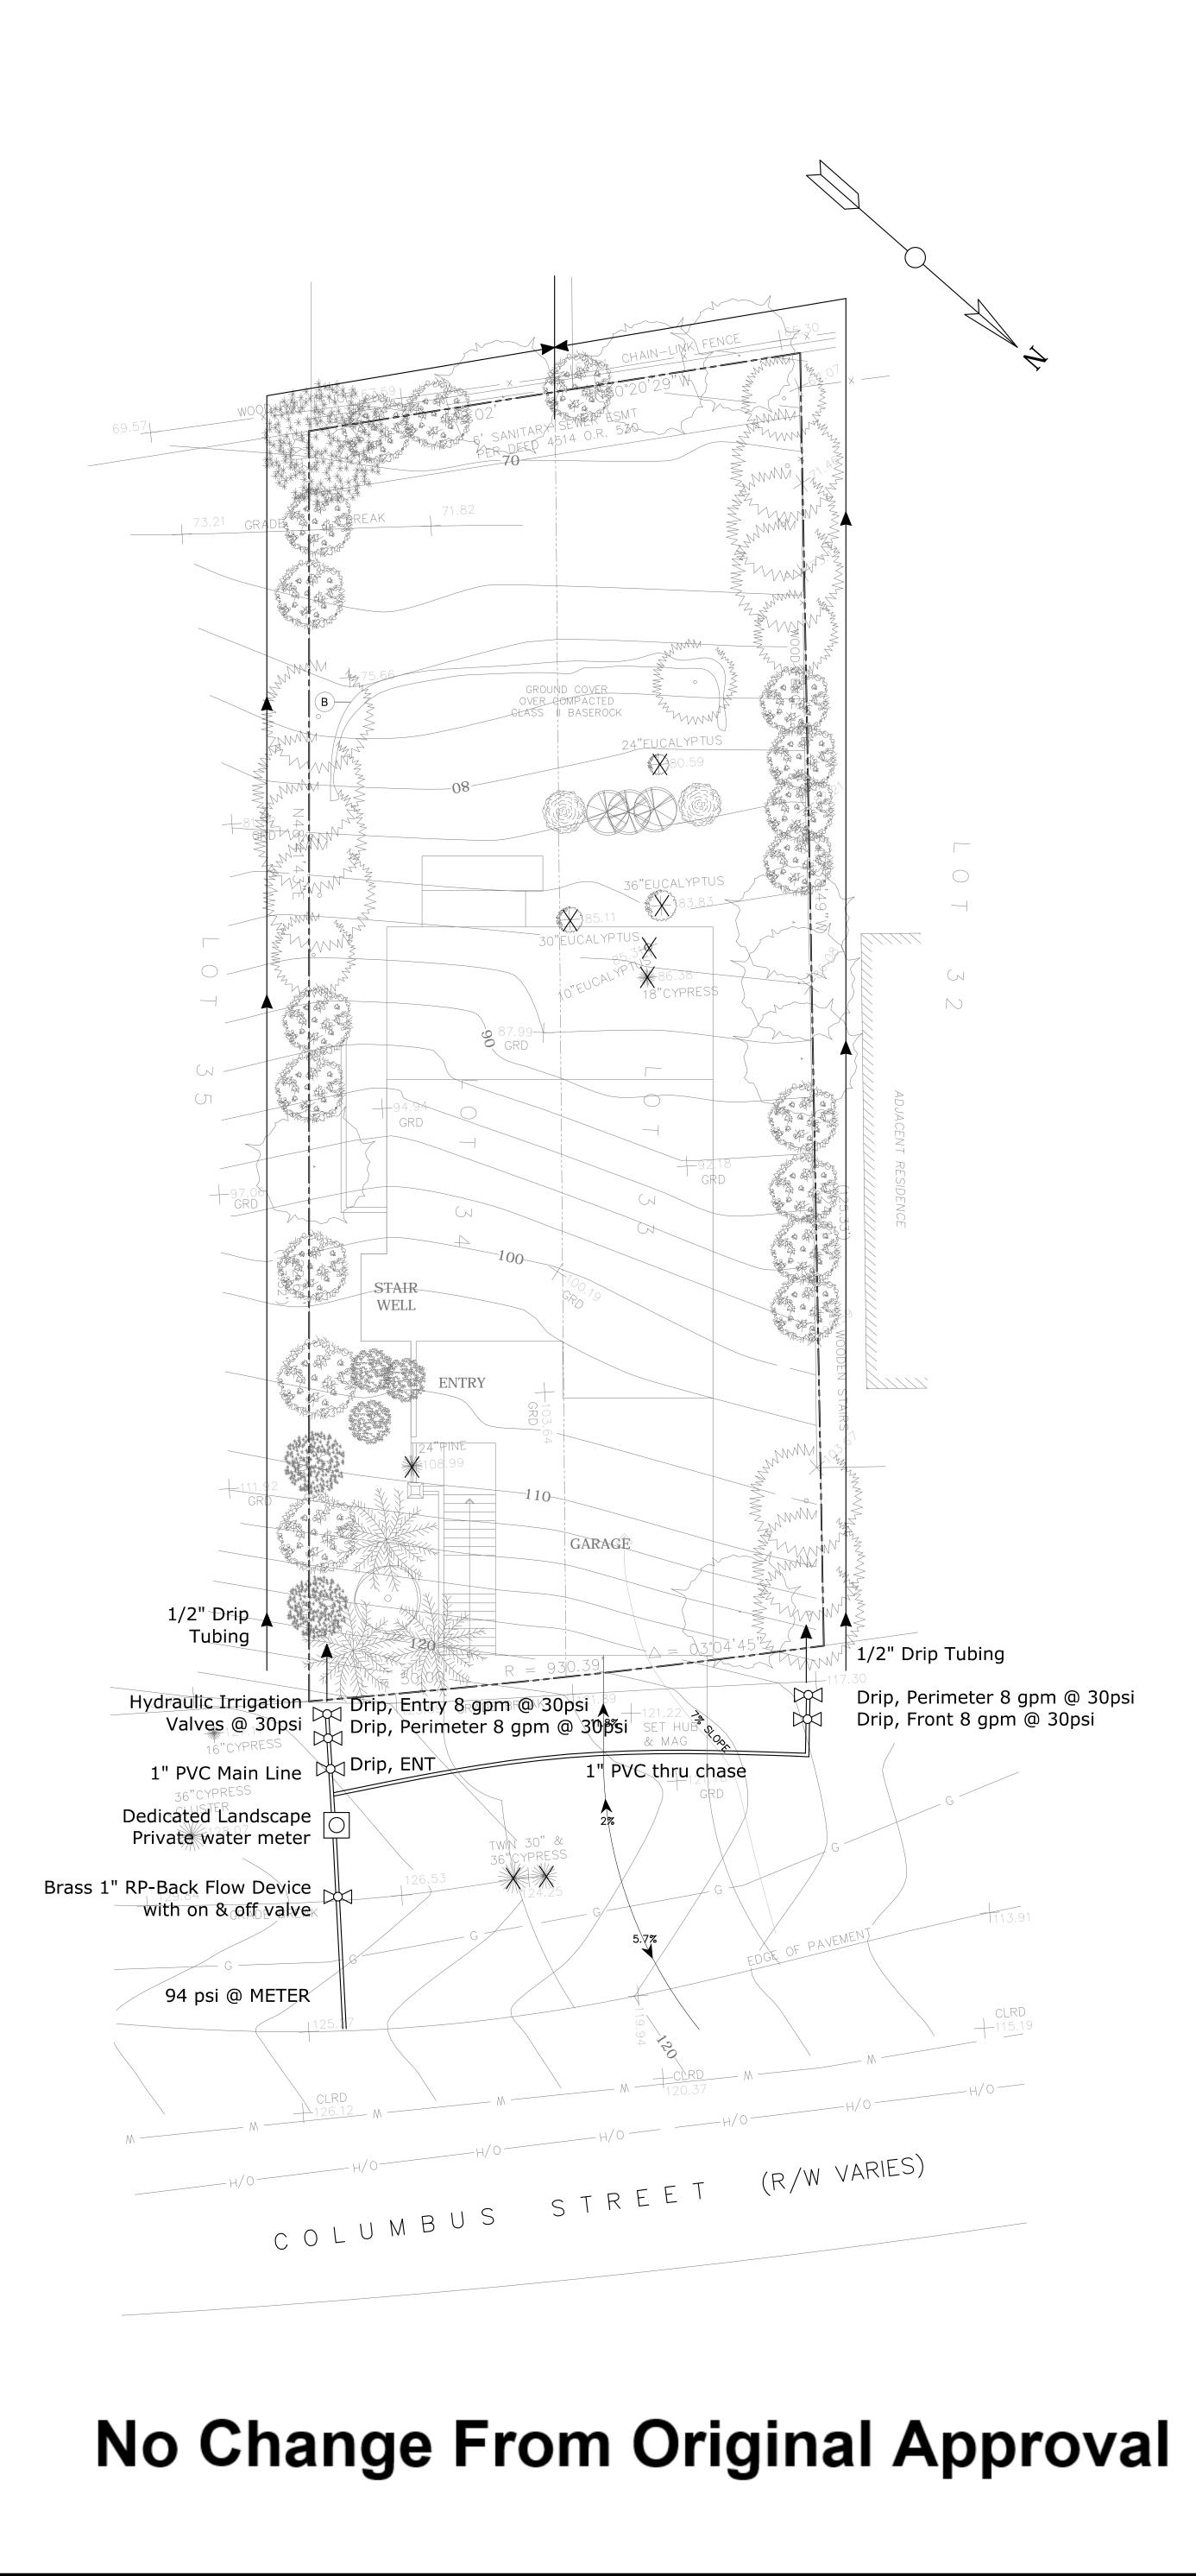

DRIP IRRIGATION SYSTEM:

Consists of Pressure Reducer, Y-Filter, Hydraulic Anti-Siphon Valve, 1/2" Tubing to all Plants, 1/2 Gallon, & 1 Gallon Emitters only.

NO MICRO-SPRAYS SHALL BE USED ON THIS SYSTEM.
Drip Emitters shall be placed up-slope of the plants to be watered.

Watering Schedule shall be 1 hour, three times per week, divided into (4) Intervals of 15 minute duration to prevent water run-off.

This is a WELO Compliant Landscape:

- Compost: (4) Yd3 / 1,000 Ft2 to a depth of 6 "to All Planted Areas.
- Plant Water Use: Install climate adapted plants that require occasional, little or no summer water (average WUCOLS plant factor 0.3) for 75% of the plants used.
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COLUMBUS ST. EL GRANADA, CA.