2019 CALIFORNIA ADMINISTRATIVE CODE
2019 CALIFORNIA BUILDING CODE
2019 CALIFORNIA PLUMBING CODE
2019 CALIFORNIA PLUMBING CODE
2019 CALIFORNIA MECHANICAL CODE
2019 CALIFORNIA MECHANICAL CODE
2019 CALIFORNIA RESIDENTIAL CODE
2019 CALIFORNIA ENERGY CODE
2019 CALIFORNIA ENERGY CODE
2019 CALIFORNIA ENERGY CODE
2019 CALIFORNIA EXISTING BUILDING CODE
2019 CALIFORNIA REFERENCED STANDARDS CODE
ALONG WITH ALL OTHER LOCAL AND STATE LAWS AND REGULATIONS.
ADOPTION OF THE 2019 EDITION OF THE CALIFORNIA STATE BUILDING CODES, TITLE 24,
CALIFORNIA CODE OF REGULATIONS 15 MANDATED BY PART 25 OF DIVISION 13 OF THE
CALIFORNIA HEALTH & SAFETY CODE (SECTION 1830) ET SEQ.) THE FOLLOWING LOCAL
AMENDMENTS TO THE CALIFORNIA STATE BUILDING CODES WERE FILED WITH THE BUILDING
STANDARDS COMMISSION.

GENERAL NOTES:

I ALL DETAILS, MATERIALS, FINISHES AND ASSEMBLIES ARE NOT NECESSARILY SHOWN. THESE FINAL FINISH DETAILS INCLUDING CASEWORK AND MATERIAL SELECTIONS WILL BE COORDINATED BY THE OWNER.

ALL CONSTRUCTION SHALL BE IN ACCORDANCE WITH THE CALIFORNIA BUILDING CODE, APPLICABLE EDITION, AND ALL OTHER PERTINENT CODES, LAWS AND REQUIREMENTS OF THE OCAL BUILDING OFFICIALS, WHETHER OR NOT SPECIFICALLY SHOWN ON THESE DOCUMENTS. THESE OCCUMENTS ARE NOT INTENDED TO SHOW EVERY DETAIL OR CONDITION, MANY DETAILS IN RESIDENTIAL CONSTRUCTION ARE BUILT ACCORDING TO PROFESSIONAL CONSTRUCTION PRACTICES, AND ARE THEREFORE NOT DETAILED IN THESE DOCUMENTS. CONTACT J C DESIGN, IF CONDITIONS OR OTHER CIRCUMSTANCES REQUIRE CHANGES IN THE WORK SHOWN, OR REQUIRE L'ARIFICATION. ALL WORK SHALL BE DONE IN A HIGH QUALITY MANNER, ACCORDING TO THE REVAILING STANDARDS OF THE INDUSTRY FOR EACH TRADE.

3. THE CONTRACTOR SHALL PROVIDE ALL LABOR, MATERIALS, EQUIPMENT, SUPERVISION AND CLEAN-UP TO ACCOMPLISH ALL OF THE WORK SHOWN, INCLUDING ALL WARRANTIES AND INSTRUCTIONS, TO PROVIDE A COMPLETE WORKING INSTALLATION, AND TO LEAVE THE OWNER WITH AN APPROVED PRODUCT.

STRUCTURAL OBSERVATION SPECIAL INSPECTION IS REQUIRED FOR

SHEAR WALLS WITH DESIGN LOAD OF 300 PLF, OR GREATER.

NSTALLATION OF EPOXY INSTALLED ANCHOR BOLTS.

ALL UTILITY TRENCHES, BUILDING PAD SHALL BE PROPERLY BACK-FILLED AND COMPACTED.

THE FOUNDATION EXCAVATION, HOLDOWN.

NSTALLATION OF SIMPSON STRONG WALL

LUMINATED STREET ADDRESS

4. CONTRACTOR SHALL ASSUME COMPLETE AND SOLE RESPONSIBILITY FOR MEANS AND METHODS OF CONSTRUCTION, AND FOR ALL SAFETY MEASURES TO PROTECT ALL PROPERTY, PERSONNEL AND THIRD PARTIES FROM DAMAGE OR INJURY. THIS RESPONSIBILITY SHALL BE CONTINUOUS AND NOT SOLELY DURING WORKING HOURS. CONTRACTOR SHALL DEFEND, INDEMNIFY AND HOLD HARMLESS J C DESIGN. AND RELATED ENGINEERS FROM ANY CLAIMS OF LIABILITY, REAL OR ALLEGED, IN CONNECTION WITH THE PERFORMANCE OF HIS WORK ON THIS PROJECT, EXCEPTING FOR LIABILITY ARISING FROM THE SOLE NEGLIGENCE OF J C DESIGN AND RELATED ENGINEERS.

HESE DOCUMENTS DO NOT CONTAIN PROVISIONS FOR THE HANDLING ARDOUS MATERIALS, SHOULD ANY SUCH MATERIALS BE SUSPECTED IN TO MAKE RECOMMENDATIONS. OR REMOVAL OF ANY

5. PROVIDE ALL MANDATORY FEATURES REQUIRED BY THE T-24 ENERGY CODE, INCLUDING JUEATHER-STRIPPING, BUILDING INSULATION, PIPE INSULATION, LIGHTING AND APPLIANCE YEASURES, AND OTHER FEATURES REQUIRED BY TITLE 24 OR OTHER STATE, FEDERAL OF LOCAL

T, NO PERSON SHALL ERECT (INCLUDING EXCAVATION AND GRADING), DEMOLISH, ALTER OR REPAIR ANY BUILDING OR STRUCTURE OTHER THAN BETWEEN THE HOURS PERMITTED BY THE LOCAL JURISDICTION.

FIRE SPRINKLER NOTE ; 1. FIRE SPRINKLER SYSTEM SHALL UNDER A SEPARATE PERMIT,

BE INSTALLED THROUGHOUT THE ENTIRE STRUCTURE

EXISTING GARAGE AREA:

EXISTING MAIN FLOOR:

EXISTING LOWER FLOOR AREA:

TOTAL EXISTING FLOOR AREA:

TOTAL LOT COVERED AREA / RATIO:

PROPOSED LOWER FLOOR ADDITION AREA:

PROPOSED UPPER FLOOR ADDITION AREA:

TOTAL NEW FLOOR ADDITION AREA:

EXISTING CONDITIONED FLOOR AREA:

(EXISTING + NEW) CONDITIONED FLOOR AREA:

TOTAL FLOOR AREA: 10. BUILDING DATA: 8. MAXIMUM ALLOWABLE LOT COVERAGE RATIO = 25%: 9. MAXIMUM FLOOR AREA COVERAGE RATIO = 30%: 1, SITE AREA (BASED ON THE COUNTY RECORD): 5, ZONING DISTRICT: 6. LOT SIZE: (EXISTING + NEW) FLOOR AREA / RATIO (F.A.R.) :
TOTAL LOT COVERED AREA / RATIO (L.A.R.) : R-3 DWELLING/ U GARAGE 191,11 SF, 195,10 SF, 993,41 SF, 1,711,39 SF, 2,704,86 SF, 3,131,20 SF, 3,131,20 SF, 3,131,20 SF, 2,291,08 SF, 24,93 % *0*57-262-2*00* 9,191,0 SQ. FT. 2,137.73 SF. SF./ 14.79 % YOU NA

5000 BOUNDARY SURVEY
GRADING & DRAINAGE PLAN
CONSTRUCTION BEST MANAGEMENT PRACTICES

LANDSCAPE LANDSCAPE PLAN & NOTES

COVER SHEET

PROPOSED SITE/ ROOF PLAN

EXISTING MAIN/ LOWER & UPPER FLOOR PLAN

LOWER & MAIN & UPPER FLOOR DEMOLITION PLAN

LOWER & MAIN FLOOR, UPPER FLOOR UN-PERMITTED PLAN

PROPOSED MAIN/ LOWER AND UPPER FLOOR PLAN

EXISTING & PROPOSED FRONT & REAR ELEVATION

EXISTING & PROPOSED RIGHT SIDE ELEVATION

EXISTING & PROPOSED LEFT SIDE ELEVATION

BUILDING CROSS SECTION

PROPOSED MANAGEMENT PRACTICE

ARCHITECTURAL

Jefferson Av

10

NOTE:
1. AN AUTOMATIC SPRINKLER SYSTEM (13D) IS REQUIRED THROUGH-OUT THE ENTIRE
2. THE REQUIRED SPRINKLER SYSTEM SHALL BE A DEFERRED SUBMITTAL FOR APPROVAL
3. THE REQUIRED SPRINKLER SYSTEM SHALL BE A DEFERRED SUBMITTAL FOR APPROVAL
4. FROM THE FIRE MARSHALL OF THE CITY OF PALO ALTO PRIOR TO INSTALLATION. ADDRESS NUMBERS ASSIGNED BY THE PLANNING AND BUILDING DIVISION SHALL BE POSTED ON ALL DWELLING UNITS.

Provide an illuminated street address at the entry door per City ordinance. Approved numbers or addresses shall be placed in such a position as to be plainly visible and legible from the street or road fronting the property. Said numbers shall contrast with their background, and shall be a minimum of 1/2 inch stroke by 4 inches high, shall be either internally or externally illuminated. The power of such illumination shall not be normally switchable.

ADDRESS NUMBER AND DIRECTIONAL SIGNS MAY BE REQUIRED AT THE ENTRANCE TO THE DRIVEWAY/ ACCESS ROAD, ROAD FORKS, AND INTERSECTIONS, WHEN LOCATED ON THE STREET THE NUMBERS SHALL BE VISIBLE FROM EACH DIRECTION OF TRAVEL. JACK CHU DESIGN GROUP 55 W. 43RD AVE. 5AN MATEO, CA 94403 CELL: (650) 208-8898 E-MAIL: jackchu21@yahoo.com TROPHRIY OWNER:
MR. CASEY KORSAK
504 LAKEMEAD WAY
EMERALD HILLS, CA 94062
TEL: 650-393-3433 BUILDING DESIGN. BOUNDARY SURVEY:
SAVIOR P. MICALLEF
421 WILDWOOD DRIVE
SOUTH SAN FRANCISCO, CA 94080
TEL: 805-109-2423
TRIAD HOLMES ASSOCIATES, INC.
111 WOODSIDE ROAD, STE. 2A
REDWOOD CITY, CA 94061
TEL: 650-366-0216 ... <u>C</u>

ANDSCAPE

APPROVED FIRE SPRINKLER SYSTEM THE DESIGN AND CONSTRUCTION AND INSTALLATION OF AN APPROVED FIRE SPRINKLER SYSTEM THE DESIGN SHALL BE PROVIDED BY AN APPROVED FIRE SPRINKLER CONTRACTOR THAT IS LICENSED TO WORK IN THE STATE, ALL LABOR, MATERIALS, VALVES, EQUIPMENT AND SERVICES NECESSARY TO COMPLETE THE PROJECT SHALL BE INCLUDED. LAYOUT DRAWINGS, DESIGN AND EQUIPMENT LISTS MUST BE REVIEWED AND APPROVED BY THE FIRE MARSHALL AND THE BUILDING DEPARTMENT PRIOR TO THROUGH OUT, ALL CONCEALED AREAS INCLUDING TO BE COMPLETELY SPRINKLERED CALCULATION WILL ALSO BE COLCULATION WILL ALSO BE REQUIRED TO ENGINEER THE SYSTEM.

SIGMA PRIME GEOSCIENCES, IN 332 PRINCETON AVENUE HALF MOON BAY, CA 94019 TEL.: 650-728-3590 FAX: 650-728-3593

BRUCE A. CHAN
LANDSCAPE ARCHITECT,
923 ARGUELLO STREET, SUITE 200
REDWOOD CITY, CA 94063
TEL.: 650-346-7645
Email: bacla@sbcglobalnet

FMD Engineering, Inc.
Mr. Francisco Duarte
32108 ALVARADO BLVD., #340
UNION CITY, CA 94581
TEL: (510) 427-8747
E-MAIL: fduarte@fmdengr.com

STRUCTURAL

NRG Compliance, LLC Mr. Rick Rocklewitz P.O. BOX #3717 SANTA ROSA, CA 95402 TEL: (707) 237-6957

24:

1. DEMOLISH PARTIAL ROOF FOR THE COFFER CEILING (360.711 SF. OR 17.1 % OF ROO
2. COVERT EXISTING BATHROOM IN BETWEEN BEDROOM *2 AND *3 INTO TWO BATHS.
3. DEMOLISH INTERIOR NON-BEARING WALL AT DINING ROOM.
4. REVERSE THE RUN OF THE STAIR FROM LOWER GARAGE TO MAIN FLOOR.
5. DEMOLISH EXISTING OUT-DATED CABINETS AND COUNTER-TOP, REPLACE WITH NEW LOWER AND UPPER CABINETS WITH GRANITE COUNTER-TOP, REPLACE WITH NEW LOWER AND UPPER ROOM AND NEW PANTRY NEXT TO THE STAIRS.
7. ADD NEW POWDER ROOM AND NEW BATH *1 NEXT TO EXISTING BEDROOM.
8. ADD NEW MASTER SUITE WITH NEW MASTER BATH AND WALK-IN-CLOSET.
9. NEW ADDITION WILL BE ON THE PIER AND GRADE BEAM PER SOIL ENGINEER REPCION NEW DOGLEG STAIR (REPLACE EXISTING) WITH I HOUR ENCLOSURE AT GARAGE LEVING OTHER WOOK PROPOSED AT GARAGE LEVEL.

NDITIONS OF APPROVAL ROJECT IS APPROVED. EMPTION FROM DESIGN VIEW GRANTED.
ONLY PLANNING H EXISTING HOME

210 Industrial Rd #209 San Carlos, CA 94070 O 650-486-0550

shall remain the p ACK CHU DESIGN.; no part thereof sh

Email: casey.korsak@wellsfargoadvisors.com

ADDITION & REMODELING Owner: Mr. Casey Korsak

504 Lakemead Way Emerald Hills, CA 94062 Tel.: 650-393-3433

(2)2 | |2.00,00.1 | |30,31 "F-'e8 (V) (E) 55,-8₁₁ MALK CONC. 185,19° L W SITE PLAN SCALE: 1/8" = 1'-0"

DESIGN

CONSULTING CUSTOM HOMES
REMODELING ADDITION 55 West 43rd Ave San Mateo, CA 94403 C 650-208-8898 F 650-345-9287 jackchu21@yahoo.com

The drawing on this sheet, specification ideas, designs, and arrangements represented thereby are and shall remain the property of JACK CHU DESIGN.; and in no part thereof shall be copied, disclosed to others or used in connection with any work or project other than the specified project for which they have been prepared and developed without the written consent of JACK CHU DESIGN. Visual contact with these plans or specifications shall constitute conclusive evidence of acceptance to these restrictions.

Drawing scales as indicated are for reference only and are not intended to


are not intended to accurately depicy actural or designed conditions. Written dimensions shall govern.

ADDITION & REMODELING
Owner: Mr. Casey Korsak
504 Lakemead Way Emerald Hills, CA 9
Tel.: 650-393-3433

ak@wellsfargoadvisors.com


COMMENTS

JAN. 12, 2021 AS NOTED Jack Chu Korsak

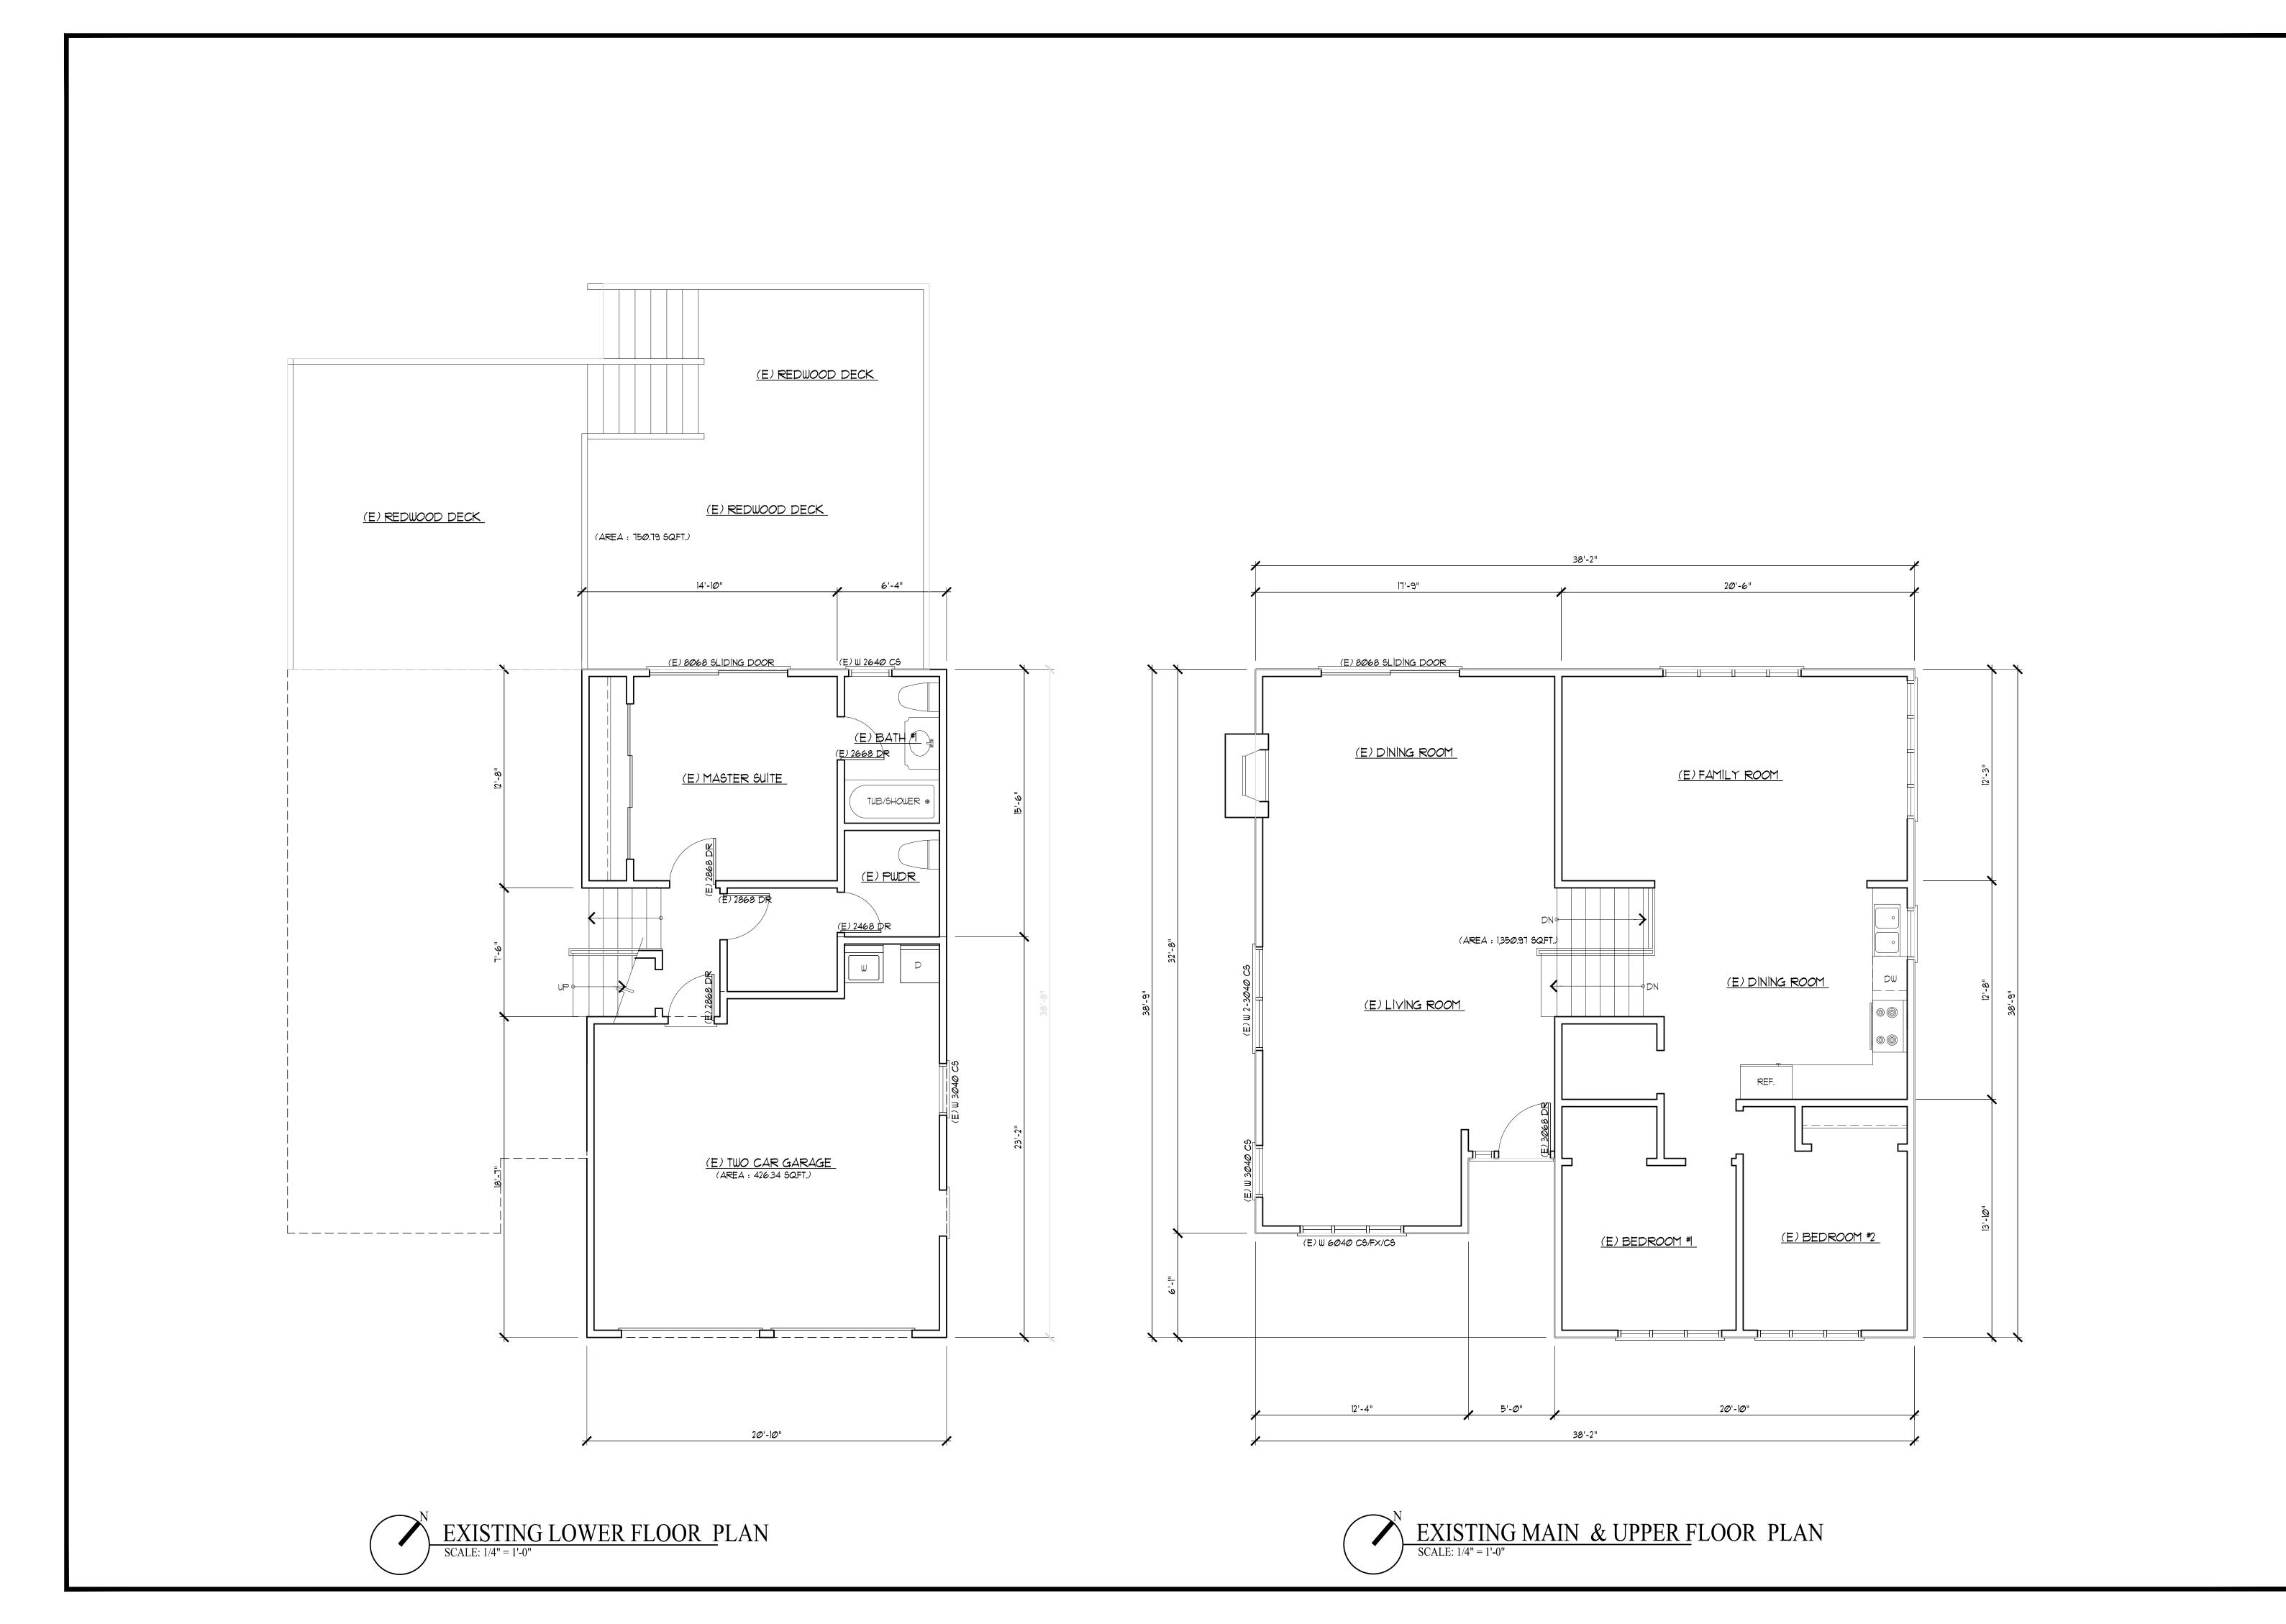


Oct. 30, 2020 AS NOTED


Korsak

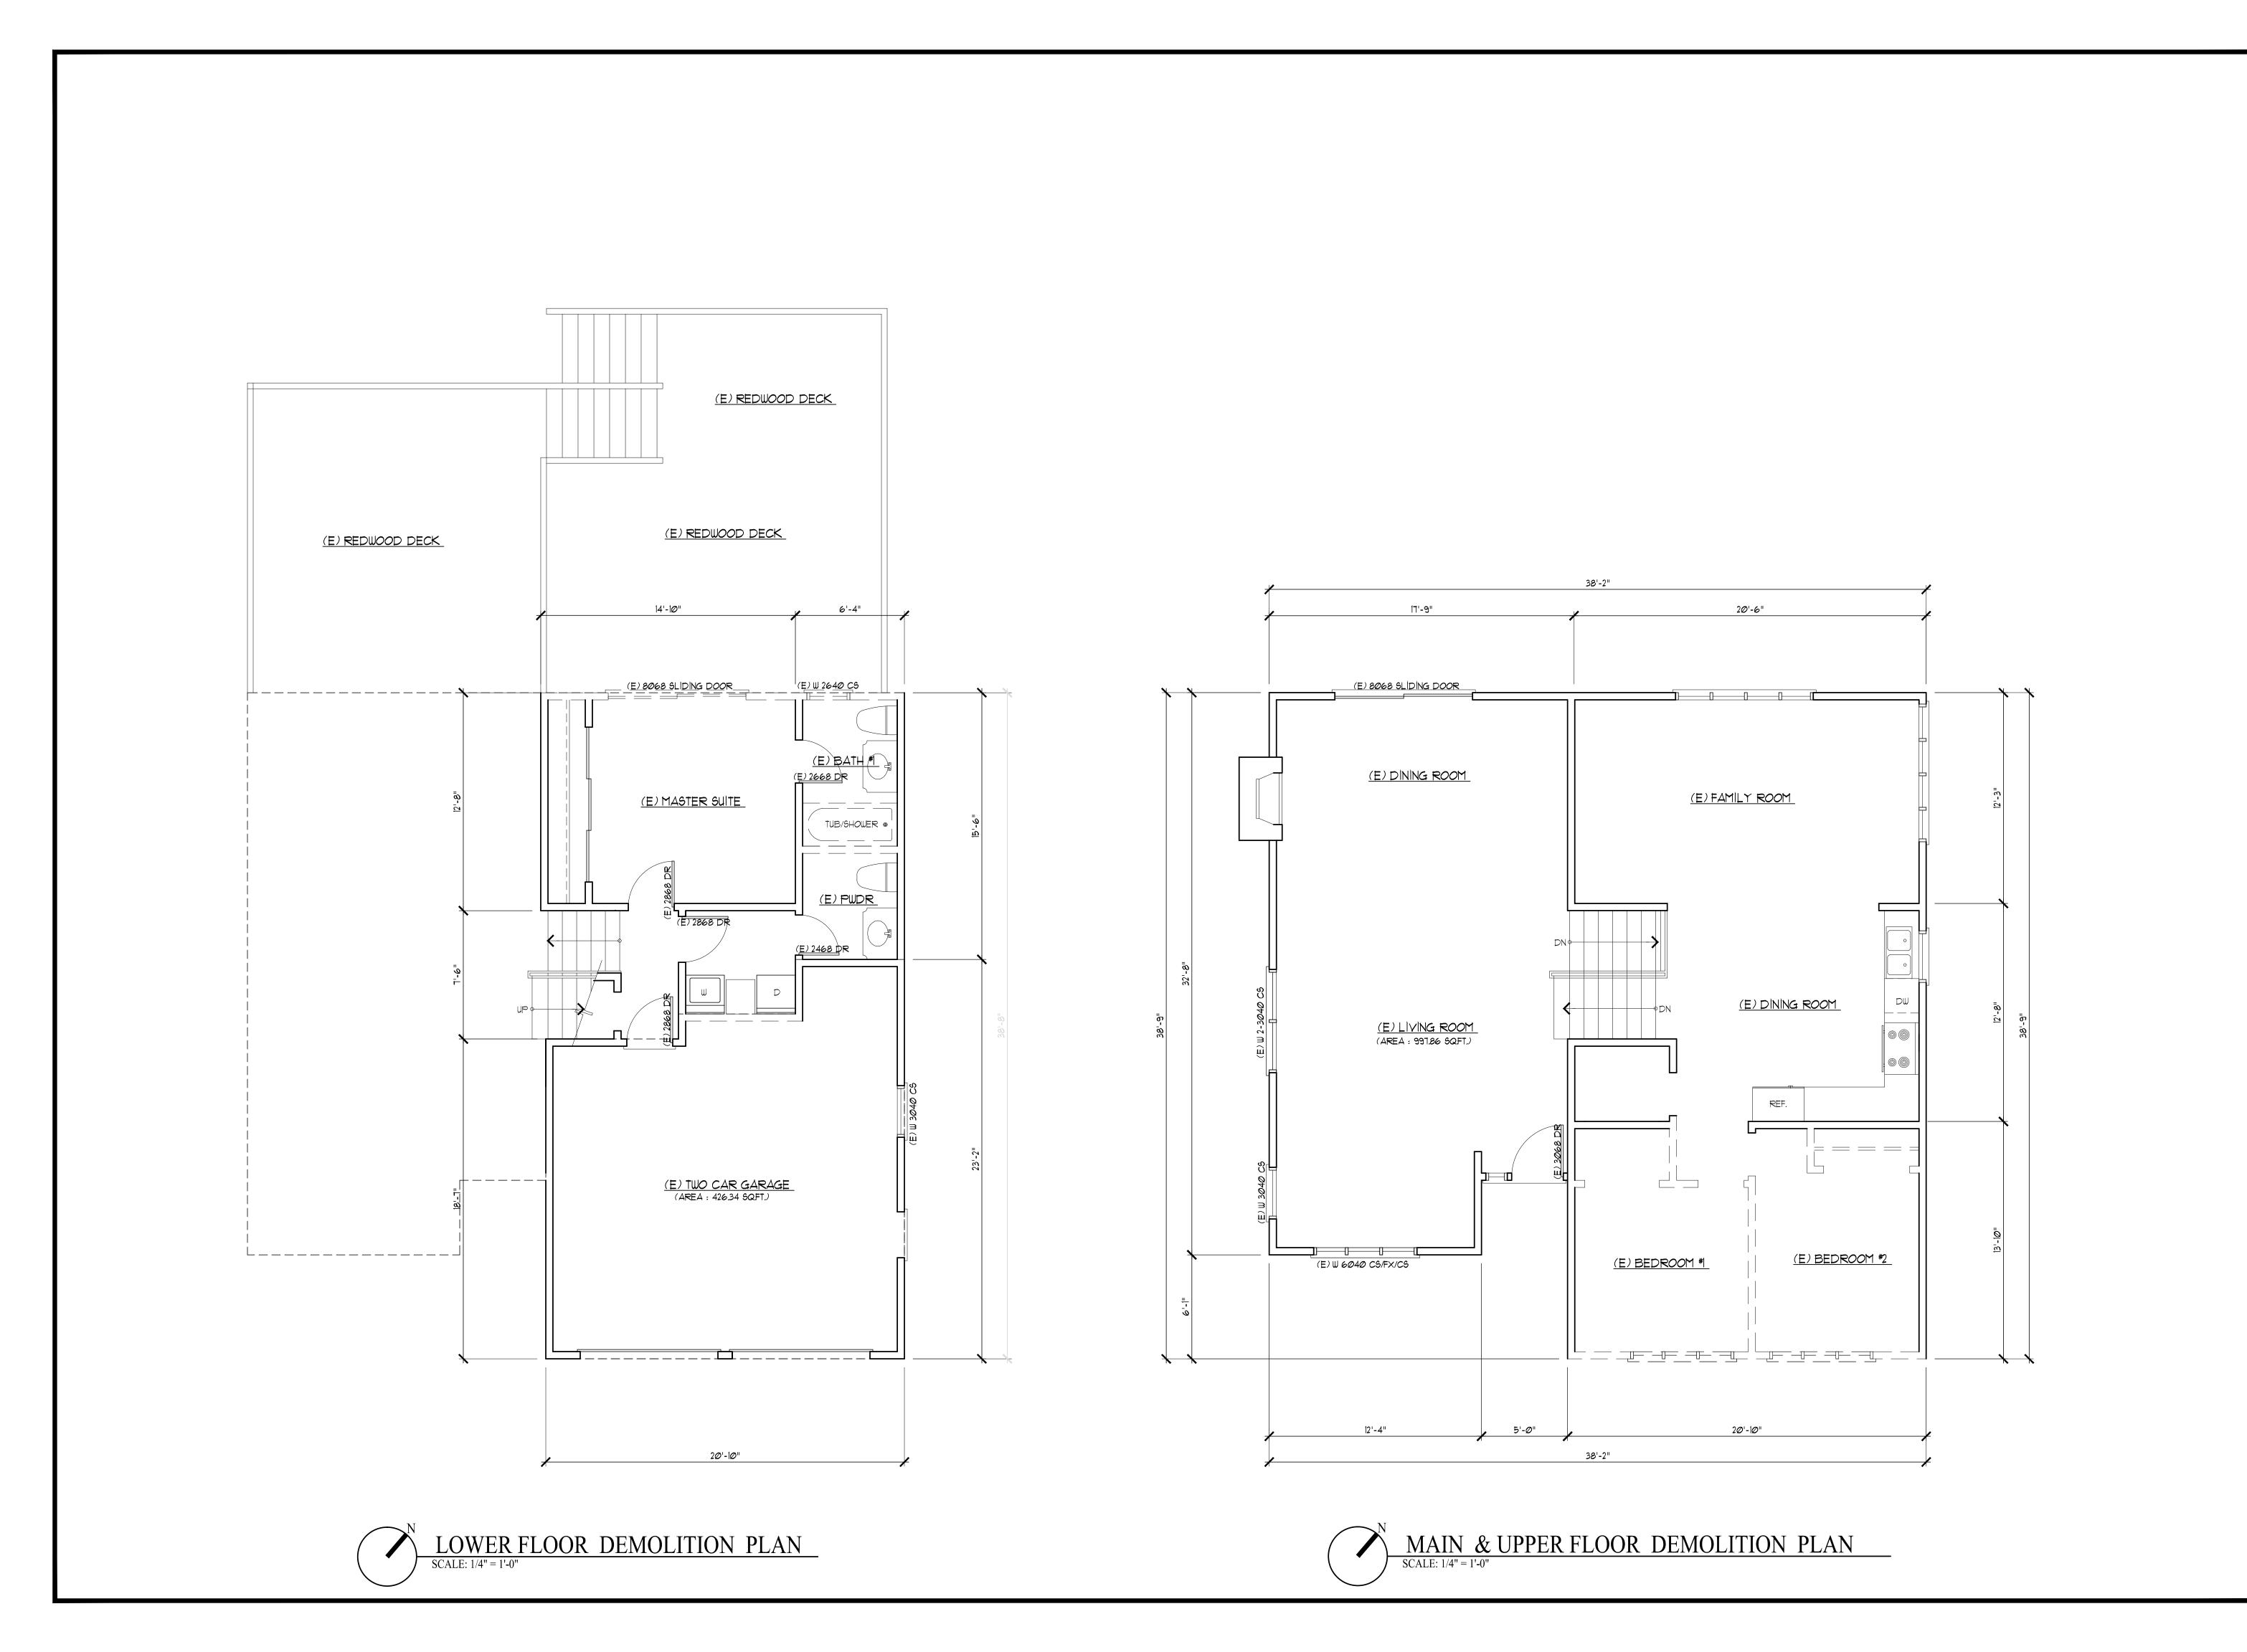

Oct. 30, 2020 AS NOTED

Korsak

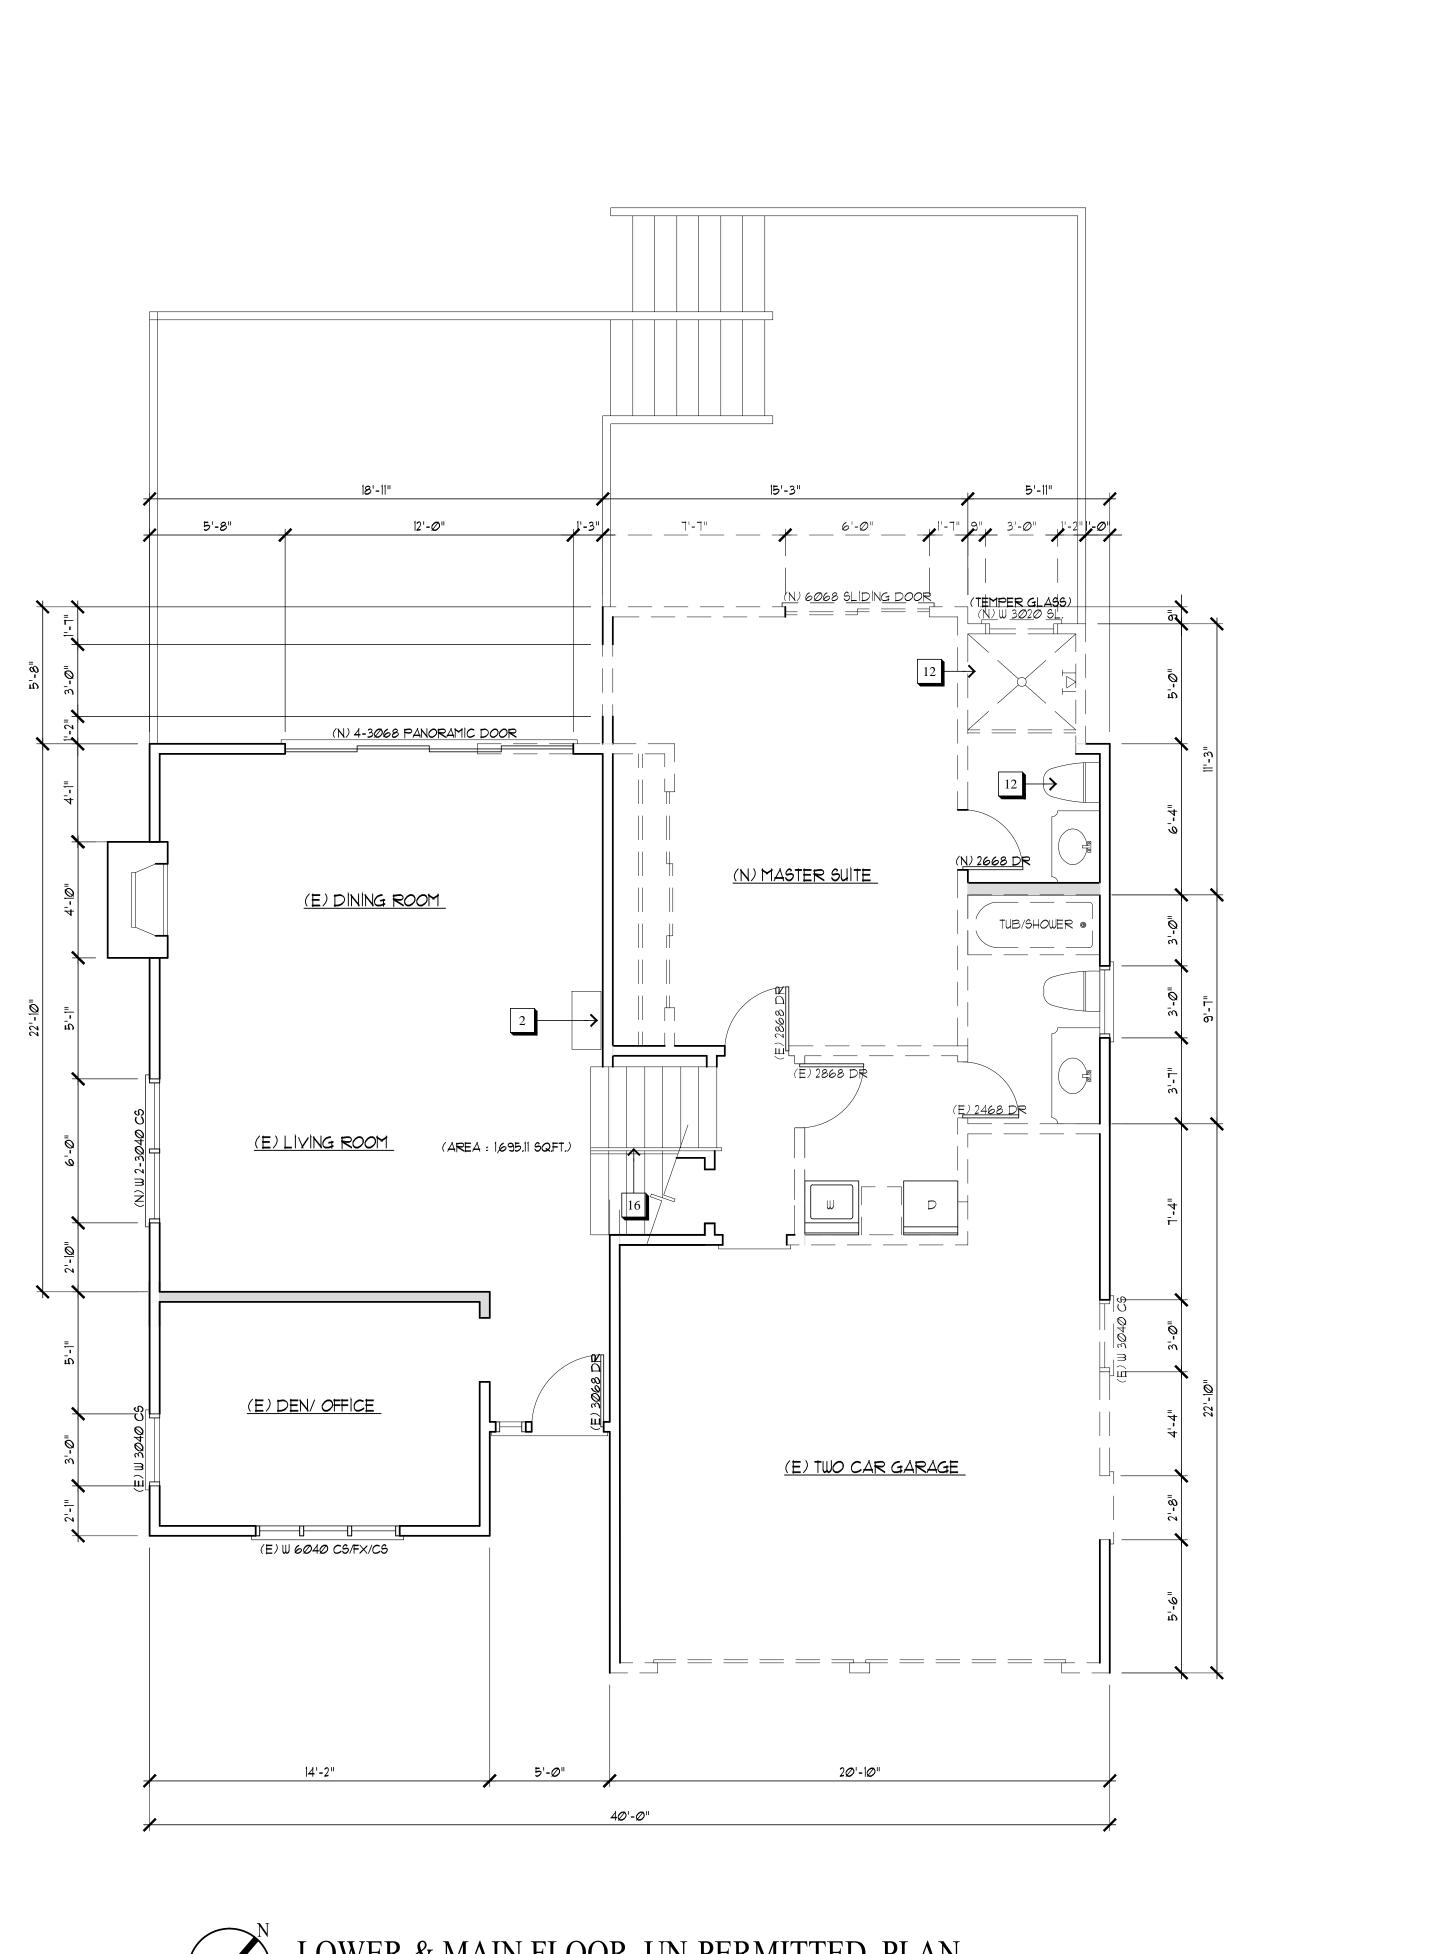

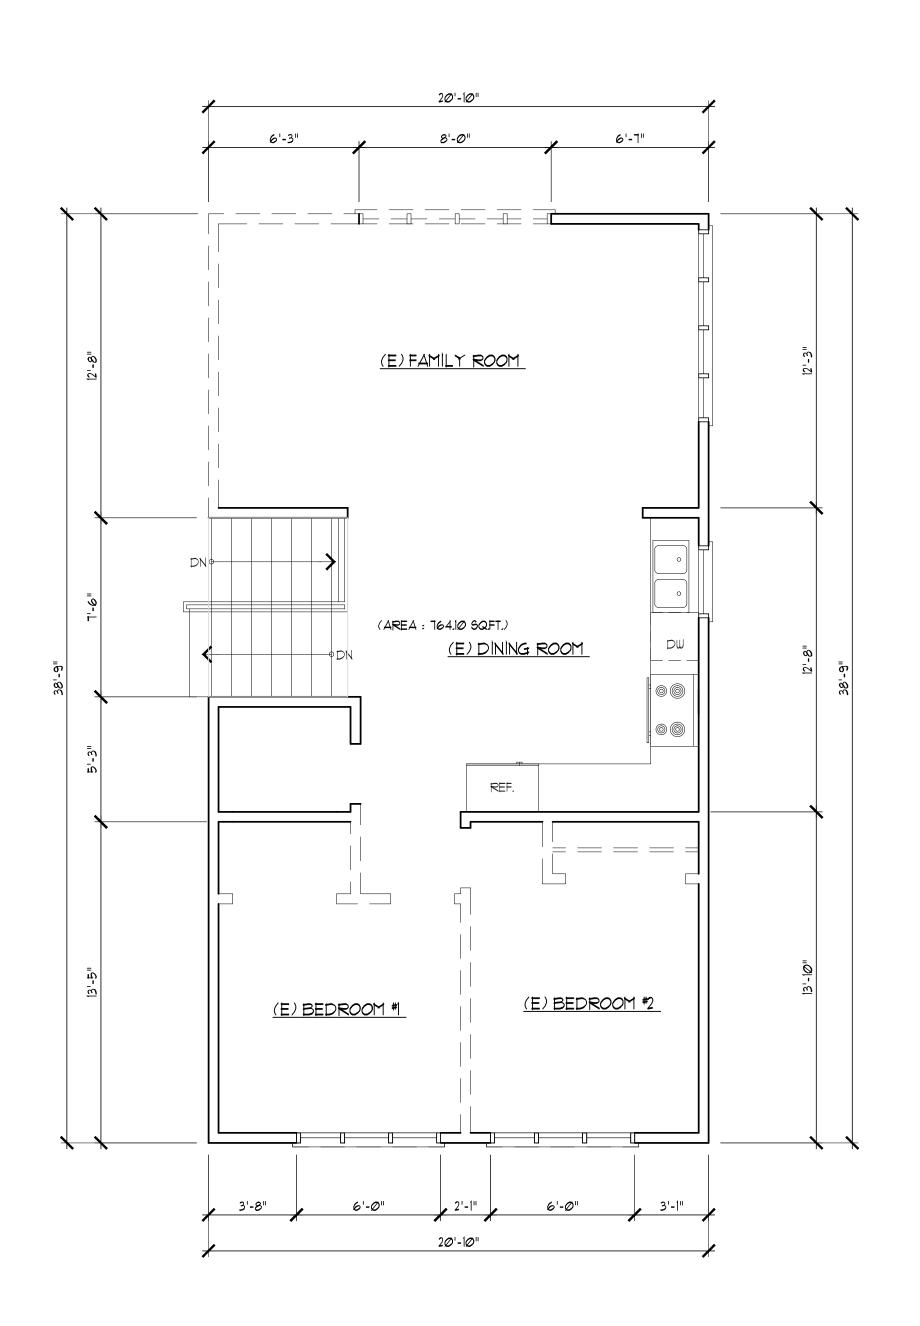


LOWER & MAIN FLOOR UN-PERMITTED PLAN


SCALE: 1/4" = 1'-0"




AS NOTED

Korsak

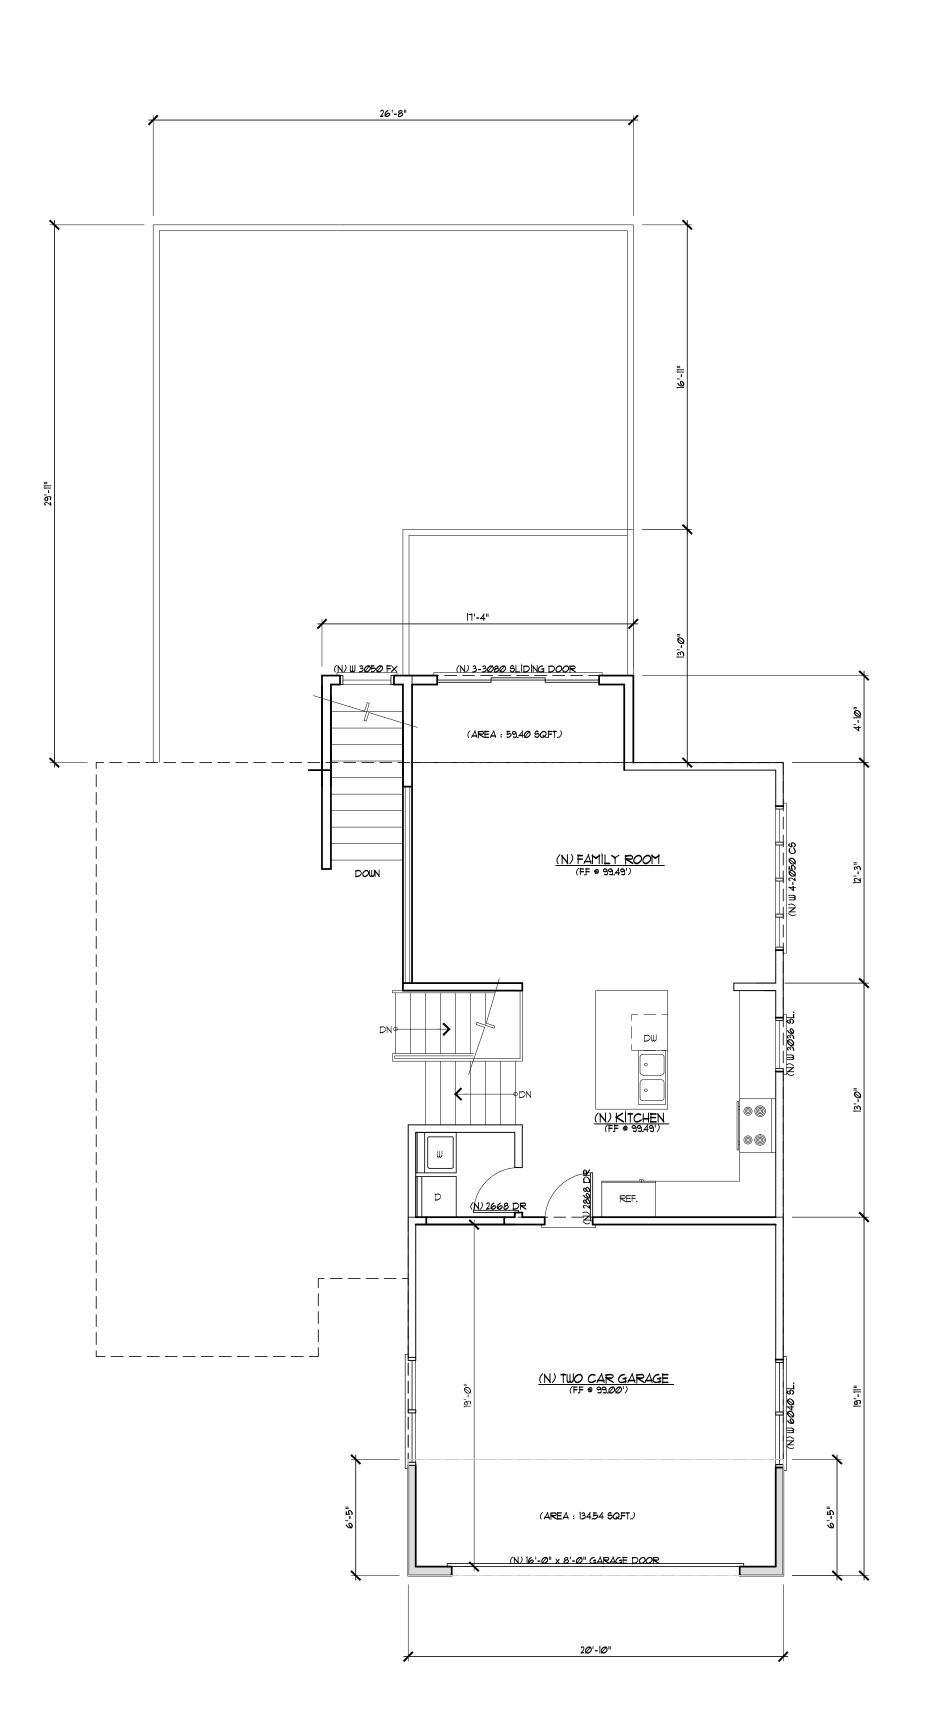

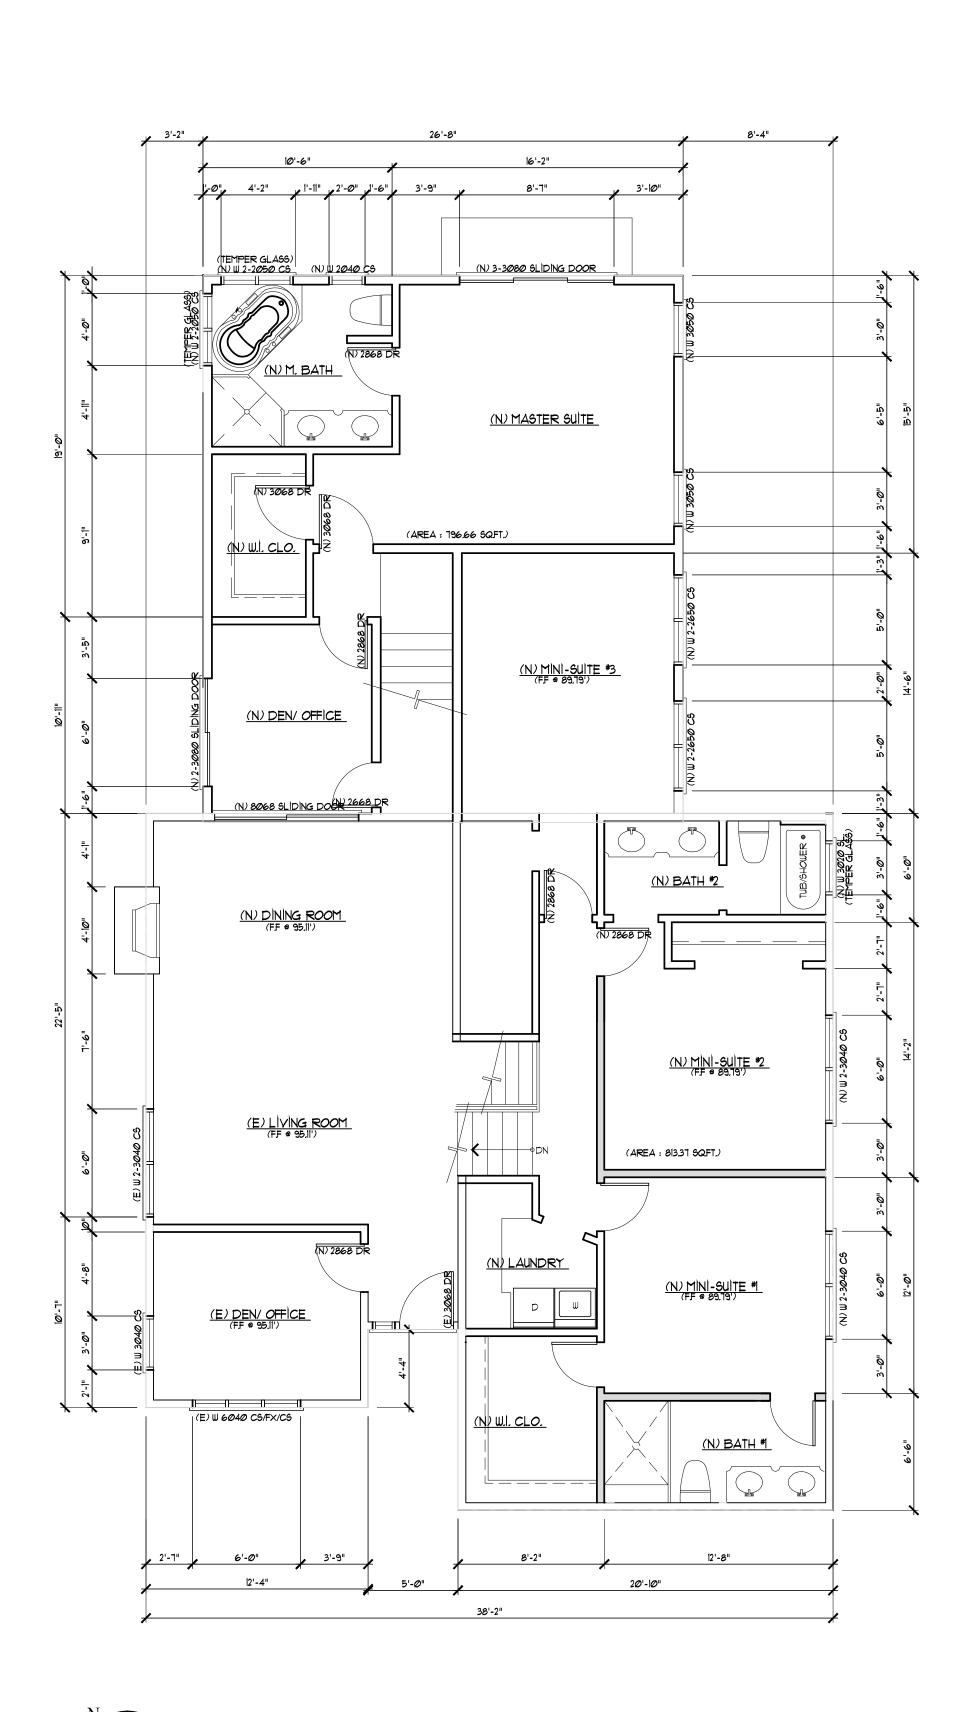

PROPOSED MAIN & LOWER FLOOR PLAN

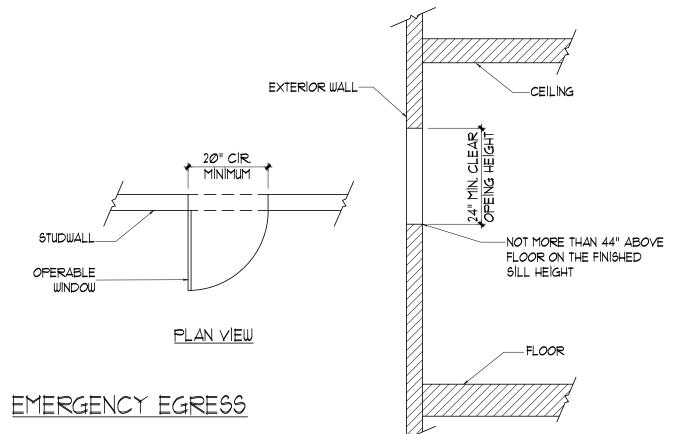

ESCAPE OR RESCUE WINDOWS FROM SLEEPING

ROOMS SHALL HAVE A MINIMUM NET CLEAR OPENING OF 5.7 SQ. FT. EVERY SLEEPING ROOM BELOW THE FOURTH STORY SHALL HAVE AT LEAST ONE OPERABLE WINDOW OR EXTERIOR DOOR APPROVED FOR EMERGENCY ESCAPE OR RESCUE, THE UNITS SHALL BE OPERABLE FROM THE INSIDE TO PROVIDE A CLEAR OPENING WITHOUT THE USE OF SEPARATE TOOLS.

SECTION VIEW

LOCAL VENTILATION RATE SUMMARY ENTER THE REQUIRED FAN FLOW RATE (CFM) BATHROOM FAN FLOW (CFM) = 100 * of BATHROOM = 3USE THE FAN FLOW RATE FROM THIS SUMMARY FOR SELECTION OF THE WHOLE-BUILDING VENTILATION FAN AND FOR THE DUCT DESIGN FOR THE WHOLE-BUILDING VENTILATION SYSTEM FROM TABLE 7.1

DUCT SIZE (INCHES) = 6" MAXIMUM ALLOWABLE DUCT LEGTH (FT) = 125

WATER USE WORKSHEET

EXIS1	٠ +	ΔĽ	DDED	=	sum	TYPE OF FIXTURE	FİXTURE MULTİPLİER	UNITS
1	+		1	-	2	BATH TUB (WITH OR WITHOUT SHOWER)	× 4	8
	+			=	1	CLOTHES WASHER	× 4	4
	+			=	1	DISH WASHER	× 1.5	1.5
2	+		5	=	٦	LAVATORY (BATHROOM SINK)	× 1	7
1	+		1	=	1	STALL SHOWER (COUNT EACH HEAD)	× 2	2
1	+		1	=	2	SINK (KITCHEN SINK OR OTHER SINK)	x 1.5	3.0
2	+		2	=	4	TOILET (WATER CLOSET)	× 2.5	10.0
						FIXTURE	UNÎT TOTAL:	35.50

<u>B</u> 4	<u>athroom ve</u>	<u>NT CALCU</u>	<u>Lation:</u>	
REQUIRED:				
LOCATION	AREA	RATE	TOTAL REQUIRED	
BATH #	25.Ø SQ.FT.	8%	224 SQFT.	
BATH #2	63.95 SQ.FT.	8%	5.11 SQFT.	
BATH #3	63.95 SQ.FT.	8%		
MASTER BATH	96.37 SQ.FT.	8%	7.71 SQ.FT.	
LAUNDRY	37.67 SQ.FT.		3.Ø1 5Q.FT.	
PROVIDED:				
LOCATION	OPENING SIZE / MECH. VENT	aty.	TOTAL PROVIDED	
(E) BATH	2'-Ø"x2'-Ø"	1	4.00 SQFT.	
BATH #2	2'-Ø"x3'-Ø"	1	6.00 SQ.FT.	
MASTER BATH	2'-Ø"x4'-Ø"	1	8.00 SQ.FT.	
LAUNDRY	2'-Ø"×2'-Ø"	1	4.00 SQ.FT.	

FOR INTERMITTENT LOCAL EXHAUST, THE MINIMUM BATHROOM INTERMITTENT VENTILATION AIRFLOW SHALL BE 50 cfm AND FOR KITCHEN HOOD EXHAUST SHALL BE 100 cfm (OR AS AN ALTERNATE, PROVIDE CEILING OR WALL MOUNTED EXHAUST FAN OR DUCTED VENTILATION SYSTEM THAT PROVIDES AT LEAST 5 AIR CHANGES OF THE KITCHEN VOLUME PER HOUR). ASHRAE 622-2010, SEC.

(E) PARTITION TO BE DEMOLISHED

(N) ONE-HOUR FIRE WALL

LEGEND:

(E) PARTÍTION TO REMAÎN

(N) PARTÍTION

CONSULTING CUSTOM HOMES REMODELING ADDITION 55 West 43rd Ave San Mateo, CA 94403 C 650-208-8898 F 650-345-9287 jackchu21@yahoo.com

The drawing on this sheet, specification ideas, designs, and arrangements represented thereby are and shall remain the property of JACK CHU DESIGN.; and in no part thereof shall be copied, disclosed to others or used in connection with any work or project other than the specified project for which they have been prepared and developed without the written consent of JACK CHU DESIGN. Visuo contact with these plans or specifications shall constitute conclusive evidence of acceptance to these restrictions. Drawing scales as indicated are for reference only and are not intended to accurately depicy actural or designed conditions. Written dimensions shall govern.


> wellsfargoadvisor Emerald Hills,


COMMENTS


Korsak


SCALE: 3/16" = 1'-0"


PROPOSED UPPER FLOOR PLAN SCALE: 3/16" = 1'-0"

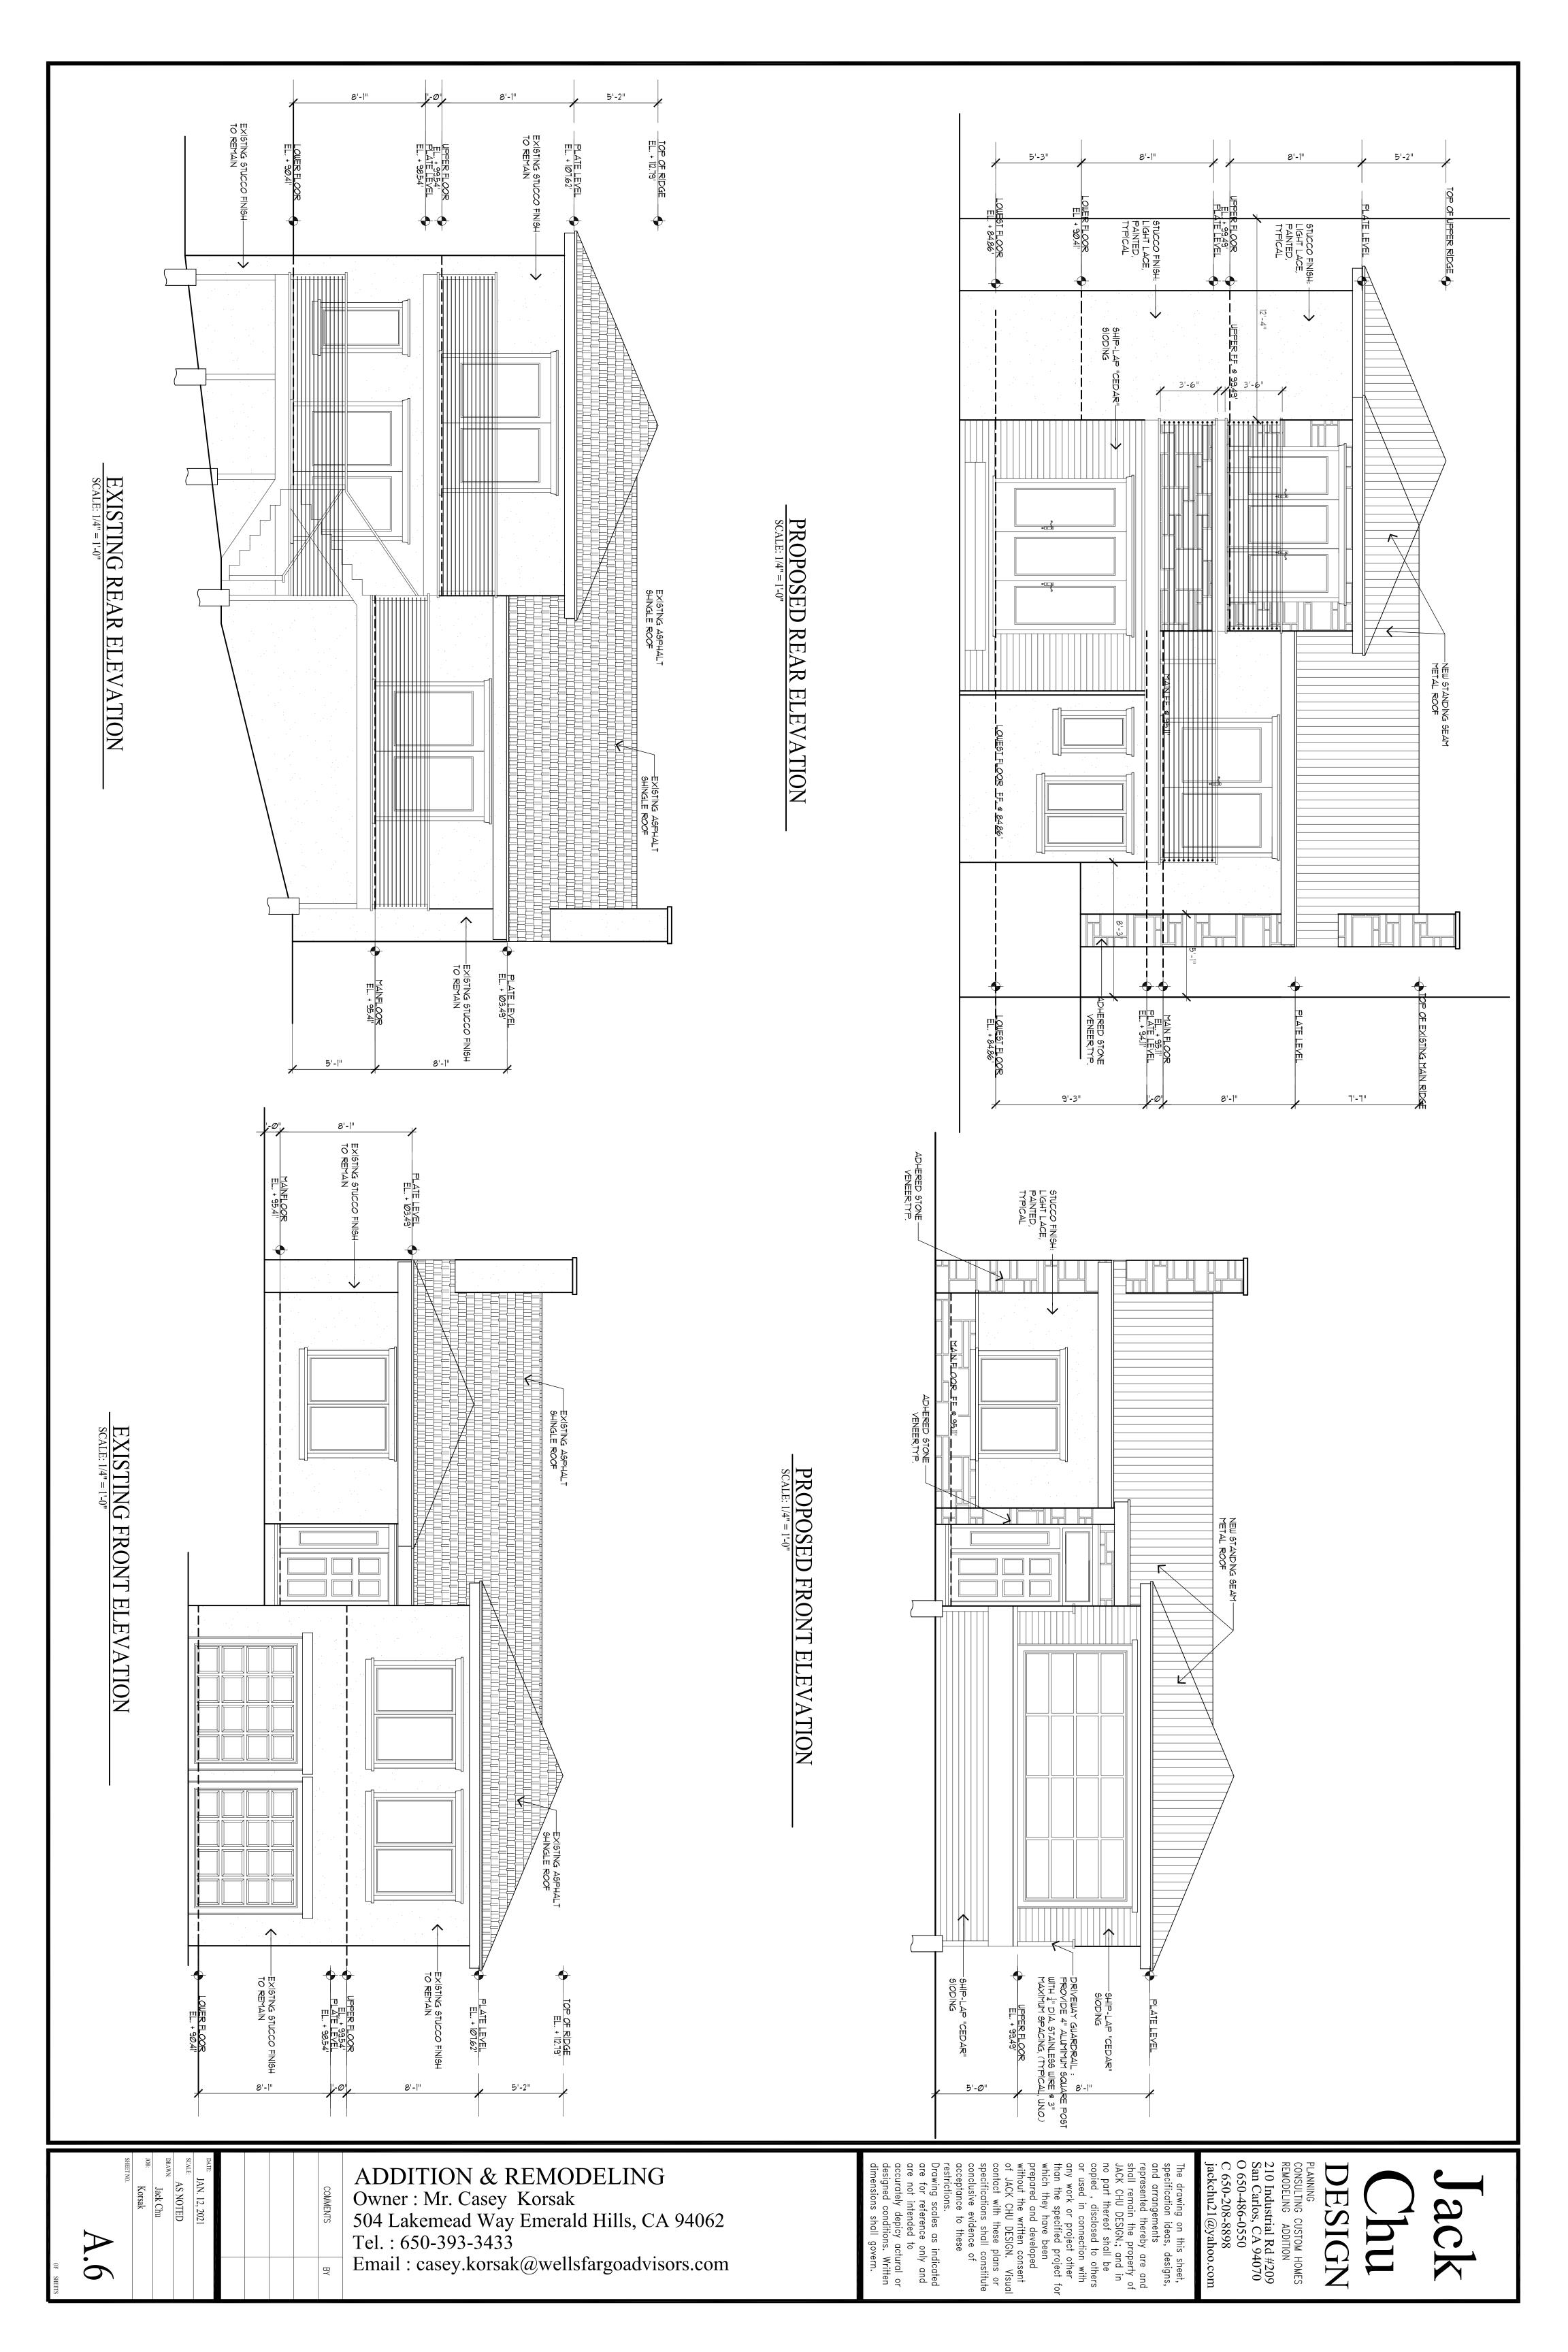

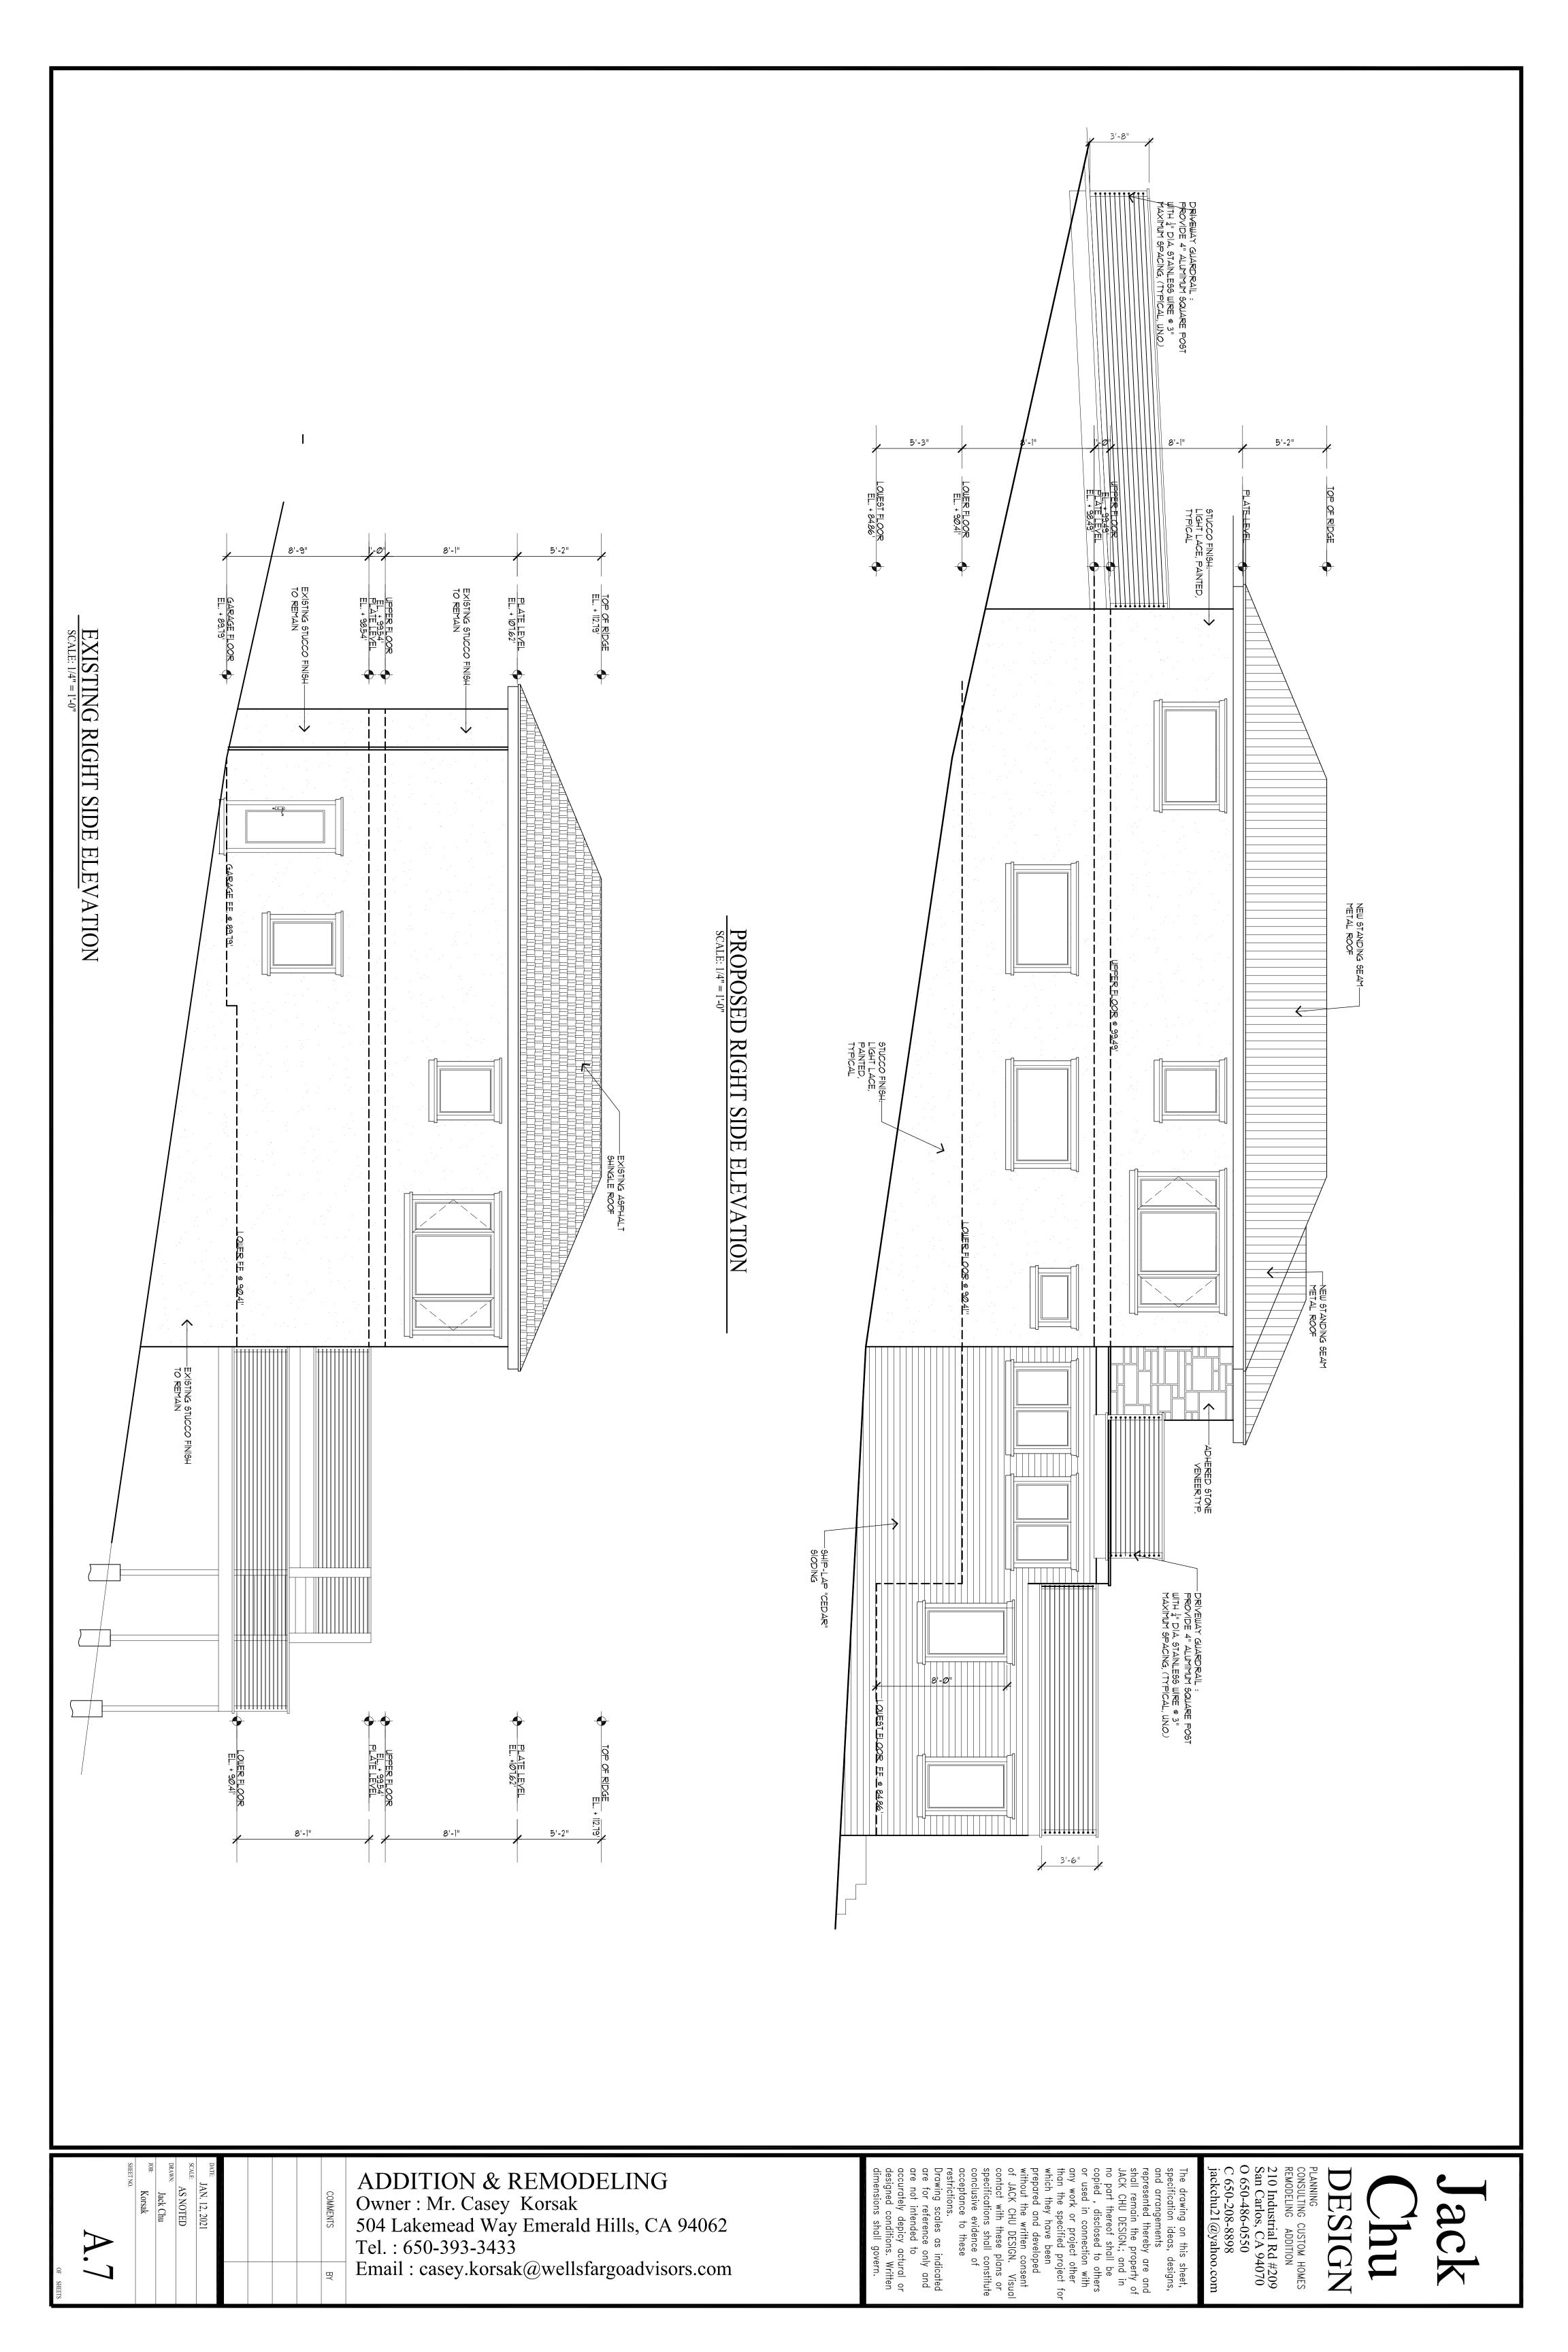

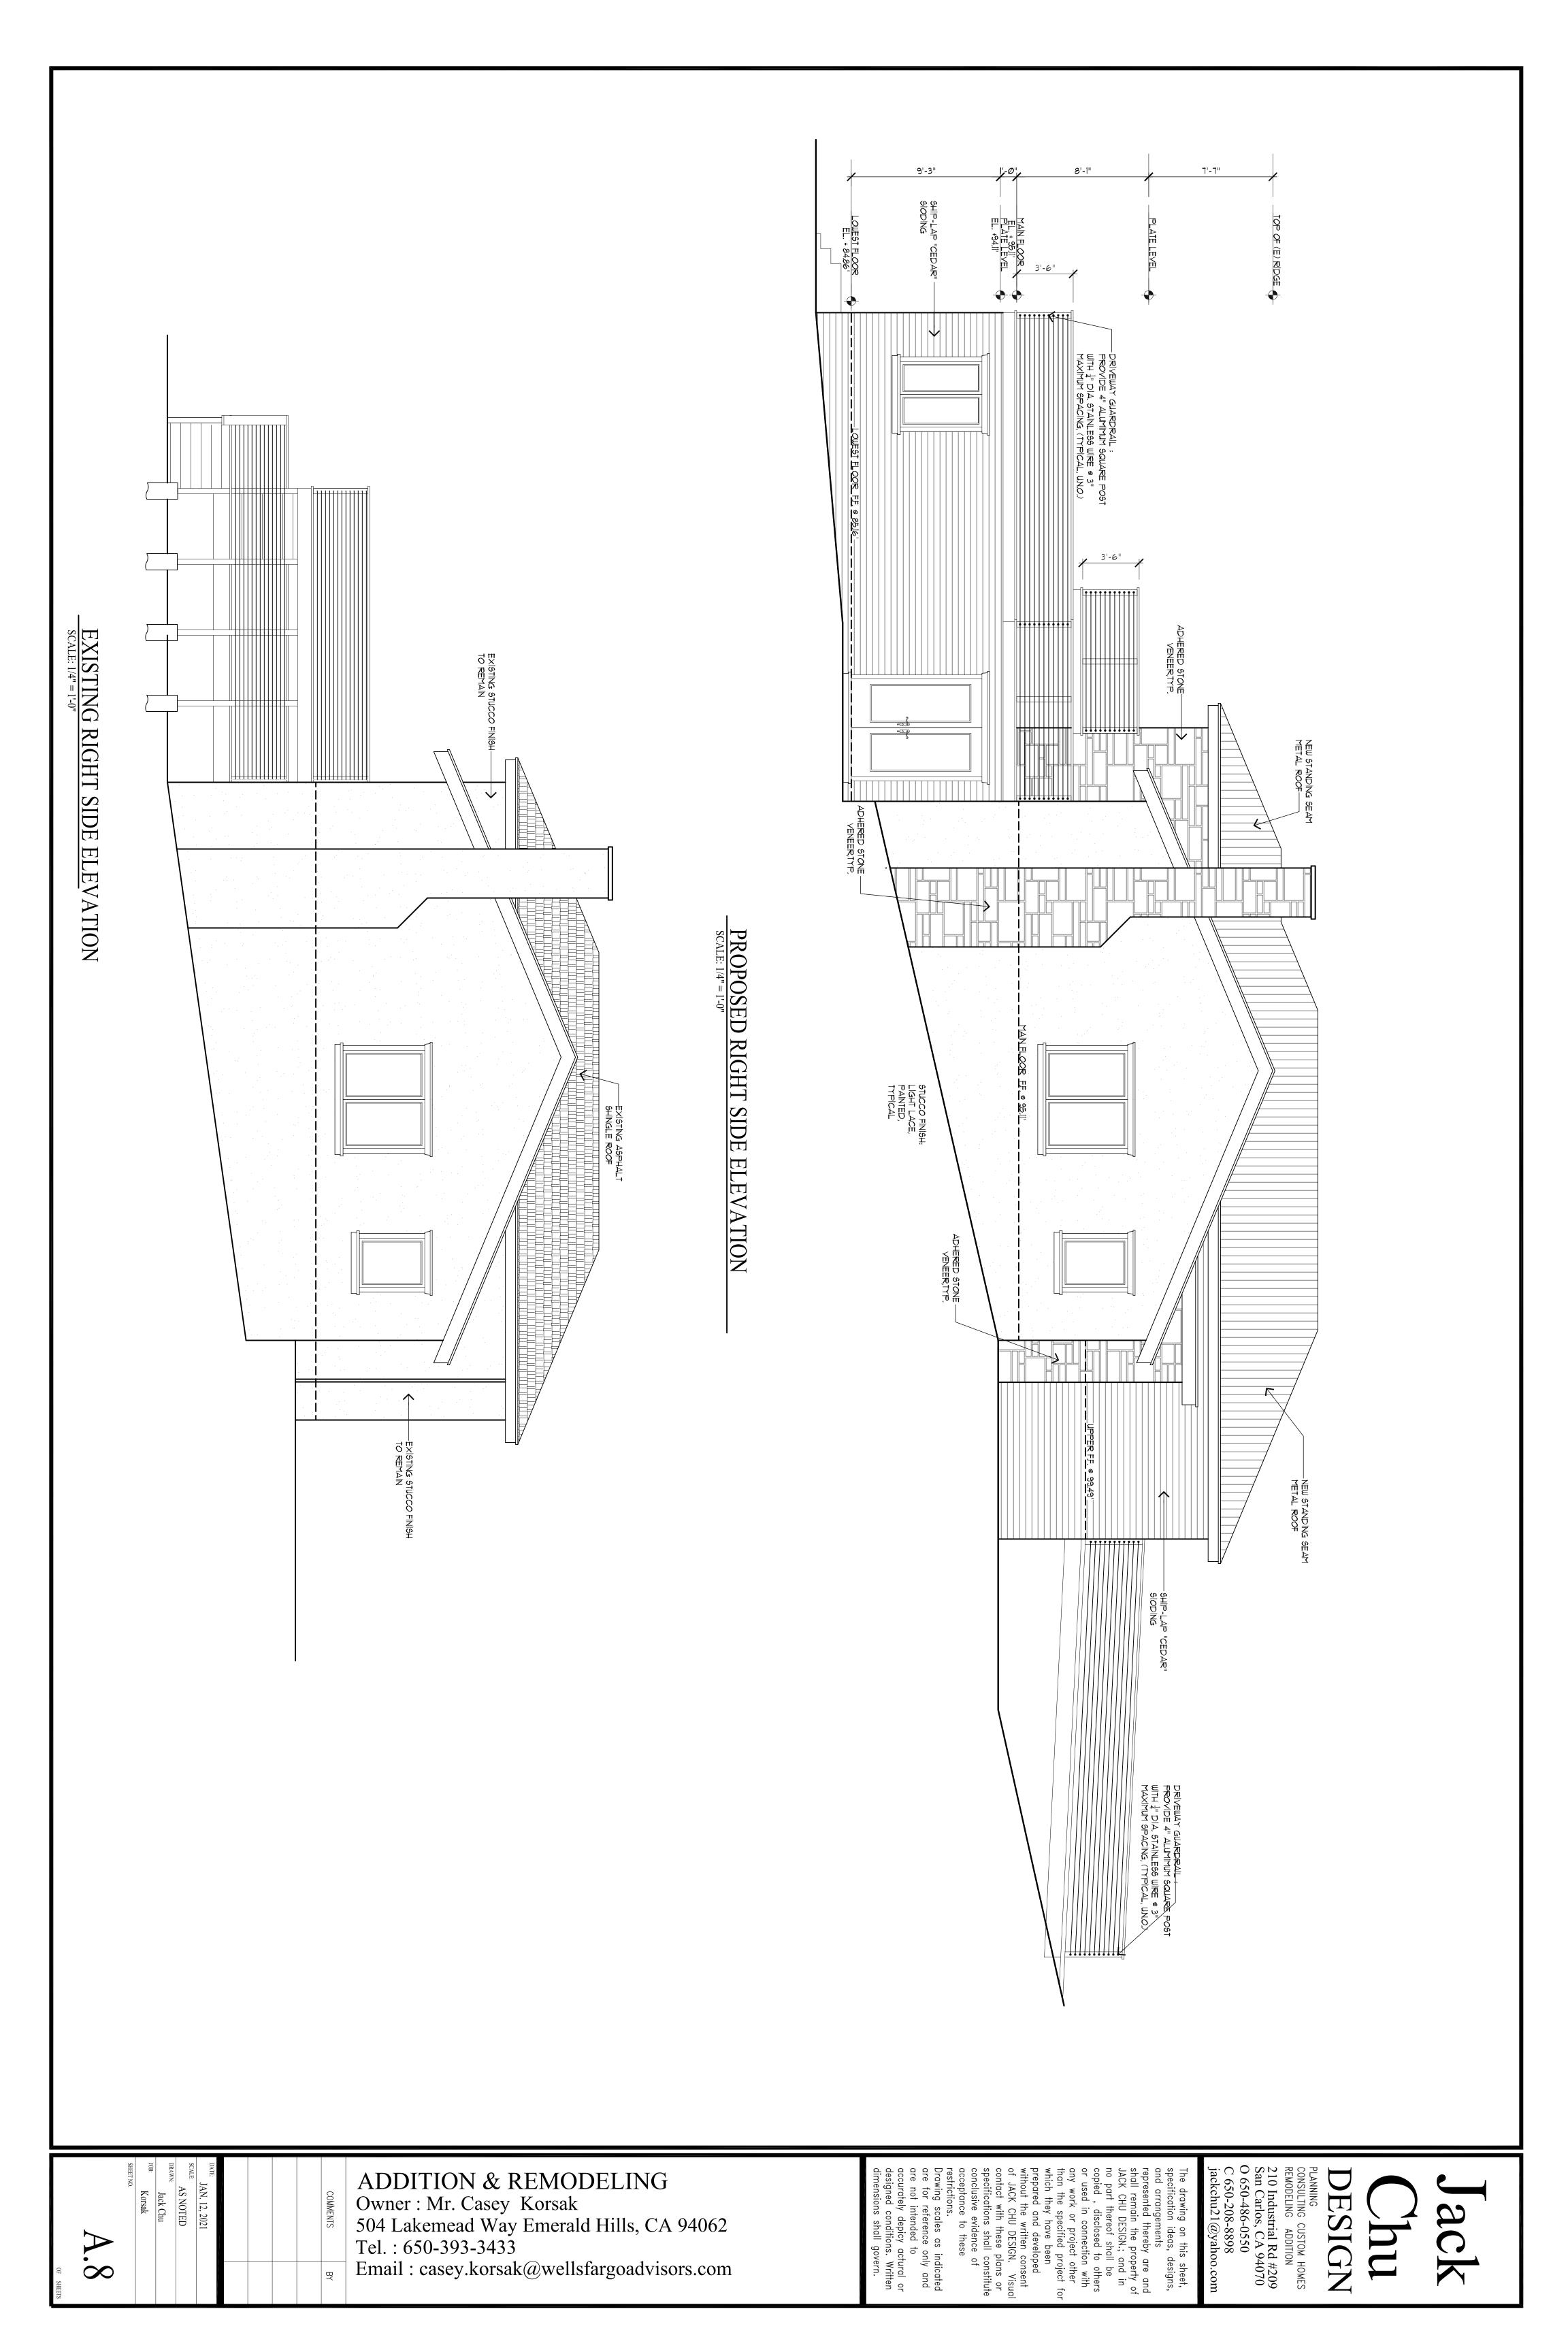

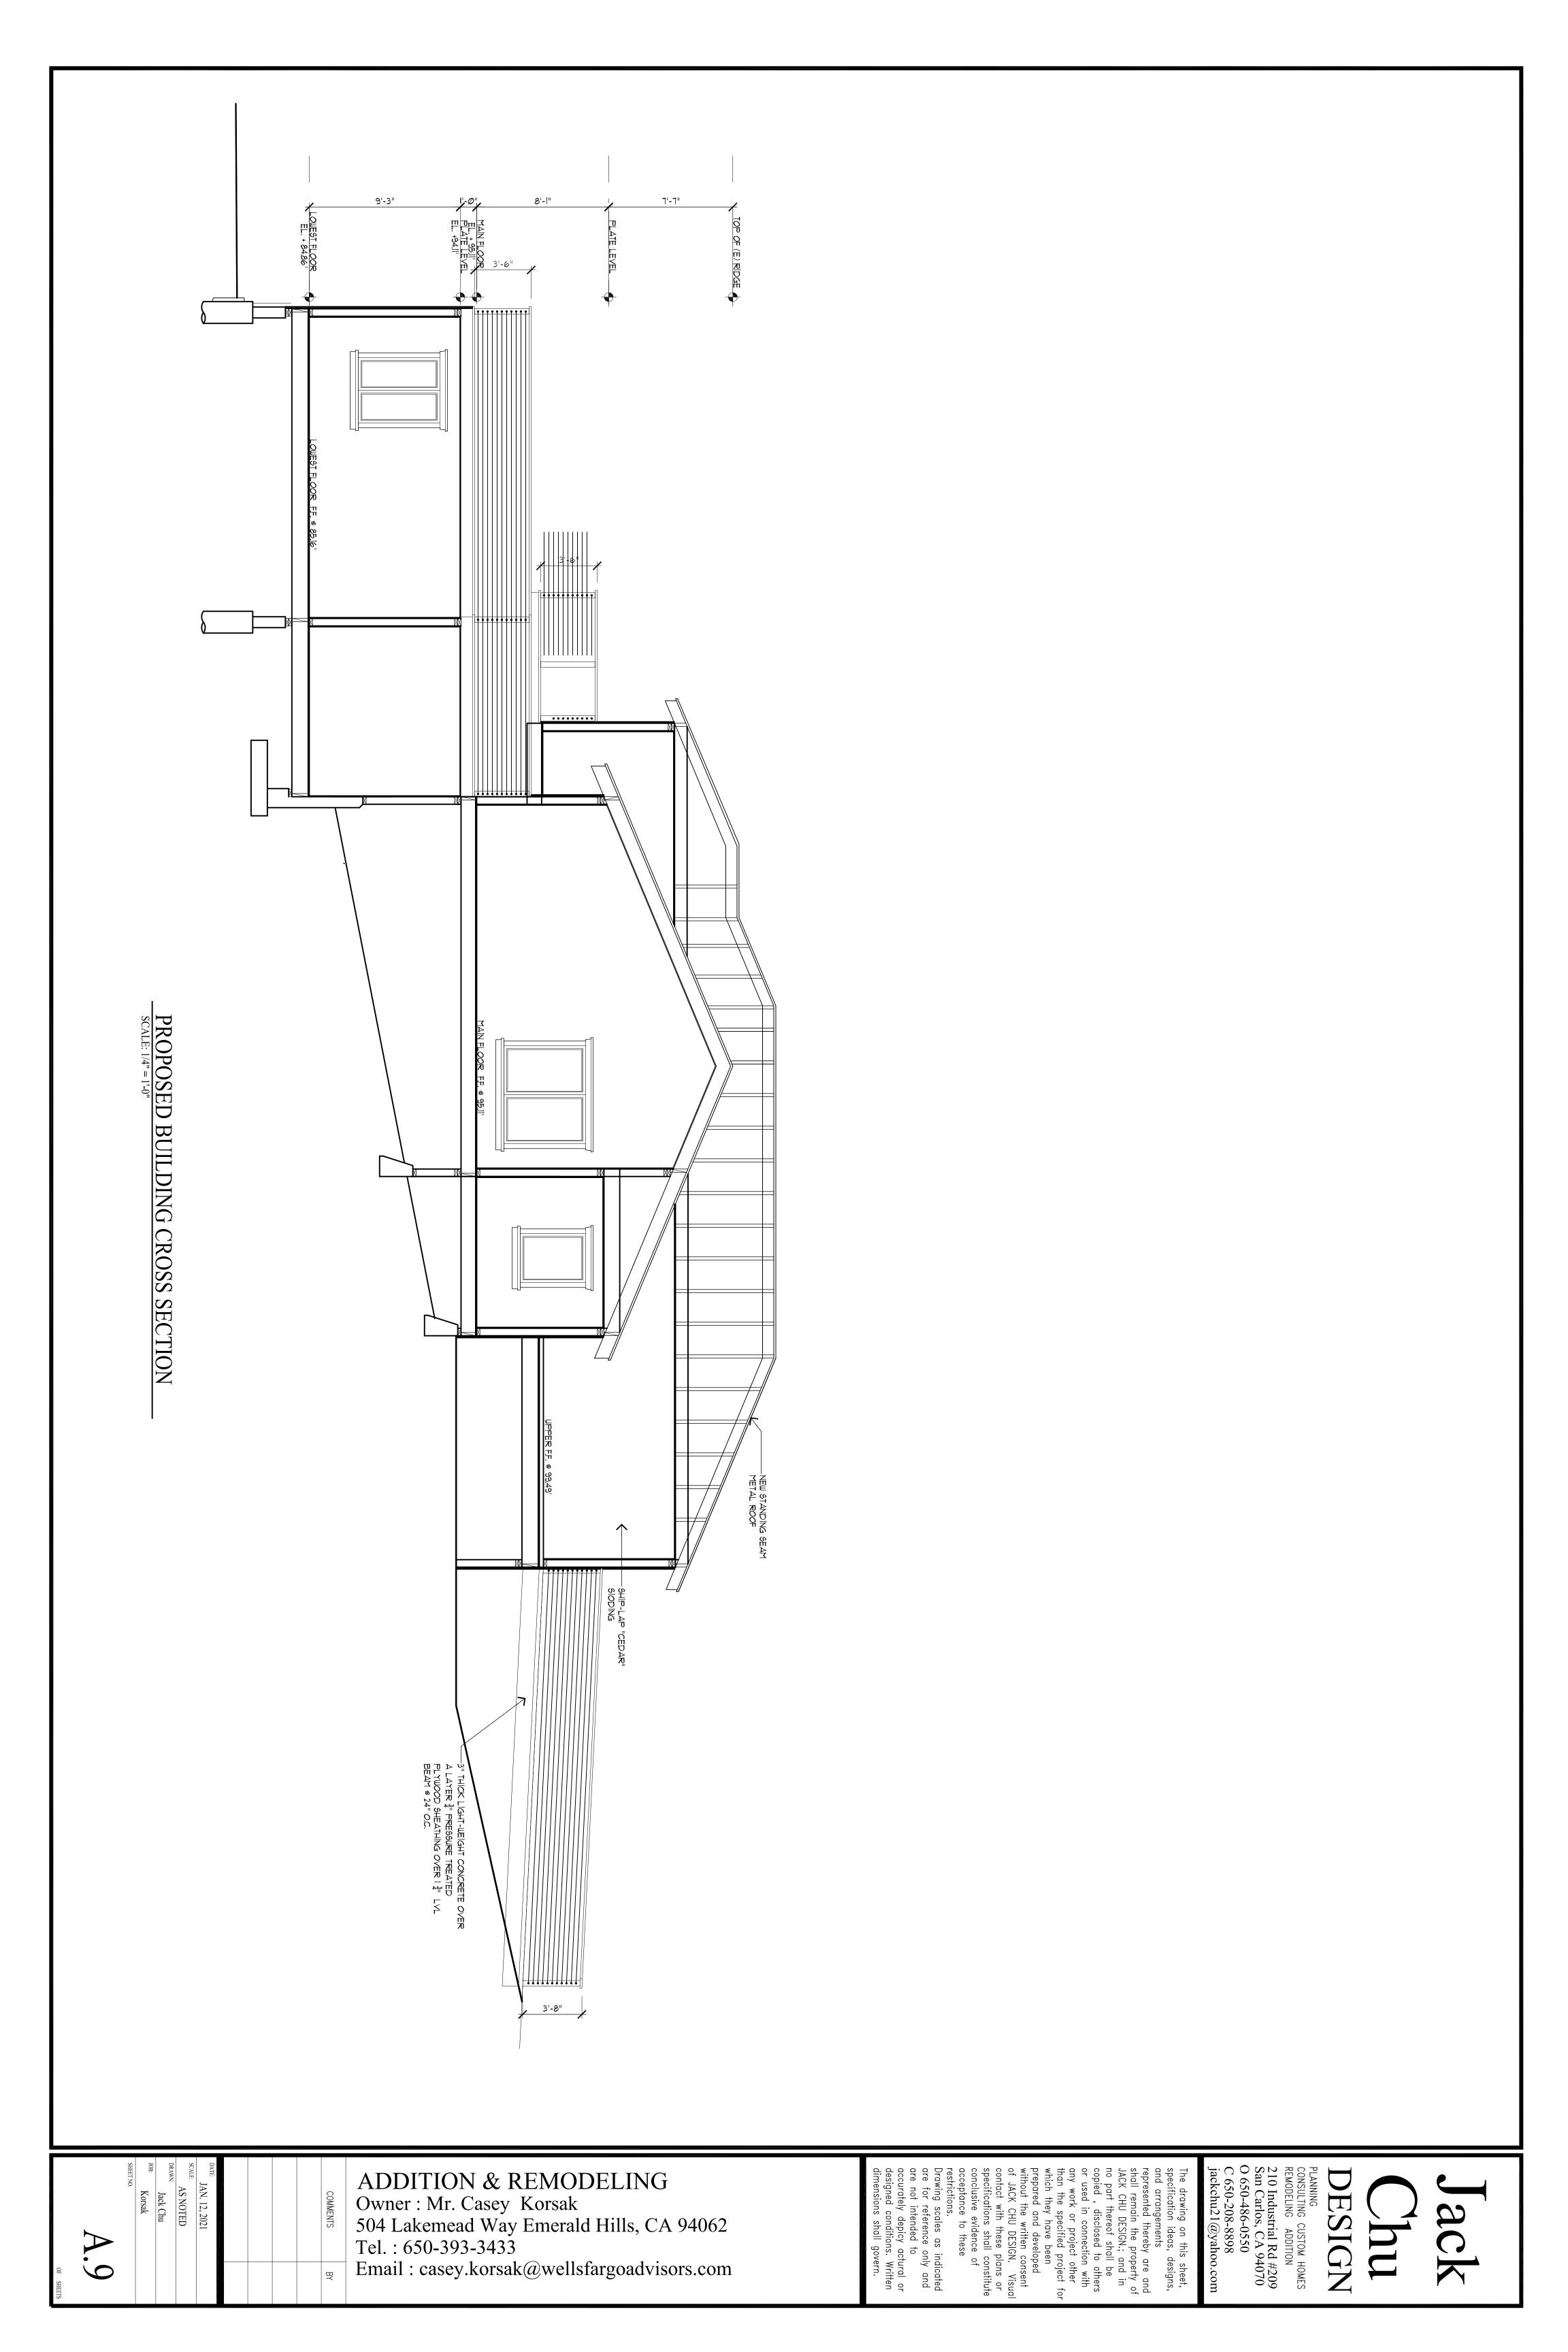

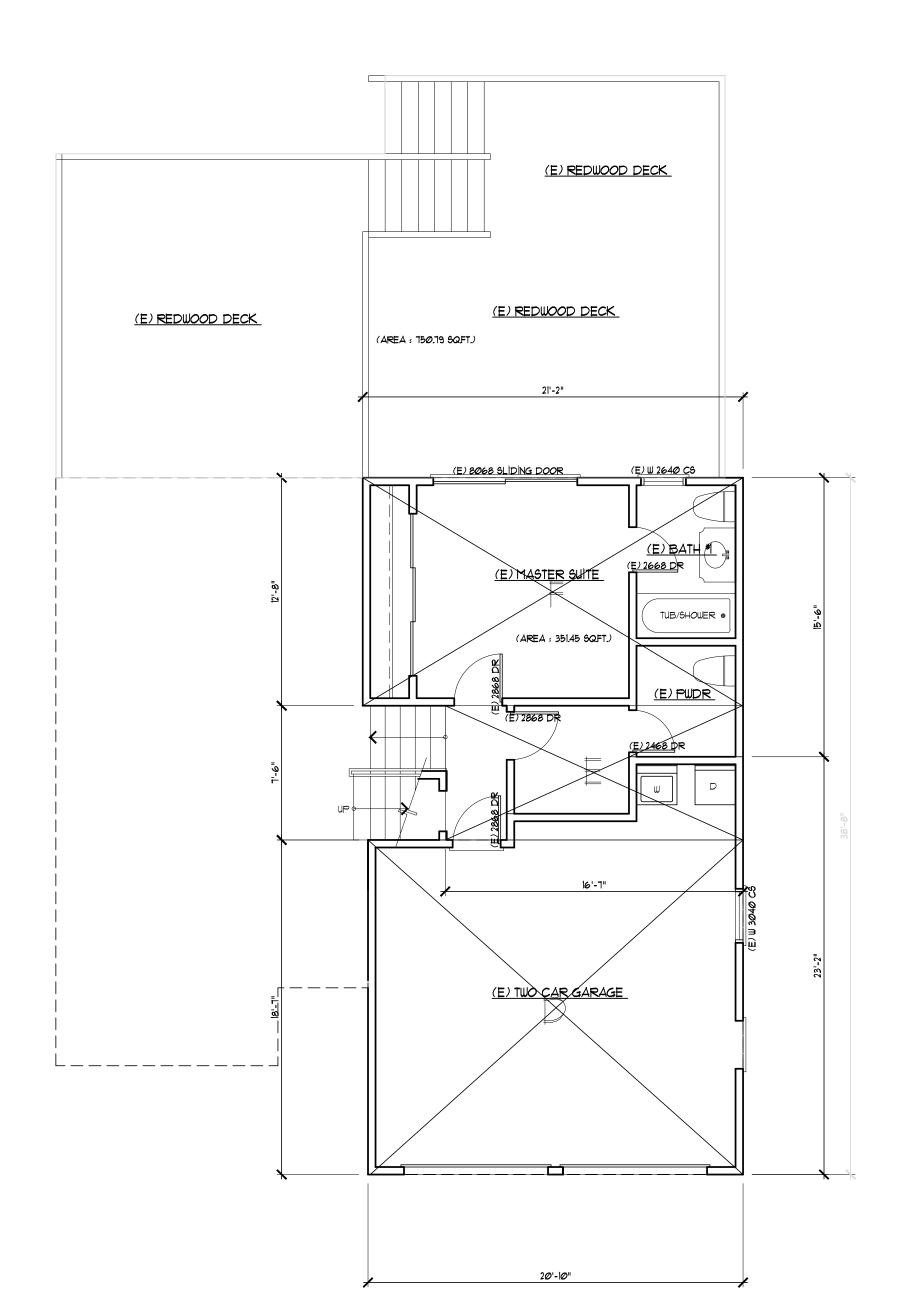

EXISTING LOWER FLOOR PLAN


SCALE: 3/16" = 1'-0"

LOWER FLOOR AREA

20'-10" × 18'-7" = 387.15 SF $16' = 7'' \times 7' = 6'' = 123.37 \text{ SF}$

 $21'-2'' \times 12'-8'' = 267.58 \text{ SF}$

TOTAL FLOOR AREA: 778.10 SF

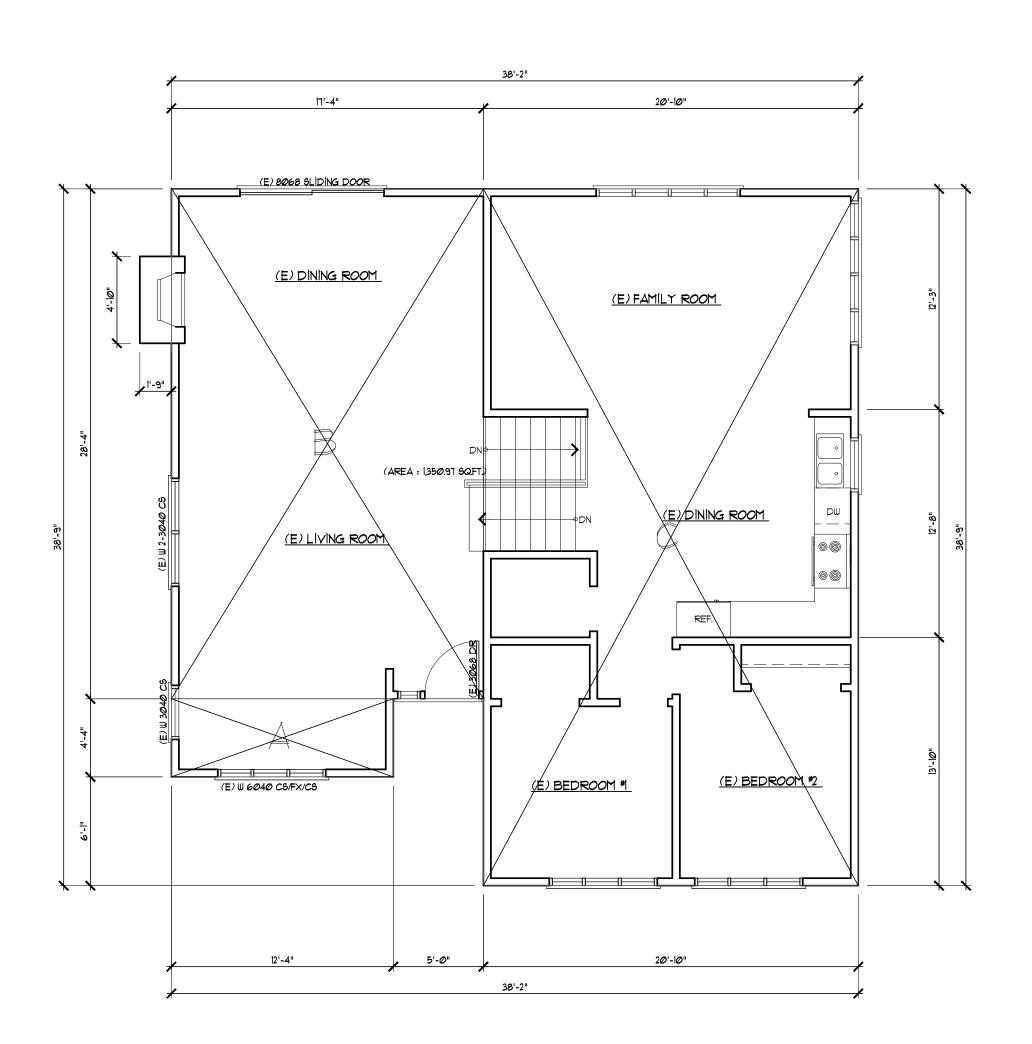

MAIN & UPPER FLOOR AREA

12 - 4 11 × 4 - 4 11 53.44 SF 491.11 SF 17 = 4 | X 28 = 4 | = 20'=10" × 38'=9" = 807.16 SF

FIREPLACE 1'-9" x 4'-10"

TOTAL FLOOR AREA: 1,359.63 SF





DESIGN

CONSULTING CUSTOM HOMES REMODELING ADDITION 55 West 43rd Ave San Mateo, CA 94403 C 650-208-8898 F 650-345-9287 jackchu21@yahoo.com

The drawing on this sheet, specification ideas, designs, and arrangements represented thereby are and shall remain the property of JACK CHU DESIGN.; and in no part thereof shall be copied , disclosed to others or used in connection with any work or project other than the specified project fo which they have been prepared and developed without the written consent of JACK CHU DESIGN. Visuo contact with these plans or specifications shall constitute conclusive evidence of acceptance to these restrictions. Drawing scales as indicated are for reference only and are not intended to accurately depicy actural or designed conditions. Written dimensions shall govern.

COMMENTS

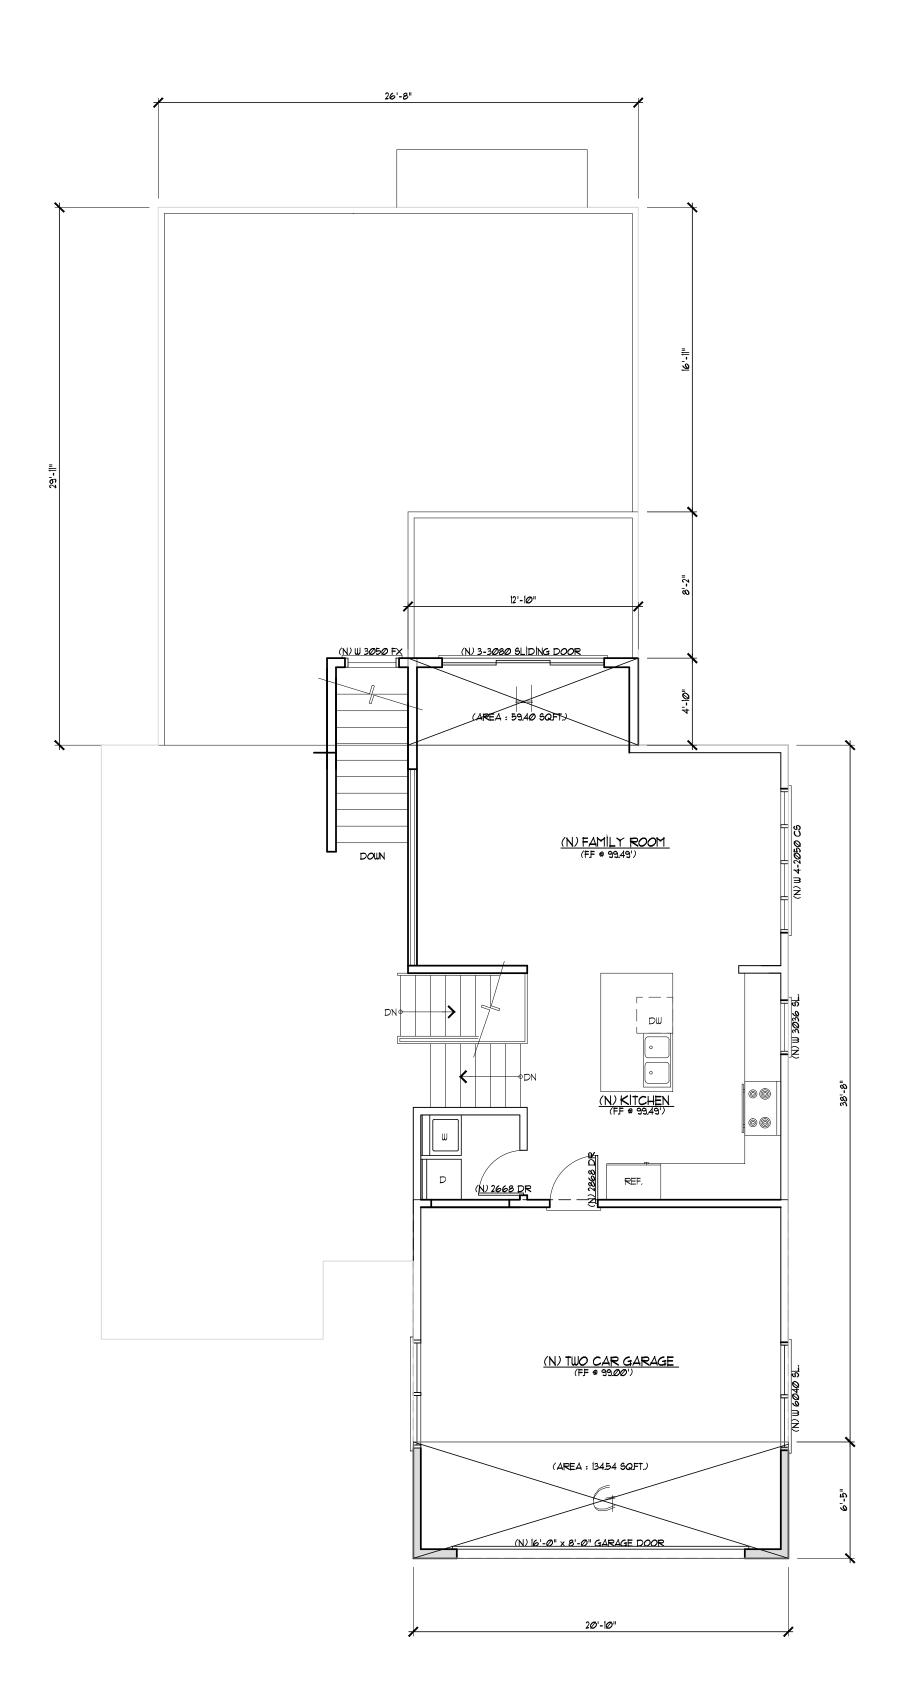

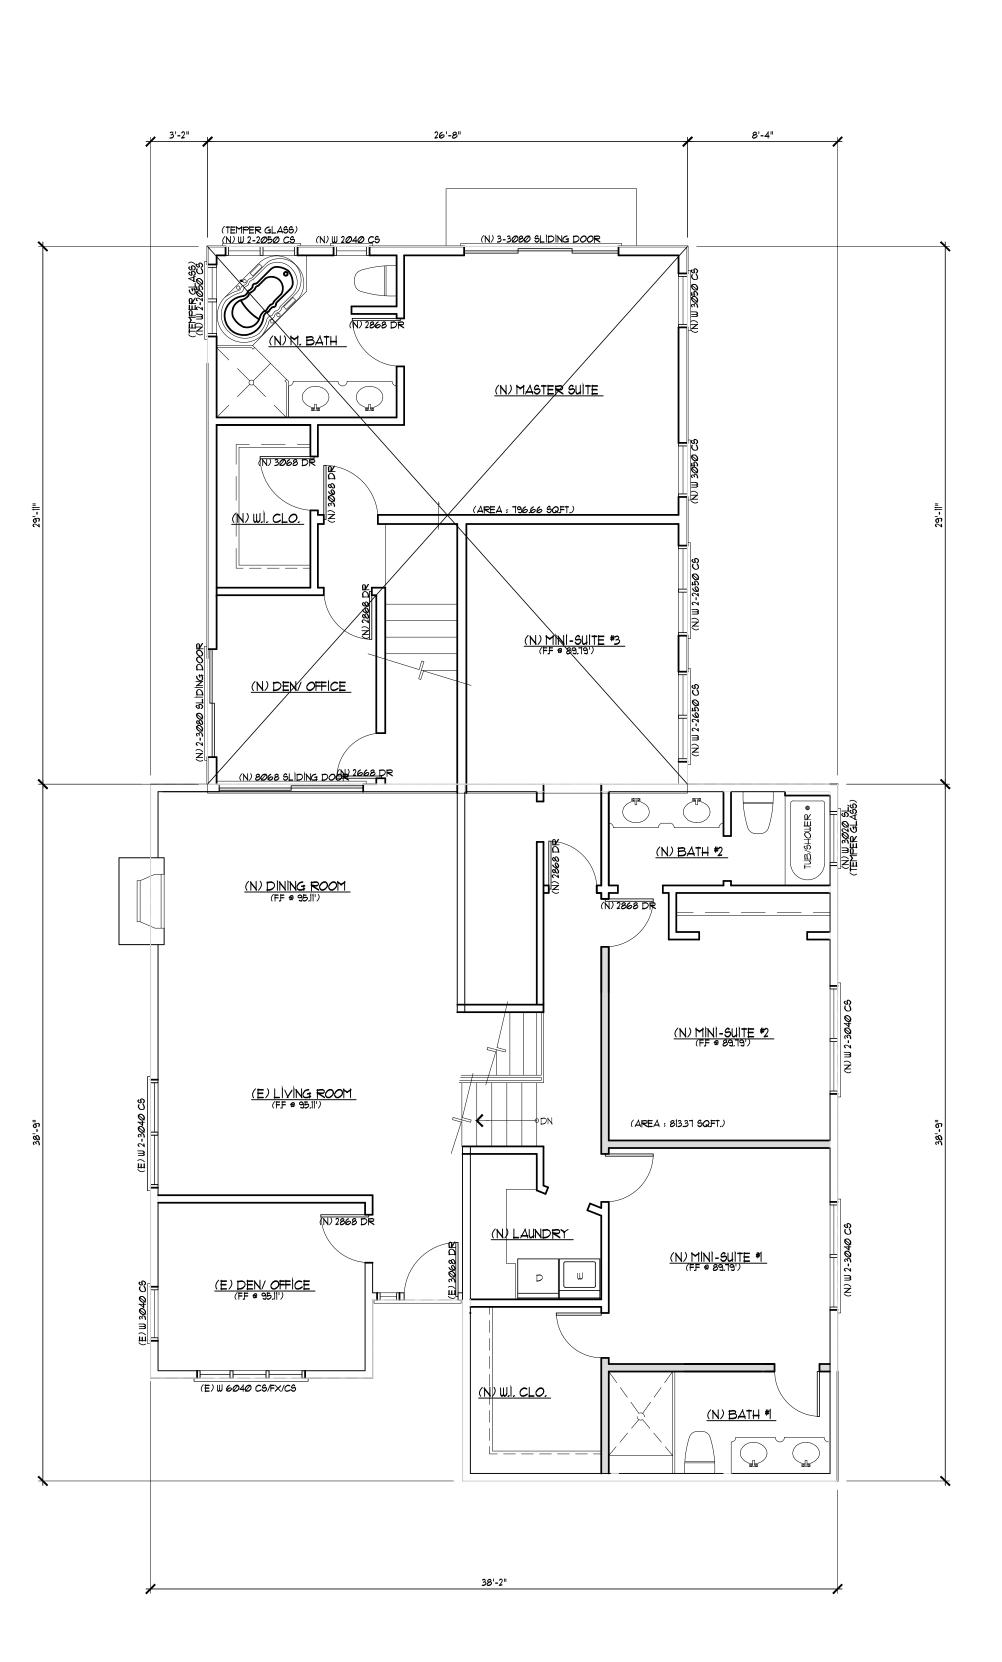

PROPOSED LOWER FLOOR AREA

TOTAL FLOOR AREA: 973.80 SF

PROPOSED LOWER FLOOR AREA

26'-8" x 29'-11" = 797.77 SF

TOTAL PROPOSED FLOOR AREA: 797.77 SF





Jack Chu DESIGN

PLANNING
CONSULTING CUSTOM HOMES
REMODELING ADDITION
55 West 43rd Ave
San Mateo, CA 94403
C 650-208-8898
F 650-345-9287
jackchu21@yahoo.com

The drawing on this sheet, specification ideas, designs, and arrangements represented thereby are and shall remain the property of JACK CHU DESIGN.; and in no part thereof shall be copied , disclosed to others or used in connection with any work or project other than the specified project for which they have been prepared and developed without the written consent of JACK CHU DESIGN. Visua contact with these plans or specifications shall constitute conclusive evidence of acceptance to these restrictions. Drawing scales as indicated are for reference only and are not intended to

accurately depicy actural or

designed conditions. Written dimensions shall govern.

DDITION & REMODELING
wner: Mr. Casey Korsak
4 Lakemead Way Emerald Hills, CA 94062
11: 650-393-3433

DATE:
JAN. 12, 2021
SCALE:

JAN. 12, 2021

SCALE:

AS NOTED


DRAWN:


Jack Chu

DRAWN:
Jack Chu
JOB:
Korsak

AC.2

.____

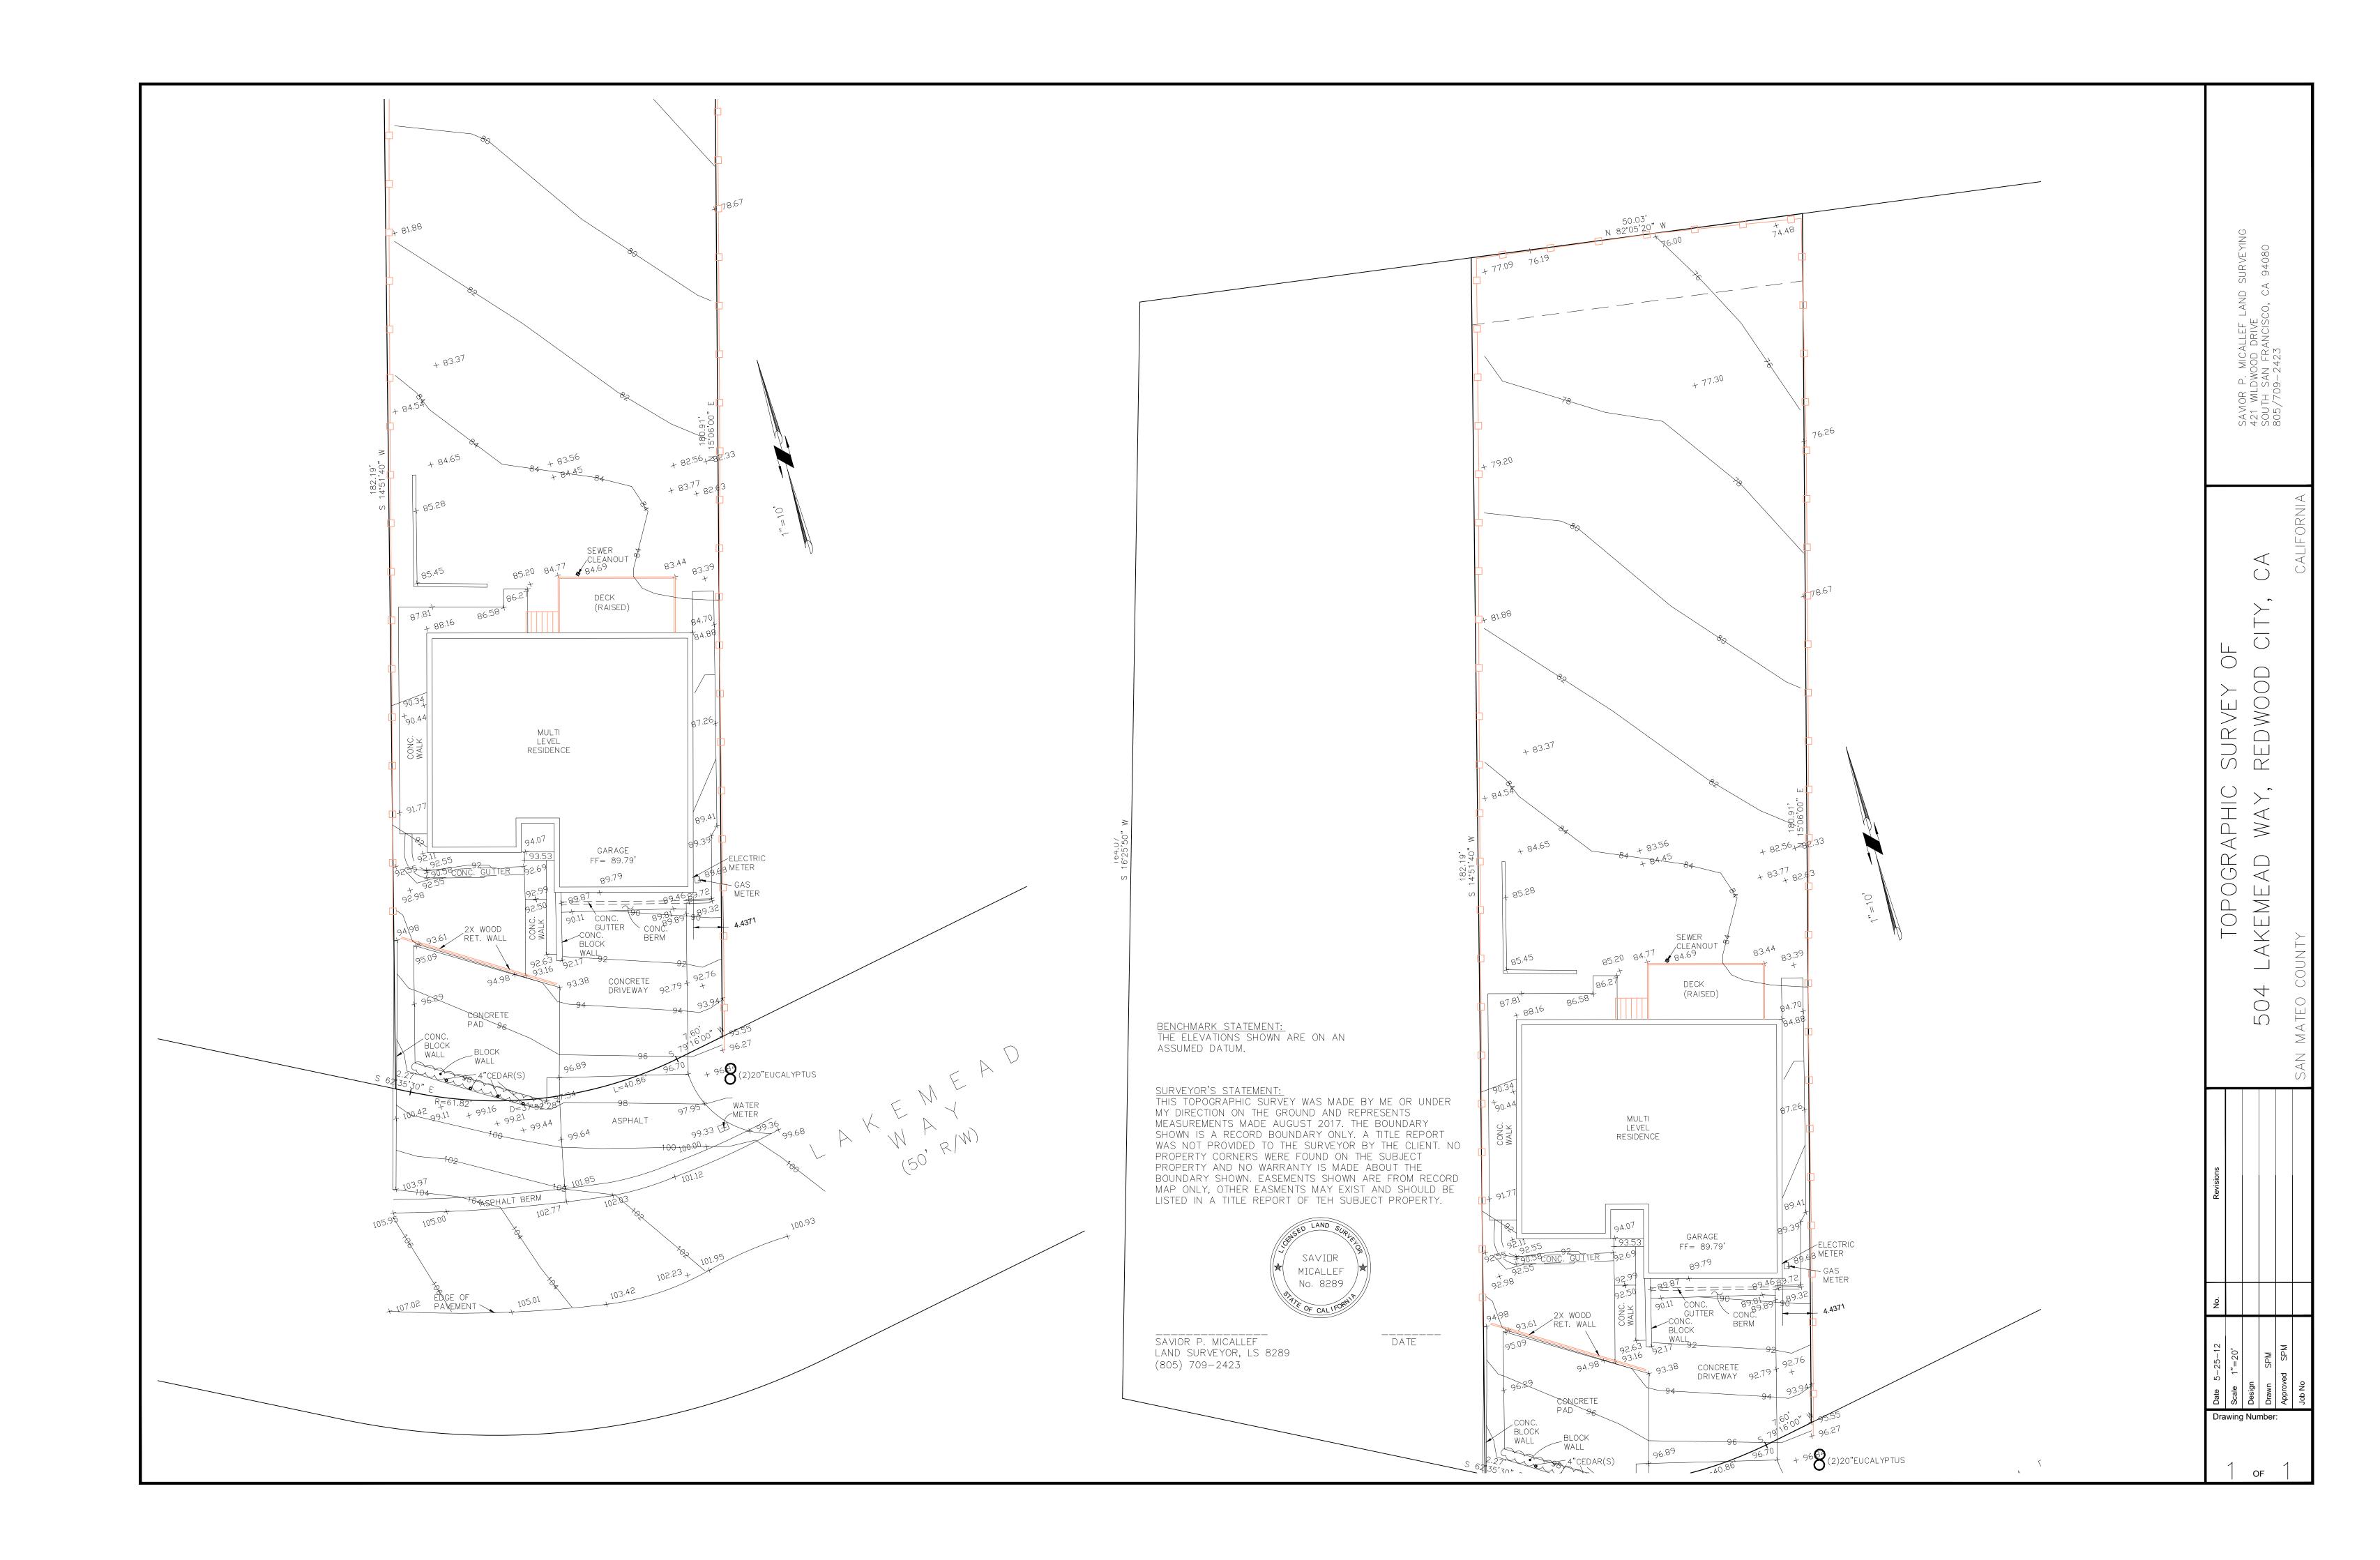

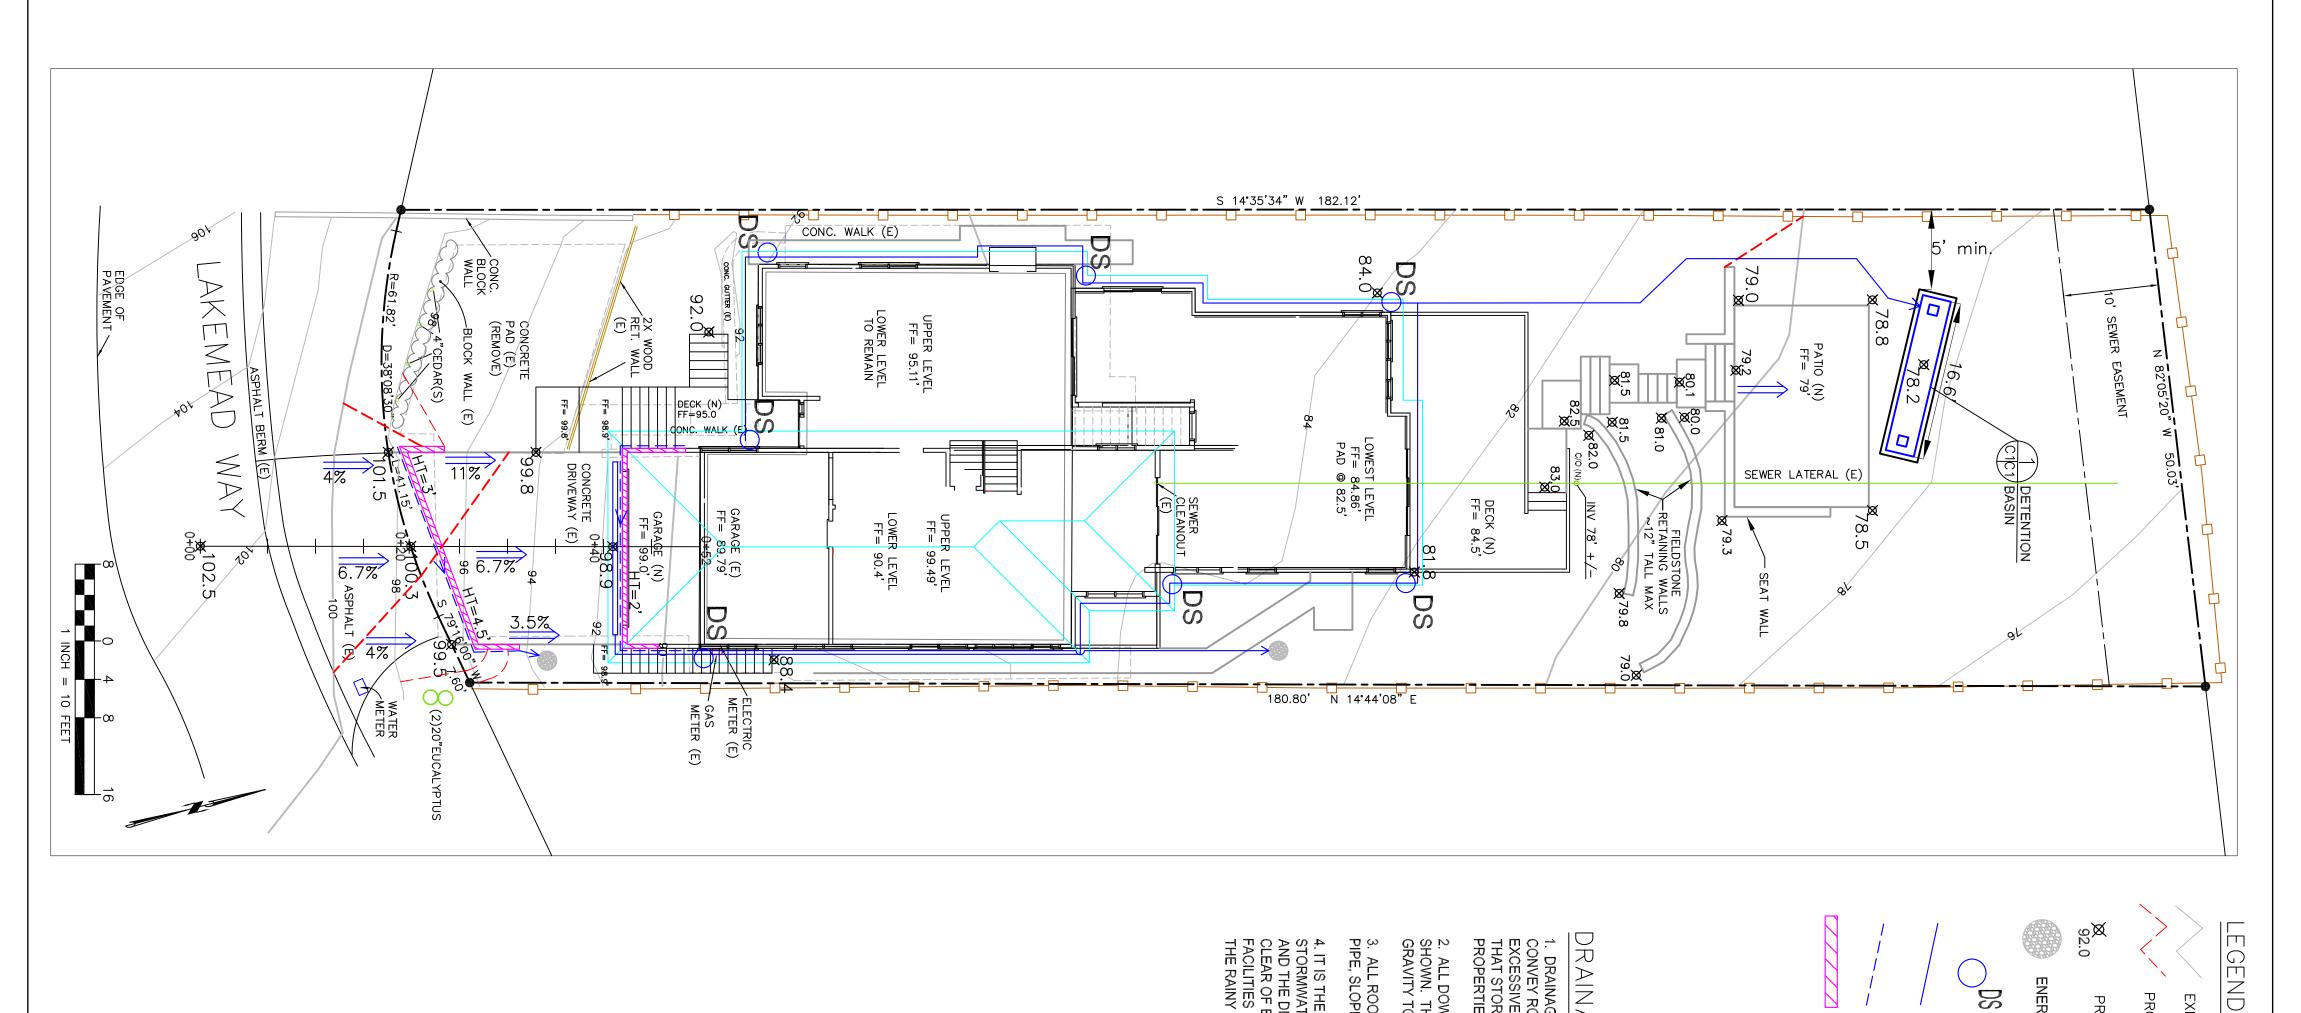

CLEAN—OUT ACCESS GRATE FOR ACCESS AND OVERFLOW RIM @ 78.2'

FINAL SLOPE

DRAINAGE NOTES

1. DRAINAGE INTENT: IT IS THE INTENT OF THE DRAINAGE SYSTEM TO CONVEY ROOF RUNOFF TO A SAFE LOCATION, AND TO MINIMIZE EXCESSIVE MOISTURE AROUND FOUNDATIONS. DIRECT SLOPES SUCH THAT STORMWATER WILL NOT BE DIVERTED ONTO ADJACENT PROPERTIES.

3. ALL ROOF DRAINAGE PIPES SHALL BE 4" DIAMETER MINIMUM SOLID PIPE, SLOPED AT 1% MINIMUM. 2. ALL DOWNSPOUT DRAIN LINES SHALL LEAD TO DETENTION BASIN, AS SHOWN. THE DETENTION BASIN SHALL BE WATER-TIGHT AND DRAIN BY GRAVITY TO AN ENERGY DISSIPATER, AS SHOWN.

4. IT IS THE PROPERTY OWNER'S RESPONSIBILITY TO CHECK ON ALL STORMWATER FACILITIES SUCH AS ROOF GUTTERS, DOWNSPOUT LINES, AND THE DETENTION BASIN/SUMP PUMP TO BE SURE THAT THEY ARE CLEAR OF EXCESSIVE DEBRIS AND OPERATING EFFICIENTLY. THE FACILITIES SHALL BE CHECKED EVERY FALL AND PERIODICALLY DURING THE RAINY SEASON.

GRADING NOTES

CUT VOLUME: 70 CY FILL VOLUME: 40 CY (30 CY IN R.O.W., FOR DRIVEWAY) VOLUMES ABOVE ARE APPROXIMATE.

THE SUBGRADE BELOW ALL PAVED AREAS SI COMPACTED TO 95%. HALL BE BASEROCK

ALL GRADING SHALL CONFORM TO LOCAL CODES AND ORDINANCES.

ALL TRENCHES UNDER PROPOSED PAVED AREAS OR CONCRETE SHALL BE BACKFILLED TO SUBGRADE ELEVATION WITH COMPACTED APPROVED GRANULAR MATERIALS. IF TRENCHES ARE IN PROPOSED LANDSCAPE AREAS, THEY SHALL BE BACKFILLED WITH COMPACTED APPROVED GRANULAR MATERIAL TO WITHIN ONE FOOT OF FINISHED GRADE, AND THEN FILLED WITH HAND TAMPED SOILS.

ENERGY DISSIPATER - PER DETAIL 2 4" SOLID DRAIN PIPE RETAINING WALL - PROPOSED 4" SOLID PERFORATED PIPE

PROPOSED CONTOUR PROPOSED SPOT ELEVATION

EXISTING CONTOUR


GENERAL

PROJECT SITE

Brookline Way

CASEY KORSAK, OWNER
2. TOPOGRAPHY BY S. MICALLEF, SURVEYED AUGUST 3, 2018.
2. TOPOGRAPHY BY S. MICALLEF, SURVEYED AUGUST 3, 2018.
3. THIS IS NOT A BOUNDARY SURVEY.
4. ELEVATION DATUM ASSUMED.
5. THE GEOTECHNICAL REPORT:
GEOTECHNICAL STUDY: KORSAK PROPERTY, 504 LAKEMEAD WAY, EMERALD HILLS, CALIFORNIA.
DATE: MAY 2, 2019. BY SIGMA PRIME INC., PROJECT NO. 18-198
SHALL BE RETAINED ON THE CONSTRUCTION SITE.
THE GEOTECHNICAL ENGINEER OF RECORD IS SIGMA PRIME GEOSCIENCES, INC., WITH THE CONTACT NUMBER (650)-728-3590 (SIGMAPRM@GMAIL.COM).
THE CONTRACTOR MUST SHALL NOTIFY THE GEOTECHNICAL ENGINEER OF RECORD AT LEAST 48 HOURS BEFORE CONSTRUCTION OF GEOTECHNICAL ENGINEER OF RECORD AT LEAST 48 HOURS BEFORE CONSTRUCTION OF GEOTECHNICAL RELATED WORK. THE GEOTECHNICAL PART OF CONSTRUCTION WORK.
INCLUDING BUT NOT LIMITED TO, ALL THE EARTHWORK AND FOUNDATION CONSTRUCTIONS, MUST SHALL BE APPROVED BY THE GEOTECHNICAL ENGINEER OF RECORD.
6. STORMWATER MANAGEMENT CONSTRUCTION INSPECTIONS, WHICH INCLUDE SITE CLEARANCE AND EROSION CONTROL MEASURES INSTALLATION AS WELL AS INSPECTION OF MAJOR DRAINAGE INSPECTIONS, WHICH INCLUDE SITE CLEARANCE AND EROSION CONTROL MEASURES INSTALLATION AS WELL AS INSPECTION CARD INSTRUCTIONS AND PHONE NUMBER (650-306-3405 EXT 181) TO SCHEDULE COUNTY DRAINAGE INSPECTIONS ACCORDINGLY. THERE SHALL BE THREE INSPECTIONS: ONE FOR EROSION CONTROL INSTALLATION, ONE BEFORE DRAINAGE FACILITIES ARE BURIED, AND ONE FOR FINAL WALK AROUND.

VICINITY MAP NOT TO SCALE

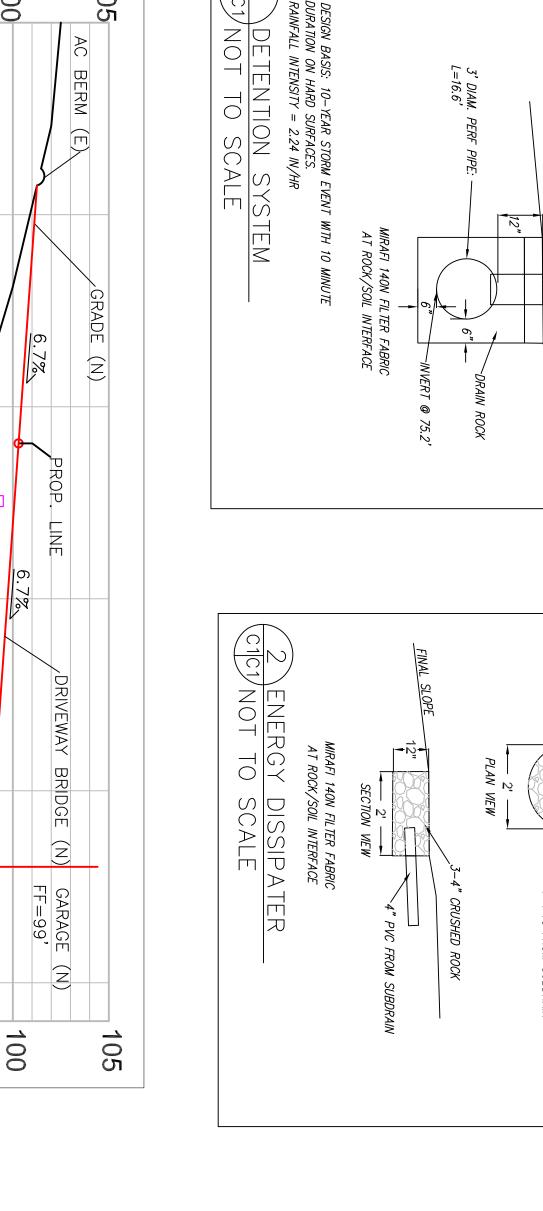

1 DETENTION C1C1 NOT TO SC

SCALE

SYSTEM

100

95

90

DRIVEWAY SURFACE (E)

RETAINING WALL (N)

BATH ROOM (N)

95

RE-GRADE TO DIRECT

GARAGE (E)

90

0+52

85

0+00

DRIVEWAY PROFILE


1"=5'

105


AC BERM (E)


SH	GRADING AND DRAINAGE PLAN
	KORSAK PROPERTY 504 LAKEMEAD WAY

DATE: 5-3-19 DRAWN BY: CMK	Sigma Prime Geosciences, Inc
CHECKED BY: AZG	SIGMA PRIME GEOSCIENCES, INC.
REV. DATE: 4-22-21	332 PRINCETON AVENUE
REV. DATE:	HALF MOON BAY, CA 94019 (650) 728-3590 FAX 728-3593
REV. DATE:	1700720-0000
	DRAWN BY: CMK CHECKED BY: AZG REV. DATE: 4-22-21 REV. DATE:

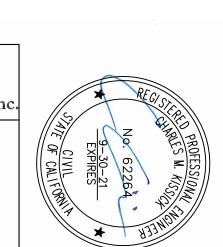



4" CRUSHED ROCK

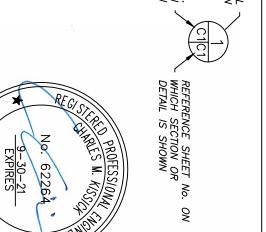

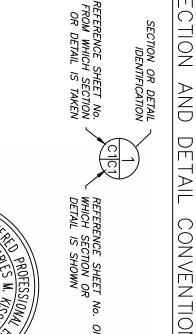

SECTION AND DETAIL SECTION OR DETAIL IDENTIFICATION CONVENTION

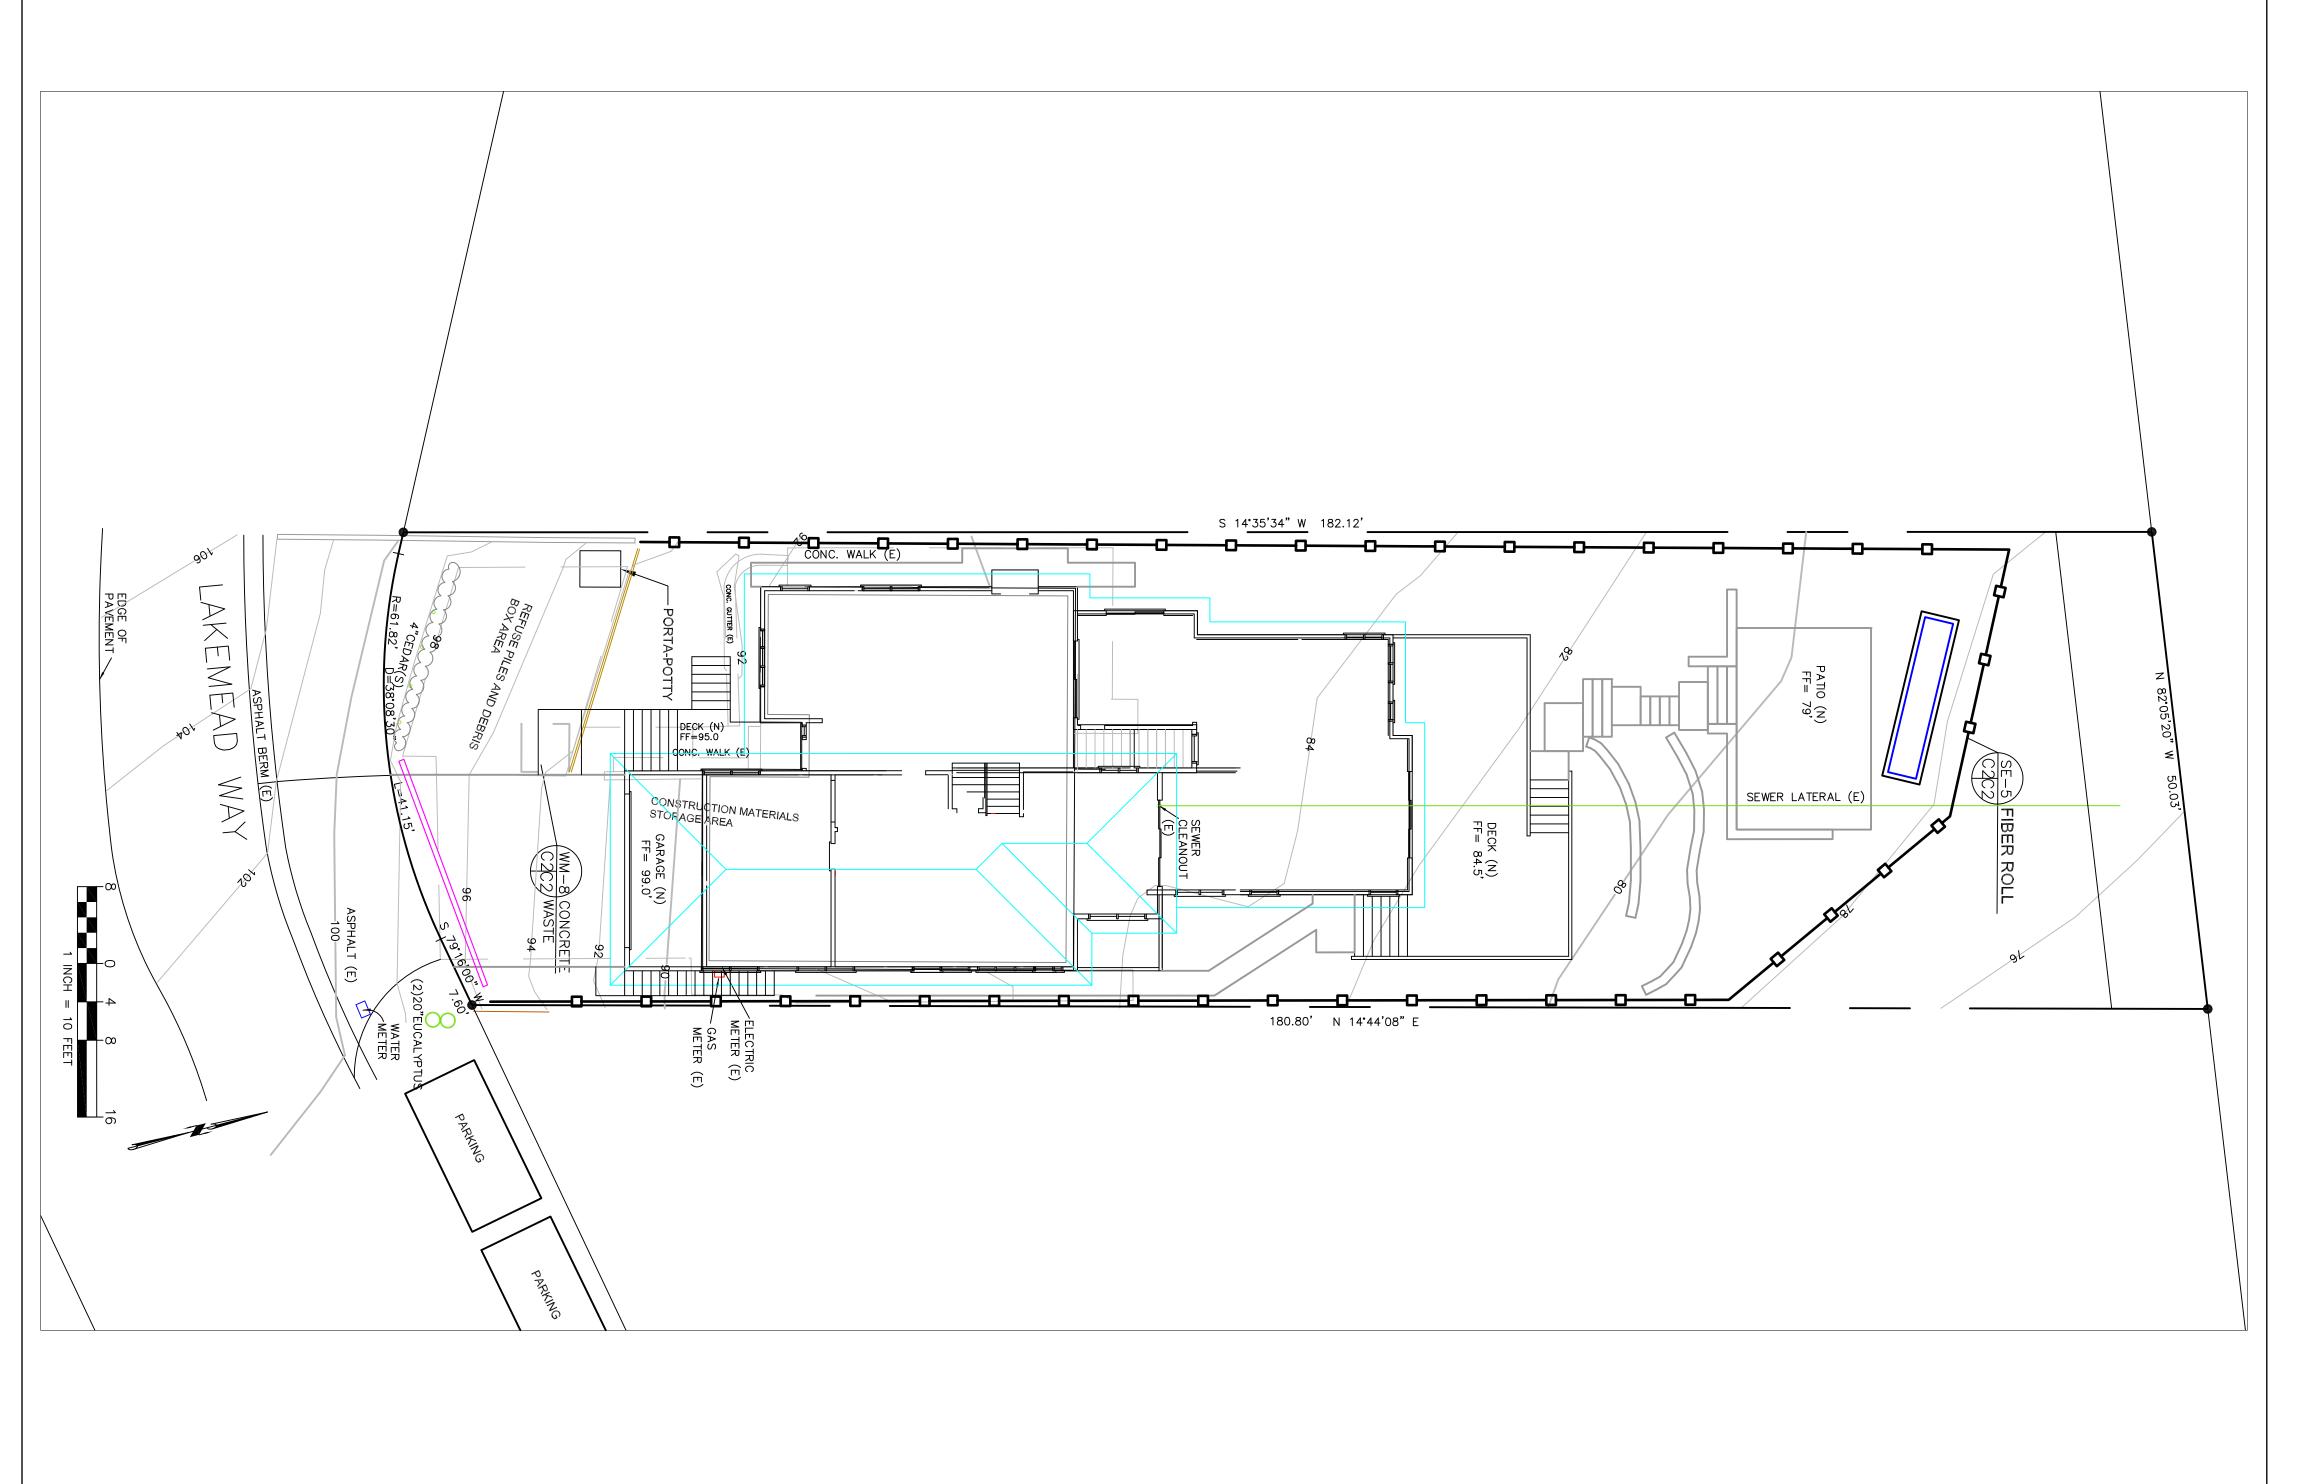

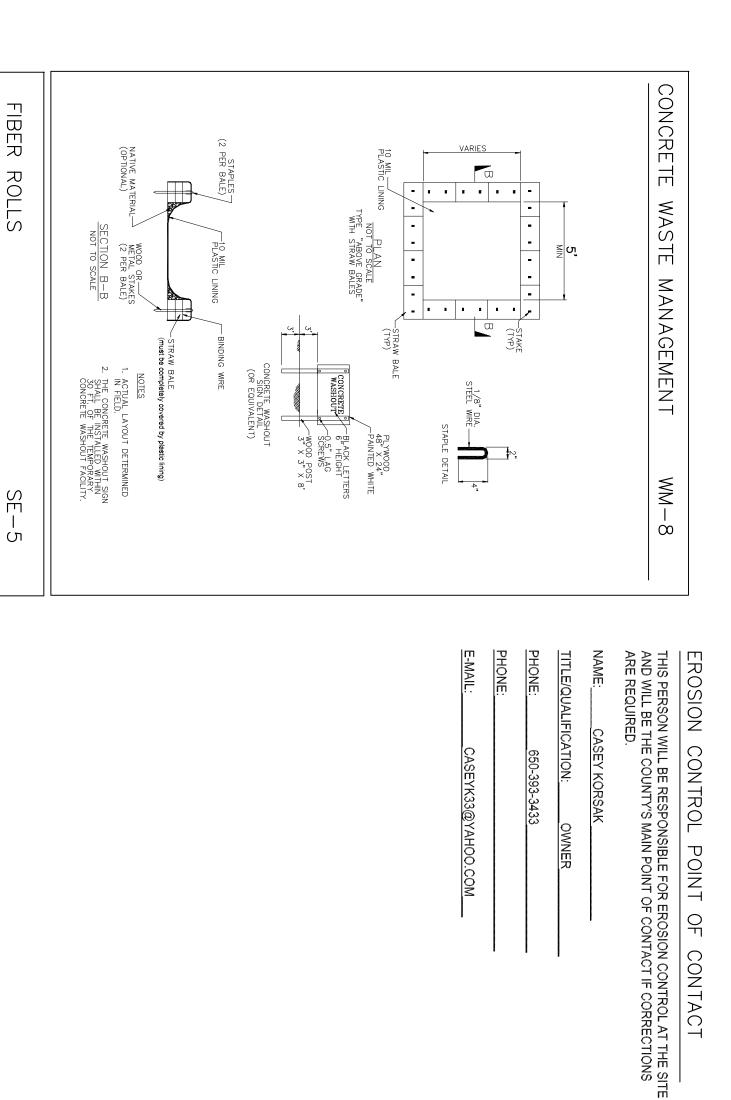

650-393-3433

PROFESSION, AISC

4. ALL STOCKPILED SOIL SHALL BE COVERED AT ALL TIMES AND REMOVED FROM SITE AS SOON AS POSSIBLE, IF SCHEDULED FOR OFF-HAUL. 5. ALL EXPOSED SURFACES SHALL BE PERMANENTLY PROTECTED FROM EROSION WITH SEEDING AND/OR LANDSCAPING. SEED MIX SHALL BE 75 LB PER ACRE ANNUAL RYGRASS OR APPROVED SUBSTITUTE. SEED SHALL BE COVERED WITH STRAW MULCH AT A RATE OF 2 TONS/ACRE. 6. THERE IS NO ROOM FOR A ROCKED CONSTRUCTION ENTRANCE. THE STEEP NATURE OF THE FRONT OF THE PROPERTY WILL PRECLUDE VEHICULAR TRAFFIC ENTERING AND LEAVNG THE SITE, EXCEPT FOR THE EXCAVATOR DOING THE FOUNDATION WORK, WHICH WILL LEAVE THE SITE ONE TIME, AFTER EARTHWORK IS COMPLETED. 7. CONCRETE WASHOUT AREA SHALL BE SURROUNDED BY A SINGLE LAYER OF SAND BAGS TO CONTAIN FLUIDS. CHANNEL INTO AREA SHALL BE CLEARED TO ALLOW TIRE DEBRIS (SEE NOTE 6.D. ABOVE) I. GRADING MAY TAKE PLACE DURING WET WEATHER AFTER OCTOBER 1 PROVIDED THE FOLLOWING PROVISIONS ARE FOLLOWED. 2. NO GRADING SHALL TAKE PLACE DURING RAINY WEATHER OR FOR A PERIOD OF AT LEAST 24 HOURS FOLLOWING RAIN. 3. ALL EXPOSED SOIL SHALL BE TEMPORARILY PROTECTED FROM EROSION WITH JUTE VIETTING. 4. ALL STOCKPILED SOIL SHALL BE COVERED AT ALL TIMES AND REMOVED FROM SITE AS SOON AS POSSIBLE, IF SCHEDULED FOR OFF-HAI!! FIBER ROLE INSTALL AT LOCATIONS SHOWN. AFIX AS SHOWN IN DETAIL SE-5 Dust control is required year-round. Placement of erosion materials is required on weekends and during rain events. Avoid tracking dirt or other materials off-site; clean off-site paved areas and sidewalks Erosion control materials shall be stored on-site enlarged or "run over. The areas delineated on the plans for parking, grubbing, storage etc., shall not be Train and provide instruction to all employees and subcontractors regarding the Watershed Limit construction access routes to stabilized, designated access points Limit and time applications of pesticides and fertilizers to prevent polluted runoff. Avoid cleaning, fueling, or maintaining vehicles on-site, except in a designated area activities and construction. using dry sweeping methods. and non-stormwater discharges to storm drains and watercourses. where wash water is contained and treated. October 1 and April 30. Protection Maintenance Standards and construction Best Management Practices.

EROSION AND SEDIMENT CONTROL

NOTES

<u>GENERAL</u>

EROSION CONTROL

NOTES

- Erosion control materials to be on-site during off-season. Perform clearing and earth-moving activities only during dry weather. Measures to ensure adequate erosion and sediment control shall be installed prior to earth-moving
- Stabilize all denuded areas and maintain erosion control measures continuously between
- Control and prevent the discharge of all potential pollutants, including pavement cutting wastes, paints, concrete, petroleum products, chemicals, wash water or sediments,
- Store, handle, and dispose of construction materials and wastes properly, so as to prevent their contact with stormwater.
 - Measures to ensure adequate erosion and sediment control are required year-round.

EROSION AND SEDIMENT CONTROL PLAN

fiber roll near nere it transitions steeper slope

KORSAK PROPERTY 504 LAKEMEAD WAY **EMERALD HILLS** APN 057-262-200

DATE: 5-3-19 DRAWN BY: CMK Sigma Prime Geosciences, Inc CHECKED BY: AZG SIGMA PRIME GEOSCIENCES, INC. 332 PRINCETON AVENUE HALF MOON BAY, CA 94019 (650) 728-3590 REV. DATE: 4-22-21 REV. DATE: FAX 728-3593



NOTES:

NOTES:

The fiber roll is placed in a row, the rolls must be overlapped, not abuse than one fiber roll up-slope to prevent runoff from going around the roll run the ends of the fiber roll up-slope to prevent runoff from going around the roll run the ends of the fiber roll up-slope to prevent runoff from going around the roll run the ends of the fiber roll up-slope to prevent runoff from going around the roll run the ends of the fiber roll up-slope to prevent runoff from going around the roll run the ends of the fiber roll up-slope to prevent runoff from going around the roll run the ends of the fiber roll up-slope to prevent runoff from going around the roll run the ends of the fiber roll up-slope to prevent runoff from going around the roll run the ends of the fiber roll up-slope to prevent runoff from going around the roll run the ends of the fiber roll up-slope to prevent runoff from going around the roll run the ends of the fiber roll up-slope to prevent run the ends of the fiber roll up-slope to prevent run the ends of the fiber roll up-slope to prevent run the ends of the fiber roll up-slope to prevent run the ends of the fiber roll up-slope to prevent run the ends of the fiber roll up-slope to prevent run the ends of th

REV. DATE: