COUNTY OF SAN MATEO PLANNING AND BUILDING

County Government Center 455 County Center, 2nd Floor Redwood City, CA 94063 650-363-4161 T 650-363-4849 F www.planning.smcgov.org

July 9, 2019

Jordan McWherter 759 Rockaway Beach Avenue Pacifica, CA 94044

Dear Mr. McWherter:

SUBJECT: Coastside Design Review Continuance

1237 Grant Road, Montara

APN 036-225-130; County File No. PLN 2018-00322

At its meeting of June 13, 2019, the San Mateo County Coastside Design Review Committee (CDRC) considered your application of a Design Review recommendation to allow construction of a new two-story, 4,000 sq. ft. residence, plus a 437 sq. ft. garage, located on a legal 4.77-acre parcel (legality confirmed via subdivision, SMJ 80-6) associated with a staff-level Coastal Development Permit, Resource Management Permit, and Grading Permit. The project involves 920 cubic yards of cut and 75 cubic yards of fill and the removal of nine significant trees.

The CDRC was unable to make the findings for a design review recommendation of approval based on certain design deficiencies. In order to resolve these deficiencies in the project's design, a more thorough review of the Local Coastal Program and "Standards for Design for One-Family and Two-Family Residential Development in the Midcoast" manual is required. As such, requirements from the CDRC for further project redesign are as follows:

- 1. From the "Standards for Design for One-Family and Two-Family Residential Development in the Midcoast" Manual
 - a. Section 6565.20(C). 1. Relationship to Exiting Topography. Standards (d) and (e): To address articulation:
 - 1. The roofline at both the front and rear perspectives should be differentiated at the entry/study/stair section.
 - 2. The entry should be recessed.
 - 3. The lower level workshop should be pulled back and cantilevered.
- Recommendations Discussed Include:
 - a. Call out materials on the elevations on Sheets A3.1 and A3.2.



- b. Roofing shall be standing seam metal in a Vermont Slate color to match the fascia color (Benjamin Moore BM2127-30 Gravel Gray). The finish shall be as flat as possible to minimize reflection.
- c. Exterior Lighting shall be a Dark Sky-compliant version of the sample provided (Sunset Lighting F6907.31).
- d. The deck posts and cap shall be powder-coated in a galvanized steel gray color.
- e. The garage door shall be lux black aluminum and white laminate glass.
- f. The deck materials shall be in a galvanized steel mesh pattern.
- g. Eliminate the two center exterior light fixtures between the two sliding doors, such that there is only one on the front elevation (Sheet A3.1) and one on the rear elevation (Sheet A3.2).
- h. Consider expanding the galvanized steel rail finish to tie into to other finishes, such as with the finish of the exterior lighting fixture.

As such, you were presented with the following available options at the end of the CDRC's deliberation of the project: (1) request for a decision from the CDRC on the plans presented or (2) request that the project be considered at the next meeting to provide you with ample time to consider and incorporate the elements recommended for project redesign. You chose the second option, and the CDRC directed staff to schedule your project for consideration at a later date.

Please contact Ruemel Panglao, Project Planner, at 650/363-4825, if you have any questions.

To provide feedback, please visit the Department's Customer Survey at the following link: http://planning.smcgov.org/survey.

Sincerely

Dennis P. Aguirre

Design Review Officer

DPA:RP - RSPDD0341 WPN.DOCX

cc: Bruce Chan, Member Landscape Architect
Kayleen Kostuik, Member Architect
Beverly Garrity, Montara Community Representative
Kathryn Carter, Interested Member of the Public

NEW SINGLE FAMILY HOME 1237 GRANT ROAD, MONTARA, CA

PLN2018-00322

RECEIVED

JUN 21 2019

San Mateo County Planning Division

A D D D D C \ / I \ A T I \ O N C

	ABBR	EVIAT	IONS
@ #	AT NUMBER	N (N)	NORTH NEW
AB A/C AFF APPROX ASF AS	ANCHOR BOLT AIR CONDITIONER ABOVE FINISHED FLOOR APPROXIMATE ABOVE SUBFLOOR ABOVE SLAB	N/A NA NIC NOM NR NSF NTS	NOT APPLICABLE NOT AVAILABLE NOT IN CONTRACT NOMINAL NON-RATED NET SQUARE FEET NOT TO SCALE
BLDG BLK BLKG BM BOT	BUILDING BLOCK BLOCKING BEAM BOTTOM	O OA OC OD	OVEN OVERALL ON CENTER OUTSIDE DIAMETER OR OVERFLOW DRAIN
CAB CB CLG CLST CMU CO COL CONC CONT	CABINET CATCH BASIN CENTERLINE CEILING CLOSET CONCRETE MASONRY UNIT CLEAN OUT COLUMN CONCRETE CONCRETE	OFF OPNG OH O/H OPP PL PLYWD PR PT	OFFICE OPENING OVERHANG OVERHEAD OPPOSITE PLATE OR PROPERTY LINE PLYWOOD PAIR POINT OR PRESSURE TREATED
D DBL DEPT DEG DIA DIM DN DR DS DW DWG	DRYER DOUBLE DEPARTMENT DEGREES DIAMETER DIMENSION DOWN DOOR DOWNSPOUT DISHWASHER DRAWING	R RAG RD REF REINF REQ'D REV RHB RM RO ROW	REQUIRED REVISION RADIANT HEATING BOILER ROOM
(E) EA ELEC ELEV ENG	EXISTING EACH ELECTRICAL ELEVATION ENGINEER EQUIPMENT	S SB SCHED SD SF SH SHT SHWR	SMOKE DETECTOR/STORM DRAIN SQUARE FEET OR SQUARE FOOT SHOWER HEAD SHEET
	FORCED AIR UNIT FLOOR AREA RATIO FLOOR DRAIN FINISHED FLOOR FINISH FLOOR FLUORESCENT FOUNDATION FIREPLACE FOOT OR FEET FOOTING FURNACE	SHTG SIM SL SPEC SQ SS STL STOR STRUCT SUB SUBFLR SW SYM	SHEATHING SIMILAR SLIDING SPECIFICATION SQUARE SANITARY SEWER STEEL STORAGE STRUCTURAL SUBCONTRACTOR SUBFLOOR
G GA GALV GC GD GL GR GYP BD	GAS GAUGE GALVANIZED GENERAL CONTRACTOR GARBAGE DISPOSAL GLASS GRADE GYPSUM BOARD	T & G TBD TEL THK TO	TILE, TREAD, TOP, OR TRANSFORMER TONGUE AND GROOVE TO BE DETERMINED TELEPHONE THICK TOP OF
HC HDR HDWD HT HORIZ HR	HANDICAP HEADER HARDWOOD HEIGHT HORIZONTAL HOUR	TOC TOP TOS TOW TP TV TYP	TOP OF CURB TOP OF PLATE TOP OF SUBFLOOR TOP OF WALL TOP OF PAVEMENT TELEVISION TYPICAL
INSUL INT	INSULATION INTERIOR	UNO VERT	UNLESS NOTED OTHERWISE VERTICAL
JT LINEN LAM LAV LT	JOINT OR JOINT TRENCH LINEN CLOSET LAMINATE LAVATORY LIGHT	W W/ WC WD WH	WEST, WASHER, OR WATER WITH WATER CLOSET WOOD WATER HEATER
MAX MECH MFR MH MIN MISC MLDG	MAXIMUM MECHANICAL MANUFACTURER MANHOLE MINIMUM MISCELLANEOUS MOULDING	W x H WNDW W/O WP WR WT	WIDTH BY HEIGHT WINDOW WITHOUT WATERPROOF WATER RESISTANT WEIGHT

MLDG

MTL

MOULDING

MOUNTED

METAL

PROJECT SCOPE

NEW TWO-STORY, SINGLE-FAMILY HOME WITH 2-CAR ATTACHED GARAGE.

PLANNING DATA

PROJECT COMMON ADDRESS: 1237 GRANT RD MONTARA, CA 94037 ASSESSOR'S PARCEL NUMBER: 036-225-130

RM-CZ/DR/CD

AND 2016 CGBC

BUILDING CODE DATA

TYPE OF OCCUPANCY: CONSTRUCTION TYPE: BEARING AND NON-BEARING WALLS (LESS THAN 5' FROM PROPERTY LINE): OPENINGS NOT PERMITTED LESS THAN 3' FROM PROPERTY LINE NUMBER OF STORIES: ALL WORK TO CONFORM TO 2016 CRC, CBC, CFC,

CPC, CMC, CEC, 2016 CALIFORNIA ENERGY CODE,

SYMBOLS

SECTION CUT, DETAIL NUMBER - SHEET ON WHICH IT OCCURS

DETAIL NUMBER - SHEET ON WHICH IT OCCURS

REVISION CLOUD

REVISION NUMBER

DOWNSLOPE INDICATION

GRIDLINE IDENTIFICATION

SHOWER HEAD

PROJECT DIRECTORY

SERVICE	COMPANY	CONTACT	TELEPHONE
APPLICANT / OWNER	*	JORDAN MCWHERTER	(650) 888-9588
CIVIL ENGINEER	ROUND HOUSE INDUSTRIES	MIKE O'CONNELL	(650) 303-0495
DRAFTING/DESIGN	-	JORDAN MCWHERTER	(650) 888-9588
SURVEYOR	SAVIOR P. MICALLEFF LAND SURVEYING	SAVIOR MICALLEF	(805) 709-2423
SOILS ENGINEER	EARTH INVESTIGATIONS	JOEL BALDWIN	(650) 557-0262
TITLE 24	ENERGY DESIGN GROUP	MILES HANCOCK	-

PROJECT NOTES

* FIRE SPRINKLERS ARE REQUIRED UNDER A SEPARATE PERMIT. THE FIRE SPRIKLER SYSTEM SHALL BE DESIGNED AND INSTALLED PER NFPA 13D STANDARDS.

PROJECT INFORMATION

LOT SIZE	4.7 ACRES (204,732 SF)
LEVEL 1 LIVING AREA	1,842 SF (CONDITIONED)
LEVEL 2 LIVING AREA	1,653 SF (CONDITIONED)
(N) TOTAL LIVING AREA	3,495 SF (CONDITIONED)
(N) GARAGE	433 SF (UN-CONDITIONED)
(N) COVERED CONC DECK	356 SF (UN-CONDITIONED)
(N) WORK SHOP	383 SF (UN-CONDITIONED)
(N) UNCOVERED CONC DECK	? SF (UN-CONDITIONED)
(E) BARN (TO REMAIN)	754 SF (UN-CONDITIONED)
(N) TOTAL FLOOR AREA	3,495+433+356+383+754=5,421 SF
FLOOR AREA RATIO	5,421 SF/204,732 SF = 2.65%

2,480 SF

3,271 SF

198,981 SF

NEW ALTERED LANDSCAPE

NEW HARDSCAPED AREAS

NEW TOTAL IMPERVIOUS

VEGETATION TO REMAIN

AREA OF NATURAL

SURFACES

DRAWING INDEX

A0.0 TITLE SHEET / PROJECT INFO

A0.1 EXTERIOR CAMERA VIEWS

EROSION AND SEDIMENT CONTROL PLAN

A1.2 PARTIAL SITE PLAN

S.S.P. SEPTIC SYSTEM PLAN

A2.4 FLOOR AREA CALCULATIONS

ARCHITECTURAL/CIVIL

A0.2 3D VIEWS

A0.3 3D CUTAWAY AND MATERIALS PERSPECTIVE

1 of 6 ORIGINAL TOPOGRAPHIC SURVEY SHEET 1

2 of 6 ORIGINAL TOPOGRAPHIC SURVEY SHEET 2

3 of 6 ORIGINAL TOPOGRAPHIC SURVEY SHEET 3

4 of 6 ORIGINAL TOPOGRAPHIC SURVEY SHEET 4 5 of 6 ORIGINAL TOPOGRAPHIC SURVEY SHEET 5

6 of 6 ORIGINAL TOPOGRAPHIC SURVEY SHEET 6 GRADING AND DRAINAGE PLAN

GRADING AND DRAINAGE, HOUSE SITE

OVERALL SITE PLAN

A1.3 TURNAROUND PLAN A1.4 TREE AND LANDSCAPE PLAN

A1.5 DRIVEWAY PROFILE PERK PERCOLATION TEST PLAN

A2.1 LEVEL 1 FLOOR PLAN A2.2 LEVEL 2 FLOOR PLAN

A2.3 ROOF PLAN

A3.1 FRONT AND LEFT ELEVATIONS A3.2 REAR AND RIGHT ELEVATIONS

A3.3 BUILDING SECTIONS

CALGREEN CONSTRUCTION REQUIREMENTS

ADDRESSING ITEMS 1 THROUGH 10 IN CALGREEN SECTION 4.410.1

* PER CALGREEN SECTION 4.408.2, CONTRACTOR SHALL PROVIDE AND SUBMIT A CONSTRUCTION WASTE MANAGEMENT PLAN, DIVERTING A MINIMUM OF 65% OF WASTE GENERATED AT THE SITE TO RECYCLE OR SALVAGE, TO THE BUILDING DEPARTMENT. THE FOLLOWING INFORMATION

IDENTIFY MATERIALS TO BE RECYCLED, REUSED, OR SALVAGED

SPECIFY IF MATERIALS WILL BE SORTED ON SITE OR MIXED FOR TRANSPORTATION

SPECIFY THAT THE AMOUNT OF MATERIALS DIVERTED ARE TO BE CALCULATED BY WEIGHT OR VOLUME

* PROTECT ANNULAR SPACES AROUND PIPES, ELECTRIC CABLES, AND CONDUITS AT EXTERIOR WALLS AGAINST THE PASSAGE OF RODENTS.

* ADHESIVES, SEALANTS, AND CAULKS SHALL BE COMPLIANT WITH VOC AND OTHER TOXIC COMPOUND LIMITS.

* AEROSOL PAINTS AND COATINGS SHALL BE COMPLIANT WITH PRODUCT WEIGHTED MIR LIMITS FOR ROC AND OTHER TOXIC COMPOUNDS.

* CARPET AND CARPET SYSTEMS SHALL BE COMPLIANT WITH VOC LIMITS.

* MINIMUM OF 80% OF FLOOR AREA RECEIVING RESILIENT FLOORING SHALL COMPLY WITH SECTION 4.504.4. * PARTICLEBOARD, MEDIUM DENSITY FIBERBOARD, AND HARDWOOD PLYWOOD USED IN INTERIOR FINISH SYSTEMS SHALL COMPLY WITH LOW

FORMALDEHYDE EMISSION STANDARDS.

* CHECK MOISTURE CONTENT OF BUILDING MATERIALS USED IN WALL AND FLOOR FRAMING BEFORE ENCLOSURE.

* CONTRACTOR SHALL PROVIDE, AT THE TIME OF FINAL INSPECTION, AN OPERATION AND MAINTENANCE MANUAL TO THE OWNER OR OCCUPANT,

SHALL BE PROVIDED IN THE PLAN:

IDENTIFY THE DIVERSION FACILITY(IES) TO BE USED IDENTIFY CONSTRUCTION METHODS TO BE USED TO LIMIT WASTE GENERATION

* AUTOMATIC IRRIGATION SYSTEMS CONTROLLERS INSTALLED AT THE TIME OF FINAL INSPECTION SHALL BE WEATHER-BASED.

* COVER DUCT OPENINGS AND OTHER RELATED AIR DISTRIBUTION COMPONENT OPENINGS DURING CONSTRUCTION.

* PAINTS, STAINS, AND OTHER COATINGS SHALL BE COMPLIANT WITH VOC LIMITS.

VERIFICATION OF COMPLIANCE SHALL BE PROVIDED.

* INSTALL CAPILLARY BREAK AND VAPOR RETARDER AT SLAB ON GRADE FOUNDATIONS.

* EACH BATHROOM SHALL BE MECHANICALLY VENTILATED WITH AN ENERGY STAR EXHAUST FAN, AND FAN MUST BE CONTROLLED BY A HUMIDITY CONTROL.



			I		1
DESCRIPTION	PRE APPLICATION MEETING	PLANNING SUBMITTAL	PLANNING RESUBMITTAL	2ND PLANNING RESUBMITTAL	3RD PLANNING RESUBMITTAL
DATE	04/10/2018	08/16/2018	11/14/2018	03/07/2019	06/20/2019
REV	1	7	3	4	5
			CT SCOPE:	TH (N) ATTACHED	JOH JOH

FAMILY HOME RESIDENCE ROAD A 9403

SHEET TITLE

TITLE SHEET/ PROJECT INFO

SHEET


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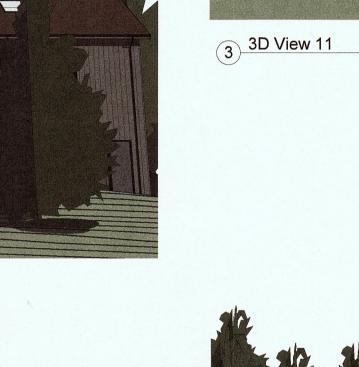










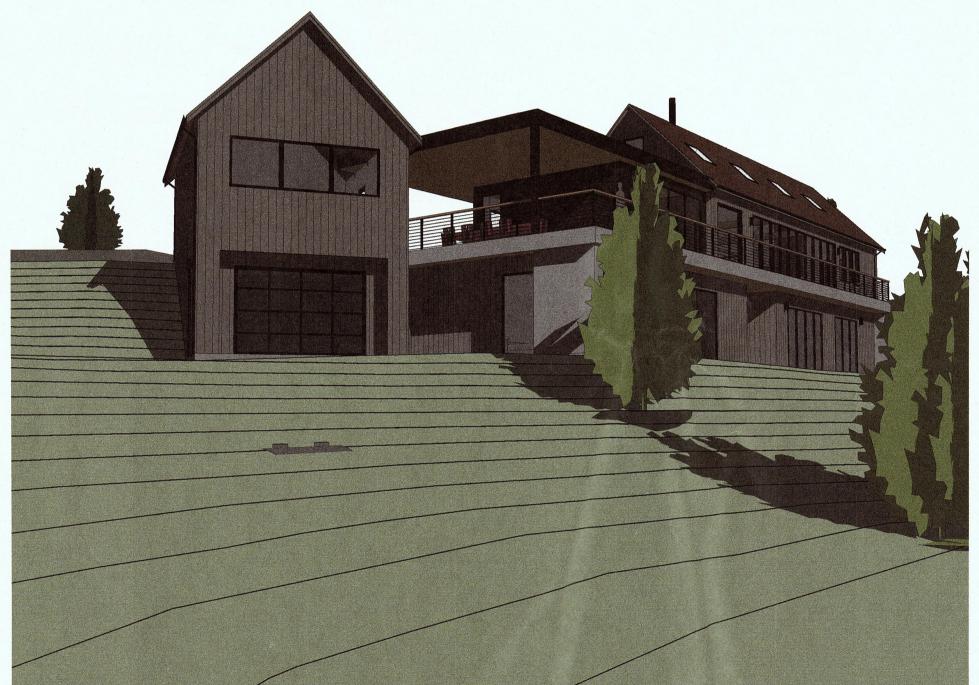

6 3D View 14





8 3D View 16



10 3D View 18

	IEET	MCWHERTER MCWHERTER		MONTARA, CA 94037
	NEW SINGLE FAMILY HOMI	MCWHERTER RESIDENCE	ROAD	A 94037

SHEET

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7 3D View 15

1 3D View 9


1 DESIGN VIEW 1 3 DESIGN VIEW 2 NEW SINGLE FAMILY HOME MCWHERTER RESIDENCE SHEET TITLE 4 DESIGN VIEW 3 2 APPROACH VIEW 2 SHEET

A0.2

3D VIEWS

1237 GRANT ROAD
MONTARA, CA 94037

PROJECT SCOPE:
(N) TWO STORY, SINGLE FAMILY HOME WITH (N) ATTACHED GARAGE

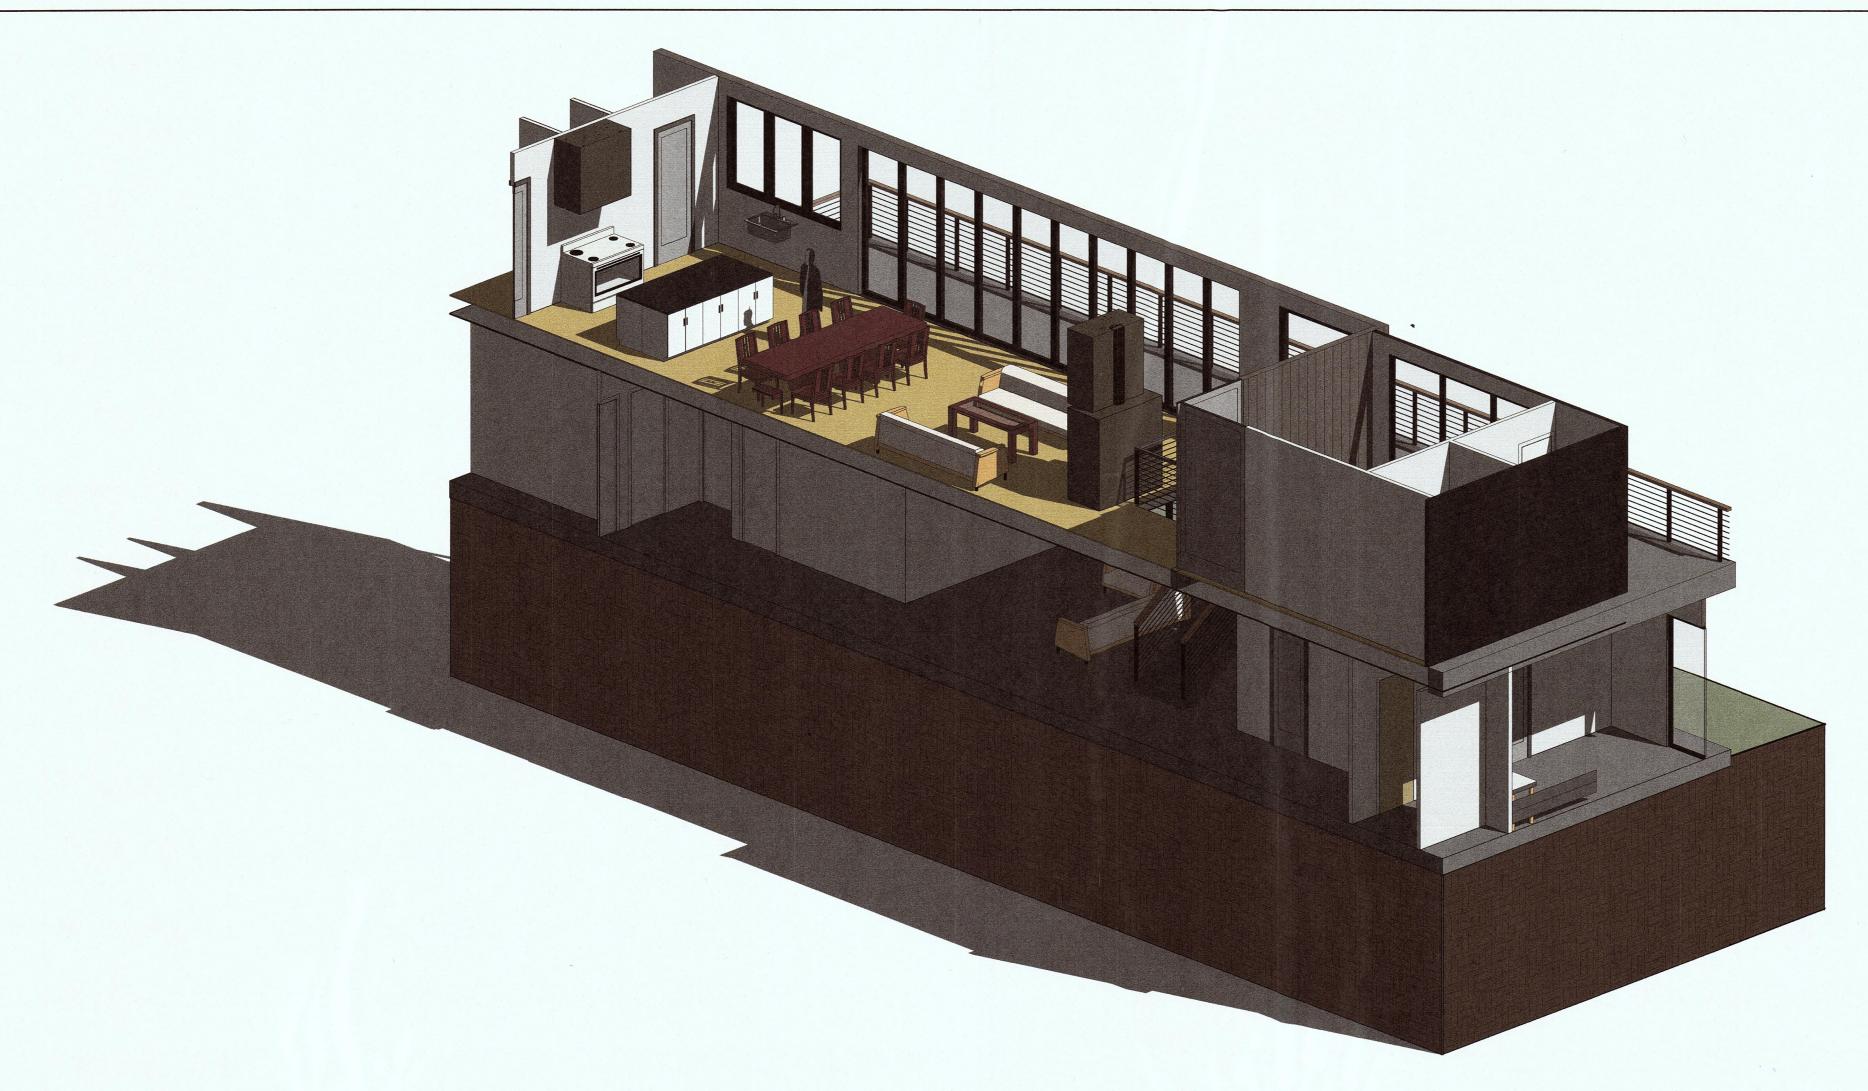





7/8" CORRUGATED METAL ROOFING COLOR TRUTEN A606 (TYP.)
PLATINUM STAINED SPRUCE CLADDING (TYP.)
BLACK STAINED SPRUCE CLADDING (TYP.)
ROOF FASCIA SAME MATERIAL AS SIDING (TYP.)
MIN 42" HIGH RAILING WITH 3"x3" STEEL POSTS WITH WOVEN 3/4" MESH AND WOOD CAP
TRIMLESS BLACK ALUMINUM DOORS AND WINDOWS BY ANDERSON.
CONCRETE DECKING
CERTAINTEED FLINTLASTIC SA BUILT UP, SELF-ADHERING, MODIFIED BITUMEN ROOFING SYSTEM, OR SIMILAR

PROJECT NAME:

NEW SINGLE FAMILY HOME

MCWHERTER RESIDENCE

PROJECT ADDRESS:

1237 GRANT ROAD

MONTARA, CA 94037

SHEET


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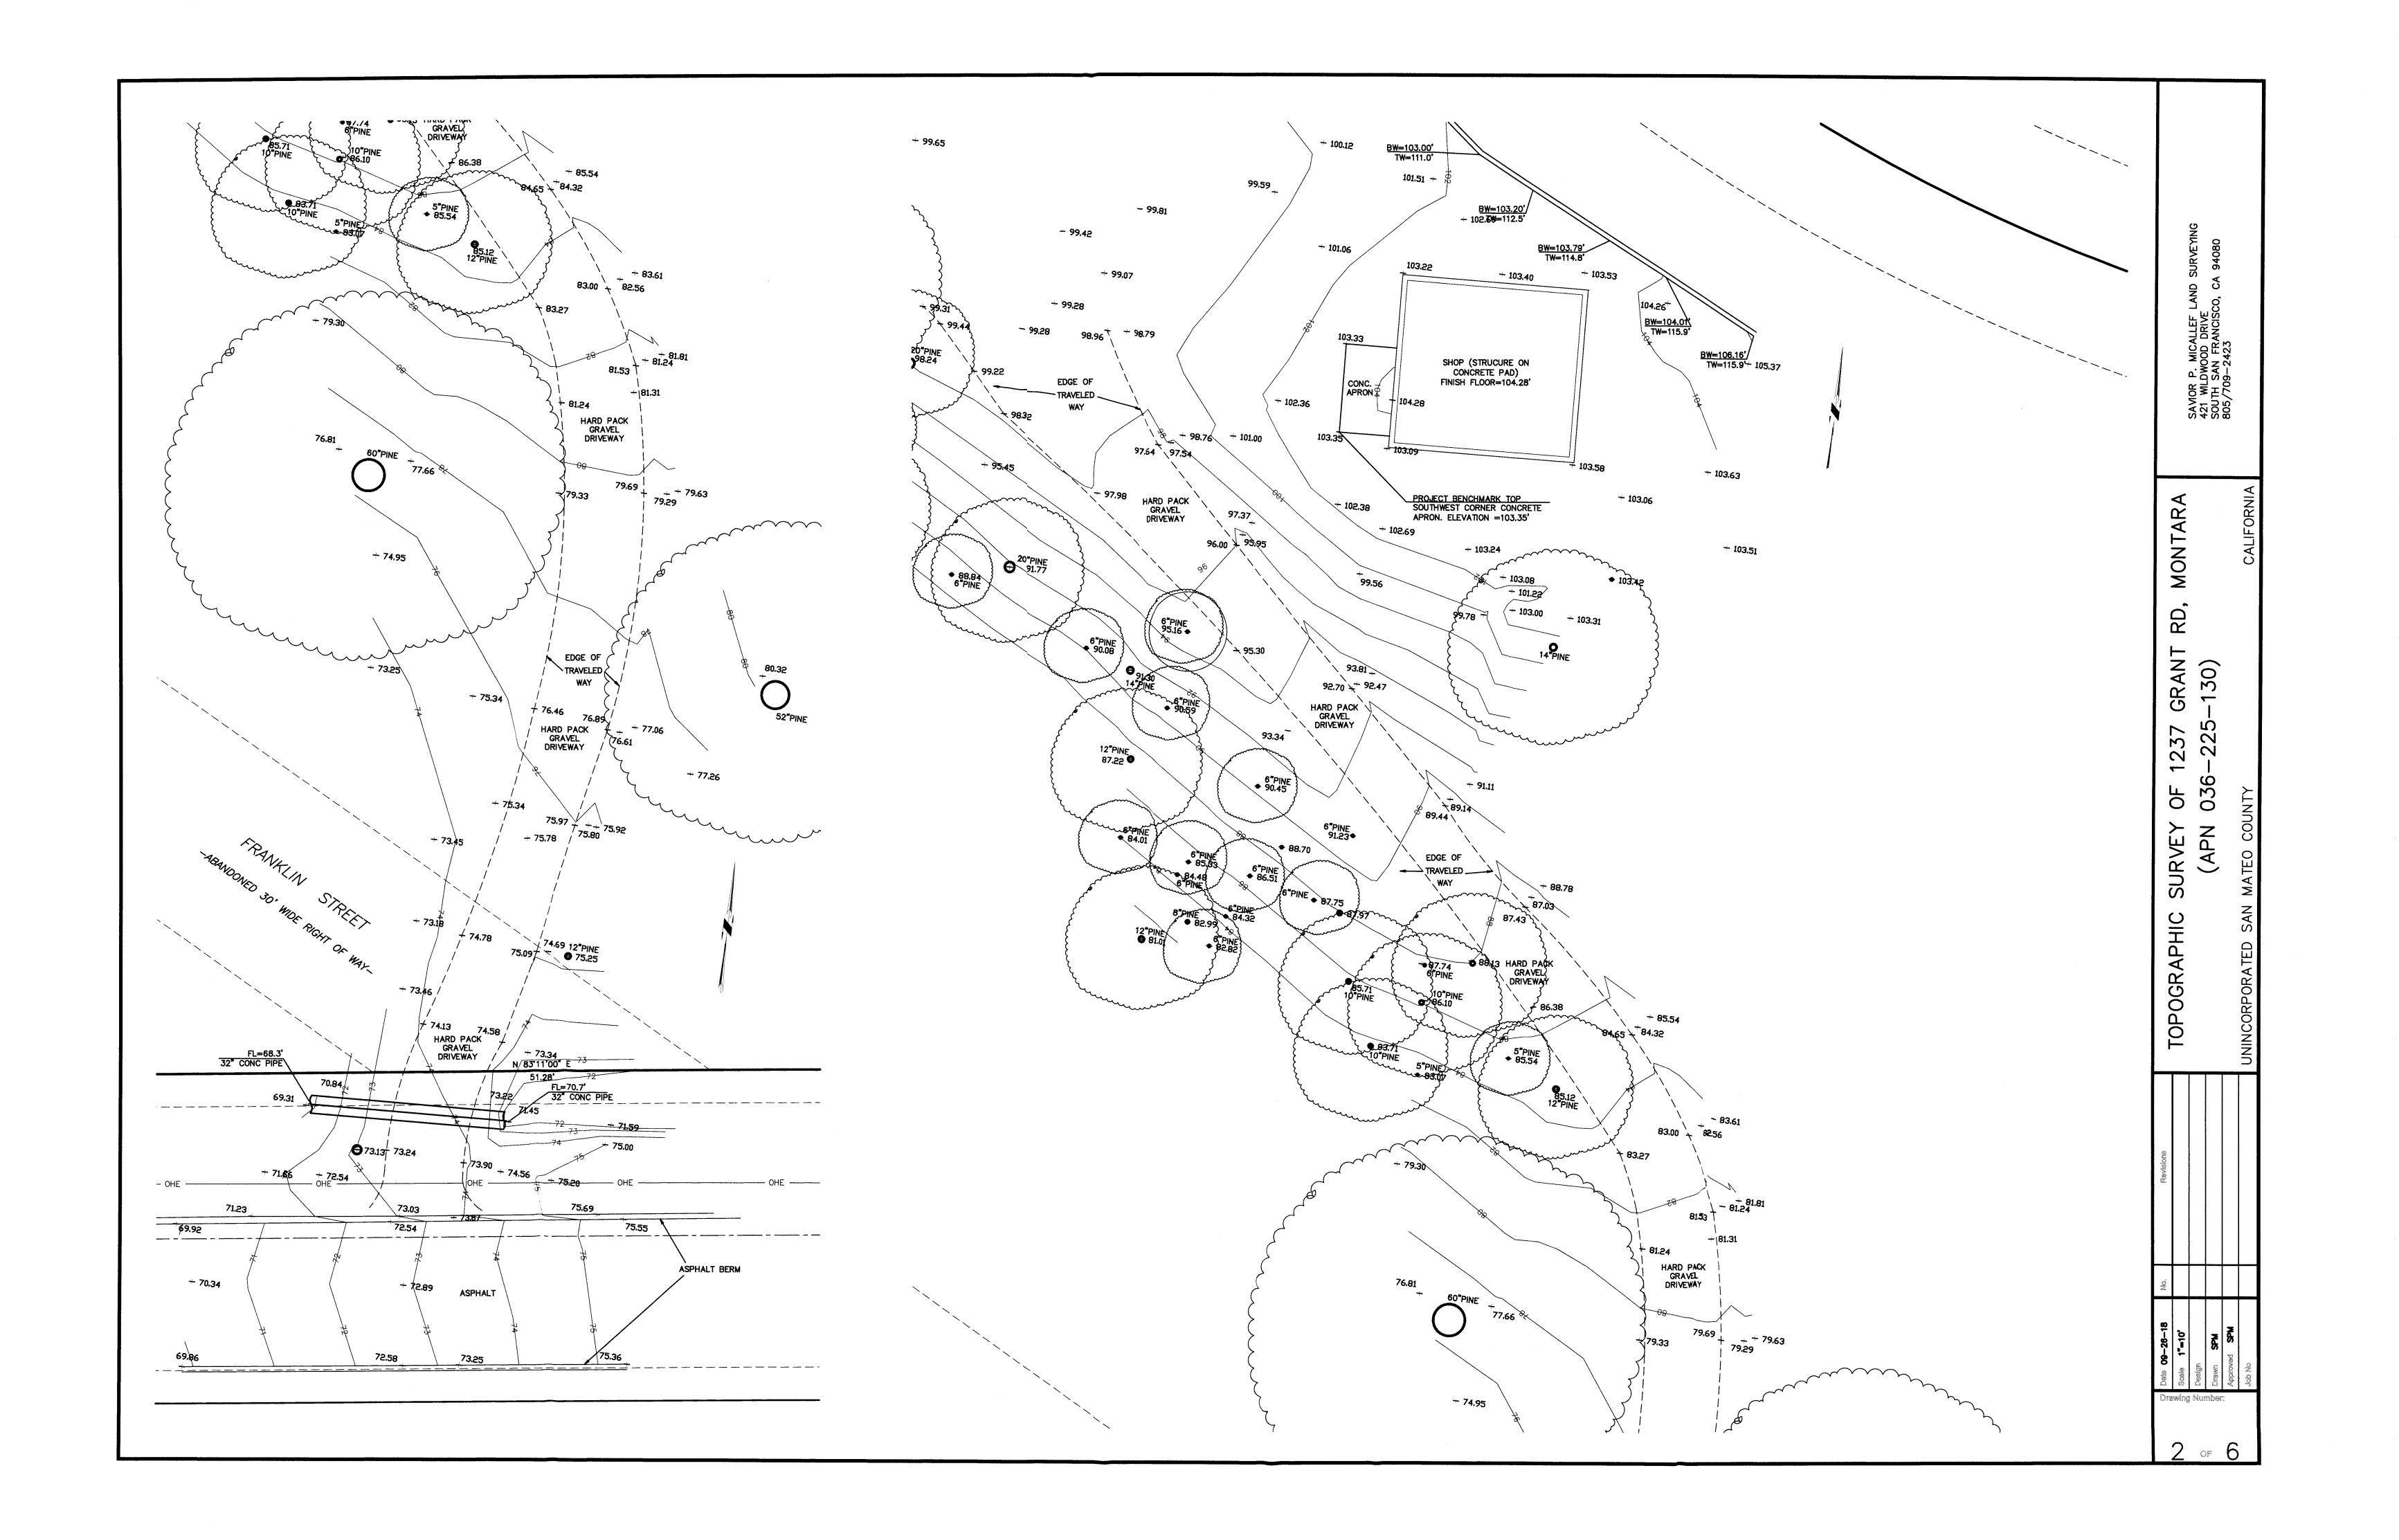
3D CUTAWAY


AND MATERIALS


PERSPECTIVE


2 MATERIALS PERSPECTIVE




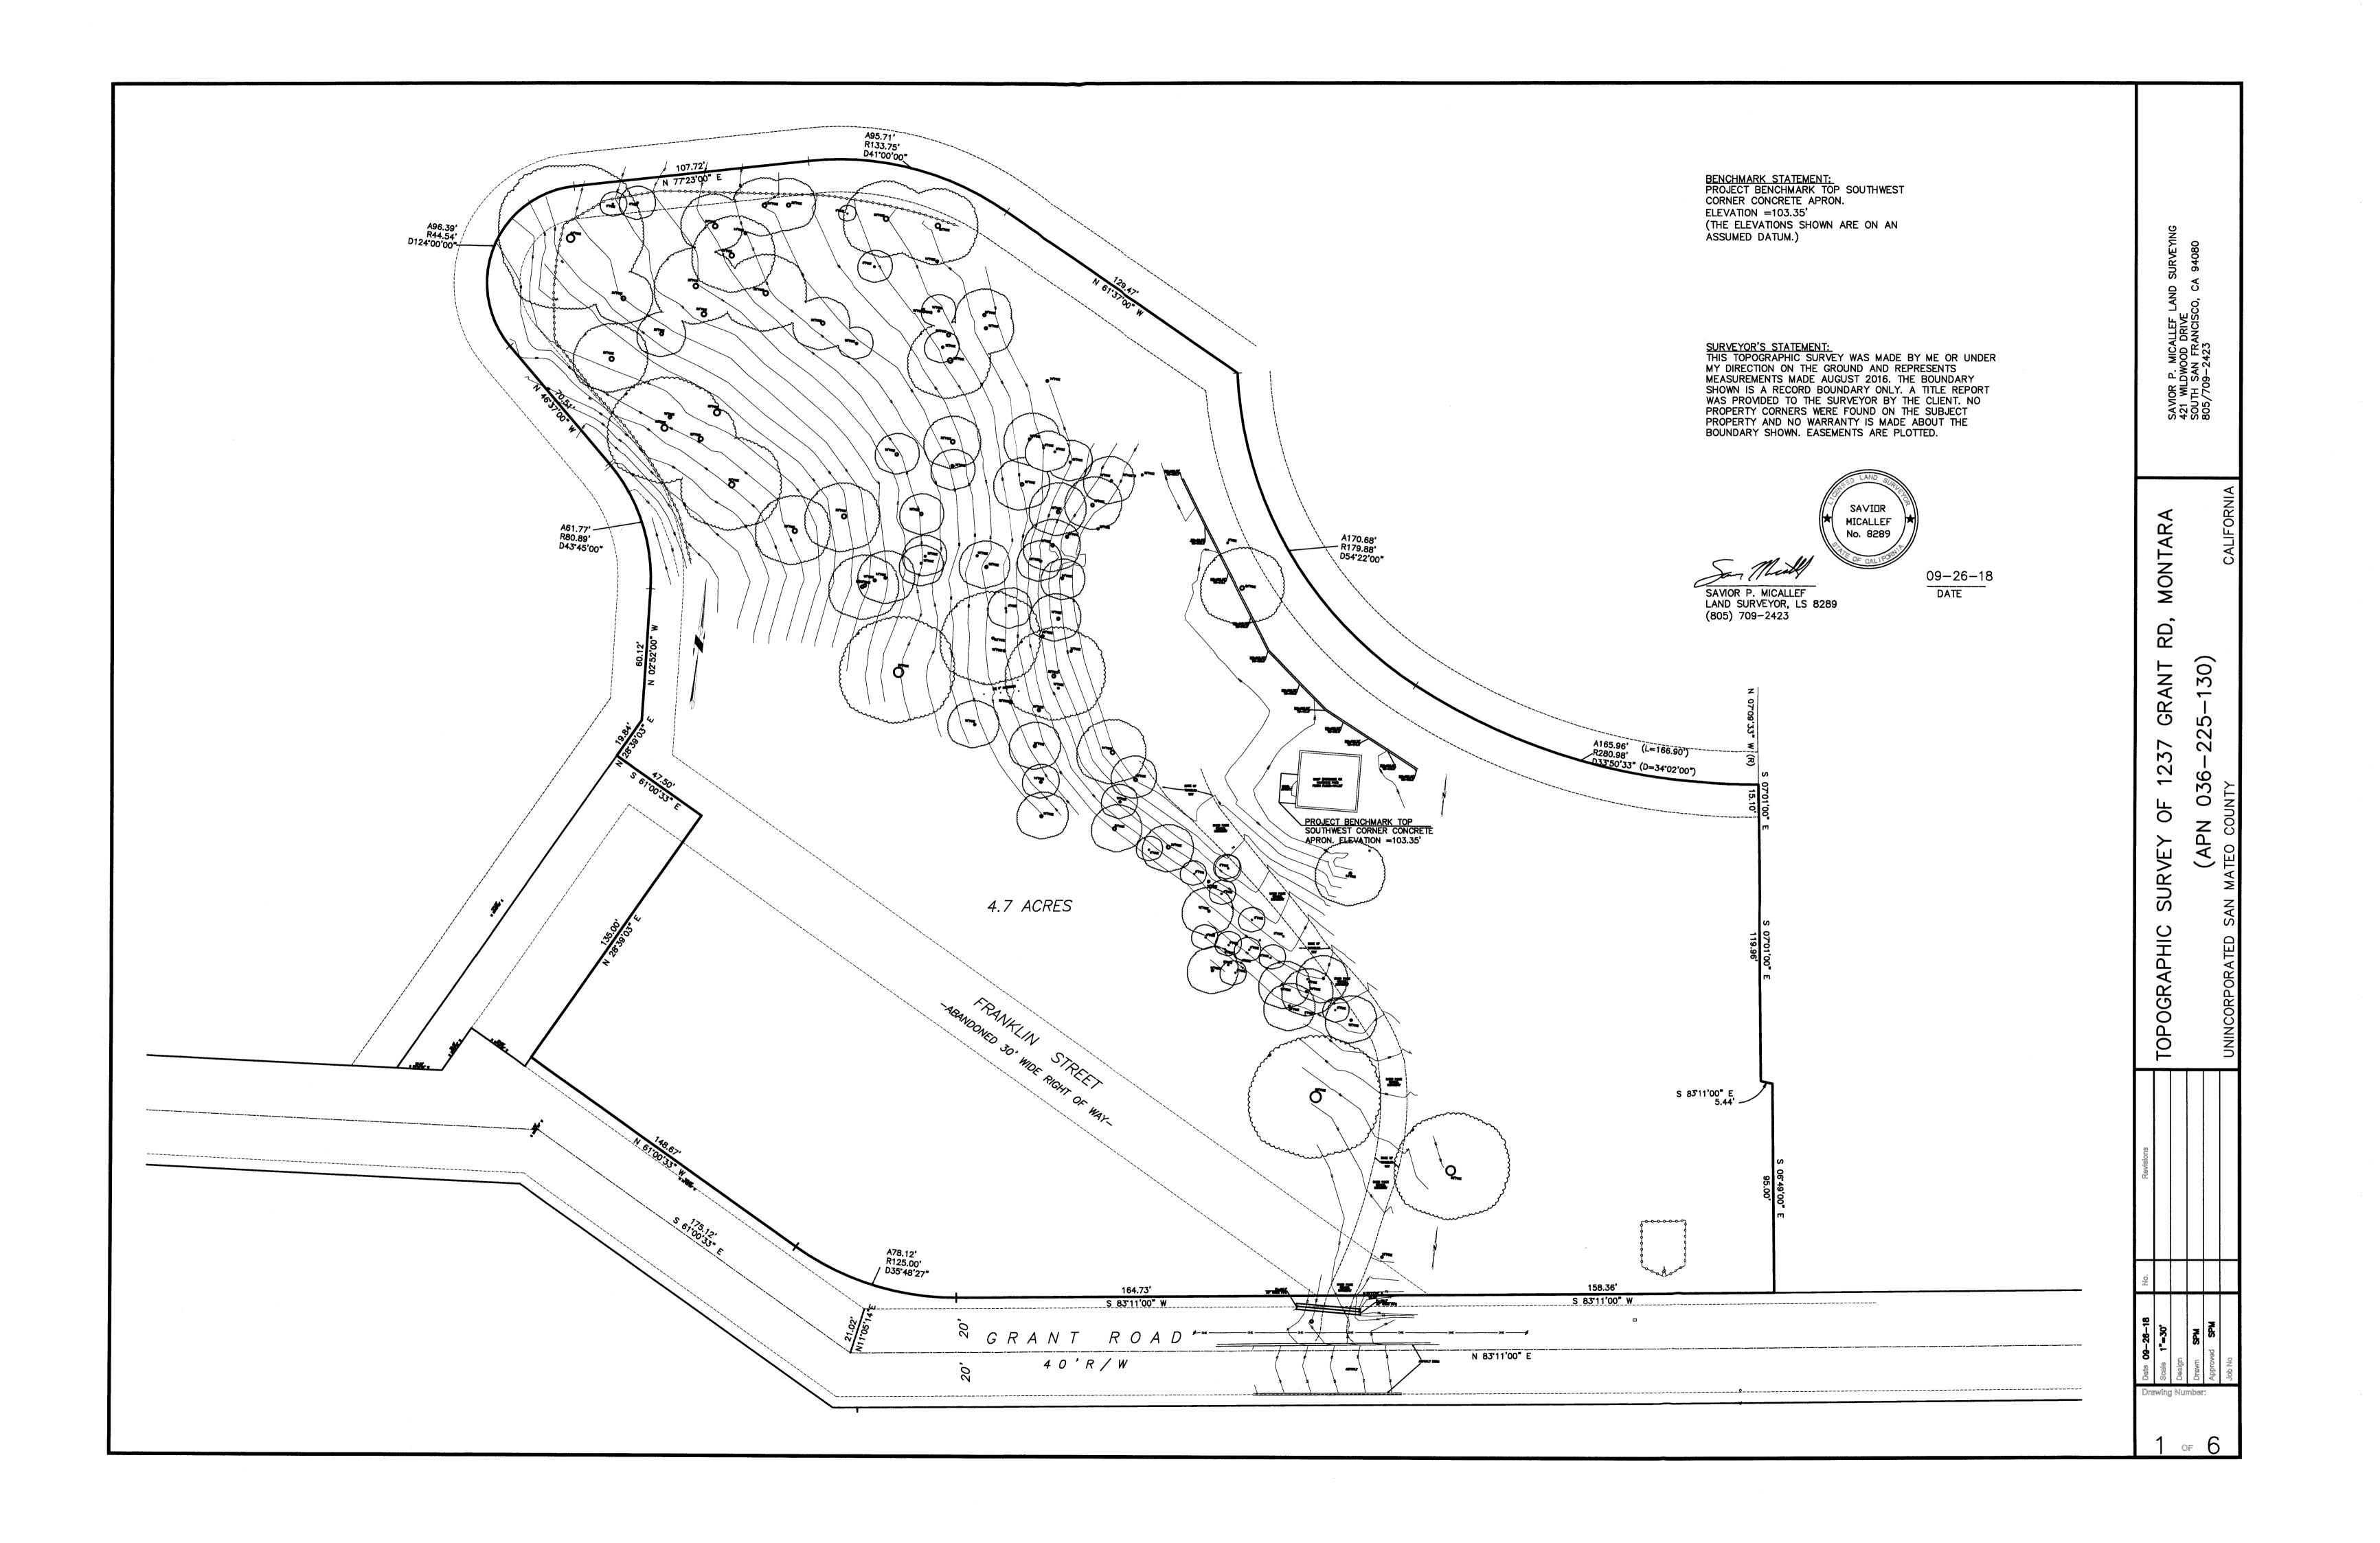


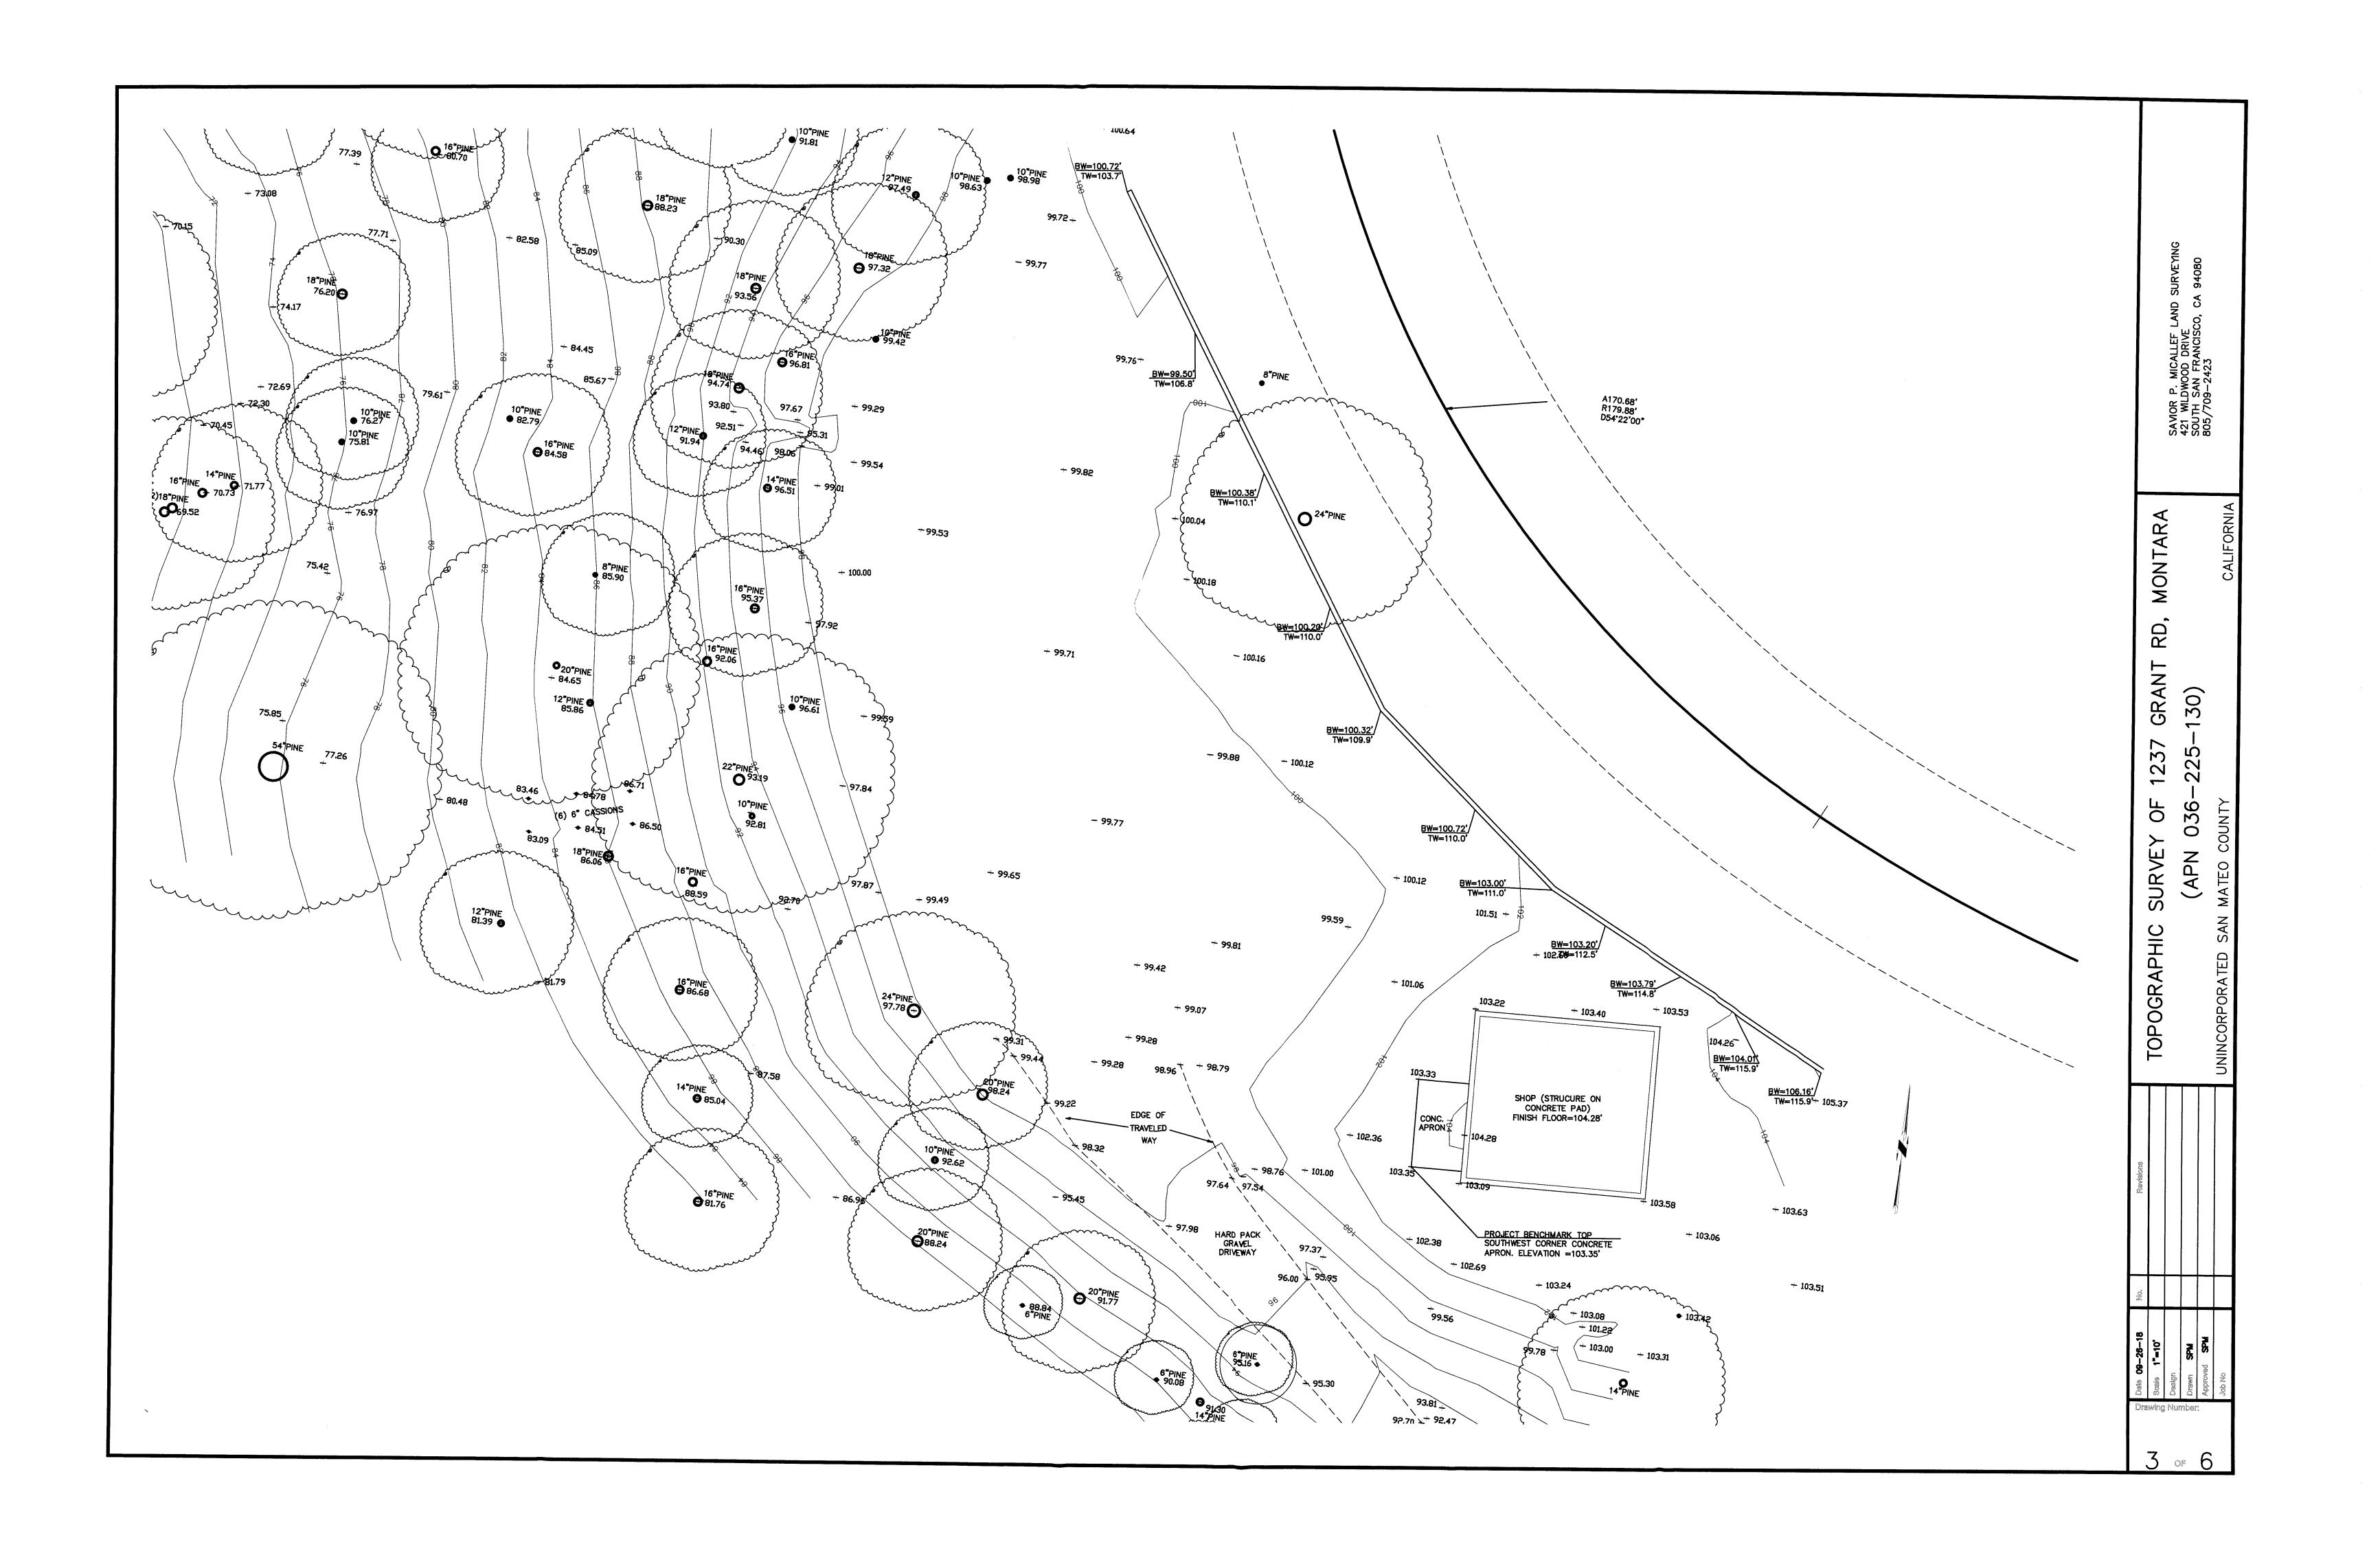

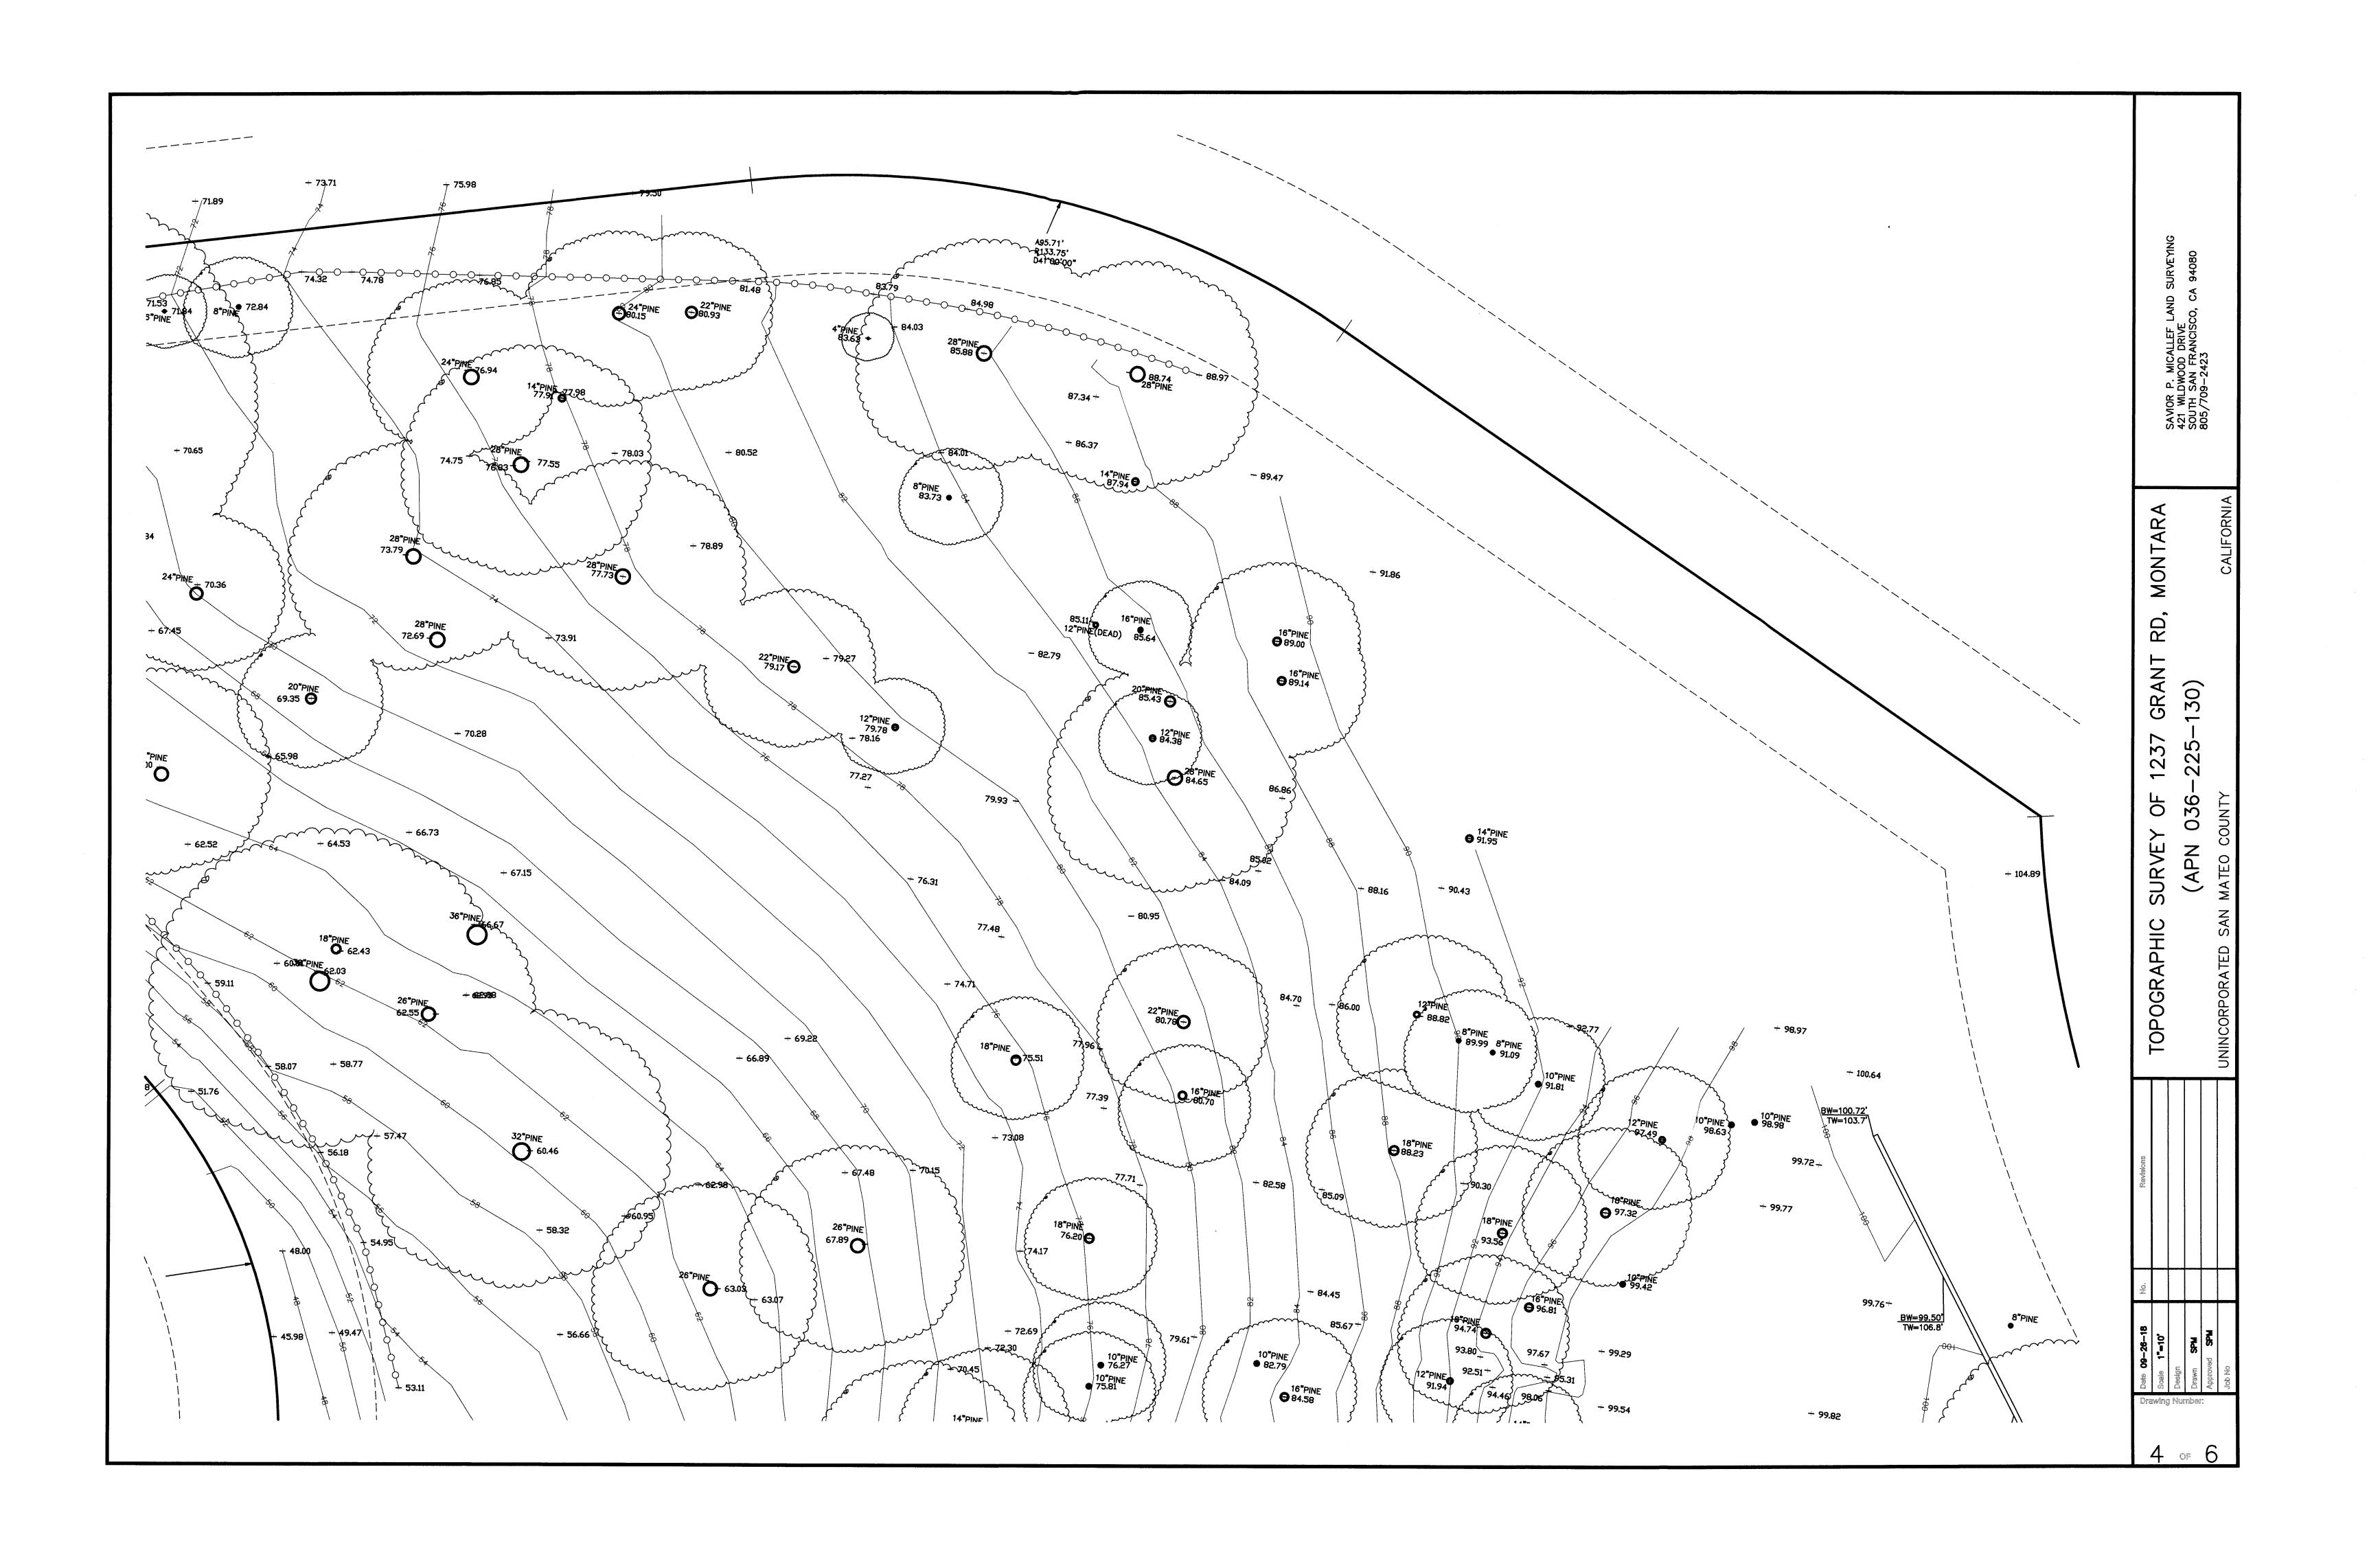


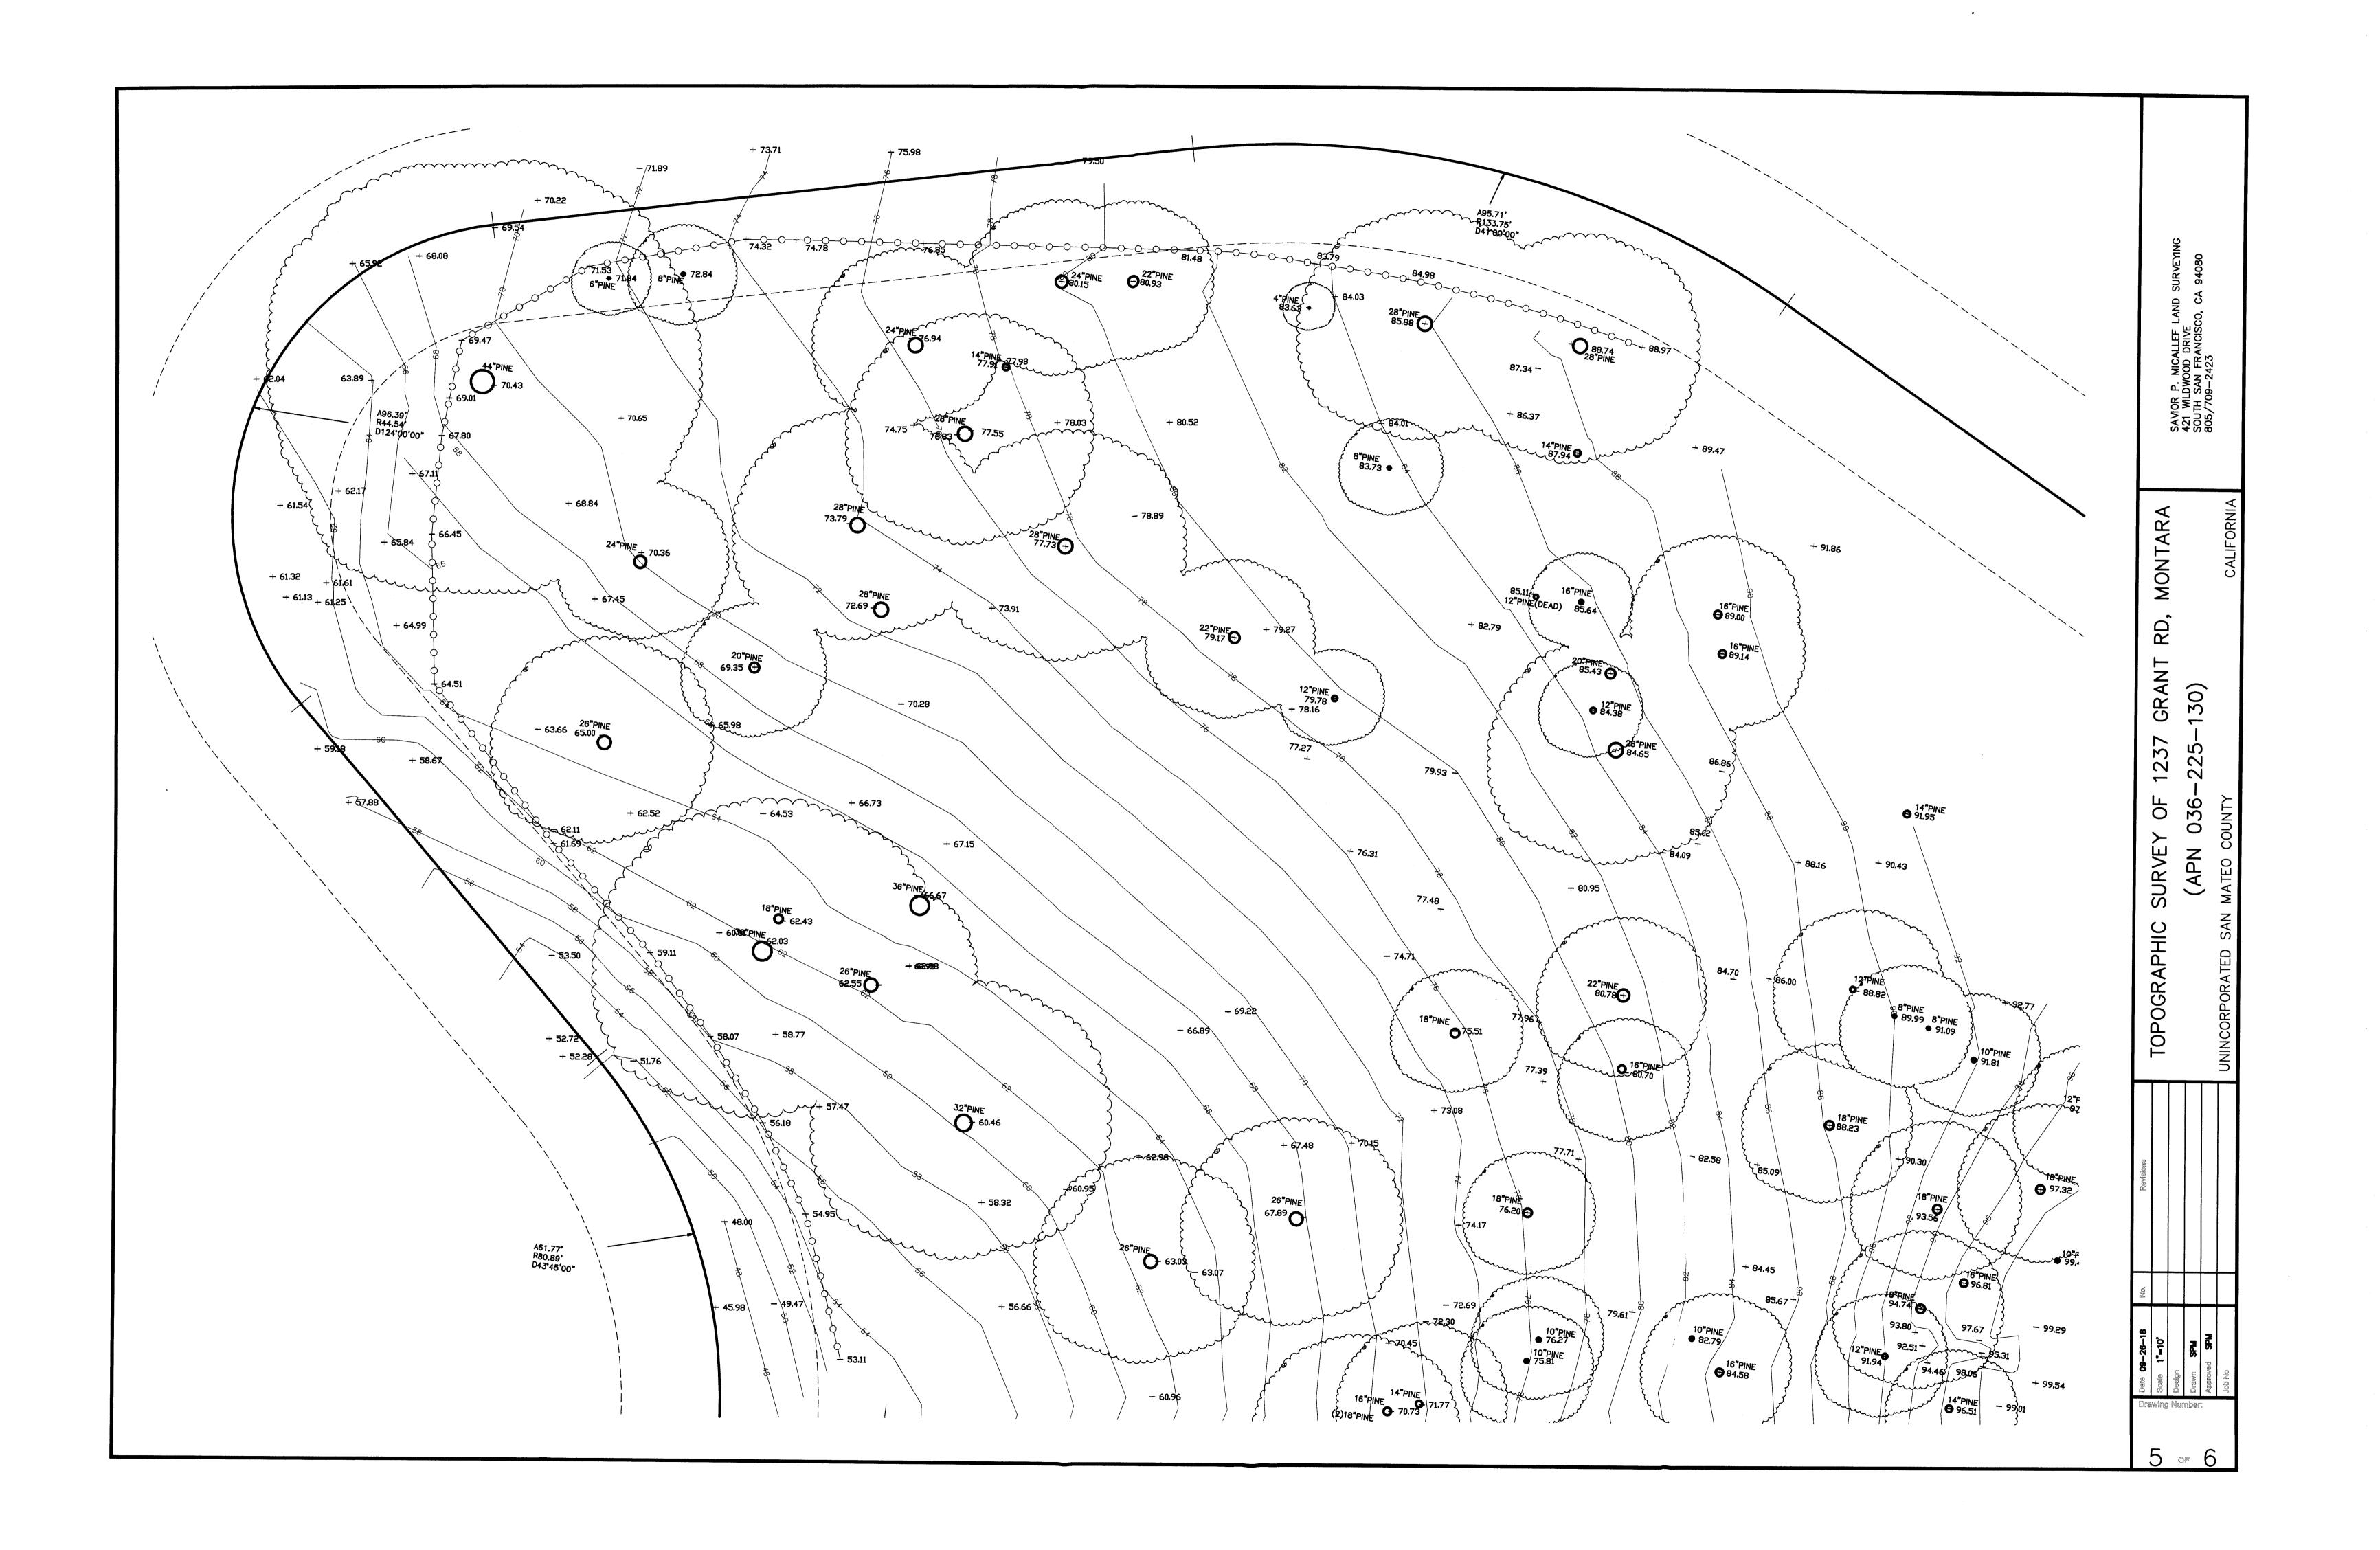

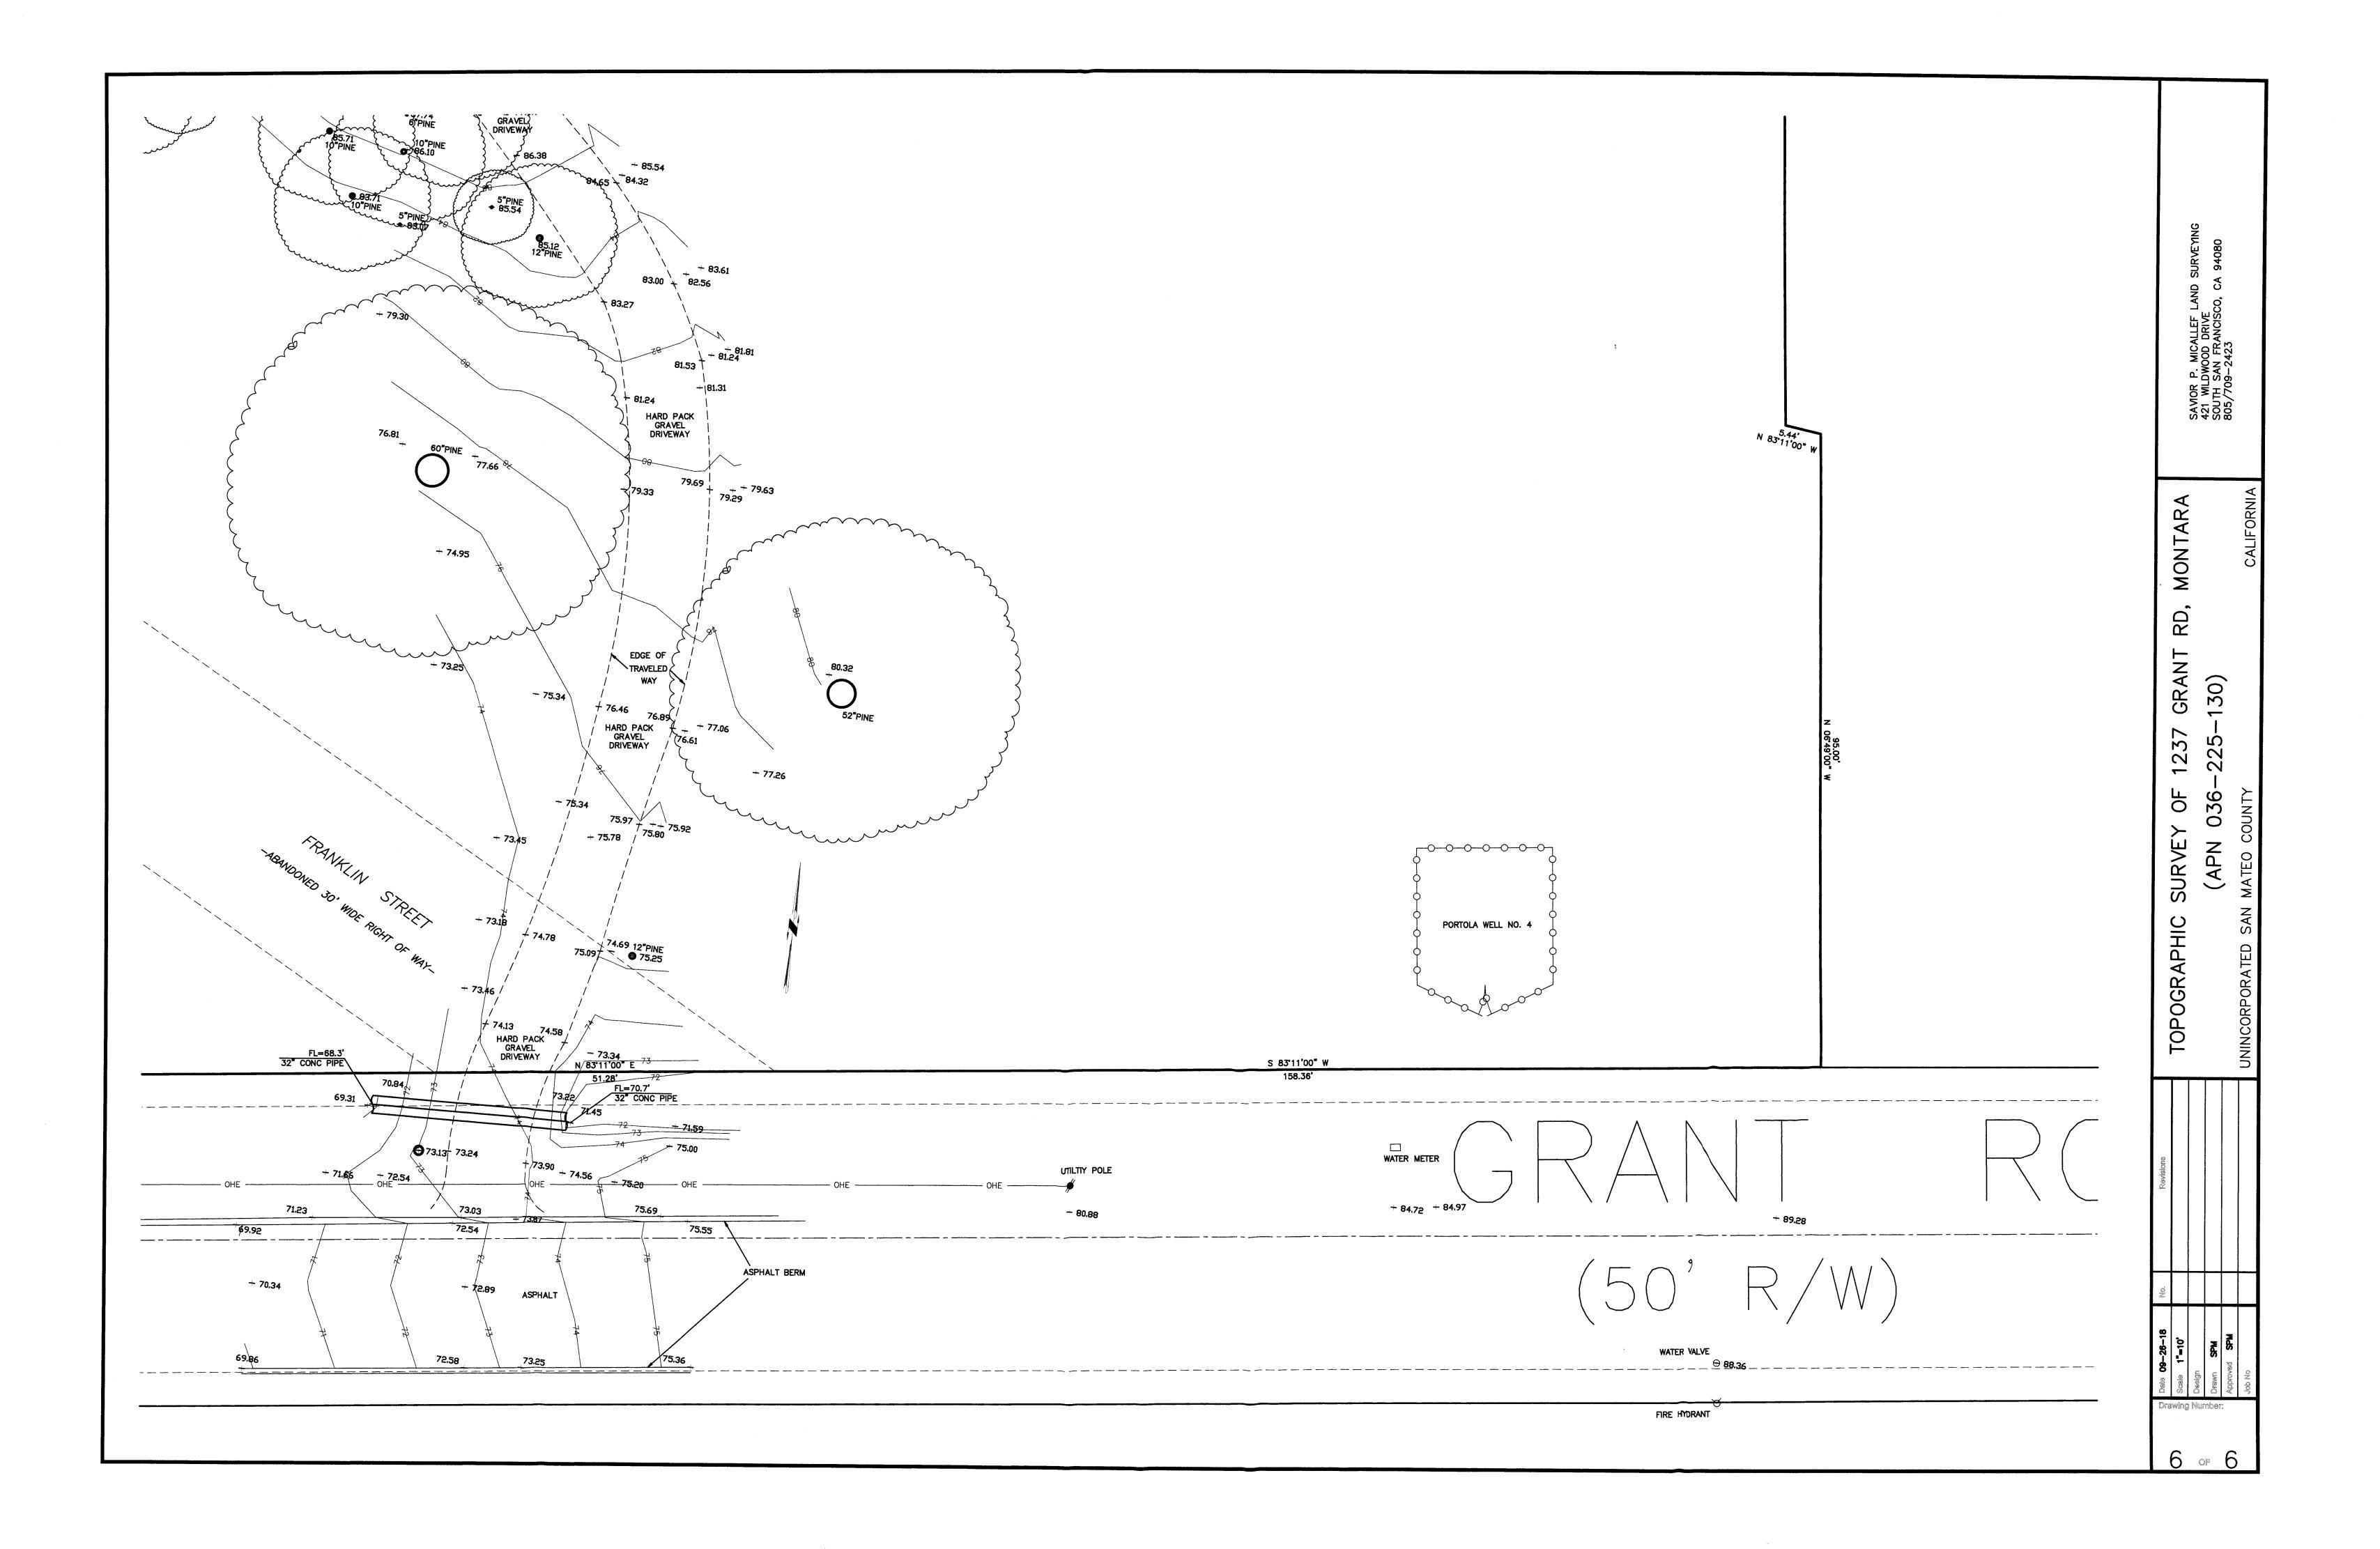

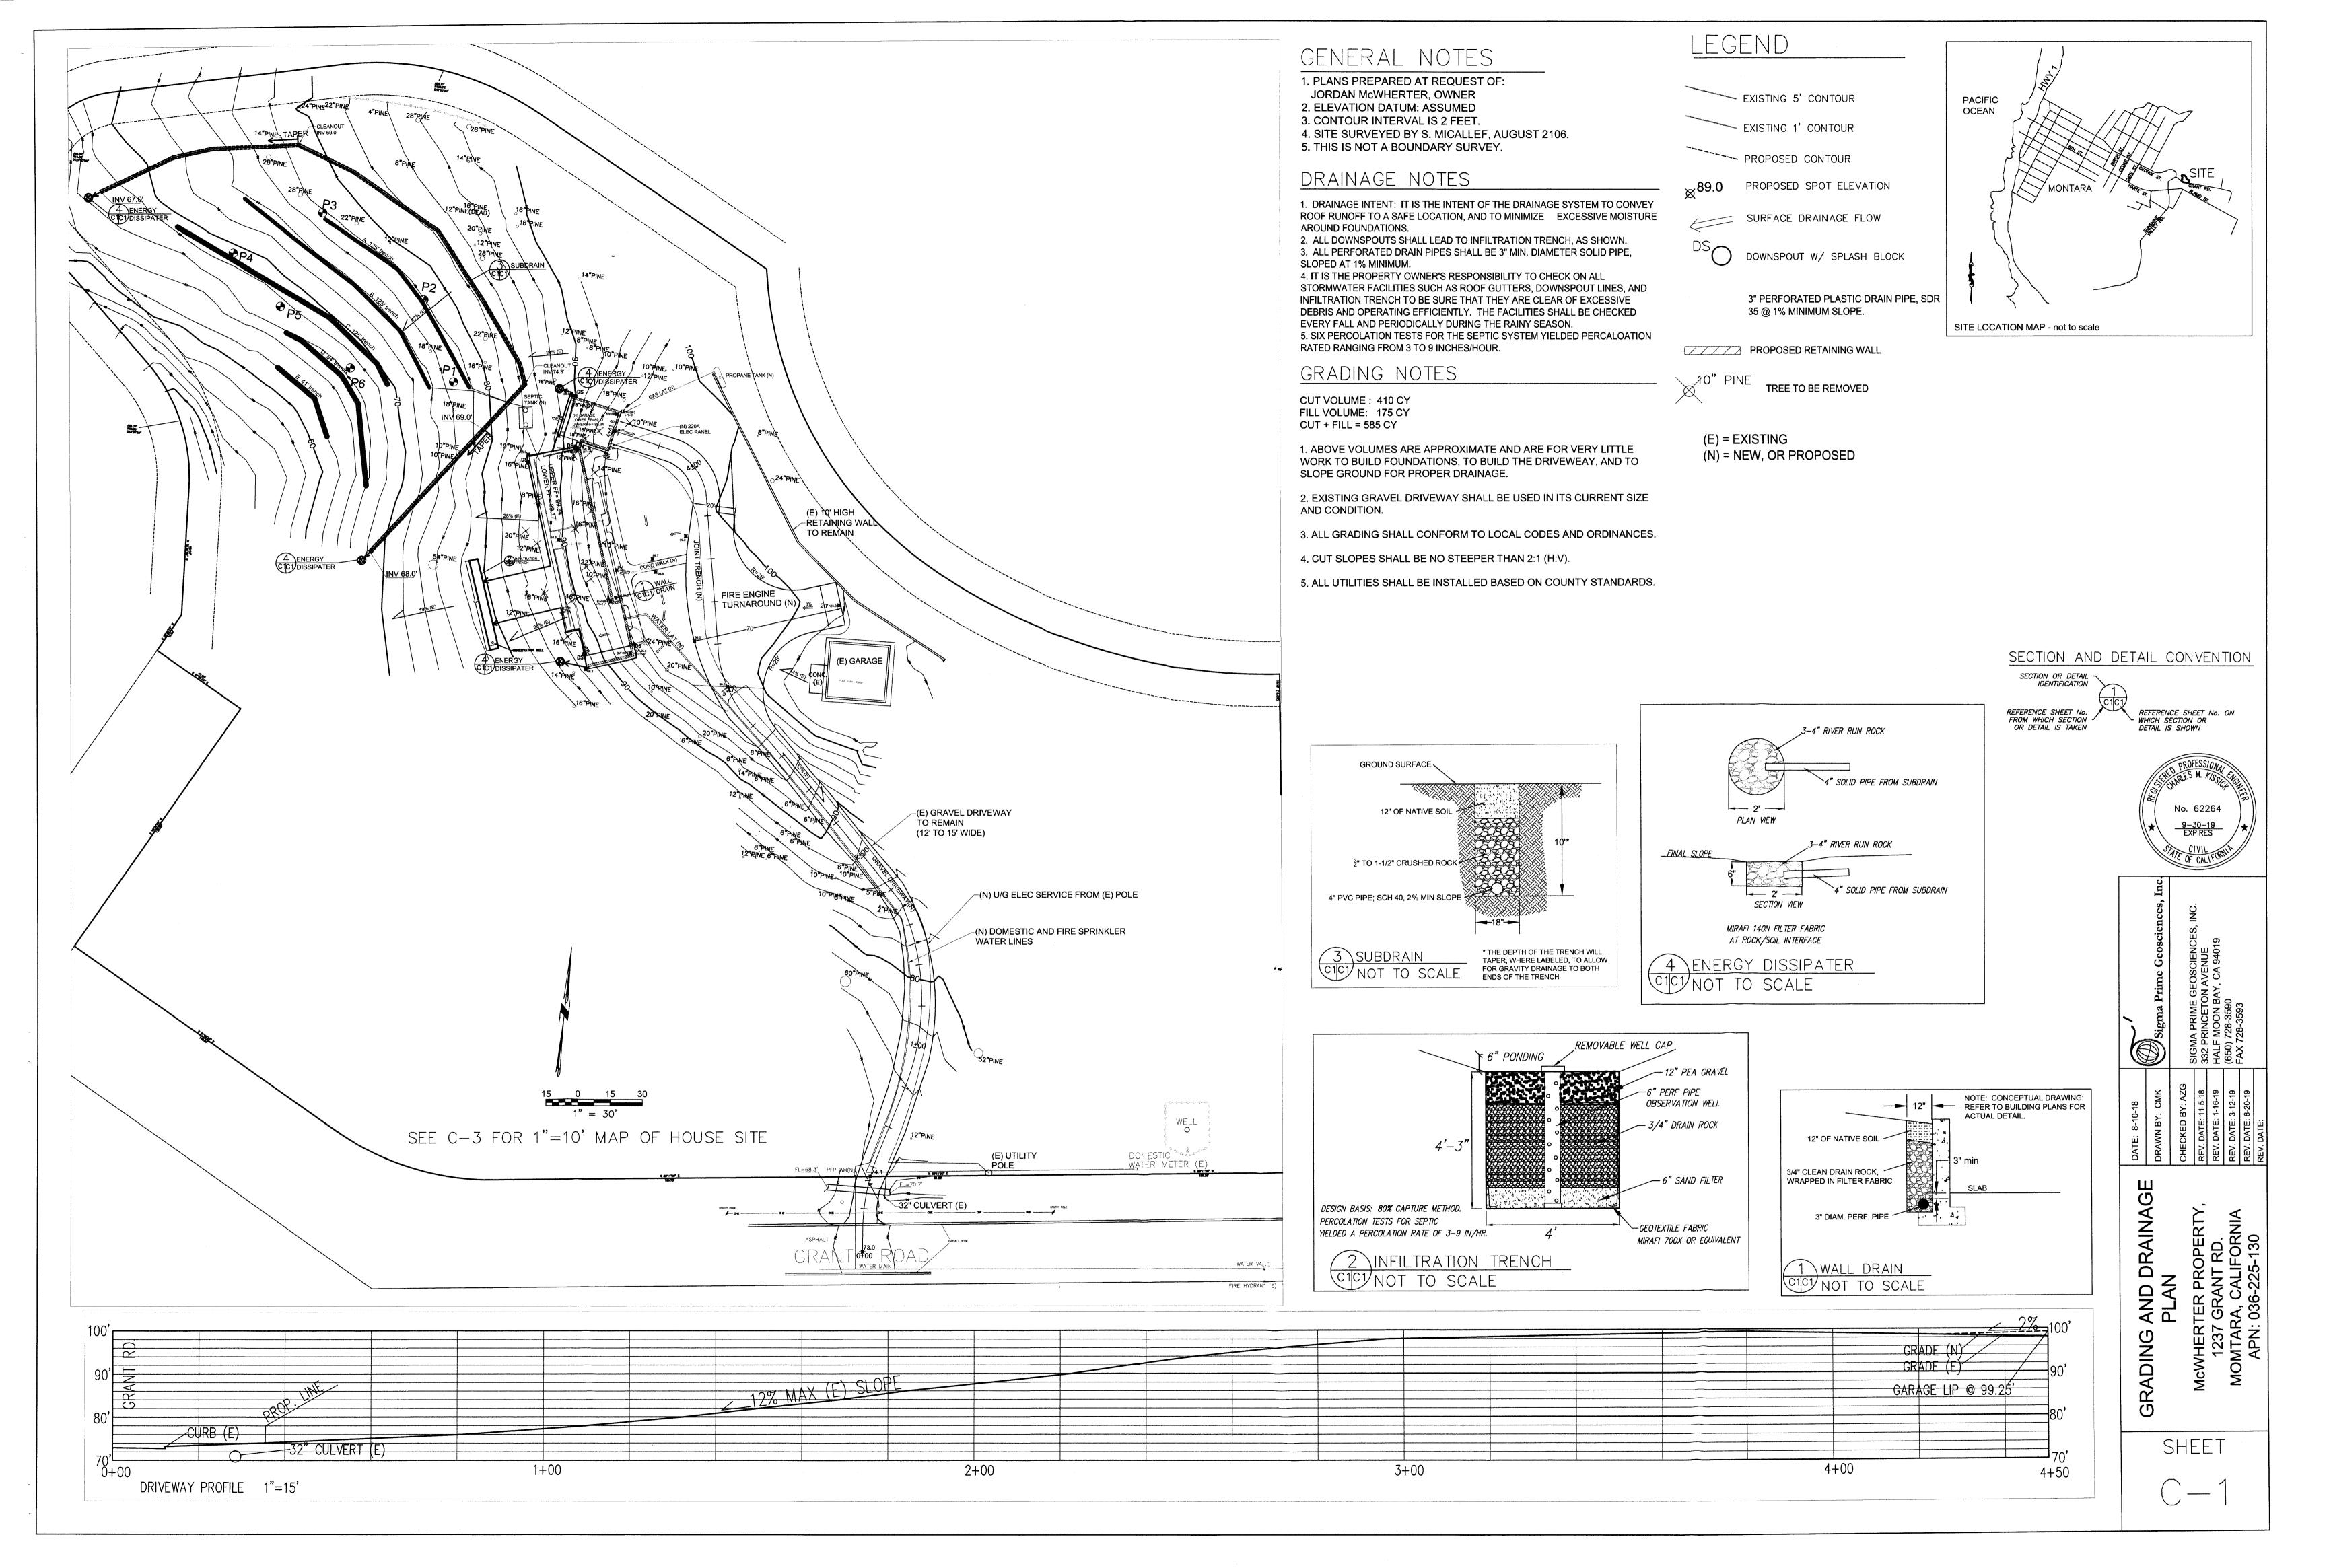



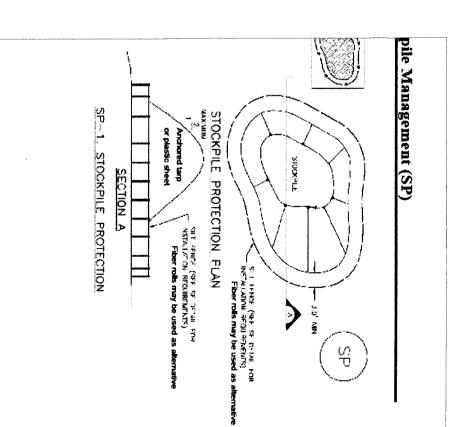

2. TREE PROTECTION FENCES SHALL BE INSTALLED AS CLOSE TO DRIP LINES AS POSSIBLE.

3. OWNER/BUILDER SHALL MAINTAIN TREE PROTECTION ZONES FREE OF EQUIPMENT AND MATERIALS STORAGE AND SHALL NOT CLEAN ANY EQUIPMENT WITHIN THESE AREAS.

EROSION CONTROL POINT OF CONTACT

THIS PERSON WILL BE RESPONSIBLE FOR EROSION CONTROL AT THE SITE AND WILL BE THE COUNTY'S MAIN POINT OF CONTACT IF CORRECTIONS ARE REQUIRED.

NAME: JORDAN McWHERTER


TITLE/QUALIFICATION: OWNER

E-MAIL: taylormakedevelopment@gmail.com


4. ANY LARGE ROOTS THAT NEED TO BE CUT SHALL BE INSPECTED BY A CERTIFIED ARBORIST OR REGISTERED FORESTER PRIOR TO CUTTING, AND MONITORED AND DOCUMENTED.

5. ROOTS TO BE CUT SHALL BE SEVERED WITH A SAW OR TOPPER.

6. PRE-CONSTRUCTION SITE INSPECTION WILL BE REQUIRED PRIOR TO ISSUANCE OF BUILDING DEPMIT

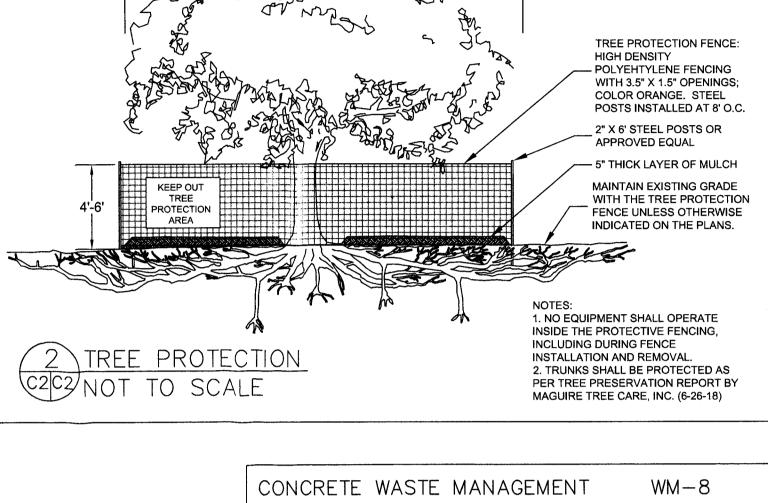

CONCRETE WASTE MANAGEMENT STARE (17P) B 1/8' DIA STAPLE DETAIL STAPLE DETAIL STAPLE DETAIL STAPLE DETAIL STAPLE DETAIL ON METAIN BALE (17P) STAPLES ON CRETE WASHOUT STAPLES ON CRETE WASHOUT STAPLES ON CRETE WASHOUT STAPLES ON TO STARES (17P) STAPLES ON CRETE WASHOUT STAPLES ON TO STARES (17P) STAPLES ON CRETE WASHOUT STAPLES ON TO STARES (17P) STAPLES ON TO STARES ON TO STARES

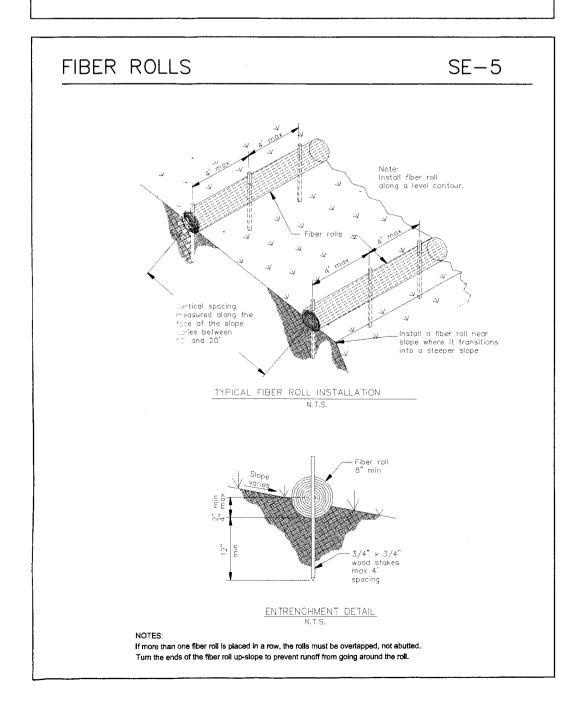

GENERAL EROSION AND SEDIMENT CONTROL NOTES

- Perform clearing and earth-moving activities only during dry weather. Measures to ensure adequate erosion and sediment control shall be installed prior to earth-moving activities and construction.
- Measures to ensure adequate erosion and sediment control are required year-round.
 Stabilize all denuded areas and maintain erosion control measures continuously between October 1 and April 30.
- Store, handle, and dispose of construction materials and wastes properly, so as to prevent their contact with stormwater.
- Control and prevent the discharge of all potential pollutants, including pavement cutting wastes, paints, concrete, petroleum products, chemicals, wash water or sediments, and non-stormwater discharges to storm drains and watercourses.
- Use sediment controls or filtration to remove sediment when dewatering site and obtain Regional Water Quality Control Board (RWQCB) permit(s) as necessary.
- Avoid cleaning, fueling, or maintaining vehicles on-site, except in a designated area where wash water is contained and treated.
- · Limit and time applications of pesticides and fertilizers to prevent polluted runoff.
- Limit construction access routes to stabilized, designated access points
- Avoid tracking dirt or other materials off-site; clean off-site paved areas and sidewalks using dry sweeping methods.
- Train and provide instruction to all employees and subcontractors regarding the Watershed Protection Maintenance Standards and construction Best Management Practices.
- Placement of erosion materials is required on weekends and during rain events.
- The areas delineated on the plans for parking, grubbing, storage etc., shall not be enlarged or "run over."
- Dust control is required year-round.
- Erosion control materials shall be stored on-site.
- Protect existing culvert at Grant Road with two rows of sand bags, as shown.

EROSION CONTROL NOTES

FIBER ROLE INSTALL AT LOCATIONS SHOWN. AFIX AS SHOWN IN DETAIL 1

- 1. GRADING MAY TAKE PLACE DURING WET WEATHER AFTER OCTOBER 1 PROVIDED THE FOLLOWING PROVISIONS ARE FOLLOWED.
- FOLLOWING PROVISIONS ARE FOLLOWED.


 2. NO GRADING SHALL TAKE PLACE DURING RAINY WEATHER OR FOR A PERIOD OF AT LEAST 24 HOURS FOLLOWING RAIN.
- 3. ALL EXPOSED SOIL SHALL BE TEMPORARILY PROTECTED FROM EROSION WITH JUTE NETTING.
 4. ALL STOCKPILED SOIL SHALL BE COVERED AT ALL TIMES AND REMOVED FROM SITE
- AS SOON AS POSSIBLE, IF SCHEDULED FOR OFF-HAUL.


 5. ALL EXPOSED SURFACES SHALL BE PERMANENTLY PROTECTED FROM EROSION WITH SEEDING AND/OR LANDSCAPING. SEED MIX SHALL BE 75 LB PER ACRE ANNUAL RYGRASS OR APPROVED SUBSTITUTE. SEED SHALL BE COVERED WITH STRAW MULCH AT A RATE OF 2 TONS/ACRE.
- 6. ROCKED CONSTRUCTION ENTRANCE SHALL BE 50 FEET LONG BY 12 FEET WIDE AND CONFORM TO THE FOLLOWING:
- A. THE MATERIAL FOR THE PAD SHALL BE 3 TO 6 INCH STONE.
- B. PAD SHALL BE NOT LESS THAN 12" THICK.

 C. THE ENTRANCE SHALL BE MAINTAINED IN A CONDITION THAT WILL PREVENT TRACKING OR FLOWING OF SEDIMENT ONTO PUBLIC RIGHT-OF-WAY. THIS MAY REQUIRE PERIODIC TOP DRESSING WITH ADDITIONAL STONE AS CONDITIONS DEMAND, AND REPAIR AND/OR CLEANOUT OF ANY MEASURES USED TO TRAP SEDIMENT. ALL SEDIMENT SPILLED, DROPPED, WASHED, OR TRACKED ONTO PUBLIC RIGHT-OF-WAY
- SHALL BE REMOVED IMMEDIATELY.

 D. WHEN NECESSARY, WHEELS SHALL BE CLEANED TO REMOVE SEDIMENT PRIOR TO ENTRANCE ONTO PUBLIC RIGHT-OF-WAY. WHEN WASHING IS REQUIRED, IT SHALL BE DONE ON AN AREA THAT DRAINS TO THE CONCRETE WASHOUT AREA.

 7. CONCRETE WASHOUT AREA SHALL BE SURROUNDED BY A SINGLE LAYER OF SAND.
- 7. CONCRETE WASHOUT AREA SHALL BE SURROUNDED BY A SINGLE LAYER OF SAND BAGS TO CONTAIN FLUIDS. CHANNEL INTO AREA SHALL BE CLEARED TO ALLOW TIRE DEBRIS (SEE NOTE 6.D. ABOVE)

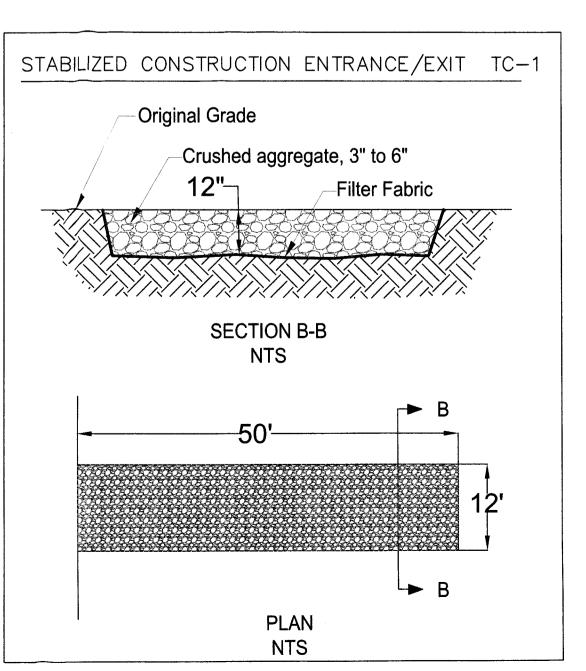

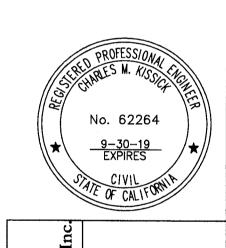

E: 8-10-18

WN BY: CMK

CKED BY: AZG

SIGMA PRIME GEOSCIENCES, INC

332 PRINCETON AVENUE

HALF MOON BAY, CA 94019


DATE: 6-20-19


(650) 728-3593

FAX 728-3593

ROSION, SEDIMENT
ONTROL, AND TREE
PROTECTION PLAN
ICWHERTER PROPERTY,
1237 GRANT RD.

SHEET C-2

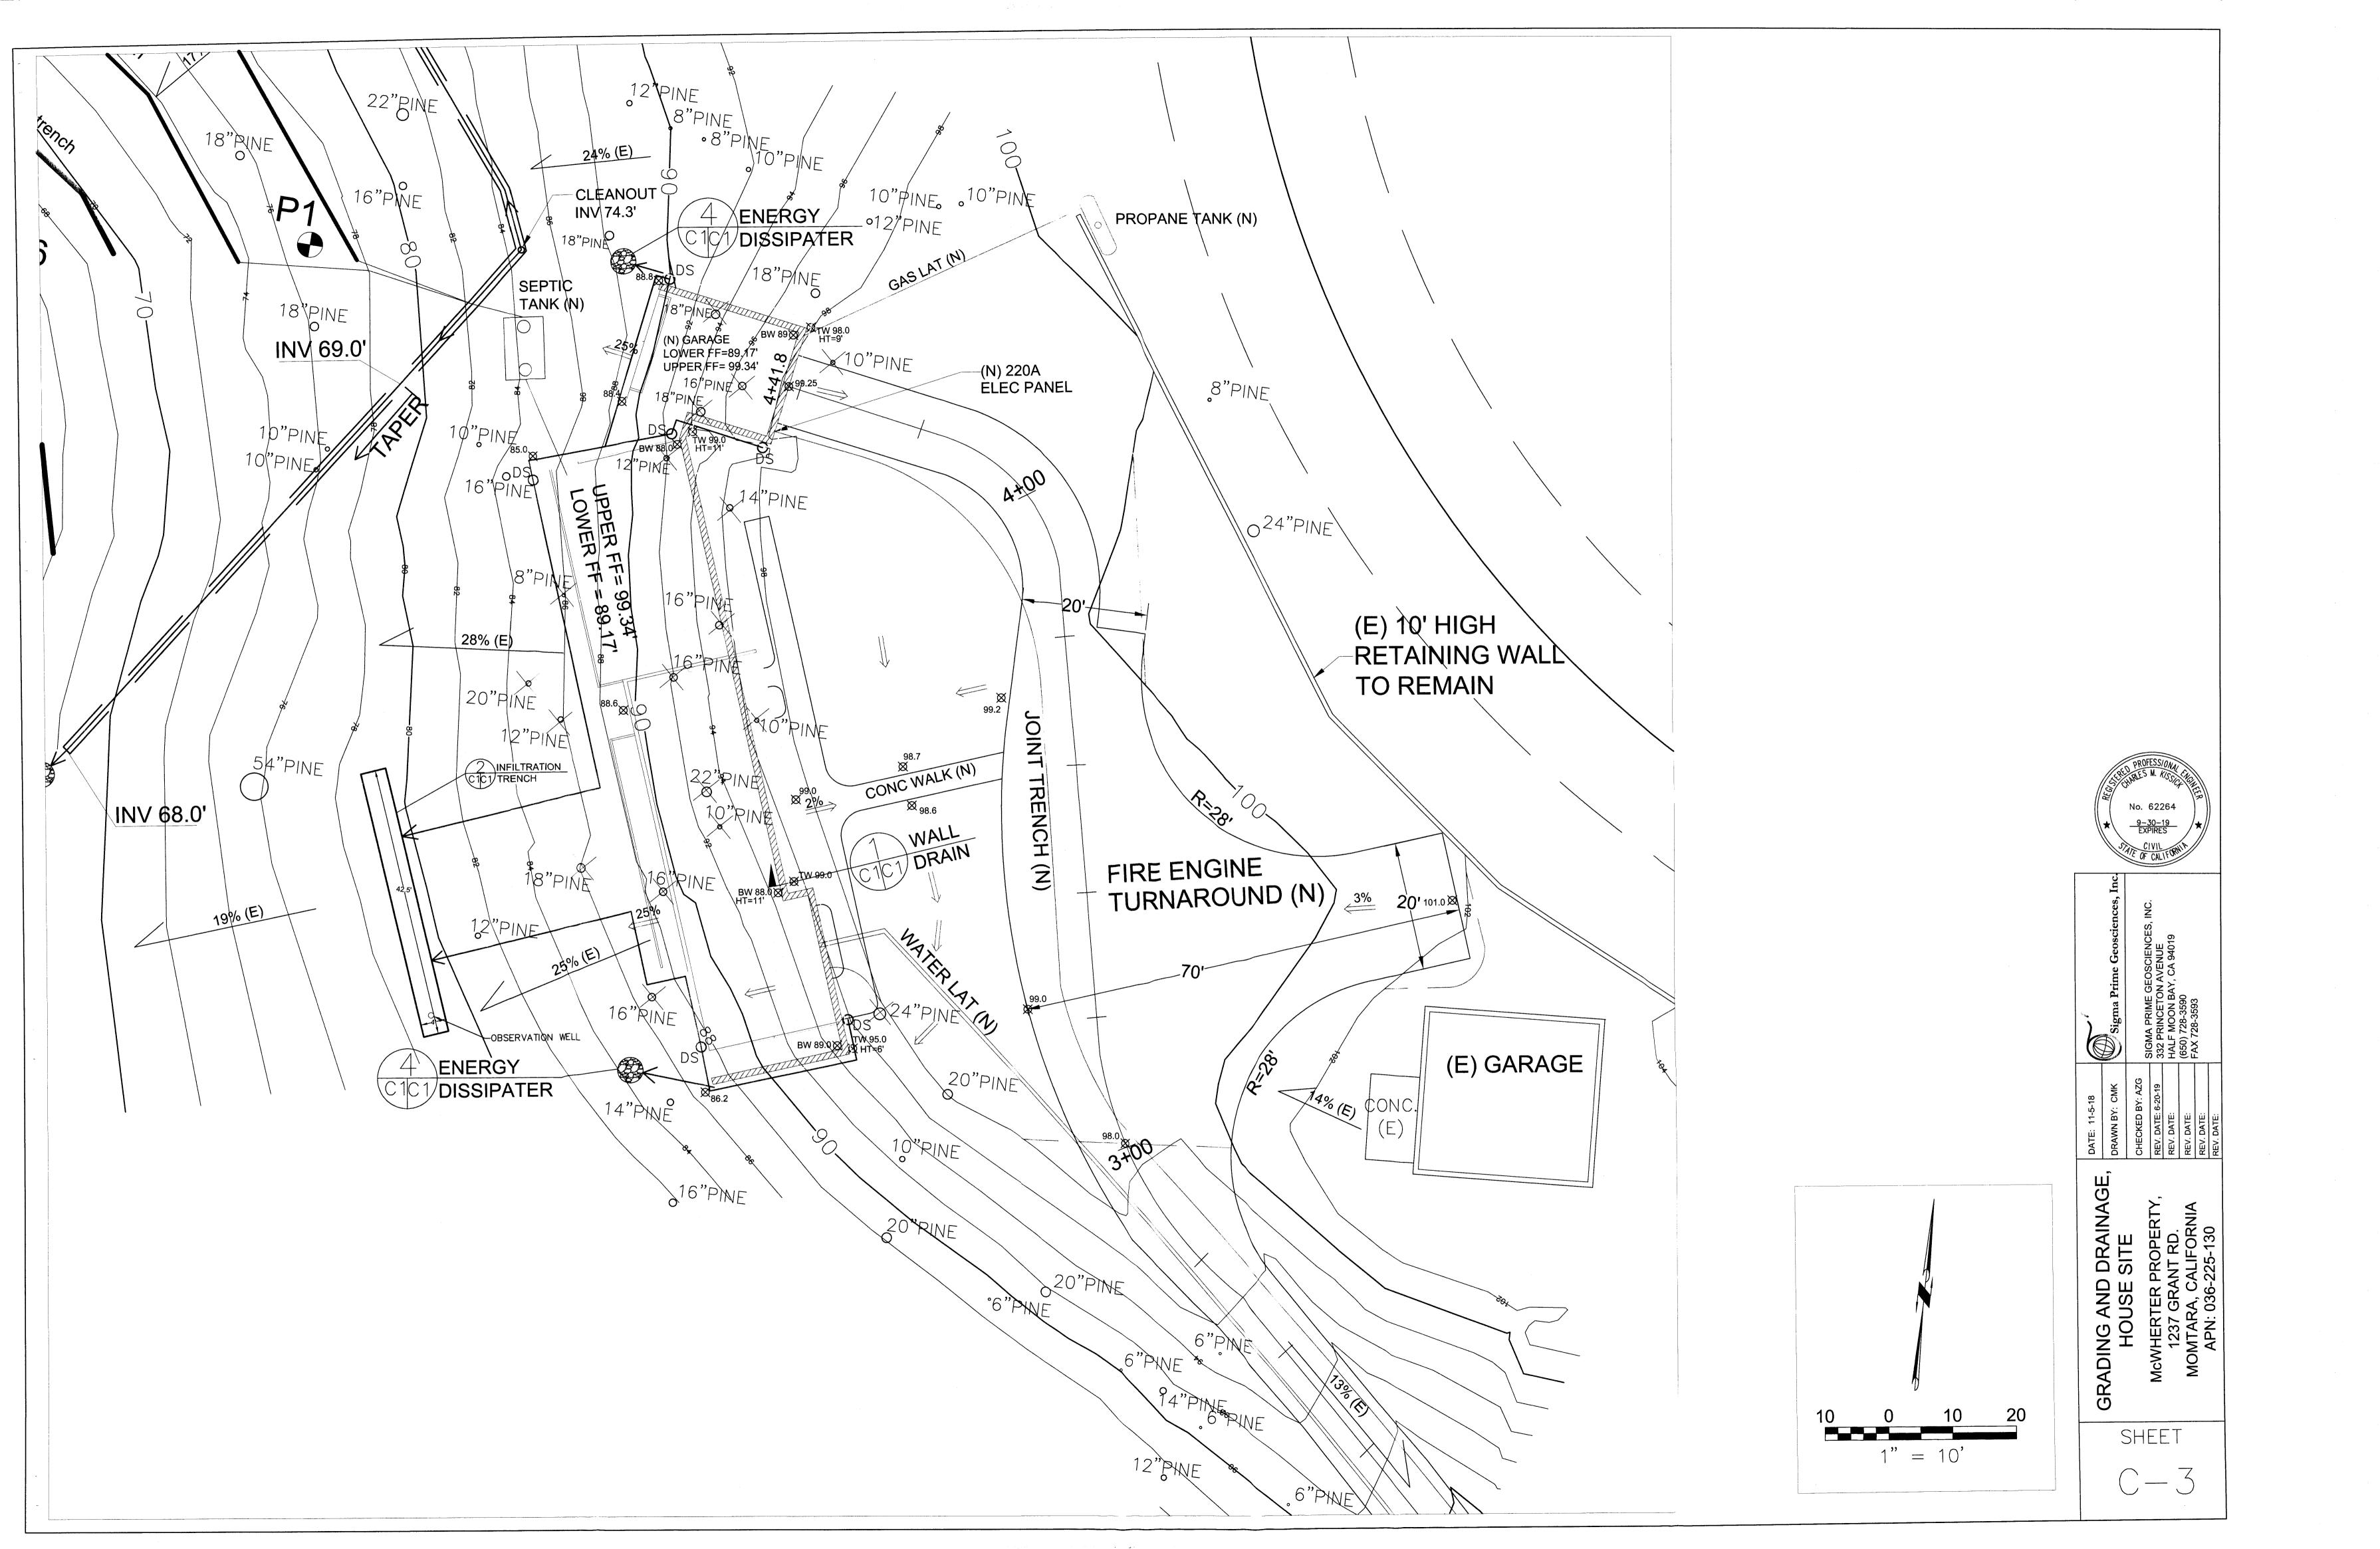

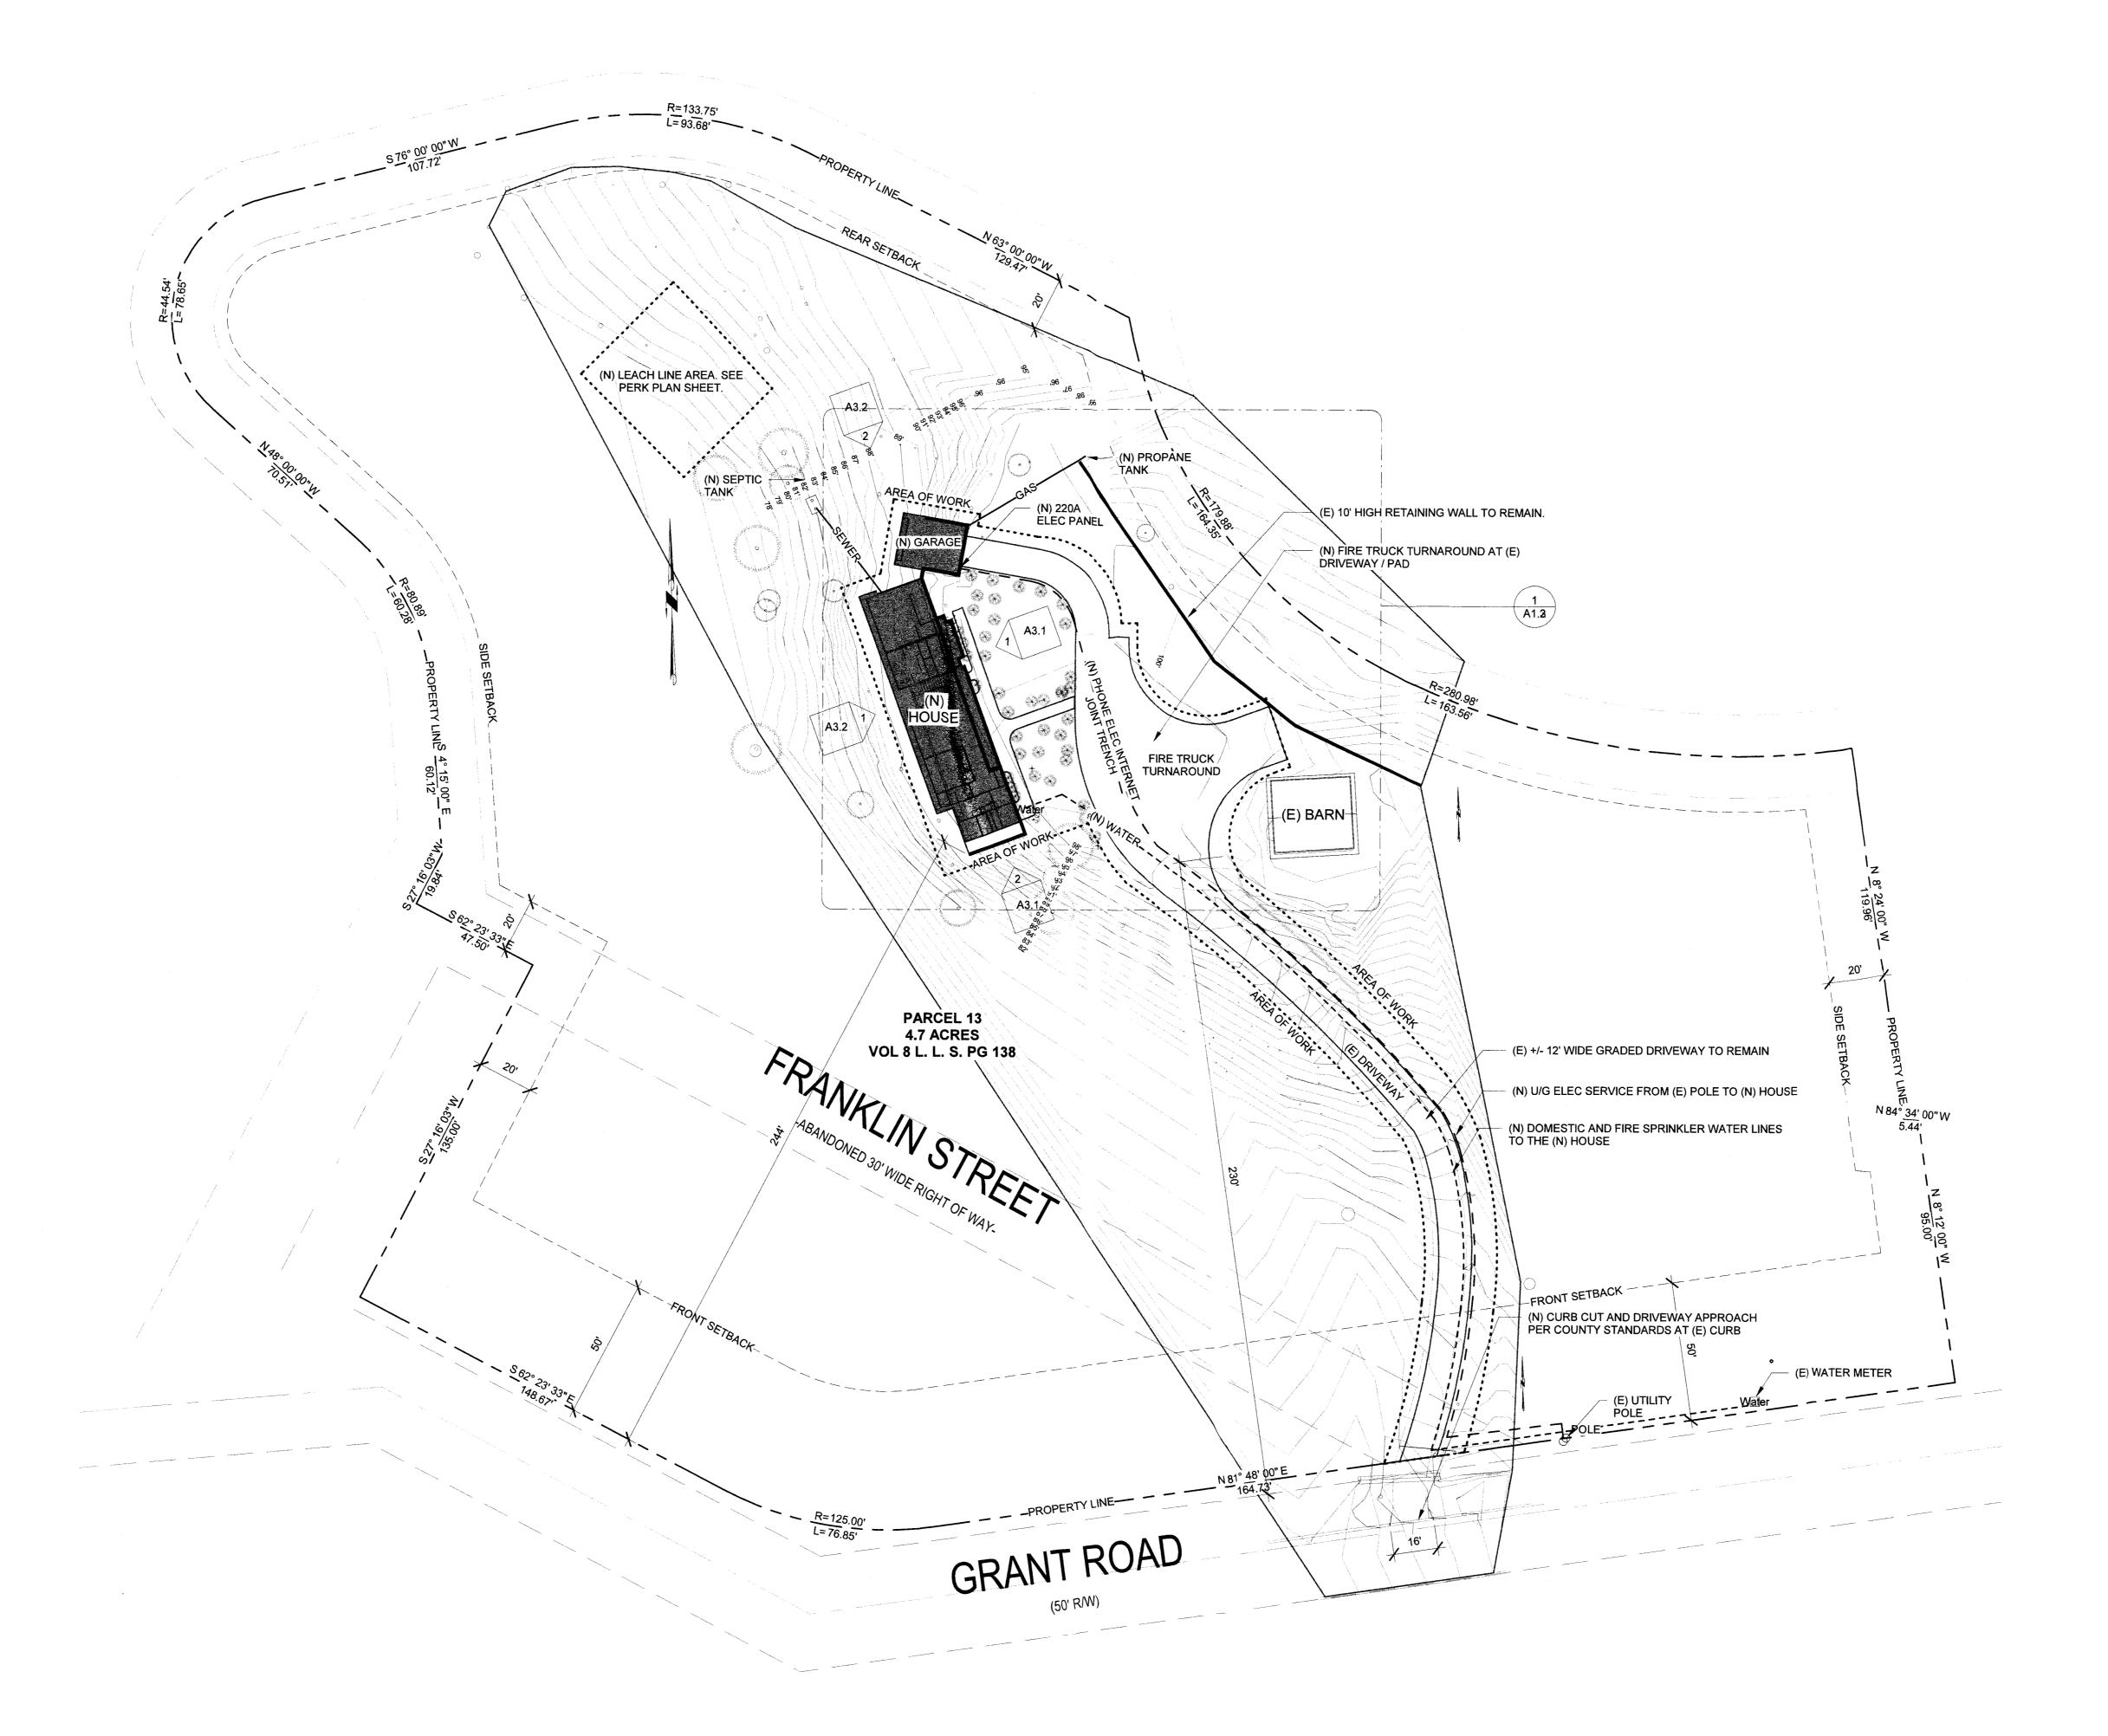


1" = 30'-0"

SLE FAMILY HOME		~	04/10/2018	PRE APPLICATION MEETING	
I EK KESIDENCE		2	08/16/2018	PLANNING SUBMITTAL	
.SS:	PROJECT SCOPE:	က	11/14/2018	PLANNING RESUBMITTAL	
N ROAD	HOME WITH (N) ATTACHED	4	03/07/2019	2ND PLANNING RESUBMITTAL	
4, CA 94037	GARAGE	2	06/20/2019	3RD PLANNING RESUBMITTAL	

SHEET TITLE

OVERALL SITE PLAN

SHEET

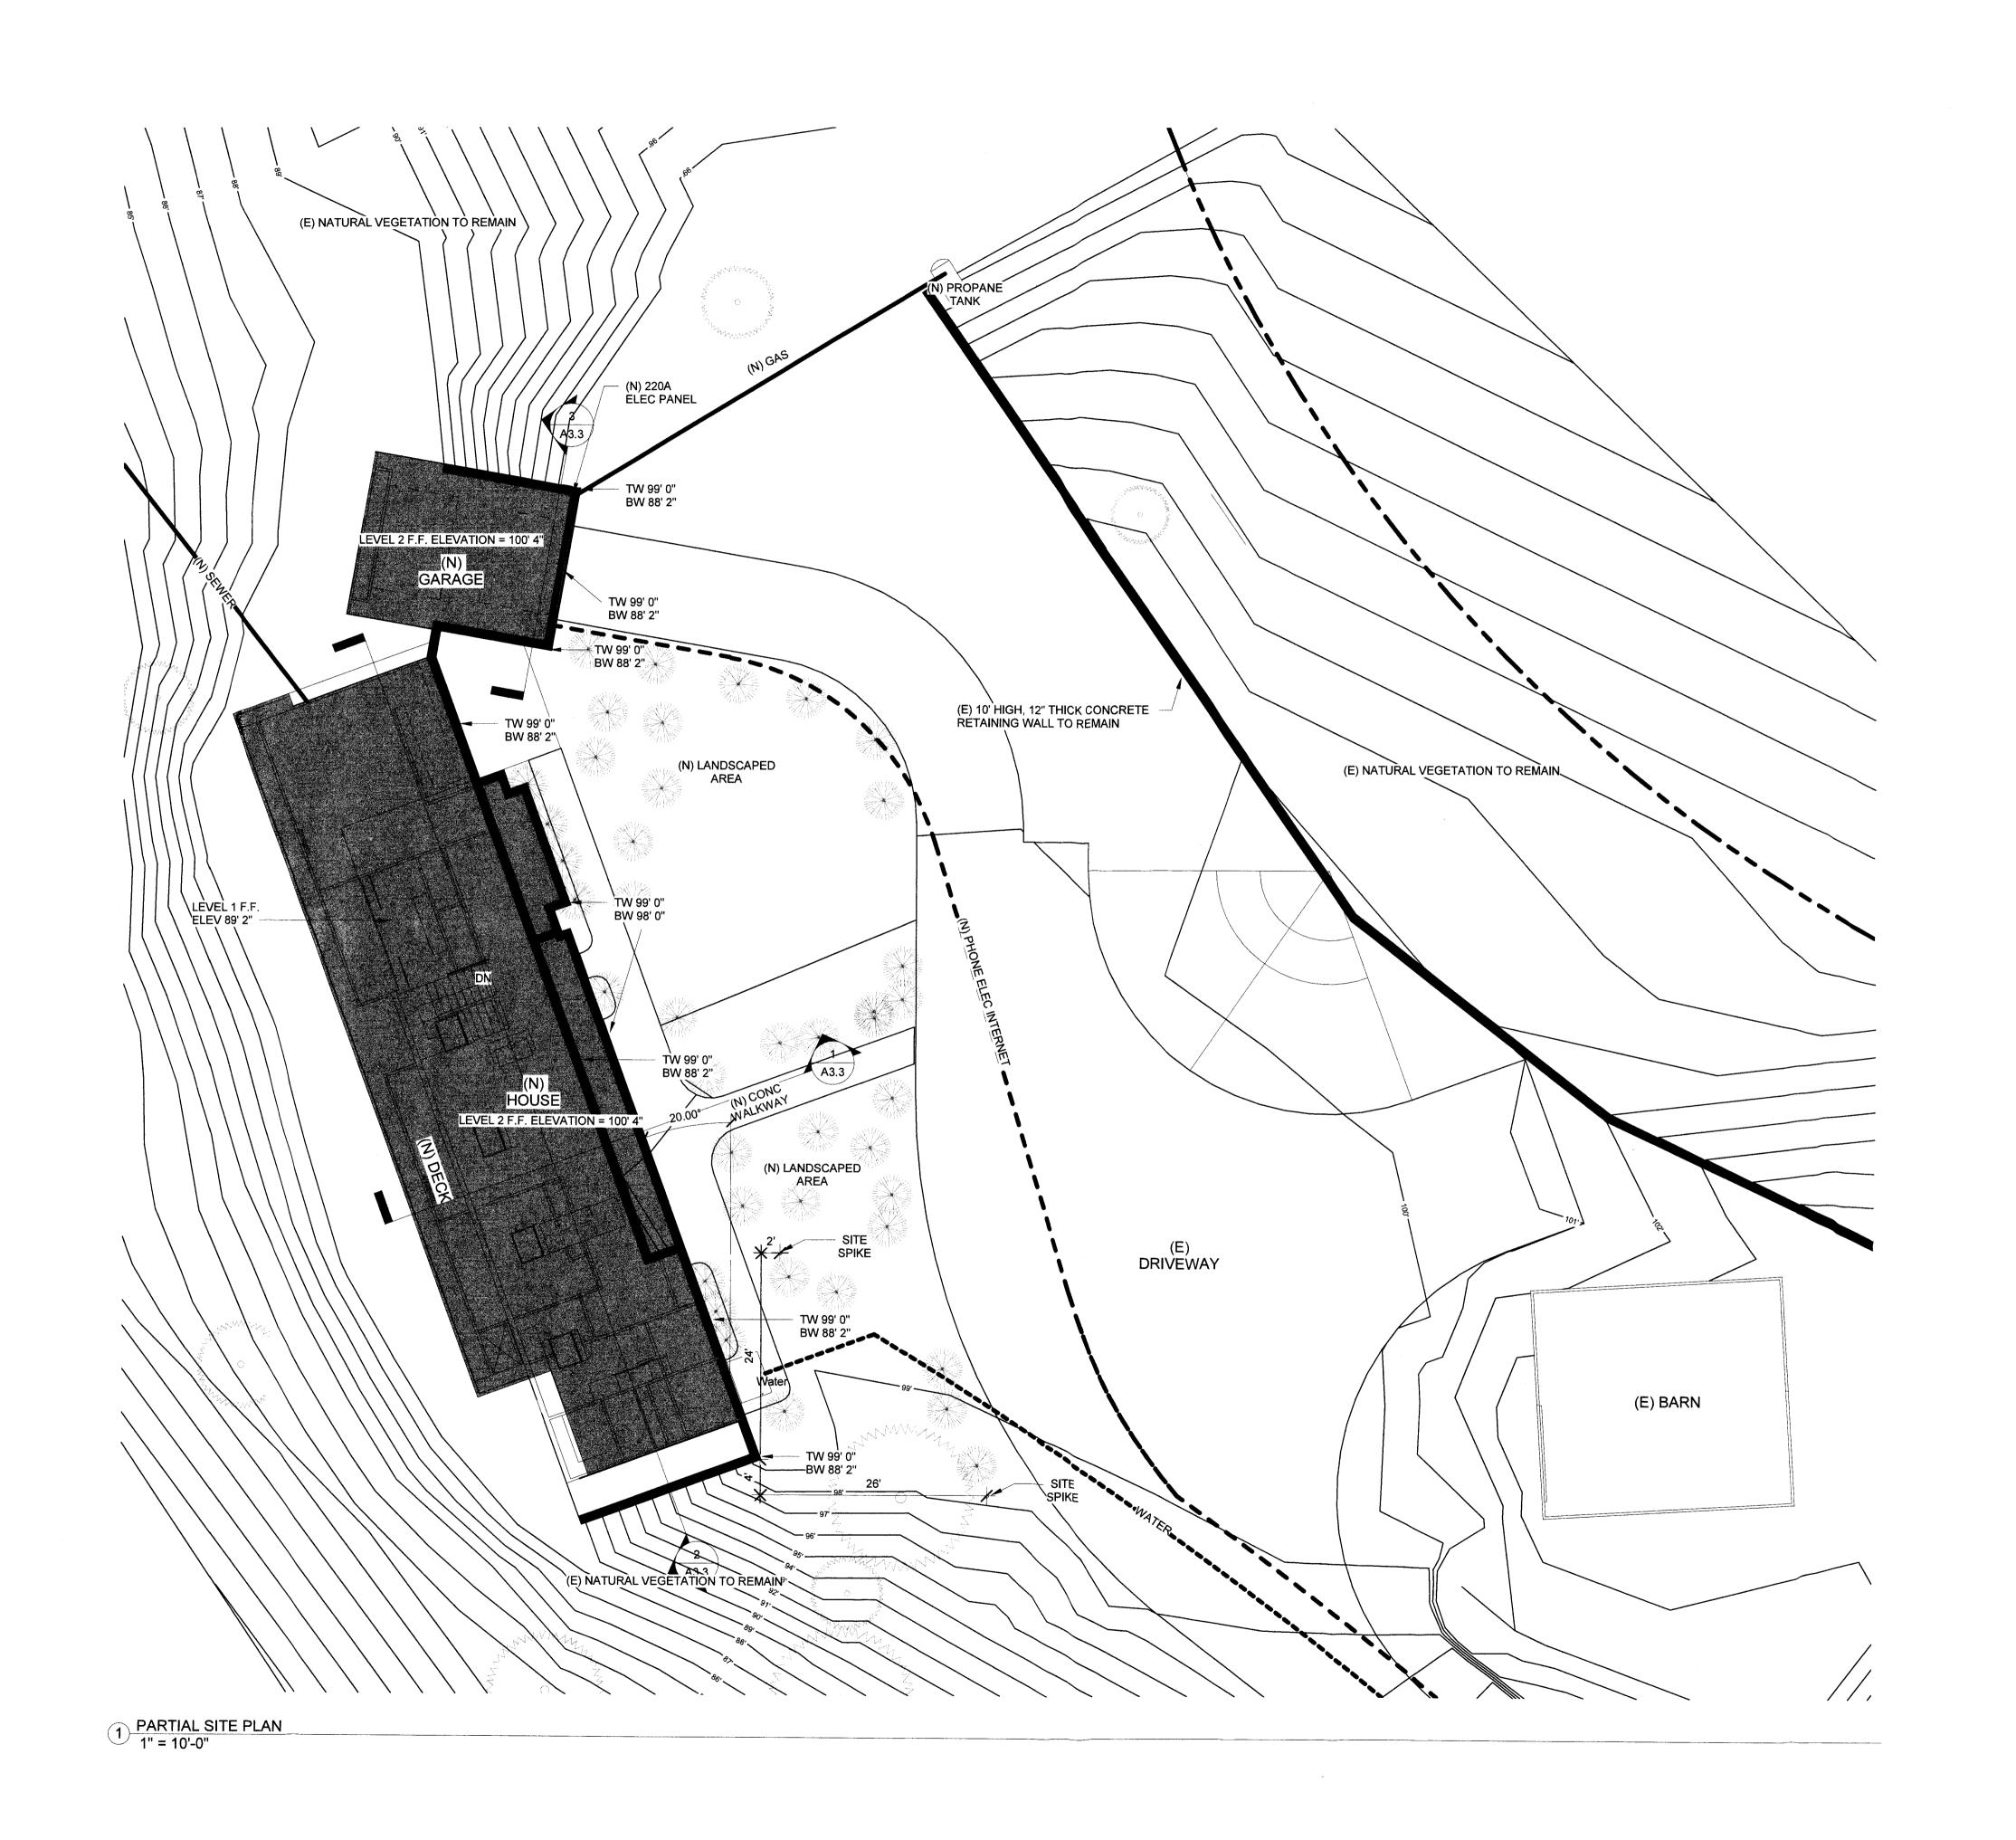




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DESCRIPTION	PRE APPLICATION MEETING	PLANNING SUBMITTAL	PLANNING RESUBMITTAL	2ND PLANNING RESUBMITTAL	3RD PLANNING RESUBMITTAL	
DATE	04/10/2018	2 08/16/2018	11/14/2018	03/07/2019	06/20/2019	
REV	1	2	3	4	5	
			PROJECT SCOPE: (N) TWO STORY SINGLE FAI	HOME WITH (N) ATTACHED	BOANAGE (
	NEW SINGLE FAMILY HOME	MOWNER IER RESIDENCE	PROJECT ADDRESS:	7	MONTARA, CA 34057	
	ET TI		LS	ITE		
	7717	- 1/T	<u> </u>		l l	

PARTIAL SITE PLAN

SHEET

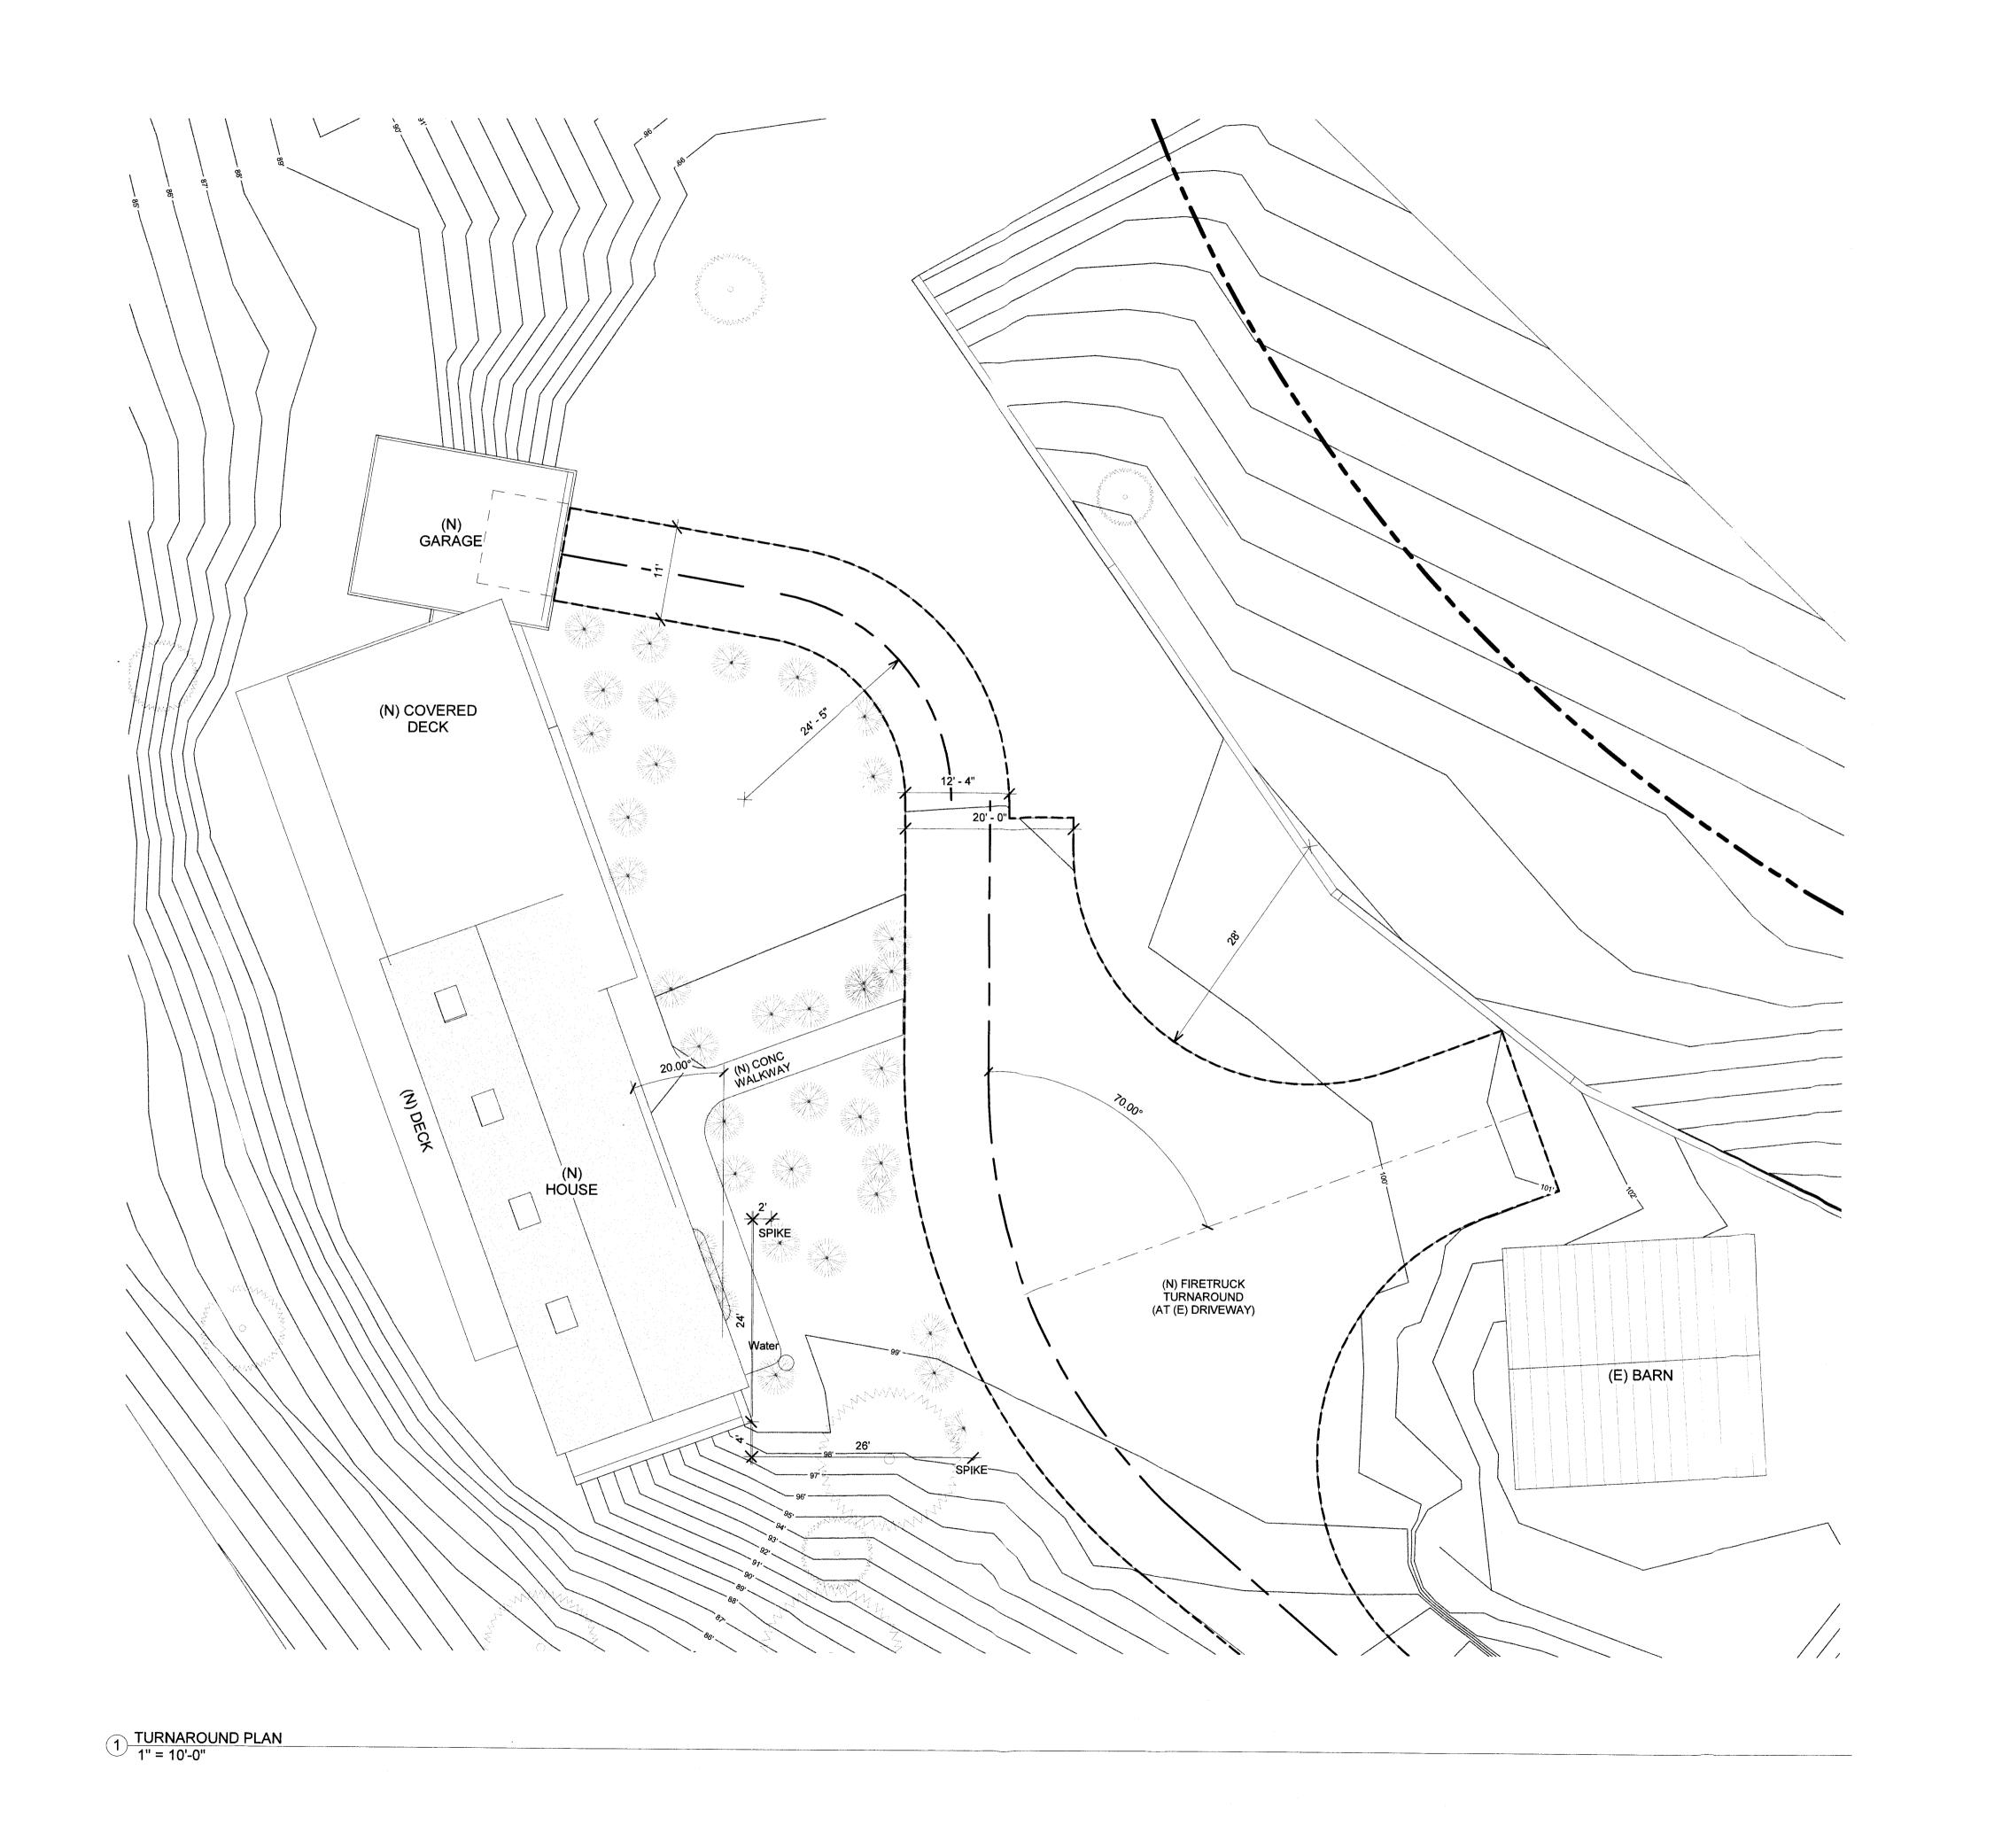

Tailand Mare

PRE APPLICATION MEETING	PLANNING SUBMITTAL	PLANNING RESUBMITTAL	2ND PLANNING RESUBMITTAL	3RD PLANNING RESUBMITTAL
04/10/2018	08/16/2018	11/14/2018	03/07/2019	06/20/2019
1	2	3	4	5
		PROJECT SCOPE: (N) TWO STORY SINGLE FA	HOME WITH (N) ATTACHED	
W SINGLE FAMILY HOME			CAL GRANI ROAD	MONTARA, CA 84057
	Σ	PRG 6		∑ │
	1 04/10/2018	FAMILY HOME 1 04/10/2018 RESIDENCE 2 08/16/2018	TER RESIDENCE PROJECT SCOPE: 3 11/14/2018 N) TWO STORY SINGLE FAMILY 3 11/14/2018	LE FAMILY HOIME

SHEET

A1.3

PLAN



-		Phase	
Mark	Туре	Created	Phase Demolished
	22" Pine	Existing	None
1	18" Pine	Existing	None
2	22" Pine	Existing	None
3	16" Pine	Existing	None
4	18" Pine	Existing	None
5	12" Pine	Existing	New Construction
6	8" Pine	Existing	New Construction
7	8" Pine	Existing	New Construction
8	10" Pine	Existing	New Construction
9	12" Pine	Existing	New Construction
10	10" Pine	Existing	None
11	18" Pine	Existing	New Construction
12	10" Pine	Existing	New Construction
13	18" Pine	Existing	New Construction
14	18" Pine	Existing	New Construction
15	16" Pine	Existing	New Construction
16	18" Pine	Existing	New Construction
17	12" Pine	Existing	New Construction
18	14" Pine	Existing	New Construction
19	10" Pine	Existing	None
20	16" Pine	Existing	New Construction
21	10" Pine	Existing	None
22	10" Pine	Existing	None
23	8" Pine	Existing	New Construction
24	16" Pine	Existing	New Construction
25	16" Pine	Existing	New Construction
26	10" Pine	Existing	New Construction
27	20" Pine	Existing	New Construction
28	12" Pine	Existing	New Construction
29	22" Pine	Existing	New Construction
30	10" Pine	Existing	New Construction
31	16" Pine	Existing	New Construction
32	18" Pine	Existing	New Construction
33	12" Pine	Existing	None
34	16" Pine	Existing	New Construction
35	24" Pine	Existing	New Construction
36	20" Pine	Existing	None
37	14" Pine	Existing	New Construction
38	10" Pine	Existing	None
39	16" Pine	Existing	None
40	20" Pine	Existing	None
41	8" Pine	Existing	None
42	24" Pine	Existing	New Construction

SYMBOL BOTANICAL NAME COMMON NAME PLANT TYPE NATIVE A (not used) B (not used) C CEANOTHUS 'DARK STAR' CALIFORNIA LILAC SHRUB X D LUPINUS ALBIFRONS SILVER BUSH LUPINE SHRUB X E ARCTOSTAPHYLOS DENSIFLORA 'SUNSET' SUNSET MANZANITA SHRUB X F ERICAMERIA ERICOIDES CALIFORNIA GOLDENBUSH SHRUB X G GALVEZIA SPECIOSA ISLAND BUSH SNAPDRAGON SHRUB X H SALVIA CLEVELANDI CLEVELANDI GLEYELAND'S SAGE SHRUB X I MISCANTHUS SINENSIS 'MORNING LIGHT' MORNING LIGHT MAIDEN GRASS GRASS J CHONDROPETALUM TECTORUM SMALL CAPE RUSH GRASS K SALVIA CHAMAEDRYOIDES 'BEE'S BLISS' SAGE PERENNIAL X L IRIS DOUGLASIANA 'CANYON SNOW CANYON SNOW IRIS PERENNIAL X M ARABIS BLEPHAROPHYLIA COAST ROCK CRESS PERENNIAL X				Τ	PLANT LIS	_	
B (not used) C CEANOTHUS 'DARK STAR' CALIFORNIA LILAC SHRUB X D LUPINUS ALBIFRONS SILVER BUSH LUPINE SHRUB X E ARCTOSTAPHYLOS DENSIFLORA 'SUNSET' SUNSET MANZANITA SHRUB X F ERICAMERIA ERICOIDES CALIFORNIA GOLDENBUSH SHRUB X G GALVEZIA SPECIOSA ISLAND BUSH SNAPDRAGON SHRUB X H SALVIA CLEVELANDII CLEVELAND'S SAGE SHRUB X I MISCANTHUS SINENSIS 'MORNING LIGHT' MORNING LIGHT MAIDEN GRASS GRASS J CHONDROPETALUM TECTORUM SMALL CAPE RUSH GRASS K SALVIA CHAMAEDRYOIDES 'BEE'S BLISS' SAGE PERENNIAL X L IRIS DOUGLASIANA 'CANYON SNOW CANYON SNOW IRIS PERENNIAL X		DROUGHT TOLERANT?	NATIVE?	PLANT TYPE	COMMON NAME	BOTANICAL NAME	SYMBOL
C CEANOTHUS 'DARK STAR' CALIFORNIA LILAC SHRUB X D LUPINUS ALBIFRONS SILVER BUSH LUPINE SHRUB X E ARCTOSTAPHYLOS DENSIFLORA 'SUNSET' SUNSET MANZANITA SHRUB X F ERICAMERIA ERICOIDES CALIFORNIA GOLDENBUSH SHRUB X G GALVEZIA SPECIOSA ISLAND BUSH SNAPDRAGON SHRUB X H SALVIA CLEVELANDII CLEVELAND'S SAGE SHRUB X I MISCANTHUS SINENSIS 'MORNING LIGHT' MORNING LIGHT MAIDEN GRASS GRASS J CHONDROPETALUM TECTORUM SMALL CAPE RUSH GRASS K SALVIA CHAMAEDRYOIDES 'BEE'S BLISS' SAGE PERENNIAL X L IRIS DOUGLASIANA 'CANYON SNOW CANYON SNOW IRIS PERENNIAL X						(not used)	Α
D LUPINUS ALBIFRONS SILVER BUSH LUPINE SHRUB X E ARCTOSTAPHYLOS DENSIFLORA 'SUNSET' SUNSET MANZANITA SHRUB X F ERICAMERIA ERICOIDES CALIFORNIA GOLDENBUSH SHRUB X G GALVEZIA SPECIOSA ISLAND BUSH SNAPDRAGON SHRUB X H SALVIA CLEVELANDII CLEVELANDIS SAGE SHRUB X I MISCANTHUS SINENSIS 'MORNING LIGHT' MORNING LIGHT MAIDEN GRASS GRASS J CHONDROPETALUM TECTORUM SMALL CAPE RUSH GRASS K SALVIA CHAMAEDRYOIDES 'BEE'S BLISS' SAGE PERENNIAL X L IRIS DOUGLASIANA 'CANYON SNOW CANYON SNOW IRIS PERENNIAL X						(not used)	В
E ARCTOSTAPHYLOS DENSIFLORA 'SUNSET SUNSET MANZANÍTA SHRUB X F ERICAMERIA ERICOIDES CALIFORNÍA GOLDENBUSH SHRUB X G GALVEZIA SPECIOSA ISLAND BUSH SNAPDRAGON SHRUB X H SALVIA CLEVELANDI CLEVELANDI SAGE SHRUB X I MISCANTHUS SINENSIS 'MORNING LIGHT MORNING LIGHT MAIDEN GRASS GRASS J CHONDROPETALUM TECTORUM SMALL CAPE RUSH GRASS K SALVIA CHAMAEDRYOIDES 'BEE'S BLISS' SAGE PERENNIAL X L IRIS DOUGLASIANA 'CANYON SNOW CANYON SNOW IRIS PERENNIAL X	BAY NATIVES none	х	х	SHRUB	CALIFORNIA LILAC	CEANOTHUS 'DARK STAR'	С
F ERICAMERIA ERICOIDES CALIFORNIA GOLDENBUSH SHRUB X G GALVEZIA SPECIOSA ISLAND BUSH SNAPDRAGON SHRUB X H SALVIA CLEVELANDII CLEVELAND'S SAGE SHRUB X I MISCANTHUS SINENSIS 'MORNING LIGHT' MORNING LIGHT MAIDEN GRASS GRASS J CHONDROPETALUM TECTORUM SMALL CAPE RUSH GRASS K SALVIA CHAMAEDRYOIDES 'BEE'S BLISS' SAGE PERENNIAL X L IRIS DOUGLASIANA 'CANYON SNOW CANYON SNOW IRIS PERENNIAL X	SUNSET none	х	,X	SHRUB	SILVER BUSH LUPINE	LUPINUS ALBIFRONS	D
G GALVEZIA SPECIOSA ISLAND BUSH SNAPDRAGON SHRUB X H SALVIA CLEVELANDI CLEVELANDI CLEVELAND'S SAGE SHRUB X I MISCANTHUS SINENSIS 'MORNING LIGHT MORNING LIGHT MAIDEN GRASS GRASS J CHONDROPETALUM TECTORUM SMALL CAPE RUSH GRASS K SALVIA CHAMAEDRYOIDES 'BEE'S BLISS' SAGE PERENNIAL X L IRIS DOUGLASIANA 'CANYON SNOW CANYON SNOW IRIS PERENNIAL X	BAY NATIVES none	х	х	SHRUB	SUNSET MANZANITA	ARCTOSTAPHYLOS DENSIFLORA 'SUNSET'	E
H SALVIA CLEVELANDI CLEVELANDI SAGE SHRUB X I MISCANTHUS SINENSIS 'MORNING LIGHT MORNING LIGHT MAIDEN GRASS GRASS J CHONDROPETALUM TECTORUM SMALL CAPE RUSH GRASS K SALVIA CHAMAEDRYOIDES 'BEE'S BLISS' SAGE PERENNIAL X L IRIS DOUGLASIANA 'CANYON SNOW CANYON SNOW IRIS PERENNIAL X	SUNSET none	х	х	SHRUB	CALIFORNIA GOLDENBUSH	ERICAMERIA ERICOIDES	F
I MISCANTHUS SINENSIS 'MORNING LIGHT MORNING LIGHT MAIDEN GRASS GRASS J CHONDROPETALUM TECTORUM SMALL CAPE RUSH GRASS K SALVIA CHAMAEDRYOIDES 'BEE'S BLISS' SAGE PERENNIAL X L IRIS DOUGLASIANA 'CANYON SNOW CANYON SNOW IRIS PERENNIAL X	SUNSET non	х	х	SHRUB	ISLAND BUSH SNAPDRAGON	GALVEZIA SPECIOSA	G
J CHONDROPETALUM TECTORUM SMALL CAPE RUSH GRASS K SALVIA CHAMAEDRYOIDES 'BEE'S BLISS' SAGE PERENNIAL X L IRIS DOUGLASIANA 'CANYON SNOW CANYON SNOW IRIS PERENNIAL X	BAY NATIVES non	х	х	SHRUB	CLEVELAND'S SAGE	SALVIA CLEVELANDII	н
K SALVIA CHAMAEDRYOIDES 'BEE'S BLISS' SAGE PERENNIAL X L IRIS DOUGLASIANA 'CANYON SNOW CANYON SNOW IRIS PERENNIAL X	SAN MARCOS non	х		GRASS	MORNING LIGHT MAIDEN GRASS	MISCANTHUS SINENSIS MORNING LIGHT	ı
L IRIS DOUGLASIANA 'CANYON SNOW CANYON SNOW IRIS PERENNIAL X	SAN MARCOS GROWERS non	х		GRASS	SMALL CAPE RUSH	CHONDROPETALUM TECTORUM	J
	SUNSET non	х	Х	PERENNIAL	'BEE'S BLISS' SAGE	SALVIA CHAMAEDRYOIDES	к
M ARABIS BLEPHAROPHYLLA COAST ROCK CRESS PERENNIAL X	SUNSET non	х	х	PERENNIAL	CANYON SNOW IRIS	IRIS DOUGLASIANA CANYON SNOW	L
	SUNSET non	х	х	PERENNIAL	COAST ROCK CRESS	ARABIS BLEPHAROPHYLLA	М
N SOD: FESCUE BLEND FESCUE BLEND SOD X	BAY NATIVES non	х	х	SOD	FESCUE BLEND SOD	SOD: FESCUE BLEND	N
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ME:		REV	DATE	DESCRIPTION
INGLE FAMILY HOME		1	04/10/2018	PRE APPLICATION MEETING
EKIEK KESIDENCE		2	08/16/2018	PLANNING SUBMITTAL
DRESS:	PROJECT SCOPE: (N) TWO STORY SING! E FAMILY	3	11/14/2018	PLANNING RESUBMITTAL
KANI KOAD	HOME WITH (N) ATTACHED	4	03/02/2019	2ND PLANNING RESUBMITTAL
1KA, CA 94031	GARAGE	5	6102/02/90	3RD PLANNING RESUBMITTAL


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SHEET TITLE


TREE AND


LANDSCAPE

PLAN

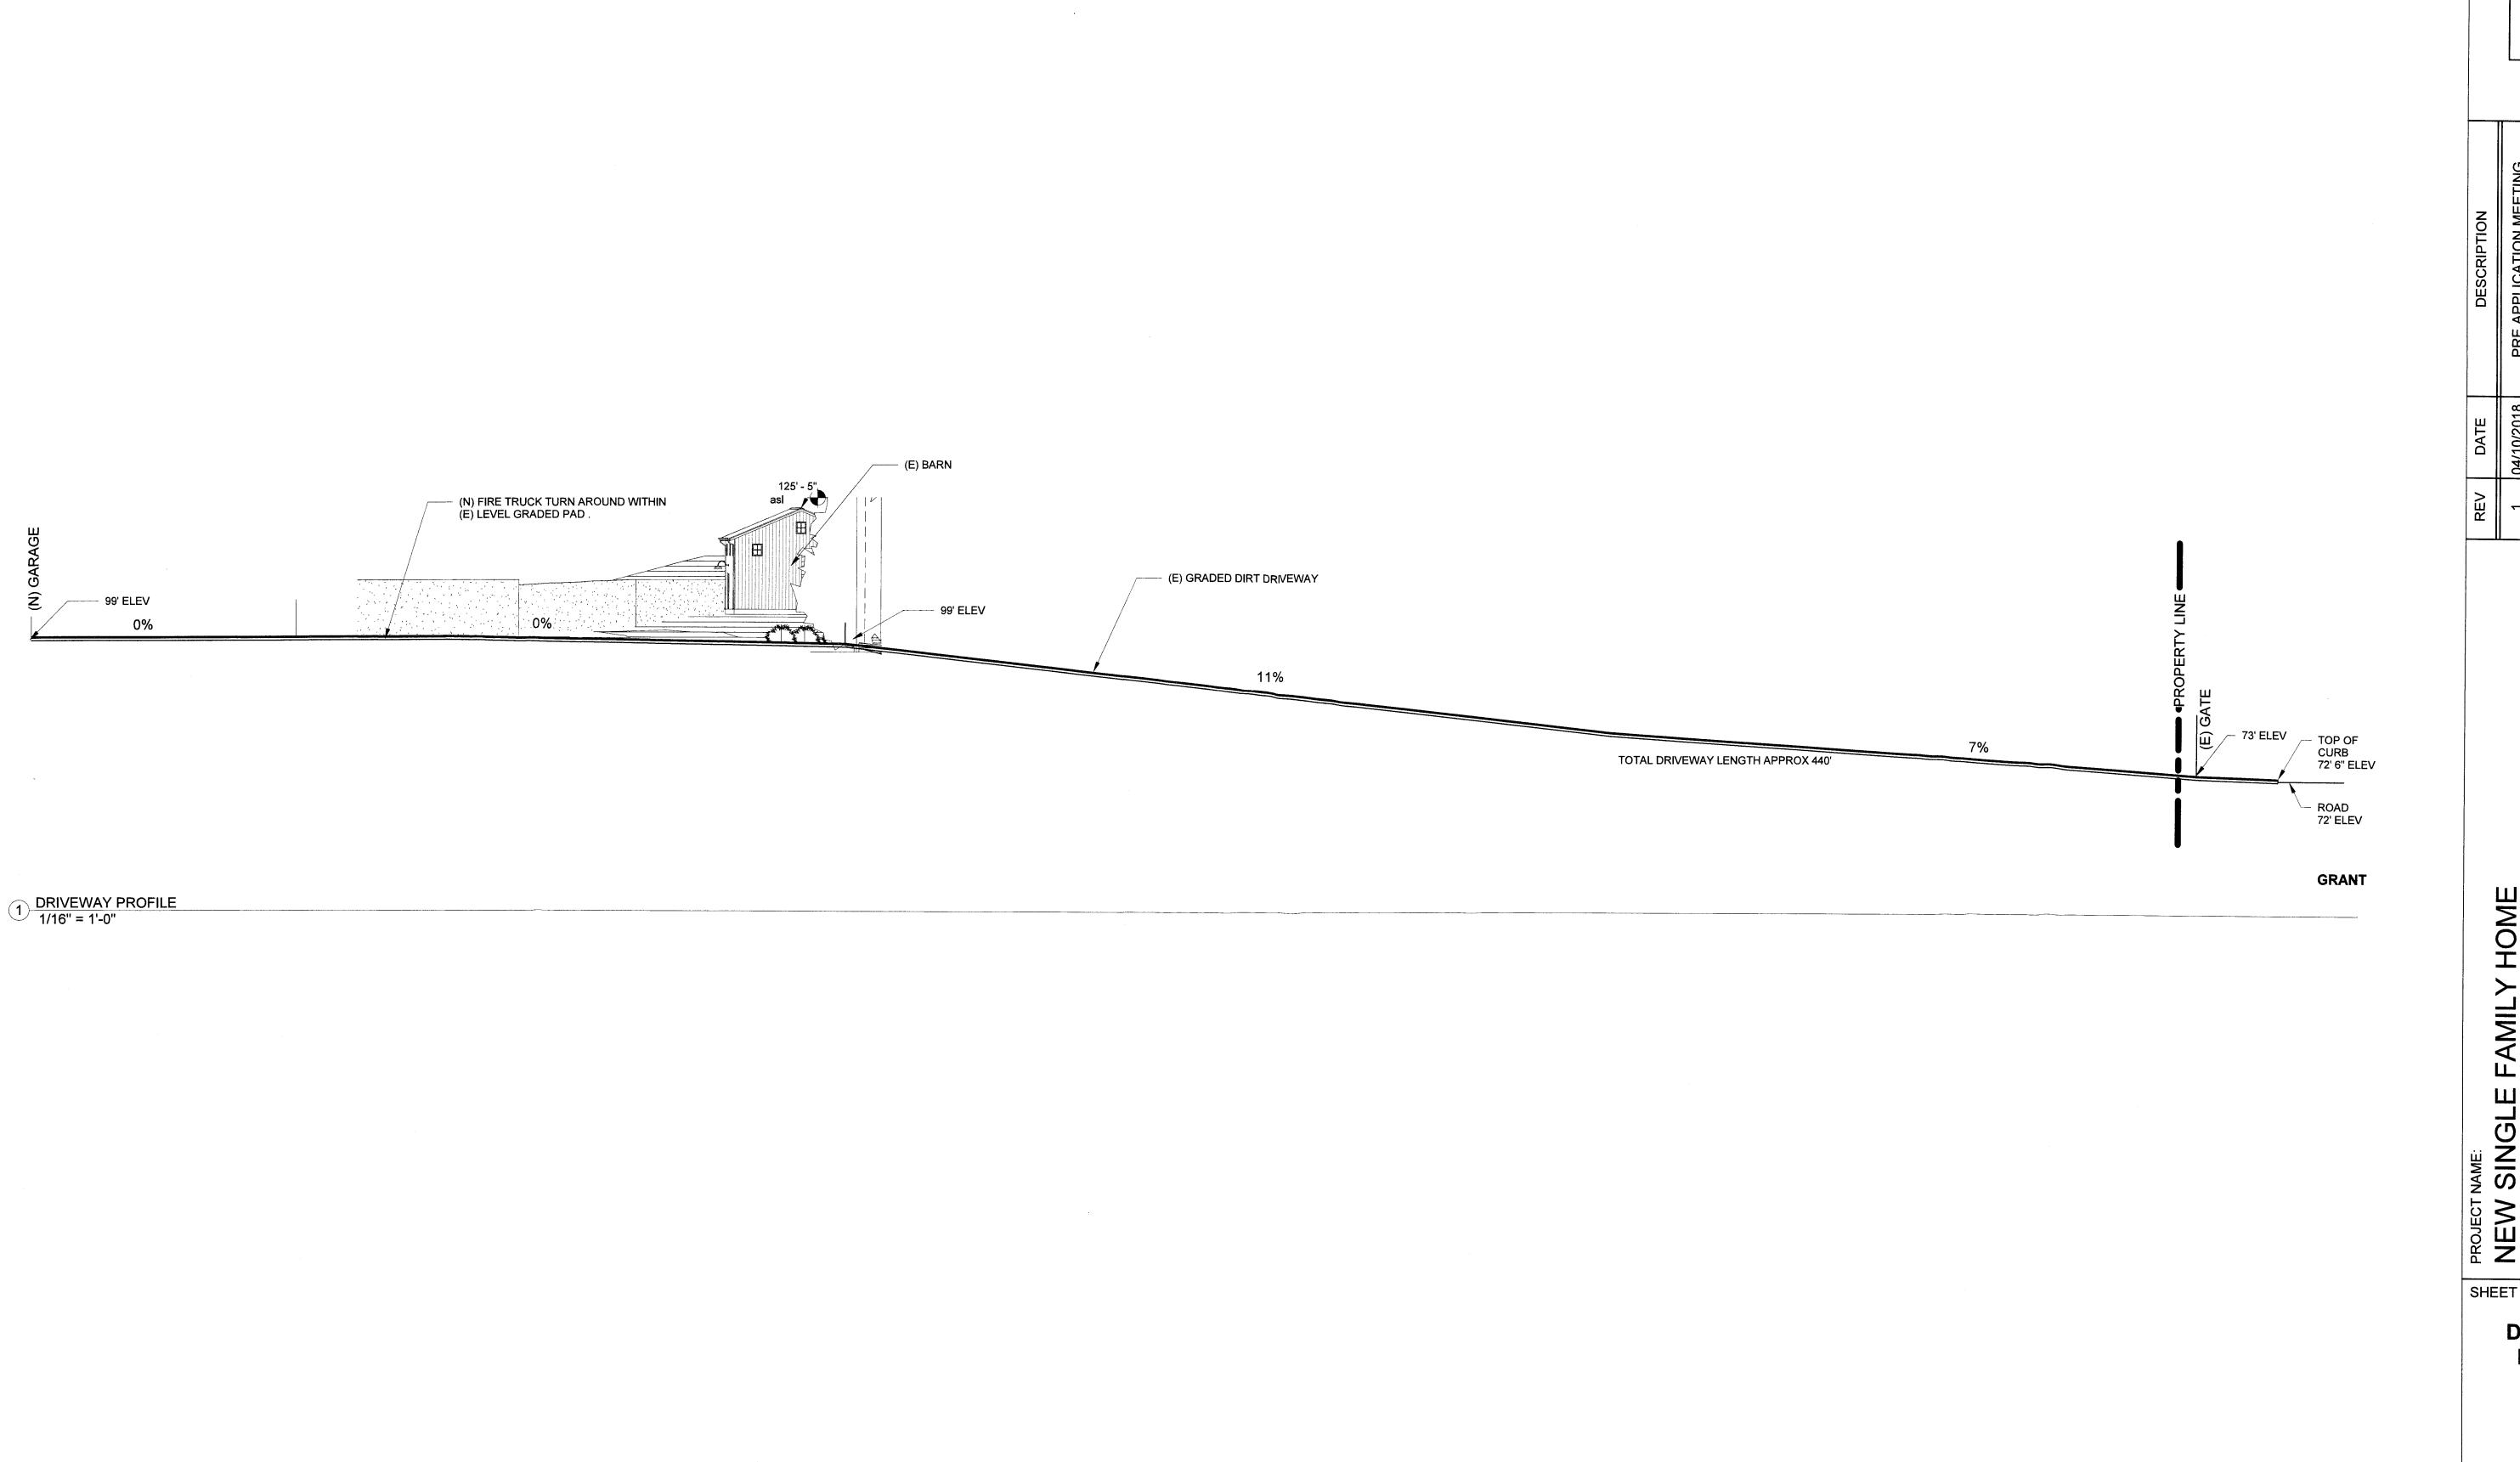


PROJECT SCOPE (N) TWO STOR HOME WITH (N NEW SINGLE FAMILY HOME
MCWHERTER RESIDENCE
PROJECT ADDRESS:
1237 GRANT ROAD
MONTARA, CA 94037 SHEET TITLE DRIVEWAY PROFILE

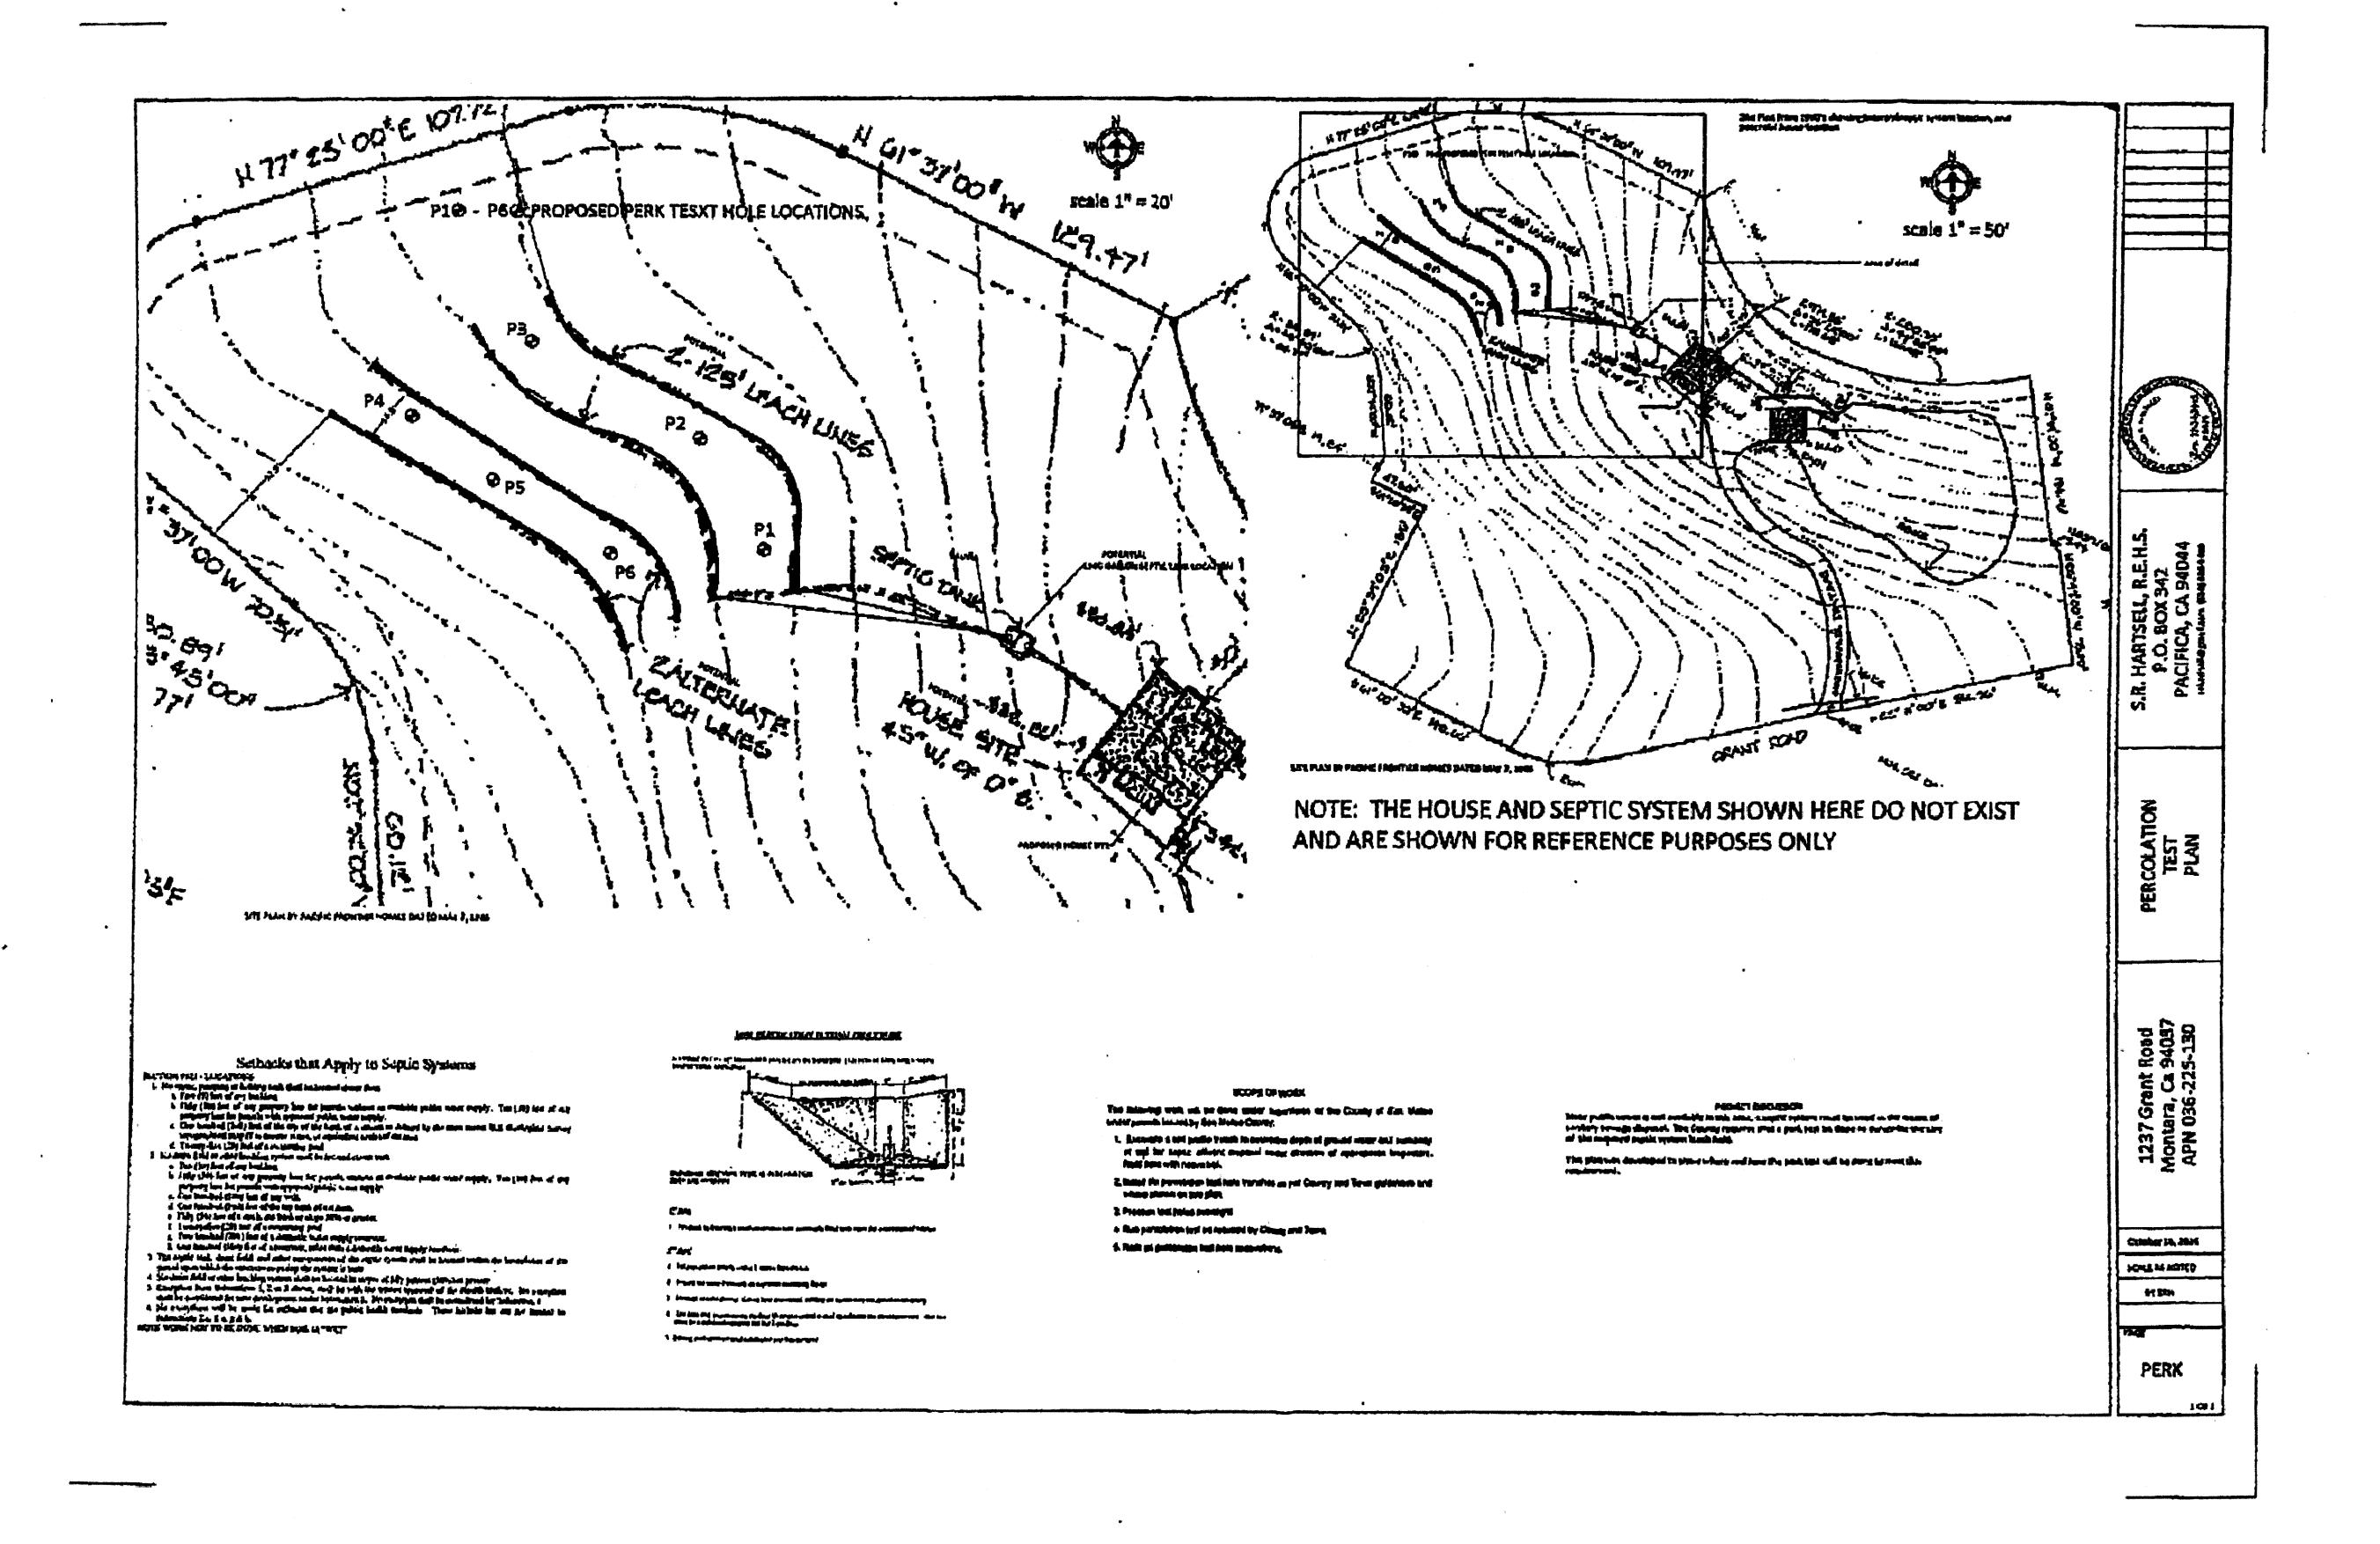


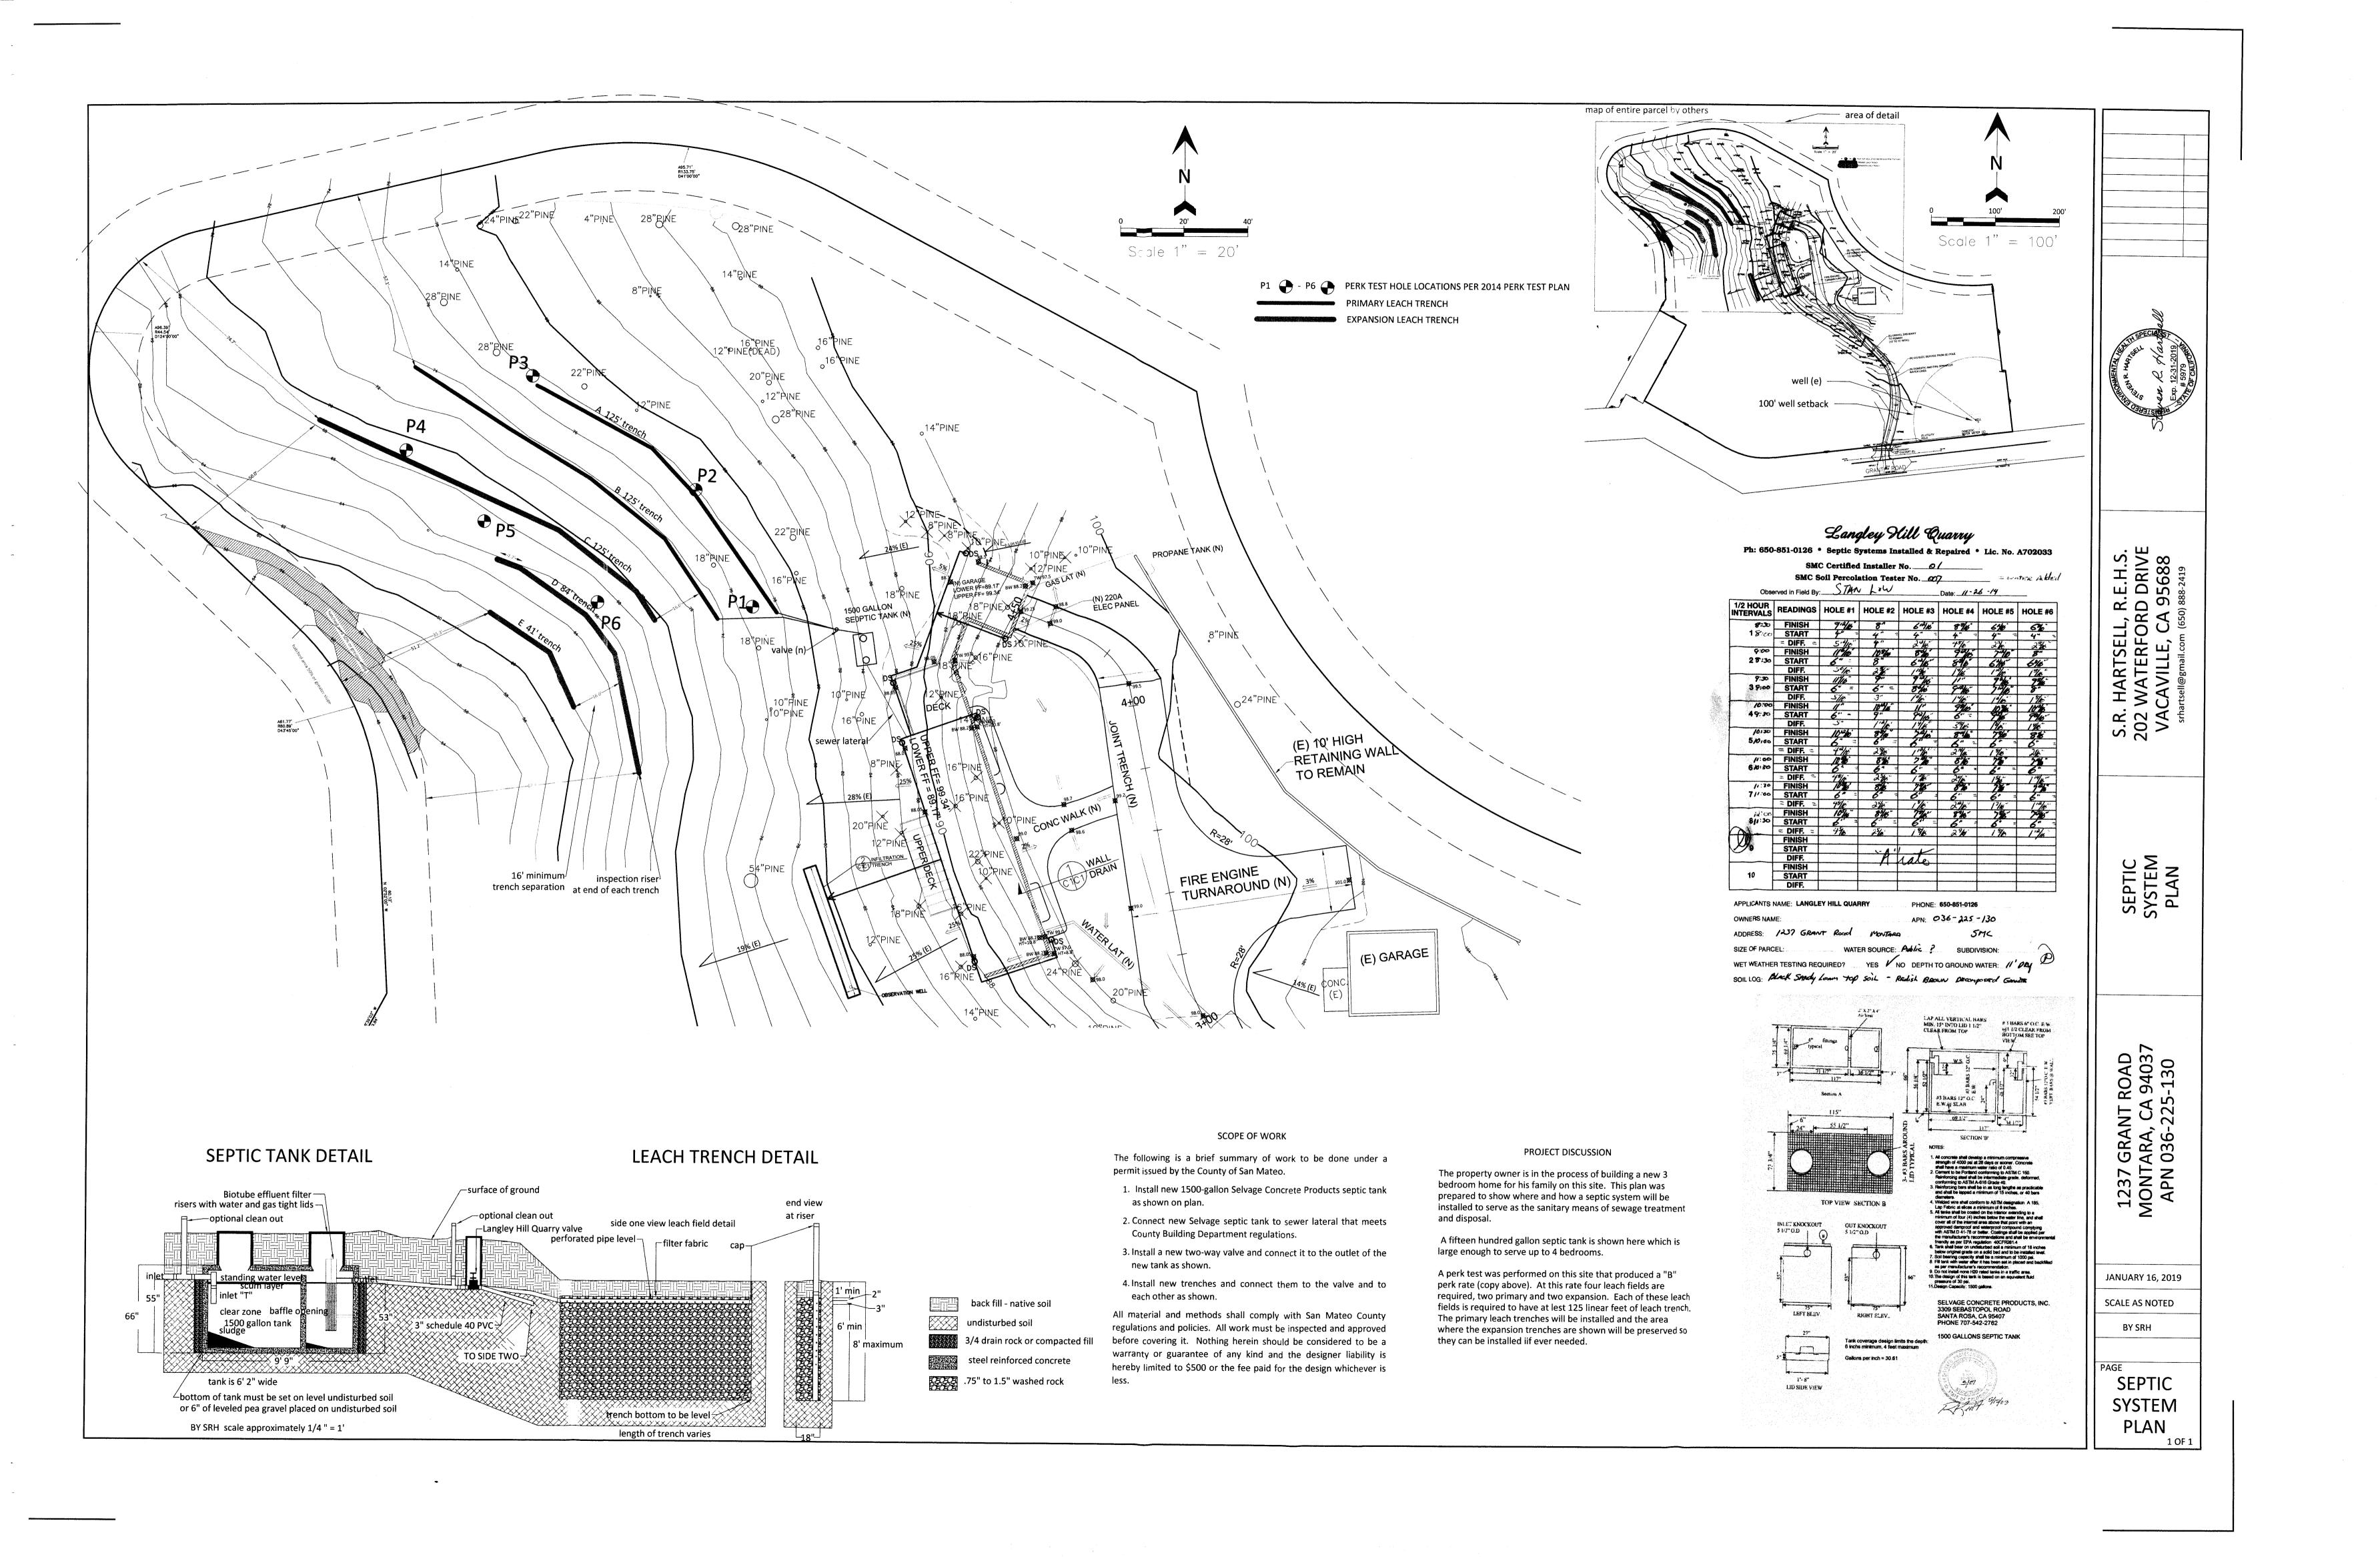

			LEVEL	1 DOOR SCHE	DULE	
Mark	Count	Width	Height	Level	Operation	Comments
D 4		01 011	0, 011		00.015	
D1	1	2' - 8"	8' - 0''	LEVEL 1 F.F.	SINGLE	
D2	1	9' - 0"	8' - 0"	LEVEL 1 F.F.	SLIDING	
D3	1	9' - 0"	8' - 0''	LEVEL 1 F.F.	SLIDING	
D4	1	12' - 0"	8' - 0''	LEVEL 1 F.F.	SLIDING	
D11	1	2' - 6"	7' - 0''	LEVEL 1 F.F.	POCKET	
D12	1	2' - 6"	7' - 0''	LEVEL 1 F.F.	POCKET	
D14	1	6' - 0"	7' - 0''	LEVEL 1 F.F.	FOLDING	
D20	1	6' - 0"	6' - 8"	LEVEL 1 F.F.	FOLDING	
D43	1	12' - 0"	8' - 0''	LEVEL 1 F.F.	OVERHEAD	
D44	1	3' - 0"	8' - 0"	LEVEL 1 F.F.	SINGLE	
D59	1	12' - 0"	8' - 0"	LEVEL 1 F.F.	SLIDING	
D60	1	2' - 6"	7' - 0"	LEVEL 1 F.F.	POCKET	
D61	1	2' - 8"	8' - 0"	LEVEL 1 F.F.	SINGLE	
D65	1	2' - 8"	8' - 0"	LEVEL 1 F.F.	SINGLE	
D66	1	2' - 6"	7' - 0"	LEVEL 1 F.F.	SINGLE	
D67	1	2' - 8"	8' - 0"	LEVEL 1 F.F.	SINGLE	
D68	1	4' - 6"	7' - 0''	LEVEL 1 F.F.	DOUBLE	
D69	1	2' - 8"	8' - 0"	LEVEL 1 F.F.	SINGLE	

				LEVEL	1 WINDO	OW SCHEDULE		
Mark	Count	Width	Height	Sill Height	Head Height	Level	Operation	Comments
W1	1	7' - 0"	10' - 0"	0' - 0"	10' - 0"	LEVEL 1 F.F.	FIXED	
W3	1	4' - 0"	8' - 0"	0' - 0''	8' - 0"	LEVEL 1 F.F.	FIXED	
W14	1	6' - 0"	8' - 0"	0' - 0"	8' - 0"	LEVEL 1 F.F.	FIXED	
W15	4	3' - 0"	5' - 0"	11 10"	6' 10"	ANNEX T.O. ROOF	FIXED	

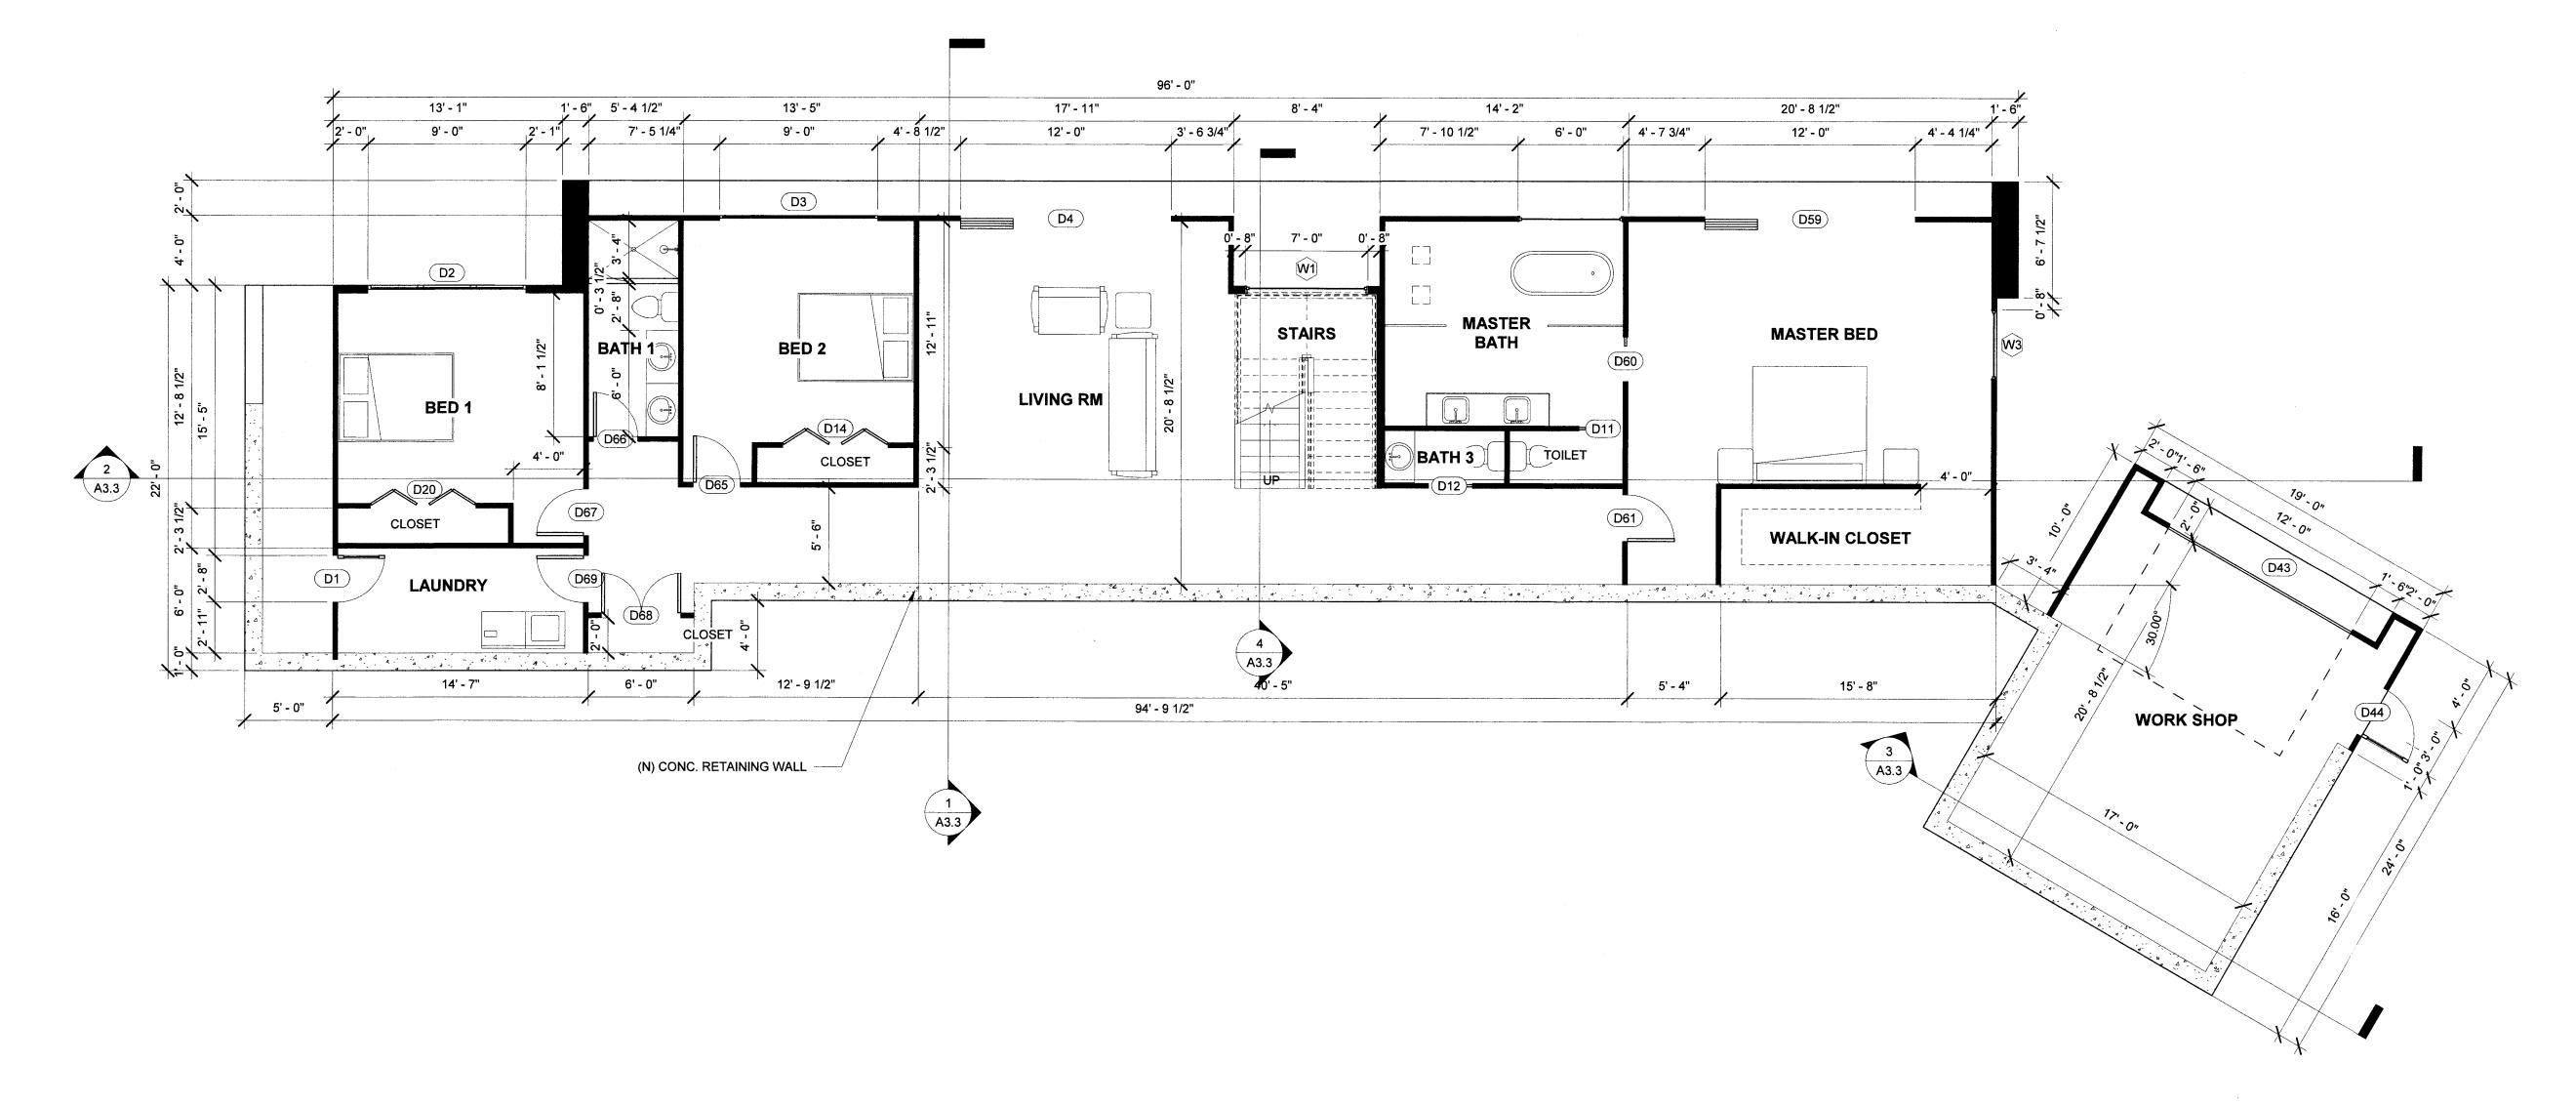

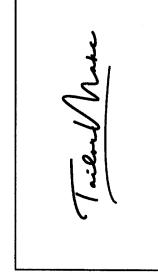


ΗE						
ETT			-	04/10/2018	PRE APPLICATION MEETING	<u> </u>
ITLE	MCWHEKIEK KESIDENCE		2	08/16/2018	PLANNING SUBMITTAL	
	PROJECT ADDRESS:	PROJECT SCOPE:	3	11/14/2018	PLANNING RESUBMITTAL	
	1237 GRANI ROAD	HOME WITH (N) ATTACHED	4	03/07/2019	2ND PLANNING RESUBMITTAL	
	MONIARA, CA 94037	GARAGE	5	06/20/2019	3RD PLANNING RESUBMITTAL	

LEVEL 1 FLOOR PLAN

		LE	VEL 2 DC	OOR SCHEDUL	. E	
Mark	Count	Width	Height	Level	Operation	Comments
		1	<u></u>		,	· · · · · · · · · · · · · · · · · · ·
25	1	3' - 0"	9' - 0"	LEVEL 2 F.F.	POCKET	
26	1	15' - 0"	9' - 0"	LEVEL 2 F.F.	SLIDING	
27	1	15' - 0"	9' - 0"	LEVEL 2 F.F.	SLIDING	
30	1	15' - 0"	9' - 0"	LEVEL 2 F.F.	SLIDING	
31	1	15' - 0"	9' - 0"	LEVEL 2 F.F.	SLIDING	
32	1	2' - 8"	8' - 0"	LEVEL 2 F.F.	POCKET	
33	1	2' - 8"	8' - 0"	LEVEL 2 F.F.	POCKET	
34	1	2' - 6"	7' - 0"	LEVEL 2 F.F.	POCKET	
37	1	11' - 0"	9' - 0"	LEVEL 2 F.F.	OVERHEAD	
46	1	3' - 0"	8' - 0"	LEVEL 2 F.F.	SINGLE	
52	1	3' - 0"	9' - 0"	LEVEL 2 F.F.	POCKET	,,
56	1	5' - 0"	10' - 0"	LEVEL 2 F.F.	POCKET	
57	1	5' - 0"	10' - 0"	LEVEL 2 F.F.	POCKET	
58	1	12' - 0"	9' - 0"	LEVEL 2 F.F.	SLIDING	
62	1	3' - 0"	9' - 0"	LEVEL 2 F.F.	SINGLE	
63	1	2' - 4"	8' - 0"	LEVEL 2 F.F.	SINGLE	
64	1	2' - 4"	8' - 0"	LEVEL 2 F.F.	SINGLE	

				LEVEL 2	. WINDO	W SCHEDULE		
Mark	Count	Width	Height	Sill Height	Head Height	Level	Operation	Comments
W11	1	3' - 0"	5' - 6"	3' - 0"	8' - 6"	LEVEL 2 F.F.	FIXED	
W12	1	3' - 0"	5' - 6"	3' - 0"	8' - 6"	LEVEL 2 F.F.	FIXED	
W13	1	3' - 0"	5' - 6"	3' - 0"	8' - 6"	LEVEL 2 F.F.	FIXED	
W15	1	3' - 0"	5' - 0"	1' - 10"	6' - 10"	ANNEX T.O. ROOF	FIXED	
W20	1	5' - 0"	9' - 0"	0' - 0''	9' - 0"	LEVEL 2 F.F.	FIXED	-
W21	1	3' - 0"	5' - 6"	3' - 6"	9' - 0"	LEVEL 2 F.F.	FIXED	
W22	1	3' - 0"	5' - 6"	3' - 6"	9' - 0"	LEVEL 2 F.F.	CASEMENT	
W23	1	3' - 0"	5' - 6"	3' - 6"	9' - 0"	LEVEL 2 F.F.	FIXED	
W24	1	7' - 0"	9' - 0"	0' - 0"	9' - 0"	LEVEL 2 F.F.	FIXED	
W30	1	4' - 6"	4' - 6"	3' - 6"	8' - 0"	LEVEL 2 F.F.	FIXED	
W31	1	4' - 6"	4' - 6"	3' - 6"	8' - 0"	LEVEL 2 F.F.	FIXED	
W32	1	4' - 6"	4' - 6"	3' - 6"	8' - 0"	LEVEL 2 F.F.	FIXED	

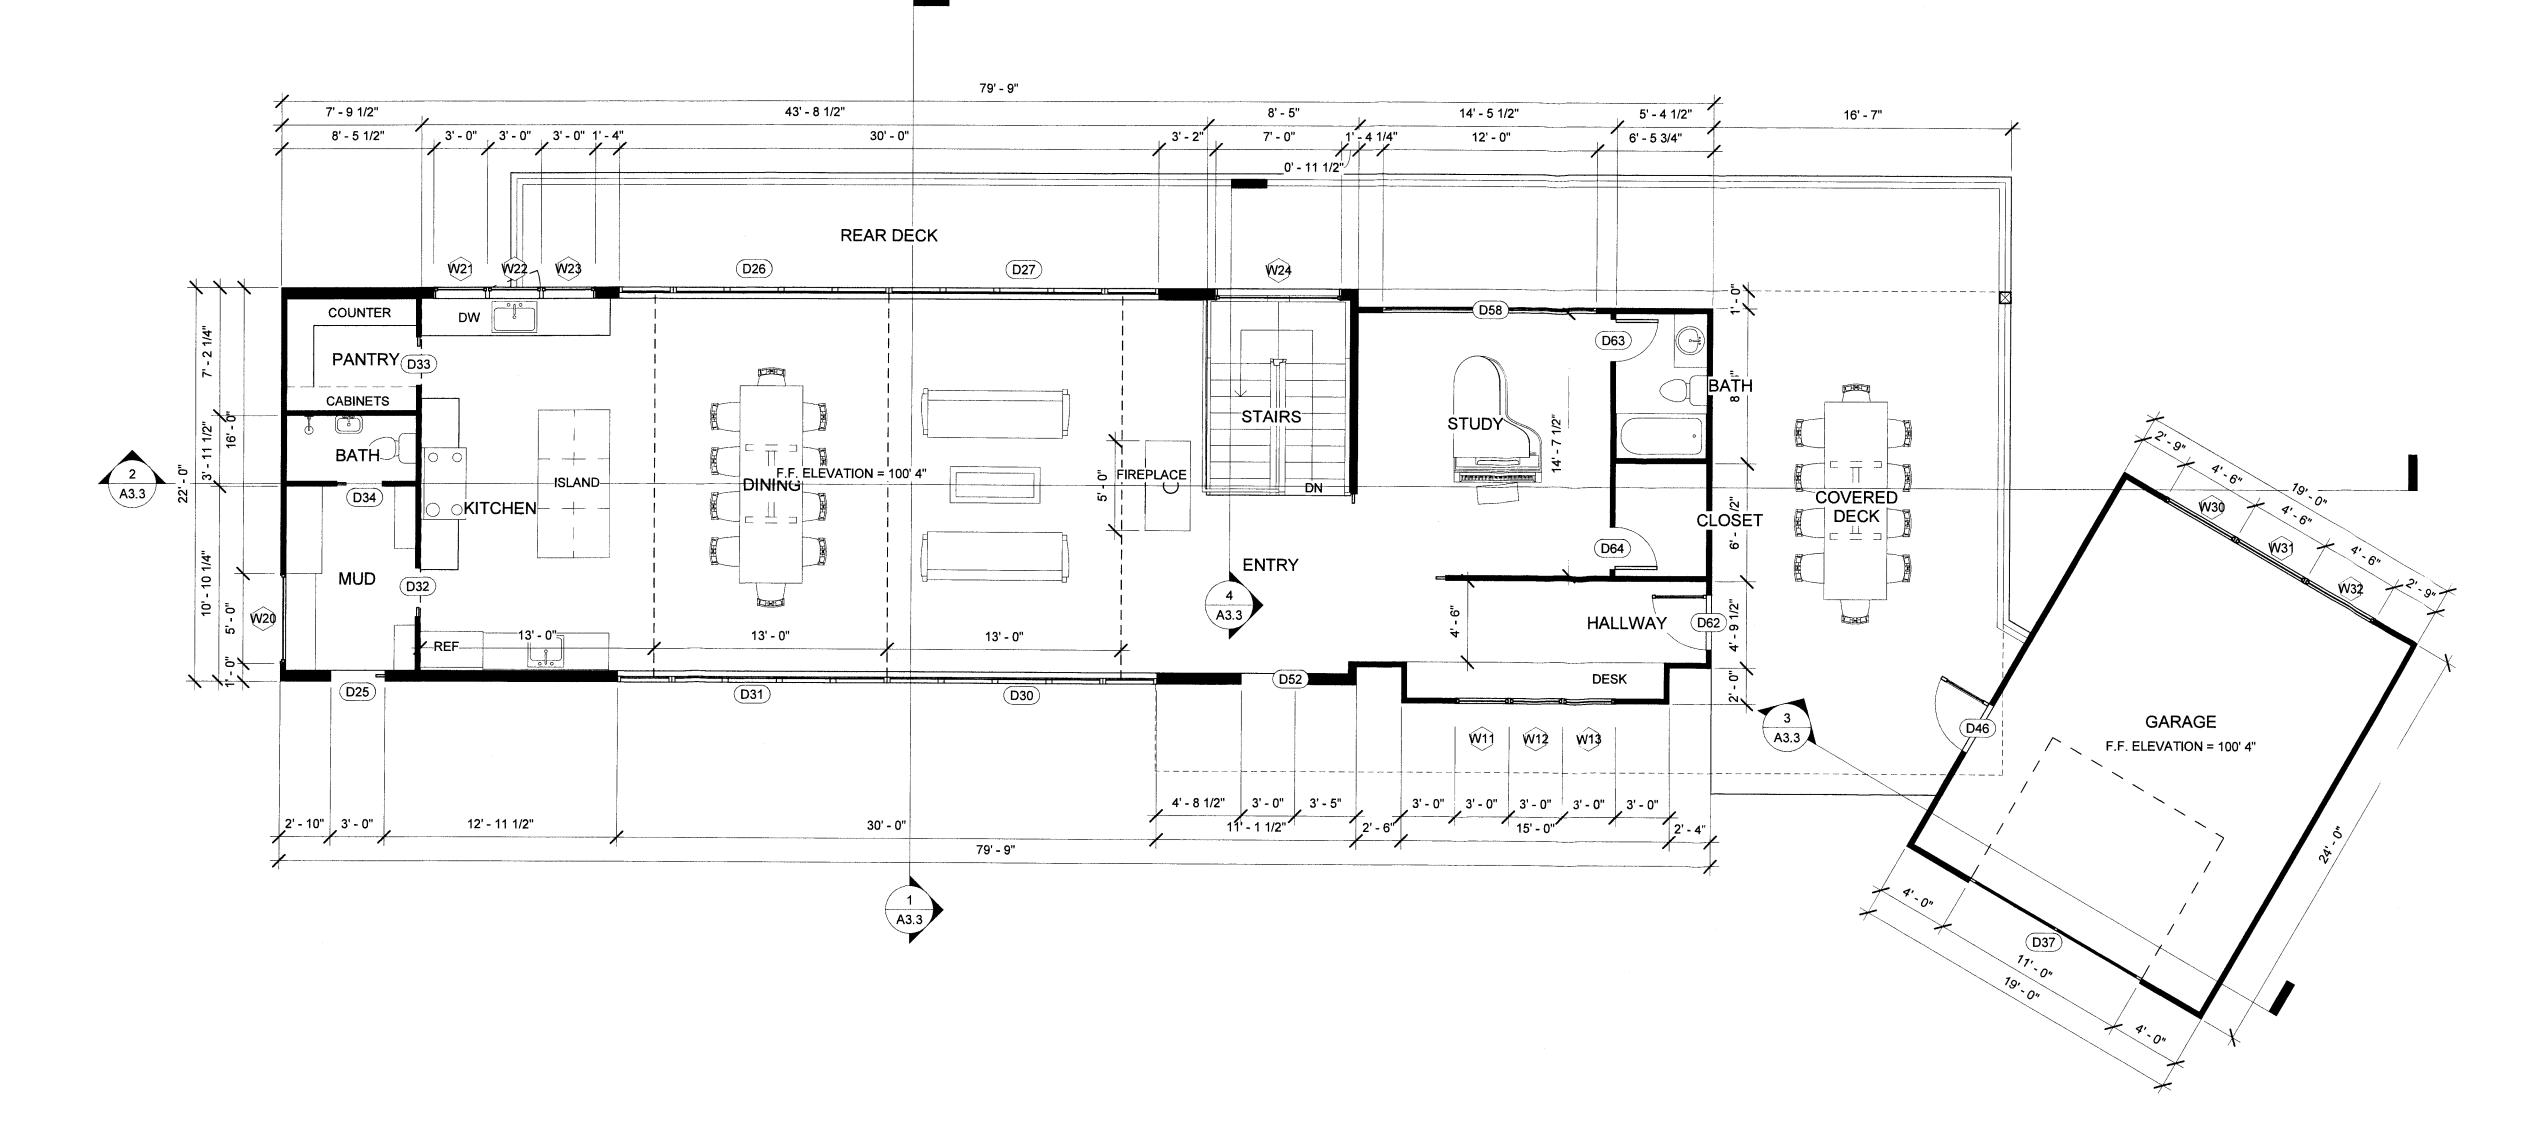





1 LEVEL 2 FLOOR PLAN 3/16" = 1'-0"




		r	T	'	Τ
DESCRIPTION	PRE APPLICATION MEETING	PLANNING SUBMITTAL	PLANNING RESUBMITTAL	2ND PLANNING RESUBMITTAL	3RD PLANNING RESUBMITTAL
DATE	04/10/2018	08/16/2018	11/14/2018	03/07/2019	06/20/2019
REV	-	2	3	4	5
			PROJECT SCOPE: (N) TWO STORY SING!	HOME WITH (N) ATTACHED	GARAGE
			PROJECT ADDRESS:	ACMITADA CACCA	MONTARA, CA 34037
	ET TI	TLE			
LE	EVE	L 2 PL		IOC	₹

SHEET

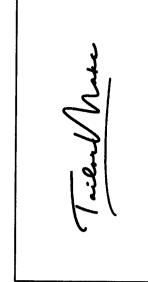


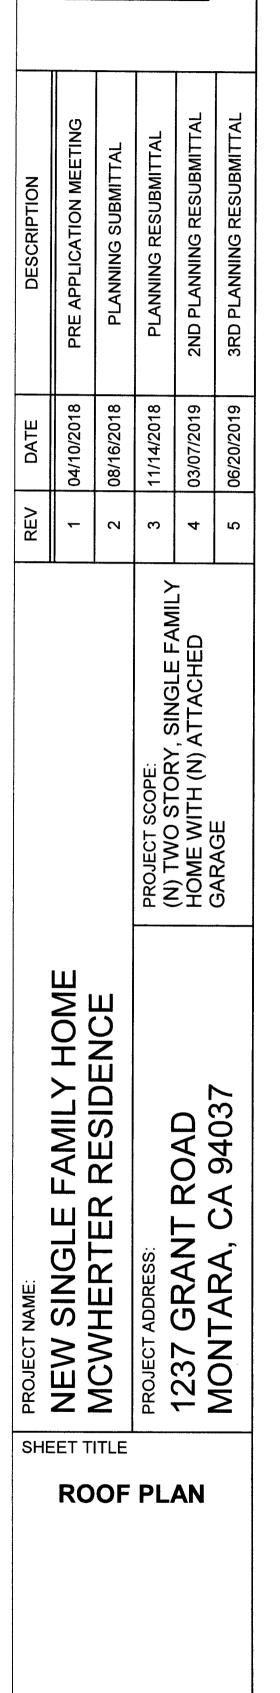

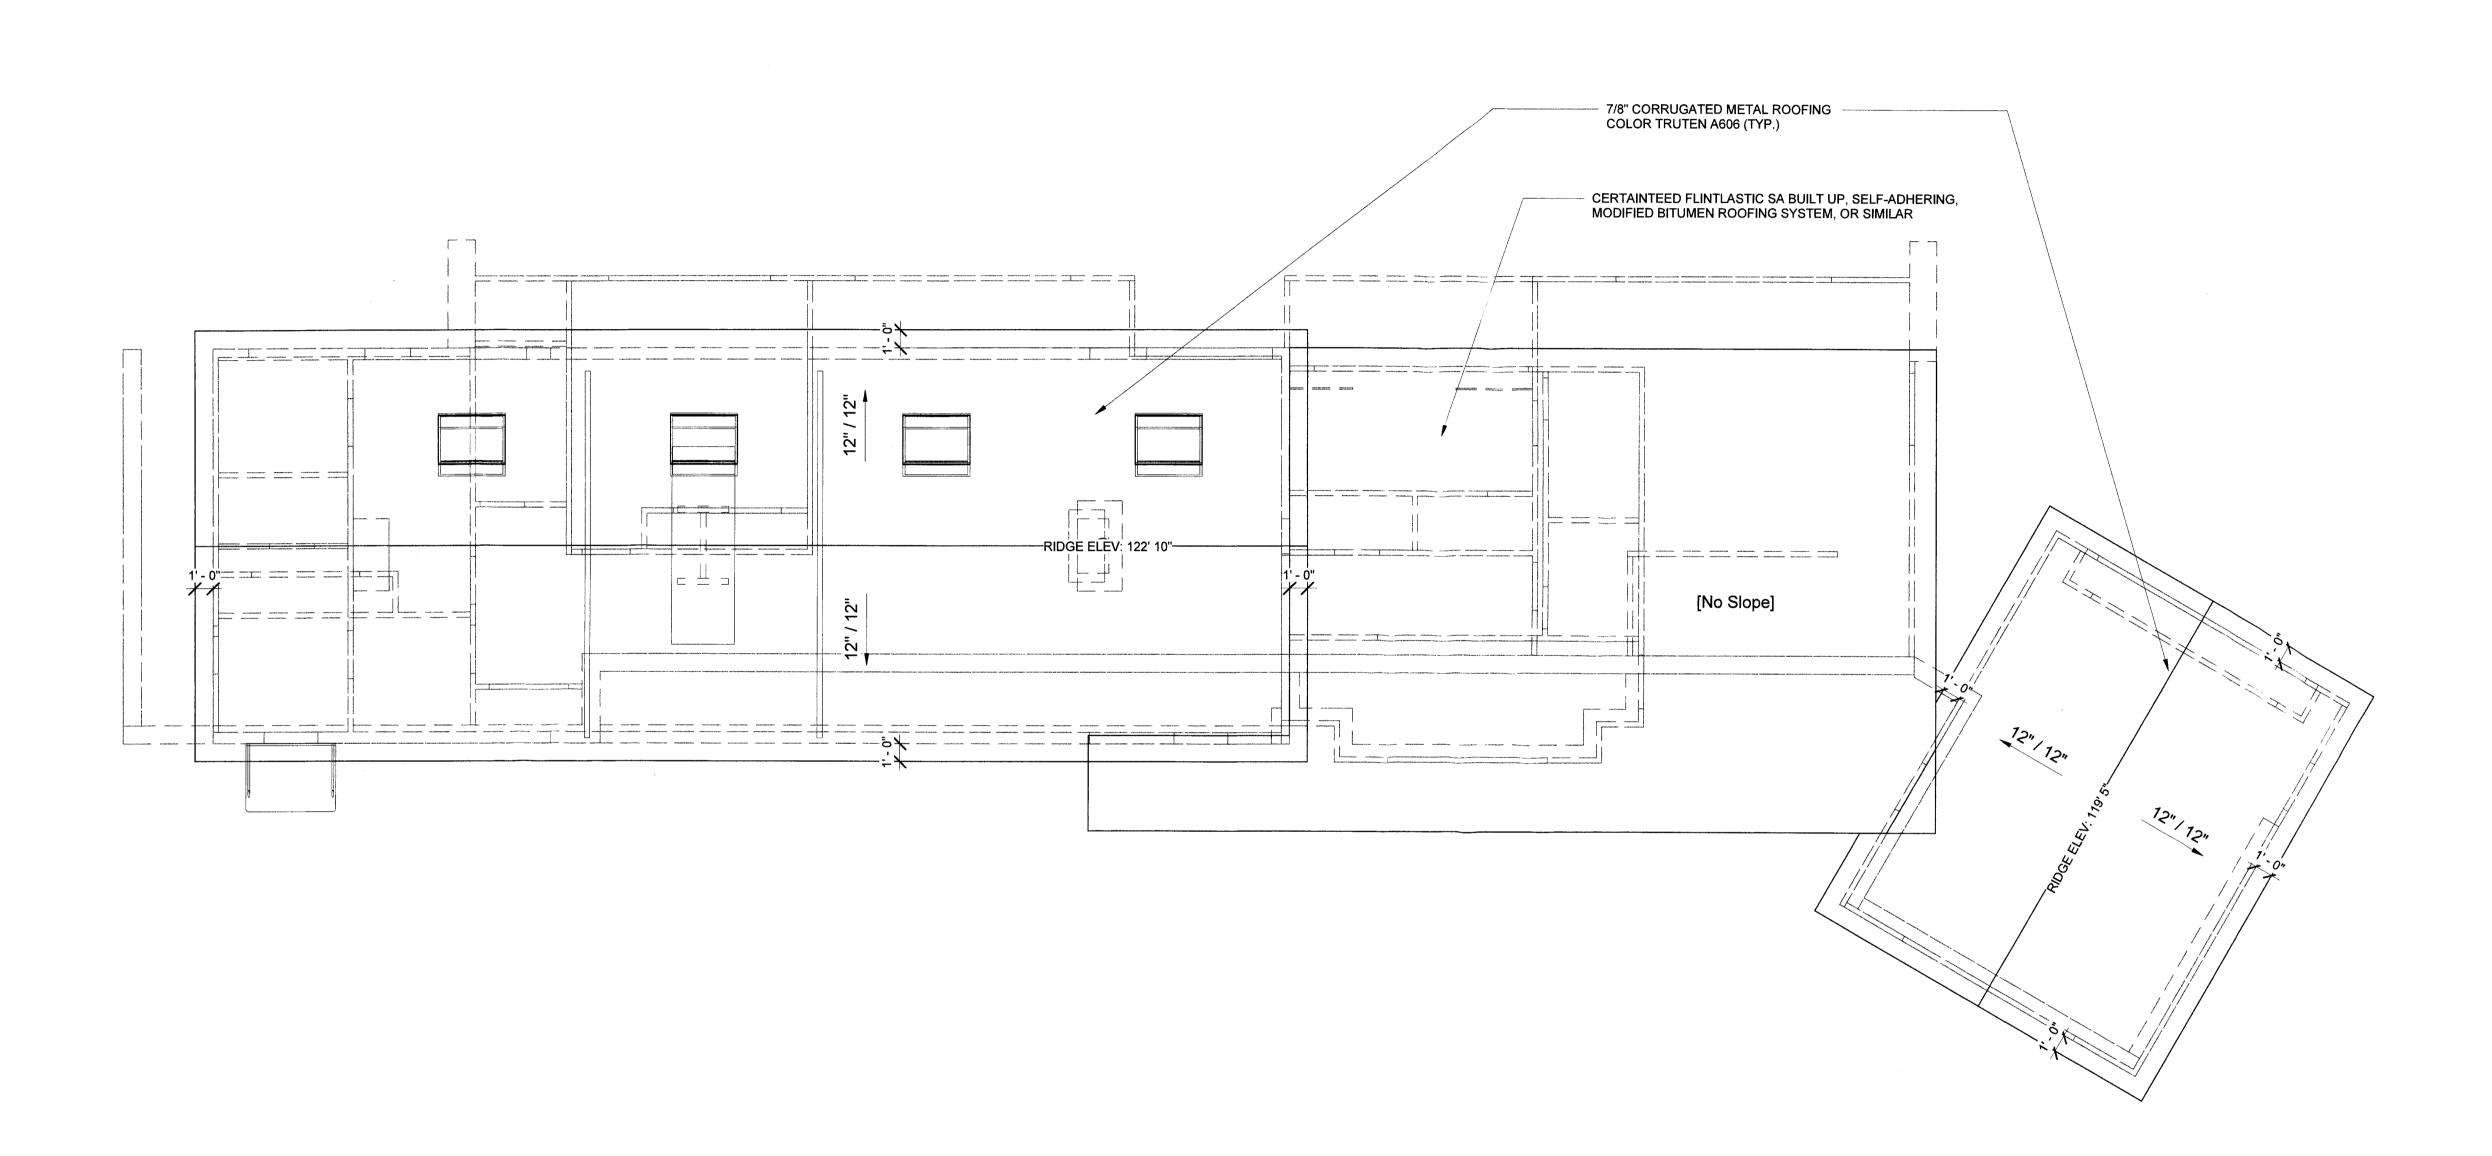


ROOF PLAN
3/16" = 1'-0"

SHEET

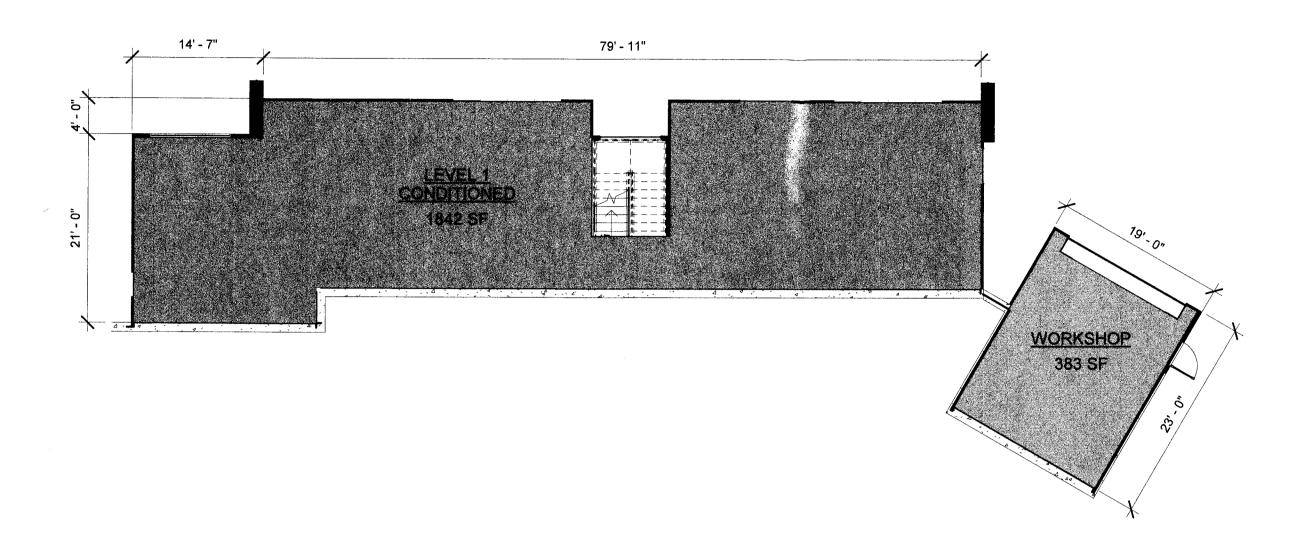

1 LEVEL 1 AREA PLAN 3/32" = 1'-0"

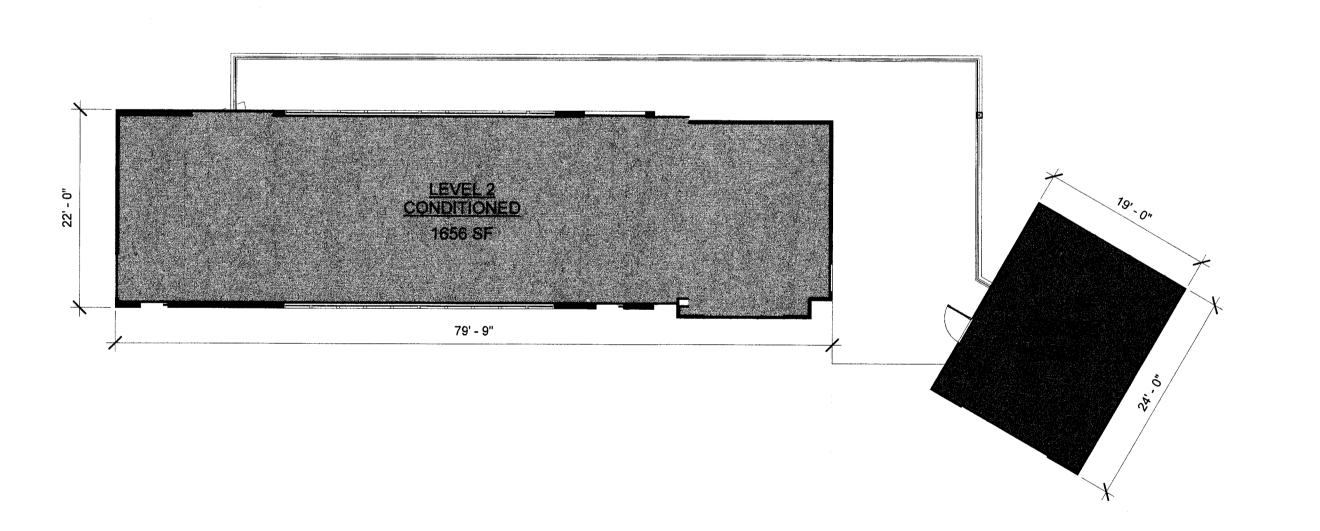

2 LEVEL 2 AREA PLAN 3/32" = 1'-0"

Name	Area
EVEL 2 CONDITIONED	1656 SF
VEL 1 CONDITIONED	1842 SF
ORKSHOP	383 SF
ARAGE	433 SF



		VE V	חאוב	DESCRIPTION	
AGLE FAMILY HOME		_	04/10/2018	PRE APPLICATION MEETING	
KIEK KESIDENCE		2	08/16/2018	PLANNING SUBMITTAL	
ESS:	PROJECT SCOPE:	က	11/14/2018	PLANNING RESUBMITTAL	
ANI KOAD	HOME WITH (N) ATTACHED	4	03/07/2019	2ND PLANNING RESUBMITTAL	
4A, CA 94031	GARAGE	5	06/20/2019	3RD PLANNING RESUBMITTAL	

SHEET TITLE

FLOOR AREA CALCULATIONS

SHEET

