Planning Permit Application Form

455 County Center, 2nd Floor • Redwood City CA 94063 Mail Drop: PLN 122 • TEL (650) 363-4161 • FAX (650) 363-4849 www.co.sapmateo.ca.us/planning

	BLD:
Comment of the second s	
Applicant: David Jaehning	
Mailing Address: 25 Forest Side Avenue	a contract of the contract of
San Francisco, California	Zip: 94127
Phone, W: 4152729444	н: 4152729444
E-mail Address: djaehning@davidjaehning.com	FAX:
Name of Owner (1): Fuli Li	Name of Owner (2): Ivanti Weignand Lie
Mailing Address: 1855 Sunshine Valley Road	Mailing Address: (same)
Moss Beach, California	
zip: 94038	. Zip:
Phone,W: 4157510522	Phone,W:
H:	H:
E-mail Address: lifuli.elle@gmail.com	E-mail Address:
Project Location (address):	Assessor's Parcel Numbers: 37 — 156 — 130
Sunshine Valley Road	
Moss Beach, California 94038	
Zoning: S-17 Midcoast	Parcel/lot size: 5,000 SF (Square Feet)
Describe Existing Site Conditions/Features (e.g. topograph	y, water bodies, vegetation):
Vacant parcel, majority of the site is landscaped ruderal v	egetation covering 4,382 SQ FT
Dean Creek, an intermittent creek, runs within the norther	n edge of the property
Describe Existing Structures and/or Development:	
None	
We hereby certify that the information stated above and o of the application is true and correct to the best of our kno through our assigned project planner of any changes to in	n forms, plans and other materials submitted herewith in support wledge. It is our responsibility to inform the County of San Mater formation represented in these submitalls.
Owner's signature:	
Owner's signature: Willow	
Applicant's signature:	

PLN:

Planning and Building Department

Application for a Coastal Development Permit

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Companion Page

Applicant's Name: Fuli Li

Primary Permit #: 7016 - 458

1. Instructions

Please fill out the general Planning Permit Application Form and this form when applying for a Coastal Development Permit. You must also submit all items indicated on the checklist found on the reverse side of the Planning Permit Application Form.

Does the owner or applicant own any adjacent property not listed? Yes No	Have you or anyone else previously applied to either the County of San Mateo or the California Coastal Commission for a Coastal Development Permit for this or a similar project at this location?
If yes, list Assessor's Parcel Number(s): 37 _ 156 _ 50	☐ Yes ■ No If yes, explain (include date and application file numbers). ————————————————————————————————————
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San Mateo County

Planning and Building Department

Note: By completing this section you do not need to file a separate application for Design Review Approval.

	atches
Fill in Blanks: Material Color/Finish exi	isting
a. Exterior Walls cedar untreated to turn gray	
b. Trim anodized aluminum bronze	
c. Roof standing seam zinc matte gray	
d. Chimneys n/a n/a	
e. Accessory Buildings planted gabions stone and planting	
f. Decks/Stairs n/a n/a	
g. Retaining Walls planted gabions stone and planting	
h. Fences n/a n/a	
i. Storage Tanks n/a n/a	

Does this project, the parcel on which it is lo immediate vicinity involve or include:	cated or	p. Between the sea and the nearest public road?				
a. Demolition of existing housing units?	Yes	No	q. Existing or proposed provisions for public access to the shoreline?			
(If yes, give value of owner-occupied		耳	r. Public or commercial recreation facilities?			
units or current monthly rent of rental units in explanation below.)			s. Visitor-serving facilities?			
b. Creeks, streams, lakes or ponds?		ഥ	t. Existing or proposed public trail			
c. Wetlands (marshes, swamps, mudflats)?		₽ P	easements?			
d. Beaches?		F	Explain all Yes answers below. Indicate whether the			
e. Sand Dunes?		T 17	item applies to the project itself, the parcel on located, or the immediate vicinity (attach addi			
f. Sea cliff, coastal bluffs or blufftops?		7	necessary):	nonai si	ieerz ii	
g. Ridgetops?		ĘĮ	- Dean Creek, an intermittent creek, runs wit	thin the		
h. Pampas Grass, invasive brooms or			northern edge of the property.			
Weedy Thistle?			- Removal of 4 Ngaio trees, 1 Monterey Cyp	oress,		
i. Removal of trees or vegetation?	K		and 1 Coastal Redwood. Monterey Cypres	ss is wi	thiņ	
j. Grading or alteration of landforms?		K	footprint of allowed setbacks, and an arborist	was co	nsulted	
k. Landscaping?	哟		fo Coastal Redwood. See report for findings regard	ing healt	h of tree.	
I. Signs?		7	- Removing most of turf grass and replacing with r			
m. Phone or utility line extensions or connections, either above or below ground (explain which)?		K	on the east side of lot to blend with adjacent i	riparian	habitat,	
n. Areas subject to flooding?		171	removing invasive and non-native species from Dean C	Creek, and	d adding	
o. Development on slopes 30% or steeper?		12X 12A	native riparian plants along banks, addition of Pistacia Chinensis			
5. Stat Use Snly						
California Coastal Commission Juri	isdictio	on	Commission; a public hearing is always require	ed.		
A. Does the Proposed Project Involve:			B. Does the proposed project involve lands below the mean			
A subdivision, Certificate of Compliance Type B, Use Permit, or Planned Agricultural District Permit?			high tide line and lands where the public trust may exist (See "Post CCP Certification Permit and Appeal Jurisdiction Map).			
☐ Yes ☐ No	☐ Yes ☐ No		Yes □ No			
2. Construction or grading within 100 feet of wetland?	a stream	or				
☐ Yes ☐ No			Yes to above means that the California Coastal			
3. A parcel located between the sea and the first public through road paralleling the sea; 300 feet from the inland extent of any beach or mean high tide line if there is no beach; or within 300 feet of the top of the seaward face of a coastal bluff?			retains permit jurisdiction over all or part of the proposed project. A Coastal Development Permit from that agency is required. Reviewed by:			

Application for Design Review by the County Coastside Design Review Committee

Planning and Building Department

7018 -

County Government Center = 455 County Center = Redwood City CA 94063 Mail Drop PLN 122 = 650 · 363 · 4161 = FAX 650 · 363 · 4849

Review Committee	reimit #. Fun				
	Other Permit #:				
1. Basic Information					
Applicant:	Owner (if different from Applicant):				
Name: DAGID JABANING	Name: FULLY + WELGUANG XIE				
Address: 25 FOREST SIDE AKE	Address: 18-8 SANSHINE VALLEY RD				
Zip: 9(4127	MOSS BEHCH Zip: 94038				
Phone, W: (45) 272 944(H:	Phone, W: A(5) 761 0572 H:				
Email: diaehnne davidipelining com	Phone, W: A15) 751 0522 H: Email: 11-11. elle amoil com				
Architect or Designer (if different from Applicant):	∀				
Name:					
Address:	Zip:				
Phone,W: H:	Email:				
2 Project Site Information					
Project location:	Site Description:				
APN: 037-154-130	₩ Vacant Parcel				
Address: SUNSHINE VALUEY 120	Existing Development (Please describe):				
WOSS BIENCH Zip: 14038					
Zoning: 5-17 MID COLAST					
Parcel/lot size: 5,000 sq. ft.					
3. Project Description					
Project:	Additional Permits Required:				
\mathbf{u} New Single Family Residence: 290 sq. ft					
☐ Addition to Residence: sq. ft	Coastal Development Permit				
Other:	Fence Height Exception (not permitted on coast)				
	☐ Grading Permit or Exemption				
Describe Project:	☐ Home Improvement Exception				
3-level regoderal, 730-50 FT Fastprint	□ Non-Conforming Use Permit				
compact, entry dance to bridge over	☐ Off-Street Parking Exception				
Dean Creek.	Variance				

4. Materials and	d Finish of Proposed Bui	Idings or Structures	
Fill in Blanks:	Material	Color/Finish	Check if matches existing
		(If different from existing, attach sample)	omoung
a. Exterior walls	cedar	untrosted to two arm	
b. Trim	ancotred aluminum	bruze	
c. Windows	malited alumnym	anne	
d. Doors	andred Lumman	bruze	
e. Roof	strong glam zinc	matte gray	
f. Chimneys	- 42/		
g. Decks & railings	n/a	n e	
h. Stairs	n/2	<u> </u>	
i. Retaining walls	gabien plante	Aire + planting	
j. Fences	NZ	$\frac{n}{2}$	
k. Accessory buildings	gebore planted	_ Stovet planting	
I. Garage/Carport	n/2	n/2	
	((*	
5. Required Sinc	ings		
including the required find		oroject complies with all applicable regulation he standards and guidelines for design revolution. 10.	
(optional) Applicant	's Statement of project compliance with	n standards and guidelines (check if attach	ed).
6. Signatures			
support of the application i	is true and correct to the best of my kno	lans, and other materials submitted herew owledge. It is my responsibility to inform the to information represented in these submit	ne County of
Owner:	Applić	capit:	
1! /20/2018 Date:	Date:	1/20/2018	

Application for a Variance

Companion Page

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Applicant's Name: Fuli Li

Primary Permit#:

PIN 2018 . 458

Please fill out the general Planning Permit Application Form and this form when applying for a Variance. You must also submit all items indicated on the checklist found on the reverse side of the Planning Permit Application Form and a parcel constraints map.

Specific zoning requirements for which a variance is sought: (Example: 10 ft. side setbacks)

- 1) 15-ft side yard setback on west
- 2) no garage due to additional 30-ft setback from Dean Creek (removed 435 sq. ft. from buildable area footprint)

Zoning ordinance section numbers:

6300.2.3

6120

What you propose instead:

- Encroach on west setback by 10", with approval of adjacent owner at 1855 Sunshine Valley Road
- 2) Provide 3 on-site parking spaces: 2 wide and additional tandem on-site, area in front of Dean Creek (adjacent to Sunshine Valley Road) for additional guest/overflow parking

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To approve this application, the County must determine that this project complies with all applicable regulations including the following specifically required findings. Please attach a brief statement in which you present evidence to support the required findings.

- a. The parcel's location, size, shape, topography and/or other physical conditions vary substantially from those of other parcels in the same zoning district or vicinity.
- b. Without the variance, the landowner would be denied the rights and privileges that are enjoyed by other landowners in the same zoning district or vicinity.

- c. The variance does not grant the landowner a special privilege which is inconsistent with the restrictions placed on other parcels in the same zoning district or vicinity.
- d. The variance authorizes only uses or activities which are permitted by the zoning district.
- e. The variance is consistent with the objectives of the General Plan, the Local Coastal Program (LCP) and the Zoning Regulations.

Environmental Information Disclosure Form

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PLN_	and the same of th	16-	<u> </u>		
BI D	•				

Project Address: Sunshine Valley Road	Name of Owner: Fuli Li and Weiguang Xie		
Moss Beach, California 94038	Address: 1855 Sunshine Valley Road		
APN 037156130	Moss Beach, CA Phone: 4157510522		
Assessor's Parcel No.: 37 — 156 — 130	Name of Applicant: David Jaehning		
	Address: 25 Forest Side Avenue		
Zoning District: S-17 Midcoast	San Francisco Phone: 4152729444		

Existing Site Conditions

Parcel size: 5000 SQ FT

Describe the extent and type of all existing development and uses on the project parcel, including the existence and purpose of any easements on the parcel, and a description of any natural features on the project parcel (i.e. steep terrain, creeks, vegetation). Vacant parcel, majority of the site is landscaped ruderal vegetation covering 4,382 SQ FT

Vacant parcel, majority of the site is landscaped ruderal vegetation covering 4,382 SQ FT

Dean Creek, an intermittent creek, runs within the northern edge of the property

	1	Environmental Quality Act (CEQA) Review						
es	No	Will this project involve:						
		a. Addition to an existing structure > 50% of the existing area OR > 2,500 sq. ft?						
nteressery):	N	b. Construction of a new multi-family residential structure having 5 or more units?						
No Hermitol	IX.	c. Construction of a commercial structure > 2,500 sq.ft?						
(en maren al	 d. Removal of mature tree(s) (≥ 6" d.b.h. in Emerald Lake Hills area or ≥ 12" d.b.h. in any residential zoning district)? If yes, how many trees to be removed? 2 						
Z)	Sant society	e. Land clearing or grading? If yes, please state amount in cubic yards (c.y.): Excavation: 21						
Notween to	IN	f. Subdivision of land into 5 or more parcels?						
al Subsection	N	g. Construction within a State or County scenic corridor?						
V. (1. (1. (1. (1. (1. (1. (1. (1. (1. (1		h. Construction within a sensitive habitat?						
	18	i. Construction within a hazard area (i.e. seismic fault, landslide, flood)?						
		j. Construction on a hazardous waste site (check with Co. Env. Health Division)?						
	-	vall "Yes" answers: ypress, 24" dia, and 1 Coastal Redwood, 26" dia. (see arborist report on health of redwood)						
educ	e slope	at rear yard, and flow away from residence						

2. Na	tional f	Marine Fisheries Rule 4(d) Review
Yes	No	Will the project involve:
	W	a. Construction outside of the footprint of an existing, legal structure?
1	1 TX	b. Exterior construction within 100-feet of a stream?
- Printerinality		c. Construction, maintenance or use of a road, bridge, or trail on a stream bank or unstable hill slope?
1	TX	d. Land-use within a riparian area?
- Comment	X	e. Timber harvesting, mining, grazing or grading?
January 17	N	f. Any work inside of a stream, riparian corridor, or shoreline?
And the second	X	g. Release or capture of fish or commerce dealing with fish?
Please	e explain	any "Yes" answers:
A 100 C	1 19 (1) 1	Pollutant Discharge Elimination System (NPDES) Review
A 100 C	tional P	Will the project involve:
A 100 C	1 19 (1) 1	
A 100 C	1 19 (1) 1	Will the project involve: a. A subdivision or Commercial / Industrial Development that will result in the addition or replacement of the commercial of the
A 10 To 10	1 19 (1) 1	a. A subdivision or Commercial / Industrial Development that will result in the addition or replacement of 10,000 sq. ft. or more of impervious surface? If yes, Property Owner may be required to implement appropriate source control and site design measures and to design and implement stormwater treatment measures, to reduce the discharge of stormwater pollutants. Please consult the Current Planning Section for necessary forms and both
3. Nat	1 19 (1) 1	a. A subdivision or Commercial / Industrial Development that will result in the addition or replacement of 10,000 sq. ft. or more of impervious surface? If yes, Property Owner may be required to implement appropriate source control and site design measures and to design and implement stormwater treatment measures, to reduce the discharge of stormwater pollutants. Please consult the Current Planning Section for necessary forms and both construction and post-construction requirements.
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A 10 To 10	1 19 (1) 1	 a. A subdivision or Commercial / Industrial Development that will result in the addition or replacement of 10,000 sq. ft. or more of impervious surface? If yes, Property Owner may be required to implement appropriate source control and site design measures and to design and implement stormwater treatment measures, to reduce the discharge of stormwater pollutants. Please consult the Current Planning Section for necessary forms and both construction and post-construction requirements. b. Land disturbance of 1 acre or more of area? If yes, Property Owner must file a Notice of Intent (NOI) to be covered under the statewide General Construction Activities Storm Water Permit (General Permit) prior to the commencement of construction activity. Proof of coverage under State permit must be demonstrated prior to the
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Yes	No X	 Will the project involve: a. A subdivision or Commercial / Industrial Development that will result in the addition or replacement of 10,000 sq. ft. or more of impervious surface? If yes, Property Owner may be required to implement appropriate source control and site design measures and to design and implement stormwater treatment measures, to reduce the discharge of stormwater pollutants. Please consult the Current Planning Section for necessary forms and both construction and post-construction requirements. b. Land disturbance of 1 acre or more of area? If yes, Property Owner must file a Notice of Intent (NOI) to be covered under the statewide General Construction Activities Storm Water Permit (General Permit) prior to the commencement of construction activity. Proof of coverage under State permit must be demonstrated prior to the issuance of a building permit.
Yes	No No	 Will the project involve: a. A subdivision or Commercial / Industrial Development that will result in the addition or replacement of 10,000 sq. ft. or more of impervious surface? If yes, Property Owner may be required to implement appropriate source control and site design measures and to design and implement stormwater treatment measures, to reduce the discharge of stormwater pollutants. Please consult the Current Planning Section for necessary forms and both construction and post-construction requirements. b. Land disturbance of 1 acre or more of area? If yes, Property Owner must file a Notice of Intent (NOI) to be covered under the statewide General Construction Activities Storm Water Permit (General Permit) prior to the commencement of construction activity. Proof of coverage under State permit must be demonstrated prior to the issuance of a building permit. tion y that the statements furnished above and in the attached exhibits present the data and the statements furnished above and in the attached exhibits present the data and the statements furnished above and in the attached exhibits present the data and the statements furnished above and in the attached exhibits present the data and the statements furnished above and in the attached exhibits present the data and the statements furnished above and in the attached exhibits present the data and the statements furnished above and in the attached exhibits present the data and the statements furnished above and in the attached exhibits present the data and the statements furnished above and in the attached exhibits present the data and the statements furnished above and in the attached exhibits present the data and the statement of the statement
Yes hereb	No No	 Will the project involve: a. A subdivision or Commercial / Industrial Development that will result in the addition or replacement of 10,000 sq. ft. or more of impervious surface? If yes, Property Owner may be required to implement appropriate source control and site design measures and to design and implement stormwater treatment measures, to reduce the discharge of stormwater pollutants. Please consult the Current Planning Section for necessary forms and both construction and post-construction requirements. b. Land disturbance of 1 acre or more of area? If yes, Property Owner must file a Notice of Intent (NOI) to be covered under the statewide General Construction Activities Storm Water Permit (General Permit) prior to the commencement of construction activity. Proof of coverage under State permit must be demonstrated prior to the issuance of a building permit.
Yes nereb formation formation and the second	No Vertification relation pro	 Will the project involve: a. A subdivision or Commercial / Industrial Development that will result in the addition or replacement of 10,000 sq. ft. or more of impervious surface? If yes, Property Owner may be required to implement appropriate source control and site design measures and to design and implement stormwater treatment measures, to reduce the discharge of stormwater pollutants. Please consult the Current Planning Section for necessary forms and both construction and post-construction requirements. b. Land disturbance of 1 acre or more of area? If yes, Property Owner must file a Notice of Intent (NOI) to be covered under the statewide General Construction Activities Storm Water Permit (General Permit) prior to the commencement of construction activity. Proof of coverage under State permit must be demonstrated prior to the issuance of a building permit. tion y that the statements furnished above and in the attached exhibits present the data and quired for this initial evaluation to the best of my ability, and the facts, statements and
Yes hereb formation formation and the second	No Vertification relation pro	a. A subdivision or Commercial / Industrial Development that will result in the addition or replacement of 10,000 sq. ft. or more of impervious surface? If yes, Property Owner may be required to implement appropriate source control and site design measures and to design and implement stormwater treatment measures, to reduce the discharge of stormwater pollutants. Please consult the Current Planning Section for necessary forms and both construction and post-construction requirements. b. Land disturbance of 1 acre or more of area? If yes, Property Owner must file a Notice of Intent (NOI) to be covered under the statewide General Construction Activities Storm Water Permit (General Permit) prior to the commencement of construction activity. Proof of coverage under State permit must be demonstrated prior to the issuance of a building permit. It ion y that the statements furnished above and in the attached exhibits present the data and quired for this initial evaluation to the best of my ability, and the facts, statements and esented are true and correct to the best of my knowledge and belief. If any of the

Planning and Building Department **Certificate of Compliance Type A** (for parcel legalization)

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Companion Page

. Instructions

Please fill out the general Planning Permit Application Form and this form when applying for a Certificate of Compliance Type A. You must also submit all items listed below.

2. Basic Information	
Civil Engineer/Land Surveyor (only <u>if</u> required) Name: BGT Land Surveying Phone: (650) 212-1030	Address: 871 Woodside Way San Mateo, CA Zip: 94401 License #: LS 7551
3. Project Information	
Street/road frontage or closest access:	Existing development/uses on property:
Sunshine Valley Road	None
Water supply: NA well water district: Montara Water Sewage disposal: NA septic sanitary district: Montara Sanitary	Does legalization sought match current Assessor's Parcel boundaries? Yes

4. Application Requirements

- Land Division history, tracing history of parcel(s), including previous parcel(s) of which it is a part, back to last legal parcel or to its original creation. History shall include:
 - (1) A chronological chain of title, listing all deed conveyances (via date, book/page, document number) from: (a) in the case of historic subdivision - the subdivision map's recorded date up to the present ownership, or (b) in all other cases, the subject parcel's initial creation/separation from a larger "parent" property. In either scenario, the chain of title must also include copies of all referenced deeds
- (2) a map depicting the parcel boundaries; and (3) a chain of title narrative that traces all such deed history from the parcel's initial creation to the present (current owner), with graphics references, where necessary, on accompanying maps
- If this legalization is triggered by the Witt/Abernathy cases, consult the 1-8-2010 "Legalization of Parcels" policy.
- A topographic and Boundary Survey of Parcel(s) maybe required
- Building permit history on the house or other principal use may be required, obtainable from the Building

NOTE: If, upon review of the Type A application, it is determined that a Type B Certificate of Compliance is required, a topographic and boundary survey will be required, as well as other possible property improvements and planning applications.

SUNSHINE VALLEY RESIDENCE

APN 037156130 Sunshine Valley Road Moss Beach, California 94038



ARCHITECTURAL:

STRUCTURAL:

DAVID JAEHNING ARCHITECT 25 FOREST SIDE AVENUE SAN FRANCISCO, CA 94127 T: +1 415 272 9444

ALEX LAU ENGINEERING SAN FRANCISCO, CA T: +1 408 207 6113

BUILDING CODE INFORMATION:

APPLICABLE BUILDING CODE: 2016 CALIFORNIA BUILDING STANDARDS CODE (CAL. CODE REGS., TITLE 24)

> COUNTY ZONED: S-17 COMBINING DISTRICT (MIDCOAST)

> > TOTAL: 1464 SF (29%)

PARCEL SIZE: 5000 SF

LOT COVERAGE: BUILDING: 730 SF HARDSCAPE: 734 SF

FLOOR AREA RATIO: 0.44

LANDSCAPE AREA (REHABILITATED): 2061 SF LANDSCAPE AREA (TURF & PLANT): 954 SF

OCCUPANCY CLASSIFICATION: R-3

BUILDING CHARACTERISTICS: LEVEL 1: 730 SF LEVEL 2: 730 SF LEVEL 3: 730 SF

GRADE ELEVATION: 109'-0"

BUILDING HEIGHT: 28'-0" PERIMETER, 31'-4" PEAK

TOTAL: 2190 SF

BUILDING LEVELS: 3

MECHANICAL, ELECTRICAL, & PLUMBING:

DESIGN/BUILD BY CONTRACTOR

BUILDING CODE INFORMATION: TYPE V-A

PRIMARY STRUCTURAL FRAME: 1 TYPE OF CONSTRUCTION: BEARING WALLS: 1

NON-BEARING WALLS AND PARTITIONS (EXT.): TABLE 602 NON-BEARING WALLS AND PARTITIONS (INT.): 0 FLOOR CONSTRUCTION: 1

ROOF CONSTRUCTION: 1

ALLOWABLE HEIGHT: 50'-0" PER TABLE 503

BUILDABLE AREA: UNLIMITED PER TABLE 503

OCCUPANT LOAD: 2190 SF / 200 GROSS = 11 PERSONS

EGRESS REQUIREMENT: PER SECTION 1006.2.1:


IN GROUP-R-2 AND R-3 OCCUPANCIES, ONE MEANS OF EGRESS IS PERMITTED WITHIN AND FROM INDIVIDUAL DWELLING UNITS WITH A MAXIMUM OCCUPANT LOAD OF 20 WHERE THE DWELLING UNIT IS EQUIPPED THROUGHOUT WITH AN AUTOMATIC SPRINKLER SYSTEM IN ACCORDANCE WITH SECTION 903.1.1 OR 903.2.1.2 AND THE COMMON PATH OF EGRESS TRAVEL DOES NOT

EXCEED 125 FEET

SMOKE DETECTION: HARD-WIRED, INTERCONNECTED, AND BATTERY BACKUP PER CBC, STATE FIRE MARSHALL REGULATIONS, AND COASTSIDE FIRE DISTRICT ORDINANCE 2016-01. PLACED

ONE PER BEDROOM AND ONE IN HALLWAY PER FLOOR

FIRE SUPPRESSION: BUILDING WILL BE PROTECTED BY AN AUTOMATIC FIRE SPRINKLER SYSTEM

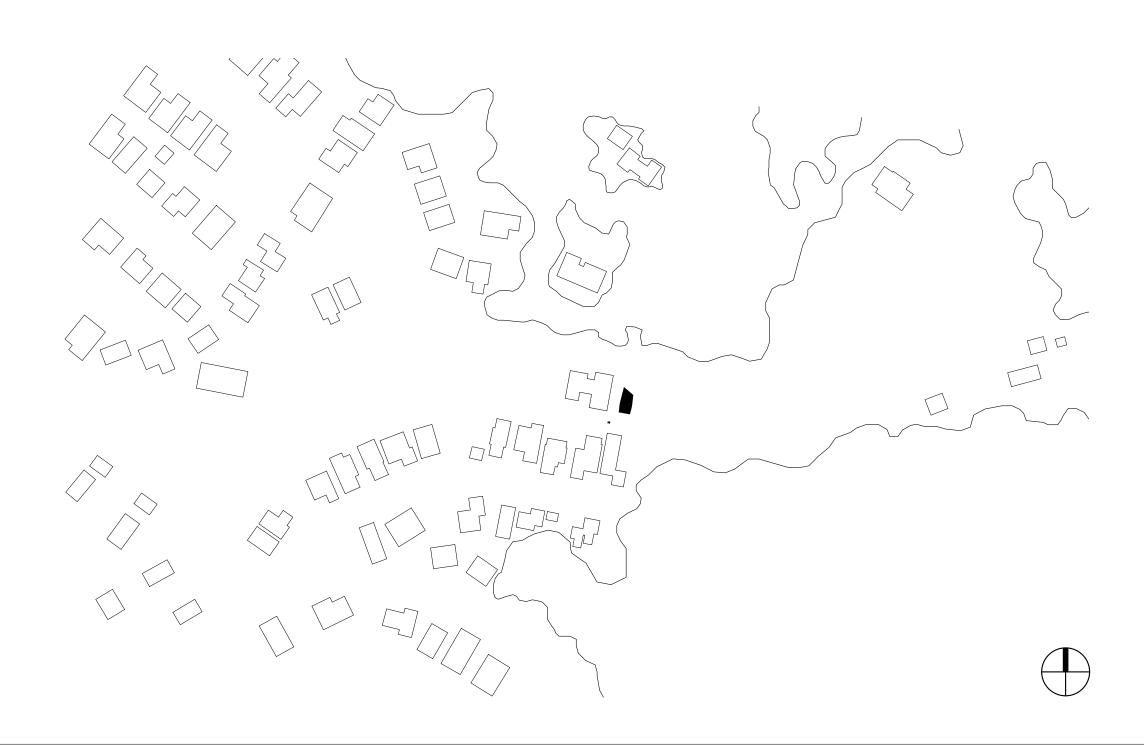

SHEET LIST **NAME** # **GENERAL INFORMATION** A001 GENERAL NOTES CIVIL

C002 EROSION & SEDIMENT CONTROL

C001 GRADING & DRAINAGE

LANDSCAPE L001 LANDSCAPE PLAN L002 TREE LOCATION

ARCHITECTURAL

A112 ARCHITECTURAL SITE PLAN A211 DIMENSION FLOOR PLAN - LEVEL 1 A212 DIMENSION FLOOR PLAN - LEVEL 2 A213 DIMENSION FLOOR PLAN - LEVEL 3 A271 ROOF PLAN A311 ELEVATIONS A312 ELEVATIONS

STRUCTURAL S001 STRUCTURAL TBD

PLUMBING

P001 PLUMBING TBD

MECHANICAL M001 MECHANICAL TBD

ELECTRICAL

E001 ELECTRICAL TBD

FOR REVIEW & FILING NOT FOR CONSTRUCTION



David Jaehning Architect

25 Forest Side Avenue. San Francisco. California 94127

CONSULTANT TEAM:

Trees 360 Degrees, Straun Edwards: WE5612-A Saratoga, California

SWCA Environmental Consultants: Half Moon Bay, California

Sigma Prime Geosciences, Inc.: Half Moon Bay, California

Alex Lau Engineering: C 75773, San Francisco, California

CLIENT:

Elle and Ivan Li

1855 Sunshine Valley Road, Moss Beach, California 94038

PROJECT NAME: PROJECT NO:

1802 **Sunshine Valley** Residence

APN 037156130, Sunshine Valley Road Moss Beach, California 94038 PROJECT ADDRESS:

PROJECT PHASE: Construction Documents

DRAWN: CHECKED: Checker


ISSUE DATE: 5/14/2019 1:24:00 PM DRAWING TITLE: COVER SHEET

A000

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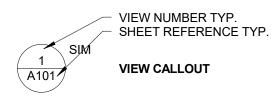
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PARTITION KEY LEGEND





NOTES

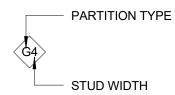A. ALL INTERIOR PARTITION FRAMING TO BE WOOD STUD U.O.N. **B.** ALL INTERIOR PARTITIONS TO INCLUDE SOUND ATTENUATION UNLESS OTHERWISE NOTED C. EPOXY PAINT @ ALL KITCHENETTE BACKSLASHES, AND BREAKEROOM **D.** ALL FRAMING TO EXTEND TO ROOF DECK, U.O.N. E. RE. INTERIOR ELEVATION FOR PAINTED EXPOSED HOMASOTE, PAINT COLOR TO MATCH WINDOW FRAMES



NORTH ARROW

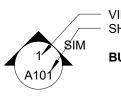

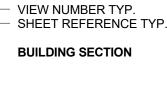

VIEW NUMBER TYP.SHEET REFERENCE TYP.




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VIEW NUMBER TYP.

EXTERIOR GLAZING

ELEVATION

SHEET REFERENCE TYP.



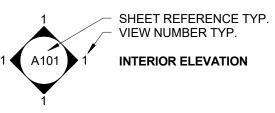





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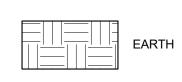
TYPE TAG



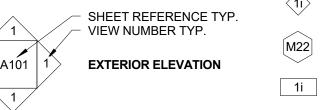


MATERIAL SYMBOLS



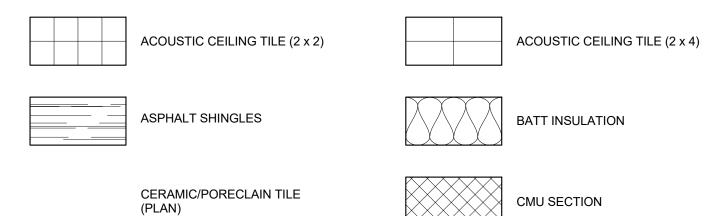



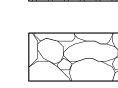








FINISH WOOD



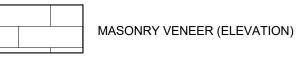


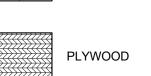



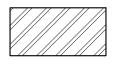

ALUMINUM

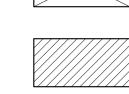

BRICK VENEER SECTION

EPS INSULATION

WOOD (ROUGH)


MASONRY VENEER (SOLDIER


SIMULATED STONE (SECTION)

COURSE) (ELEVATION)

RIGID INSULATION

(ELEVATION)

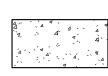

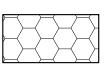





MANUFACTURED STONE

SPRAY FOAM INSULATION

	ABBREVIATION LEGEND		ABBREVIATION LEGEND
ABBRV	DESCRIPTION	ABBRV	DESCRIPTION
A @	AT	M M.O .	MASONRY OPENING
@ A.F.F.	ABOVE FINISH FLOOR	M.O. MAT'L	MATERIAL MATERIAL
AC ACST	ABOVE COUNTER ACOUSTIC	MAX MECH	MAXIMUM MECHANICAL
ADJ	ADJUSTABLE	MFR	MANUFACTURER
ALUM ANNOD	ALUMINUM ANNODIZED	MIN MISC	MINIMUM MISCELLANEOUS
APPROX ARCH	APPROXIMATE ARCHITECT/ARCHITECTURAL	MTL	METAL
ASST	ASSISTANT	N	NORTH
ATFP AUTO	ANTI TERRORISM FORCE PROTECTION AUTOMATIC	N N.I.C.	NORTH NOT IN CONTRACT
AVG	AVERAGE	N.T.S. NO	NOT TO SCALE NUMBER
В		NOM	NOMINAL
BATT BD	BATT INSULATION BOARD	0	
BLDG BLK	BUILDING BLOCK	OC OD	ON CENTER OUTSIDE DIAMETER
BLKG	BLOCKING	OFF	OFFICE
BOT/BT M	BOTTOM	OH OH	OVERHEAD OPPOSITE HAND
BRG	BEARING	OPP	OPPOSITE
C	CONTROL JOINT	Р	DEDDINDIOLII AD
CL CJ	CENTER LINE	PERP PL	PERPINDICULAR PLATE
CLG CLR	CEILING CLEAR	PLAM PLBG.	PLASTIC LAMINATE PLUMBING
CMU	CONCRETE MASONRY UNIT	PLYWD	PLYWOOD
COL CONC	COLUMN CONCRETE	PNL PREFIN	PANEL PREFINISHED
CONST	CONSTRUCTION COORDINATE	PROJ	PROJECT
CORR	CORRIDOR	PSF PSI	POUNDS PER SQUARE FOOT POUNDS PER SQUARE INCH
CPT CT	CARPET CERAMIC TILE	PT PTD	PAINT PAPER TOWEL DISPENSER
CTRTOP	COUNTERTOP	PVMNT	PAVEMENT
CU.FT. CU.YD.	CUBIC FOOT CUBIC YARD	Q	
D		QC	QUALITY CONTROL
DBL DEMO	DOUBLE DEMOLISH	R RB	RUBBER BASE
DIA	DIAMETER	REF	REFERENCE
DIM DN	DIMENSION DOWN	REFRIG REINF	REFRIGERATOR REINFORCE
DS DW	DOWN SPOUT DISH WASHER	REQ'D	REQUIRED
DWGS	DRAWING/S	RM RO	ROUGH OPENING
E		RUB	RUBBER
E.W.C. EA	ELECTRICAL WATER COOLER EACH	S	SOUTU
EF EF	EXHAUST FAN	S SCHED	SOUTH SCHEDULED
EJ EL	EXPANSION JOINT ELEVATION	SECT SHT	SECTION SHEET
ELEC	ELECTRICAL	SIM	SIMILAR
ELEV EQ	ELEVATION EQUAL	SPEC SS	SPECIFICATION STAINLESS STEEL
EQUIP EXIST	EQUIPMENT EXISTING	STD STL	STANDARD STEEL
EXP	EXPANSION	STOR	STORAGE
EXT	EXTERIOR	STRU SUSP	STRUCTURE SUSPENDED
F F.F .	FINISH FLOOR	SYM	SYMMETRICAL
F/C	FACE OF CURB	Т	
FACP FD	FIRE ALARM CONTROL PANEL FLOOR DRAIN	THRSD TO	THRESHOLD TOP OF
FE	FIRE EXTINGUISHER	TOC	TOP OF CONCRETE
FEC FH	FIRE EXTINGUISHER CABINET FIRE HYDRANT	TOG TOM	TOP OF GRADE TOP OF MASONRY
FIN FLOUR	FINISH FLOURESCENT	TOS TV	TOP OF STEEL TELEVISION
FLR	FLOOR	TYP	TYPICAL
FT FTG	FEET FOOTING	U	
FV	FIELD VERIFY	U.L. UG	UNDERWRITERS LABORATORIES UNDERGROUND
G	ONIOE	UNO	UNLESS NOTED OTHERWISE
GA GALV	GAUGE GALVANIZED	UR	URINAL
GB GOV'T	GRAB BAR GOVERNMENT	∨ ∨ СТ	VINYL COMPOSITE TILE
GWB	GYPSUM WALL BOARD	VENT	VENTILATION
GYP	GYPSUM	VERT VIF	VERTICAL VERIFY IN FIELD
Н	HANDICAD ACCESSIBLE	VOL	VOLUME
H.C. HCW	HANDICAP ACCESSIBLE HOLLOW WOOD CORE	VTR VWC	VENT THROUGH ROOF VINYL WALL COVERING
HDWE HGT	HARDWARE HEIGHT	W	
НМ	HOLLOW METAL HORIZONTIAL	W/	WITHOUT
HORZ HVAC	HEATING VENTIALTION AND AIR CONDITIONING	W/O WC	WITHOUT WATER CLOSET
1		WD WP	WOOD WORKING POINT
ID	INSIDE DIAMETER	WT	WEIGHT
IN INSUL	INCH INSULATION	X	
INT	INTERIOR	XFMR	TRANSFORMER
J J -BOX	JUNCTION BOX	Y YD	YARD
J-BOX JAN	JANITOR	טז	וחוע
JST JT	JOIST JOINT		
L			
LAB	LABORATORY		
LAV LBS/LB	LAVATORY POUNDS/POUND		
LF	LINEAR FEET		

LIGHT

LTG LIGHTING

REVISION:

FOR REVIEW & FILING NOT FOR CONSTRUCTION



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Sigma Prime Geosciences, Inc.: Half Moon Bay, California

STRUCTURAL:

Alex Lau Engineering: C 75773, San Francisco, California

CLIENT:

Elle and Ivan Li

1855 Sunshine Valley Road, Moss Beach, California 94038

PROJECT NAME: PROJECT NO:

1802 **Sunshine Valley** Residence

PROJECT

APN 037156130, Sunshine Valley Road Moss Beach, California 94038 ADDRESS:

PROJECT PHASE: Construction Documents

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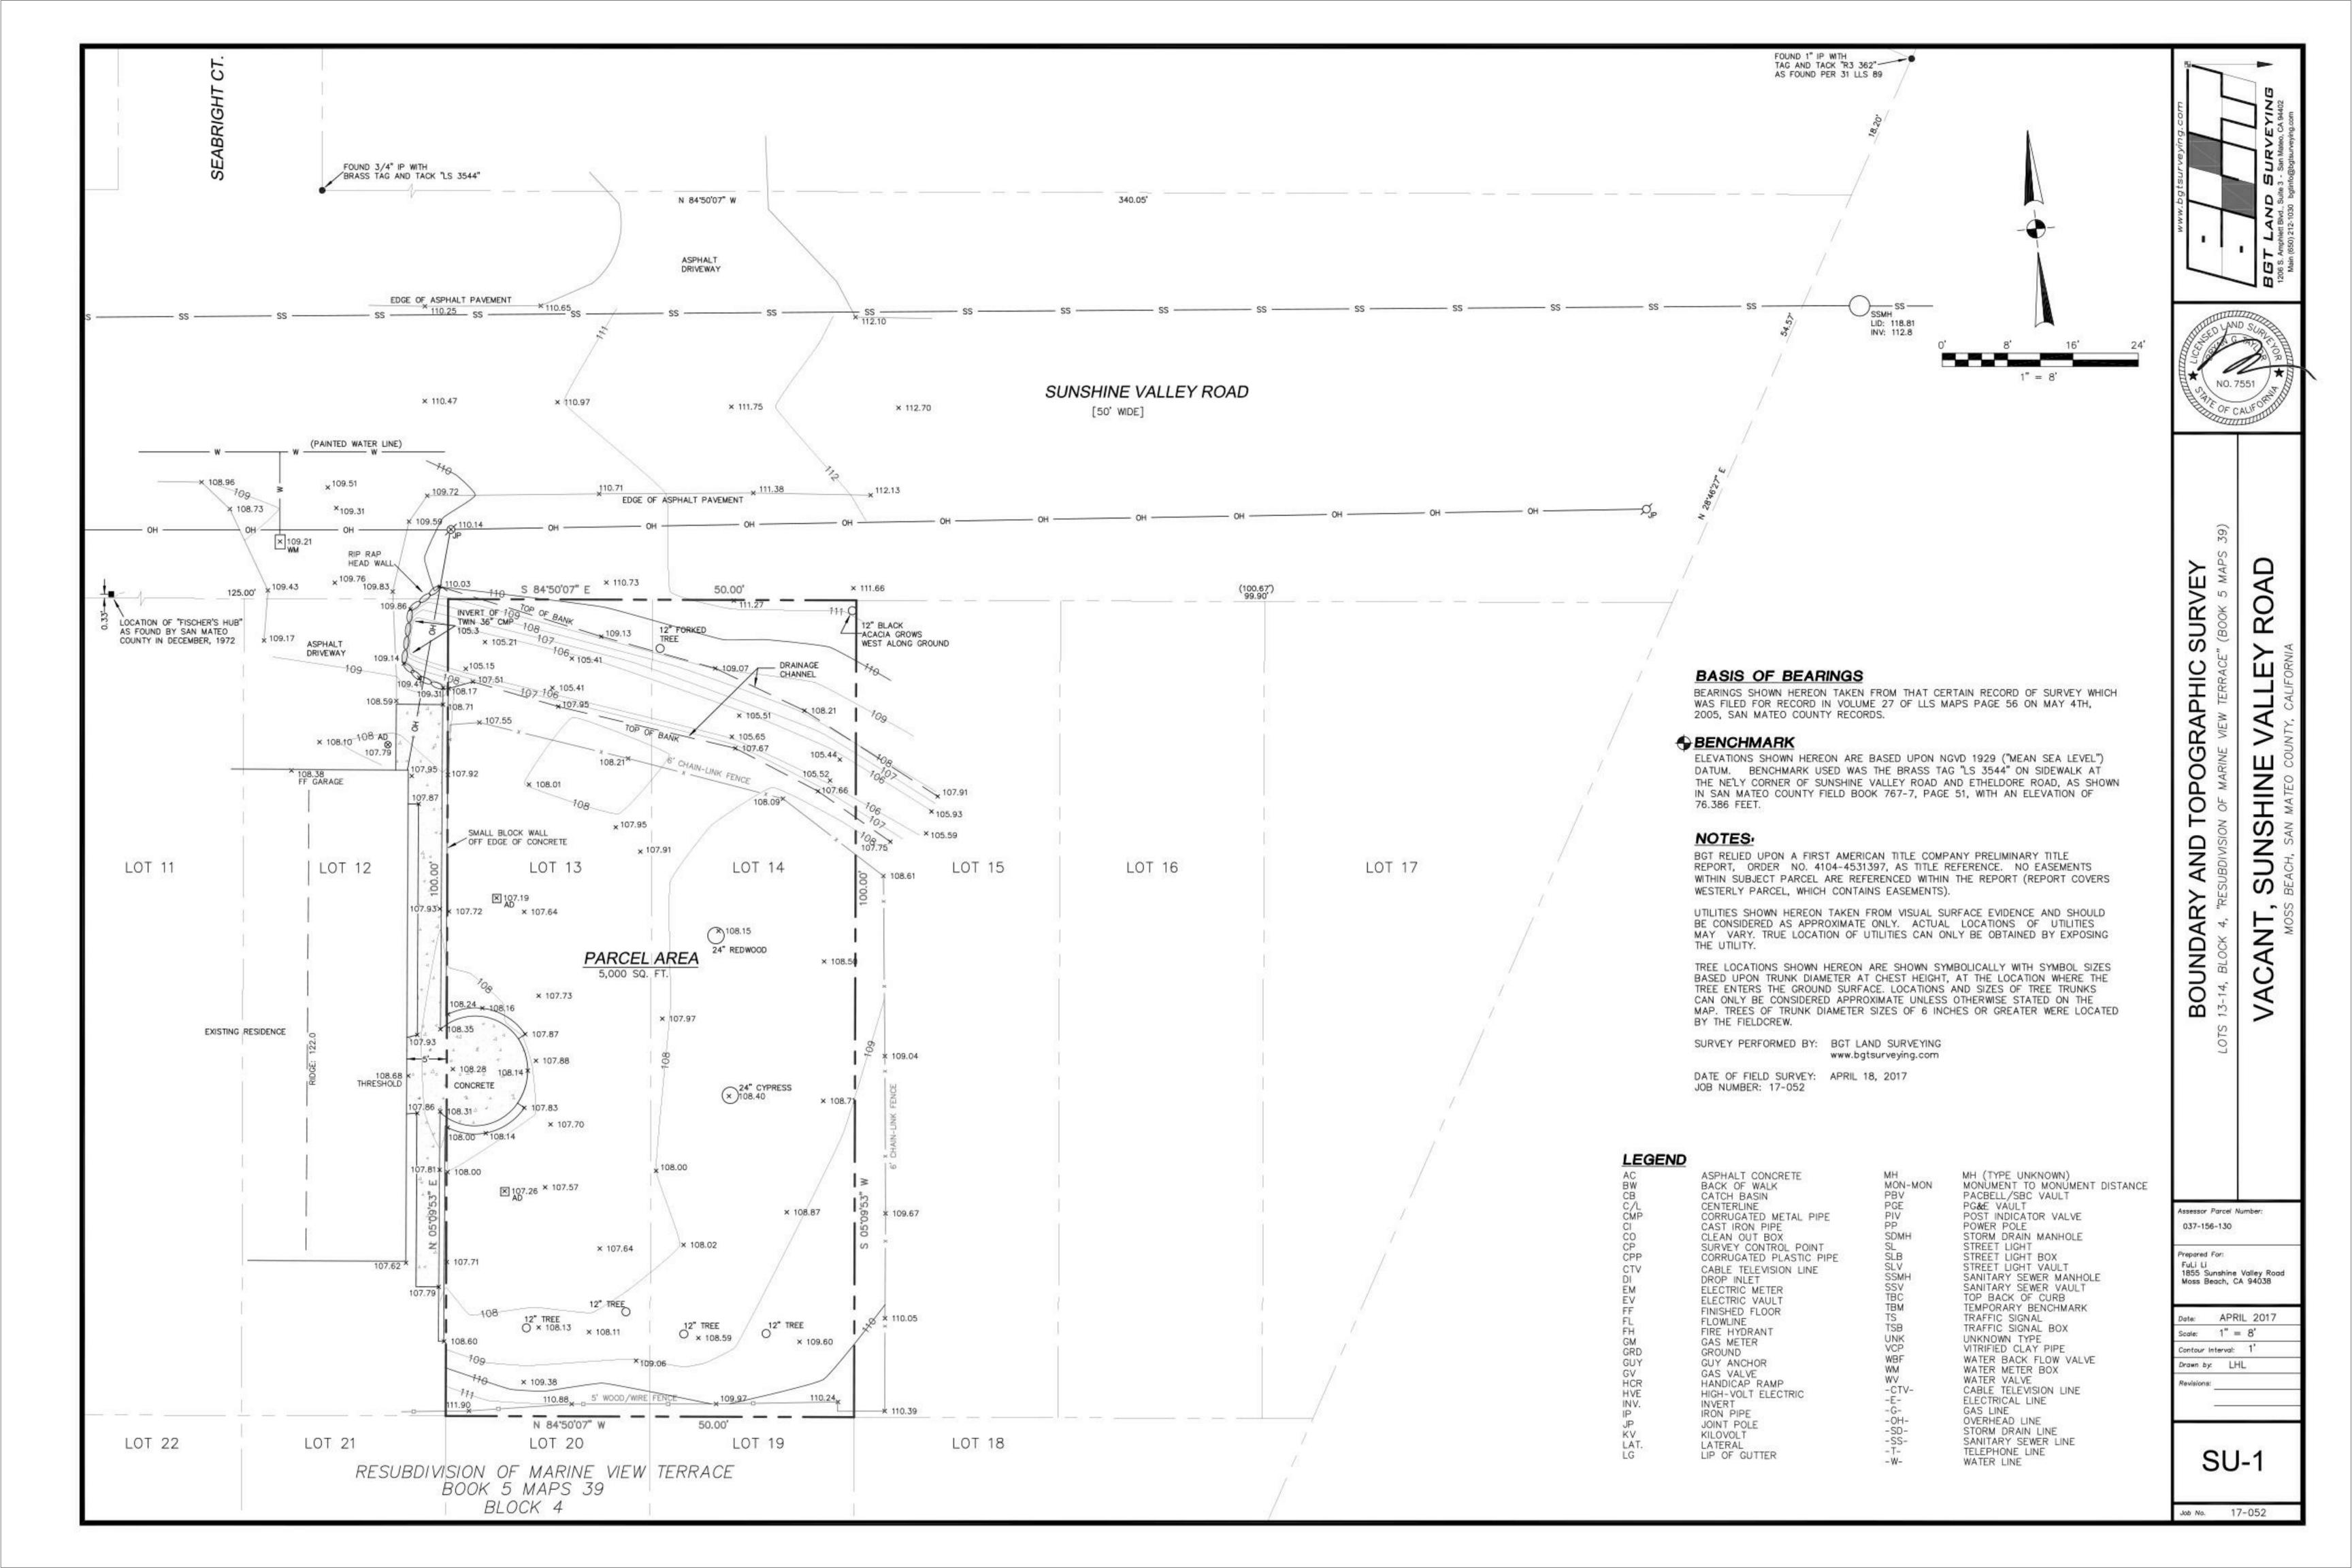
ISSUE DATE: DRAWING TITLE: **GENERAL NOTES**


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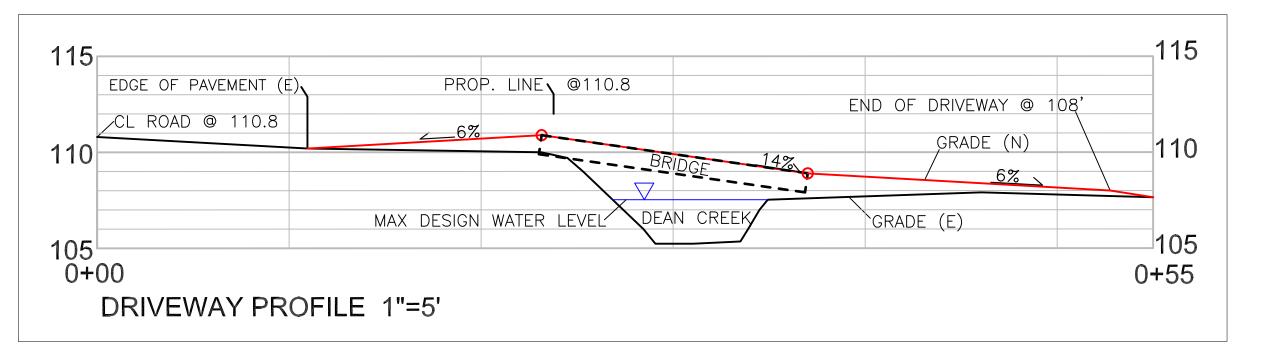
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LEGEND

 $\sqrt{111.27}$ EXISTING SPOT ELEVATION PROPOSED SPOT ELEVATION



GENERAL NOTES

- 1. PLANS PREPARED AT THE REQUEST OF:
- FULI LI, OWNER 2. TOPOGRAPHY BY BGT LAND SURVEYING, SURVEYED 4-18-17.
- 3. THIS IS NOT A BOUNDARY SURVEY.
- 4. ELEVATION DATUM: NGVD29.

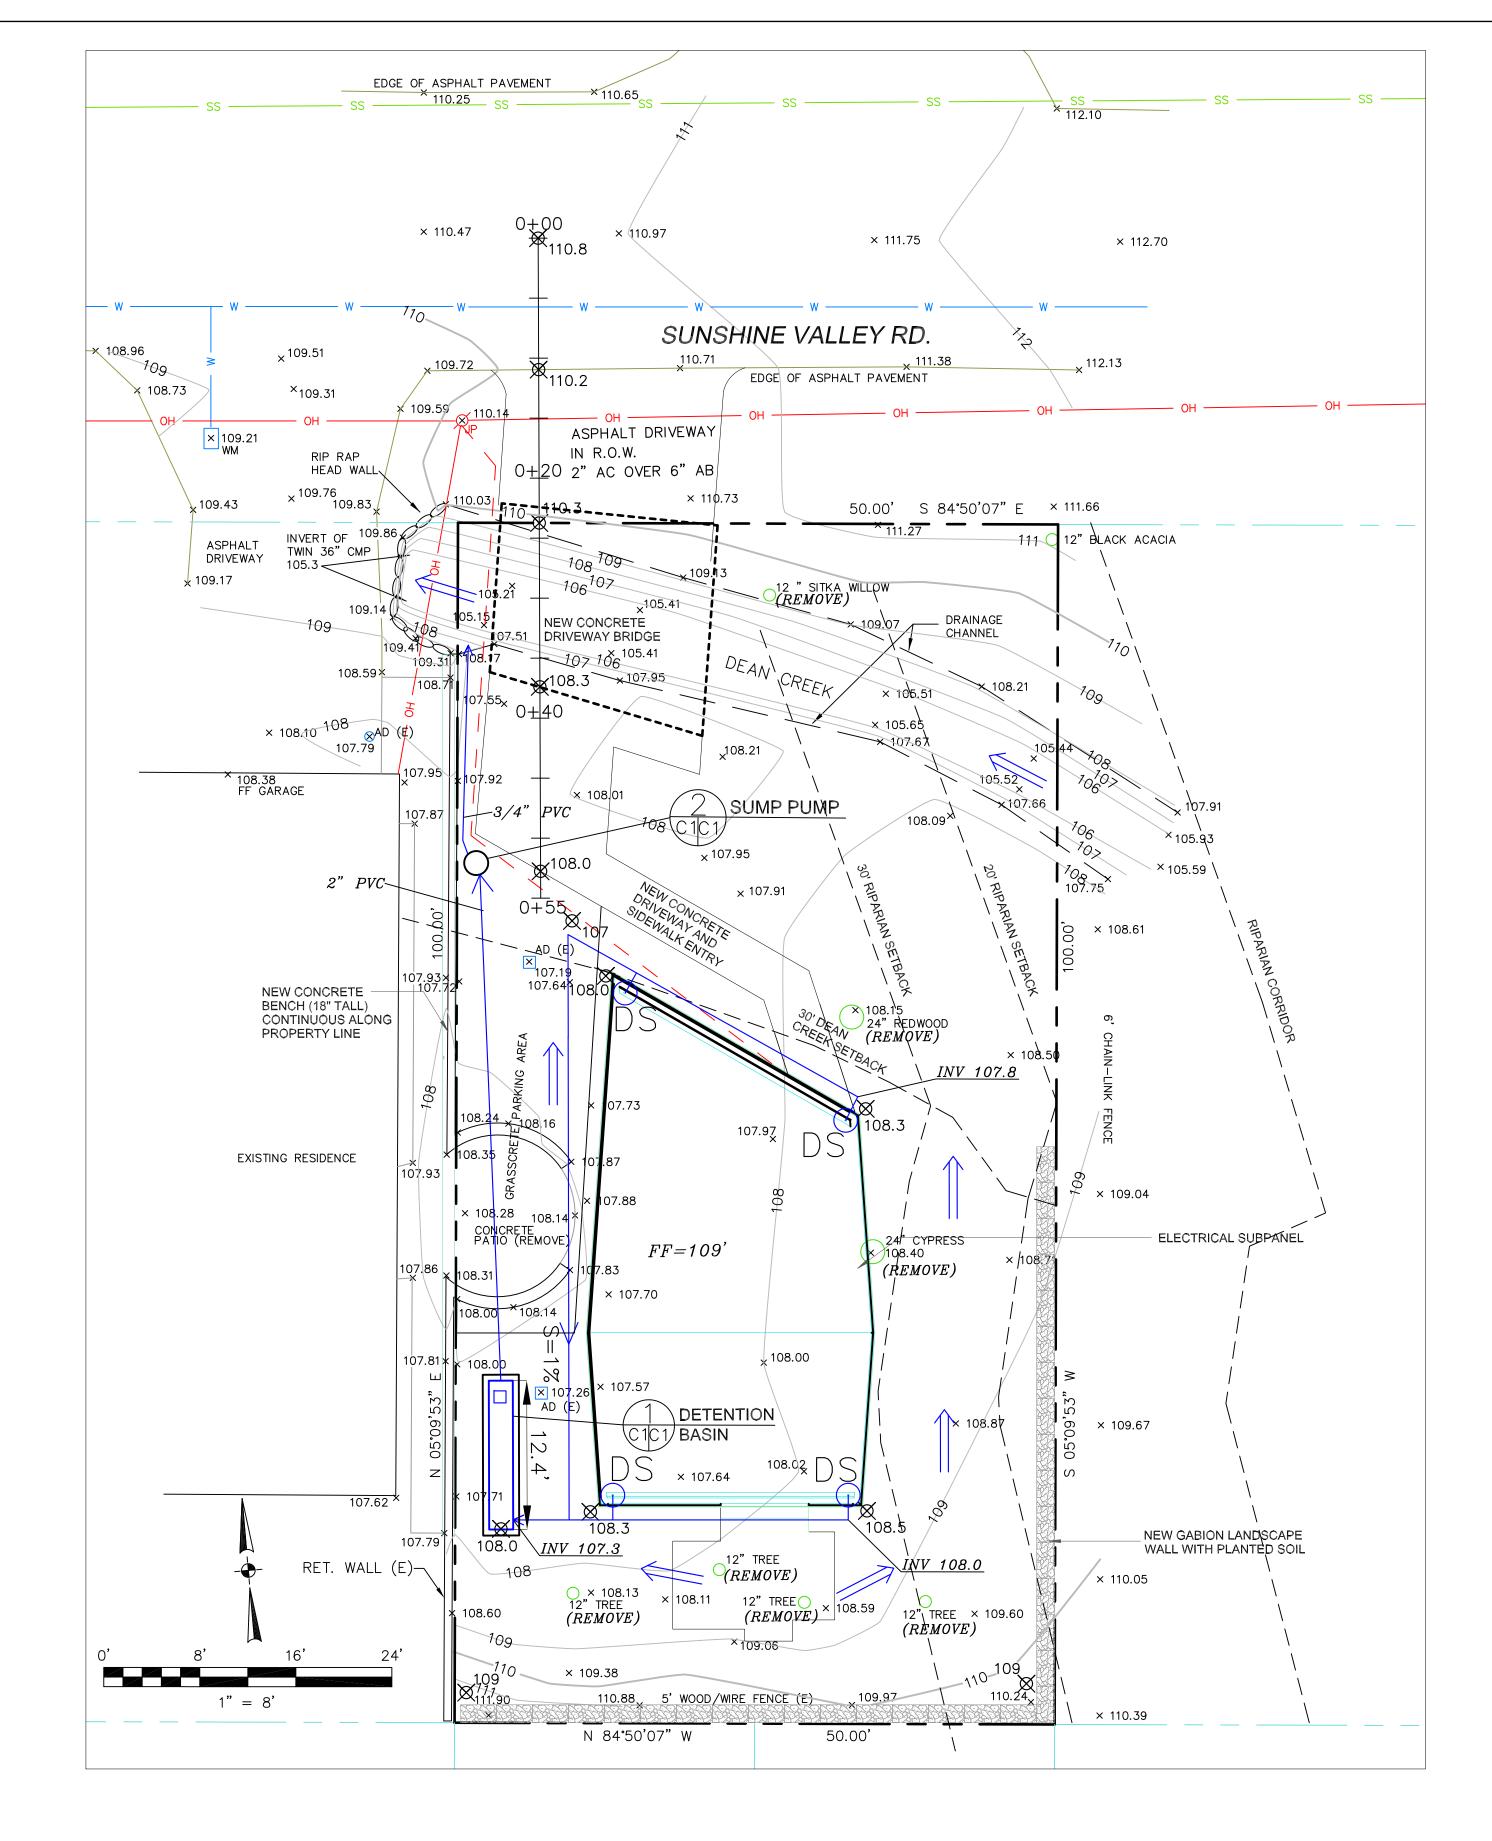AND ONE FOR FINAL WALK AROUND.

5. THE GEOTECHNICAL REPORT: GEOTECHNICAL STUDY, UPDATE GEOTECHNICAL INVESTIGATION, PROPOSED SINGLE FAMILY RESIDENCE, 1855 SUNSHINE VALLEY ROAD, MOSS BEACH CALIFORNIA. DATED: MAY 5 201, BY WAYNE TING AND ASSOCIATES PROJECT NO. 5264 SHALL BE RETAINED ON THE CONSTRUCTION SITE. THE GEOTECHNICAL ENGINEER OF RECORD IS WAYNE TING AND ASSOCIATES, WITH THE CONTACT NUMBER (510)-623-7768; WAYNE@WAYNETING.NET). THE CONTRACTOR MUST SHALL NOTIFY THE GEOTECHNICAL ENGINEER OF RECORD AT LEAST 48 HOURS BEFORE CONSTRUCTION OF GEOTECHNICAL RELATED WORK. THE GEOTECHNICAL PART OF CONSTRUCTION WORK, INCLUDING BUT NOT LIMITED TO, ALL THE EARTHWORK AND FOUNDATION CONSTRUCTIONS MUST SHALL BE APPROVED BY THE GEOTECHNICAL ENGINEER OF RECORD 6. STORMWATER MANAGEMENT CONSTRUCTION INSPECTIONS SHALL BE SCHEDULED FOR APPLICABLE DRAINAGE INSPECTIONS, WHICH INCLUDE SITE CLEARANCE AND EROSION CONTROL MEASURES INSTALLATION AS WELL AS INSPECTION OF MAJOR DRAINAGE CONTAINMENT, TREATMENT, AND CONVEYANCE DEVICES BEFORE BEING BURIED (INCLUDING REQUIRED MATERIAL LABELS, E.G. PIPES, SUG-BGRADE MATERIALS, ETC.). PLEASE FOLLOW THE INSPECTION CARD INSTRUCTIONS AND PHONE NUMBER

(650-306-8405 EXT 181) TO SCHEDULE COUNTY DRAINAGE INSPECTIONS ACCORDINGLY. THERE SHALL BE THREE INSPECTIONS: ONE FOR EROSION

CONTROL INSTALLATION. ONE BEFORE DRAINAGE FACILITIES ARE BURIED.

DRAINAGE NOTES

1. DRAINAGE INTENT: IT IS THE INTENT OF THE DRAINAGE SYSTEM TO CONVEY ROOF RUNOFF TO A SAFE LOCATION, AND TO MINIMIZE EXCESSIVE MOISTURE AROUND FOUNDATIONS. SLOPE ALL IMPERVIOUS SURFACES A MINIMUM OF 2% AWAY FROM BUILDING. DIRECT SLOPES SUCH THAT STORMWATER WILL NOT BE DIVERTED ONTO ADJACENT PROPERTIES.

2. ALL DOWNSPOUT DRAIN LINES SHALL LEAD TO DETENTION BASIN, AS

3. ALL ROOF DRAINAGE PIPES SHALL BE 4" DIAMETER SOLID PIPE, SLOPED AT 1% MINIMUM.

4. IT IS THE PROPERTY OWNER'S RESPONSIBILITY TO CHECK ON ALL STORMWATER FACILITIES SUCH AS ROOF GUTTERS, DOWNSPOUT LINES, AND THE FLOW-THROUGH PLANTER/SUMP PUMP TO BE SURE THAT THEY ARE CLEAR OF EXCESSIVE DEBRIS AND OPERATING EFFICIENTLY. THE FACILITIES SHALL BE CHECKED EVERY FALL AND PERIODICALLY DURING THE RAINY SEASON.

GRADING NOTES

CUT VOLUME: 40 CY (FOR FOUNDATION, BACK-YARD GABION) FILL VOLUME: 10 CY

VOLUMES ABOVE ARE APPROXIMATE.

THE SUBGRADE BELOW ALL PAVED AREAS SHALL BE BASEROCK COMPACTED TO 95%.

ALL GRADING SHALL CONFORM TO LOCAL CODES AND ORDINANCES.


ALL TRENCHES UNDER PROPOSED PAVED AREAS OR CONCRETE SHALL BE BACKFILLED TO SUBGRADE ELEVATION WITH COMPACTED APPROVED GRANULAR MATERIALS. IF TRENCHES ARE IN PROPOSED LANDSCAPE AREAS, THEY SHALL BE BACKFILLED WITH COMPACTED APPROVED GRANULAR MATERIAL TO WITHIN ONE FOOT OF FINISHED GRADE, AND THEN FILLED WITH HAND TAMPED SOILS.

UTILITY NOTES

1. DETAILED UTILITY PLAN WILL BE SUBMITTED SEPARATEY FOR SUBMITTAL TO AND APPROVAL BY BY THE MONTARA WATER AND SANITARY DISTRICT.

2. ALL UTILITIES TO HOUSE WILL BE UNDERGROUND AND ATTACHED TO BRIDGE TO CROSS DEAN CREEK.

3. SEWER LATERAL WILL REQUIRE AN EJECTOR PUMP. LATERAL SHALL BE ENCASED IN A STEEL PIPE WHERE IT IS ATTACHED TO THE BRIDGE.

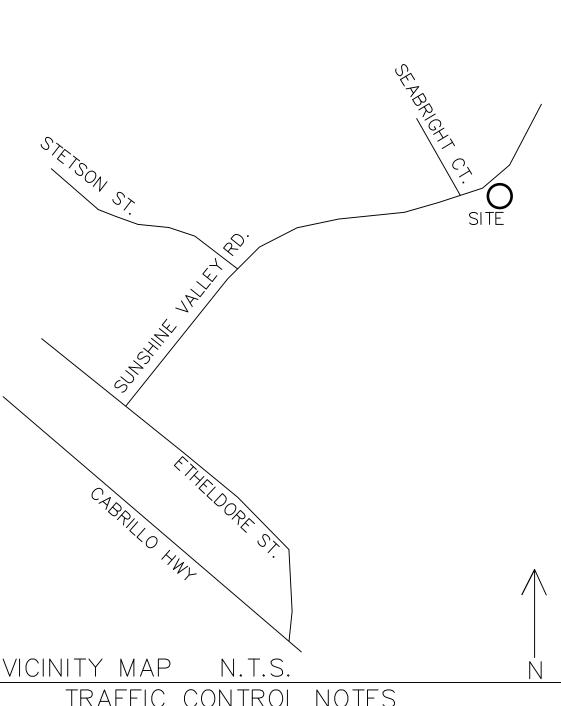

TRAFFIC CONTROL NOTES

1. CONTRACTOR AND WORKERS SHALL PARK ON SHOULDER OF STREET.

2. WHEN TRUCKS PARK IN DRIVEWAY FOR DELIVERY OF SUPPLIES AND CONCRETE, EVERY EFFORT SHALL BE MADE TO PROVIDE ROOM FOR VEHICLES TO PASS.

3. WORKERS SHALL PROVIDE TRAFFIC CONTROL ON SUNSHINE VALLEY ROAD WHEN TRUCKS ARE BACKING ONTO STREET.

SECTION AND DETAIL CONVENTION

SECTION OR DETAIL IDENTIFICATION REFERENCE SHEET No. ON REFERENCE SHEET No. FROM WHICH SECTION OR DETAIL IS TAKEN DETAIL IS SHOWN

No. 62264

ROA


SUNSF


AND PLAN


GRADING)RAINAGE


SHEET

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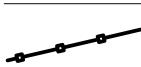


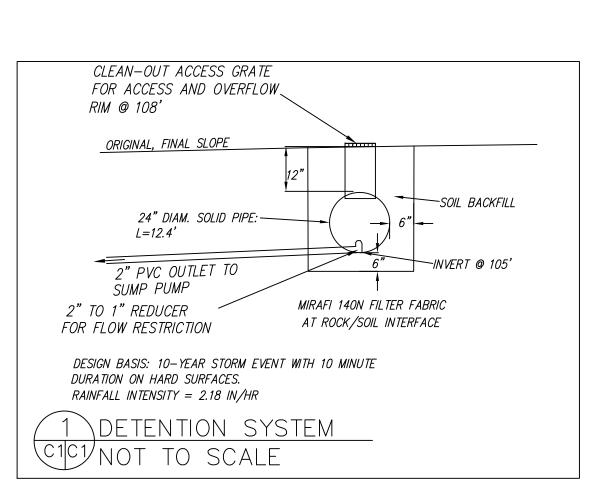

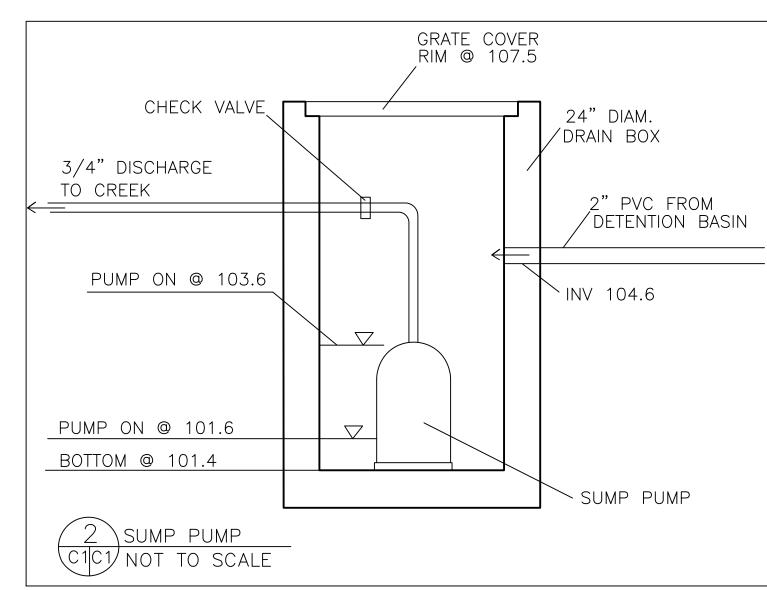

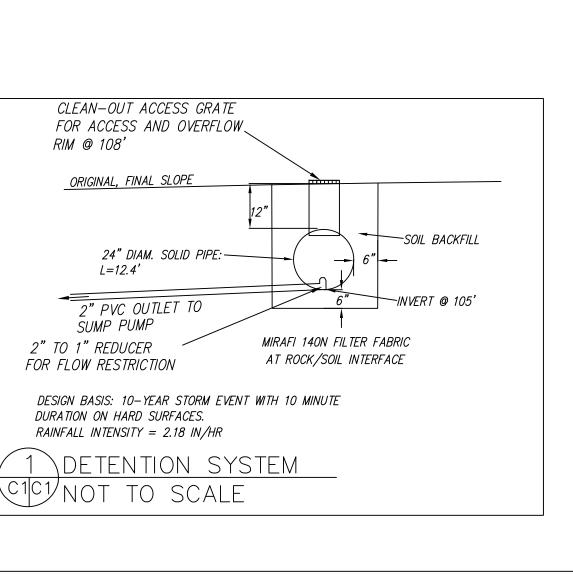

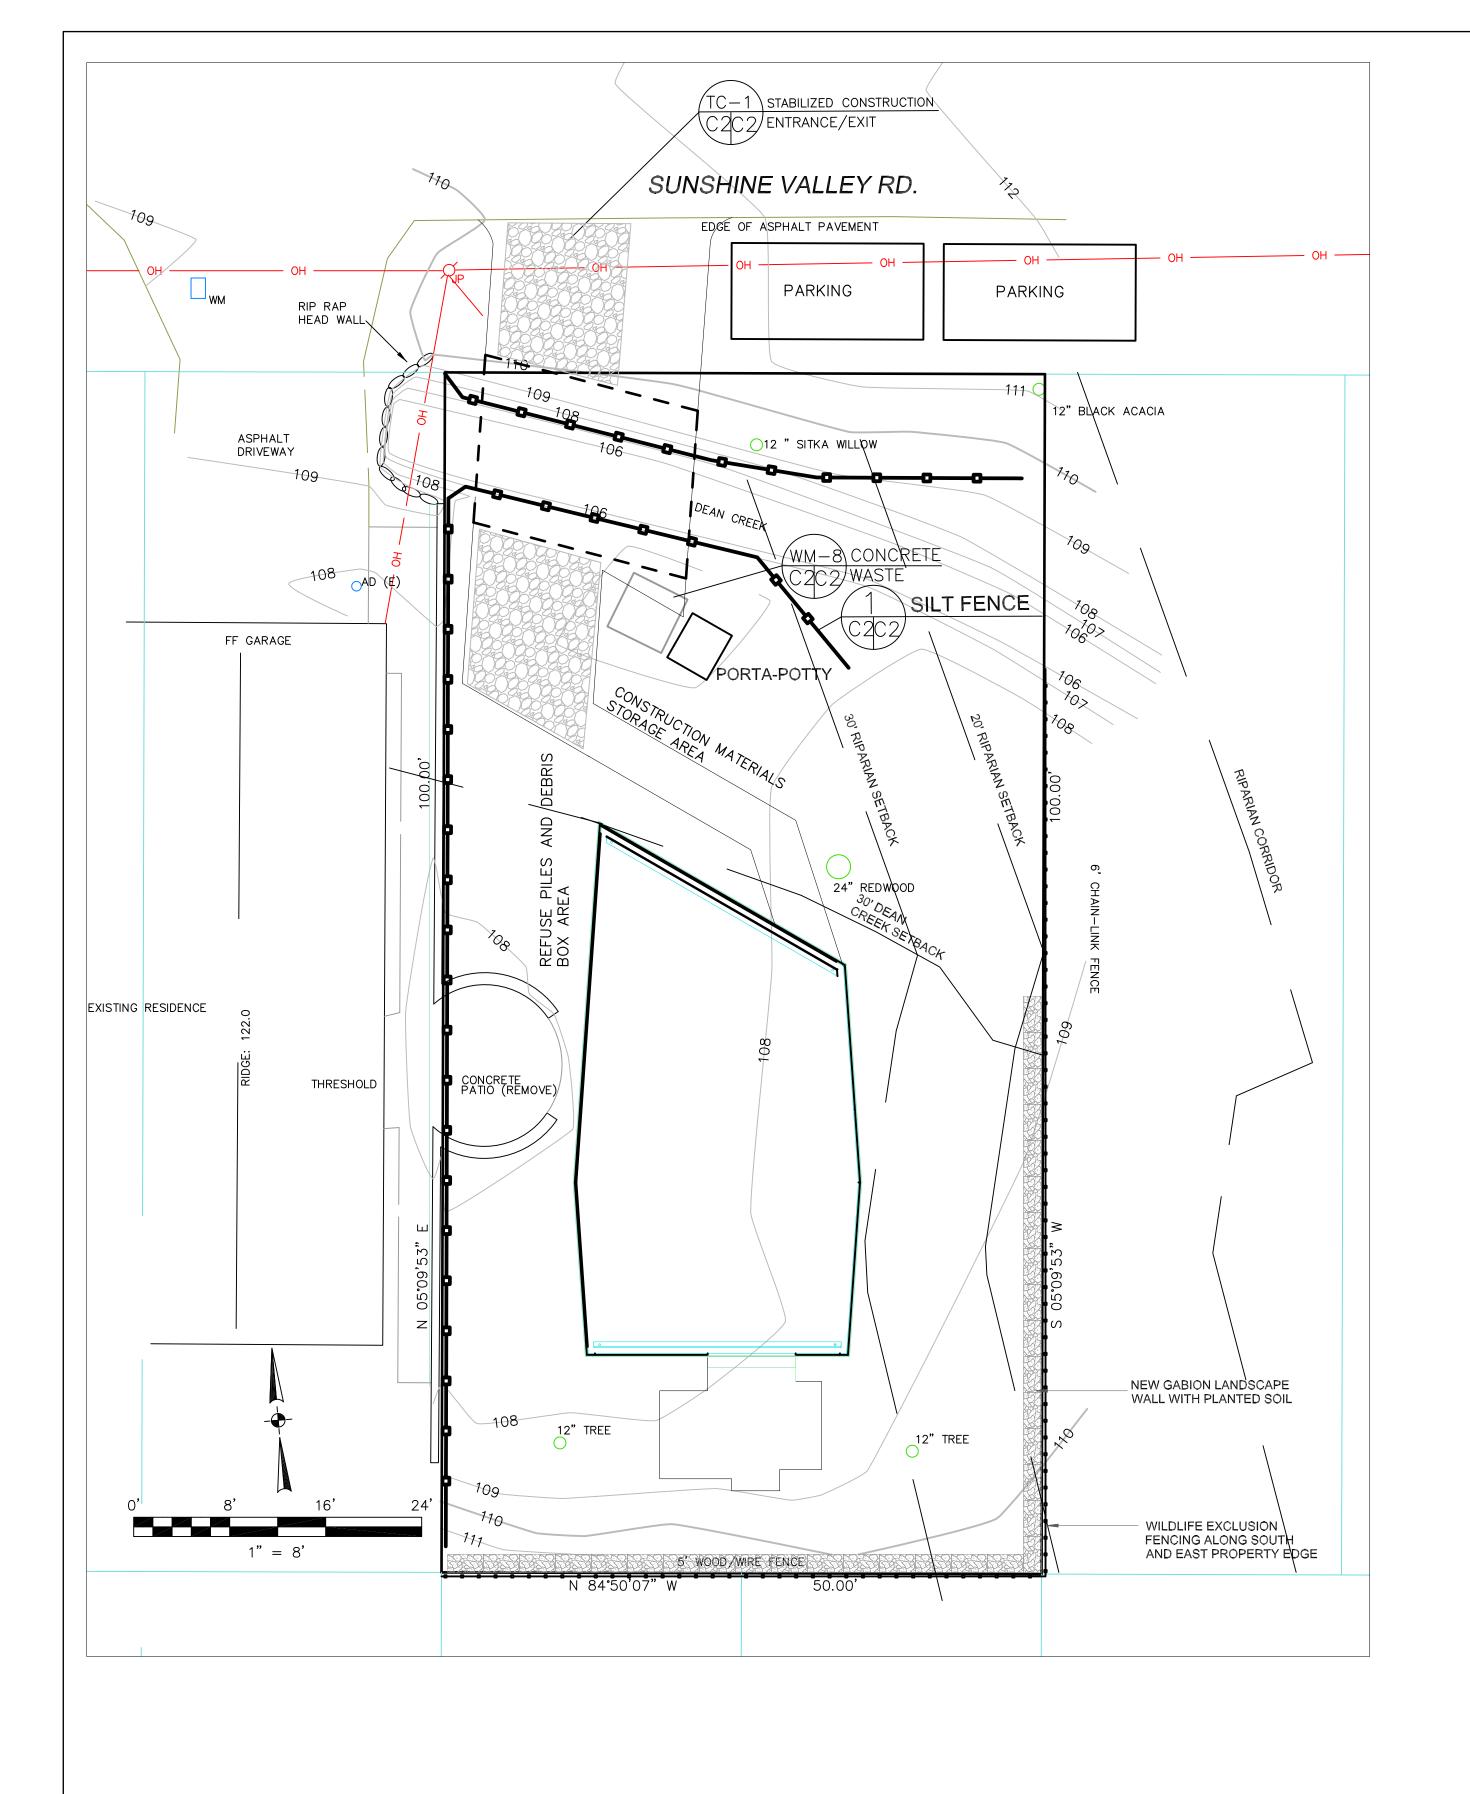EROSION CONTROL NOTES



INSTALL AT LOCATIONS SHOWN. AFIX AS SHOWN IN DETAIL 4 1. GRADING MAY TAKE PLACE DURING WET WEATHER AFTER OCTOBER 1 PROVIDED THE

FOLLOWING PROVISIONS ARE FOLLOWED. 2. NO GRADING SHALL TAKE PLACE DURING RAINY WEATHER OR FOR A PERIOD OF AT

LEAST 24 HOURS FOLLOWING RAIN. 3. ALL EXPOSED SOIL SHALL BE TEMPORARILY PROTECTED FROM EROSION WITH JUTE

4. ALL STOCKPILED SOIL SHALL BE COVERED AT ALL TIMES AND REMOVED FROM SITE

AS SOON AS POSSIBLE, IF SCHEDULED FOR OFF-HAUL. 5. ALL EXPOSED SURFACES SHALL BE PERMANENTLY PROTECTED FROM EROSION WITH SEEDING AND/OR LANDSCAPING. SEED MIX SHALL BE 75 LB PER ACRE ANNUAL RYGRASS OR APPROVED SUBSTITUTE. SEED SHALL BE COVERED WITH STRAW MULCH AT A RATE OF 2 TONS/ACRE.

6. ROCKED CONSTRUCTION ENTRANCE SHALL CONFORM TO THE FOLLOWING: A. THE MATERIAL FOR THE PAD SHALL BE 3 TO 6 INCH STONE.

B. PAD SHALL BE NOT LESS THAN 12" THICK.

C. THE ENTRANCE SHALL BE MAINTAINED IN A CONDITION THAT WILL PREVENT TRACKING OR FLOWING OF SEDIMENT ONTO PUBLIC RIGHT-OF-WAY. THIS MAY REQUIRE PERIODIC TOP DRESSING WITH ADDITIONAL STONE AS CONDITIONS DEMAND, AND REPAIR AND/OR CLEANOUT OF ANY MEASURES USED TO TRAP SEDIMENT. ALL

SEDIMENT SPILLED, DROPPED, WASHED, OR TRACKED ONTO PUBLIC RIGHT-OF-WAY SHALL BE REMOVED IMMEDIATELY. D. WHEN NECESSARY, WHEELS SHALL BE CLEANED TO REMOVE SEDIMENT PRIOR TO

ENTRANCE ONTO PUBLIC RIGHT-OF-WAY. WHEN WASHING IS REQUIRED, IT SHALL BE

DONE ON AN AREA THAT DRAINS TO THE CONCRETE WASHOUT AREA. 7. CONCRETE WASHOUT AREA SHALL BE SURROUNDED BY A SINGLE LAYER OF SAND BAGS TO CONTAIN FLUIDS. CHANNEL INTO AREA SHALL BE CLEARED TO ALLOW TIRE DEBRIS (SEE NOTE 6.D. ABOVE)

> PLAN NOT TO SCALE TYPE "ABOVE GRADE" WITH STRAW BALES

NATIVE MATERIAL— (OPTIONAL)

C2C2 NOT TO SCALE

-STRAW BALE

(must be completely covered by plastic lining)

1. ACTUAL LAYOUT DETERMINED IN FIFLD

GENERAL EROSION AND SEDIMENT CONTROL NOTES

- There will be no stockpiling of soil. All excavated soil will be hauled off-site as it is excavated.
- Perform clearing and earth-moving activities only during dry weather. Measures to ensure adequate erosion and sediment control shall be installed prior to earth-moving activities and construction.
- Erosion control materials to be on-site during off-season.
- Measures to ensure adequate erosion and sediment control are required year-round. Stabilize all denuded areas and maintain erosion control measures continuously between October 1 and April 30.
- · Store, handle, and dispose of construction materials and wastes properly, so as to prevent their contact with stormwater.
- · Control and prevent the discharge of all potential pollutants, including pavement cutting wastes, paints, concrete, petroleum products, chemicals, wash water or sediments, and non-stormwater discharges to storm drains and watercourses.
- · Avoid cleaning, fueling, or maintaining vehicles on-site, except in a designated area where wash water is contained and treated
- · Limit and time applications of pesticides and fertilizers to prevent polluted runoff.
- · Limit construction access routes to stabilized, designated access points
- · Avoid tracking dirt or other materials off-site; clean off-site paved areas and sidewalks using dry sweeping methods.
- · Train and provide instruction to all employees and subcontractors regarding the Watershed
- Protection Maintenance Standards and construction Best Management Practices.
- · Placement of erosion materials is required on weekends and during rain events.
- The areas delineated on the plans for parking, grubbing, storage etc., shall not be enlarged or "run over."
- · Dust control is required year-round.
- · Erosion control materials shall be stored on-site

EROSION CONTROL POINT OF CONTACT

• The tree protection shall be in place before any grading, excavating or grubbing is started.

8-MWCONCRETE WASTE MANAGEMENT THIS PERSON WILL BE RESPONSIBLE FOR EROSION CONTROL AT THE SITE AND WILL BE THE COUNTY'S MAIN POINT OF CONTACT IF CORRECTIONS ARE REQUIRED. NAME:____FULI LI__ TITLE/QUALIFICATION: OWNER E-MAIL: ____LIFULI.ELLE@GMAIL.COM_ STAPLE DETAIL

CONSTRUCTION SCHEDULE

DAY 1: INSTALL EROSION CONTROL

DAY 2: COMMENCE WORK WITH SITE CLEARING

DAY 5: INSTALL ROCKED CONSTRUCTION ENTRANCE WEEK 2: FINISH ROUGH GRADING

WEEK 3: BEGIN PIER DRILLING FOR FOUNDATIONS


WEEK 4: POUR CONCRETE IN PIER HOLES, BEGIN BUILDING FORMS FOR GRADE


WEEK 6: BEGIN FRAMING


MONTH 3: FINISH SHELL OF HOUSE MONTH 8: FINISH MOST OF HOUSE INTERIOR

MONTH 9: FINISH PATIOS, WALKWAYS, DRIVEWAY, OTHER EXTERIOR FLAT

MONTH 10: FINISH PROJECT

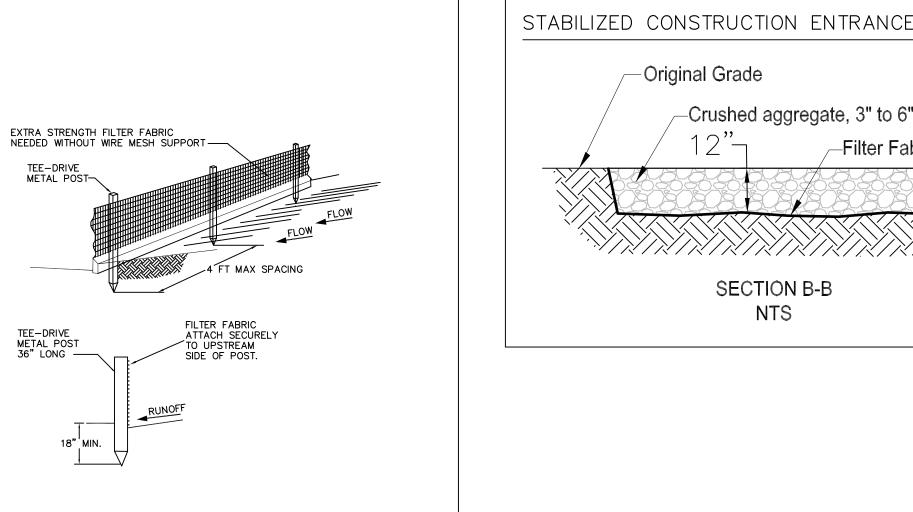

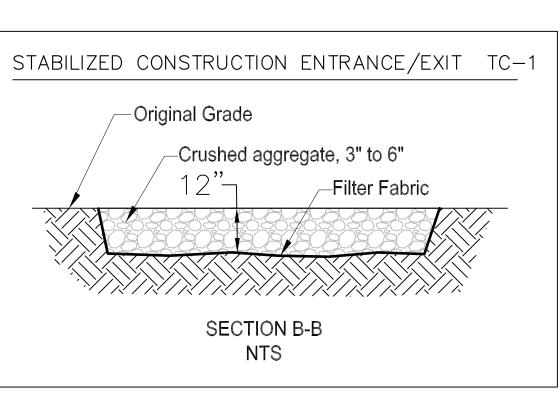


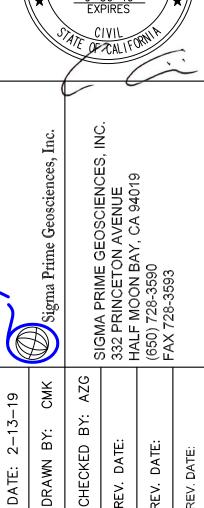


AD SEDIMENT PLAN R 0

SHEET

C-2

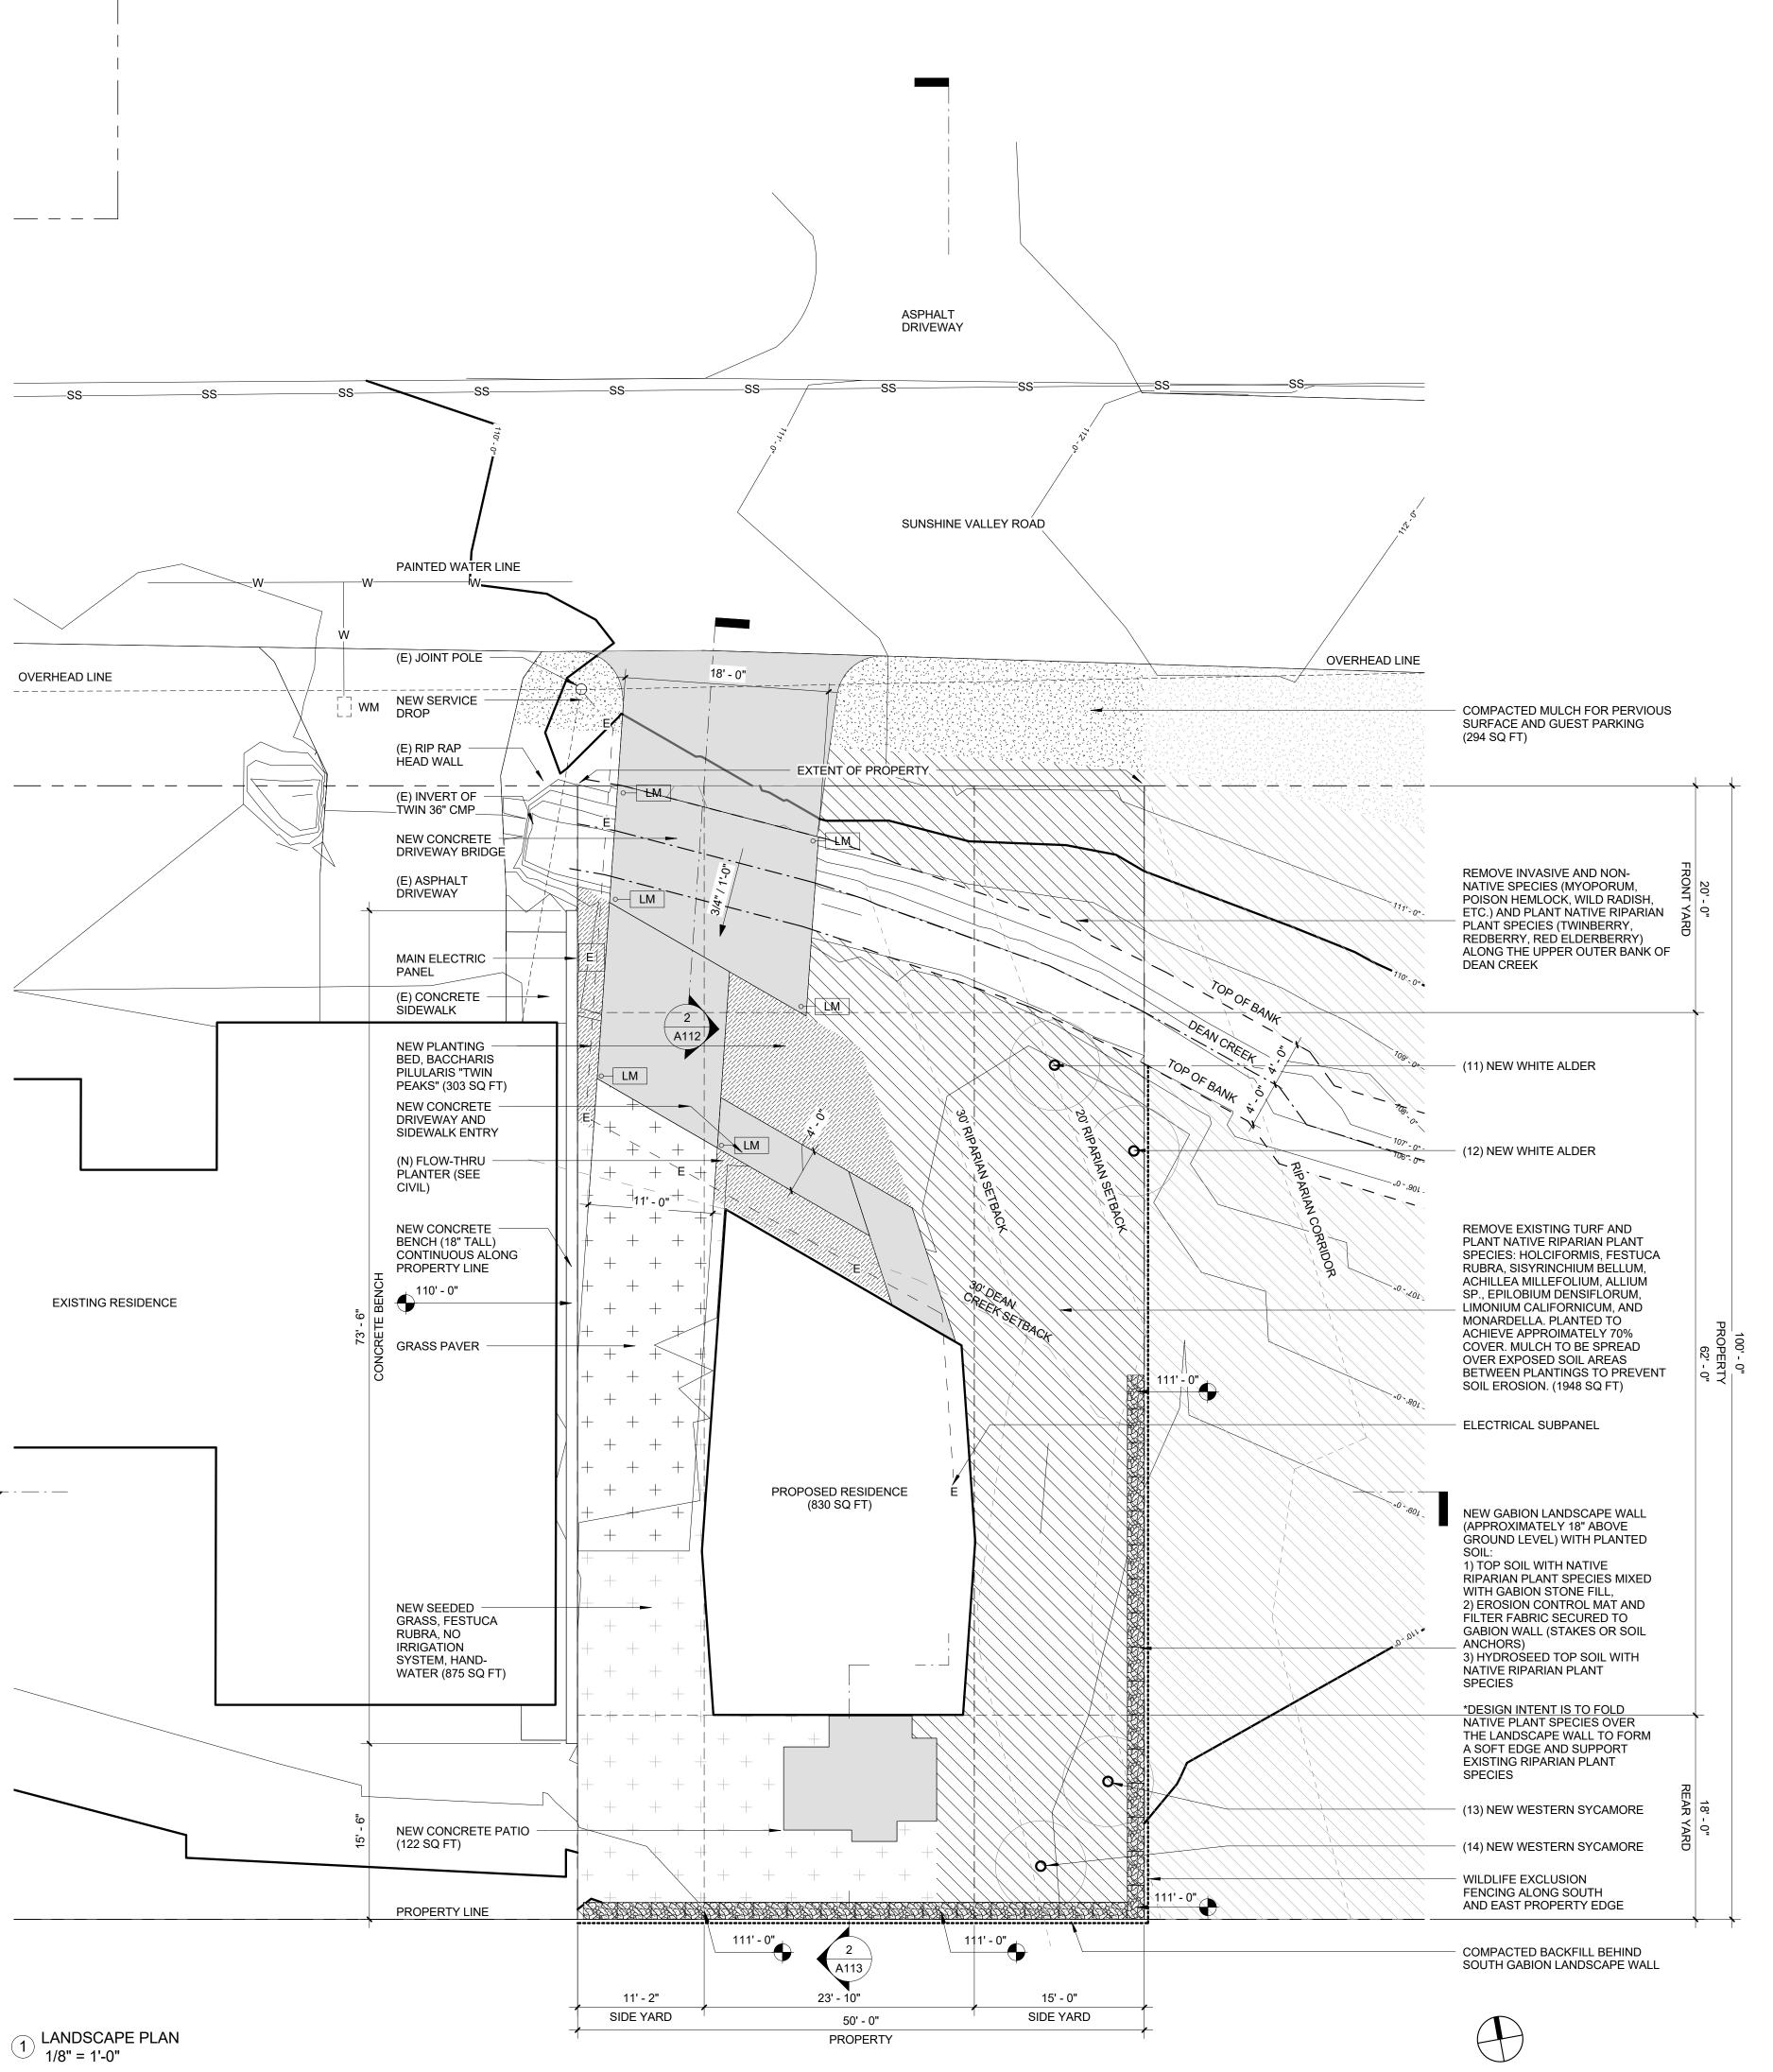

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EXTERIOR LIGHTING SCHEDULE:

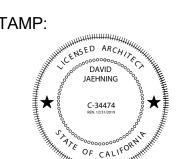LM - LIGMAN LIGHT LINEAR PT BOLLARD UL1-10021, 3500K
LL - NEMALUX GS, 3500K

GENERAL NOTES:

1) A MININUM 3-INCH LAYER OF MULCH SHALL BE APPLIED TO ALL EXPOSED SOIL SURFACES OF PLANTING AREAS EXCEPT TURF AREAS, CREEPING OR ROOT GROUNDCOVERS, OR DIRECT SEEDING APPLICATIONS WHERE MULCH IS CONTRAINDICATED.

2) TURF AREA SHALL NOT EXCEED 25% OF THE LANDSCAPE AREA IN RESIDENTIAL

3) AT THE TIME OF FINAL INSPECTION, THE PERMIT APPLICANT MUST PROVIDE THE OWNER OF THE PROPERTY WITH A CERTIFICATE OF COMPLETION, CERTIFICATE OF INTSTALLATION, IRRIGATION SCHEDULE OF LANDSCAPE AND IRRIGATION MAINTENANCE.

4) UNLESS CONTRADICTED BY A SOILS TEST, COMPOST AT A RATE OF A MINUMUM FOR FOUR CUBIC YARDS PER 1,000 SQUARE FEET OF PERMEABLE AREA SHALL BE INCORPORATED TO A DEPTH OF SIX INCES INTO THE SOIL.

5) PROJECT MUST INCORPORATE COMPOST AT A RATE OF AT LEAST 4 CUBIC YARDS PER 1,000 SQ FT TO A DEPTH OF 6 INCHES INTO LANDSCAPE AREA.

6) IN RESPONSE TO WATER EFFICIENT LANDSCAPE ORDINANCE (WELO): NO IRRIGATION SYSTEM PROVIDED.

LOT COVERAGE:

BUILDING: 830 SF HARDSCAPE: 786 SF TOTAL IMPERVOIUS: 1616 SF (32%)

MATERIAL AREAS:

LANDSCAPE AREA (REHABILITATED): 2206 SF LANDSCAPE AREA (TURF & PLANT): 1178 SF TOTAL PERVIOUS: 3384 (68%)

NO.	EXIST/NEW	DBH	GENUS SPECIES	COMMON NAME
01	EXISTING	7"	MYOPORUM LAETUM	NGAIO (SHRUB)
02	EXISTING	12"	SALIX LASIOLEPIS	ARROYO WILLOW
03	EXISTING	26"	SEQUOIA SEMPERVIRENS	COASTAL REDWOOD
04	EXISTING	26"	HESPEROCYPARIS MACROCARPA	MONTEREY CYPRESS
05	EXISTING	6"	MYOPORUM LAETUM	NGAIO (SHRUB)
06	EXISTING	16"	MYOPORUM LAETUM	NGAIO (SHRUB)
07	EXISTING	14"	MYOPORUM LAETUM	NGAIO (SHRUB)
08	EXISTING	12"	MYOPORUM LAETUM	NGAIO (SHRUB)
09	EXISTING	14"	MYOPORUM LAETUM	NGAIO (SHRUB)
10	EXISTING	12"	MYOPORUM LAETUM	NGAIO (SHRUB)
11	NEW	6"	ALNUS RHOMBIFOLIA	WHITE ALDER
12	NEW	6"	ALNUS RHOMBIFOLIA	WHITE ALDER
13	NEW	6"	PLATANUS RACEMOSA	WESTERN SYCAMORE
14	NEW	6"	PLATANUS RACEMOSA	WESTERN SYCAMORE

*SEE ARBORIST REPORT FOR DETAILED INFORMATION

ARCHITECT:

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BIOLOGICAL:

SWCA Environmental Consultants: Half Moon Bay, California

Sigma Prime Geosciences, Inc.: Half Moon Bay, California

STRUCTURAL: Alex Lau Engineering: C 75773, San Francisco, California

CLIENT:

Elle and Ivan Li

1855 Sunshine Valley Road, Moss Beach, California 94038

PROJECT NO: PROJECT NAME:

1802 Sunshine Valley Residence

PROJECT APN 037156130, Sunshine Valley Road ADDRESS: Moss Beach, California 94038

PROJECT PHASE: Construction Documents

DRAWN: Author CHECKED: Checker

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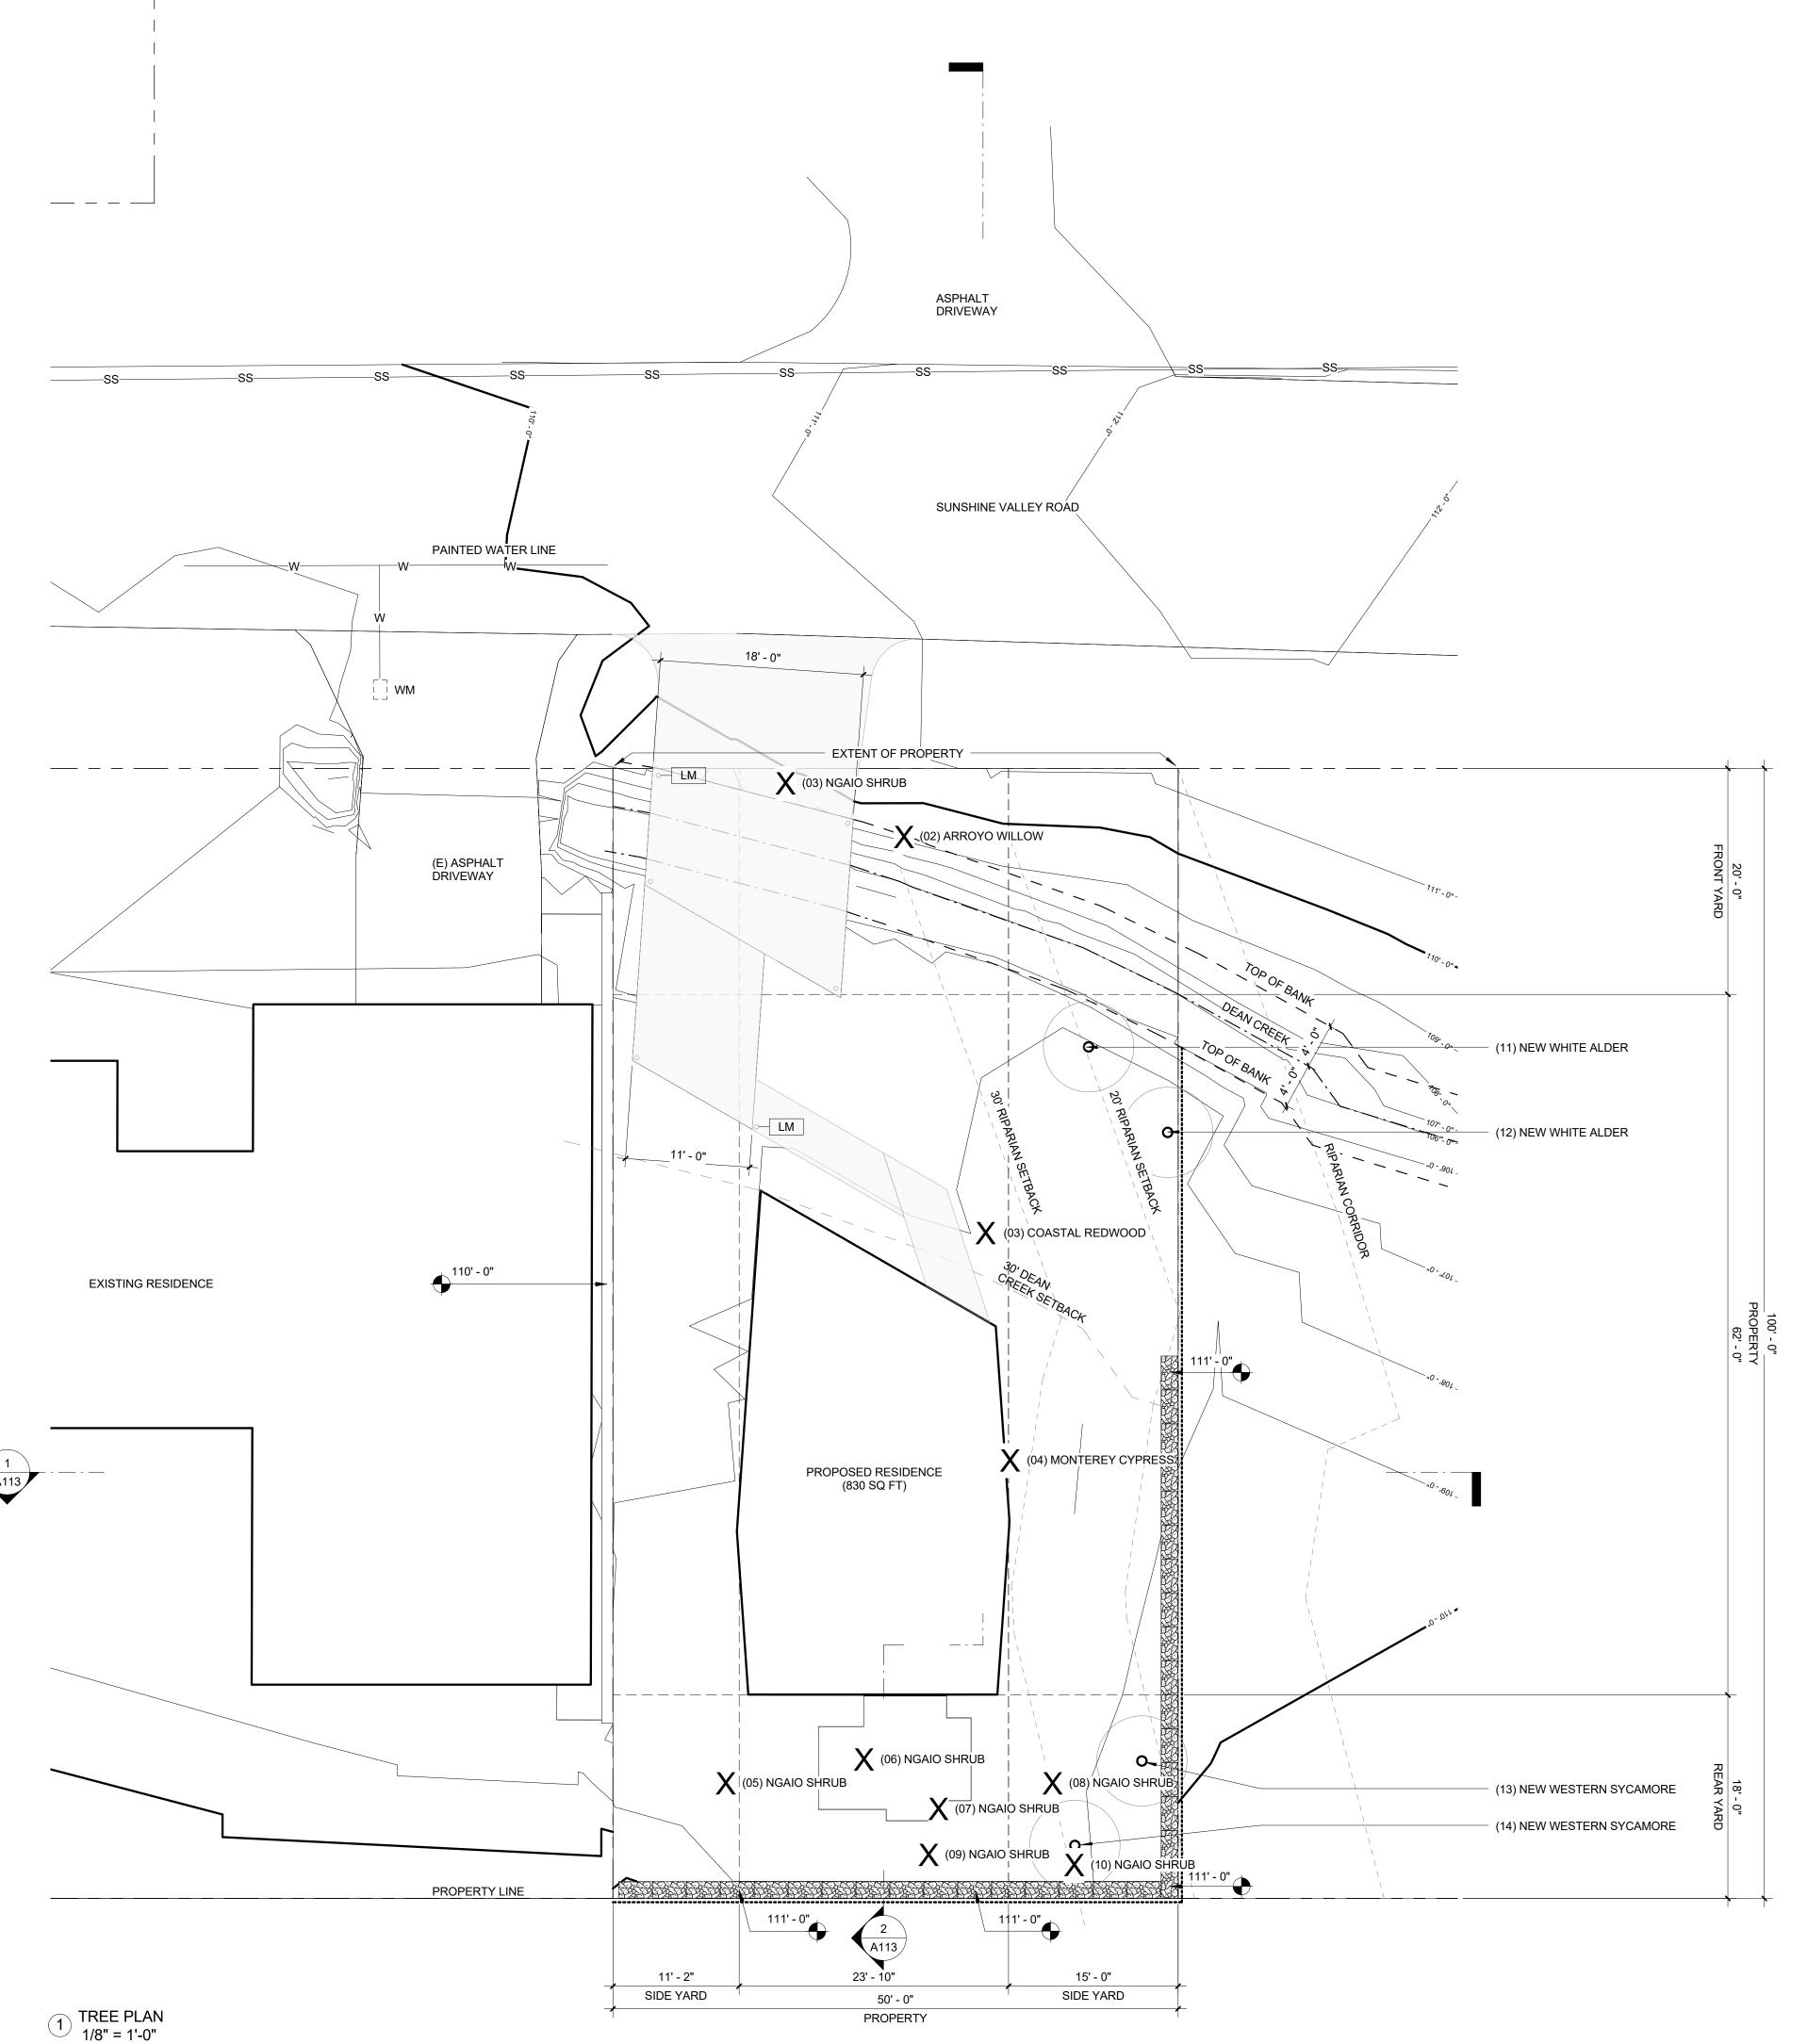
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DRAWING NO:


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ARCHITECT:

David Jaehning Architect

25 Forest Side Avenue, San Francisco, California 94127

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SWCA Environmental Consultants: Half Moon Bay, California

Sigma Prime Geosciences, Inc.: Half Moon Bay, California

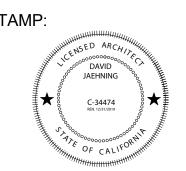STRUCTURAL: Alex Lau Engineering: C 75773, San Francisco, California

CLIENT:

Elle and Ivan Li

1855 Sunshine Valley Road, Moss Beach, California 94038

PROJECT NO: PROJECT NAME:

1802 **Sunshine Valley** Residence

APN 037156130, Sunshine Valley Road Moss Beach, California 94038 PROJECT

ADDRESS:

PROJECT PHASE: Construction Documents

CHECKED: DRAWN: Checker Author

ISSUE DATE: 5/14/2019 1:24:26 PM

DRAWING TITLE: TREE LOCATION

DRAWING NO:


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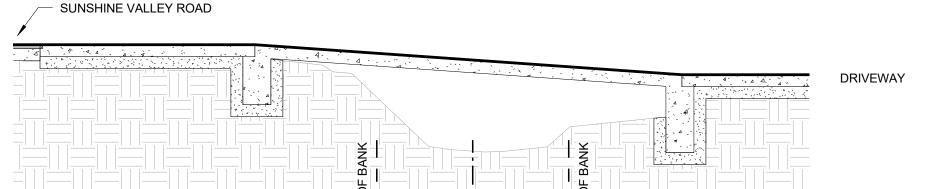
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NO.	EXIST/NEW	DBH	GENUS SPECIES	COMMON NAME
01	EXISTING	7"	MYOPORUM LAETUM	NGAIO (SHRUB)
02	EXISTING	12"	SALIX LASIOLEPIS	ARROYO WILLOW
03	EXISTING	26"	SEQUOIA SEMPERVIRENS	COASTAL REDWOOD
04	EXISTING	26"	HESPEROCYPARIS MACROCARPA	MONTEREY CYPRESS
05	EXISTING	6"	MYOPORUM LAETUM	NGAIO (SHRUB)
06	EXISTING	16"	MYOPORUM LAETUM	NGAIO (SHRUB)
07	EXISTING	14"	MYOPORUM LAETUM	NGAIO (SHRUB)
80	EXISTING	12"	MYOPORUM LAETUM	NGAIO (SHRUB)
09	EXISTING	14"	MYOPORUM LAETUM	NGAIO (SHRUB)
10	EXISTING	12"	MYOPORUM LAETUM	NGAIO (SHRUB)
11	NEW	6"	ALNUS RHOMBIFOLIA	WHITE ALDER
12	NEW	6"	ALNUS RHOMBIFOLIA	WHITE ALDER
13	NEW	6"	PLATANUS RACEMOSA	WESTERN SYCAMORE
14	NEW	6"	PLATANUS RACEMOSA	WESTERN SYCAMORE

*SEE ARBORIST REPORT FOR DETAILED INFORMATION





2 SITE SECTION - ENTRY DRIVE LOOKING EAST 1/4" = 1'-0" REF 1 - A112

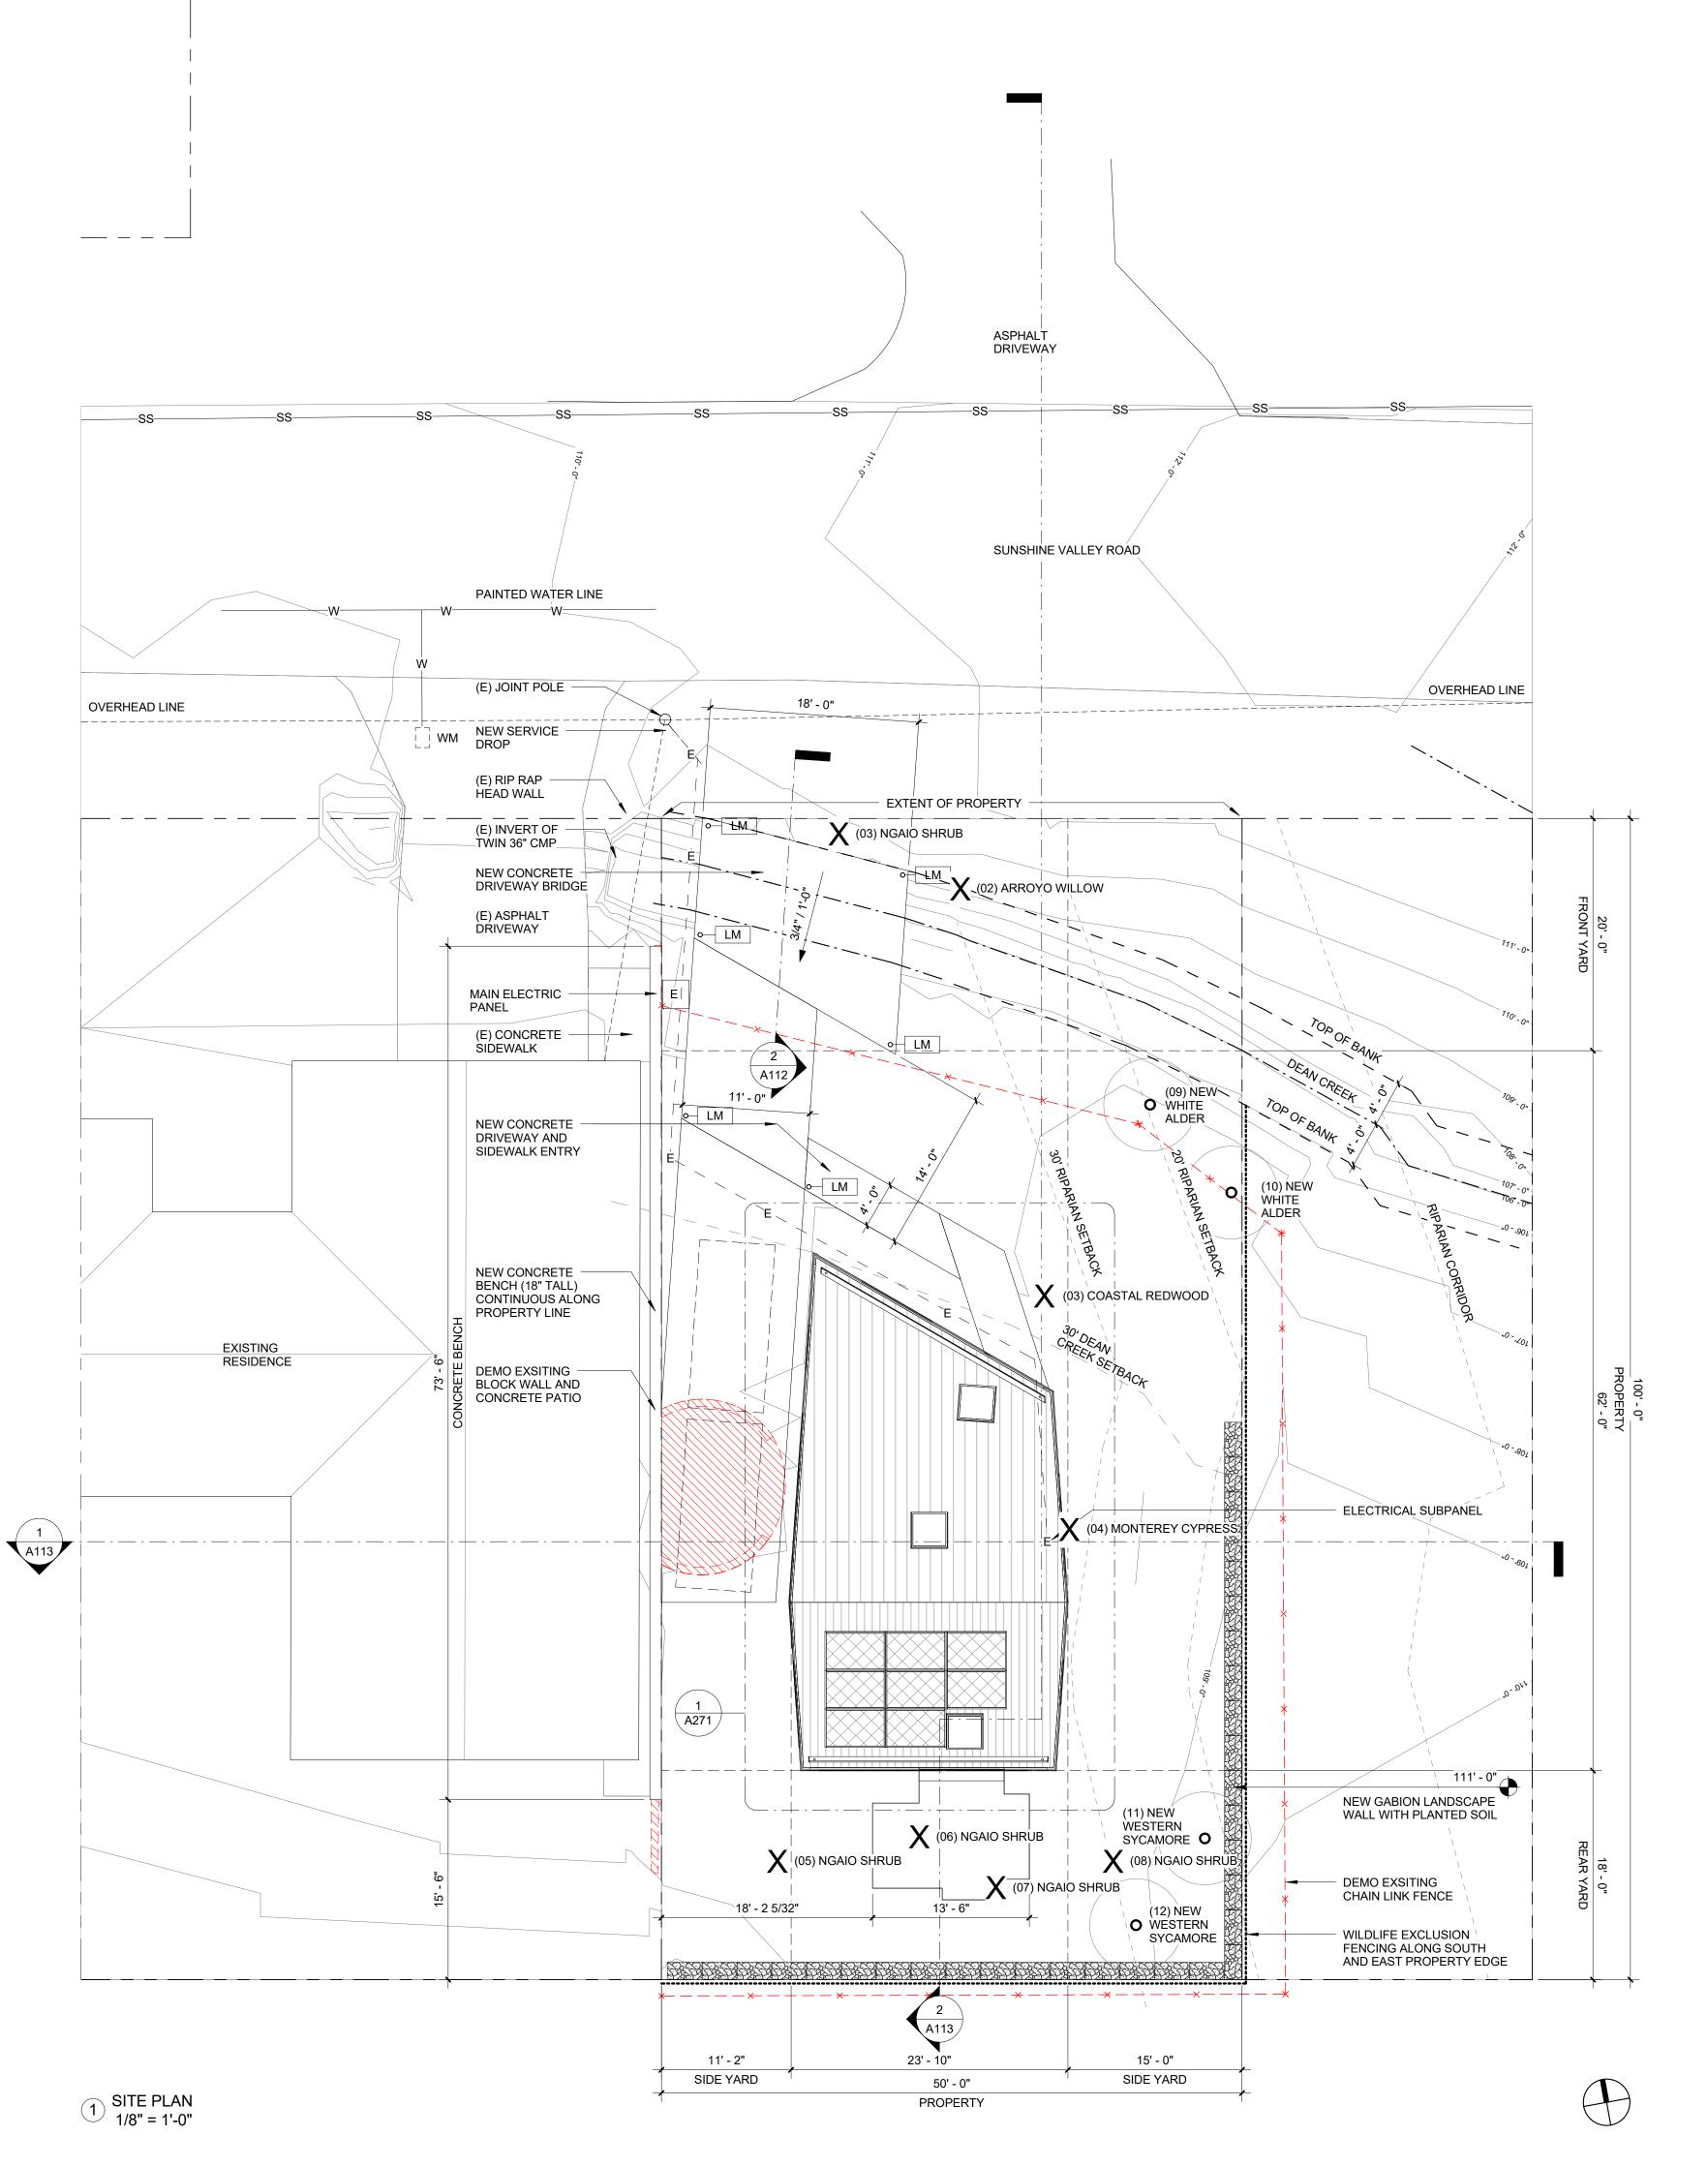
SEE CIVIL DRAWING C1 FOR DRIVEWAY PROFILE

EXTERIOR LIGHTING SCHEDULE:

LL - NEMALUX GS, 3500K

LM - LIGMAN LIGHT LINEAR PT BOLLARD UL1-10021, 3500K

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ARCHITECT:

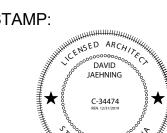David Jaehning Architect

25 Forest Side Avenue, San Francisco, California 94127

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BIOLOGICAL:

SWCA Environmental Consultants: Half Moon Bay, California

VIL:

Sigma Prime Geosciences, Inc.: Half Moon Bay, California

TRUCTURAL:

Alex Lau Engineering: C 75773, San Francisco, California

CLIENT:

Elle and Ivan Li

1855 Sunshine Valley Road, Moss Beach, California 94038

PROJECT NO: PROJECT NAME:

1802 Sunshine Valley Residence

PROJECT APN 037156130, Sunshine Valley Road ADDRESS: Moss Beach, California 94038

PROJECT PHASE: Construction Documents

DRAWN: Author CHECKED: Checker

ISSUE DATE: 5/14/2019 1:24:03 PM


DRAWING TITLE: ARCHITECTURAL SITE PLAN

DRAWING NO:


A112

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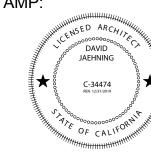


1 SITE SECTION WEST-EAST 1/8" = 1'-0" REF 1 - A112

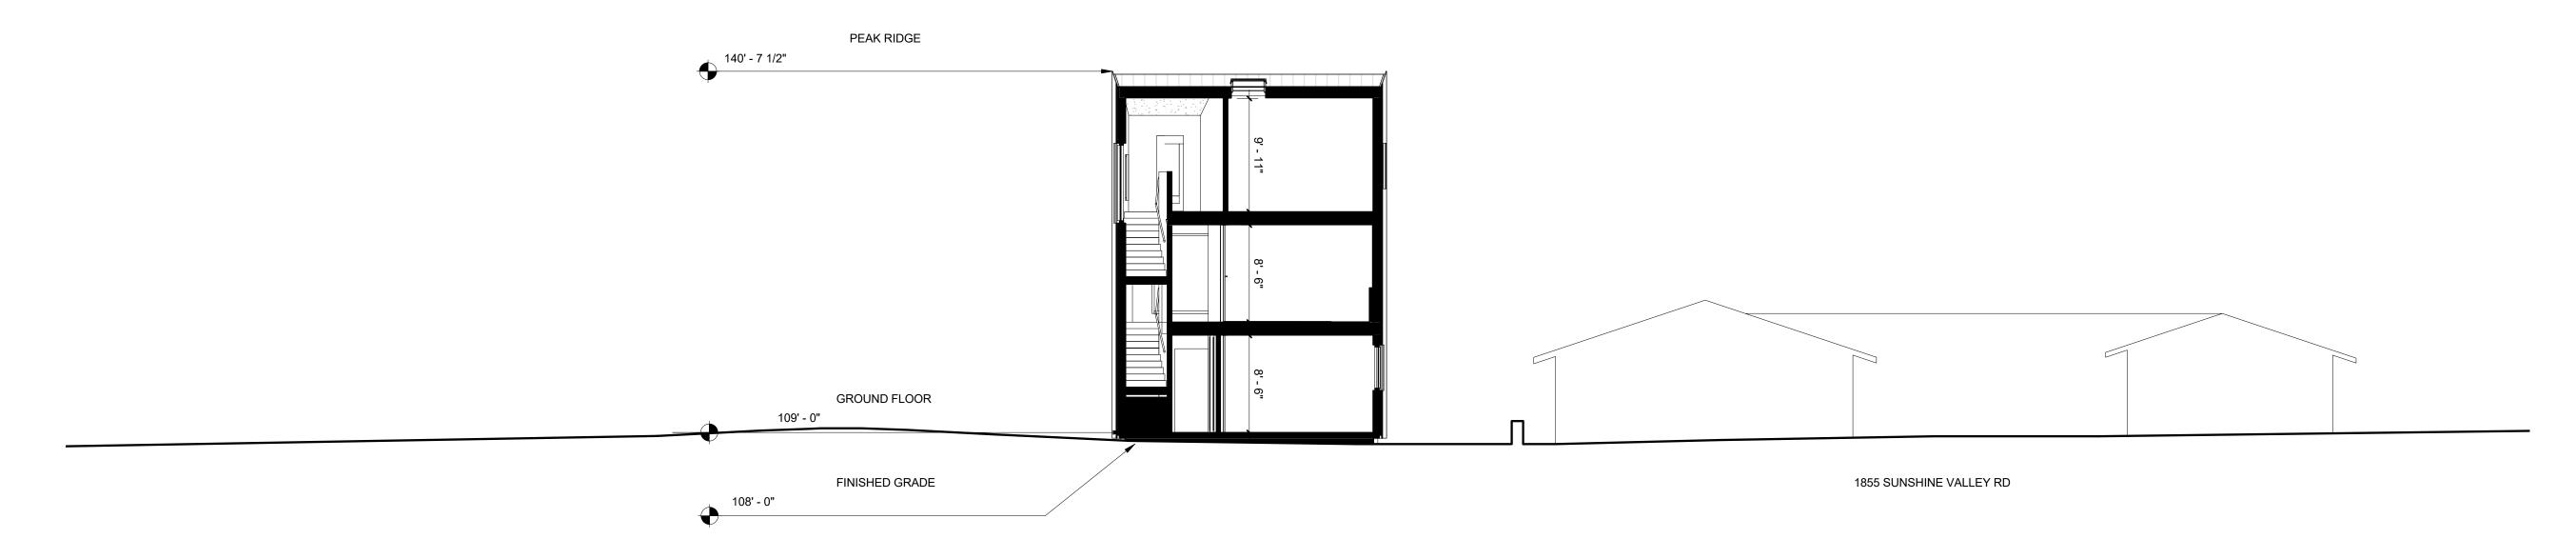

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ARCHITECT:

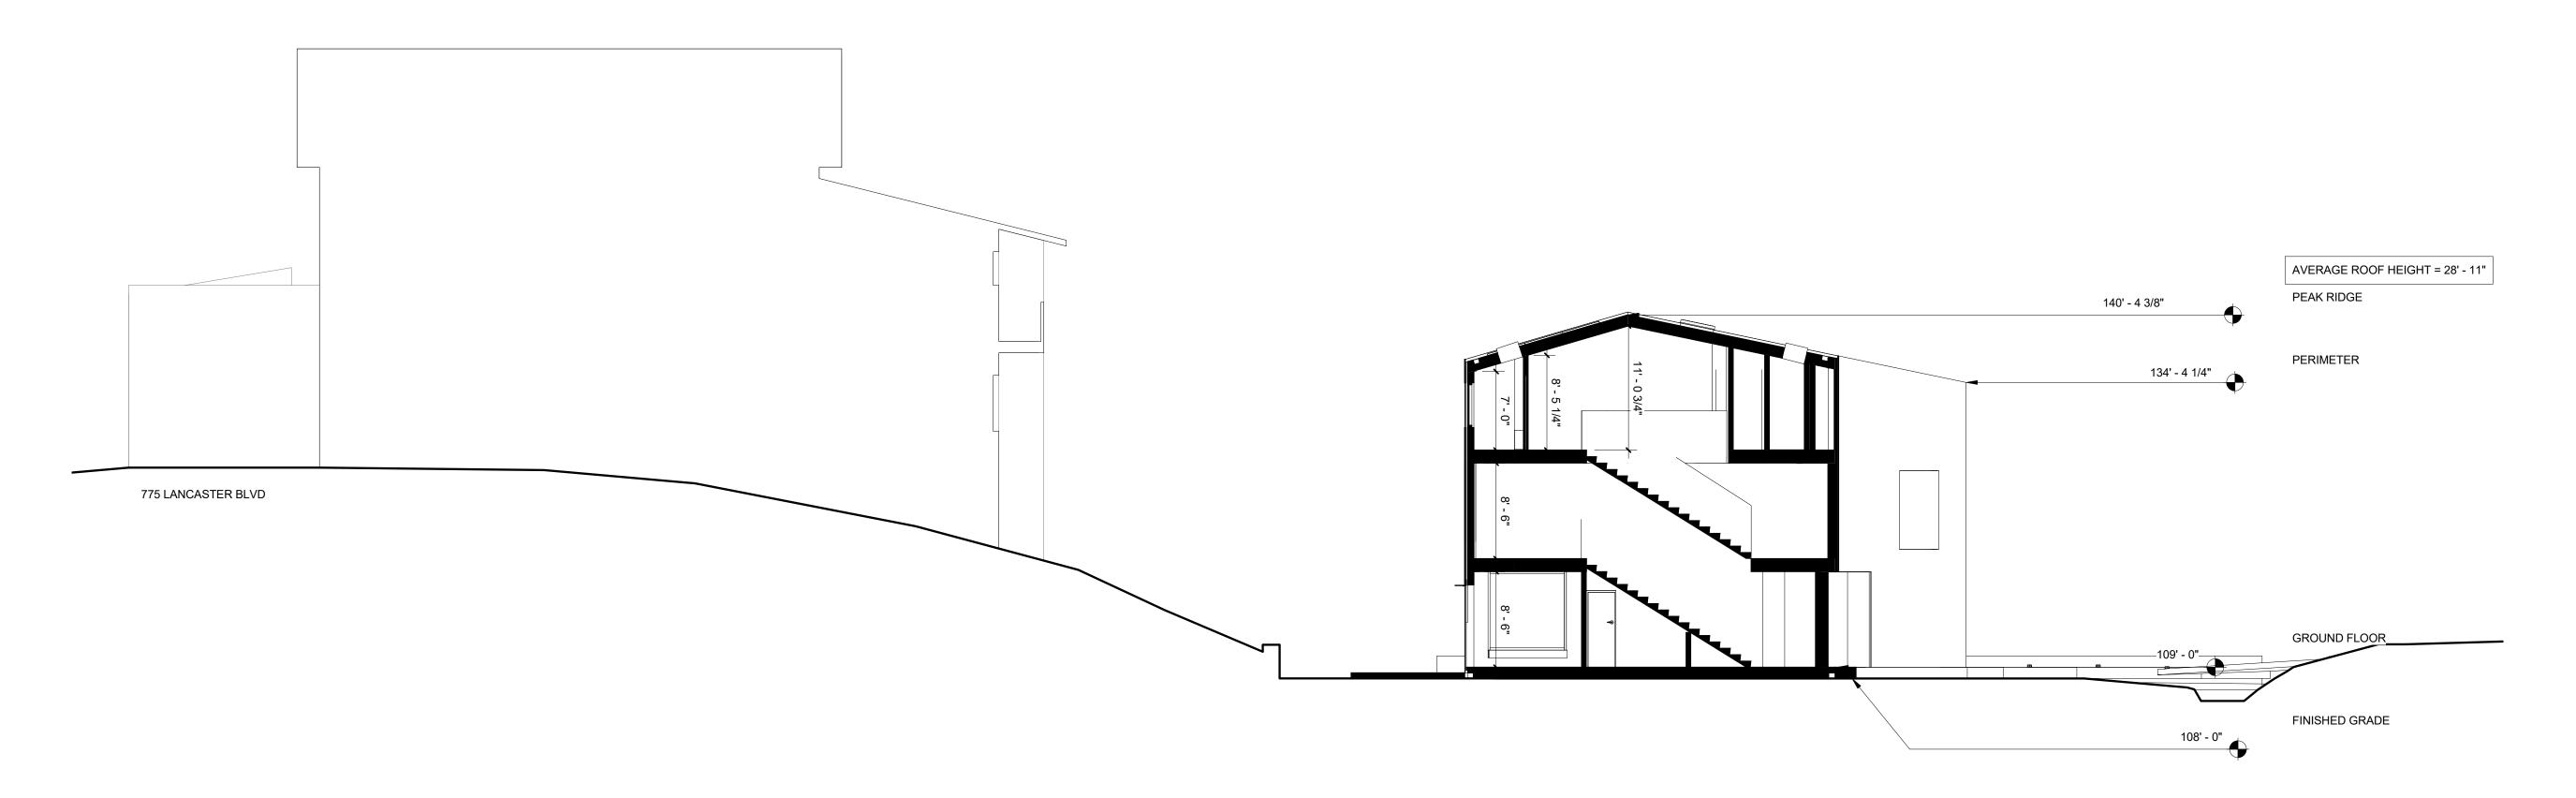David Jaehning Architect

25 Forest Side Avenue, San Francisco, California 94127

CONSULTANT TEAM:

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BIOLOGICAL:

SWCA Environmental Consultants: Half Moon Bay, California

Sigma Prime Geosciences, Inc.: Half Moon Bay, California

STRUCTURAL: Alex Lau Engineering: C 75773, San Francisco, California

CLIENT:

Elle and Ivan Li

1855 Sunshine Valley Road, Moss Beach, California 94038

PROJECT NO: PROJECT NAME:

1802 Sunshine Valley Residence

APN 037156130, Sunshine Valley Road Moss Beach, California 94038 PROJECT ADDRESS:

PROJECT PHASE: Construction Documents

DRAWN: CHECKED: Checker Author

ISSUE DATE: 5/14/2019 1:24:04 PM


DRAWING TITLE: ARCHITECTURAL SITE SECTION

DRAWING NO:

A113

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MECH


L LIVING

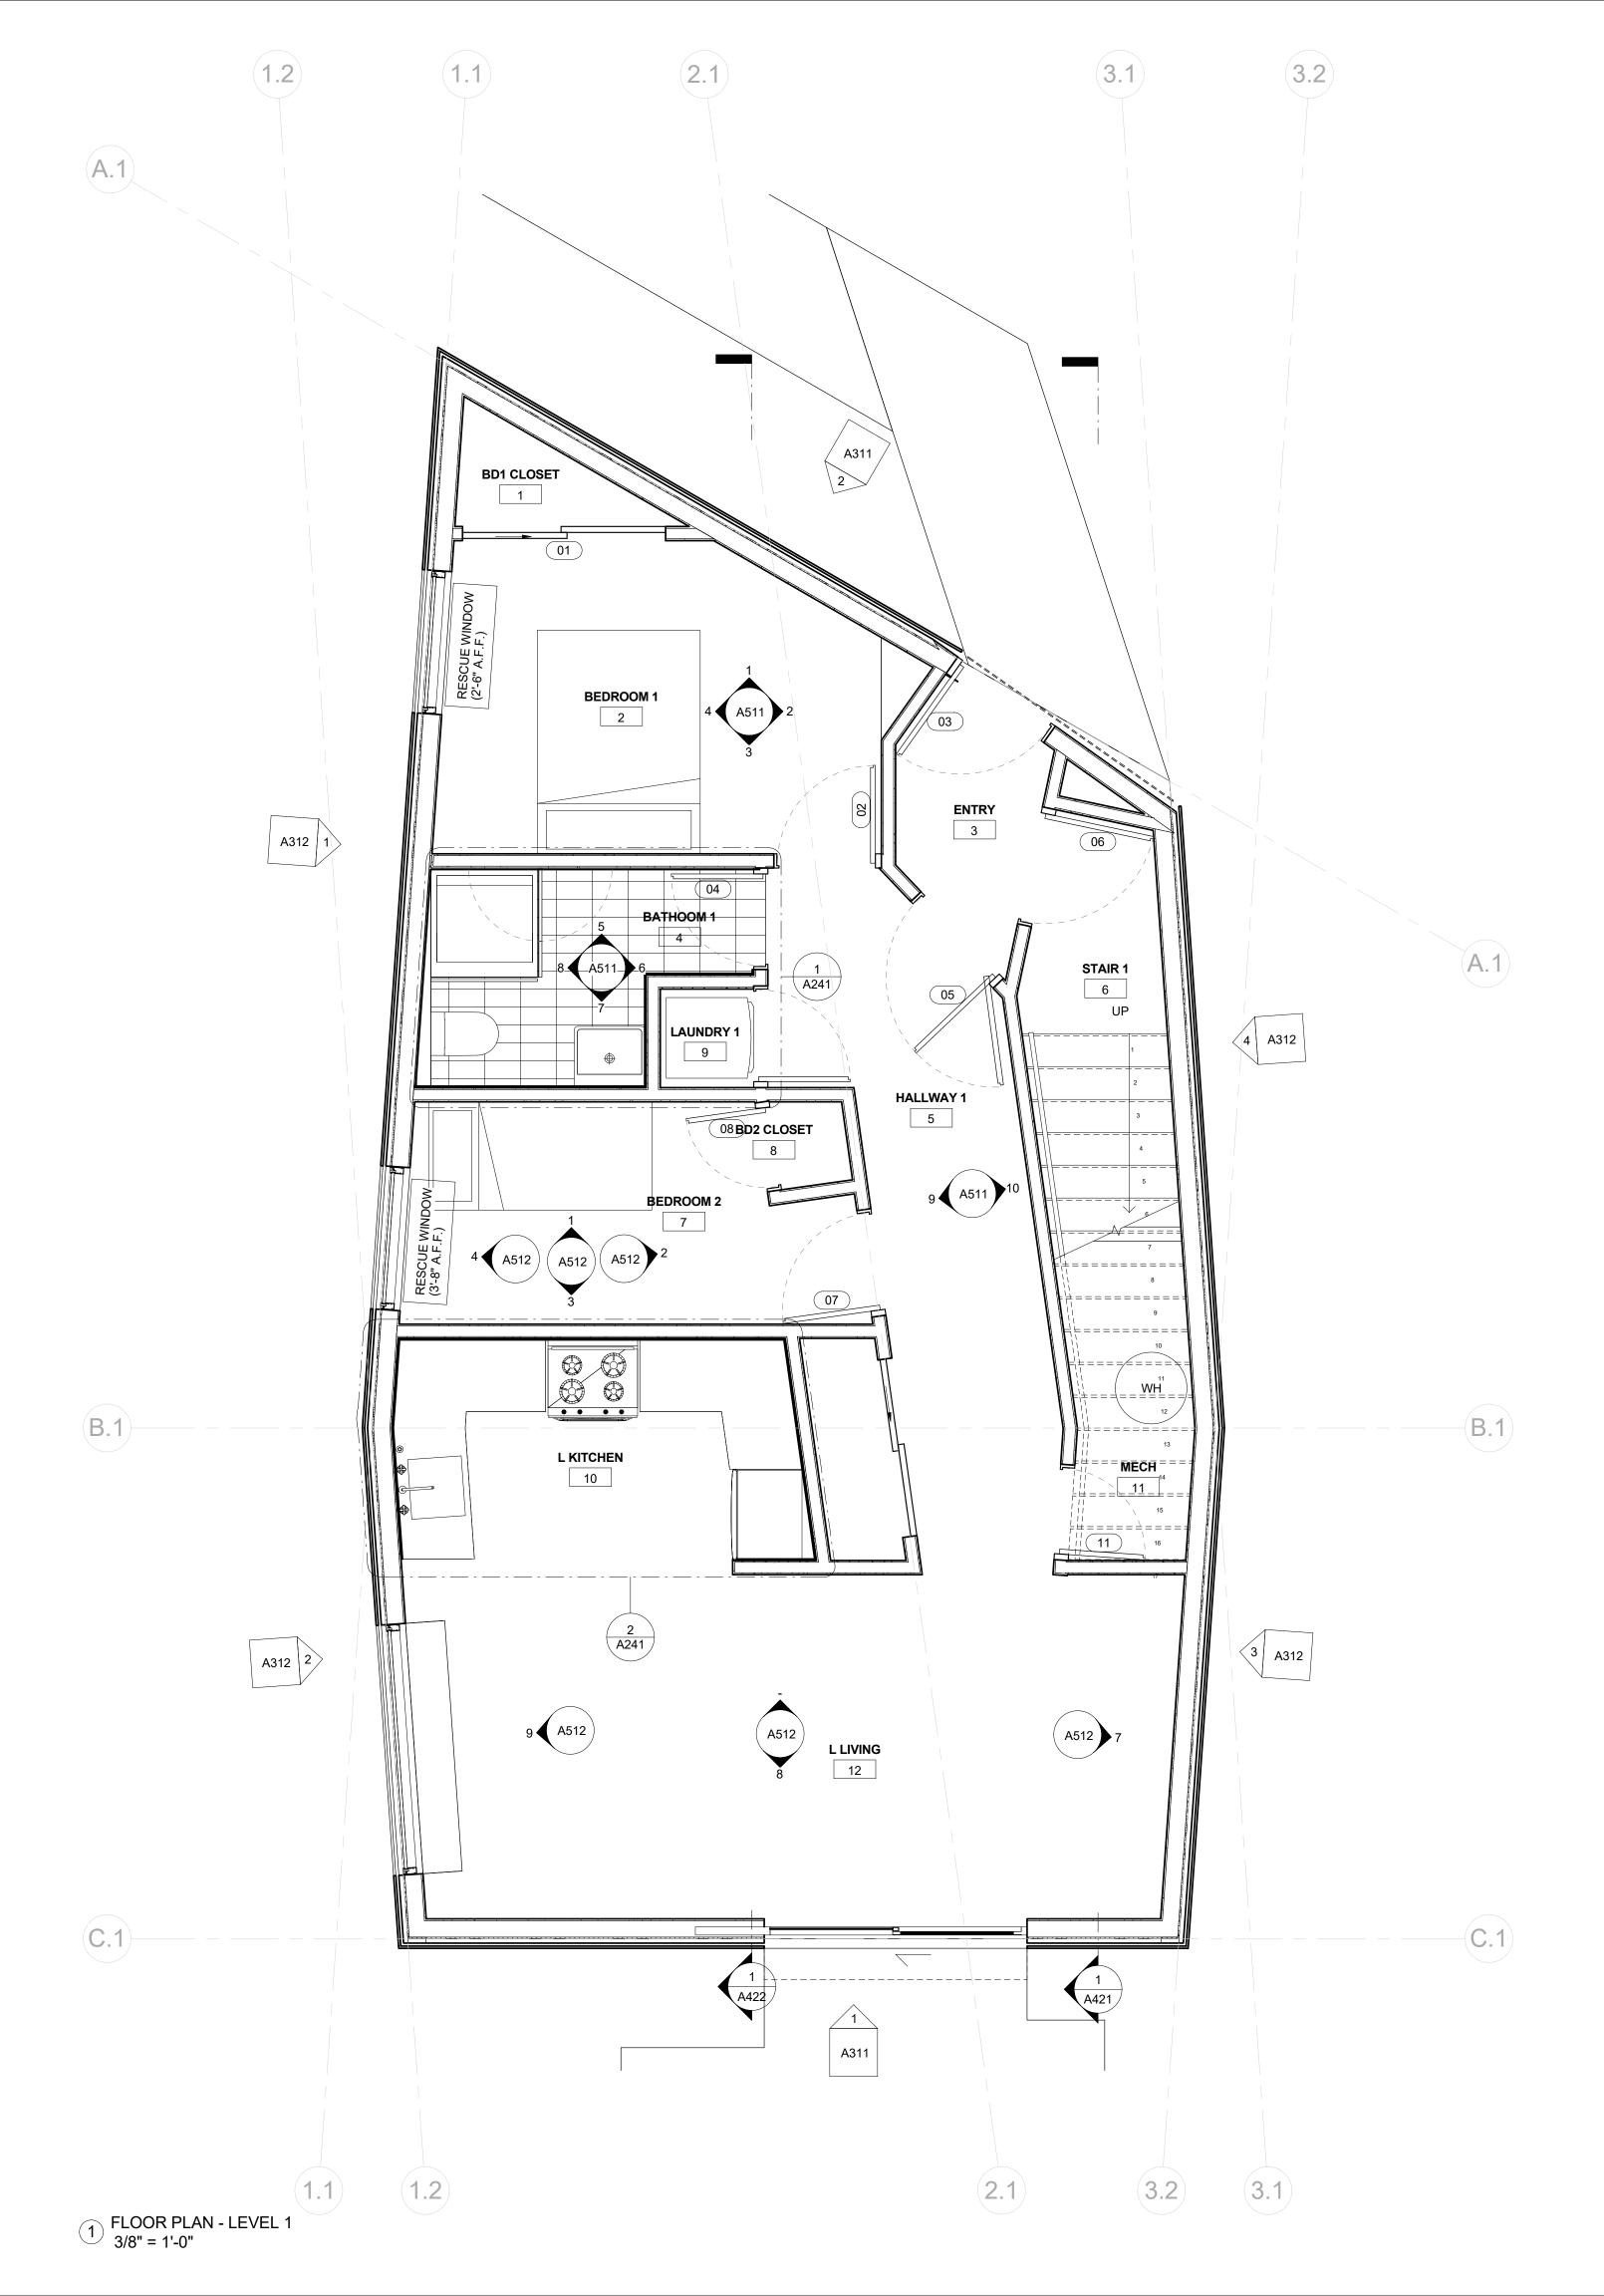JAMB DEPTH MATERIAL # WIDTH HEIGHT MATERIAL FINISH HEAD THRESHOLD <By Category>
<By Category> SINGLE BLIND 8' - 6" SINGLE BLIND SINGLE BLIND <By Category> <By Category> <By Category> SINGLE BLIND <By Category> <By Category> SINGLE BLIND 8' - 6" <By Category> 8' - 6" <By Category> SINGLE BLIND 6' - 8" SINGLE BLIND <By Category> <By Category> SINGLE BLIND 6' - 8" <By Category> <By Category> SINGLE BLIND <By Category> <By Category>

REVISION:

ROOM SCHEDULE - LEVEL 1 FLOOR BASE CEILING PERIMETER NET AREA **BD1 CLOSET** 17' - 5 1/8" 41' - 3 3/16" 103 SF BEDROOM 1 ENTRY 20' - 6 1/4" 24 SF 30' - 3 3/32" 46 SF BATHOOM 1 HALLWAY 1 50' - 2 15/32" 94 SF STAIR 1 29' - 4 1/16" 42 SF 37' - 11 1/32" 71 SF BEDROOM 2 BD2 CLOSET 8' - 8 11/32" 5 SF LAUNDRY 1 10' - 8 1/2" 34' - 5 9/32" 73 SF L KITCHEN 24' - 9 7/8" 30 SF



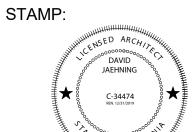

ARCHITECT:

61' - 8 7/8" 203 SF

David Jaehning Architect

25 Forest Side Avenue, San Francisco, California 94127

CONSULTANT TEAM:

Trees 360 Degrees, Straun Edwards: WE5612-A Saratoga, California

SWCA Environmental Consultants: Half Moon Bay, California

Sigma Prime Geosciences, Inc.: Half Moon Bay, California

STRUCTURAL:

Alex Lau Engineering: C 75773, San Francisco, California

CLIENT:

Elle and Ivan Li

1855 Sunshine Valley Road, Moss Beach, California 94038

PROJECT NO: PROJECT NAME:

1802 **Sunshine Valley** Residence

APN 037156130, Sunshine Valley Road Moss Beach, California 94038 **PROJECT** ADDRESS:

PROJECT PHASE: Construction Documents

DRAWN: CHECKED: Checker

5/14/2019 1:24:05 PM ISSUE DATE:

DRAWING TITLE: **DIMENSION FLOOR PLAN - LEVEL 1**

DRAWING NO:

A211

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SMOKE DETECTION: HARD-WIRED, INTERCONNECTED, AND BATTERY BACKUP PER CBC, STATE FIRE MARSHALL REGULATIONS, AND COASTSIDE FIRE DISTRICT ORDINANCE 2016-01. PLACED ONE PER BEDROOM AND

ONE IN HALLWAY PER FLOOR


ESCAPE OR RESUCE WINDOWS SHALL HAVE A MINIMUM NET CLEAR OPENABLE AREA OF 5.7 SQUARE FEET ALLOWED AT GRADE. THE MINUMUM NET CLEAR


OPENABLE HEIGHT DIMENSION SHALL BE 24 INCHES. THE NET CLEAR OPENABLE WIDTH DIMENSION SHALL BE 20 INCHES. FINISHED SILL HEIGHTS SHALL BE NOT

FIRE SUPPRESSION: BUILDING WILL BE PROTECTED BY AN AUTOMATIC FIRE

SPRINKLER SYSTEM

MORE THAN 44 INCHES ABOVE THE FINISHED FLOOR.

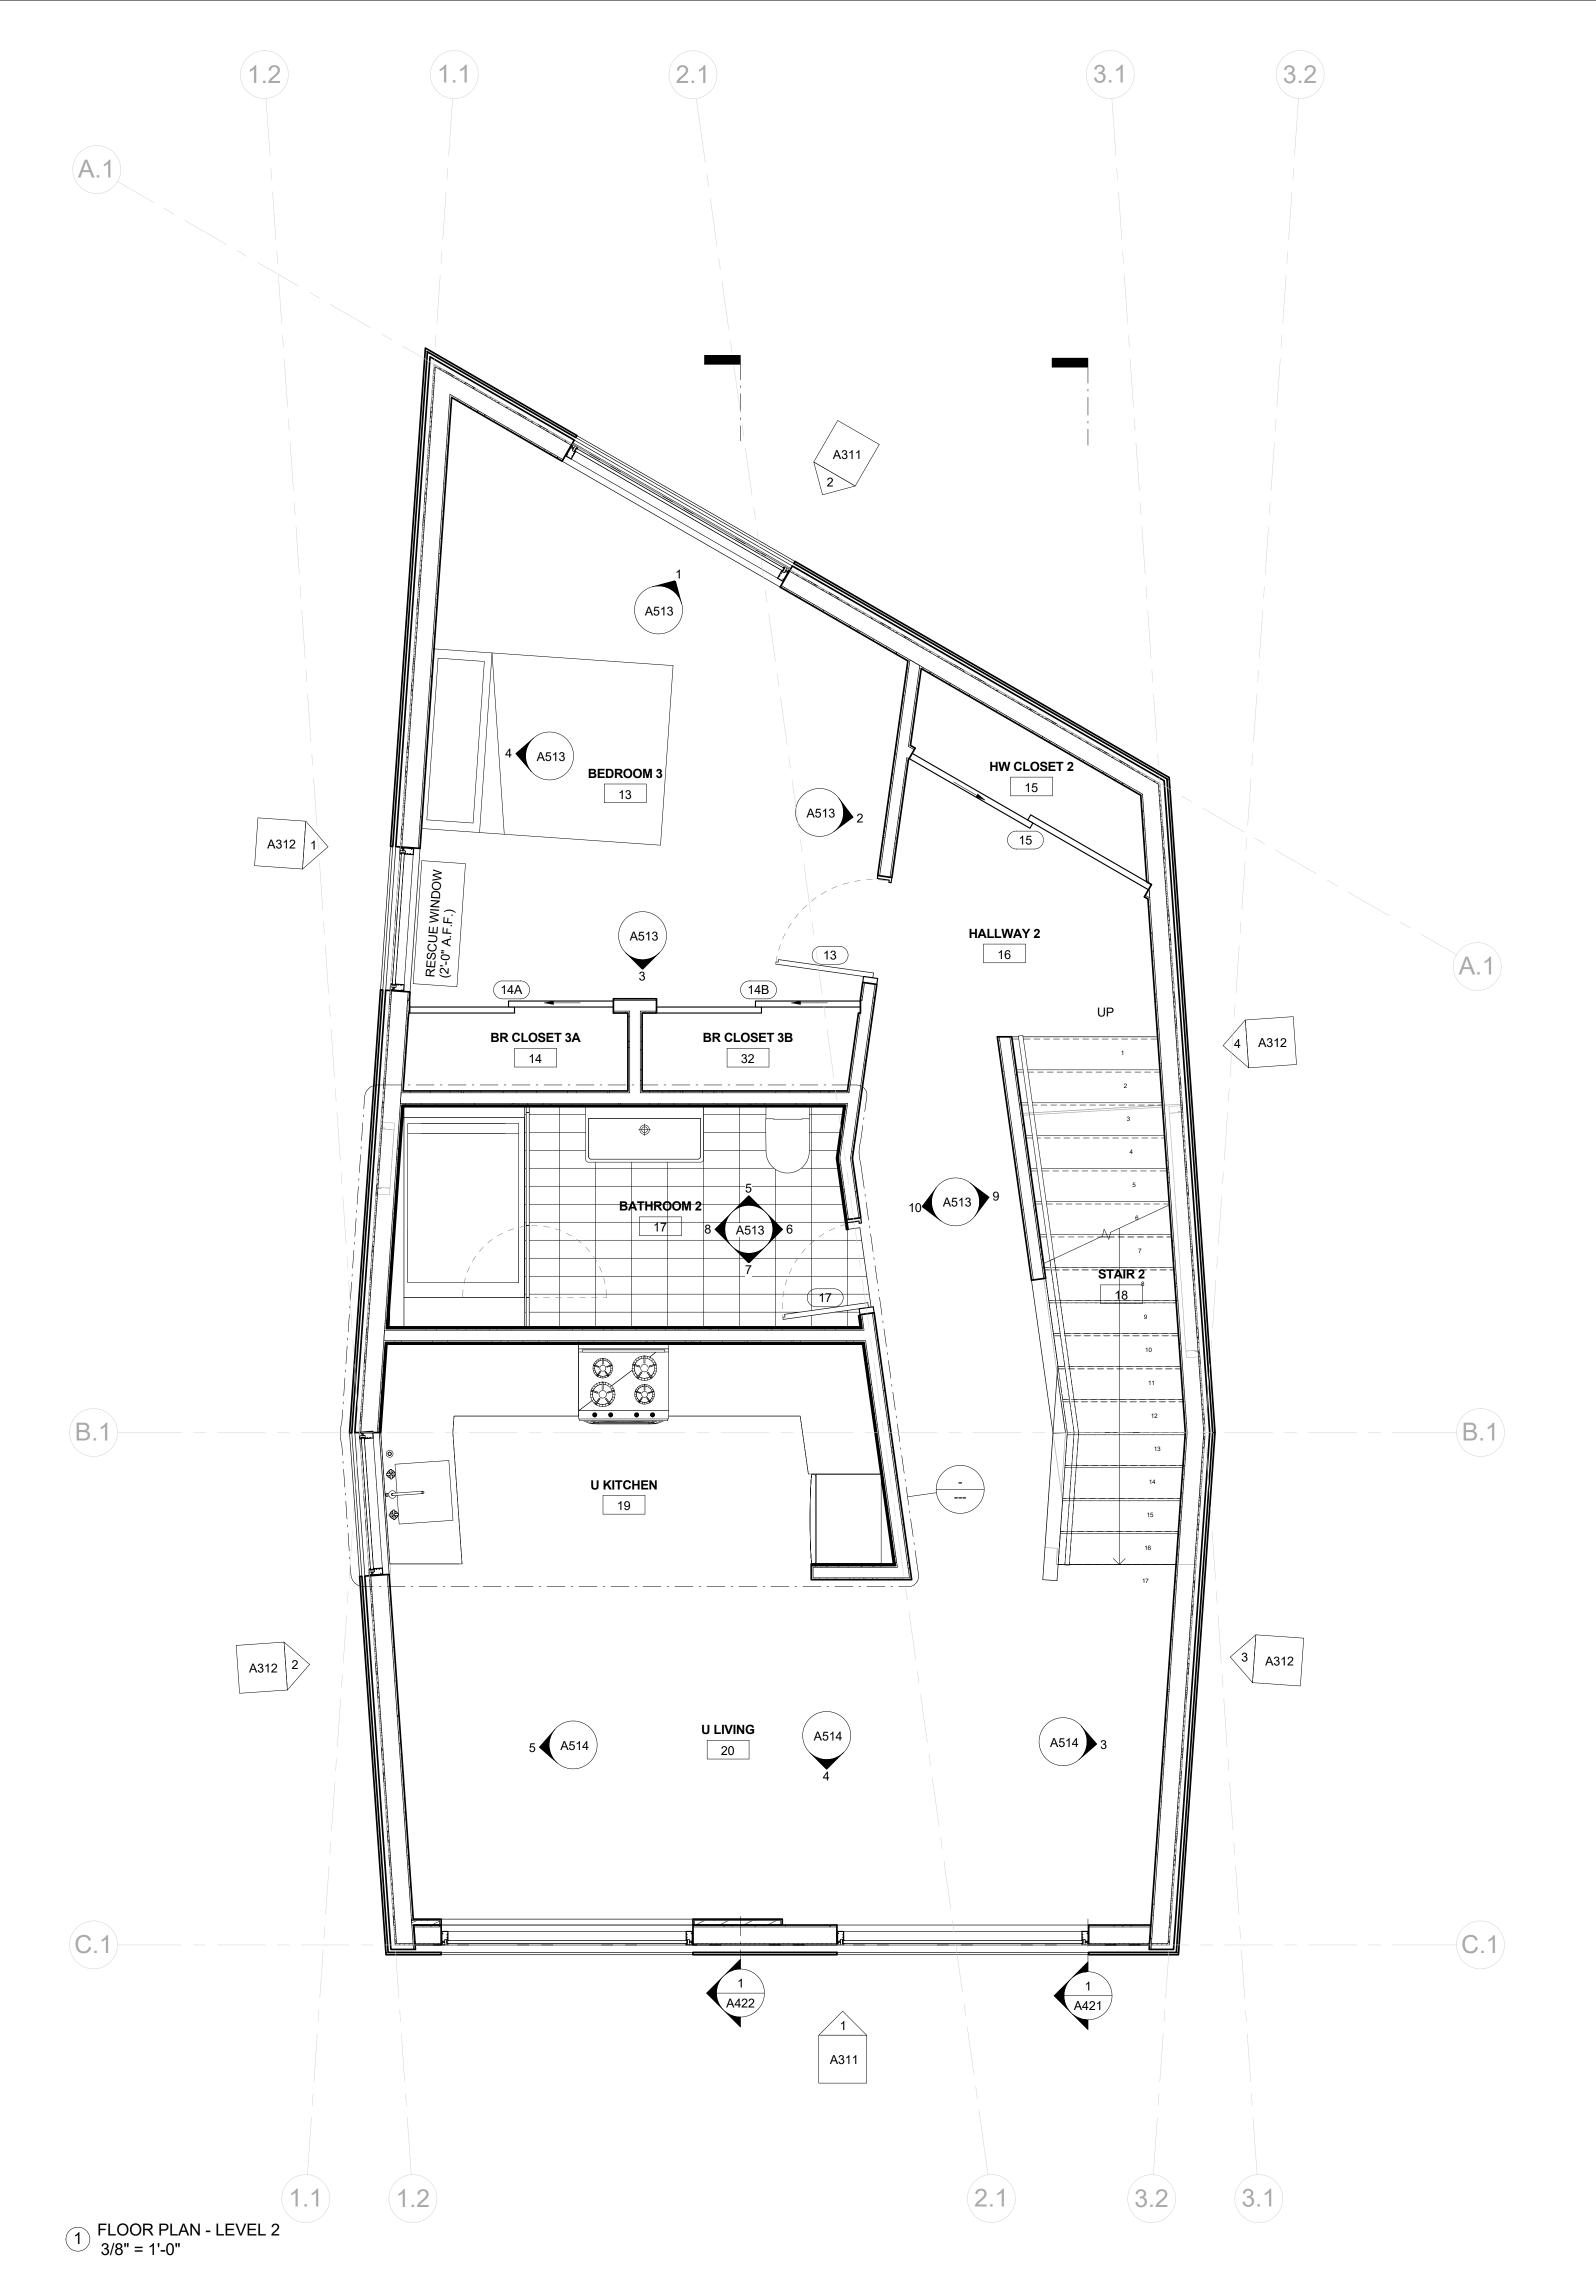

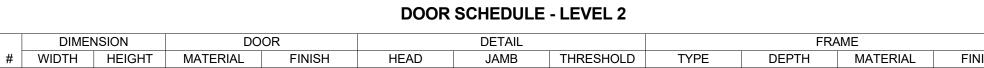


<By Category> SINGLE BLIND 8' - 6" <By Category> <By Category> SINGLE BLIND <By Category>

				OULE - LEVE			
			FINI				
#	NAME	FLOOR	BASE	WALL	CEILING	PERIMETER	NET AREA
EVEL 2							
13	BEDROOM 3					53' - 4 11/16"	168 SF
4	BR CLOSET 3A					16' - 8 3/16"	13 SF
5	HW CLOSET 2					19' - 2 13/32"	15 SF
6	HALLWAY 2					57' - 10 1/16"	107 SF
7	BATHROOM 2					37' - 5 5/8"	77 SF
8	STAIR 2					36' - 11 9/16"	53 SF
9	U KITCHEN					40' - 2 1/4"	90 SF
20	U LIVING					62' - 10 15/16"	203 SF
				1	+	16' - 0 29/32"	13 SF

REVISION:

FOR REVIEW & FILING NOT FOR CONSTRUCTION

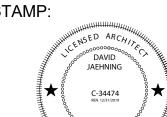

ARCHITECT:

David Jaehning Architect

25 Forest Side Avenue, San Francisco, California 94127

CONSULTANT TEAM:

ARBORIST: Trees 360 Degrees, Straun Edwards: WE5612-A Saratoga, California

SWCA Environmental Consultants: Half Moon Bay, California

Sigma Prime Geosciences, Inc.: Half Moon Bay, California

STRUCTURAL:

Alex Lau Engineering: C 75773, San Francisco, California

CLIENT:

Elle and Ivan Li

1855 Sunshine Valley Road, Moss Beach, California 94038

PROJECT NO: PROJECT NAME:

1802 **Sunshine Valley** Residence

APN 037156130, Sunshine Valley Road Moss Beach, California 94038 PROJECT ADDRESS:

PROJECT PHASE: Construction Documents

CHECKED: DRAWN: Checker

ISSUE DATE: 5/14/2019 1:24:06 PM

DRAWING TITLE: **DIMENSION FLOOR PLAN - LEVEL 2**

DRAWING NO:

A212

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SMOKE DETECTION: HARD-WIRED, INTERCONNECTED, AND BATTERY BACKUP PER CBC, STATE FIRE MARSHALL REGULATIONS, AND COASTSIDE FIRE DISTRICT

ESCAPE OR RESUCE WINDOWS SHALL HAVE A MINIMUM NET CLEAR OPENABLE AREA OF 5.7 SQUARE FEET ALLOWED AT GRADE. THE MINUMUM NET CLEAR

OPENABLE HEIGHT DIMENSION SHALL BE 24 INCHES. THE NET CLEAR OPENABLE


WIDTH DIMENSION SHALL BE 20 INCHES. FINISHED SILL HEIGHTS SHALL BE NOT

ORDINANCE 2016-01. PLACED ONE PER BEDROOM AND ONE IN HALLWAY PER FLOOR

FIRE SUPPRESSION: BUILDING WILL BE PROTECTED BY AN AUTOMATIC FIRE

SPRINKLER SYSTEM

MORE THAN 44 INCHES ABOVE THE FINISHED FLOOR.

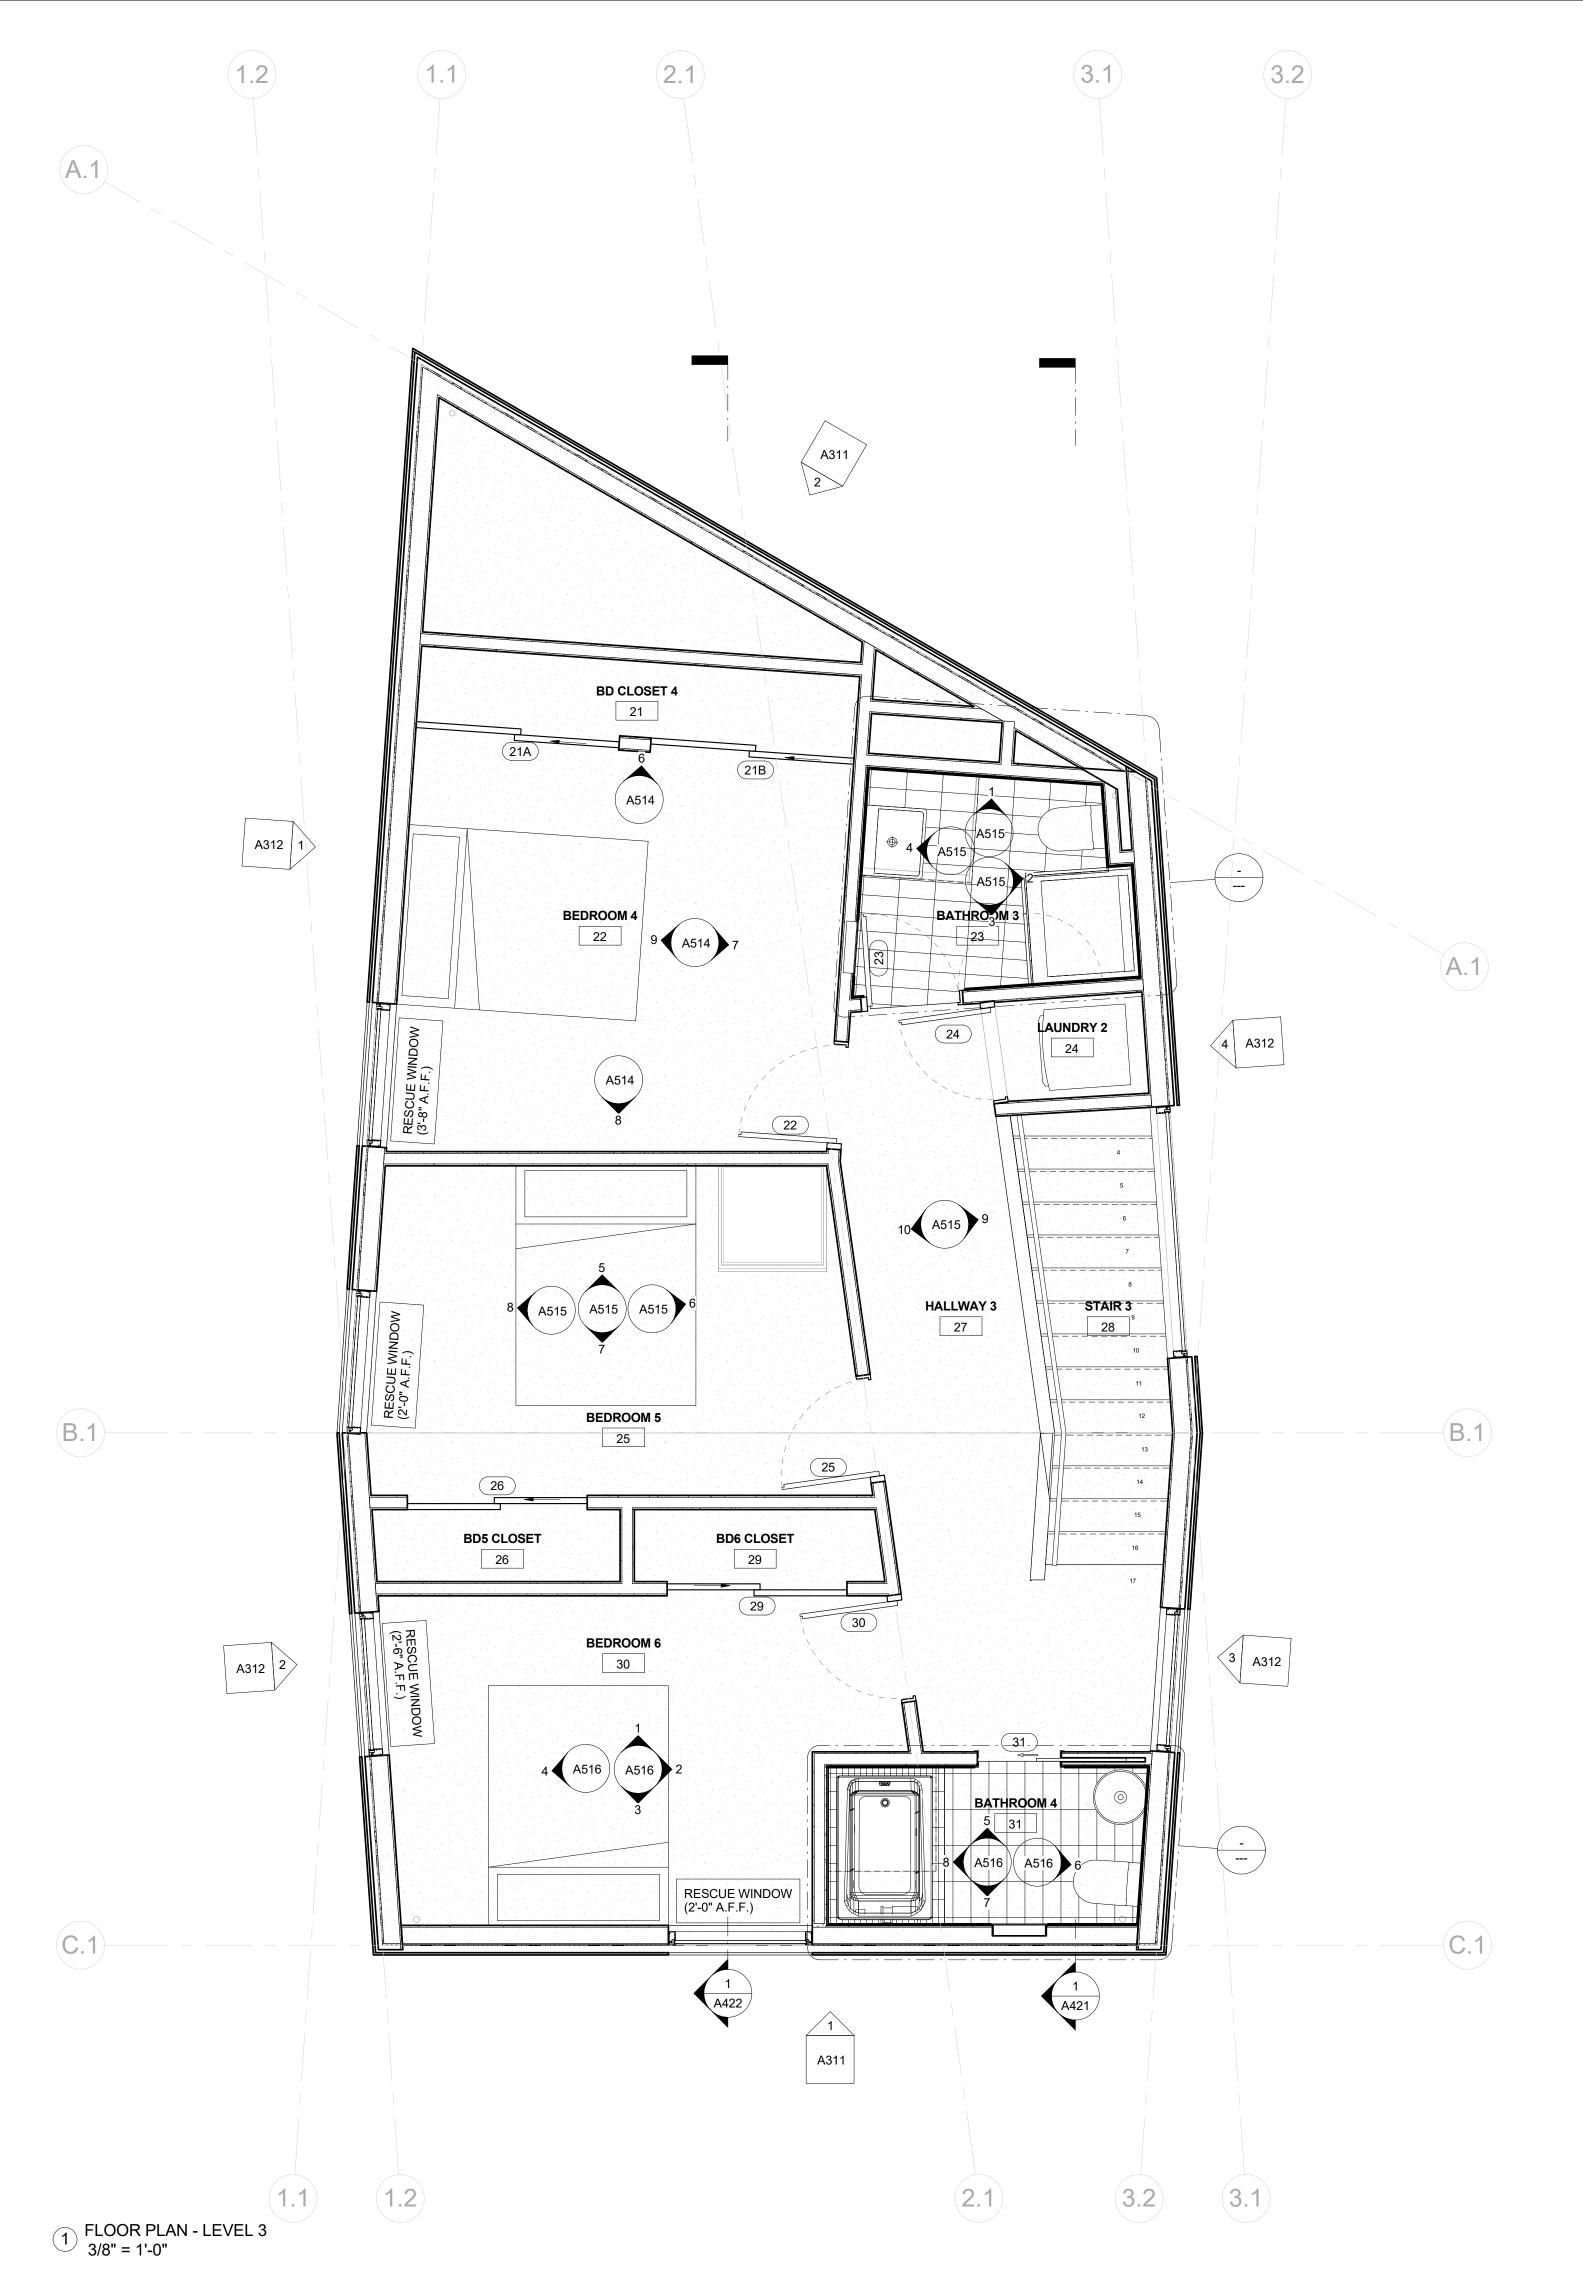

DOOR SCHEDULE - LEVEL 3 DETAIL JAMB # WIDTH HEIGHT MATERIAL DEPTH MATERIAL FINISH HEAD THRESHOLD


SINGLE BLIND SINGLE BLIND <By Category> 7' - 0" SINGLE BLIND <By Category> 7' - 0" SINGLE BLIND <By Category> <By Category> SINGLE BLIND <By Category> <By Category>

			FINI				
#	NAME	FLOOR	BASE	WALL	CEILING	PERIMETER	NET AREA
LEVEL 3							
21	BD CLOSET 4					28' - 7 1/2"	26 SF
22	BEDROOM 4					46' - 9 5/32"	136 SF
23	BATHROOM 3					27' - 2 1/32"	43 SF
24	LAUNDRY 2					13' - 7 19/32"	11 SF
25	BEDROOM 5					44' - 7 11/16"	121 SF
26	BD5 CLOSET					17' - 7 27/32"	14 SF
27	HALLWAY 3					55' - 3 3/16"	100 SF
28	STAIR 3					33' - 4 13/16"	46 SF
29	BD6 CLOSET					17' - 8 1/32"	14 SF
30	BEDROOM 6					46' - 7 11/16"	118 SF
31	BATHROOM 4					26' - 4 11/32"	38 SF
					1		667 SF

REVISION:

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ARCHITECT:

David Jaehning Architect

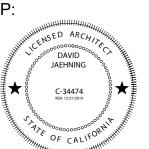25 Forest Side Avenue, San Francisco, California 94127

CONSULTANT TEAM:

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SWCA Environmental Consultants: Half Moon Bay, California

Sigma Prime Geosciences, Inc.: Half Moon Bay, California

STRUCTURAL:

Alex Lau Engineering: C 75773, San Francisco, California

CLIENT:

Elle and Ivan Li

1855 Sunshine Valley Road, Moss Beach, California 94038

PROJECT NO: PROJECT NAME:

1802 **Sunshine Valley** Residence

APN 037156130, Sunshine Valley Road Moss Beach, California 94038 PROJECT ADDRESS:

PROJECT PHASE: Construction Documents

DRAWN: CHECKED: Checker

ISSUE DATE: 5/14/2019 1:24:09 PM

DRAWING TITLE: **DIMENSION FLOOR PLAN - LEVEL 3**

DRAWING NO:

A213

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SMOKE DETECTION: HARD-WIRED, INTERCONNECTED, AND BATTERY BACKUP PER CBC, STATE FIRE MARSHALL REGULATIONS, AND COASTSIDE FIRE DISTRICT ORDINANCE 2016-01. PLACED ONE PER BEDROOM AND

ESCAPE OR RESUCE WINDOWS SHALL HAVE A MINIMUM NET CLEAR OPENABLE AREA OF 5.7 SQUARE FEET ALLOWED AT GRADE. THE MINUMUM NET CLEAR

OPENABLE HEIGHT DIMENSION SHALL BE 24 INCHES. THE NET CLEAR OPENABLE


WIDTH DIMENSION SHALL BE 20 INCHES. FINISHED SILL HEIGHTS SHALL BE NOT

MORE THAN 44 INCHES ABOVE THE FINISHED FLOOR.


ONE IN HALLWAY PER FLOOR

SPRINKLER SYSTEM

FIRE SUPPRESSION: BUILDING WILL BE PROTECTED BY AN AUTOMATIC FIRE

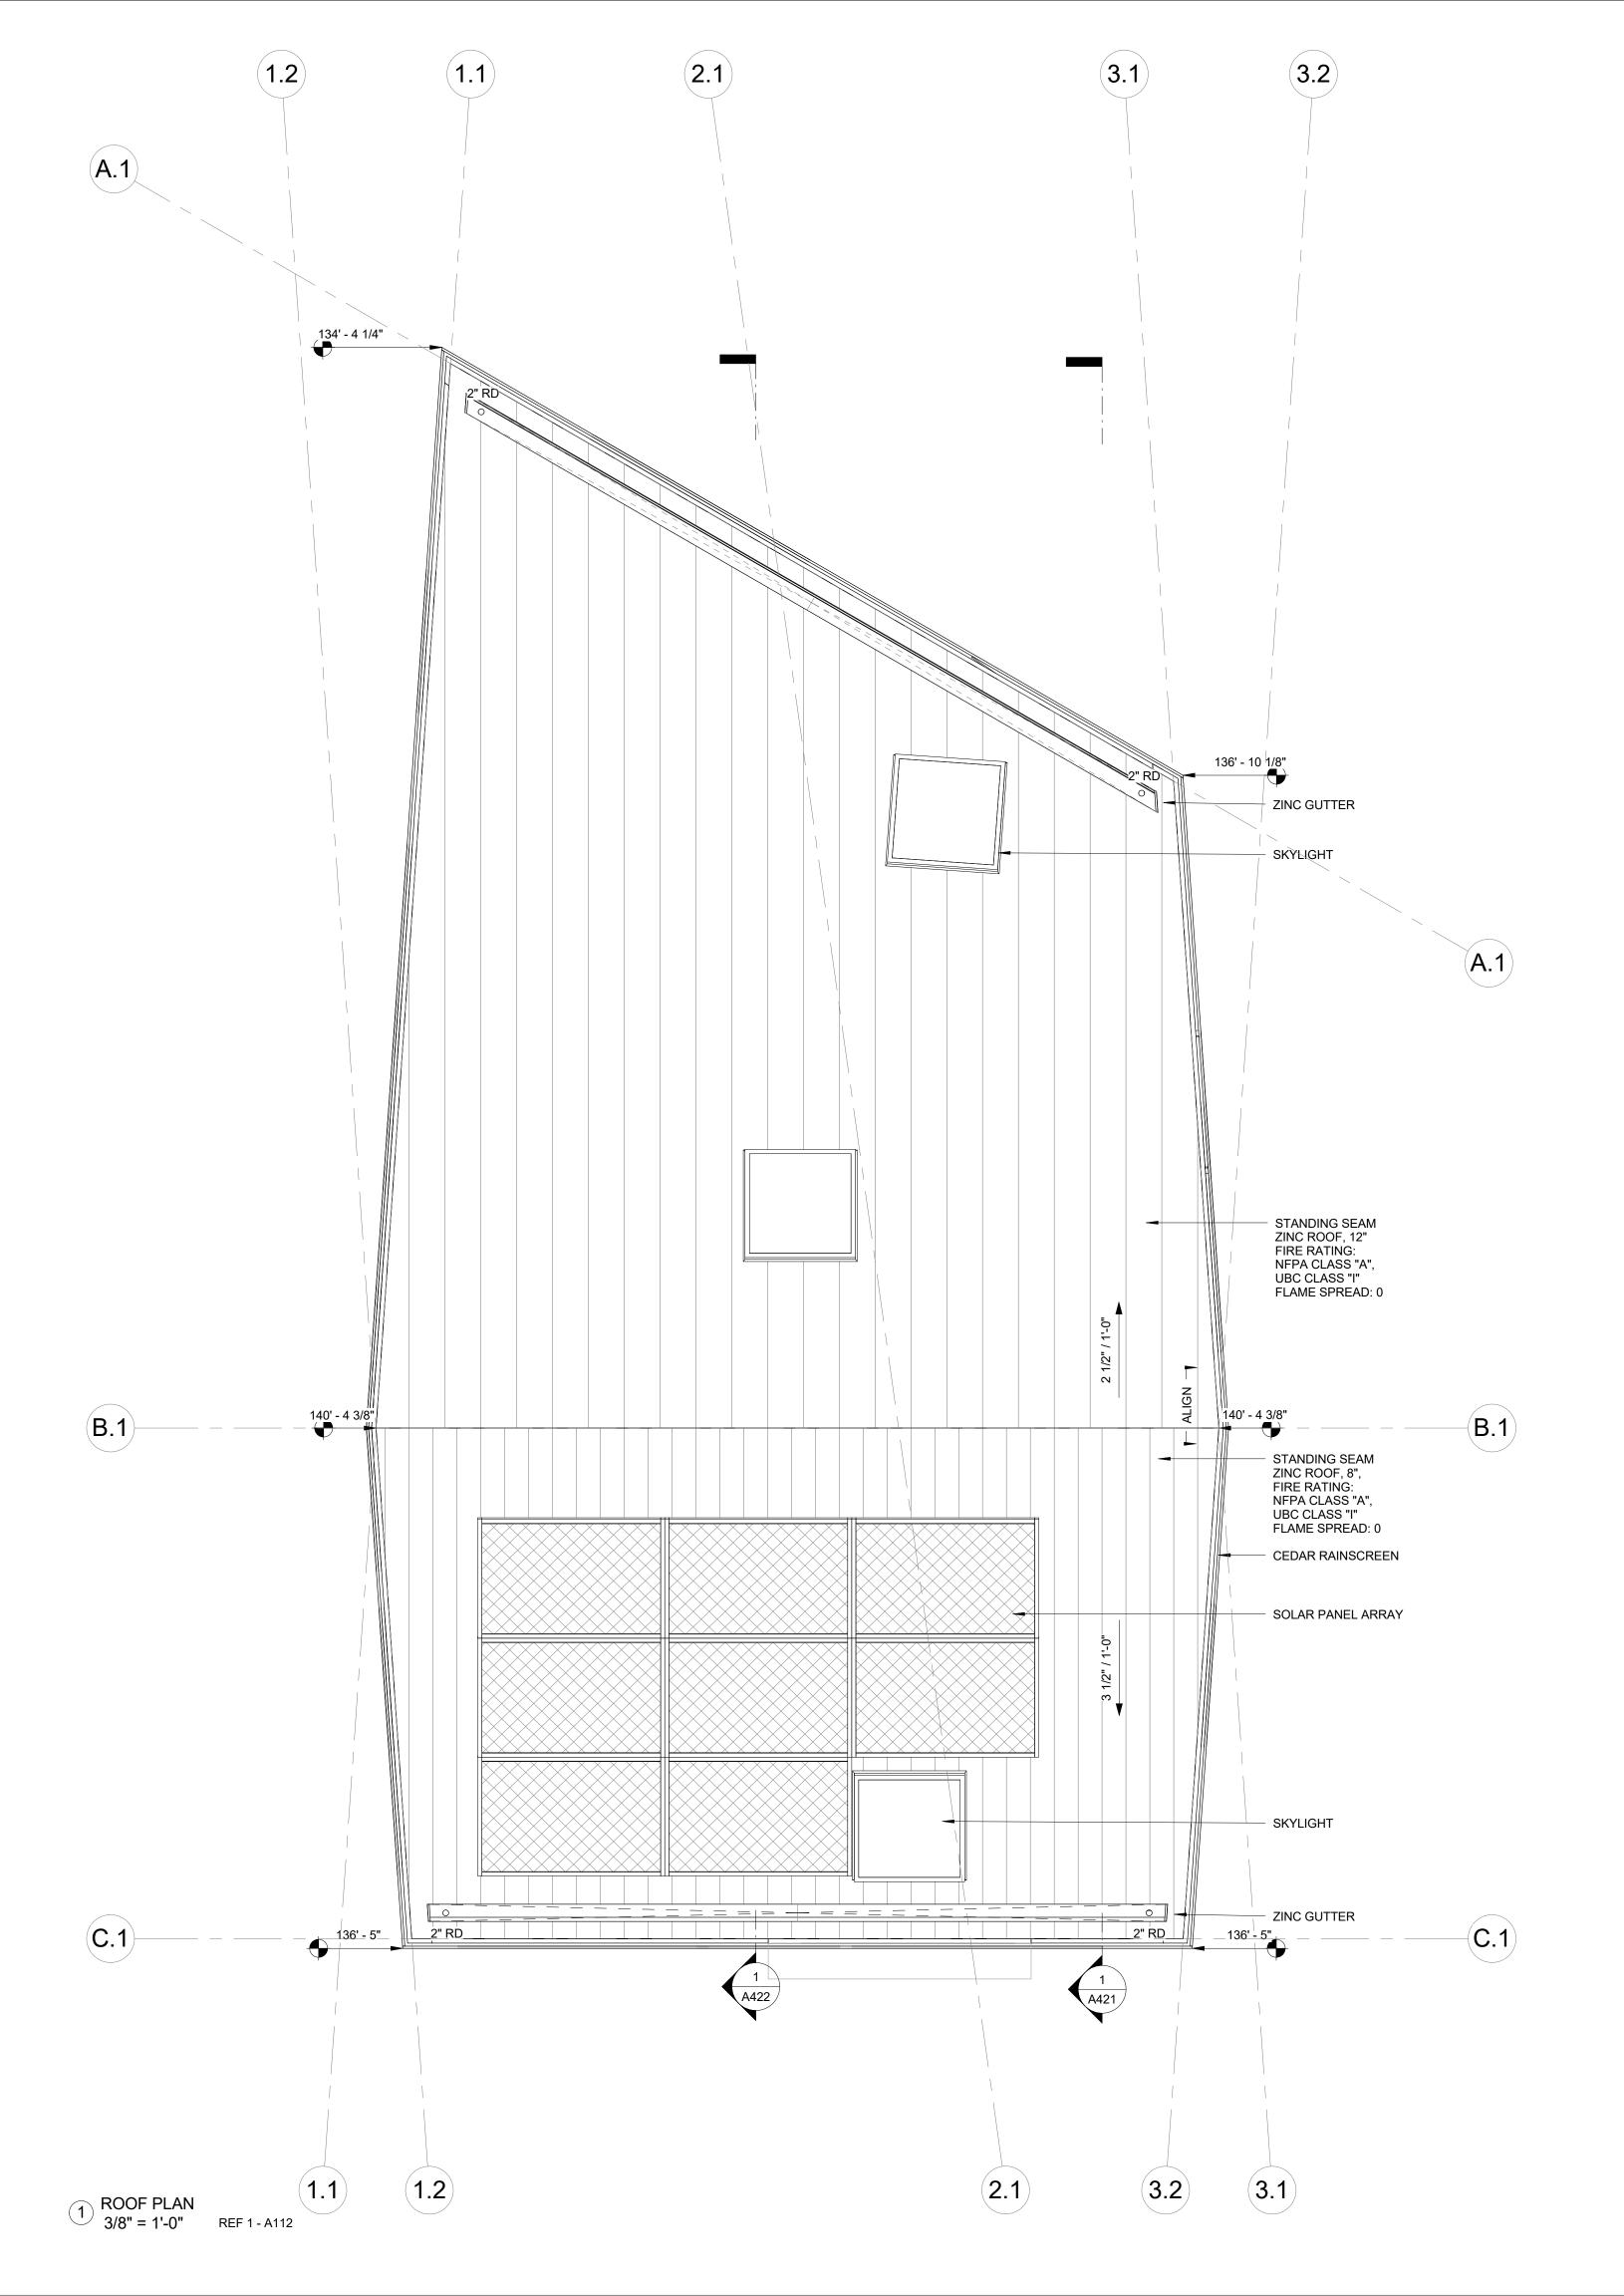

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ARCHITECT:

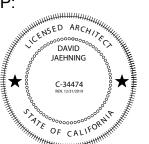David Jaehning Architect

25 Forest Side Avenue, San Francisco, California 94127

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SWCA Environmental Consultants: Half Moon Bay, California

Sigma Prime Geosciences, Inc.: Half Moon Bay, California

STRUCTURAL: Alex Lau Engineering: C 75773, San Francisco, California

CLIENT:

Elle and Ivan Li

1855 Sunshine Valley Road, Moss Beach, California 94038

PROJECT NO: PROJECT NAME:

1802 **Sunshine Valley** Residence

PROJECT

APN 037156130, Sunshine Valley Road Moss Beach, California 94038 ADDRESS:

PROJECT PHASE: Construction Documents

DRAWN: CHECKED: Checker Author

ISSUE DATE: 5/14/2019 1:24:10 PM

DRAWING TITLE: ROOF PLAN

DRAWING NO:


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ARCHITECT:

EXTERIOR LIGHTING SCHEDULE:

David Jaehning Architect

25 Forest Side Avenue, San Francisco, California 94127

CONSULTANT TEAM:

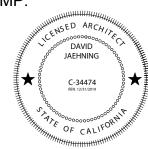Trees 360 Degrees, Straun Edwards: WE5612-A Saratoga, California

SWCA Environmental Consultants: Half Moon Bay, California

Sigma Prime Geosciences, Inc.: Half Moon Bay, California

STRUCTURAL: Alex Lau Engineering: C 75773, San Francisco, California

CLIENT:

Elle and Ivan Li

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PROJECT NO: PROJECT NAME:

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APN 037156130, Sunshine Valley Road Moss Beach, California 94038 PROJECT ADDRESS:

PROJECT PHASE: Construction Documents

CHECKED: Checker DRAWN: Author


ISSUE DATE: 5/14/2019 1:24:11 PM

DRAWING TITLE: **ELEVATIONS**

DRAWING NO: **A311**

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EXTERIOR MATERIAL SYMBOLS

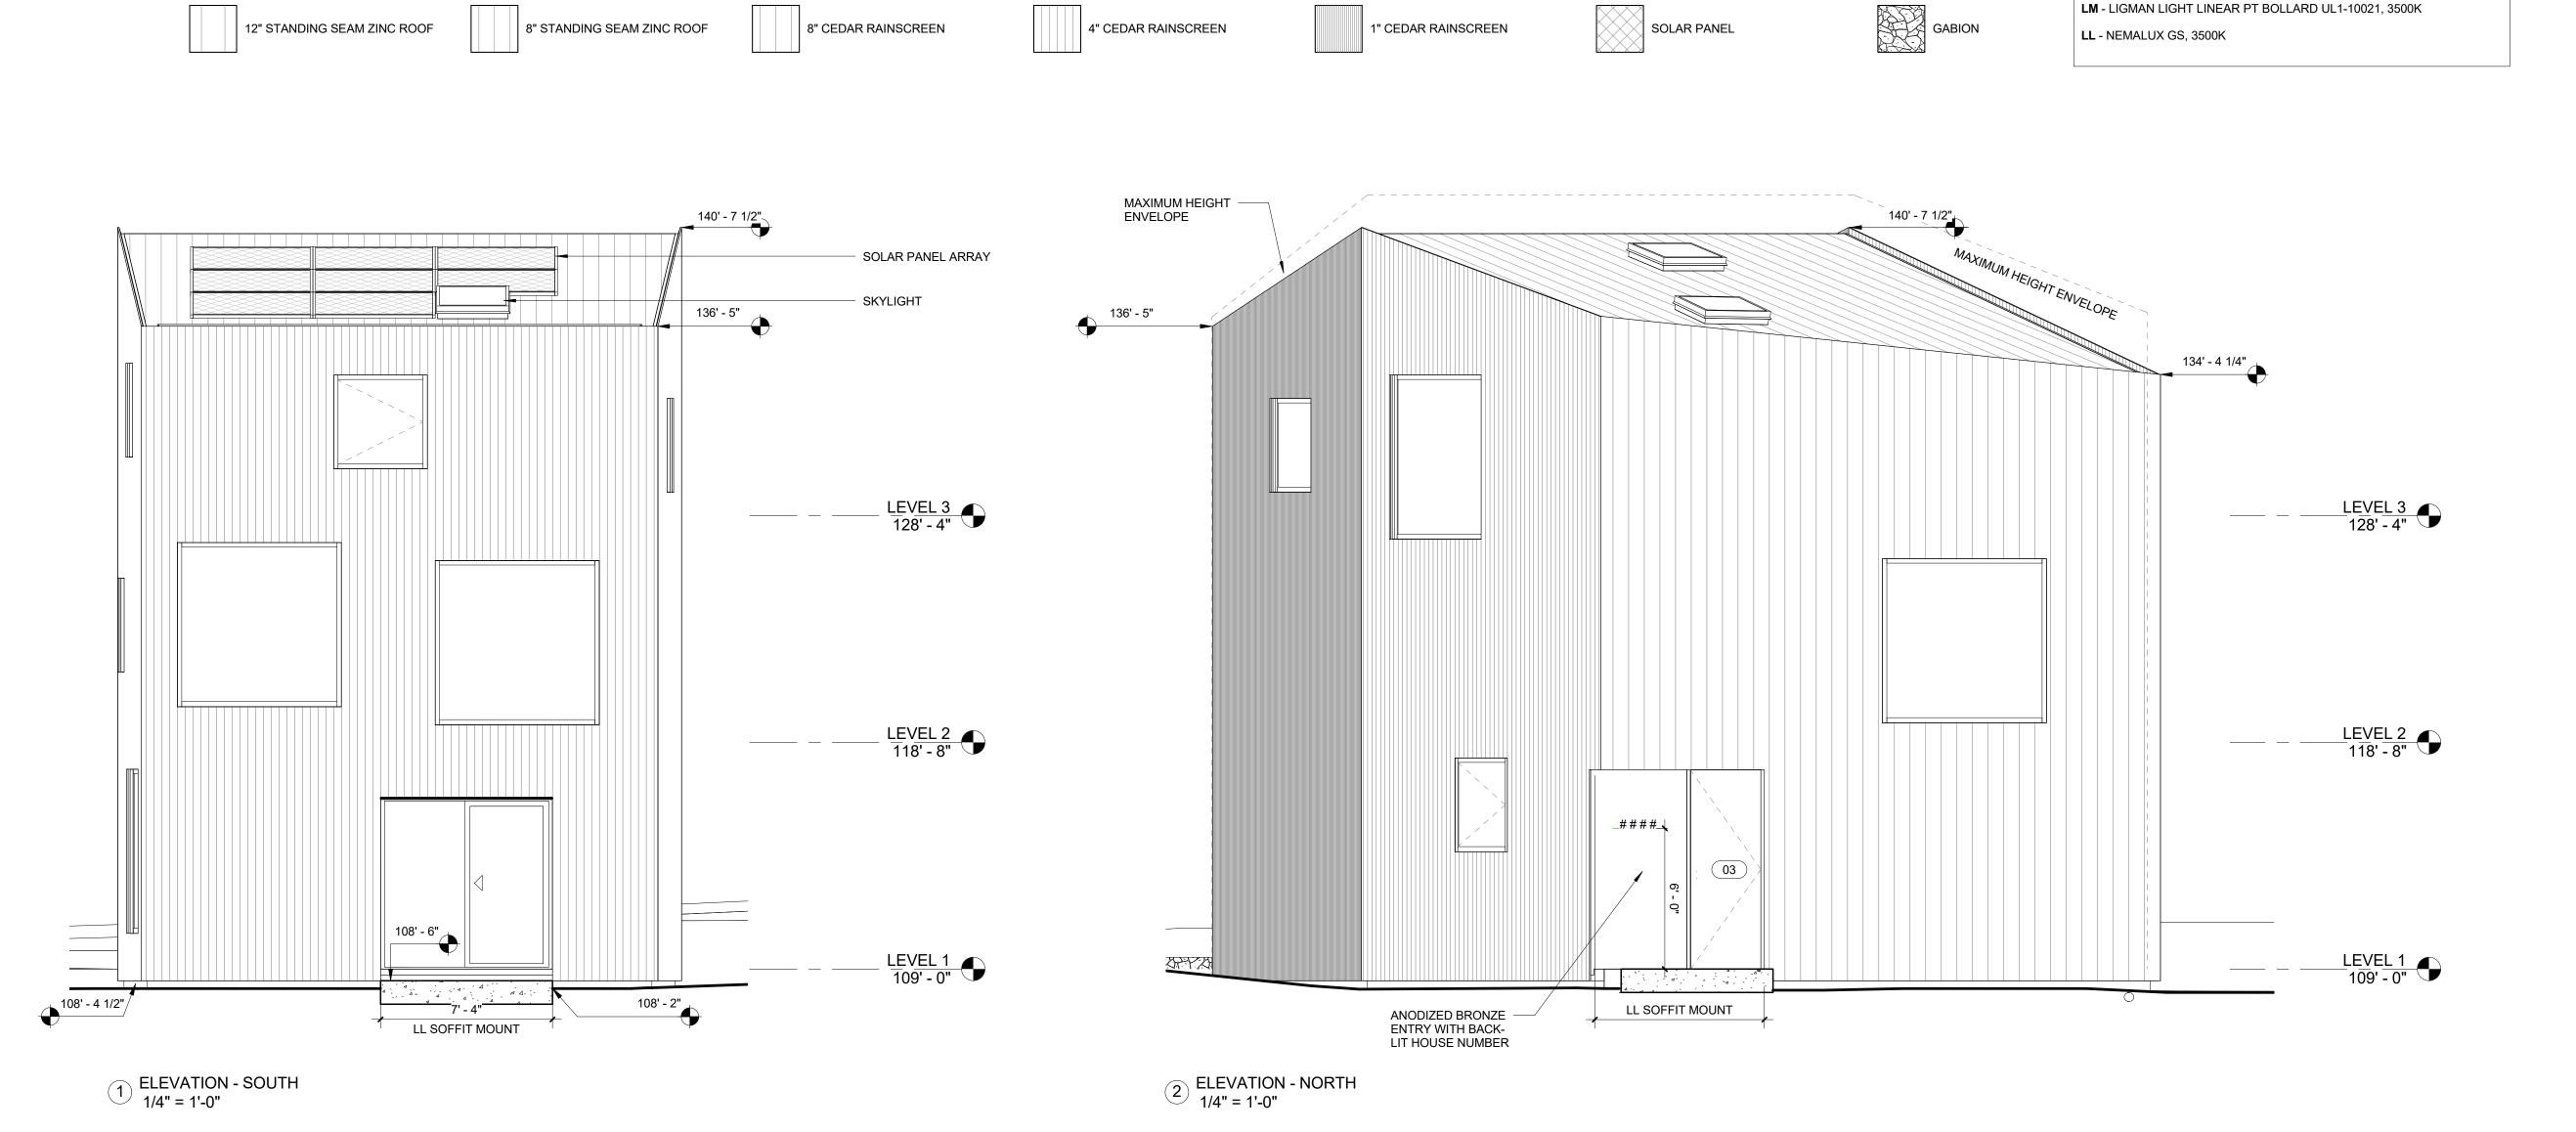

Design review hearing application

APN 037156130 Sunshine Valley Residence Moss Beach CA 94038

Response to Planning Comments PLN 2018-00458

May 13 2019



TABLE OF CONTENTS

02	Introduction
03	Proposed Certificate of Compliance
04	Survey
05	Setbacks
06	Height
09	Site Plan
10	Arborist Report
11	Landscaping
12	Erosion Control Plan
13	Biology Report
16	Soft Copy
16	General Comments/Questions
20	Geotechnical
21	Civil Drainage and Stormwater

INTRODUCTION

One November 21, 2018 our design team submitted a Design Review Hearing application for a new residence on Sunshine Valley Road in Moss Beach, California, APN: 037156130, on behalf of Fuli Li and Weiguang Xie. On December 21 we received planning comments from Laura Richstone, and on December 26 geotechnical and stormwater/drainage comments from Sherry.

This document is in response to these planning comments in order to deem our application complete. Please refer to the table of contents, as it has been organized in order of the comments received from the County of San Mateo Planning & Building Department. Each response begins with the question or comment posed, then with a response in the form of diagram, photograph, drawing, or reference to another document too large to include within these pages.

David Jaehning per David Jaehning Architect Tele: (415) 272-9444

Email: djaehning@davidjaehning.com

PROPOSED CERTIFICATE OF COMPLIANCE

Questions/comments:

- a. Grant deeds provided are incomplete. They mostly speak to lots 10, 11, 12 and only go back to 1979.
- b. The grant deeds should focus on lots 13 and 14 and go back as far as possible (preferably to the creation of the subdivision in 1907).
- c. In order to process a COC Type A, the County needs to see that lots 13 and 14 were conveyed separately from all of the adjacent lots prior to 1945.
- d. I would recommend getting a Title Report from a title company.

Response:

Please refer to the attached document. "CLTA Chain of Title Guar Form 6 6-6-92-N" is a Chain of Title Guarantee prepared by First American Title Company. Schedule A lists Lots 13 and 14 separate from the other lots under Tract Two (037-156-130): JPN: 037-015-156-13A APN: 037-156-050 and 037-156-130.

"The Following Matters Affect TRACT TWO: (037-156-130):" begins on page 6. It begins with chain of title documents recorded beginning on December 12, 1927 up to the current Client of the proposed residence.

Other documents included for reference are "GUARANTEE DOCUMENTS_01" and "GUARANTEE DOCUMENTS_02".

Form No. 6 (6-6-92) CLTA Chain of Title Guarantee

Order Number: 3420-5855272 Page Number: 2

SCHEDULE A

CHAIN OF TITLE GUARANTE

The assurances referred to on the face page hereof are

That, according to those public records which, under the recording laws, impart constructive notice of matters relating to the interest, if any, which was (acquired) (reserved) by:

WEIGUANG XIE AND FULI LI, HUSBAND AND WIFE AND ZHENING HU AND XIAOYONG LI, WIFE AND

pursuant to a GRANT DEED in and to the real property in the unincorporated area of the County of San Mateo, State of California . described as follows:

TRACT ONE: (037-156-050)

PARCEL I:

LOTS 10, 11 AND 12 IN BLOCK 4, AS SHOWN ON THAT CERTAIN MAP ENTITLED "MAP OF RESUBDIVISION OF MARINE VIEW TERMACE TRACT, SAM MATEO COUNTY, CALIFORNIA", FILED IN THE OFFICE OF THE COUNTY RECONDER OF SAM NAMED COUNTY, STATE OF CALIFORNIA, ON OCTOBER 30, 1907 IN BOOK 5 OF MAPS AT PAGE(5) 39.

PARCEL II:

COMMENCING AT THE COMMON FRONT PROPERTY CORNER OF LOTS 22 AND 23 OF SAID BLOCK 4; THENCE NORTH 89° 15° WEST, ALONG THE NORTHERLY RIGHT OF WAY LINE OF LANGASTER BOULEVARD LS.OF DEET TO THE POINT OF BEGINNING FOR SAID ASSEMBLY, THENCE NORTH 4° 45° EAST ALONG THE CENTERLINE OF THE 2° WIDE EASEMENT, MEASURED AT RIGHT ANGLE TO SAID CENTERLINE, A DISTANCE OF 100.00 FEET TO THE MOST NORTHERLY LINE OF SAID LOT 23.

JPN: 037-015-156-05A

TRACT TWO: (037-156-130)

LOTS 13 AND 14 IN BLOCK 4, AS SHOWN ON THAT CERTAIN MAP ENTITLED "MAP OF RESUBDIVISION OF MARINE VIEW TERRACE TRACT, SAN MATEO CO., CAL.", FILED IN THE OFFICE OF THE COUNTY RECORDER OF SAN MATEO COUNTY, STATE OF CALIFORNIA, ON OCTOBER 30, 1907 IN BOOK 5 OF MAPS AT PAGE(5) 39.

JPN: 037-015-156-13A

APN: 037-156-050 and 037-156-130

First American Title Company

22. A document recorded August 13, 1992 as INSTRUMENT NO. 1992-130476 of Official Records.

GERALD P. FREIDIN AND PAULINE B. FREIDIN, HUSBAND AND WIFE, AS THEIR COMMUNITY PROPERTY GERALD P. FREIDIN AND PAULINE B. FREIDIN, HUSBAND AND WIFE, TRUSTEES UNDER TRUST AGREEMENT DATED JULY 22, 1992

23. A document recorded April 25, 1996 as INSTRUMENT NO. 1996-50137 of Official Records.

GERALD P. FREIDIN AND PAULINE B. FREIDIN, HUSBAND AND WIFE,

TRUSTEES UNDER TRUST AGREEMENT DATED JULY 22, 1992
PAUL REPLICON AND JEAN REPLICON, HUSBAND AND WIFE AS JOINT

24. A document recorded March 13, 2014 as INSTRUMENT NO. 2014-21048 of Official Records.

PAUL REPLICON AND JEAN REPLICON, HUSBAND AND WIFE WEIGUANG XIE AND FULI LI, HUSBAND AND WIFE AS JOINT TENANTS

25. A document recorded May 07, 2014 as INSTRUMENT NO. 2014-39082 of Official Records

WEIGUANG XIE AND FULI LI, HUSBAND AND WIFE

WEIGUANG XIE AND FULI LI, HUSBAND AND WIFE AND ZHENING HU AND XIAOYONG LI, WIFE AND HUSBAND, ALL AS JOINT TENANTS

The Following Matters Affect TRACT TWO: (037-156-130):

26. A document recorded December 12, 1927 as BOOK/REEL 325, PAGE/IMAGE 415 of Official Records.

IN THE MATTER OF THE ESTATE OF MARIE BERGITTE SPUUR, ALSO KNOWN AS MARY B. SPUUR, DECEASED IN THE SUPERIOR COURT OF THE STATE OF CALIFORNIA, IN AND FOR THE CITY AND COUNTY OF

SAN FRANCISCO
1/3 THEREOF TO SAID ALFRED J. SPUUR. 2/15 THEREOF TO SAID
LAWRENCE SPUUR. 2/15 THEREOF TO SAID CARL SPUUR, 2/15
THEREOF TOO SAID EVA SPUUR. 2/15 THEREOF TO SAID MARY SPUUR,
AND 2/15 THEREOF TO SAID HENRY SPUUR.

27. A document recorded August 25, 1932 as BOOK/REEL 599, PAGE/IMAGE 62 of Official Records.

A. MCSWEENEY, TAX COLLECTOR OF THE COUNTY OF SAN MATEO STATE OF CALIFORNIA
THE STATE OF CALIFORNIA

28. A document recorded May 27, 1955 as BOOK/REEL 2806, PAGE/IMAGE 286 of Official Records.

RALPH C. MAC ARTHUR TAX COLLECTOR OF THE COUNTY OF SAN MATEO STATE OF CALIFORNIA CALIFORNIA PACIFIC TITLE INSURANCE COMPANY

First American Title Company

(Above) Excerpts from the Chain of Title Guarantee prepared by First American Title Company. See "CLTA Chain of Title Guar Form 6 6-6-92-N" for a full description.


SURVEY

Questions/comments:

- a. Must be stamped and signed by a licensed surveyor b. It is a little busy, please bold or specifically call out the property lines (especially the front property line).
- c. See comment 9.a below

Response:

The survey is prepared and signed by a licensed surveyor, BGT Land Surveying. In making it scaled to fit my drawings, I did not include BGT's title bar with their stamp. Attached is the file for reference. This is now included in full as part of the 24x36 drawing set. Property lines have been further highlighted and noted for clarity. Top of Bank has been established and is noted on the Archtiectural Site Plan.

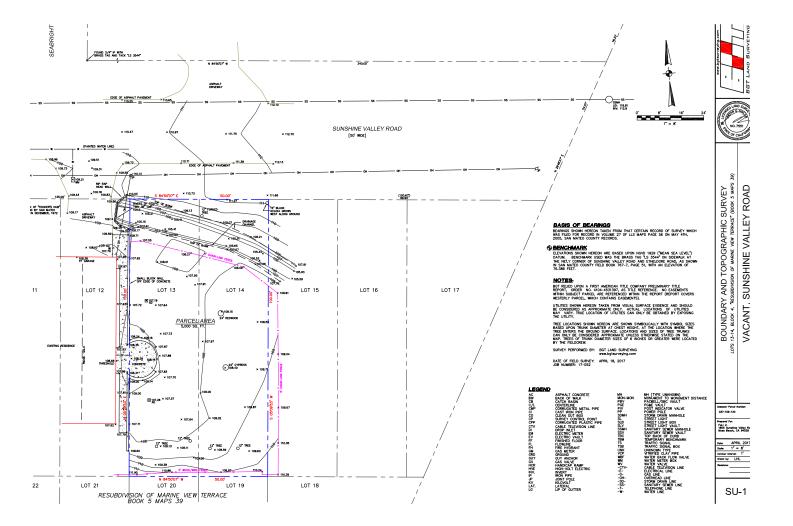

⁽Above) Survey by BGT Land Surveying.

SETBACKS


Questions/comments:

a. Only a combined 15' side yard setback is required with a minimum setback on either side of 5' feet.

i. i.e. you can have a setback of 5' on one side and 10' on another or 7.5' on both sides etc. This is pertinent to 4.a and 5.c below.

Response:


The proposed residence has been adjusted. See A112 - Architectural Site Plan for the updated setbacks: west side yard 11' - 2", east side yard 15' - 0", and rear yard 18' - 0" (covered under variance request). The Dean Creek setback does not allow us to take advantage of the full front yard setback, and when considering the allowable built area, pushed this residence to a three-story proposal. This segways into the next set of questions/comments on height.

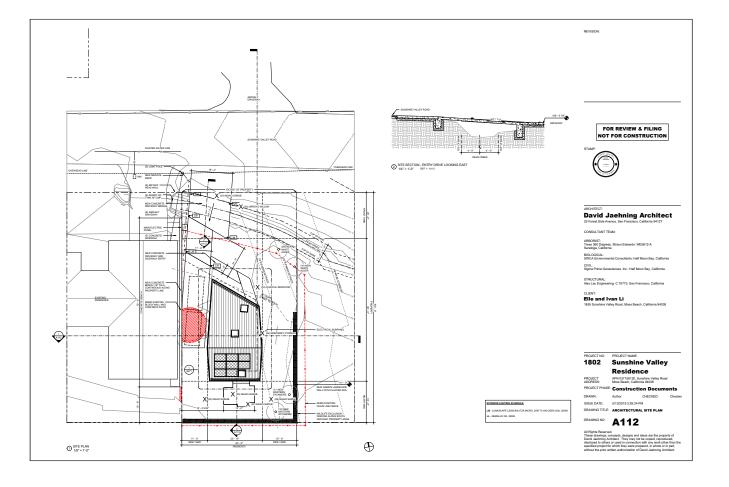


(Above) A112 Architectural Site Plan

5

HEIGHT

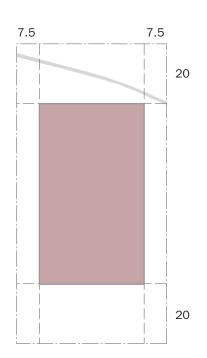

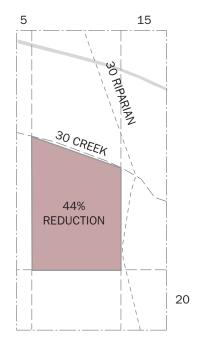

(Above) Allowable zoning per regulations for "S-17" Combining District, Midcoast (Below) Allowable zoning with applied riparian corridors

Questions/comments:

a. The increase in height of 33' is only allowed for parcels with a 30% slope or greater. In addition this height increase is only for the center 40% of the house. Because this lot does not have a significant slope the maximum height for a structure is 28'. Please reduce the height of the building.


Response:


Our site analysis began with following the Section 6300.2 Regulations for "S-17" Combining District (Midcoast). The above diagram to the left follows the minimum setbacks of front (20-feet), sides (combined 15-feet), and rear (20-feet). This formula allowed for 2,100 square feet of parcel coverage. The below left diagram acknowledges a 30-foot setback required for Dean Creek, an intermittent stream. As an Arroyo Willow thicket is found to the east of the property, an additional 30-foot setback is required as a vegetation buffer. The resulting parcel coverage is 1,177 square feet, or a 44% reduction.

Our massing studies began by following the 28-foot maximum, but quickly realized a two-story option would not allow the project to reach either the allowed building floor area (0.53 of parcel size or 2,650 square feet) or the client's program requirements (next page) without a third level.


In order to minimize its bulk, the next step was to follow the daylight plane requirements. Shown in the diagram to the right, the plane is established on two opposites sides of the house, upward a vertical distance of 20-feet, and then inward at an angle of 45° until the maximum building height was reached.

The following page shows a series of massing options that pay careful attention minimizing the mass above 28-feet. During our pre-application meetings on September 27 with Carmelisa and Camille we agreed that the additional site constraints posed by Dean Creek could be relieved by allowing part of the house to hit the 33-foot mark, gaining a third level. We then shaped the house to minimize the bulk.

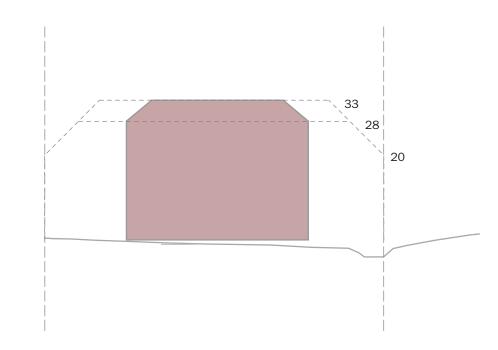

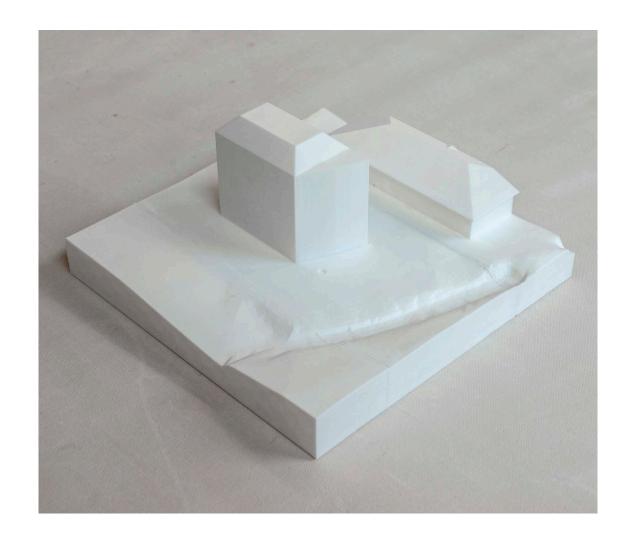

(Above) Daylight plane diagram (Below) Massing study that is the result of allowed parcel coverage and daylight planes

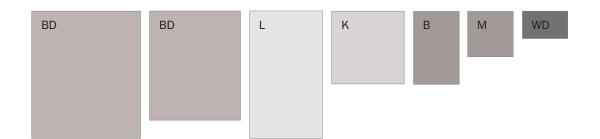

Ground floor


BD - two bedrooms

L – living roomK – lower kitchen

B – full bathroom

M – mechanical

WD - washer and dryer

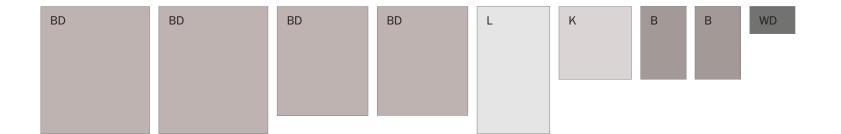


Upper floors

BD - four bedrooms

L – living room
K – upper kitchen
B – two full bathrooms

WD – washer and dryer

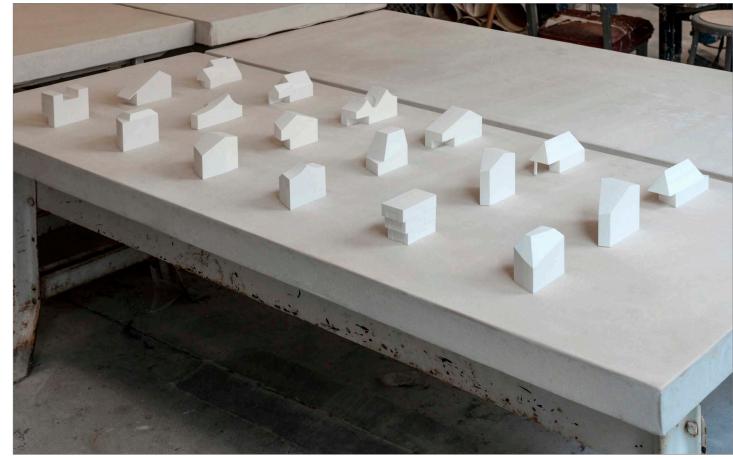

HEIGHT (CONTINUED)

(Top right)


Longitudinal section as presented on November 21, 2018 in which only the peak of the house is at 33-feet. The perimeter elevation heights are between 28 and 26-feet.

(Middle right)


After receiveing your comments, the house has been reduced as much as possible by: a) reducing the pitch of the roof without creating unliveable top floor rooms, b) reduced the first and second floor heights to 8'-6", and 3) using a robust laminated veneer lumber joist system to minimize floor depth. Our position on the 8'-6" height is based on a) lower would affect daylighting thus adding to artificial lighting loads, and b) the house provides radiant heat only, bypassing A/C cooling and any lower height would affect fresh air and bring the trapped heat at the ceiling closer to house occupants. This is the limit of our adjustment without hardship.

(Bottom right)

If the house were required to be reduced to 28-feet (at its peak only), this would cause the ground floor of the house to be carved (or sunken into) the ground plane. This is strongly ill-advised by our geotechnical engineer as it would require a constant sump pump system as well as expensive and robust water-proofing details.

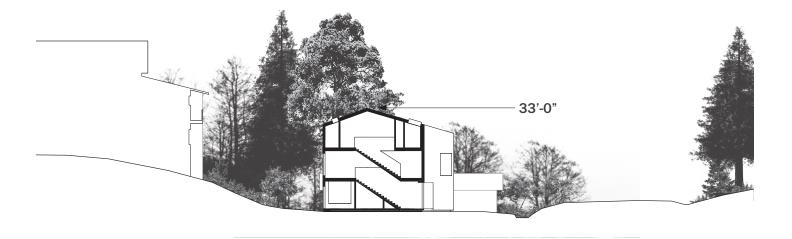



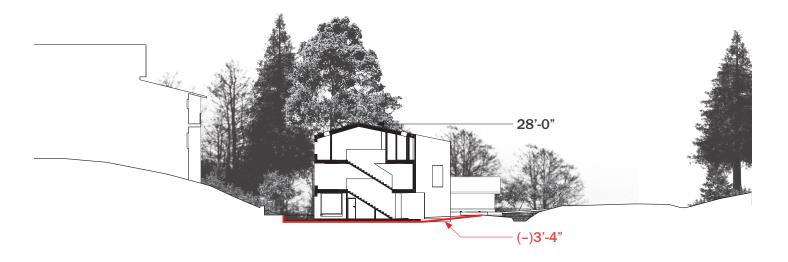

 $(Above) \ \textbf{Sequence of site section height studies}.$


SITE PLAN

Questions/comments:

- a. It's hard to tell where the property lines are. Please either bold or specifically call out.
- b. The 30' Dean Creek setback does not scale out to 30'. Portions of the setback only scale to 28' and the house encroaches into the setback. Please move the house out of the creek setback. This will encroach into the rear yard setback but will be covered/ considered under the variance.
- c. Finish drawing the 30' Riparian buffer line.
- i. It looks like the house will encroach into this buffer area when the line is drawn. Move the house outside of the buffer area
- d. Show existing trees on the property and if they will be retained or removed
- i. "X" out trees proposed for removal
- ii. Number the trees per the arborist report
- e. Show location of uncovered parking spaces.

Response:

a. Additional annotations have been added to call out the property lines, b. The previous version followed the setbacks from the (previous biology consultant), The proposed residence has been moved outside the Dean Creek setback, c. The proposed residence has been moved outside the riparian setbacks. d. See updated plan A112 and landscape plans. As per the arborist report, all existing trees to be removed. Trees have been "X" out and labeled per the arborist report, e. uncovered parking spaces are shown dashed on A112.

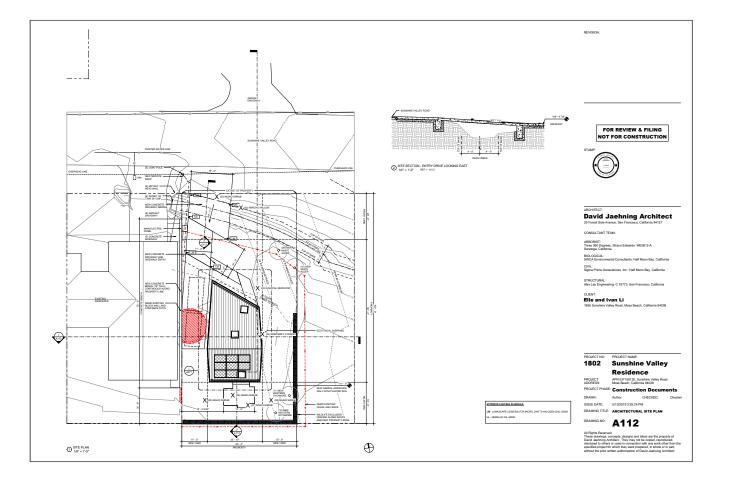

(Above) A112 Architectural Site Plan

ξ

ARBORIST REPORT

Questions/comments:

- a. Revise to include a description of all trees on the property including trees in the right-of-way directly in front of the property(size, health, species etc.) and include recommended tree protection measures for trees to be retained. The report should include a tree inventory. b. Incorporate tree protection measures into a separate tree protection sheet.
- c. Show recommended location of required tree replantings

Response:

Please refer to the documents attached to this document. "Sunshine Valley Residence Tree Report" is a narrative of all trees on site provided by Trees 360 Degrees. "Sunshine Valley Residence Tree Inventory" is a listing of all trees on site provided by Trees 360 Degrees. Recommended new tree planting locations have been provided on the architectural and landscape plans.

Sunshine Valley Residence APN 037156130 Sunshine Valley Road Moss Beach CA 94038

To whom it may concern:

Trees no. 1 & no. 2 are located at the front of the property, along the road side. The
Myoporum is fairly insignificant and the Salix is a specimen that has previously failed and is
currently growing along the ground. Trees no. 3 & no. 4 (Sequota and Hesperocyparis) will
require removal to allow for construction. Trees no. 5-10 (Myoporum) are old specimens that are
located in close proximity to the property boundary lines. All of these trees have fallen and
continue to grow along the ground. This growth pattern is typical for the species of older age.

It is my professional opinion that none of the Myoporum be classified as significant trees and recommendation that these trees be removed and replaced to create a similar canopy for vegetative screening purposes. Replacement trees could include same species or others such as Melaleuca, Pittosporum, Lauris, Ceanothus, or Salix. Final decision would depend on preference of the homeowner. In regard to the tree protection, at this time I do not deem it necessary to provide tree protection if all trees on site are to be removed. However, should any trees be retained and protection required, I recommend 6 ft. chain link fencing be installed at, or as close to, the drip lines of the canopies throughout all phases of construction. Should you have any questions regarding the above information please do not hesitate to call me at (408) 898-

Thank you,

Straun Edwards ISA Certified Arborist WE-5612A

SUNSHINE VALLEY RESIDENCE TREE INVENTORY MOSS BEACH. CA

Tree No.	Scientific name	Common name	DBH (in.)	Health	Vigor	Structure	Comments	
1	Myopourm laetum	Ngaio Tree	6&7	Fair	Fair	Poor	Large shrub, small tree. Old specimen, typical form and structure for species- not a significant tree.	
2	Salix lasiolepis	Arroyo willow	12	Fair	Fair	Poor	Tree has previously failed, lying on the ground a regrown.	
3	Sequoia sempervirens	coast redwood	26	Good	Good	Poor	Co-dominant structure at 15 ft. Large include bark area is visible. Tree will need to be remo to accommodate construction.	
4	Hesperocyparis macrocarpa	Monterey cypress	26	Good	Good	Fair	Young specimen with decent structure and hea Tree will need to be removed to accommodat construction.	
5	Myopourm laetum	Ngaio Tree	6	Poor	Poor	Poor	Large shrub, small tree. Sprouted up from tre that was previously removed.	
6	Myopourm laetum	Ngaio Tree	16	Poor	Poor	Poor	Older specimen. Large amount of deadwood, has peviously failed and is lying on the groun Tree is still alive and growing. Structure and for is typical for species.	
7	Myopourm laetum	Ngaio Tree	14	Poor	Poor	Poor	Older specimen. Large amount of deadwood, has peviously failed and is lying on the grour Tree is still alive and growing. Structure and f is typical for species.	
8	Myopourm laetum	Ngaio Tree	12	Poor	Poor	Poor	Older specimen. Large amount of deadwood, tree has peviously failed and is lying on the ground. Tree is still alive and growing. Structure and form is typical for species.	

Trees 360 Degrees PO Box 2280 Saratoga, CA 95070

Inventory 2/18/2019

(Above) Excerpts from the documents provided by Trees 360 Degrees, the certified arborist for this project. Full descriptions are attached to this document.


LANDSCAPING


Questions/comments:

- a. Do not show the trees proposed for removal on the landscaping plan
- b. Is the new turf native grasses? Or just regular turf? If is just regular grass how will it survive without irrigation?
- c. Specify the plants proposed for the planting beds and native riparian species (location, quantity, species)
- d. See Comment 9.c.iv below

Response:

a. Trees proposed for removal have been taken off of the Landscape Plan (now named L001). A new sheet, L002 has been drawn per your request to show a Tree Location Plan, b. This is new seeded grass, Pestuca Rubra. This grass type is on the recommended list "San Mateo Countywide Stormwater Pollution Prevention Plan". It is recommended as a California native and is drought tolerant. This grass will be hand-watered with no irrigation system, c. The new planting beds will be Baccharis Pilularis. This plant type is on the recommended list "San Mateo Countywide Stormwater Pollution Prevention Plan". It is recommended for bioretention areas and flow through planters (see C001 Flow Through Planter), vegetated buffer strip, a California native and is drought tolerant, 303 square feet of full coverage, d. As the existing turf is proposed for removal being close to the riparian buffer, we propose replacement with native riparian plant species: holciformis, festuca rubra, sisyrinchium bellum, achillea millefolium, allium sp., Epilobium densiflorum, limonium californicum, and monardella. Planted to achieve approimately 70% cover. Mulch to be spread over exposed soil areas between plantings to prevent soil erosion.

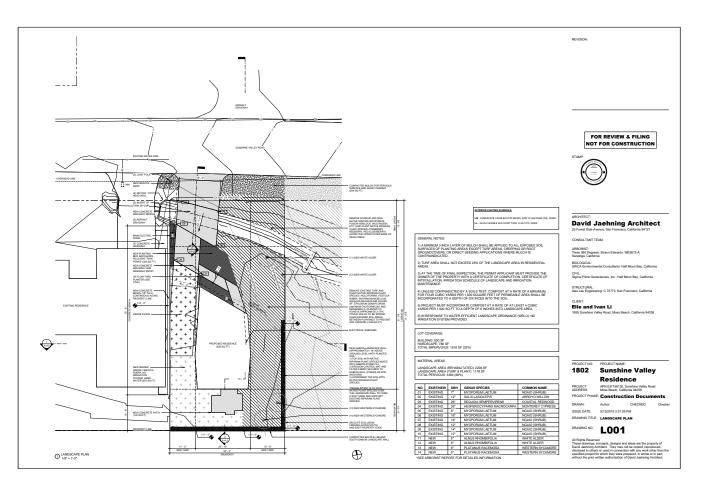

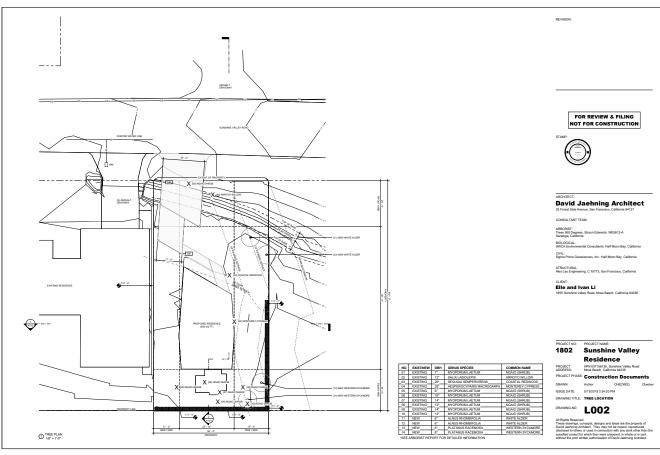

 $(\mbox{\it Above})$ L001 Landscape Plan and L002 Tree Location Plan

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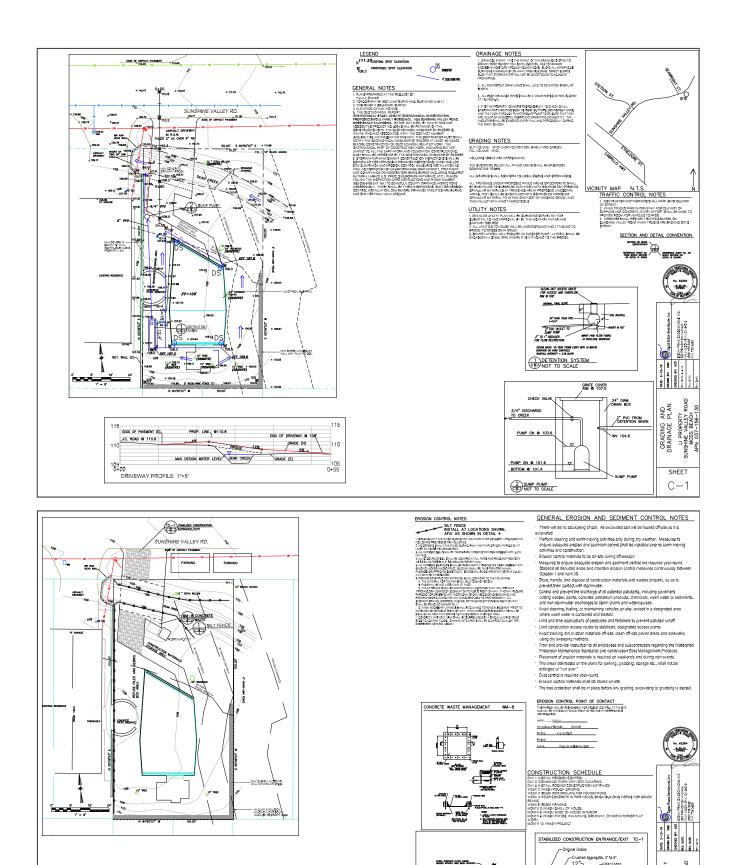
EROSION CONTROL PLAN

Questions/comments:

- a. Please provide an erosion control plan for the construction of the bridge and the house
- b. The EC plan should be a separate sheet from the grading plan.
- i. Show location of equipment storage areas, ec measures, concrete washout etc.
- ii. The biologist should consult on the EC plan. See comment 9 below.

Response:

See the new Civil drawings. C002 address erosion and sediment control. C001 provides the locations requested. All have been confirmed with SWCA, our boilogical consultant.



SILT FENCE NOT TO SCALE

(Above) C001 Grading and Drainage Plan and C002 Erosion and Sediment Plan.

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SHEET

BIOLOGY REPORT

Questions/comments:

- a. Biologist to establish top of bank (TOB). The TOB should then be mapped on the survey and shown on the site plan.
- b. Revise to include discussion about the construction of the bridge
- i. What type of work is involved in the construction?
- 1. What work is expected to occur in the creek or on the banks?
- 2. Discuss the footings on the bank and exposed sewer line
- ii. How long will it take? When is the best time for it to happen?
- iii. What would the potential impacts be from the construction activities?
- iv. Provide more specific erosion control measures
- c. Mitigation Measures Questions
- i. Who installs the woodrat exclusion fencing?
- 1. How long before construction begins should this fencing be installed?
- 2. Is this the same type of fencing that you recommend for the SFGS and CRF?
- 3. Can you provide picture examples of the fencing?
- 4. Please provide a map of where each fencing type should be installed
- ii. Provide mitigation measures for if a woodrat nest is found on the site.
- iii. Will construction activities/noise interfere with the woodrats' breeding season?
- iv. Please address all landscaping in the riparian buffer
- 1. The bio report should determine the appropriate mix of natives to be installed
- a. What would be the establishment rate of the new plants?
- 2. Address the proposed removal of the non-native species within the banks of Dean Creek (does that need biologist oversight?)
- a. When should this removal happen?
- b. Will the removal of the vegetation destabilize the bank?

Response:

See following pages and attached PDF "Response to Planning Comments PLN2018-00458-FINAL"



Half Moon Bay Office 60 Stone Pine Road, Suite 100 Half Moon Bay, California 94019 Tel: 650.440.4160 Fax: 650.440.4165

MEMORANDUM

To: Fuli Li, Project Applicant

CC: David Jaehning, Owner, David Jaehning Architect

From: Kristen Outten, Project Manager, SWCA Environmental Consultants

Date: January 17, 2019

Re: Responses to County of San Mateo Planning Comments for 1855 Sunshine Valley Road, Moss Beach,

California (PLN 2018-00458)

SWCA Environmental Consultants (SWCA) understands that Fuli Li (Applicant) submitted plans to the County of San Mateo (County) to construct a new single-family dwelling on 1855 Sunshine Valley Road in Moss Beach, California. The County provided comments regarding the project plans to the Applicant on December 21, 2018. This memorandum provides responses to the County's planning comments, specifically those that pertain to environmental resources.

Comment No. 5 - Site Plan

- (c) Refer to Drawing No. A112, Site Plan for a complete drawing of the 30-foot riparian buffer line.
 - (i) House has been relocated outside of the 30-foot buffer line.

Comment No. 8- Erosion Control Plan

- (a) Refer to Drawing No. C-2, Erosion Control Plan.
- (b) Refer to Drawing No. C-2, Erosion Control Plan.
 - (i) Location of equipment storage areas, erosion control measures, concrete washout, etc. are shown on the Erosion Control Plan.
 - (ii) SWCA biologist Kristen Outten assisted in preparation of the Erosion Control Plan. Ms. Outten is a Qualified SWPPP Practitioner (QSP) as well as Certified Erosion, Sediment, and Storm Water Inspector (CESSWI).

Comment No. 9 – Bio Report

- (a) Refer to Attachment 1, Wetland Buffer and Vegetation Map, as well as Drawing No. A112, Site Plan for the top of bank of Dean Creek.
- (b) The County is requesting a revised Biological Impact Form to address construction of the bridge. SWCA cannot revise the existing report since it is authored by Coast Ridge Ecology. The Applicant, however, in coordination with SWCA, is providing information regarding construction of the bridge in the response to the County planning comments.
 - (ii) Construction of the bridge will occur during the dry season when no water is present in Dean Creek.
 - (iii) Dean Creek could be temporarily impacted by fuel spills. Dean Creek could also be temporarily affected from fugitive dust or sediment. Such impacts will be reduced or

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- avoided with the implementation of the Erosion Control Plan (refer to Drawing No. C-2).
- (iv) To prevent impacts associated with hazardous materials, fugitive dust, sediment, or other construction-related materials, erosion control best management practices (BMPs) will be installed and maintained throughout the duration of the project. BMPs will include, but are not limited to fiber rolls, stockpile protection, a stabilized construction entrance/exit, and concrete waste management. Refer to Drawing No. C-2, Erosion Control Plan, as well as cutsheets of specific erosion and sediment control BMPs.
- (c) (i) The construction contractor will install the woodrat exclusion fencing in accordance with Drawing No. A112, Site Plan.
 - (1) Woodrat exclusion fencing will be installed prior to the start of construction, including equipment and materials staging.
 - (2) Woodrat exclusion fencing will be the same exclusion fencing that will be installed for California red-legged frog and San Francisco garter snake. The escape funnels provided for snakes and frogs shall have a small enough escape funnel (i.e., less than 3" x 3" exit) to prevent woodrats from passing through.
 - (3) The following link provides a photos and a description of the wildlife exclusion fence: http://ertecsystems.com/resourcepdf.php?filename=5a5d31ef02701-ertec%20e-fence%20brochure%202018.pdf
 - (4) Refer to Drawing No. A112, Site Plan for the location of the wildlife exclusionary fencing.
 - (ii) If woodrat nests *with* young are observed within the project footprint, an exclusion fence will be erected around the nest site adequate to provide the woodrat enough foraging habitat at the discretion of the biologist. Site preparation (i.e., grubbing and grading) within the fenced area would be postponed or halted until young have left the nest. A biological monitor will be onsite during periods when disturbance activities occur near the active nests to ensure that no inadvertent impacts will occur to the nests. If woodrat nests are observed within the project footprint outside of the breeding period (February to July), the biologist will dismantle the nest (outside the breeding period), allowing individuals to relocate to suitable habitat within adjacent open space areas.
 - (iii) Construction activities are not anticipated to impact woodrat breeding activities, given that the above-described woodrat mitigation measure and Mitigation Measure #2 in the Biological Impact Form are implemented.
 - (iv) Existing turf within the 30-foot riparian buffer will be removed, and native grasses and herbaceous species will be planted in its place.
 - (1) Native species that will be planted within the 30-foot riparian buffer include but are not limited to *Deschampsia cespitosa* ssp. *holciformis, Festuca rubra, Sisyrinchium bellum, Achillea millefolium, Allium* sp., *Epilobium densiflorum, Limonium californicum,* and *Monardella* sp.
 - a. New vegetation within the 30-foot riparian buffer area will be planted to achieve approximately 70% cover. Mulch will be spread over exposed soil areas between plantings to prevent soil erosion within the buffer area.
 - (2) To prevent potential erosion concerns within the bed and banks of Dean Creek, removal of invasive and non-native species will be limited to the area outside the banks of Dean Creek. No vegetation removal will occur within the bed or banks of the creek. Vegetation and debris resulting from vegetation removal will be placed outside of the creek channel and in a location where they cannot roll, wash,

or move back into the creek channel. A qualified biologist will be onsite to oversee removal of invasive and non-native species.

- a. Vegetation removal will occur during the dry season to minimize the potential for soil erosion.
- b. Removal of vegetation will occur during the dry season to prevent the risk of bank destabilization. In addition, native vegetation will be planted in disturbed soil areas to further reduce potential erosion concerns.

Comment No. 11 - General Comments/Questions

(a) The bridge footings will be located outside the banks of Dean Creek, and construction activities are not anticipated to result in impacts to the bed or banks of Dean Creek. Furthermore, removal of invasive and non-native plans will occur outside of the bed and banks of Dean Creek. Therefore, a Streambed Alteration Agreement is not anticipated at this time. In the event there are changes to the project design and impacts to the bed or banks of Dean Creek will occur, the Applicant understands a Streambed Alteration Agreement issued by California Department of Fish and Wildlife would be required prior to building permit issuance.



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SOFT COPY

Questions/comments:

a. Please provide a soft copy of the proposed/revised plans

Response:

Noted.

GENERAL COMMENTS/ QUESTIONS

Questions/comments:


- a. Please note that a Streambed Alternation Permit issued by CA Fish and Wildlife will likely be required. If required this permit is needed prior to building permit issuance.
- b. Shed
- i. Why is there a sewer line running to the shed? Does the shed house a washer and dryer?
- ii. The shed must be located at least 3' away from the rear property line
- c. Lighting
- i. Are you proposing any exterior lighting?
- ii. Where?
- iii. If yes, provide a cut sheet of the lighting fixtures. Fixtures must be dark sky compliant
- d. Front Door
- i. Provide a cut sheet of the front door.
- ii. What color will it be?

- e. Driveway
- i. Please consider replacing concrete with permeable pavers or permeable concrete
- f. Utilities
- i. FYI, All utilities must be undergrounded.
- g. Page A113
- i. On the North/South section, what is the smaller structure to the right of the building?

Response:

a. See response to Biology Report comments as no vegetation will be distorubed within the beds or banks of Dean Creek, b. the shed has been removed from the project as a result of addressing other setback concerns previously mentioned, c. yes, see site plan for site lighting bollards on driveway and entry walkway, and elevations for house lighting at entries. Cuts sheets have been provided with the original application, and also included here. Note that plans call our the fixtures to match with the cut sheet provided, d. See note on A311 for custom thermally insulated entry door (not a product off the shelf). Details in progress for 100% CD set, anodized bronze to match window frames, e. Both options are a maintenance issue for the Client, as they require weed control, irrigation, and fertilizer to keep green. Also, this is the primary means of vehicle parking. Finally, our permeable surfaces fall under the maximum allowances, f. note our "New Service Drop" on A112, g. the structure is the Client's existing residence, 1855 Sunshine Valley Road.


Door finish anodized bronze to match window frames. See note on A311 for custom thermally insulated entry door.

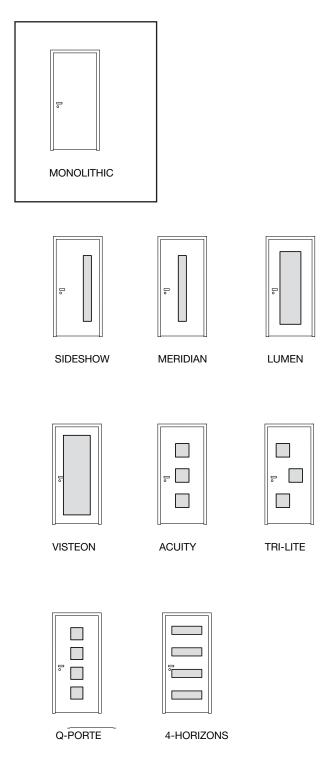

Safe and Sound



ANSI Grade 1 heavy-duty, commercial-grade security mortised lockset with integrated deadbolt and latch for maximum security.

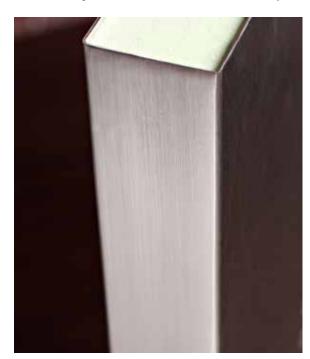

Our 2 ¼" thick doors are constructed with high-security, commercialgrade, 16 gauge door skins that are fully welded, ground smooth, and re-finished for uncompromised strength and beauty.

The security of your home and the safety of your family are second to none. Installing a Neoporte door system will give you peace of mind that your home is secure and your loved ones are protected.

Trust Neoporte door systems to keep the unwanted out.


Security features include:

- 2 1/4" thick doors
- High-security, commercial-grade,
 16 gauge door skins
- Heavy-duty, commercial-grade security mortised locksets
- High-density cores*
- Non-removable pin security hinges
- Security viewer (optional)
- Electronic access control hardware (optional)

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^{*}Neoporte door cores are 3x more dense than standard insulated commercial door cores.

Exterior lighting

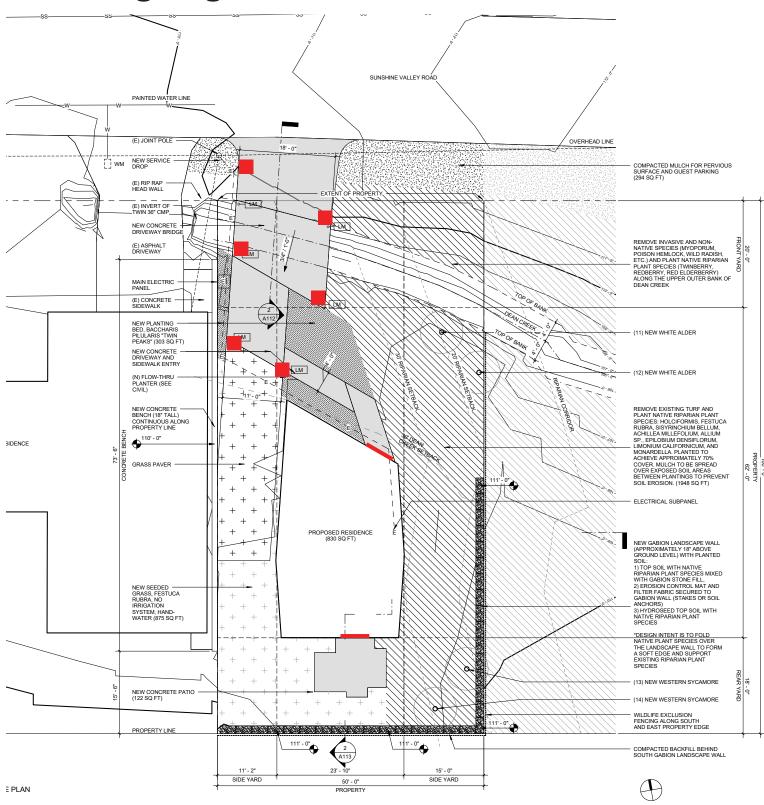

Nemalux Linear LED

Ligman Bollard



Applications

- Vehicle/equipment cabins
- Indoor building lighting
- Emergency lighting
- Solar/remote lighting
- Tunnel lighting
- Outdoor, harsh/rough usage environments

Features

- Extremely robust
- · Thermally managed for longevity
- · Easy field angle adjustment
- -40 to +65°C (AC) | -40 to +60°C (DC) operating range
- Sealed to IP66/67 Marine Outside type (Salt Water)

Output

- 559 to 2289 lumens
- 5000K standard (Additional colours & temperatures available)

Certifications

- Certified to UL 844, UL 1598, UL1 598A UL 2108, UL 8750
- CSA 22.2 No. 137, CSA 22.2 No. 250.0, CSA 22.2 No. 250.13
- Class I, Division 2, Groups ABCD
- · Class II Division 2, Groups FG
- Class III
- Class I, Zone 2, Group IIC
- Zone 22

Warranty

• Five (5) year limited warranty











are able to withstand the most demanding environments. The GS was designed as a hazardous location, light weight linear strip luminaire with a projected lifespan of 100,000 hours. Multiple lengths, optics and mounts make the GS a long term solution to area lighting in mining applications.

Extremely durable and water-tight, the GS Series of fixtures

The GS is available in a general purpose or Class 1 Div. 2 for hazardous locations. With AC and DC options, the GS can easily be wired into existing facilities or used in remote solar lighting applications.

Using industry leading manufacturing practices, our engineers and industrial designers created a fixture that transfers heat away from the LEDs to the enclosure via the metal core PCB. This optimizes the operating temperature, maximizes efficiency, and increases the longevity of the components.


The GS comes with a field adjustable end bracket or may be flush mounted to surfaces or ceilings using carriage bolts. With wide or narrow beam profiles, multiple lengths and colour options, the GS provides a long term solution for linear strip lighting applications.



F: 403.243.6190 info@nemalux.com www.nemalux.com



Exterior lighting

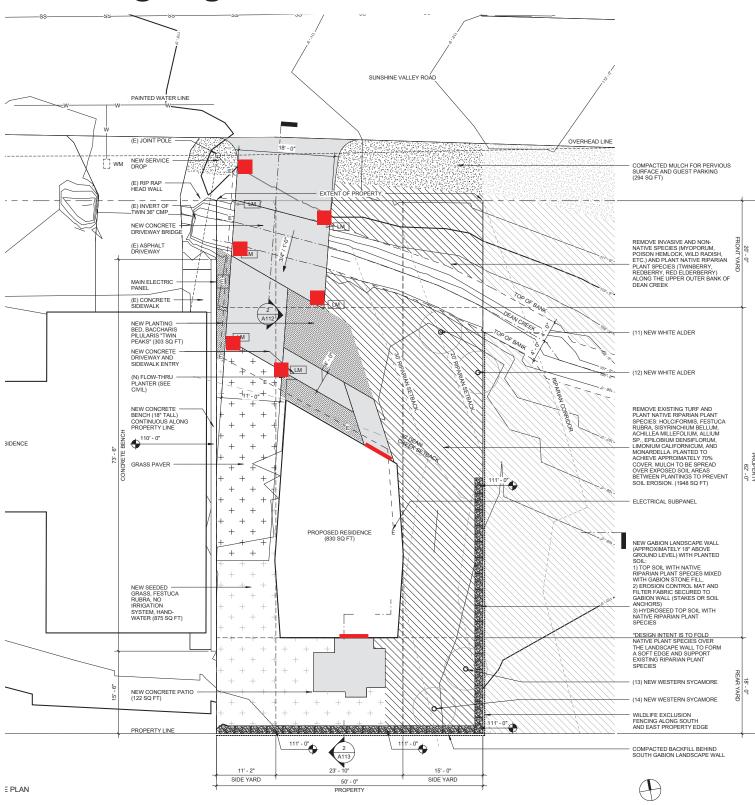

Ligman Bollard

Nemalux Linear LED

ULI-10021

Light Linear PT 1 Single Head Bollard TECHNOLOGY









29w LED 2628 - 2656 Lumens
IP65 • Suitable For Wet Locations
IK07 • Impact Resistant (Vandal Resistant)

IK07 • Impact Resistant (Vandal Resistant)
Weight 24.6 lbs

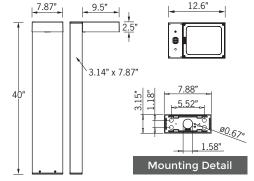




Ligman's micro Variable Optical System provides the ability to interchange, mix & rotate optics to provide specific light distributions for optimized spacing and uniformity.

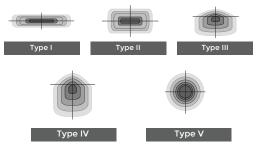

The variable optic system allows for the designer to create hybrid distrubtions for precise lighting requirements.

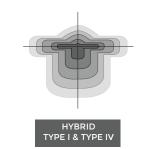

Construction

<u>lluminum</u>

Less than 0.1% copper content – Marine Grade 6060 extruded & LM6 Aluminum High Pressure die casting provides excellent mechanical strength, clean detailed product lines and excellent heat dissipation.

Pre paint

8 step degrease and phosphate process that includes deoxidizing and etching as well as a zinc and nickel phosphate process before product painting.

Memory Retentive -Silicon Casket Provided with special injection molded "fit for purpose" long life high temperature memory retentive silicon gaskets. Maintains the gaskets exact profile and seal over years of use and compression.

Thermal management

LM6 Aluminum is used for its excellent mechanical strength and thermal dissipation properties in low and high ambient temperatures. The superior thermal heat sink design by Ligman used in conjunction with the driver, controls thermals below critical temperature range to ensure maximum luminous flux output, as well as providing long LED service life and ensuring less than 10% lumen depreciation at 50,000 hours.

Surge Suppression

Standard 10kv surge suppressor provided with all fixtures.

BUG Rating

<u>Finishing</u>

All Ligman products go through an extensive finishing process that includes fettling to improve paint adherence.

<u>Paint</u>

UV Stabilized 4.9Mil thick powder coat paint and baked at 200 Deg C.
This process ensures that Ligman products

can withstand harsh environments. Rated for use in natatoriums.

<u>Hardware</u>

Provided Hardware is Marine grade 316 Stainless steel.

Anti Seize Screw Holes

Tapped holes are infused with a special anti seize compound designed to prevent seizure of threaded connections, due to electrolysis from heat, corrosive atmospheres and moisture.

Crystal Clear Low Iron Glass Lens

Provided with tempered, impact resistant crystal clear low iron glass ensuring no green glass tinge.

Optics & LED

Precise optic design provides exceptional light control and precise distribution of light. LED CRI > 80

<u>Lumen - Maintenance Life</u>

L80 /B10 at 50,000 hours (This means that at least 90% of the LED still achieve 80% of their original flux)

Area distribution bollard-integrated projectors. Stylish but technically precise area lighting solutions as part of a large flexible family.

Light Linear PT Bollard is an elegant minimalistic bollard that is suitable for both modern and classic architecture. Ideal for creating visual guidance with exceptional visual comfort. The dual sealed optical chamber with integrated heat sinks houses a range of field interchangeable optically controlled LED's, providing Type II, III, IV & V distribution, as well as variations of this for precise light distribution requirements.

An example of this, is using a combination of Type II and Type IV distribution optics inside the same fixture.

This product range is available in 29w and 55w options, as single & double head styles.

Customer specific wattages can be provided, contact the factory for more information.

This luminaire complies to Dark Sky requirements.

Bollards can be provided with GFCI boxes positioned to specific heights specified by the customer.

Internal house side shields are available as an option.

Optional: Security Bollard:

The Light Linear Bollard is available as a traffic rated security bollard

This security bollard provides restraint of vehicular traffic in unauthorized areas.

Impact calculations shows this bollard will stop a 5,500lb/2.75 tons vehicle, travelling at 30mph.

For additional strength, the galvanized pole can be filled with concrete up to the waterproof driver housing to provide a solid concrete barrier.

Additional Options (Consult Factory For Pricing)





RGBW or Static Color Laser Cut Lettering, Logos & Designs (LLVT Bollard shown for visual reference)

Ligman can provide custom logos and signage in the Light Linear Bollard The images above show this feature in the Light Linear VT Bollard

Igman Lighting USA reserves the right to change specifications without prior notice, please contact factory for latest information. Due to the continual improvements in LED technology data and components may change withou

GEOTECHNICAL

Questions/comments:

December 26, 2018

Historical records retained in County indicated consistent high ground water table (drilled in June) and potentially liquefiable soils close to ground surface, contradicting some of the drilling records presented in the proposed geotechnical report. Moreover, the project geotechnical engineer is required to drill through the potentially liquefiable layer in order to provide reasonable liquefiable layer thickness and liquefaction settlement. Liquefaction analyses with settlement results shall be attached in the report. Drilling and analyses shall follow the instruction of SPECIAL PUBLICATION 117A by California Geological Survey. CEG license is required for this report.

February 25, 2019

Based on the report resubmittal, here is the follow-up review comments per County Geotechnical Section's peer review:

The provided estimates of liquefaction induced settlement warrants mitigation. The applicant's consultant shall provide recommendations for appropriate ground improvement that would mitigate the potential settlement, and other liquefaction induced hazards. The completed liquefaction analysis, including utilized parameters, that resulted in the 9 inch settlement value should be provided for supplemental review. The Consultant encountered very shallow (2-4' bgs) groundwater at the site and should consider the potential for ejecta during a seismic event. With shallow groundwater and shallow, potentially liquefiable, deposits, there is a high risk for ejecta, sand boils and loss of bearing, and a shallow foundation (rigid mat, slab, PT slab, etc) is not a suitable foundation unless the liquefiable soils are mitigated (densified, cemented, removed) to an acceptable level.

We recommend the Consultant advance additional subsurface boring(s) to evaluate the subsurface conditions that will need to be mitigated as part of site development. We find that the releveling of structures after a seismic event is not an acceptable form of liquefaction mitigation.

We also find that a shallow foundation design without any ground improvement is not within the standard of practice for sites impacted by over 5 inches of liquefaction induced settlement.

Response:

Additional borings have been completed to address the comments. Please see the attached report provided by Wayne Ing & Associates, Geotechnical Consultants.



5 May 2019

Ms. Fuli Li 1855 Sunshine Valley Road Moss Beach, CA 94038

UPDATE GEOTECHNICAL INVESTIGATION

Proposed Single Family Struct 1855 Sunshine Valley Road Moss Beach, California

References: 1. Geotechnical Study

By Sigma Prime Geosciences, Inc. August 2018

- Guidelines for Evaluating and Mitigating Seismic Hazards in California Special Publication 117A, Division of Mines and Geology, 2008
- Seismic Hazard Zone Report for the Montara Mountain 7.5-Minute
- Quadrangle, San Mateo County, California, 2019
- Assessment of the Liquefaction Susceptibility of Fine-Grain Soils By Jonathan D. Bray and Rodolfo B. Sancio, Journal of Geotechnical and Geoenvironmental Engineering, ASCE, September 2006, pp.1165-1177
- Estimating Liquefaction-Induced Lateral Displacements Using the Standard Penetration Test or Cone Penetration Test, G. Zhang, P.K Robertson, M.ASCE, and R.W.I. Brachman

Dear Ms. Li:

In accordance with your authorization, Wayne Ting & Associates, Inc. (WTAI) has completed a geotechnical investigation for the proposed single family structure at the subject site. The purpose of this study was to investigate the subsurface conditions and obtain geotechnical data for use in the design and construction of the proposed single family structure. The scope of this investigation

- Review of Reference 1.
- A site and area reconnaissance by the Project Engineer An excavation, logging and sampling of one exploratory boring.
- Laboratory testing of the selected soil samples.
- An engineering analysis of the data and information obtained
- Preparation and writing of this report which presents our findings, conclusions, and

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CIVIL, DRAINAGE & STORMWATER

Questions/comments:

- 1. Survey Plan shall be stamped by California Registered Land Surveyor;
- 2. Drainage and Grading Plans shall be stamped by California Registered Civil Engineer;
- 3. Drainage plan shall show, in addition to the flow increase, the runoff volume increase the the location and size of the drainage device (pit, retention/detention, rain barrel, rain garden, etc.) that controls and stores the additional runoff, with at most a metered overflow to the street, away from the creek.

Response:

- 1: The survey is prepared and signed by a licensed surveyor, BGT Land Surveying. In making it scaled to fit my drawings, I did not include BGT's title bar with their stamp. Attached is the file for reference.
- 2 & 3: Please see new drawings, C-1 and C-2, and the Drainage Report provided by Sigma Prime, a California registered civil engineer.

