Application for Design Review by the **County Coastside Design Review Committee**

Application Design Revie County Coas Review Com	ew by the stside Design	Mail Dr	OP PLN 122 • 0	ounty Center = Redwood City CA 9406 650 • 363 • 4161 = FAX 650 • 363 • 4849 • DDUSU	
Applicant:	,	Owner (if diffe	erent from	Applicant):	
Name: Doug Machado		Name: Greg a	Name: Greg and Jennifer Cohn		
Address: P.O. Box 2902		Address: P.O. E	3ox 2902		
El Granada	Zip: 94018	Burlingame		Zip:	
Phone,W: 6506702810	Н:	Phone, W: 6506	782646	H: 6504375227	
mail; dougrmachado@	gmail.com	Email: greg@	gcohn.cor	n	
Address: Phone,W:	H:	Zip: Emâîl: \	Sar	IOV 2 0 2018 Mateo County Inning Division	
Project location:		Site Descript	ion:		
PN: Ö 47127520		Vacant P	arcel		
ddress: The Alameda	*****	Existing [Developmer	nt (Please describe):	
El Granada	Zip: 94,018	6000 sq ft	vacant	parcel	
oning: R-1,S-17 / Del	N				
arcel/lot size: 6000	sq. ft.				
Project:		Additional P	ermits Re	quired:	
New Single Family R	desidence: 1919	sq. ft 🔲 Certificate	e of Complia	ance Type A or Type B	
Addition to Residence	e:		•	t Permit Exemption	
Other:			: _		

Project:

Applicant:

APN:

Project location:

Address: The Alameda

Parcel/lot size: 6000

- Addition to Residence: ______ sq. 1
- Other: ___

Describe Project:

Single family residence of 1919 sq ft with a detached 457 sq ft garage.

A proposed 750 sq ft ADU will also be proposed as part of this project.

- Fence Height Exception (not permitted on coast)
- Grading Permit or Exemption
- ☐ Home Improvement Exception
- Non-Conforming Use Permit
- Off-Street Parking Exception
- Variance

PURISO17-DO195-COC PREJO18-00051

Fill in Blanks:	Material	Color/Finish	matches existing
		(If different from existing, attach sample)	Oxioning
a. Exterior walls	Hardie Plank smooth siding	SHOJI White SW70	
b. Trim	Hardie trim	SHOJI White SW70	
c. Windows	Andersen series 100	Tricorn Black SW 6258	
d. Doors	Wood	Tricorn Black SW 6258	
e. Roof	Standing seam metal	Taylor Black SRI-29	
f. Chimneys	N/A		
g. Decks & railings	Concrete	Dark Grey	۵
h. Stairs	Concrete	Dark Grey	
i. Retaining walls	Concrete	Grey	
j. Fences	Redwood	White	
k. Accessory buildings	To match main house		
I. Garage/Carport	To match main house		
including the required fir applicable to the location	idings that the project does conform of the project pursuant to Section	at this project complies with all applicable regu in to the standards and guidelines for design r 6565.10. ce with standards and guidelines (check if atta	eview
	into otatement of project compilar	ce with standards and guidelines (check if att	
support of the application	n is true and correct to the best of	rms, plans, and other materials submitted her my knowledge. It is my responsibility to inform anges to information represented in these sub	the County o
		D MLC	
Owner:		Applicant:	
11/20/18		11-20-2018	
Date:		Date:	************

Check if

Environmental Information Disclosure Form

PLN PLN 2018-00454

Project Address	пе Актера	Name of Owner: Greg and Jenniler Conn	
El Granada, Ca 94018		Address: 3045 RIVERA DRIVE BURLINGAME CA	١
		Phone: 6506782646	
Assessor's Parc	el No.: <i>()</i> 47 — 127 — 520	Name of Applicant: Doug Machado	
	4444	Address: PO Box 2902 El Granada,Ca 94018	
Zoning District:	R-1, S-17 DP CO	Phone: 6506702810	
	Site Conditions		
Parcel size: 6000 s			
Describe the extenue	ent and type of all existing development and a description.	d uses on the project pareal including the existence ar of any natural features of the pareal part alive, steep	nd terrain
creeks, vegetatio	n). Vacant land with various weeds		
Vacant land with	various weeds	NOV 2 0 2018	
		San Mateo County	J
		Planning Division	
Environm	ental Review Checklist		
1. California	Environmental Quality Act (CEQA) Review	
Yes No	Will this project involve:		
	a. Addition to an existing structure > 509	% of the existing area OR > 2,500 sq. ft?	
Lagran of Lagran	b. Construction of a new multi-family res	idential structure having 5 or more units?	
	c. Construction of a commercial structur	re > 2,500 sq.ft?	· · · · · · · · · · · · · · · · · · ·
		n. in Emerald Lake Hills area or ≥ 12" d.b.h. in any	
Land Late	residential zoning district)? If yes, how many trees to be removed	?	
Postoria de la companya del companya de la companya del companya de la companya d	e. Land clearing or grading?		***************************************
	If yes, please state amount in cubic ye		i
		.y. Fill;c.y.	~~~~~~~~~~~~~~~~~~~~~~~~~~~~~~~~~~~~~~
	f. Subdivision of land into 5 or more parg. Construction within a State or County		
	h. Construction within a sensitive habitat		
	i. Construction within a hazard area (i.e		
		ite (check with Co. Env. Health Division)?	
Please explain	all "Yes" answers:		
-	aration will require and excavation of 655 cu		
1			
			
	Partners		

		V .	
2. National Marine Fisheries Rule 4(d) Review			
Yes No Will the project involve:		Will the project involve:	
		a. Construction outside of the footprint of an existing, legal structure?	
		b. Exterior construction within 100-feet of a stream?	
		c. Construction, maintenance or use of a road, bridge, or trail on a stream bank or unstable hill slope?	
		d. Land-use within a riparian area?	
		e. Timber harvesting, mining, grazing or grading?	
		f. Any work inside of a stream, riparian corridor, or shoreline?	
		g. Release or capture of fish or commerce dealing with fish?	
Please	Please explain any "Yes" answers:		
		,	
3. Nat	tional P	ollutant Discharge Elimination System (NPDES) Review	

3. Na	3. National Pollutant Discharge Elimination System (NPDES) Review			
Yes	No	Will the project involve:		
		a. A subdivision or Commercial / Industrial Development that will result in the addition or replacement of 10,000 sq. ft. or more of impervious surface?		
		If yes, Property Owner may be required to implement appropriate source control and site design measures and to design and implement stormwater treatment measures, to reduce the discharge of stormwater pollutants. Please consult the Current Planning Section for necessary forms and both construction and post-construction requirements.		
		b. Land disturbance of 1 acre or more of area?		
J		If yes, Property Owner must file a Notice of Intent (NOI) to be covered under the statewide General Construction Activities Storm Water Permit (General Permit) <u>prior</u> to the commencement of construction activity. Proof of coverage under State permit must be demonstrated prior to the issuance of a building permit.		


(Occident level (Co)

I hereby certify that the statements furnished above and in the attached exhibits present the data and information required for this initial evaluation to the best of my ability, and the facts, statements and information presented are true and correct to the best of my knowledge and belief. If any of the facts represented here change, it is my responsibility to inform the County.

Signed:

Date: //- 20-208

(Applicant may sign)

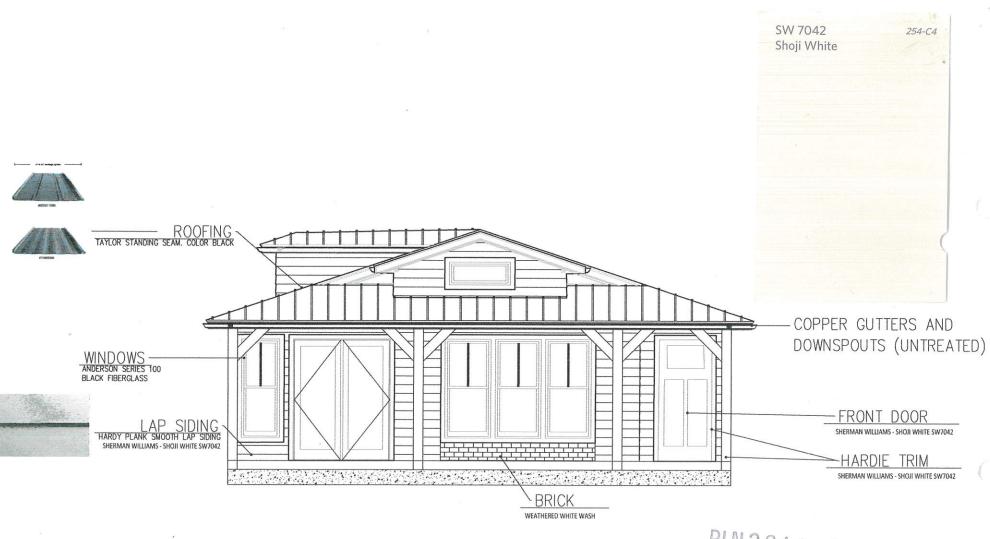


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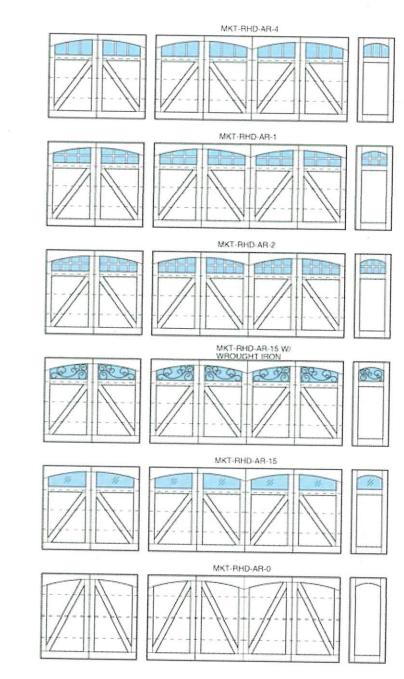
NOV 20 2018

San Mateo County Planning Division

Sherwin Williams Shoji white # SW7042

Madaket



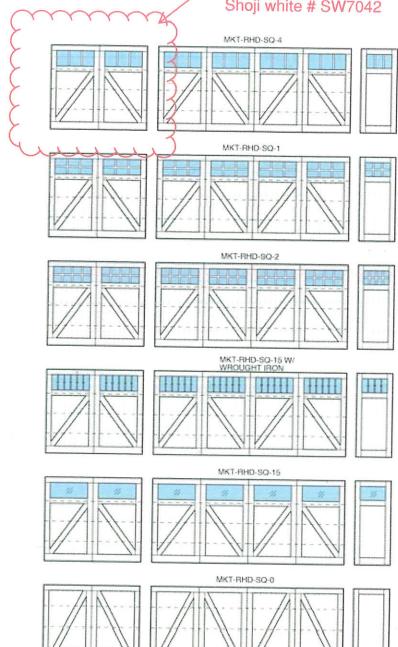

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THE TRANSPERSENT FOR THIRD PARTY.

ORAWINGS REPRESENT TO A THIRD PARTY.

MANY DIHER SIZES AVAILABLE. ALL DOORS THAT EXCED FID SALL MILL BLASSCHOOKS.

FOR INFORMATION ON HOW MANY SECTIONS YOUR DOOR WILL BE, PLEASE CONTACT RANCH HOUSE DOORS.



Washington Office: O (360) 318-1319

1527 POMONA ROAL CORONA, CA 92880 O (951) 278-2884 F (951) 278-2886

Nedefining the Entrance



Premier-LockTM STANDING SEAM



The Premier-Lock™ Standing Seam has the anti-capillary dry lock seam. It's designed with softer, less industrial lines to provide a more architecturally pleasing appearance.



- · Prevents crowning
- · No visible screws required
- · Sharp, professional appearance

KEY FEATURES

- · 12" to 20" coverage options
- 26, 24 and 22 Tru-Gauge™
- · Factory-notched panels available
- · Anti-Capillary dry lock seam
- · 1" and 1-1/2" vertical rib
- · Concealed fasteners: fasteners cannot leak
- Pre-slotted fasteners flange: allows expansion/contraction of panel
- · (ŲL) -
 - Code compliance UL Evaluation Report UL ER 25913-01
- UL580 Class 90: Dade impact: Dade 90
 Dade 140 MPH: UL Class 4 hail: ASTM 283
 ASTM 330: ASTM 331: ASTM E-1592
- · UL Class A fire rated
- 3:12 minimum pitch recommended: for lower pitches please inquire
- Standard panel lengths 2' to 35': for longer panels, please inquire
- · Panel options: Accent ribs, Striations, Flat Pan

PANEL PROFILES

12" to 20" coverage options




ACCENT RIBS



STRIATIONS

LOCK SEAM DETAIL

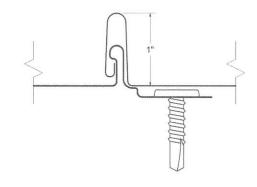



Commercial/Residential **Metal Roofing & Siding Finish Options**

Standard Kynar 500° Coatings

40-Year Residential, Transferable, Non-Prorated Limited Warranty



Premium Metallic 500[®] Coatings

(Premium Pricing Applies)



Premium Finish

(Premium Pricing Applies)



Vintage® is an innovative coating process over a G-90 metallic-coated steel surface. The process creates shade variations from light to dark, the lighter shade exhibiting a grey tone while the darker shade exhibits a bronze or brown tone. The dynamic, preaged appearance makes this a beautiful and durable product choice that is also graffiti resistant. Vintage® comes with a 20 year warranty. Warranty can vary by environment, see TMP website for more information.

Vintage® SRI-19

Weathering Materials (These materials will change appearance over time)

16 oz. Copper 20 oz. Copper please inquire Pure Copper has no warranty



Zincalume® Plus AZ-55/ Galvalume® SRI-65

Zincalume® Plus AZ-55 is a 55% aluminum, 45% zinc metallic coating over steel. It is a non-painted finish with a 25 yr. warranty







SRI=Solar Reflective Index. SRI values listed above are in accordance with ASTM E1980 and are based on actual testing. (CRRC) Cool Roof Rating Council SRI values (CA Title 24, ENERGY STAR®) are based on the grouping of colors (color families). CRRC SRI values will differ, as each color is not tested in the color family option. Coatings are low gloss 10-15% sheen. These printed this provide a close representation of the colors. Metal samples are available upon request. Custom colors available. "Oil canning" is an inherent characteristic of roof and wall products, and not a defect, which is not a cause for panel rejection.


Lighting / Gubbon Lighting / Guldoor Wall Lighting / SEU GRCS840





Ziebarth Outdoor Barn Light See Mare by Gracie Cate *** * ** ** ** ** ** ** ** \$44.21 \$36.00 and Off Shopping for a business? Unlock insider prising Free Shipping on orders over \$49 Get if by Man, Nov 26 Shee In \$4580... South San Francisco ** International State To Add to State Installation by Hondy, Haw It Works Installation by Hondy, Haw It Works Installation S72.99 Cet 255. OFF with MANUAL Learn more Edies Country Shop This Callection Ziebarth by Gracie Ooks Cet expert interior design

Do you have questions about this product? Our experts are here to help!

& Coll Us

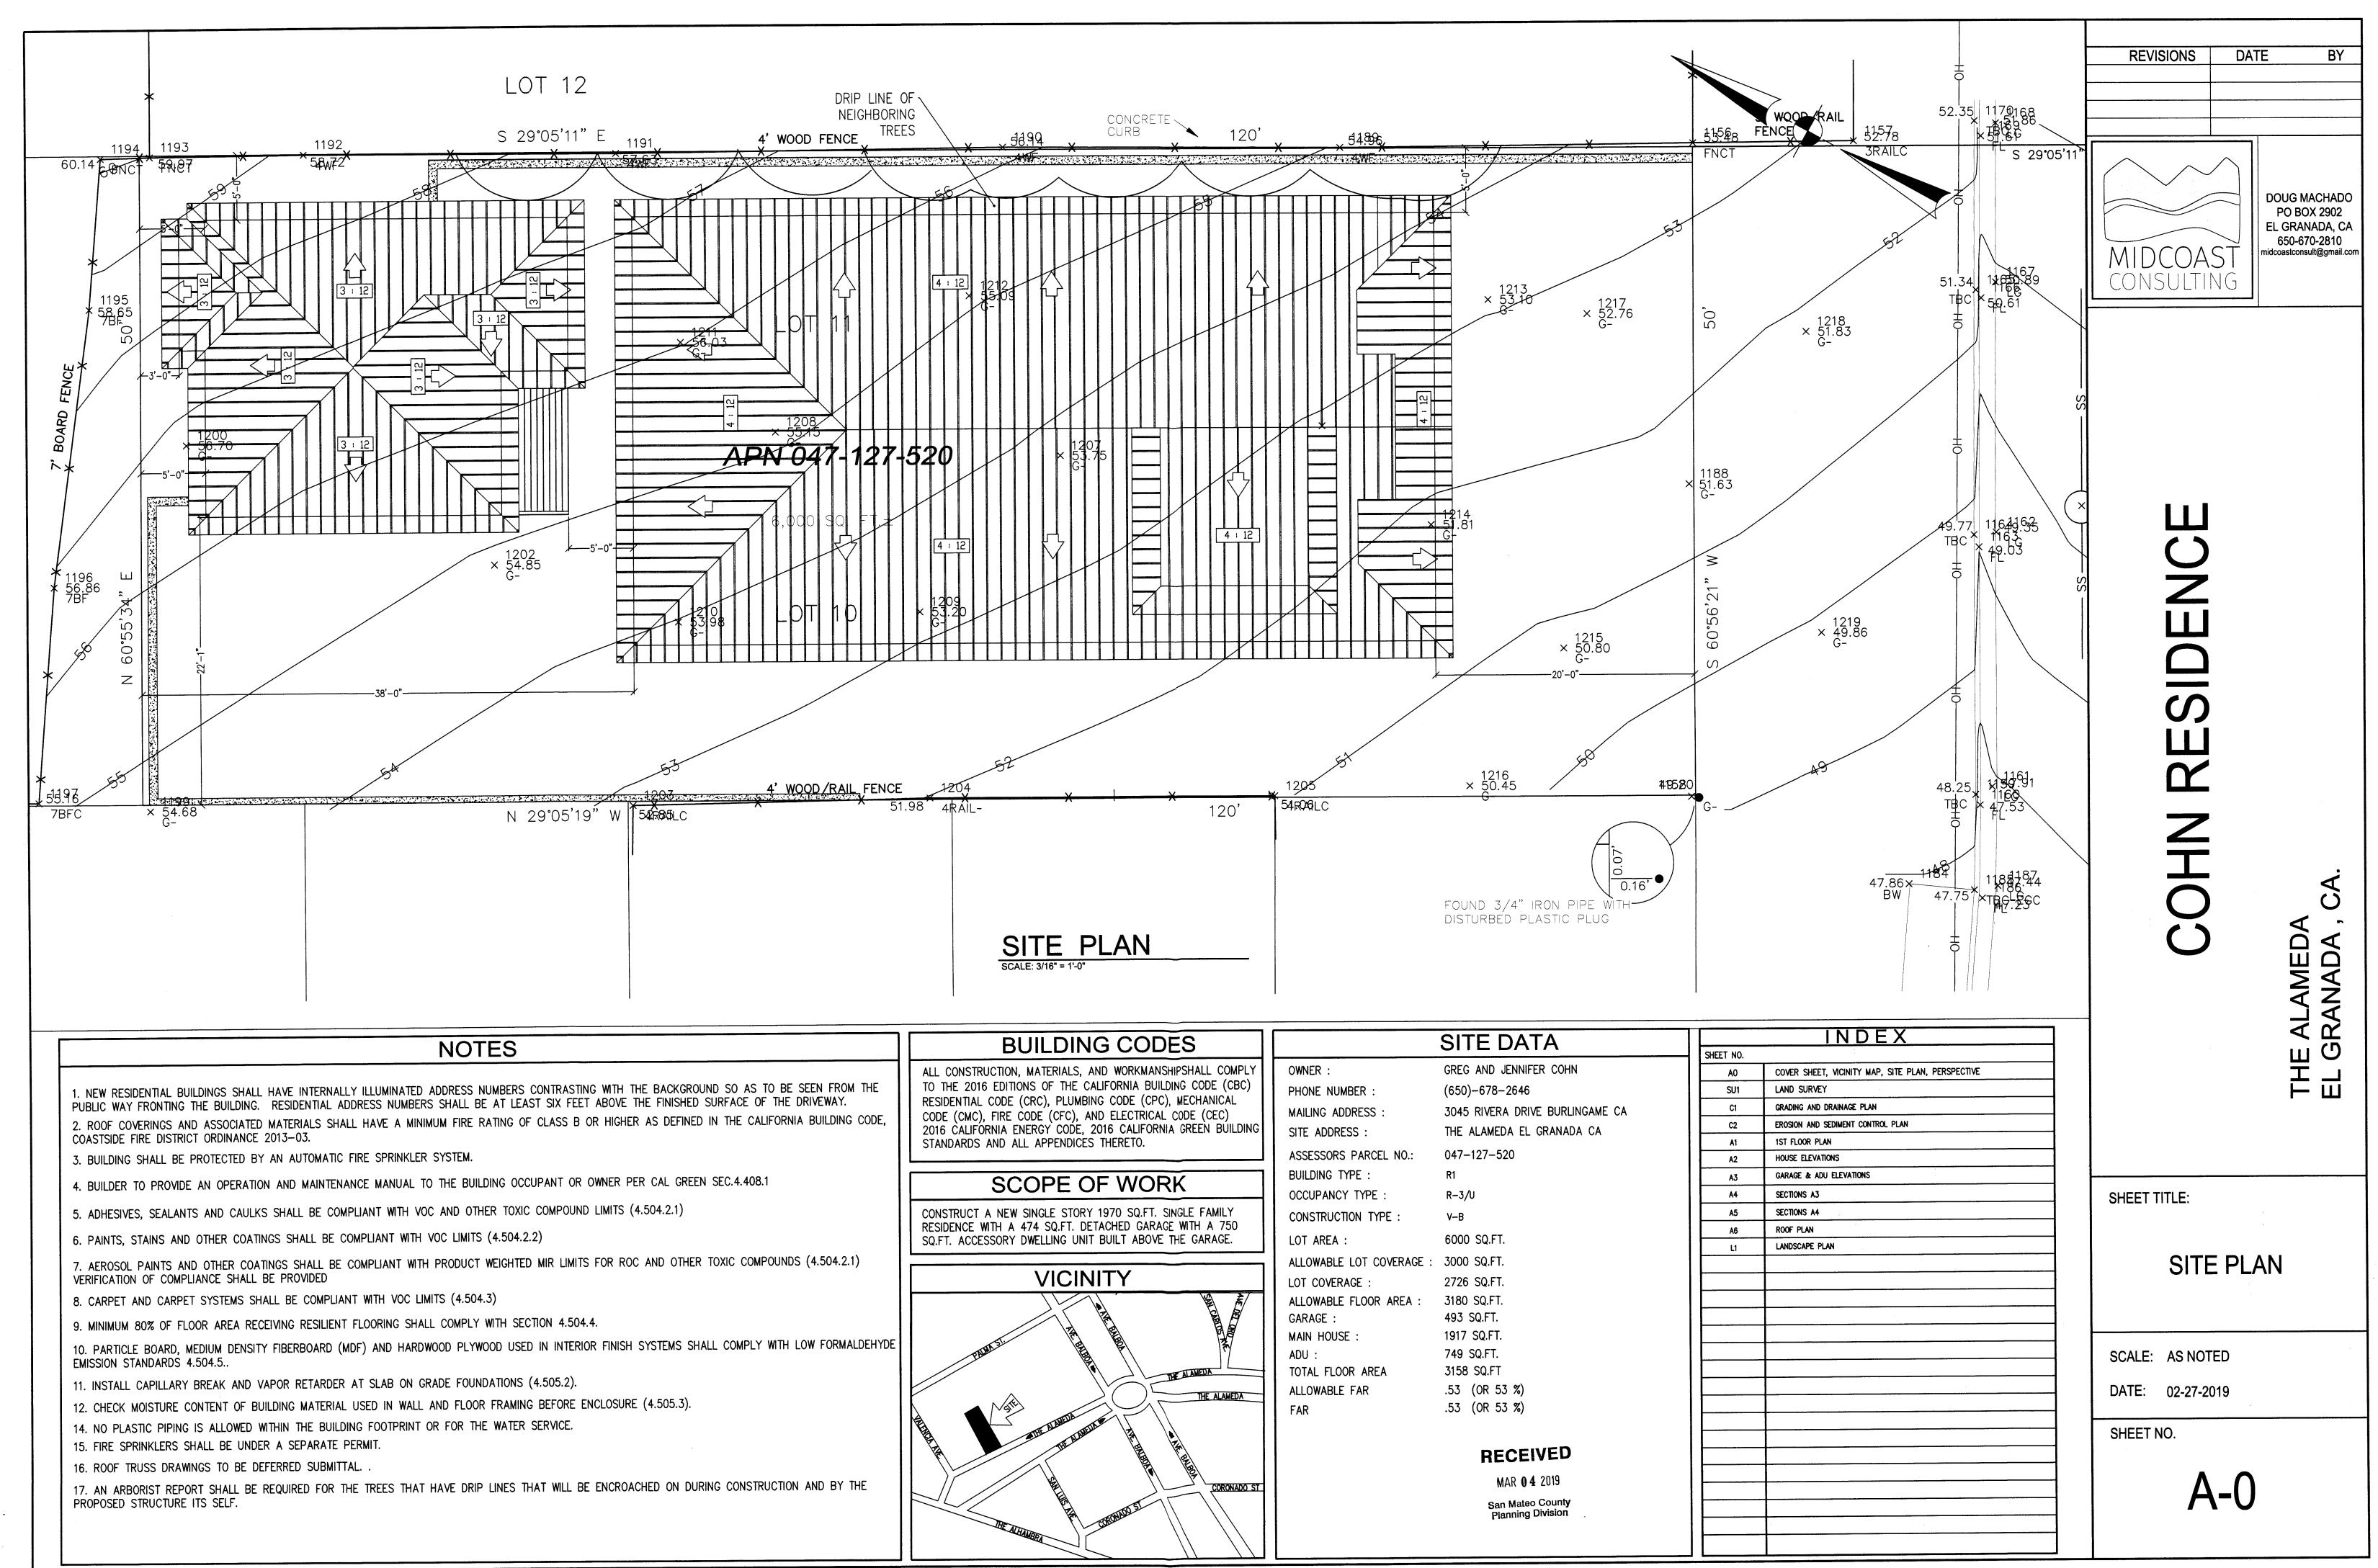

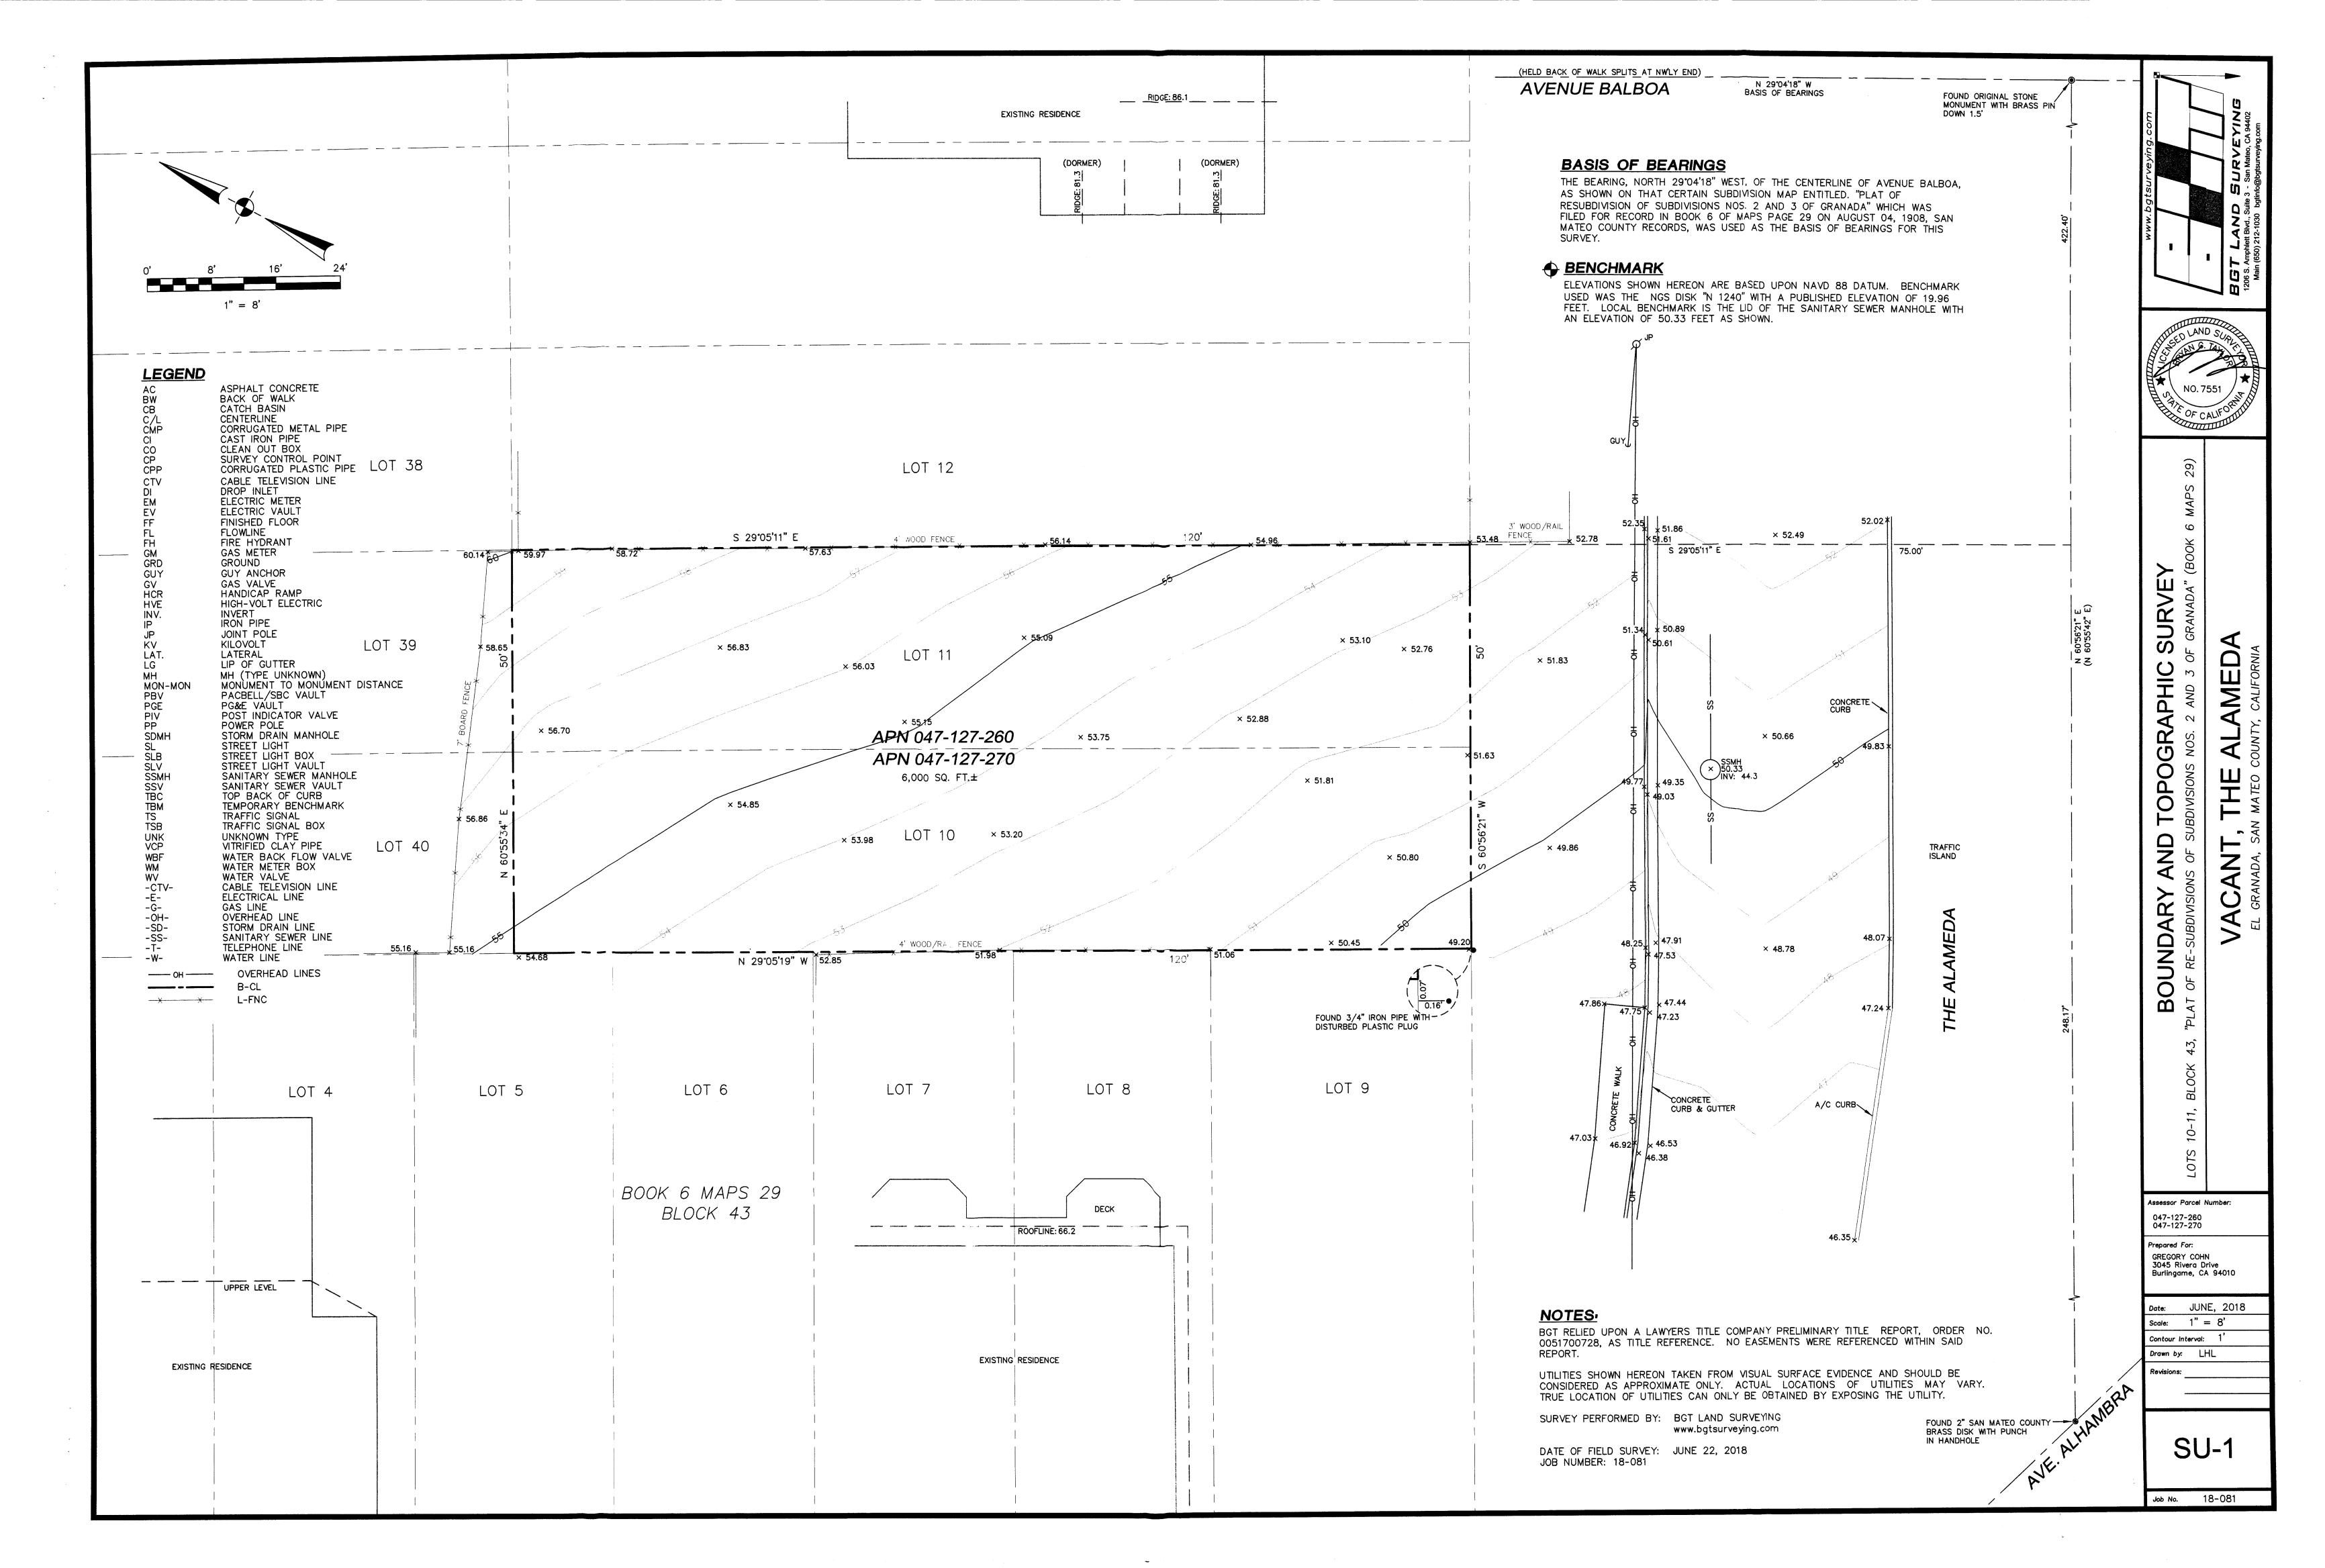

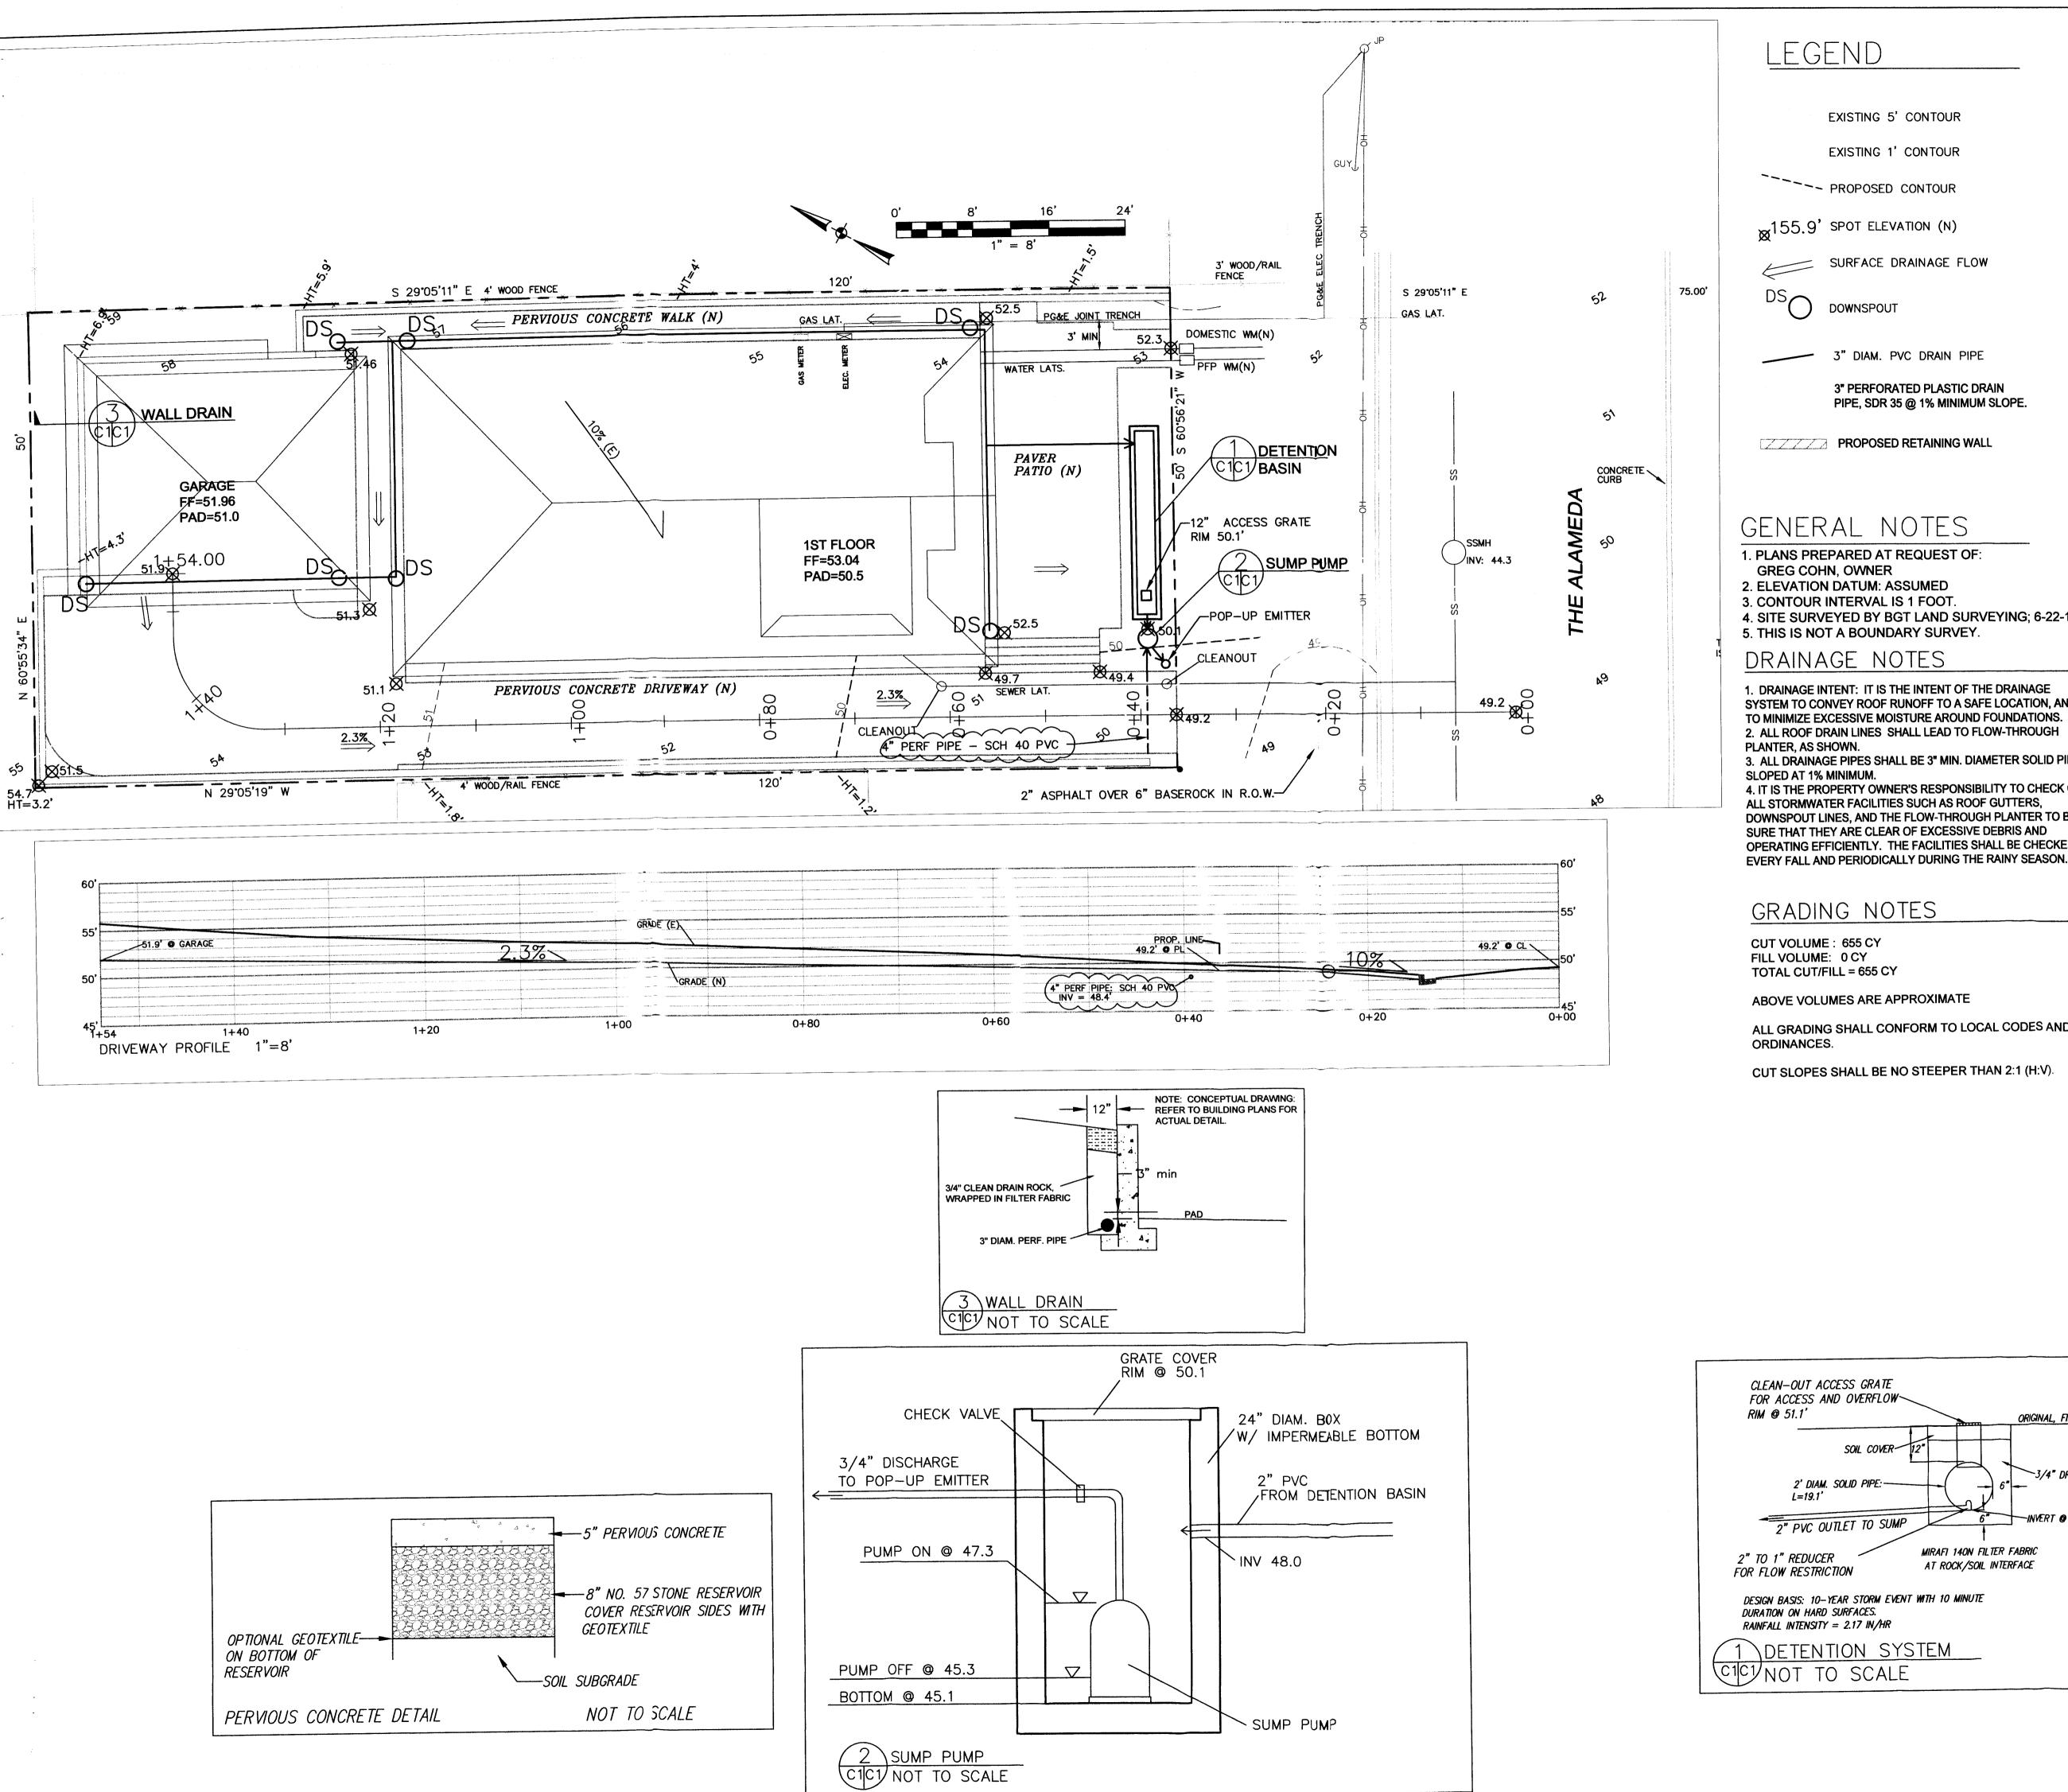

LEGEND

EXISTING 5' CONTOUR

EXISTING 1' CONTOUR

--- PROPOSED CONTOUR

₩155.9' SPOT ELEVATION (N)

SURFACE DRAINAGE FLOW

DOWNSPOUT

3" DIAM. PVC DRAIN PIPE

3" PERFORATED PLASTIC DRAIN PIPE, SDR 35 @ 1% MINIMUM SLOPE.

PROPOSED RETAINING WALL

GENERAL NOTES

- 1. PLANS PREPARED AT REQUEST OF:
- GREG COHN, OWNER 2. ELEVATION DATUM: ASSUMED
- 3. CONTOUR INTERVAL IS 1 FOOT.
- 4. SITE SURVEYED BY BGT LAND SURVEYING; 6-22-18.
- 5. THIS IS NOT A BOUNDARY SURVEY.

DRAINAGE NOTES

- 1. DRAINAGE INTENT: IT IS THE INTENT OF THE DRAINAGE SYSTEM TO CONVEY ROOF RUNOFF TO A SAFE LOCATION, AND TO MINIMIZE EXCESSIVE MOISTURE AROUND FOUNDATIONS. 2. ALL ROOF DRAIN LINES SHALL LEAD TO FLOW-THROUGH
- 3. ALL DRAINAGE PIPES SHALL BE 3" MIN. DIAMETER SOLID PIPE,
- SLOPED AT 1% MINIMUM. 4. IT IS THE PROPERTY OWNER'S RESPONSIBILITY TO CHECK ON ALL STORMWATER FACILITIES SUCH AS ROOF GUTTERS, DOWNSPOUT LINES, AND THE FLOW-THROUGH PLANTER TO BE SURE THAT THEY ARE CLEAR OF EXCESSIVE DEBRIS AND OPERATING EFFICIENTLY. THE FACILITIES SHALL BE CHECKED

GRADING NOTES

CUT VOLUME: 655 CY FILL VOLUME: 0 CY TOTAL CUT/FILL = 655 CY

ABOVE VOLUMES ARE APPROXIMATE

SOIL COVER

ALL GRADING SHALL CONFORM TO LOCAL CODES AND ORDINANCES.


CUT SLOPES SHALL BE NO STEEPER THAN 2:1 (H:V).

ORIGINAL, FINAL SLOPE

3/4" DRAIN ROCK

MIRAFI 140N FILTER FABRIC

AT ROCK/SOIL INTERFACE

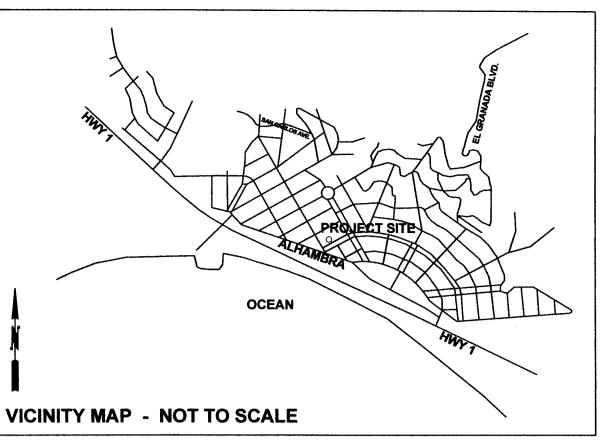

CONSTRUCTION SCHEDULE

DAY 1: INSTALL FIBER ROLLS. DAY 2: COMMENCE WORK WITH SITE CLEARING. DAY 3: INSTALL ROCKED CONSTRUCTION ENTRANCE

WEEK 2: FINISH ROUGH GRADING **WEEK 3: BEGIN FOUNDATIONS**

WEEK 5: POUR CONCRETE FOR FOOTINGS WEEK 6: BEGIN FRAMING

MONTH 3: FINISH SHELL

MONTH 5: FINISH MOST OF INTERIOR MONTH 7: FINISH PROJECT

TRAFFIC CONTROL NOTES

1. CONTRACTOR AND WORKERS SHALL PARK ALONG THE ALAMEDA. 2. THE ROAD SHALL NOT BE BLOCKED.

SECTION AND DETAIL CONVENTION

REFERENCE SHEET No. ON WHICH SECTION OR DETAIL IS SHOWN REFERENCE SHEET No. FROM WHICH SECTION OR DETAIL IS TAKEN




DRAINAGE AND PLAN

GRADING

COHN PROPEF ALAMEDA, EL APN 047-127-

SHEET


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EROSION CONTROL POINT OF CONTACT

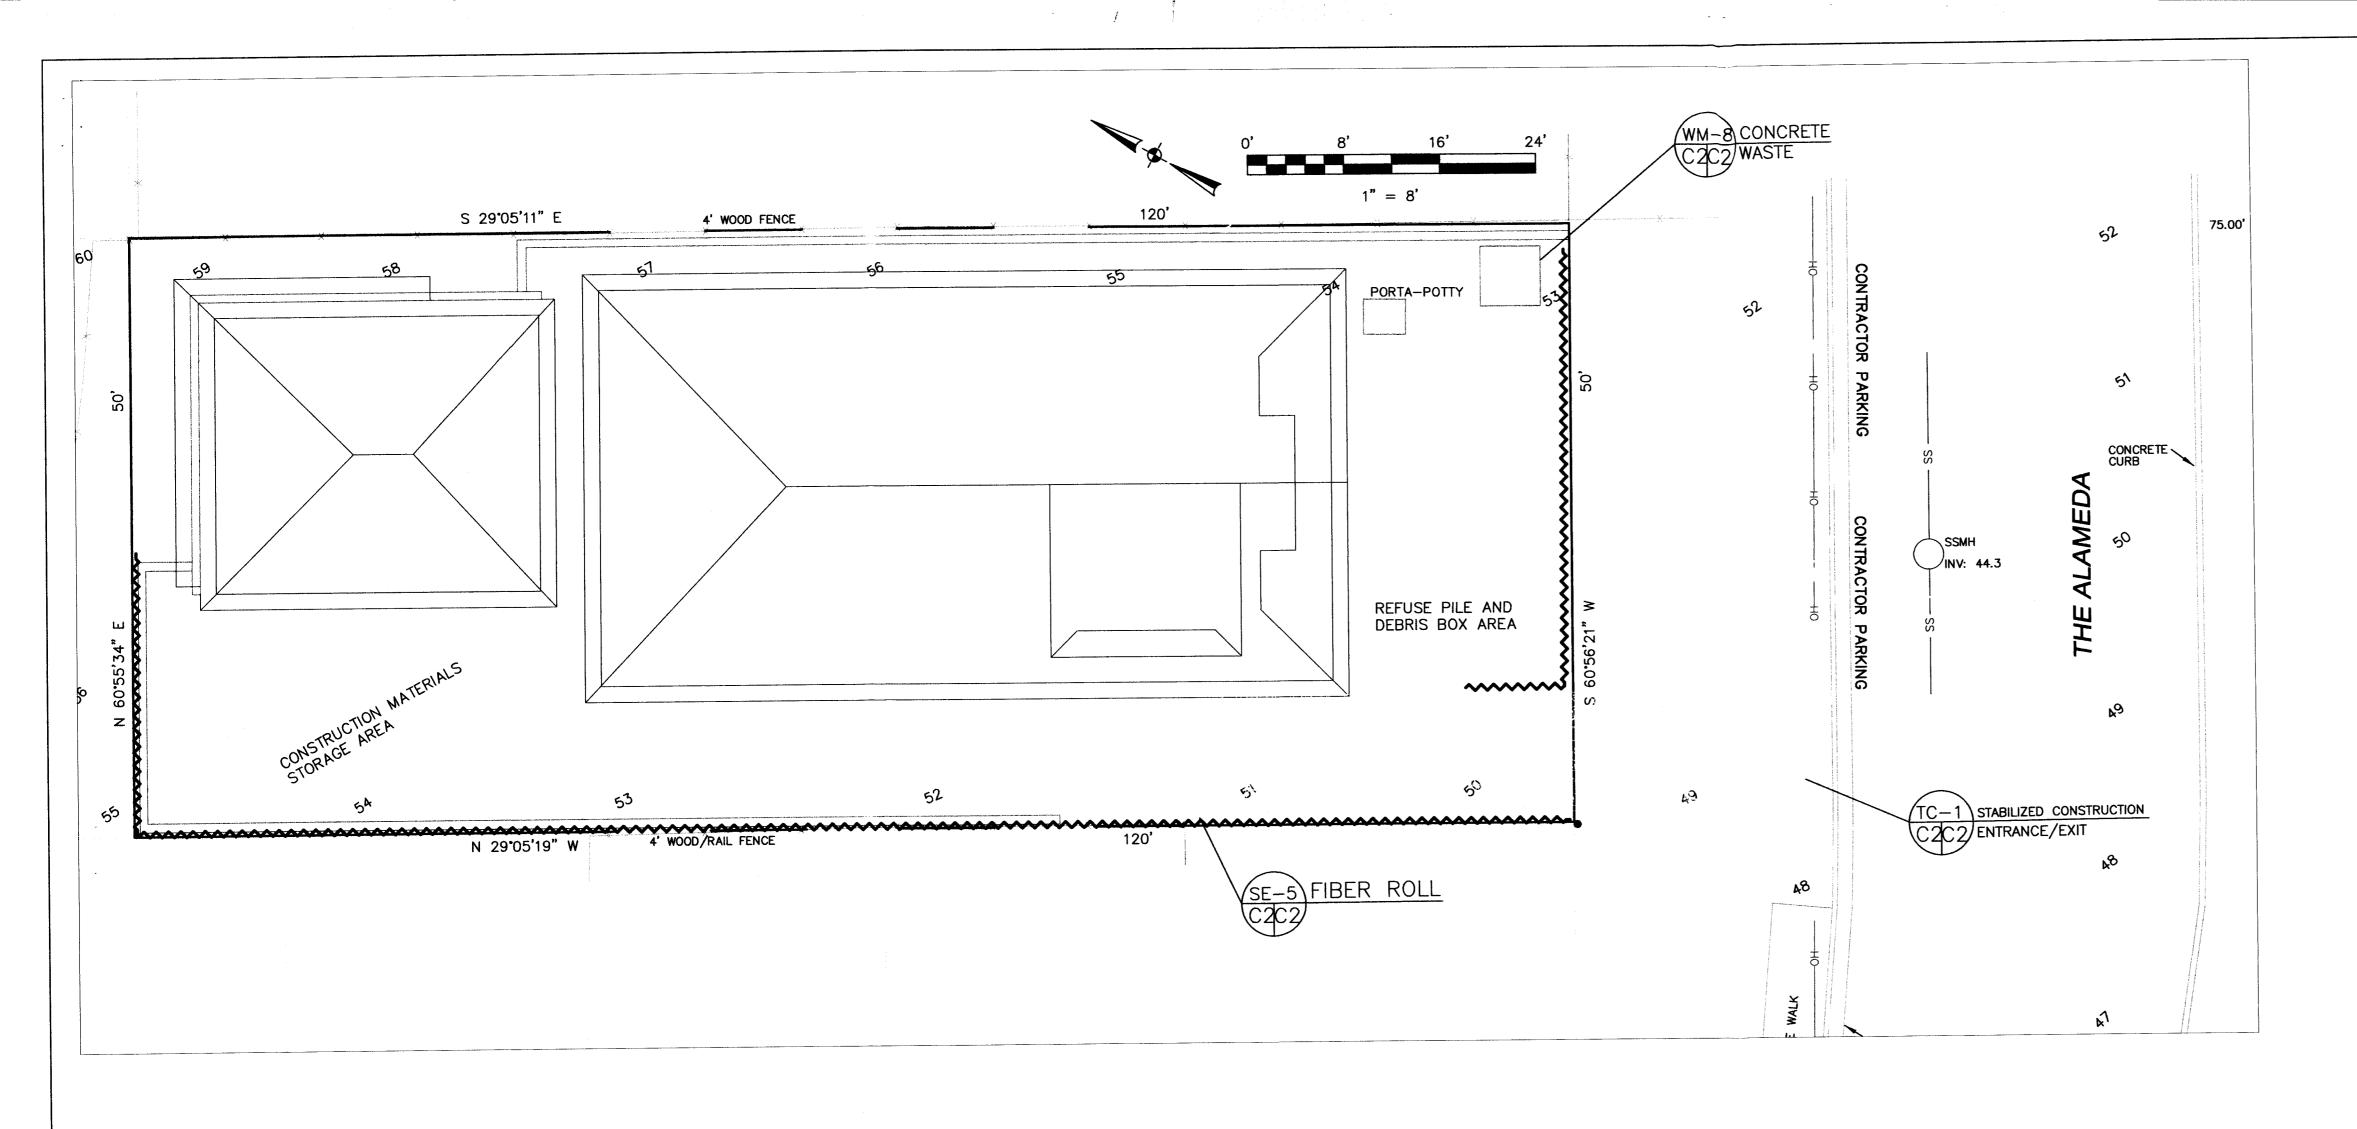THIS PERSON WILL BE RESPONSIBLE FOR EROSION CONTROL AT THE SITE AND WILL BE THE COUNTY'S MAIN POINT OF CONTACT IF CORRECTIONS ARE REQUIRED.

NAME:	DOUG MACH	ADO
TITLE/QUALI	FICATION:	CONTRACTOR
PHONE:	650-670-2	2810
PHONE:		
E-MAIL:	DOUGE	RMACHADO@GMAIL.COM_




EROSION CONTROL NOTES

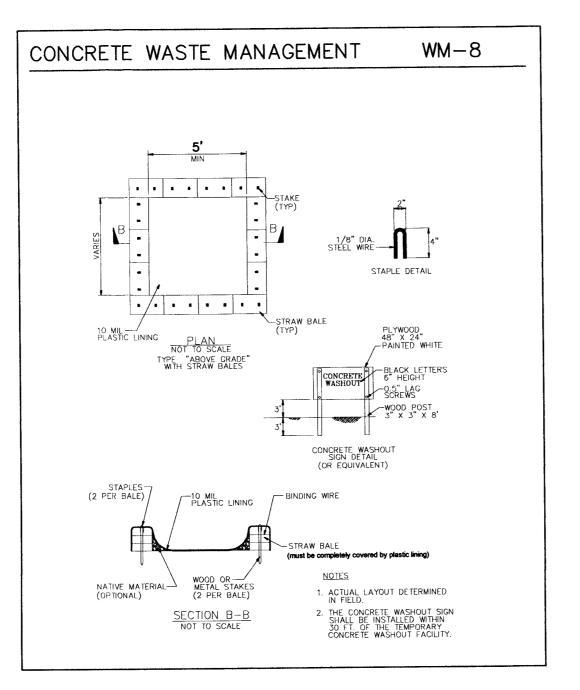INSTALL AT LOCATIONS SHOWN. AFIX AS SHOWN IN DETAIL SE-5

1. GRADING MAY TAKE PLACE DURING WET WEATHER AFTER OCTOBER 1 PROVIDED THE FOLLOWING PROVISIONS ARE FOLLOWED. 2. NO GRADING SHALL TAKE PLACE DURING RAINY WEATHER OR FOR A PERIOD OF AT LEAST 24 HOURS FOLLOWING RAIN. 3. ALL EXPOSED SOIL SHALL BE TEMPORARILY PROTECTED FROM EROSION WITH JUTE

4. ALL STOCKPILED SOIL SHALL BE COVERED AT ALL TIMES AND REMOVED FROM SITE


AS SOON AS POSSIBLE, IF SCHEDULED FOR OFF-HAUL. 5. ALL EXPOSED SURFACES SHALL BE PERMANENTLY PROTECTED FROM EROSION WITH SEEDING AND/OR LANDSCAPING. SEED MIX SHALL BE 75 LB PER ACRE ANNUAL RYGRASS OR APPROVED SUBSTITUTE. SEED SHALL BE COVERED WITH STRAW MULCH AT A RATE OF 2 TONS/ACRE.

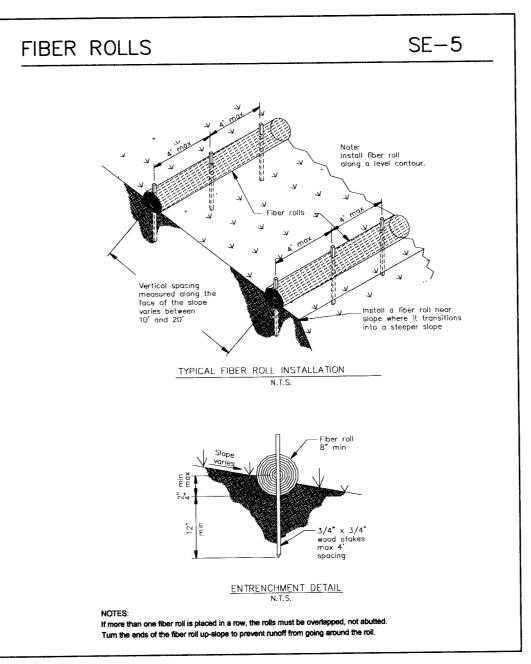

GENERAL EROSION AND SEDIMENT CONTROL NOTES

FIBER ROLL
INSTALL AT LOCATIONS SHOWN.
AFIX AS SHOWN IN DETAIL SE-5

- · There will be no stockpiling of soil. All excavated soil will be hauled off-site as it is excavated.
- · Perform clearing and earth-moving activities only during dry weather. Measures to ensure adequate erosion and sediment control shall be installed prior to earth-moving activities and construction.
- · Measures to ensure adequate erosion and sediment control are required year-round. Stabilize all denuded areas and maintain erosion control measures continuously between October 1 and April 30.
- · Store, handle, and dispose of construction materials and wastes properly, so as to prevent their contact with stormwater.
- · Control and prevent the discharge of all potential pollutants, including pavement cutting wastes, paints, concrete, petroleum products, chemicals, wash water or sediments, and non-stormwater discharges to storm drains and watercourses.
- · Use sediment controls or filtration to remove sediment when dewatering site and obtain Regional Water Quality Control Board (RWQCB) permit(s) as necessary.
- · Avoid cleaning, fueling, or maintaining vehicles on-site, except in a designated area where wash water is contained and treated.
- · Limit and time applications of pesticides and fertilizers to prevent polluted runoff.
- · Limit construction access routes to stabilized, designated access points
- · Avoid tracking dirt or other materials off-site; clean off-site paved areas and sidewalks using dry sweeping methods.
- · Train and provide instruction to all employees and subcontractors regarding the Watershed Protection Maintenance Standards and construction Best Management Practices.
- · Placement of erosion materials is required on weekends and during rain events.
- · The areas delineated onh the plans for parking, grubbing, storage etc., shall not be enlarged or "run over."
- · Dust control is required year-round.
- · Erosion control materials shall be stored on-site

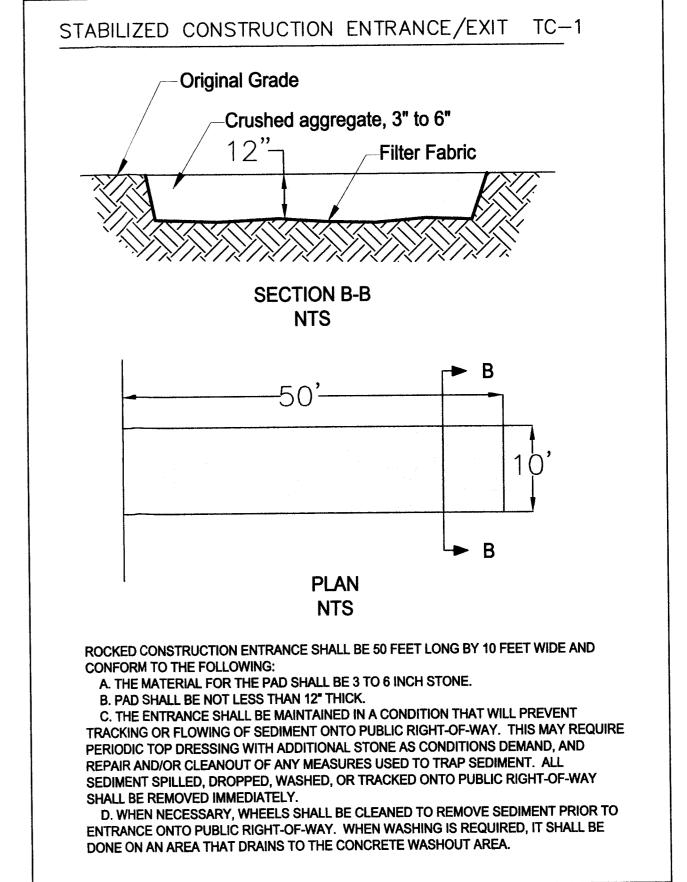



CONTROL COHN PROPERTY ALAMEDA, EL GRANA APN 047-127-520

SHEET

EROSION




Construction Best Management Practices (BMPs)

Construction projects are required to implement the stormwater best management practices (BMP) on this page, as they apply to your project, all year long.

Clean Water. Healthy Community.

Materials & Waste Management

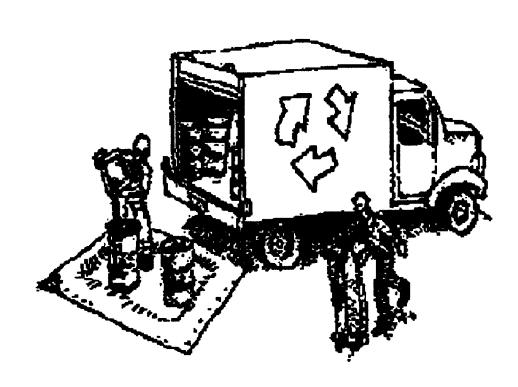

Non-Hazardous Materials

- ☐ Berm and cover stockpiles of sand, dirt or other construction material with tarps when rain is forecast or if not actively being used within 14 days.
- ☐ Use (but don't overuse) reclaimed water for dust control.

Hazardous Materials

- ☐ Label all hazardous materials and hazardous wastes (such as pesticides, paints, thinners, solvents, fuel, oil, and antifreeze) in accordance with city, county, state and federal regulations.
- ☐ Store hazardous materials and wastes in water tight containers, store in appropriate secondary containment, and cover them at the end of every work day or during wet weather or when rain is forecast.
- ☐ Follow manufacturer's application instructions for hazardous materials and be careful not to use more than necessary. Do not apply chemicals outdoors when rain is forecast within 24 hours.
- Arrange for appropriate disposal of all hazardous wastes.

Waste Management

- Cover waste disposal containers securely with tarps at the end of every work day and during wet weather.
- Check waste disposal containers frequently for leaks and to make sure they are not overfilled. Never hose down a dumpster on the construction site.
- Clean or replace portable toilets, and inspect them frequently for leaks and spills.
- Dispose of all wastes and debris properly. Recycle materials and wastes that can be recycled (such as asphalt, concrete, aggregate base materials, wood, gyp board, pipe, etc.)
- Dispose of liquid residues from paints, thinners, solvents, glues, and cleaning fluids as hazardous waste.

Construction Entrances and Perimeter

- Establish and maintain effective perimeter controls and stabilize all construction entrances and exits to sufficiently control erosion and sediment discharges from site and tracking off site.
- Sweep or vacuum any street tracking immediately and secure sediment source to prevent further tracking. Never hose down streets to clean up tracking.

Equipment Management & Spill Control




Maintenance and Parking

- ☐ Designate an area, fitted with appropriate BMPs, for vehicle and equipment parking and storage.
- ☐ Perform major maintenance, repair jobs, and vehicle and equipment washing off site.
- ☐ If refueling or vehicle maintenance must be done onsite, work in a bermed area away from storm drains and over a drip pan or drop cloths big enough to collect fluids. Recycle or dispose of fluids as hazardous waste.
- ☐ If vehicle or equipment cleaning must be done onsite, clean with water only in a bermed area that will not allow rinse water to run into gutters, streets, storm drains, or surface waters.
- Do not clean vehicle or equipment onsite using soaps, solvents, degreasers, or steam cleaning equipment.

Spill Prevention and Control

- Keep spill cleanup materials (e.g., rags, absorbents and cat litter) available at the construction site at all times.
- ☐ Inspect vehicles and equipment frequently for and repair leaks promptly. Use drip pans to catch leaks until repairs are made.
- Clean up spills or leaks immediately and dispose of cleanup materials properly.
- Do not hose down surfaces where fluids have spilled. Use dry cleanup methods (absorbent materials, cat litter, and/or rags).
- Sweep up spilled dry materials immediately. Do not try to wash them away with water, or bury them.
- ☐ Clean up spills on dirt areas by digging up and properly disposing of contaminated soil.
- ☐ Report significant spills immediately. You are required by law to report all significant releases of hazardous materials, including oil. To report a spill: 1) Dial 911 or your local emergency response number, 2) Call the Governor's Office of Emergency Services Warning Center, (800) 852-7550 (24 hours).

Earthmoving

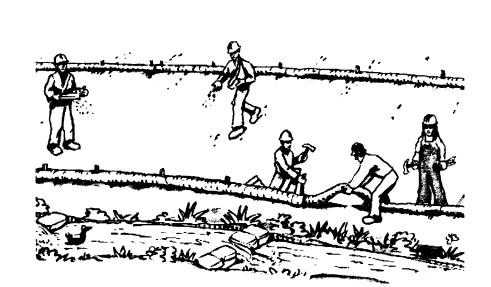


- Schedule grading and excavation work during dry weather.
- Stabilize all denuded areas, install and maintain temporary erosion controls (such as erosion control fabric or bonded fiber matrix) until vegetation is established.
- M Remove existing vegetation only when absolutely necessary, and seed or plant vegetation for erosion control on slopes or where construction is not immediately planned.
- Prevent sediment from migrating offsite and protect storm drain inlets, gutters, ditches, and drainage courses by installing and maintaining appropriate BMPs, such as fiber rolls, silt fences, sediment basins, gravel bags, berms, etc.
- ☐ Keep excavated soil on site and transfer it to dump trucks on site, not in the streets.

Contaminated Soils

- ☐ If any of the following conditions are observed, test for contamination and contact the Regional Water Quality Control Board:
- Unusual soil conditions, discoloration, or odor.
- Abandoned underground tanks.
- Abandoned wells
- Buried barrels, debris, or trash.

Paving/Asphalt Work

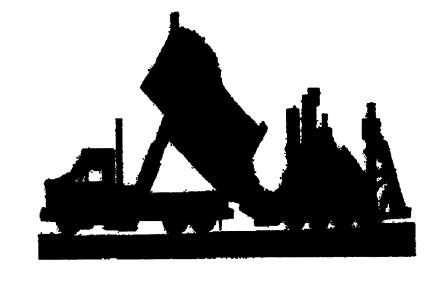


- Avoid paving and seal coating in wet weather or when rain is forecast, to prevent materials that have not cured from contacting stormwater runoff.
- ☐ Cover storm drain inlets and manholes when applying seal coat, tack coat, slurry seal, fog seal, etc.
- Collect and recycle or appropriately dispose of excess abrasive gravel or sand Do NOT sweep or wash it into gutters.
- Do not use water to wash down fresh asphalt concrete pavement.

Sawcutting & Asphalt/Concrete Removal

- ☐ Protect nearby storm drain inlets when saw cutting. Use filter fabric, catch basin inlet filters, or gravel bags to keep slurry out of the storm drain system.
- ☐ Shovel, abosorb, or vacuum saw-cut slurry and dispose of all waste as soon as you are finished in one location or at the end of each work day (whichever is sooner!).
- ☐ If sawcut slurry enters a catch basin, clean it up immediately.

Concrete, Grout & Mortar **Application**

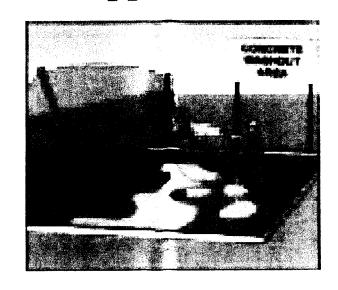


- ☐ Store concrete, grout, and mortar away from storm drains or waterways, and on pallets under cover to protect them from rain, runoff, and wind.
- Wash out concrete equipment/trucks offsite or in a designated washout area, where the water will flow into a temporary waste pit, and in a manner that will prevent leaching into the underlying soil or onto surrounding areas. Let concrete harden and dispose of as garbage.
- ☐ When washing exposed aggregate, prevent washwater from entering storm drains. Block any inlets and vacuum gutters, hose washwater onto dirt areas, or drain onto a bermed surface to be pumped and disposed of properly.

Landscaping



- ☐ Protect stockpiled landscaping materials from wind and rain by storing them under tarps all year-round.
- ☐ Stack bagged material on pallets and under cover.
- Discontinue application of any erodible landscape material within 2 days before a forecast rain event or during wet weather.

Painting & Paint Removal

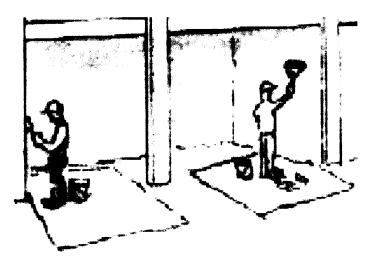

Painting Cleanup and Removal


- Never clean brushes or rinse paint containers into a street, gutter, storm drain, or stream.
- For water-based paints, paint out brushes to the extent possible, and rinse into a drain that goes to the sanitary sewer. Never pour paint down a storm drain.
- ☐ For oil-based paints, paint out brushes to the extent possible and clean with thinner or solvent in a proper container. Filter and reuse thinners and solvents. Dispose of excess liquids as hazardous waste.
- ☐ Paint chips and dust from non-hazardous dry stripping and sand blasting may be swept up or collected in plastic drop cloths and disposed of as trash.
- ☐ Chemical paint stripping residue and chips and dust from marine paints or paints containing lead, mercury, or tributyltin must be disposed of as hazardous waste. Lead based paint removal requires a statecertified contractor.


Dewatering




- ☐ Discharges of groundwater or captured runoff from dewatering operations must be properly managed and disposed. When possible send dewatering discharge to landscaped area or sanitary sewer. If discharging to the sanitary sewer call your local wastewater treatment plant.
- ☐ Divert run-on water from offsite away from all disturbed areas.
- ☐ When dewatering, notify and obtain approval from the local municipality before discharging water to a street gutter or storm drain. Filtration or diversion through a basin, tank, or sediment trap may be required.
- ☐ In areas of known or suspected contamination, call your local agency to determine whether the ground water must be tested. Pumped groundwater may need to be collected and hauled off-site for treatment and proper disposal


Storm drain polluters may be liable for fines of up to \$10,000 per day!

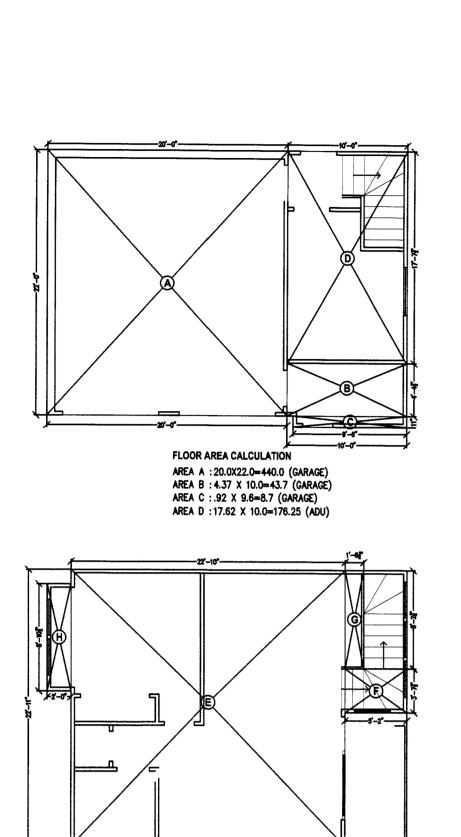

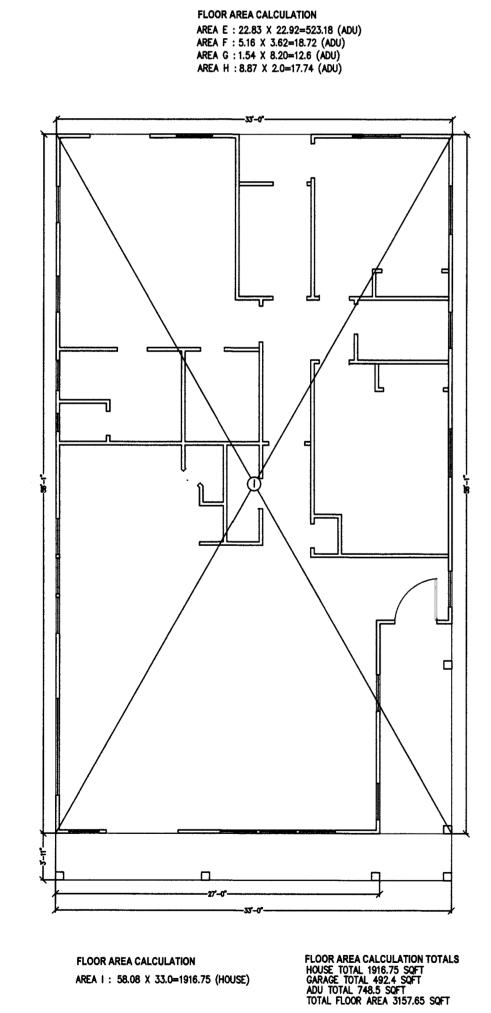




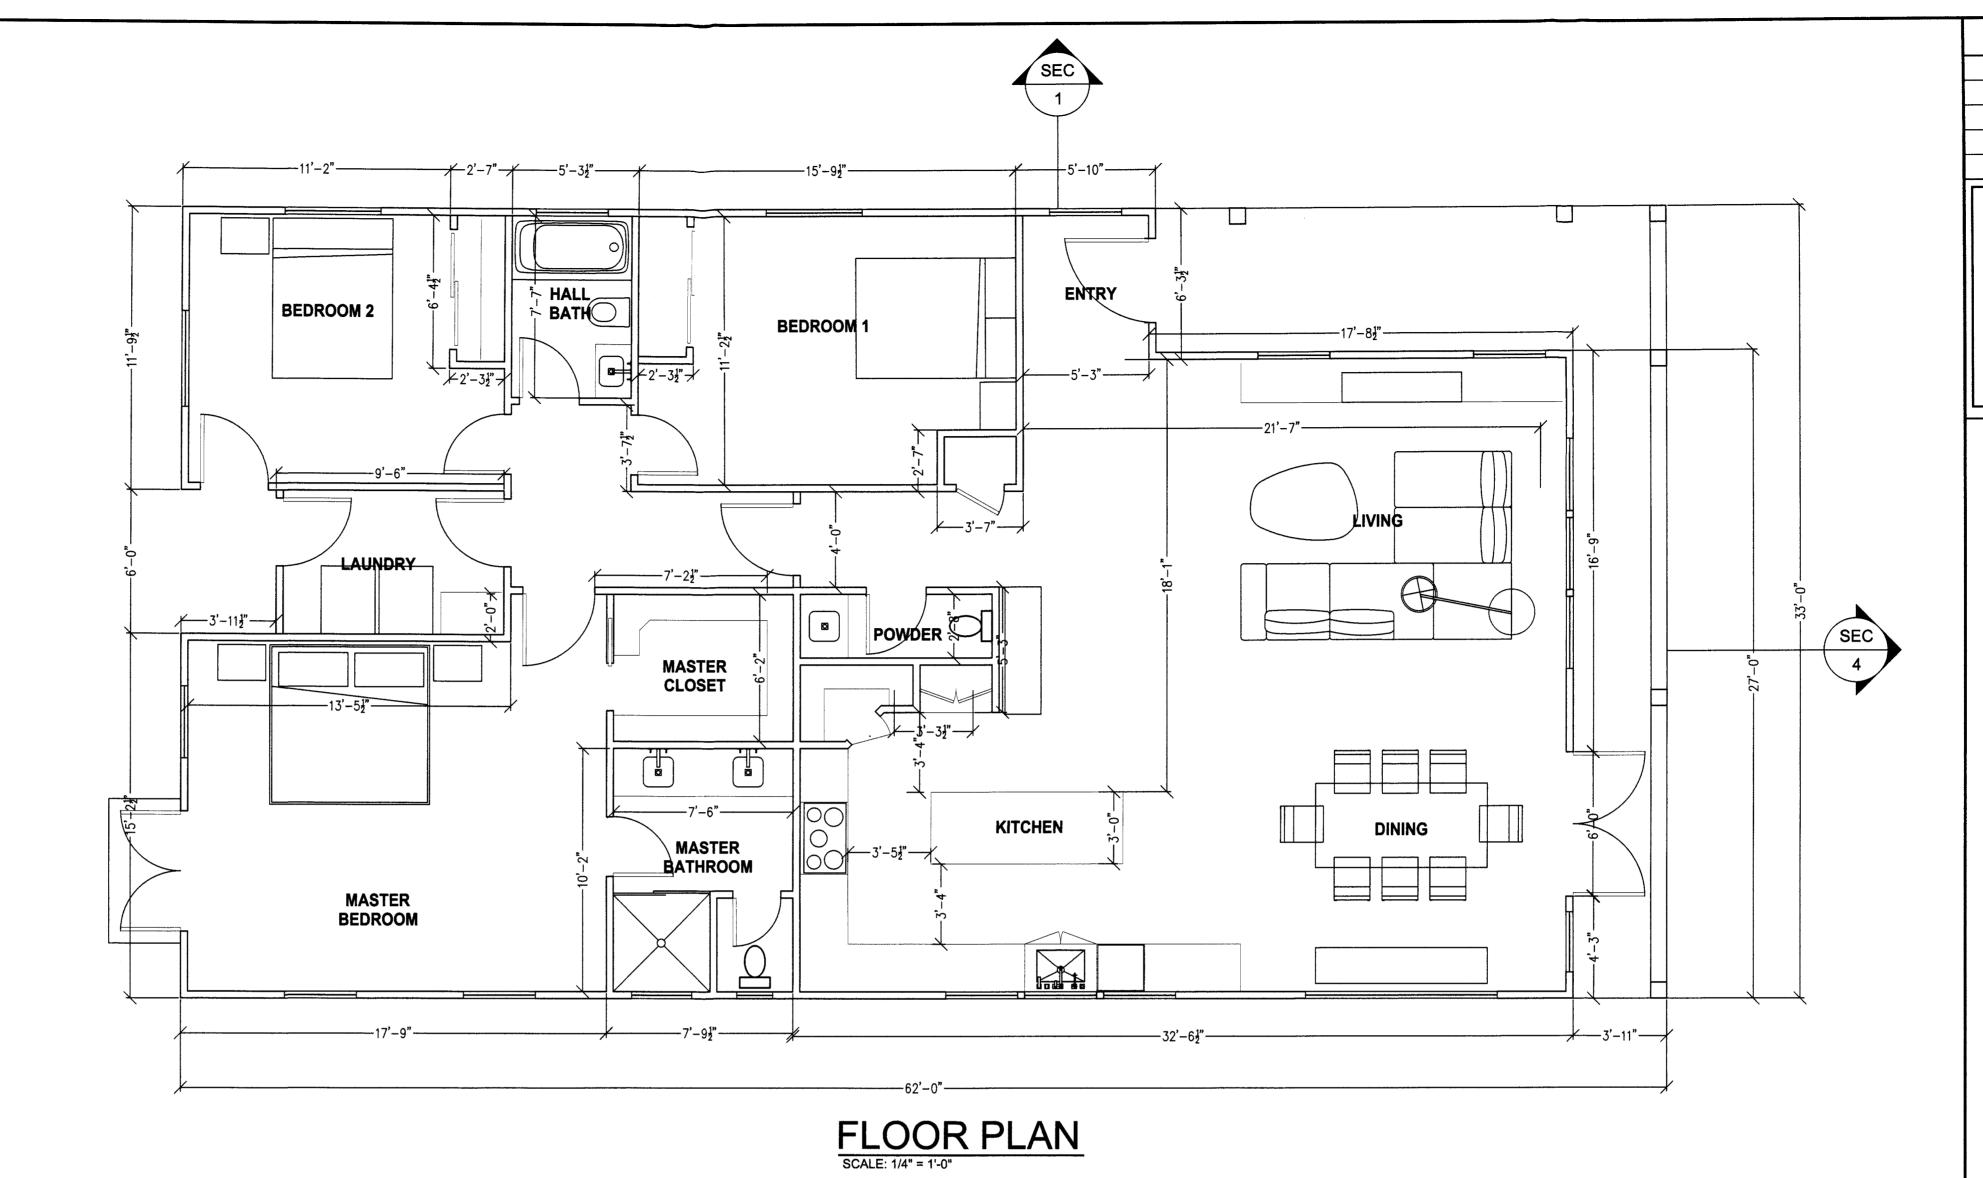

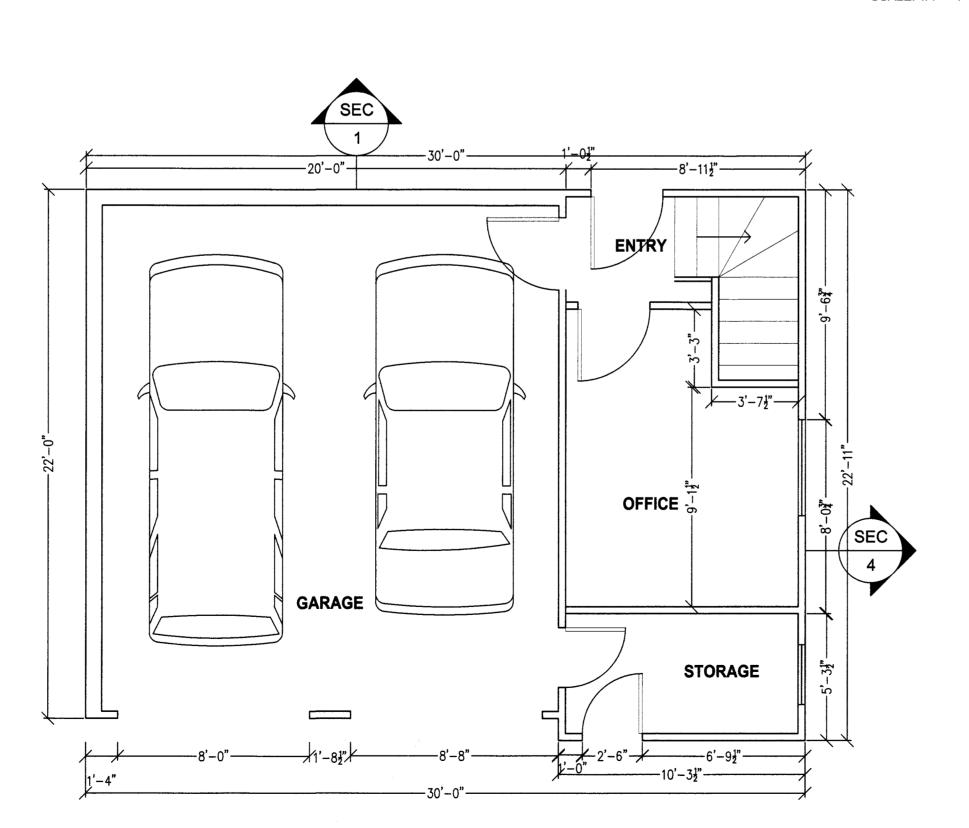



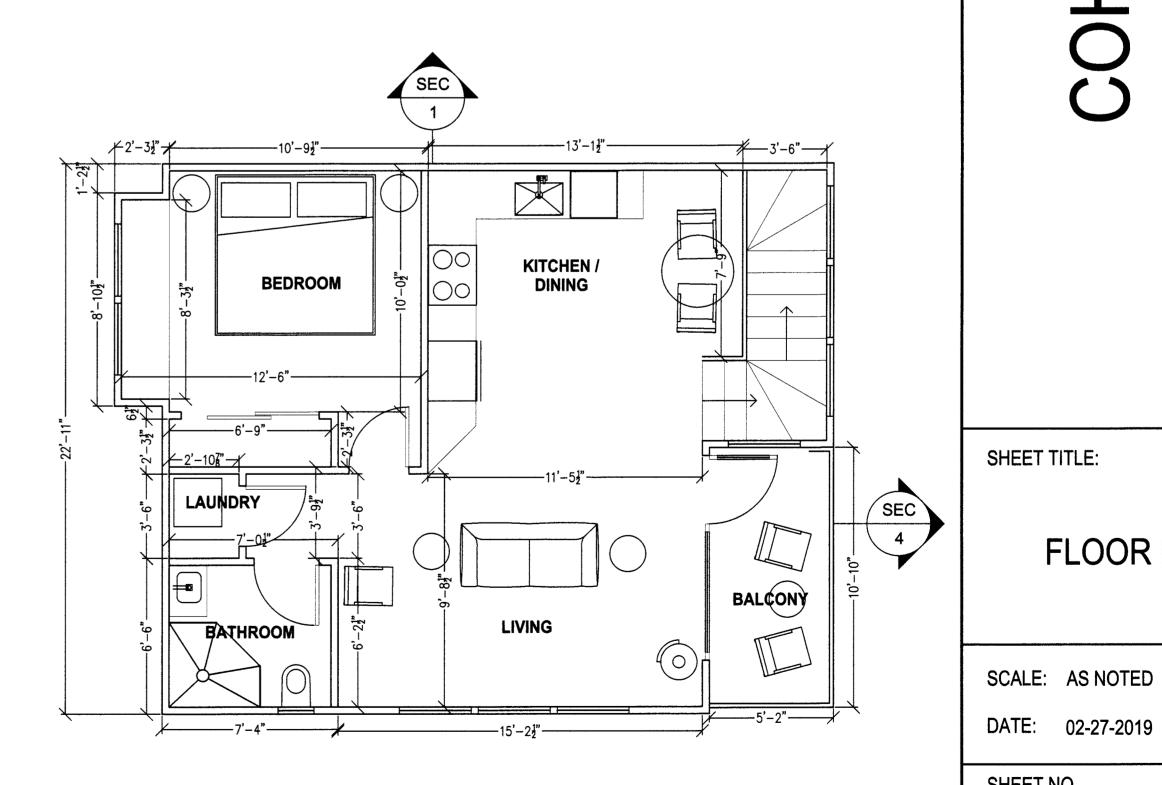

LEVEL 2 ADU FLOOR PLAN
SCALE: 1/4" = 1'-0"

REVISIONS

DATE

DOUG MACHADO PO BOX 2902

EL GRANADA, CA

650-726-1408


midcoastconsult@gmail.com


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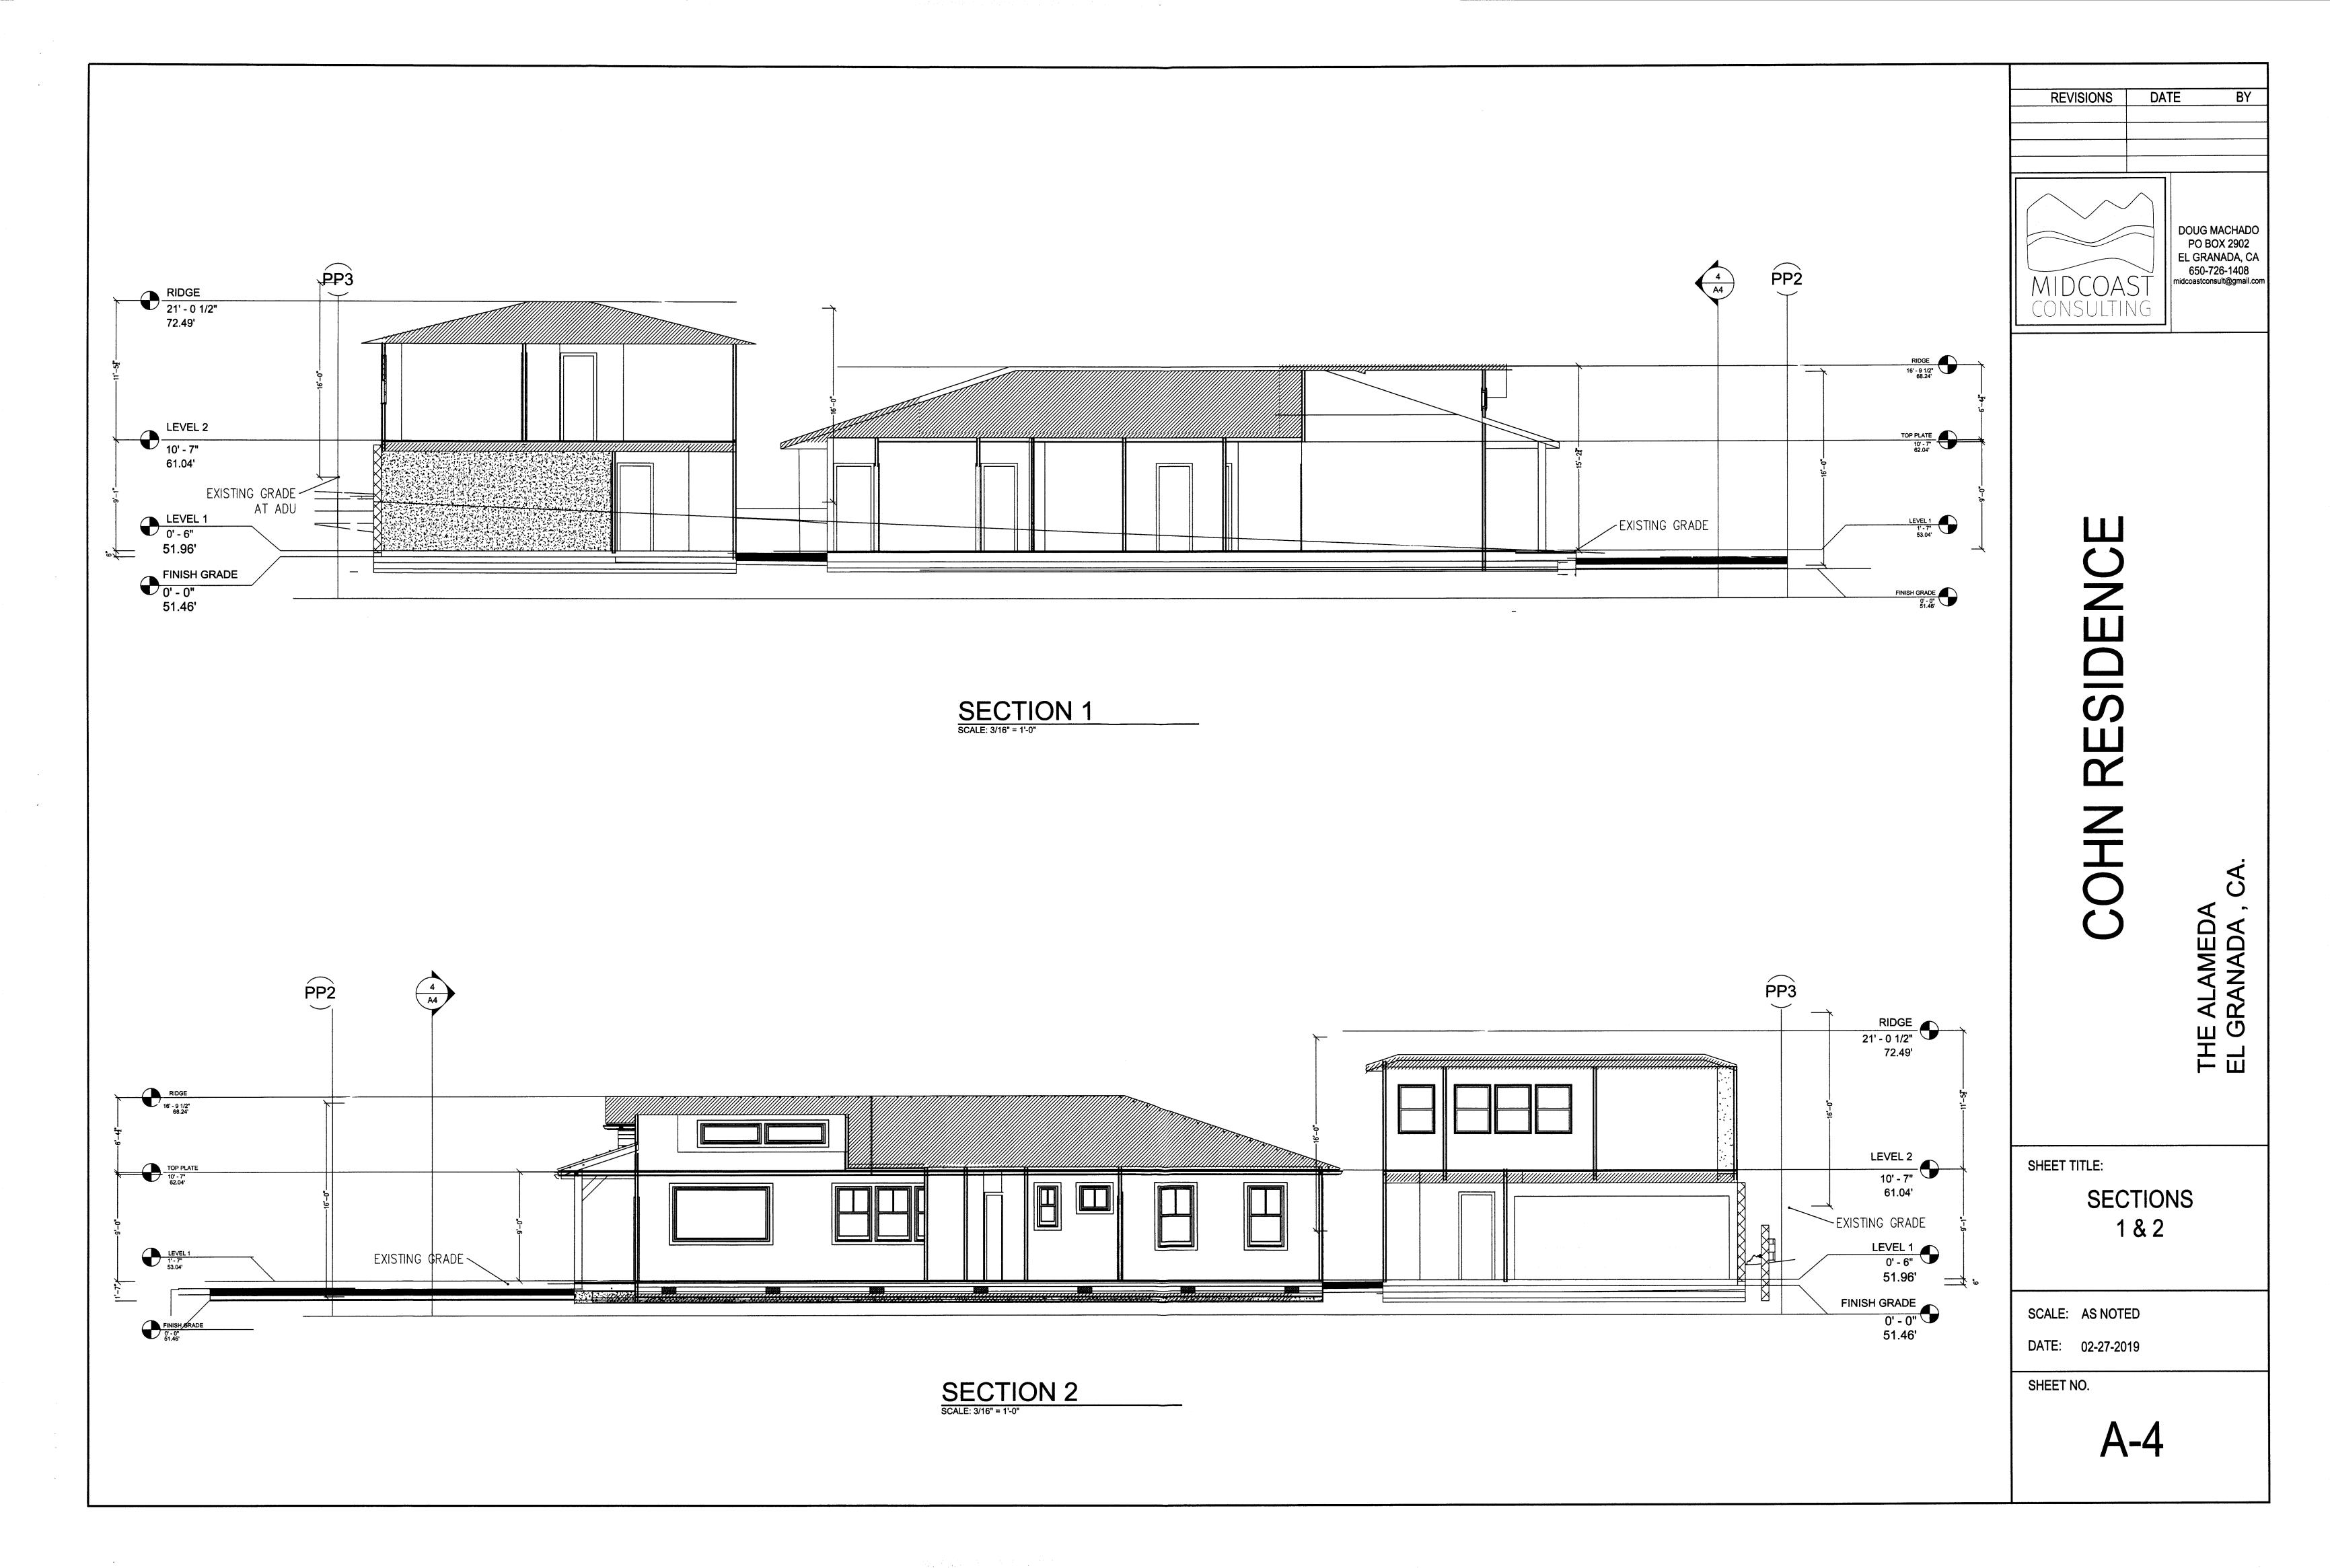
FLOOR PLANS


SCALE: AS NOTED

SHEET NO.



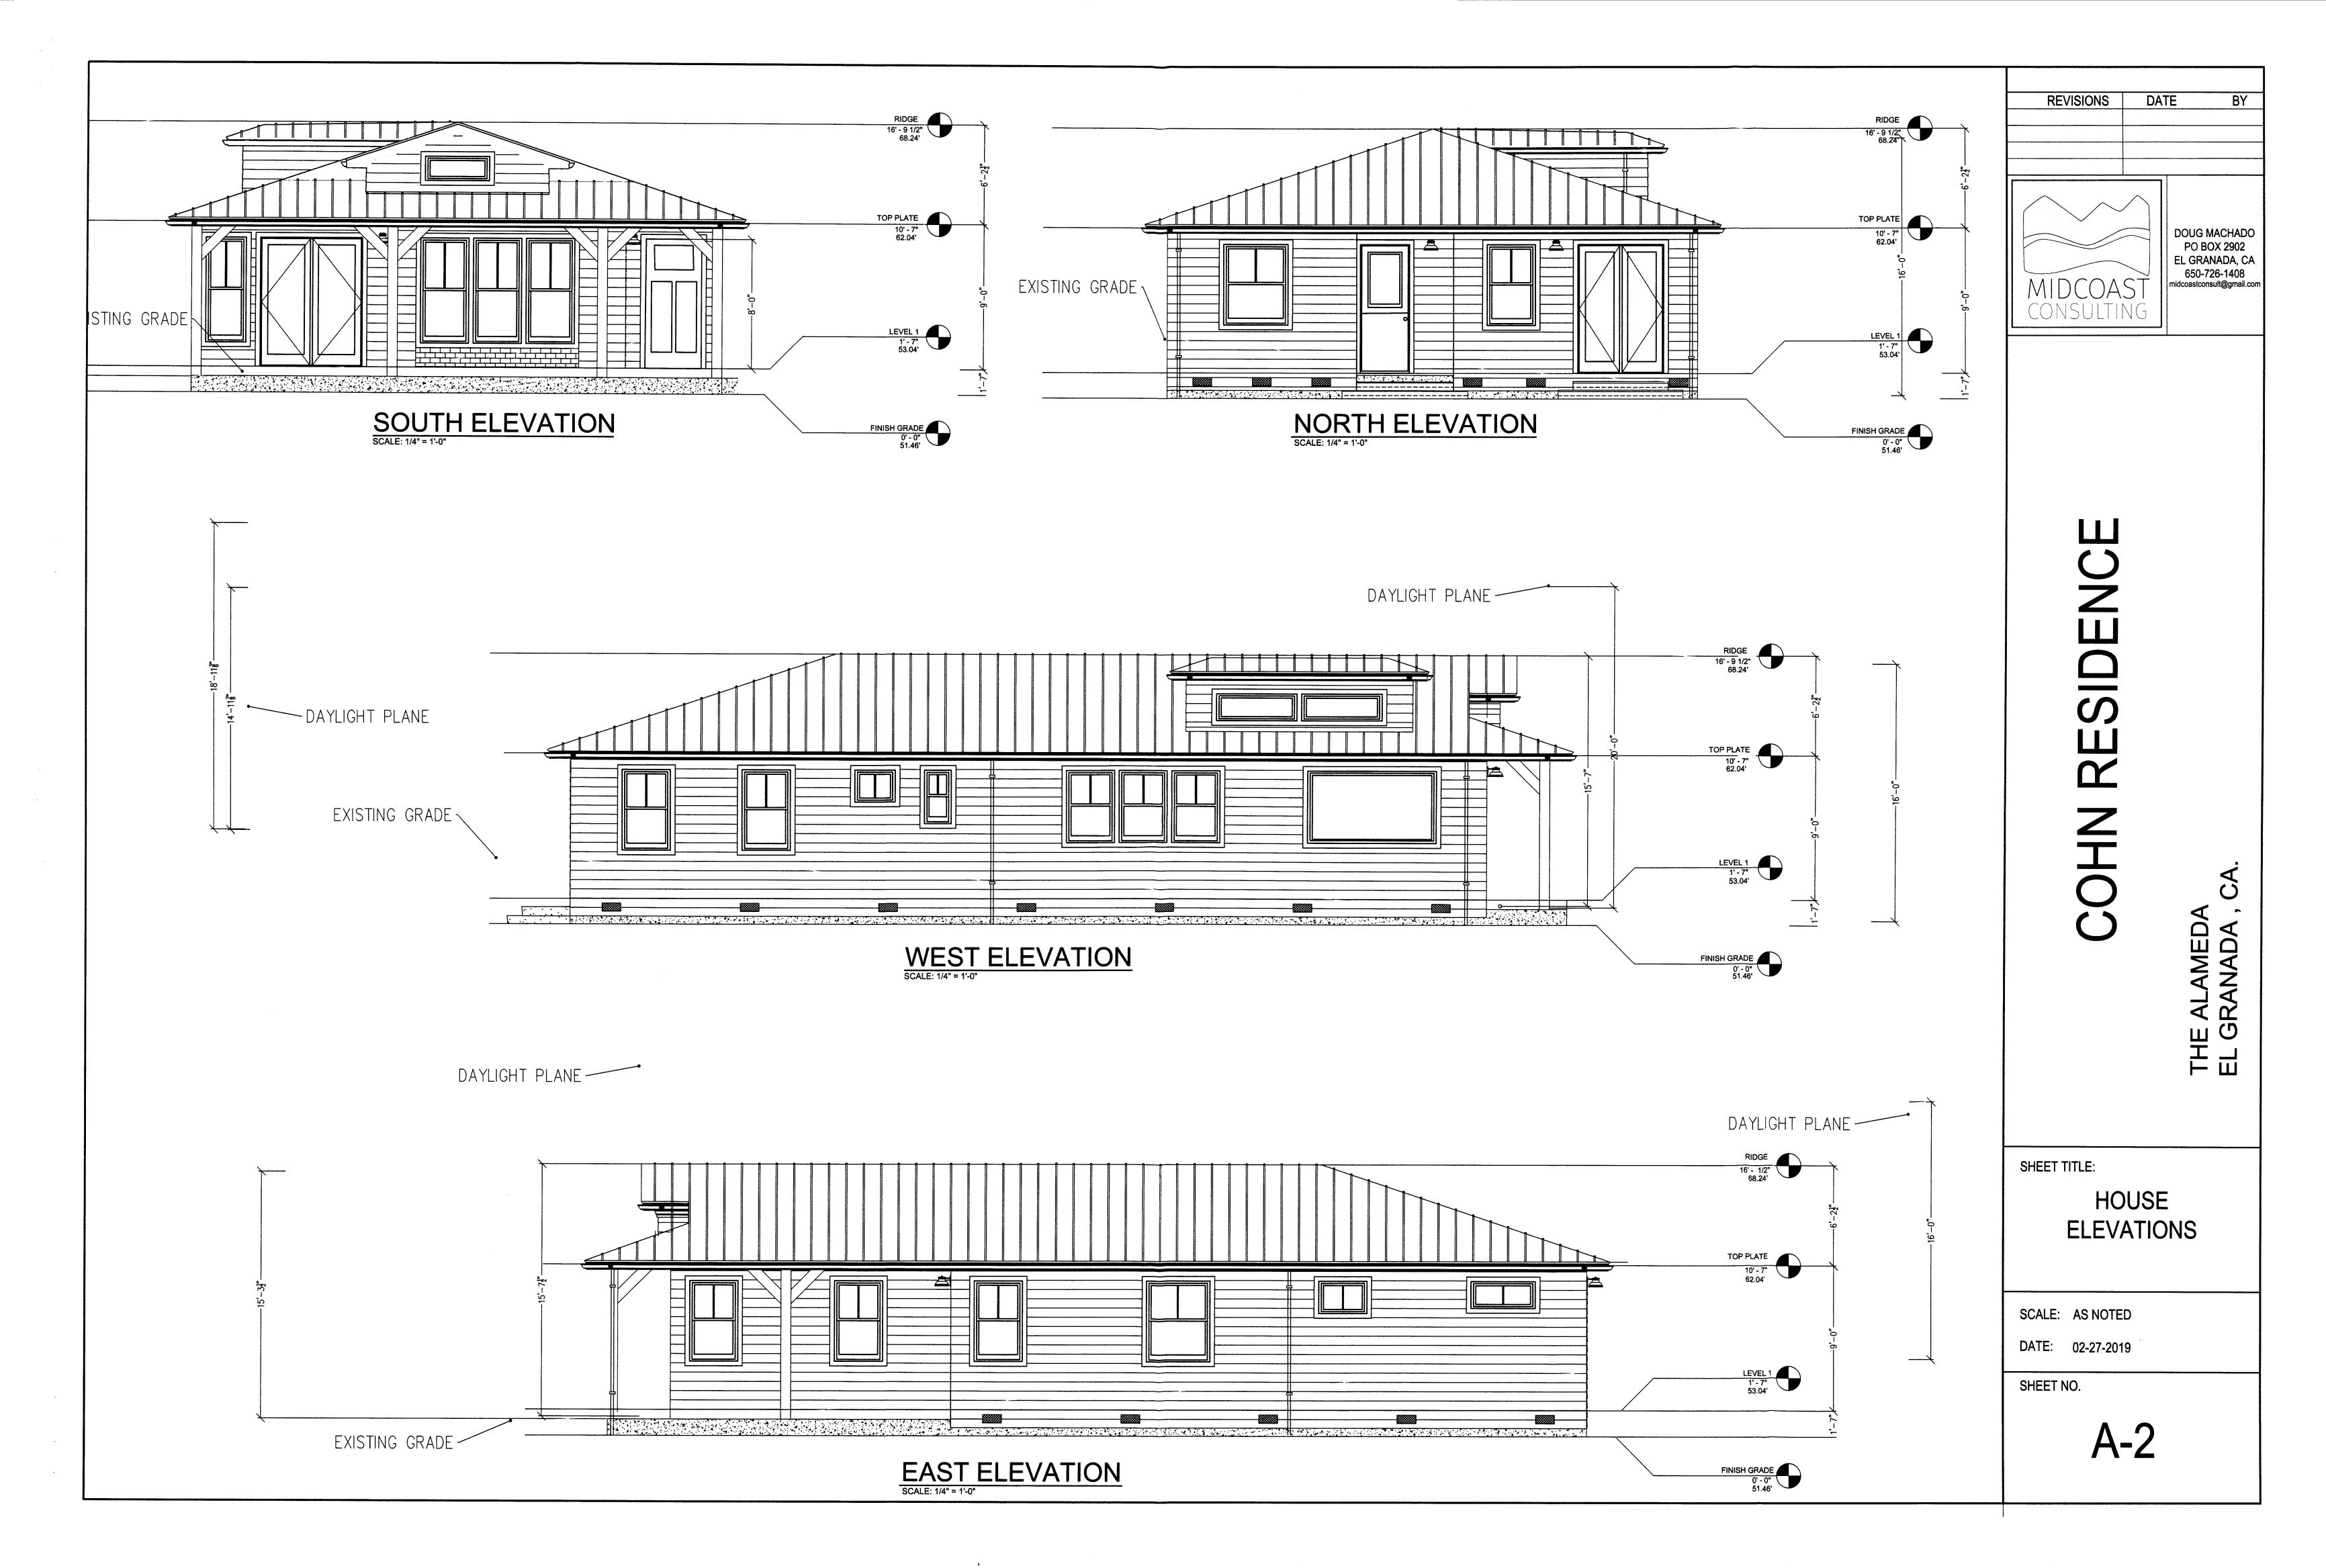

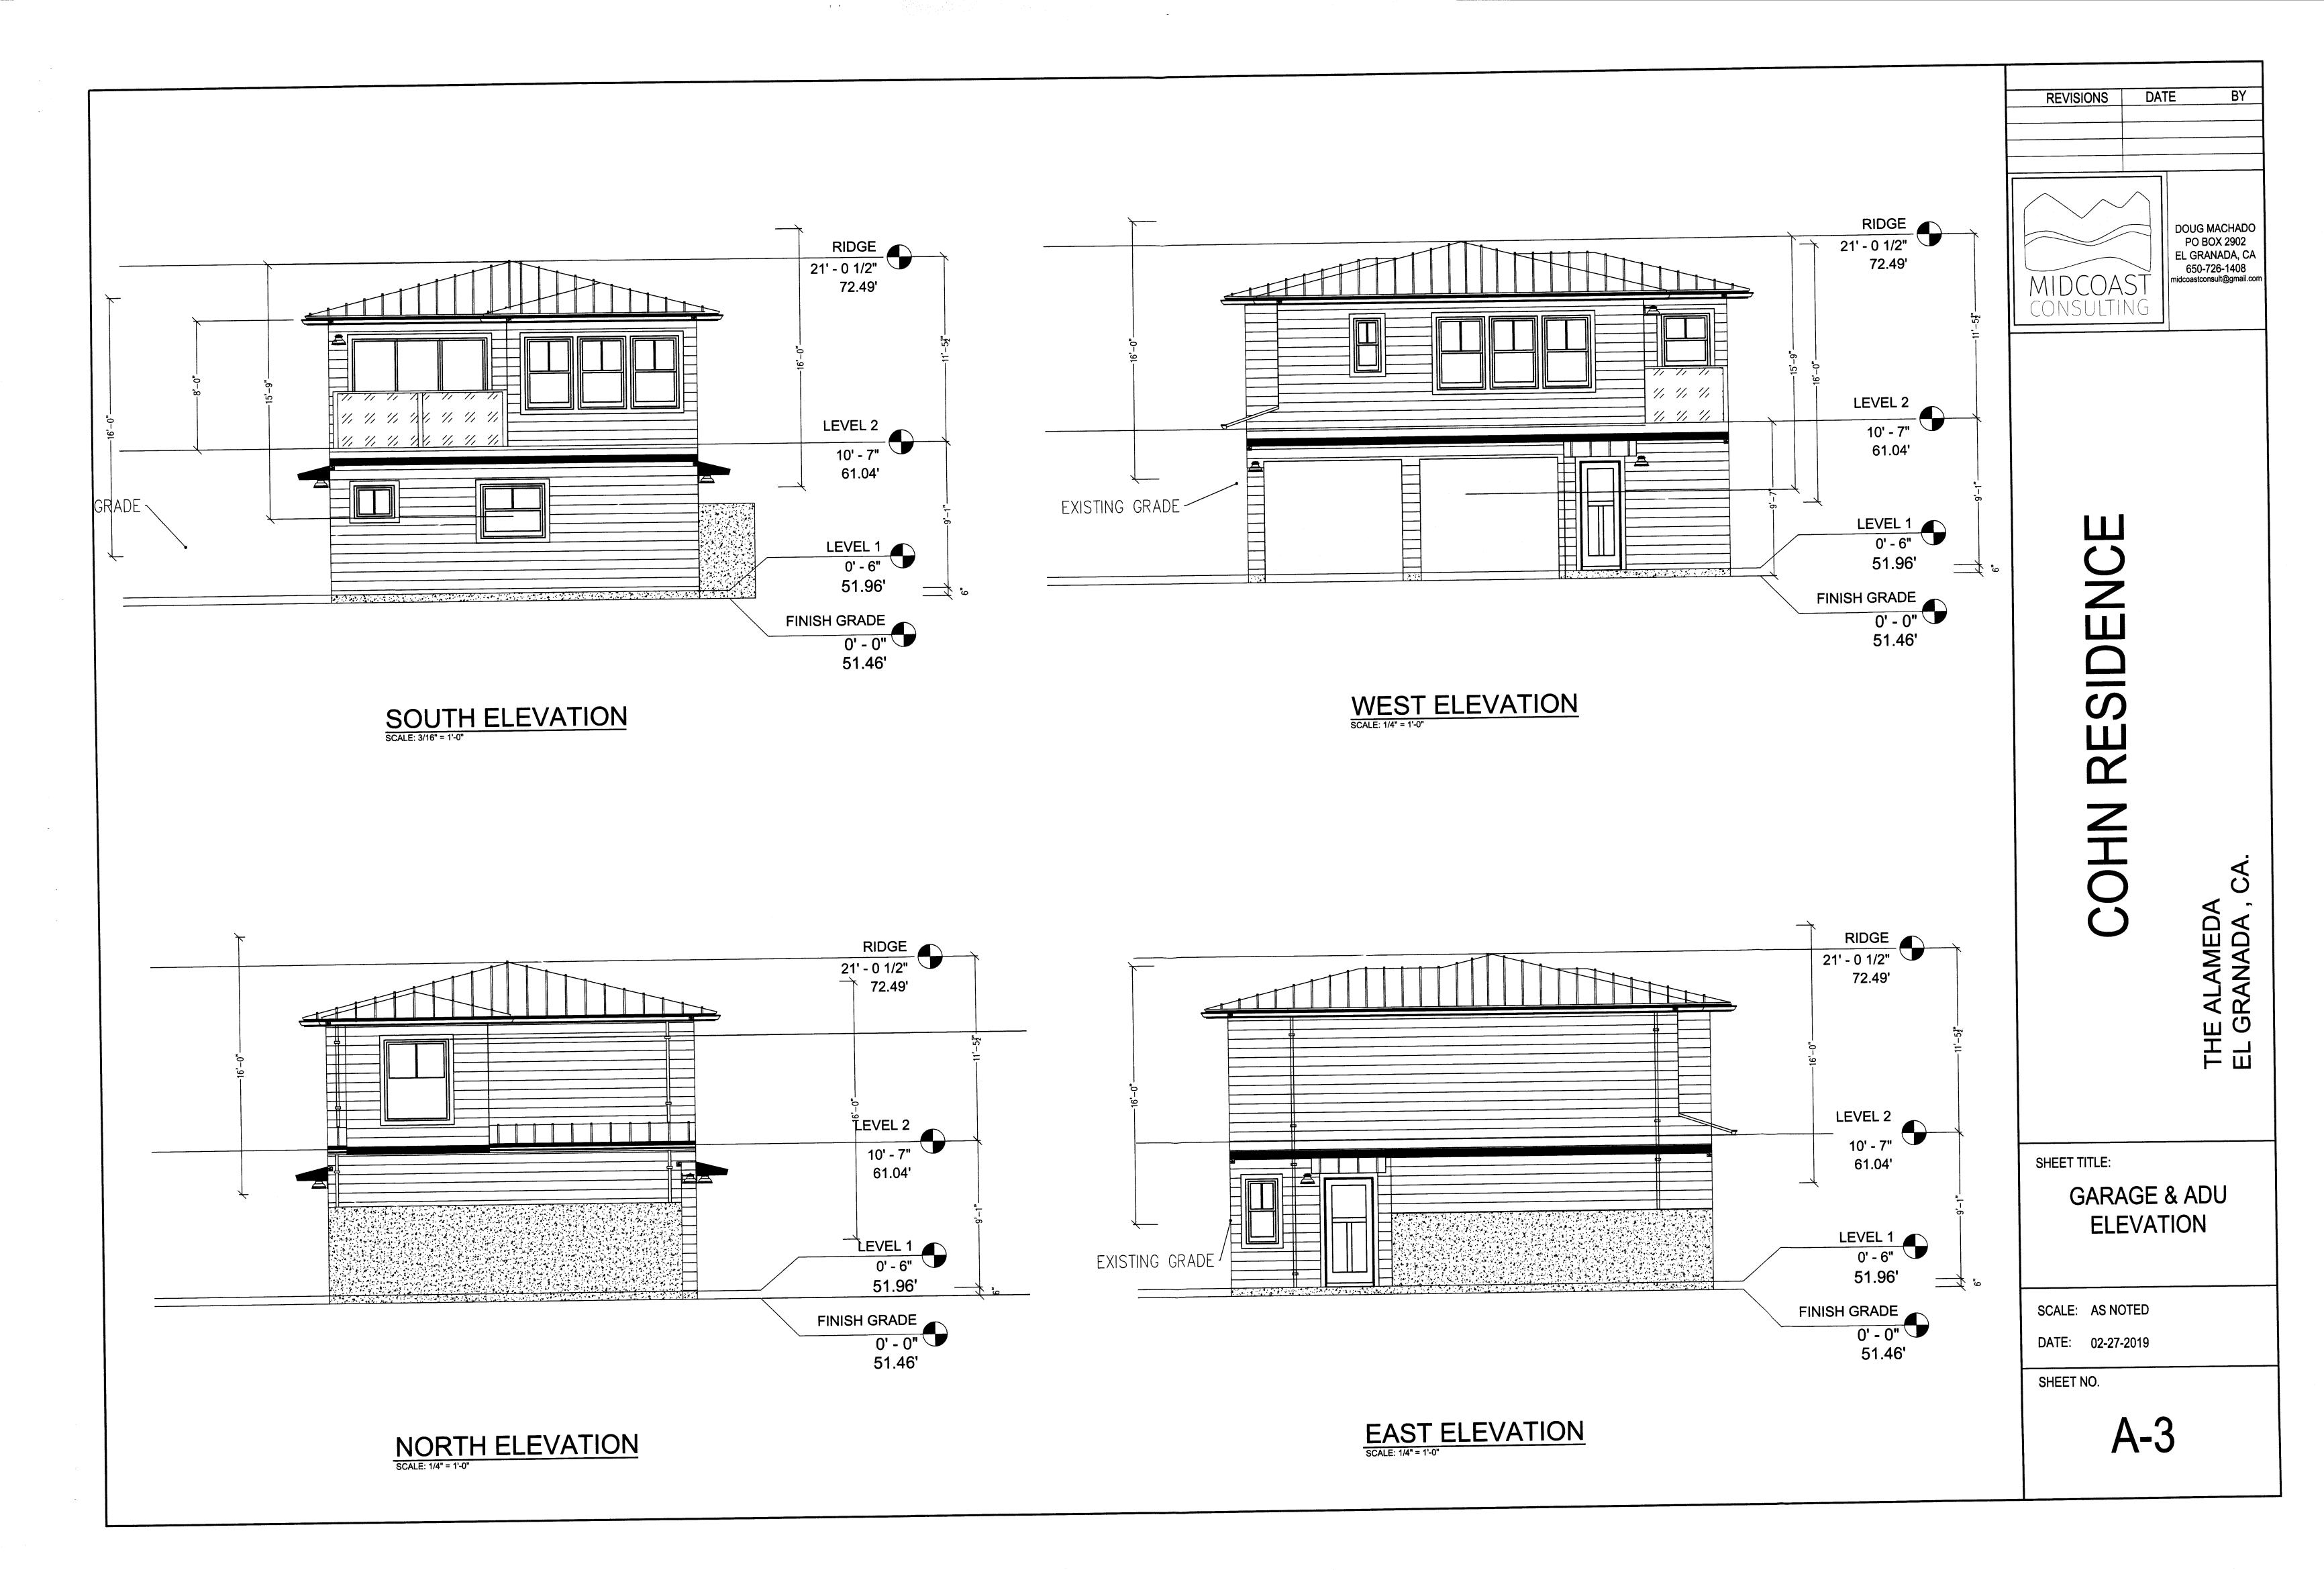

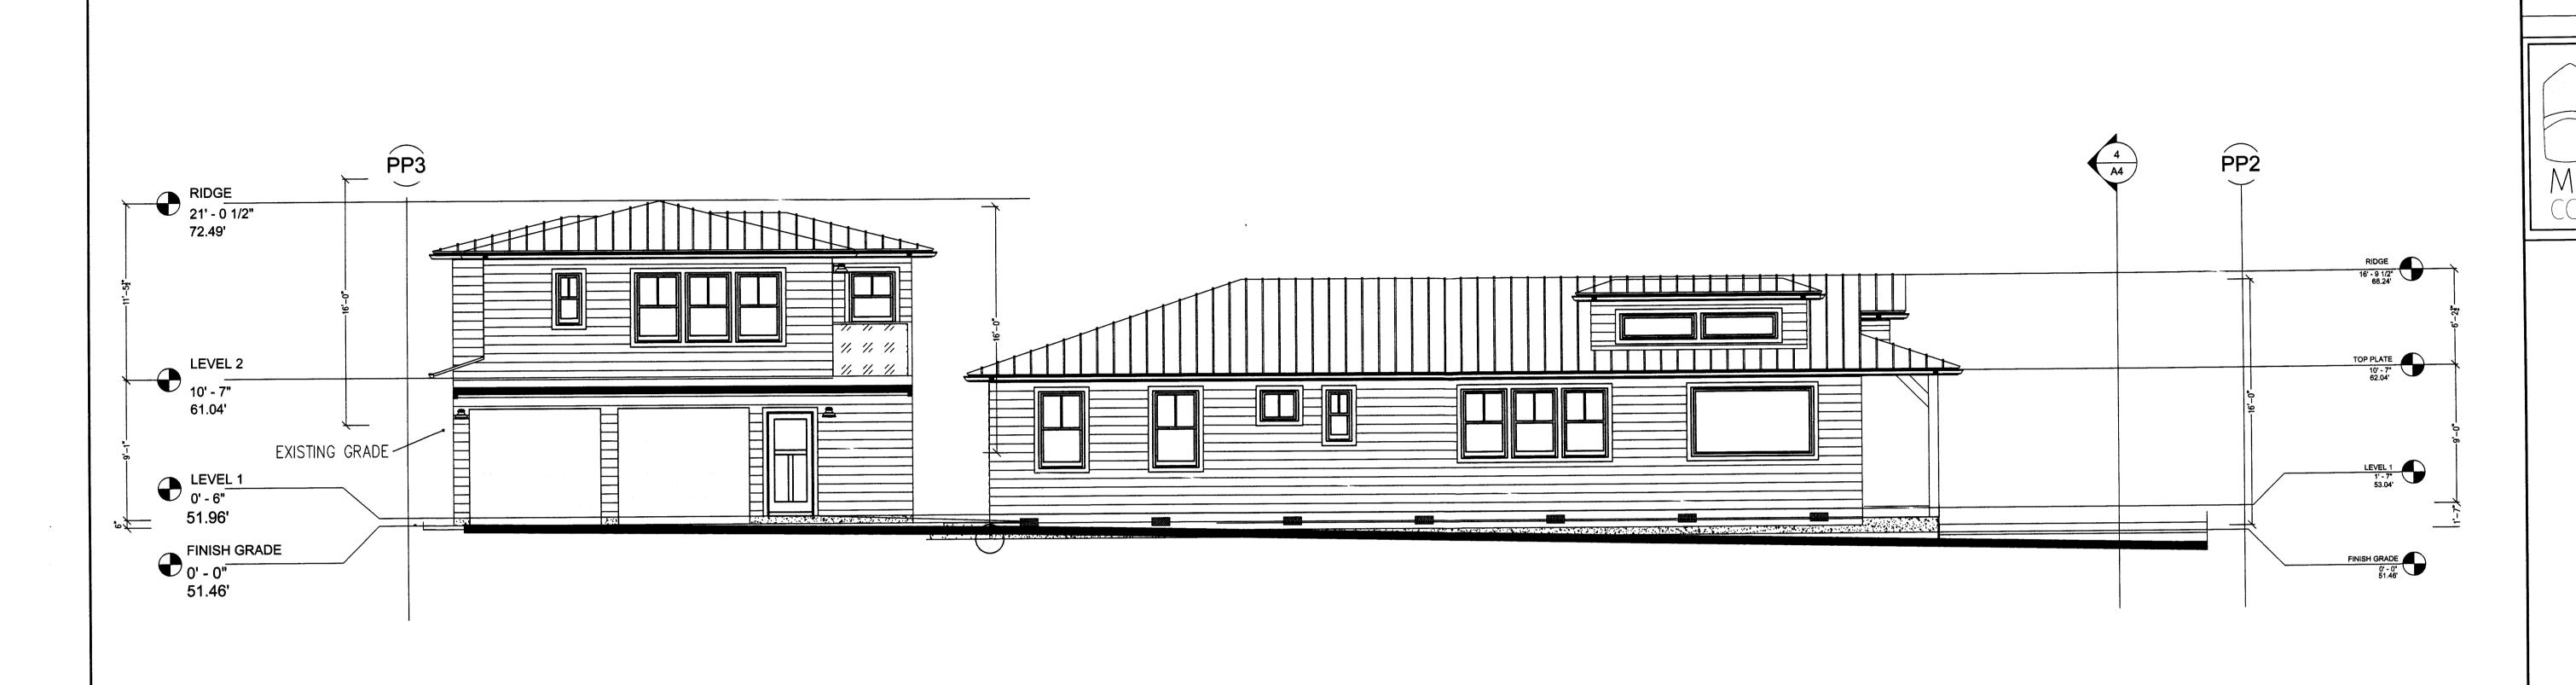

COHN RESIDENCE

THE ALAMEDA EL GRANADA , CA.

BY

DOUG MACHADO
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midcoastconsult@gmail.com

DATE

REVISIONS

SHEET TITLE:


SECTIONS 4 & 5

SCALE: AS NOTED

DATE: 02-27-2019

SHEET NO.


A-5

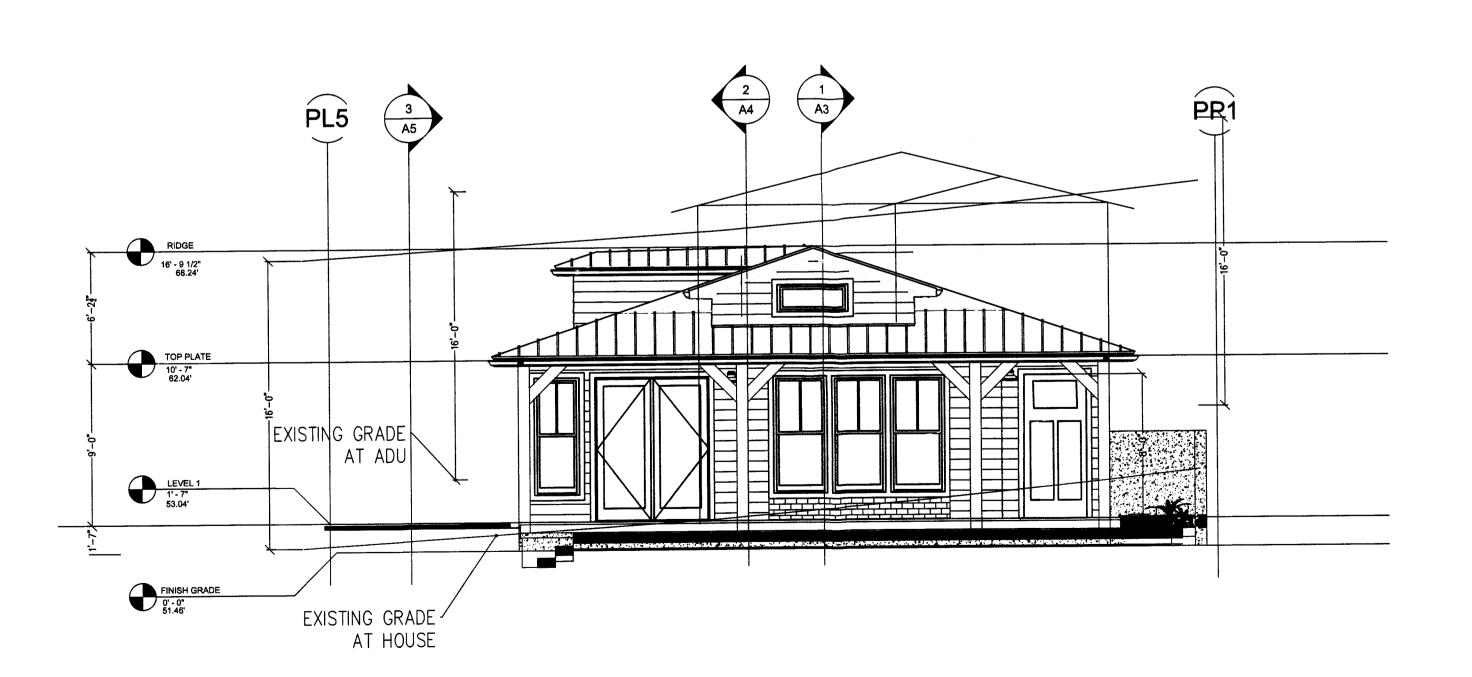

SECTION 4
SCALE: 3/16" = 1'-0"

SECTION 3

SCALE: 3/16" = 1'-0"

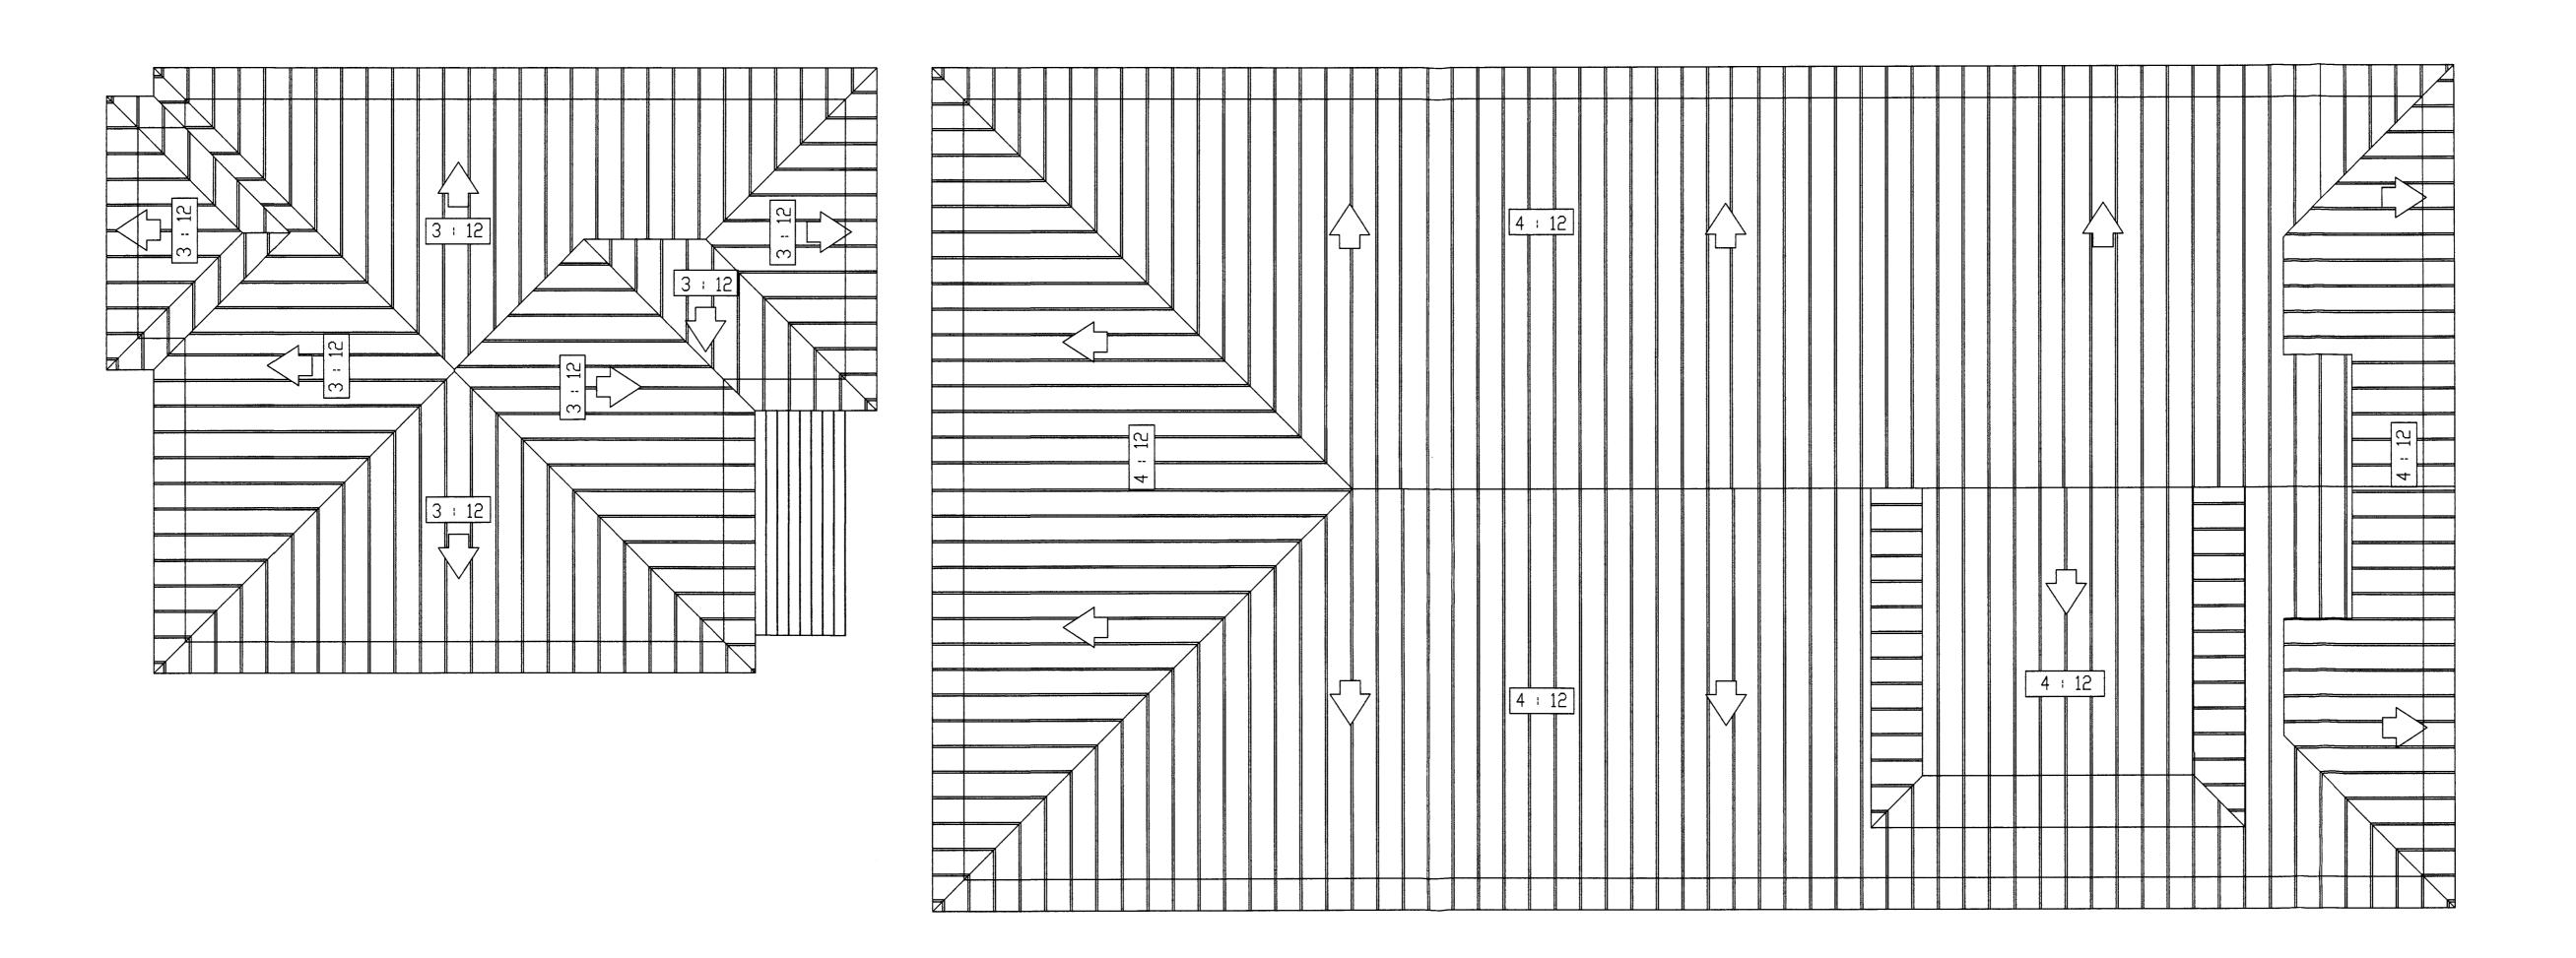

ROOF PLAN

SCALE: 1/4" = 1'-0"

POUG MACHADO PO BOX 2902 EL GRANADA, CA 650-670-2810 midcoastconsult@gmail.com

COHN RESIDENCE

SHEET TITLE:


ROOF PLAN

SCALE: AS NOTED

DATE: 02-27-2019

SHEET NO.

A-6

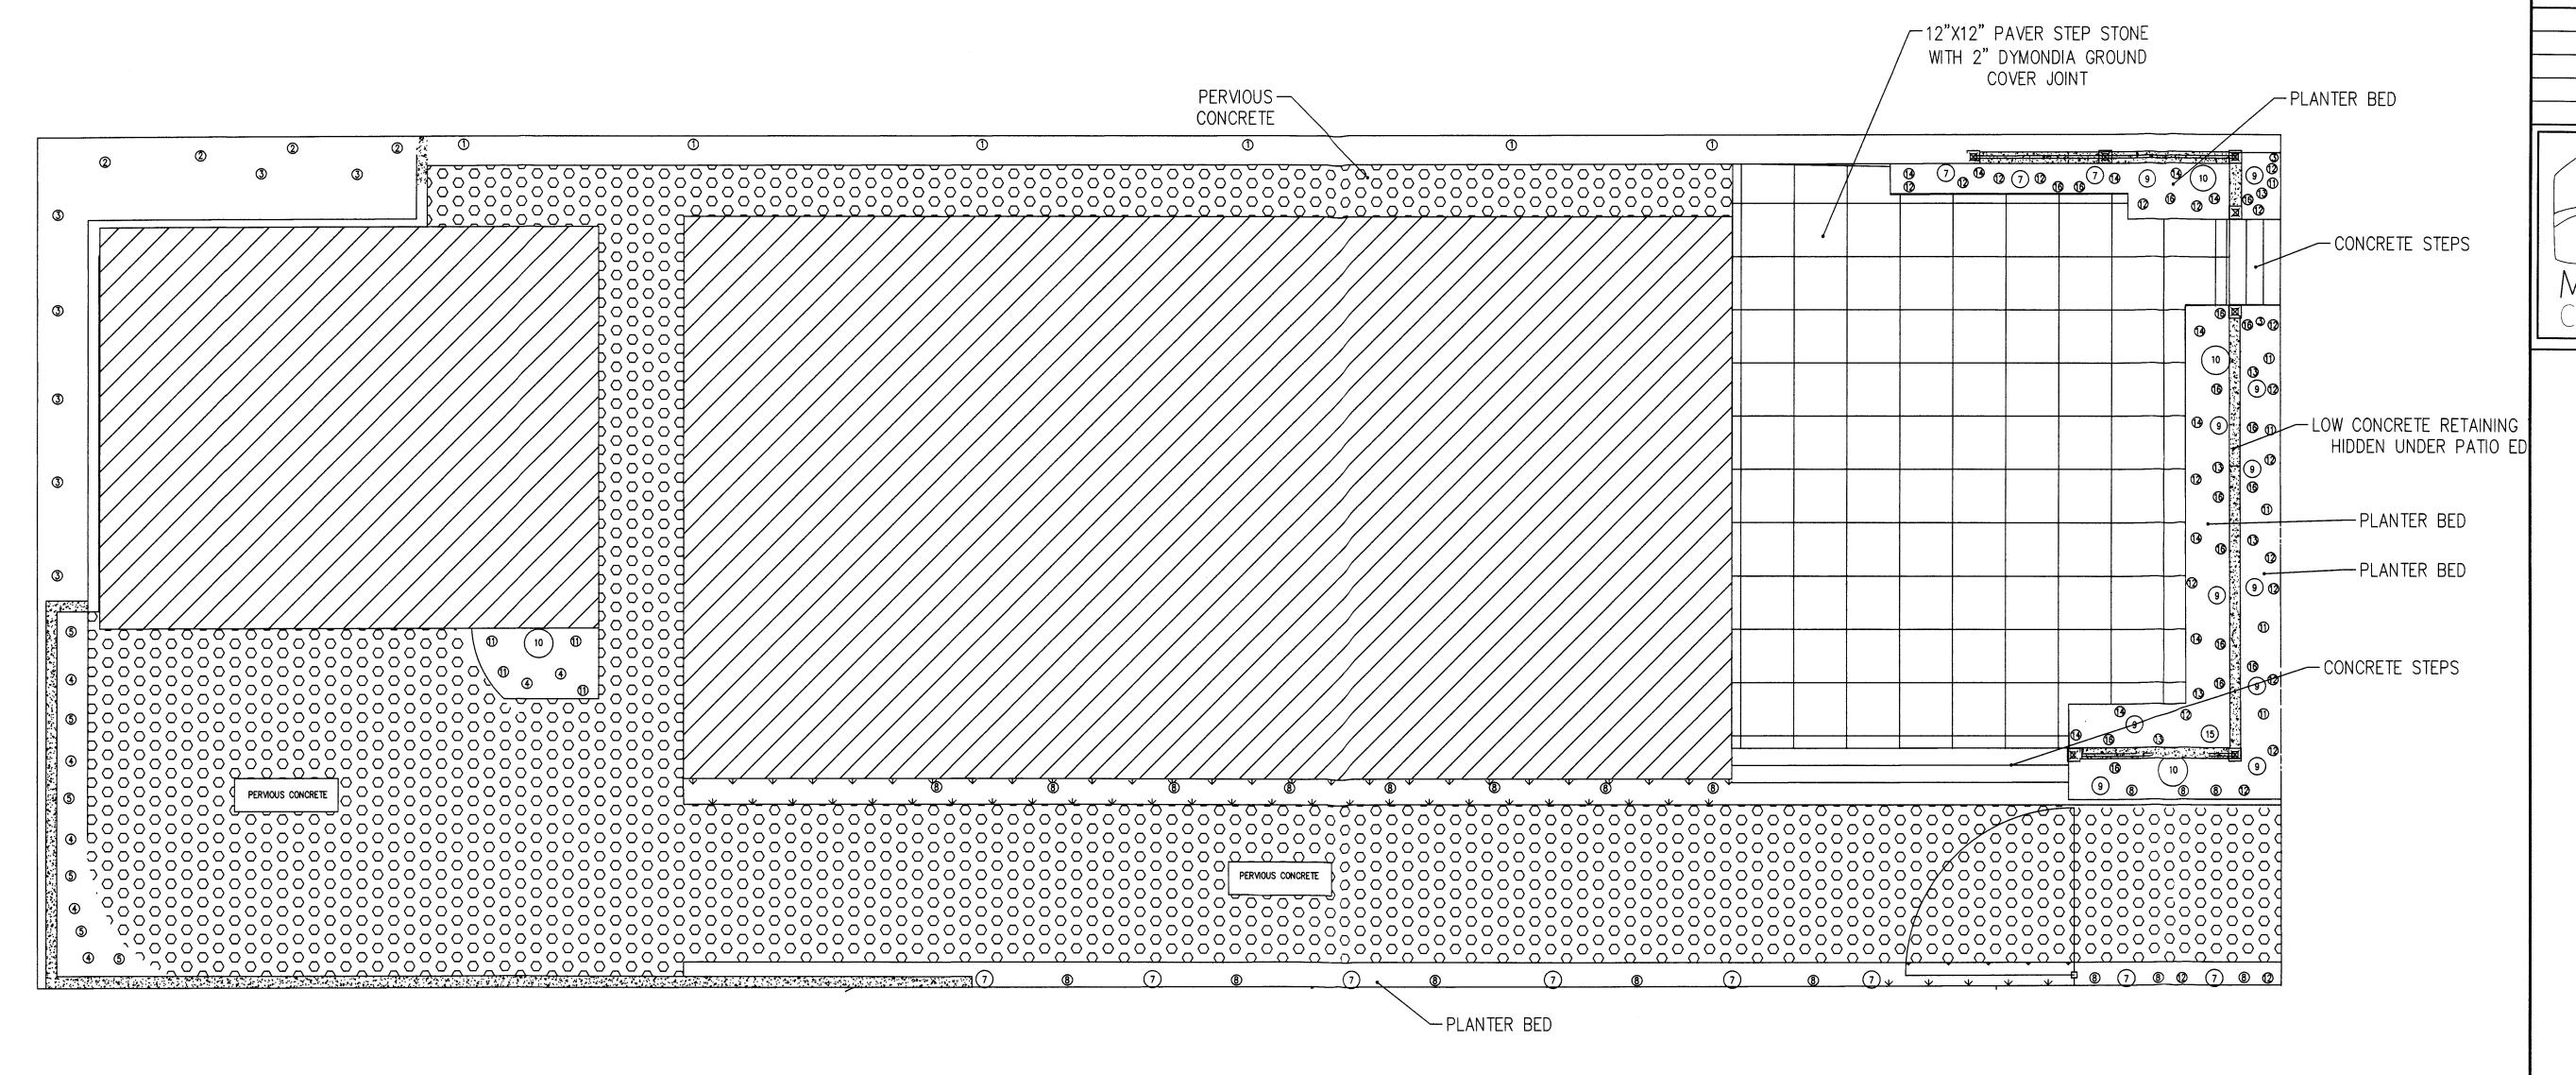

PLANT LIST

BOTANICAL NAME	QTY	SIZE
1-ROSMARINAS PROSTRATUS	18	1 GAL
2-PEROVSKIA ATRIPLIOIFOILIA "BLUE SPIRE"	12	1 GAL
3-MYOPORUM PARVIFOLIUM "PUTAH CREEK"	18	4 INCH
4-PHORMIUM TENAX "THUMBELINA"	12	1 GAL
5-DYMONDIA MARGARETAE	18	FLAT
7-DISTICTUS LAXIFLORA	18	5 GAL
8-LIRIOPE MUSCARI (SPICATA) "SILVER DRAGON"	27	1 GAL
9-EUPHORBIA CHARÀCIAS "WULFENII"	12	5 GAL
10-PHEONIX REOBELENII	3	15 GAL
11-LIRIOPI MUSCARI "SILVER SUNPROOF"	24	1 GAL
12-SEDUM SPURIUM "RED CARPET"	24	1 GAL
13-SANTOLINA CHAMAECYPARISSUS "LEMON QUEEN"	12	1 GAL
14-BERGENIA CRASIFOLIA	10	1 GAL
15-PHORMIUM TENAX "MAURI QUEEN"	1	5 GAL
16-SALVIA X SYLVESTRIS "MANACHT"	5	1 GAL

NOTES: ALL PLANTING AREAS TO HAVE A MINIMUM OF 3" OF MULCH.
ALL PLANTS TO BE HAND WATERED UNTIL ESTABLISHED.

LANDSCAPE PLAN
SCALE: 3/16" = 1'-0"

COHN RESIDENCE

REVISIONS

DATE

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THE ALAMEDA EL GRANADA, CA

SHEET TITLE:

LANDSCAPE PLAN

SCALE: AS NOTED

DATE: 02-27-2019

SHEET NO.

L-1