

Planning Permitt0270 Mai

Application Form

455 County Center, 2nd Floor • Redwood City CA 94063 Mail Drop: PLN 122 • TEL (650) 363-4161 • FAX (650) 363-4849 www.co.sanmateo.ca.us/planning

2018-00270 PLN:

Applicate/owner intermetion a se	
Applicant: Pat Datton	RECEIVED
Mailing Address: 1414 Harbour Way Sou	th Svite 190 Aug
Richmord, CA 94804	AUG 0 2102018
Phone, W: 925-818-8072	H: San Mateo County
E-mail Address: patrick. dalton e suppor	Ser. Len FAX: Planning Division
Name of Owner (1): Enily Hamphreys	Name of Owner (2):
Malling Address: 1626 Fair View St. Apt 1	Mailing Address:
Benerous (A 94703	Zire
Zip: Phone,W: ARL-JAQ-IQFS2	Phone,W:
Phone, W: 424-249-1958 H:	H:
E-mail Address: eniluh 20 alumi. Stanfor).C'E-mail Address:
Project Meimetten	
Project Location (address): O Use de Mer au	Assessor's Parcel Numbers: 037-155 - 080
MOSS beach, CA 94038	, , , , , , , , , , , , , , , , , , , ,
•	
Zoning: SIF	Parcel/lot size: 3363 SF (Square Feet)
Describe Existing Site Conditions/Features (e.g. topography	Water hodies vegetation!
EASTING SITE CONDITIONS	Consist of BRUSH VolitATION
Some Small Trues AN	D topography THAT SUPES
AWAY FROM STREET Y	o rome of proced House
LOCATION AMOUS MINIMAL	LOT DISTURBANCE AND WANT,
TO MANTON ALL EXISTING	Chetation & GROWTH AT rEAR SIDES
Describe Existing Structures and/or Development:	right of As MOCH AS postate.
NO - Easing STAUNCE	S OR DECELOPMENT
Tagastro Sinotoco	2 012 1019
Şignatures	
	n forms, plans and other materials submitted herewith in support
of the application is true and correct to the best of our knov	
through our assigned project planner of any changes to info	
Owner's signature: Wby We	
Owner's signature: WWY WME Owner's signature: Applicant's signature:	

Application for Design Review by the County Coastside Design Review Committee

[BMZ]alallatejztate Profileste e Disjozitatisatejate

County Government Center # 455 County Center # Redwood City CA 94063 Mail Drop PLN 122 # 650 • 363 • 4161 # FAX 650 • 363 • 4849

ieasea commetee	Other Permit #:
Sistematical and the second se	
Applicant:	Owner (if different from Applicant):
Name: Pat Dalton	Name: Enily Lampineys
Address: 1414 Harbour Way South, Ste 1919	Address: 1624 FARVIEW ST.
Richmond, CA Zip: 94804	PERVELEY CA Zip: CK1703
Phone, W925-818-8072 H:	Phone, W: 434-249-1908 H:
Email: patrick. daltone suppower.com	Email: enilyhaealunni stantordiedu
Architect or Designer (if different from Applicant): Name: Leila Mashhoodi	
Address: 945 Brentwood Ave, Vallejo,	A Zip: 94-591
and the same of th	Email:
	I
2. Evojao esticalidade dion	
Project location:	Site Description:
APN: 037-155-080	✓ Vacant Parcel
Address: O Vue de Mer Ave	Existing Development (Please describe):
Moss Beach, CA Zip: 94038	
Zoning: R-1/S-17/DR/CD	
Parcel/lot size: 3,363 sq. ft.	
S. Presigned editional distributions	
Project: 1257 toral	Additional Permits Required:
New Single Family Residence: sq. ft	Certificate of Compliance Type A or Type B
☐ Addition to Residence: sq. ft	Coastal Development Permit
Other:	☐ Fence Height Exception (not permitted on coast)
<u> </u>	☐ Grading Permit or Exemption
Describe Project:	☐ Home Improvement Exception
Small two story SNHE	Non-Conforming Use Permit
Family Horass - DosiGURES to	Off-Street Parking Exception
Fit was Narroeal Surroundings	□ Variance
With Little inpact on y priced	
SURRECUDINGS AS POSSIBLE.	

Check if matches Color/Finish **Material** Fill in Blanks: existing (If different from existing, attach sample) a. Exterior walls b. Trim c. Windows d. Doors e. Roof f. Chimneys 4 g. Decks & railings h. Stairs i. Retaining walls j. Fences k. Accessory buildings I. Garage/Carport To approve this application, the County must determine that this project complies with all applicable regulations including the required findings that the project does conform to the standards and guidelines for design review applicable to the location of the project pursuant to Section 6565.10. (optional) Applicant's Statement of project compliance with standards and guidelines (check if attached). I hereby certify that the information stated above and on forms, plans, and other materials submitted herewith in support of the application is true and correct to the best of my knowledge. It is my responsibility to inform the County of San Mateo through my assigned project planner of any changes to information represented in these submittals. Applicant:

Date:

7/16/18

Date:

Environmental Intelligible Disclosure Form

JUL 1 9 2018 D

		San Mateo County Service Stract CA GAOSS Service Stract Represent (A 94-703 Phone: 42A-24e)	
\cccc.	orio Par		1.1700
155055	UI S Fait		
		Address: 194 Harbour Way South St	15 601
coning	District:	2.1517 DR CD Richmond, (A 948 PATONE: 925-818-8	072
BT	stine	Site Conditions	
		3363	
ourpose	of any e	tent and type of all existing development and uses on the project parcel, including the existence and easements on the parcel, and a description of any natural features on the project parcel (i.e. steep terra on).	in,
Y CONTRACTOR	distantantan	iental Review Checklist	
Y CONTRACTOR	distantantan	tental Review Checklist Environmental Quality Act (CEQA) Review	
Y CONTRACTOR	distantantan		
1. Ca	lifornia	Environmental Quality Act (CEQA) Review	
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1. Cal Yes	No X X X X	 Environmental Quality Act (CEQA) Review Will this project involve: a. Addition to an existing structure > 50% of the existing area OR > 2,500 sq. ft? b. Construction of a new multi-family residential structure having 5 or more units? c. Construction of a commercial structure > 2,500 sq.ft? d. Removal of mature tree(s) (≥ 6" d.b.h. in Emerald Lake Hills area or ≥ 12" d.b.h. in any residential zoning district)? If yes, how many trees to be removed? e. Land clearing or grading? If yes, please state amount in cubic yards (c.y.): Excavation:	

Yes	No	Will the project involve:
,	X	a. Construction outside of the footprint of an existing, legal structure?
	X	b. Exterior construction within 100-feet of a stream?
	X	c. Construction, maintenance or use of a road, bridge, or trail on a stream bank or unstable hill slope?
	X	d. Land-use within a riparian area?
	X	e. Timber harvesting, mining, grazing or grading?
-	X	f. Any work inside of a stream, riparian corridor, or shoreline?
,	X	g. Release or capture of fish or commerce dealing with fish?
Pleas	e explaii	n any "Yes" answers:

Yes	No	Will the project involve:
	\ /	a. A subdivision or Commercial / Industrial Development that will result in the addition or replacement of 10,000 sq. ft. or more of impervious surface?
	X	If yes, Property Owner may be required to implement appropriate source control and site design measures and to design and implement stormwater treatment measures, to reduce the discharge of stormwater pollutants. Please consult the Current Planning Section for necessary forms and both construction and post-construction requirements.
	. /	b. Land disturbance of 1 acre or more of area?
	X	If yes, Property Owner must file a Notice of Intent (NOI) to be covered under the statewide General Construction Activities Storm Water Permit (General Permit) <u>prior</u> to the commencement of construction activity. Proof of coverage under State permit must be demonstrated prior to the issuance of a building permit.

I hereby certify that the statements furnished above and in the attached exhibits present the data and information required for this initial evaluation to the best of my ability, and the facts, statements and information presented are true and correct to the best of my knowledge and belief. If any of the facts represented here change, it is my responsibility to inform the County.

Signed:

(Applicant may sign)

Date:

Application for a Coastal Development Receiver

Companion Page

JUL 1 9 2018

455 County Center , 2nd Floor • Redwood City, CA 94063 Mail Drop: PLN 122 • TEL (650) 363-4161 • FAX (650) 363-4849

Applicant's Name	Pe	4	SQ.	CKORH	·
Primary Permit #:	PIN	2	11	8-00	270

িনিচ্ছিনিটের San Mateo County Planning and Building Department

KO/A-

i. Storage Tanks

Please fill out the general Planning Permit Application Form and this form when applying for a Coastal Development Permit. You must also submit all items indicated on the checklist found on the reverse side of the Planning Permit Application Form.

va:Estemor	mation —		
Does the owner or application listed?	es AKNO	Have you or anyone else previously County of San Mateo or the Californi for a Coastal Development Permit for at this location?	a Coastal Commission
If yes, list Assessor's Parcel	Number(s):	If yes, explain (include date and app	lication file numbers).
11 yes, 11se7 asessor 3 7 areer	rvarriser (3).		
	· · · · · · · · · · · · · · · · · · ·		
影周/日旬/日 野	近胃和四月三四胃牙心502000	Bandhige of Aurian	es :
Note: By completing this s	ection you do not need to file a sepa Material	rate application for Design Review A	Check if matches existing
a. Exterior Walls	SHAKERTON M. SHING	STES NATURAL	
b. Trim	PADIATA PINE	WHAE	_ 🗆
c. Roof	Compesition	Flack	_ 🗆
d. Chimneys	×4/A		🗆
e. Accessory Buildings	MALA	1	
f. Decks/Stairs	WOOD/INE/METAL	PAIL WHITE SEIRT	
g. Retaining Walls	RI/A	BLACK KAIL	_ 🗆
h. Fences	no/p		

The rest in the second of the				
Does this project, the parcel on which it is lo	cated or	p. Between the sea and the nearest public road?	Z <u>-</u> - ,	
	Yes	No	q. Existing or proposed provisions for public access to the stronglines	
a. Demolition of existing housing units?			r. Public or commercial recreation facilities?	
(If yes, give value of owner-occupied units or current monthly rent of rental			s. Visitor-serving facilities?	_ a
units in explanation below.)		,	t. Existing or proposed public trail	_
b. Creeks, streams, lakes or ponds?		,D	legisements places one colorest	
c. Wetlands (marshes, swamps, mudflats)?		Ø	_ /	ب
d. Beaches?		,d'	Explain all Yes answers below. Indicate whether the item applies to the project itself, the parcel on which it is	
e. Sand Dunes?		,d	located, or the immediate vicinity (attach additional shee	
f. Sea cliff, coastal bluffs or blufftops?		ĺØ′	necessary):	
g. Ridgetops?		ُٰٰ 📮	EVALUAD, Sease - LIATE	6 (E
-h_Pampas Grass,-invasive-brooms or			OVAZHEAD, Seaser - LeATER	2-0
Weedy Thistle?			underly source.	
i. Removal of trees or vegetation?				
j. Grading or alteration of landforms?				
k. Landscaping?		ø.		,
I. Signs?		ø		<u></u>
 m. Phone or utility line extensions or connections, either above or below ground (explain which)?)E	· ¯□		
n. Areas subject to flooding?		Ø		
o. Development on slopes 30% or steeper?		ø		
JESTILITE INV				
California Coastal Commission Ju	risdicti	ion	Commission; a public hearing is always required.	
A. Does the Proposed Project Involve:			B. Does the proposed project involve lands below the m	
A subdivision, Certificate of Compliance Type B, Use Permit, or Planned Agricultural District Permit?			high tide line and lands where the public trust may e (See "Post CCP Certification Permit and Appeal Jurisdic Map).	
☐ Yes ☐ No			☐ Yes ☐ No	
2. Construction or grading within 100 feet of a stream or wetland?				
☐ Yes ☐ No			Yes to above means that the California Coastal Commissi	
3. A parcel located between the sea and the first public through road paralleling the sea; 300 feet from the inland extent of any beach or mean high tide line if there is no beach; or within 300 feet of the top of the seaward face of			retains permit jurisdiction over all or part of the proposed project. A Coastal Development Permit from that agency required.	
a coastal bluff? ☐ Yes ☐ No		•	Reviewed by:	
Yes to any one of the above means that the				
Development Permit is appealable to the Co				

RIGITATE PROPERTY AND THE PROPERTY OF THE PROP

Application for a Zoning Noncon格氏原以ED **Use Permit**

JUL 1 9 2018

455 County Center, 2nd Floor, Redwood City, CA 94063 Mail Drop: PLN 122 • TEL (650) 363-4161 • FAX (650) 363-4849

Applicant's Name:

Primary Permit #:

Companion Page San Maleo County

Building Department

Please fill out the general Planning Permit Application Form and this form when applying for a Zoning Nonconformity Use Permit. You must also submit all items indicated on the checklist found on the reverse side of the Planning Permit Application Form, and, if applicable, a copy of a building permit or Assessor's records indicating that your nonconforming structure was built legally.

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This application is for:

- Expansion of a legal, nonconforming structure on a standard-sized parcel.
- Expansion of a legal, nonconforming structure on a substandard parcel.
- New nonconforming structure on a substandard parcel.
- New conforming structure on a substandard parcel per Zoning Regulations Section 6133.3(b).

Existing nonconformity: 3+5 FT. (Examples: 3 ft. side setback, 40% lot coverage)

3263 Parcel size:

Proposed nonconformity: GATAGE DEPTA W/ WASHEL/DRYEL-

To approve this application, the County must determine that this project complies with all applicable regulations including the following specifically required finding:

1. That the establishment, maintenance and/or conducting of the use will not, under the circumstances of the particular case, be detrimental to the public welfare or injurious to property or improvements in the neighborhood.

The County must make four additional findings for projects involving substandard parcels:

- 2. The proposed development is proportioned to the size of the parcel on which it is being built.
- , 3. All opportunities to acquire additional contiguous land have been investigated.
- 4. The proposed development is as nearly in conformance with the zoning regulations currently in effect as is reasonably possible.
- 5. Use permit approval does not constitute a granting of special privileges,

Write a brief statement in which you present evidence to support the required findings.

LOME 20_apps\22055.vp rp 8/12/09

OWNER/DEVELOPER DRAWING NOTE

TYPICAL OWNER/DEVELOPER BUILDING PERMIT SET OF DRAWINGS:

THESE DRAWINGS ARE INTENDED FOR BUILDING PERMIT APPROVAL AND ARE NOT INTENDED TO BE A COMPREHENSIVE SET OF DRAWINGS INDICATING SPECIFIC CABINETRY; PAINT COLORS; SPECIFIC PLUMBING FIXTURES; LIGHTING FIXTURES; INTERIOR FINISHES; DOOR 8 WINDOW HARDWARE; INTERIOR & EXTERIOR DETAILS OR FINISH CARPENTRY (STAIR RAILS, ETC.) OWNER/DEVELOPER IS RESPONSIBLE FOR THE SELECTION OF THESE ITEMS AND CLARIFICATION AND COORDINATION OF THESE WITH THE CONTRACTOR AS PART OF THE BUILDING CONTRACT AND CONSTRUCTION PROCESS. ADDITIONAL DETAILS, DRAWINGS AND COORDINATION MAY BE PROVIDED BY THE DESIGNER AS AN ADDITIONAL SERVICE AND BE CONSIDERED AN ADDENDUM TO THE BUILDING PERMIT SET OF DRAWINGS IF REQUESTED

2016 California Fire Code and Public Resources Code 4291.


Area) the fuel break is 100 feet or to the property line.

the outlet of a chimney or stovepipe or is within 5 ket of any structure.


NEW RESIDENCE

0 Vue De Mer Ave, Moss Beach, CA 94038 APN: 037-155-080

APPROACH APPLIED

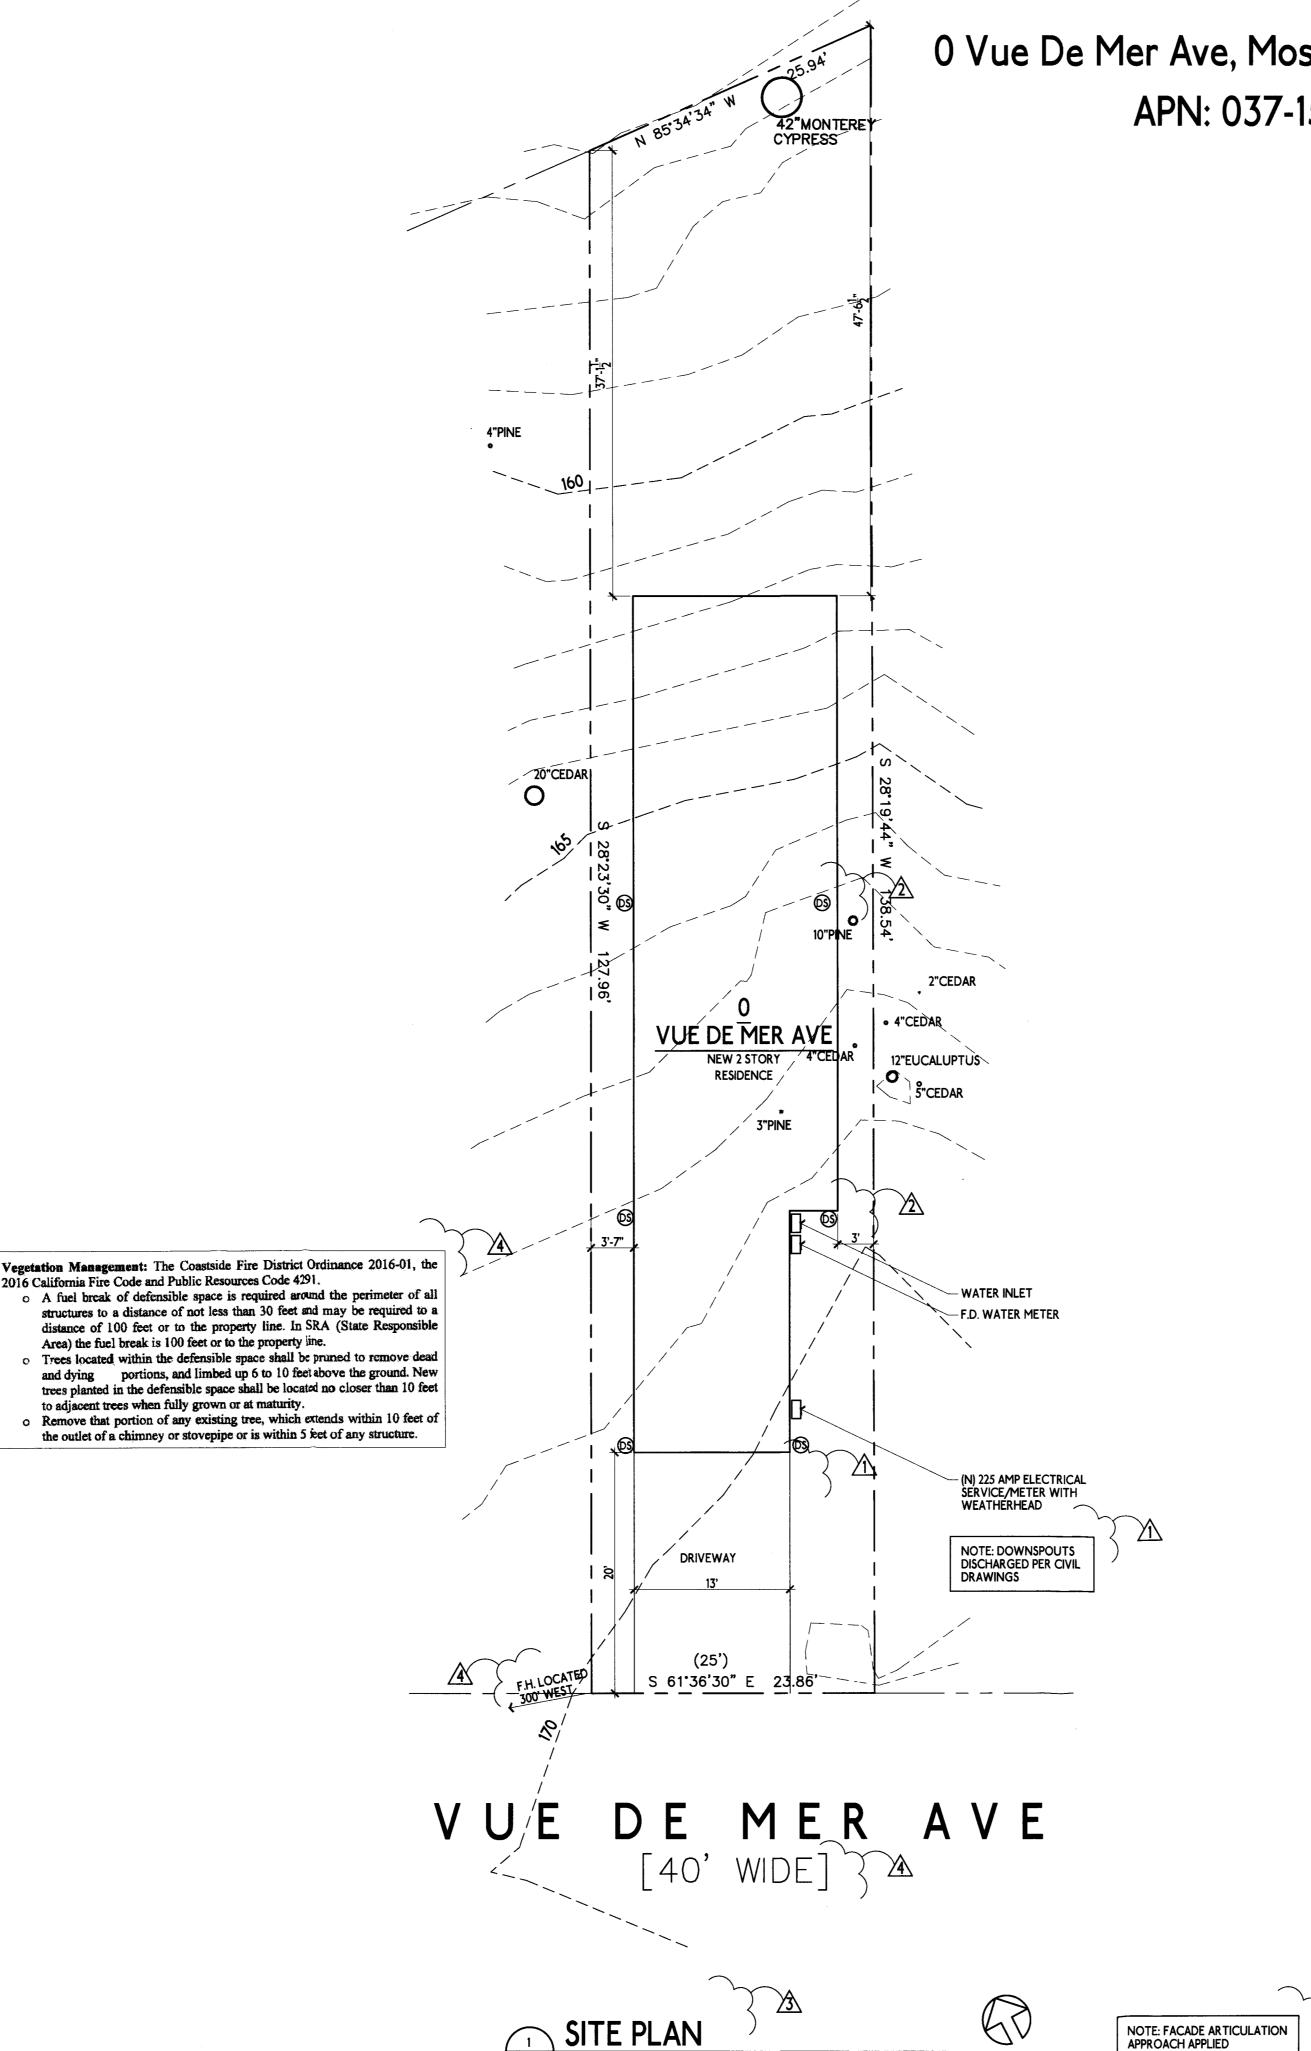


VICINITY MAP

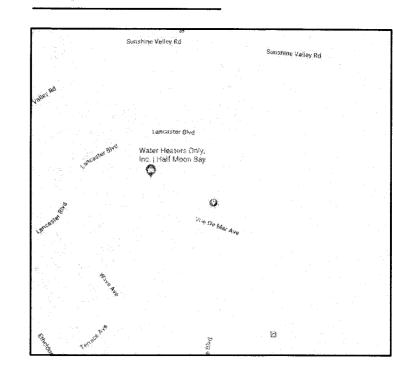

Leila Mashhoodi Design & Development

945 Brentwood Ave Vallejo, CA 94591 (925) 658-2116

SYMBOL LEGEND

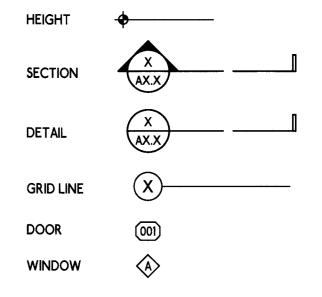

GENERAL NOTES

- REVIEW ALL DOCUMENTS AND VERIFY ALL DIMENSIONS AND FIELD CONDITIONS AND CONFIRM THAT ALL WORK IS BUILDABLE AS SHOWN. ANY CONFLICTS OR OMISSIONS SHALL BE IMMEDIATELY REPORTED TO THE DESIGNER OF RECORD FOR WRITTEN CLARIFICATION PRIOR TO PROCEEDING WITH ASSOCIATED WORK.
- 2. IN CASE OF CONFLICT BETWEEN ARCHITECTURAL AND ENGINEERING DOCUMENTS, THE ARCHITECTURAL DOCUMENTS SHALL GOVERN FOR LOCATIONAL PURPOSES. INFORM THE DESIGNER OF RECORD IN WRITING OF ALL DISCREPANCIES.
- 3. ALL WORK SHALL BE PERFORMED IN ACCORDANCE WITH ALL APPLICABLE CODES STATUTES AND REGULATIONS HAVING JURISDICTION OVER THE BUILDING SITE.
- 4. SECURE AND CONTROL ACCESS TO THE SITE AND ALL AREAS OF CONSTRUCTION AND ENFORCE ALL REQUIRED RULES OF SAFETY. 5. THESE DOCUMENTS ARE COMPLIMENTARY, WHAT IS SHOWN OR REFERRED TO ON ANY DRAWING SHALL BE PROVIDED AS IF SHOWN ON
- 6. THOSE MATERIALS IN THESE DOCUMENTS WHICH ARE SPECIFIED BY BRAND NAME ARE TO ESTABLISH STANDARDS OF QUALITY AND PERFORMANCE. ALL REQUESTS FOR SUBSTITUTION SHALL BE SUBMITTED FOR DESIGNER APPROVAL AND SUCH SUBMISSIONS SHALI
- NOT BE A CAUSE FOR DELAY OF THE PROJECT. 7. MAINTAIN A COMPLETE AND CURRENT SET OF ALL CONSTRUCTION DOCUMENTS, SUBMITTALS, AND CLARIFICATIONS ON THE JOBSITE AT
- 8. ALL DIMENSIONS ARE GIVEN TO FACE OF STUD UNLESS OTHERWISE NOTED. ELEVATION OF FLOOR DECK AND ROOF LEVELS ARE GIVEN TO FINISH FLOOR U.O.N. ALLOW 3/4" THICKNESS FOR FLOOR FINISH MATERIAL, TYPICAL.
- 9. ALL WORK SHOWN ON THE DRAWINGS IS NEW UNLESS OTHERWISE

CODE COMPLIANCE

- 2016 CALIFORNIA BUILDING CODE (CBC)
- 2016 CALIFORNIA RESIDENTIAL CODE (CRC) 2016 CALIFORNIA ENERGY CODE (CBEES)
- 2016 CALIFORNIA GREEN BUILDING STANDARDS CODE (CALGreen)
- 2016 CALIFORNIA ELECTRICAL CODE (CEC)
- 2016 CALIFORNIA PLUMBING CODE (CPC) 2016 CALIFORNIA MECHANICAL CODE (CMC)
- 2016 CALIFORNIA FIRE CODE (CFC)

PROJECT INFORMATION

ZONING: S-17 LOT SIZE: 3,363 SF

CONSTRUCTION: TYPE 5 UNPROTECTED WOOD FRAME BUILDING OCCUPANCY: SINGLE FAMILY RESIDENCE

BUILDING TO BE PROTECTED BY AUTOMATIC FIRE SPRINKLER SYSTEM PROPOSED HOUSE: 1,257 SF + 260 SF GARAGE +48 SF DECK FOOTPRINT: 1,127 SF PARCEL COVERAGE AREA MAX: 1,177 SF (35%) PARCEL COVERAGE AREA PROPOSED: 1,175 SF (34.9%) BUILDING FLOOR AREA MAX: 1,614 SF (48%)

DESCRIPTION OF WORK

BUILDING FLOOR AREA PROPOSED: 1,565 SF (46.5%)

NEW 1,288 SF TWO STORY HOUSE WITH 1-CAR GARAGE.

RECEIVED SHEET INDEX

NOV 2 9 2018

San Mateo County Planning Division

A1.0 SITE PLAN

- A1.1 GRAPHIC CALCULATIONS
- A2.0 FLOOR PLANS & ROOF PLAN A3.0 ELEVATIONS
- A4.0 SECTION, MATERIALS, & WINDOW/DOOR SCHEDULE A5.0 TITLE 24 PART 1
- A5.1 TITLE 24 PART 2

PLN2018-00270

NEW RESIDENCE

PROJECT ADDRESS: 0 Vue De Mer Ave Moss Beach, CA 94038

> OWNER: Emily Humphreys (434) 249-1908

PROJECT INFORMATION & SITE PLAN

REVISION No. Description 1 PLAN CHECK PLAN CHECK PLANNING 4 PLANNING 11/5/18 5 PLANNING

PROJECT No. DRAWN BY: CHECKED BY:

PROPOSED FLOOR AREA RATIO


LOT SIZE


3,363 SF


2ND FLOOR 390 SF

1ST FLOOR 867 SF

TOTAL 1,257 SF = 37.3%

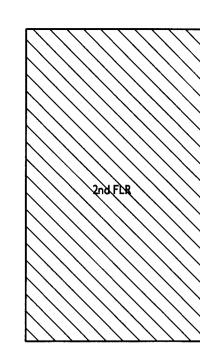

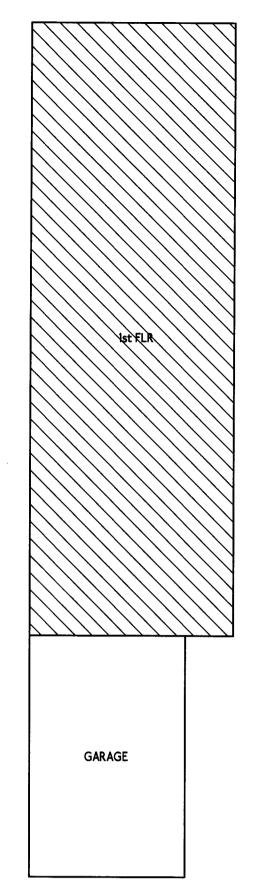

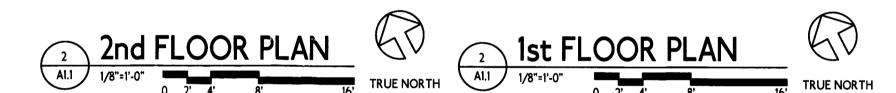

LOT COVERAGE

LOT SIZE 3,363 SF

PROPOSED STRUCTURE

1st FLOOR 867 SF DECK 48 SE

DECK 48 SF GARAGE 260 SF

TOTAL 1,175 SF = 34.9%

LOT COVERAGE SITE PLAN

1/8"=1'-0"

Leila Mashhoodi Design & Development 945 Brentwood Ave Vallejo, CA 94591 (925) 658-2116

NEW RESIDENCE

PROJECT ADDRESS: 0 Vue De Mer Ave Moss Beach, CA 94038

OWNER: Emily Humphreys (434) 249-1908

GRAPHIC CALCULATIONS

REVISION

No. Description Date

PLAN CHECK 7/1/18

PLAN CHECK 7/18/18

PLANNING 8/13/18

PLANNING 11/5/18

PLANNING 11/18/18

PROJECT No.:

DRAWN BY: LP

CHECKED BY: LP

DATE: 11/18/

A1.1

NOTES:

SMOKE ALARM/DETECTOR TO BE HARD WIRED, INTERCONNECTED, OR WITH BATTERY BACK-UP. SMOKE ALARMS TO BE INSTALLED PER MANUFACTURERS INSTRUCTIONS AND NFPA 72

Add note: Escape or rescue windows shall have a minimum net clear openable area of 5.7 square feet, 5.0 sq. ft. allowed at grade. The minimum net clear openable height dimension shall be 24 inches. The net clear openable width dimension shall be 20 inches. Finished sill height shall be not more than 44 inches above the finished floor.

Occupancy Separation: As per the 2016 CBC, Section 406.1.4, a one-hour occupancy separation wall shall be installed with a solid core, 20-minute fire rated, self-closing door assembly w/ smoke gasket between the garage and the residence. All electrical boxes installed in rated walls shall be metal or protected.

Occupancy Separation: As per the 2016 CBC, Section 406.1.4, a one-hour occupancy separation wall shall be installed with a solid core, 20-minute fire rated, self-closing door assembly w/ smoke gasket between the garage and the residence. All electrical boxes installed in rated walls shall be metal or protected.

STORAGE UNDER STAIRS: Provide 5/8" type X gyp bd under stairs at storage area typ.

Add the following note to the plans: New residential buildings shall have internally illuminated address numbers contrasting with the background so as to be seen from the public way fronting the building. Residential address numbers shall be at least six feet above the finished surface of the driveway. Where buildings are located remotely to the public roadway, additional signage at the driveway/roadway entrance leading to the building and/or on each individual building shall be required by the Coastside Fire District. This remote signage shall consist of a 6 inch by 18 inch green reflective metal sign with 3 inch reflective Numbers/ Letters similar to Hy-Ko 911 or equivalent.

Automatic Fire Sprinkler System: As per San Mateo County Building Standards and Coastside Fire District Ordinance Number 2016-01, the applicant is required to install an automatic fire sprinkler system throughout the proposed or improved dwelling and garage. All attic access locations will be provided with a pilot head on a metal upright. All areas that are accessible for storage purposes shall be equipped with fire sprinklers including closets and bathrooms. The only exception is small linen closets less than 24 square feet with full depth shelving. The plans for this system must be submitted to the San Mateo County Planning and Building Division or The City of HMB. A building permit will not be issued until plans are received, reviewed and approved. Upon submission of plans, the County or City will forward a complete set to the Coastside Fire District for review. The fee schedule for automatic fire sprinkler systems shall be in accordance with Half Moon Bay Ordinance No. 2006-01. Fees shall be paid prior to plan review.

Installation of underground sprinkler pipe shall be flushed and visually inspected by Fire District prior to hook-up to riser. Any soldered fittings must be pressure tested with trench open.

Exterior bell and interior horn/strobe: are required to be wired into the required flow switch on your fire sprinkler system. The bell, horn/strobe and flow switch, along with the garage door opener are to be wired into a separate circuit breaker at the main electrical panel and labeled.

Roofs and roof edges. CBC 705A / CRC R337.5

A noncombustible (tile or metal) or Class 'A' roofing assembly is required in SRA - Very High Fire Hazard Severity Zones. All other areas in Santa Cruz County require a Class 'B' minimum roofing assembly, including LRA, SRA-Moderate or SRA-High areas.

Where the roof profile allows a space between the roof covering and the roof decking, the spaces shall: be constructed to prevent the intrusion of flames and embers; be firestopped with approved materials; or have one layer of No. 72 cap sheet installed over the combustible decking.

Where provided, valley flashing must be not less than 26 gauge galvanized sheet metal over a 36-inch wide No. 72 ASTM cap sheet.

Exterior Walls/siding. CBC 707A.3 /CRC R337.7.3

Noncombustible, listed ignition-resistant materials, heavy timber, 5/8" Type X gypsum sheathing behind exterior covering, exterior portion of 1-hr assembly or log wall construction is allowed. The OSFM website (see link above) lists many types of exterior wall coverings that are approved.

Note: Ignition-resistant materials are those tested by a facility recognized by the SFM or ICC-Evaluation Service to have a flame-spread rating not over 25, and comply with accelerated weathering tests.

Eaves and porch ceilings CBC 707A.4, A.6 / CRC 337.7.4. R337.7.6

The exposed roof deck under unenclosed eaves and underside of porch ceilings shall be noncombustible, listed ignition-resistant materials, or 5/8" Type X gypsum sheathing behind exterior covering.

Solid wood rafter tails on the exposed underside of roof eaves having a minimum 2" nominal dimension may be unprotected.

Vents. CBC 706A / CRC R337.6

Attic vents and underfloor vent openings must resist the intrusion of flame and embers or shall be a minimum of 1/16" and maximum 1/8" corrosion-resistant, noncombustible wire mesh or equivalent. Combustible vents on top of roofs may be covered with this material to comply. Ventilation openings on the underside of eaves are not permitted, unless a SFM approved vent is installed, or eaves are fire sprinklered, or vent is 12 feet above a walking surface or grade below.

Windows and exterior doors. CBC 708A / CRC R337.8

Windows must be insulated glass with a minimum of 1 tempered pane or 20 min rated or glass block.

Exterior doors must be noncombustible or ignition resistant material or 1 3/8" solid core, or have a 20 min fireresistance rating.


Exterior decking and stairs. CBC 709A / CRC R337.9

Walking surfaces of decks, porches, balconies and stairs within 10 feet of the building must be constructed of noncombustible, fire-retardant treated or heavy-timber construction. Alternate materials can be used of they are ignition-resistant and pass performance requirements specified by the State Fire Marshal.

Underfloor and appendages. CBC 797A.8 / CRC R337.7.8

Exposed underfloors, underside of cantilevered and overhanging decks, balconies and similar appendages shall be non-combustible, ignition resistant, 5/8" Type X gypsum sheathing behind exterior covering, exterior portion of 1-hr assembly, meet performance criteria SFM Standard 12-7A-3 or be enclosed to grade.

WINDOWS TO BE TUSCANY SERIES WITH TEMPERED PANE - 20 MINUTE RATED EXTERIOR DOORS-20 MINUTE RATED ALL VENTS-VULCAN FIRE RATED FOR FOUNDATION AND EAVE VENTS

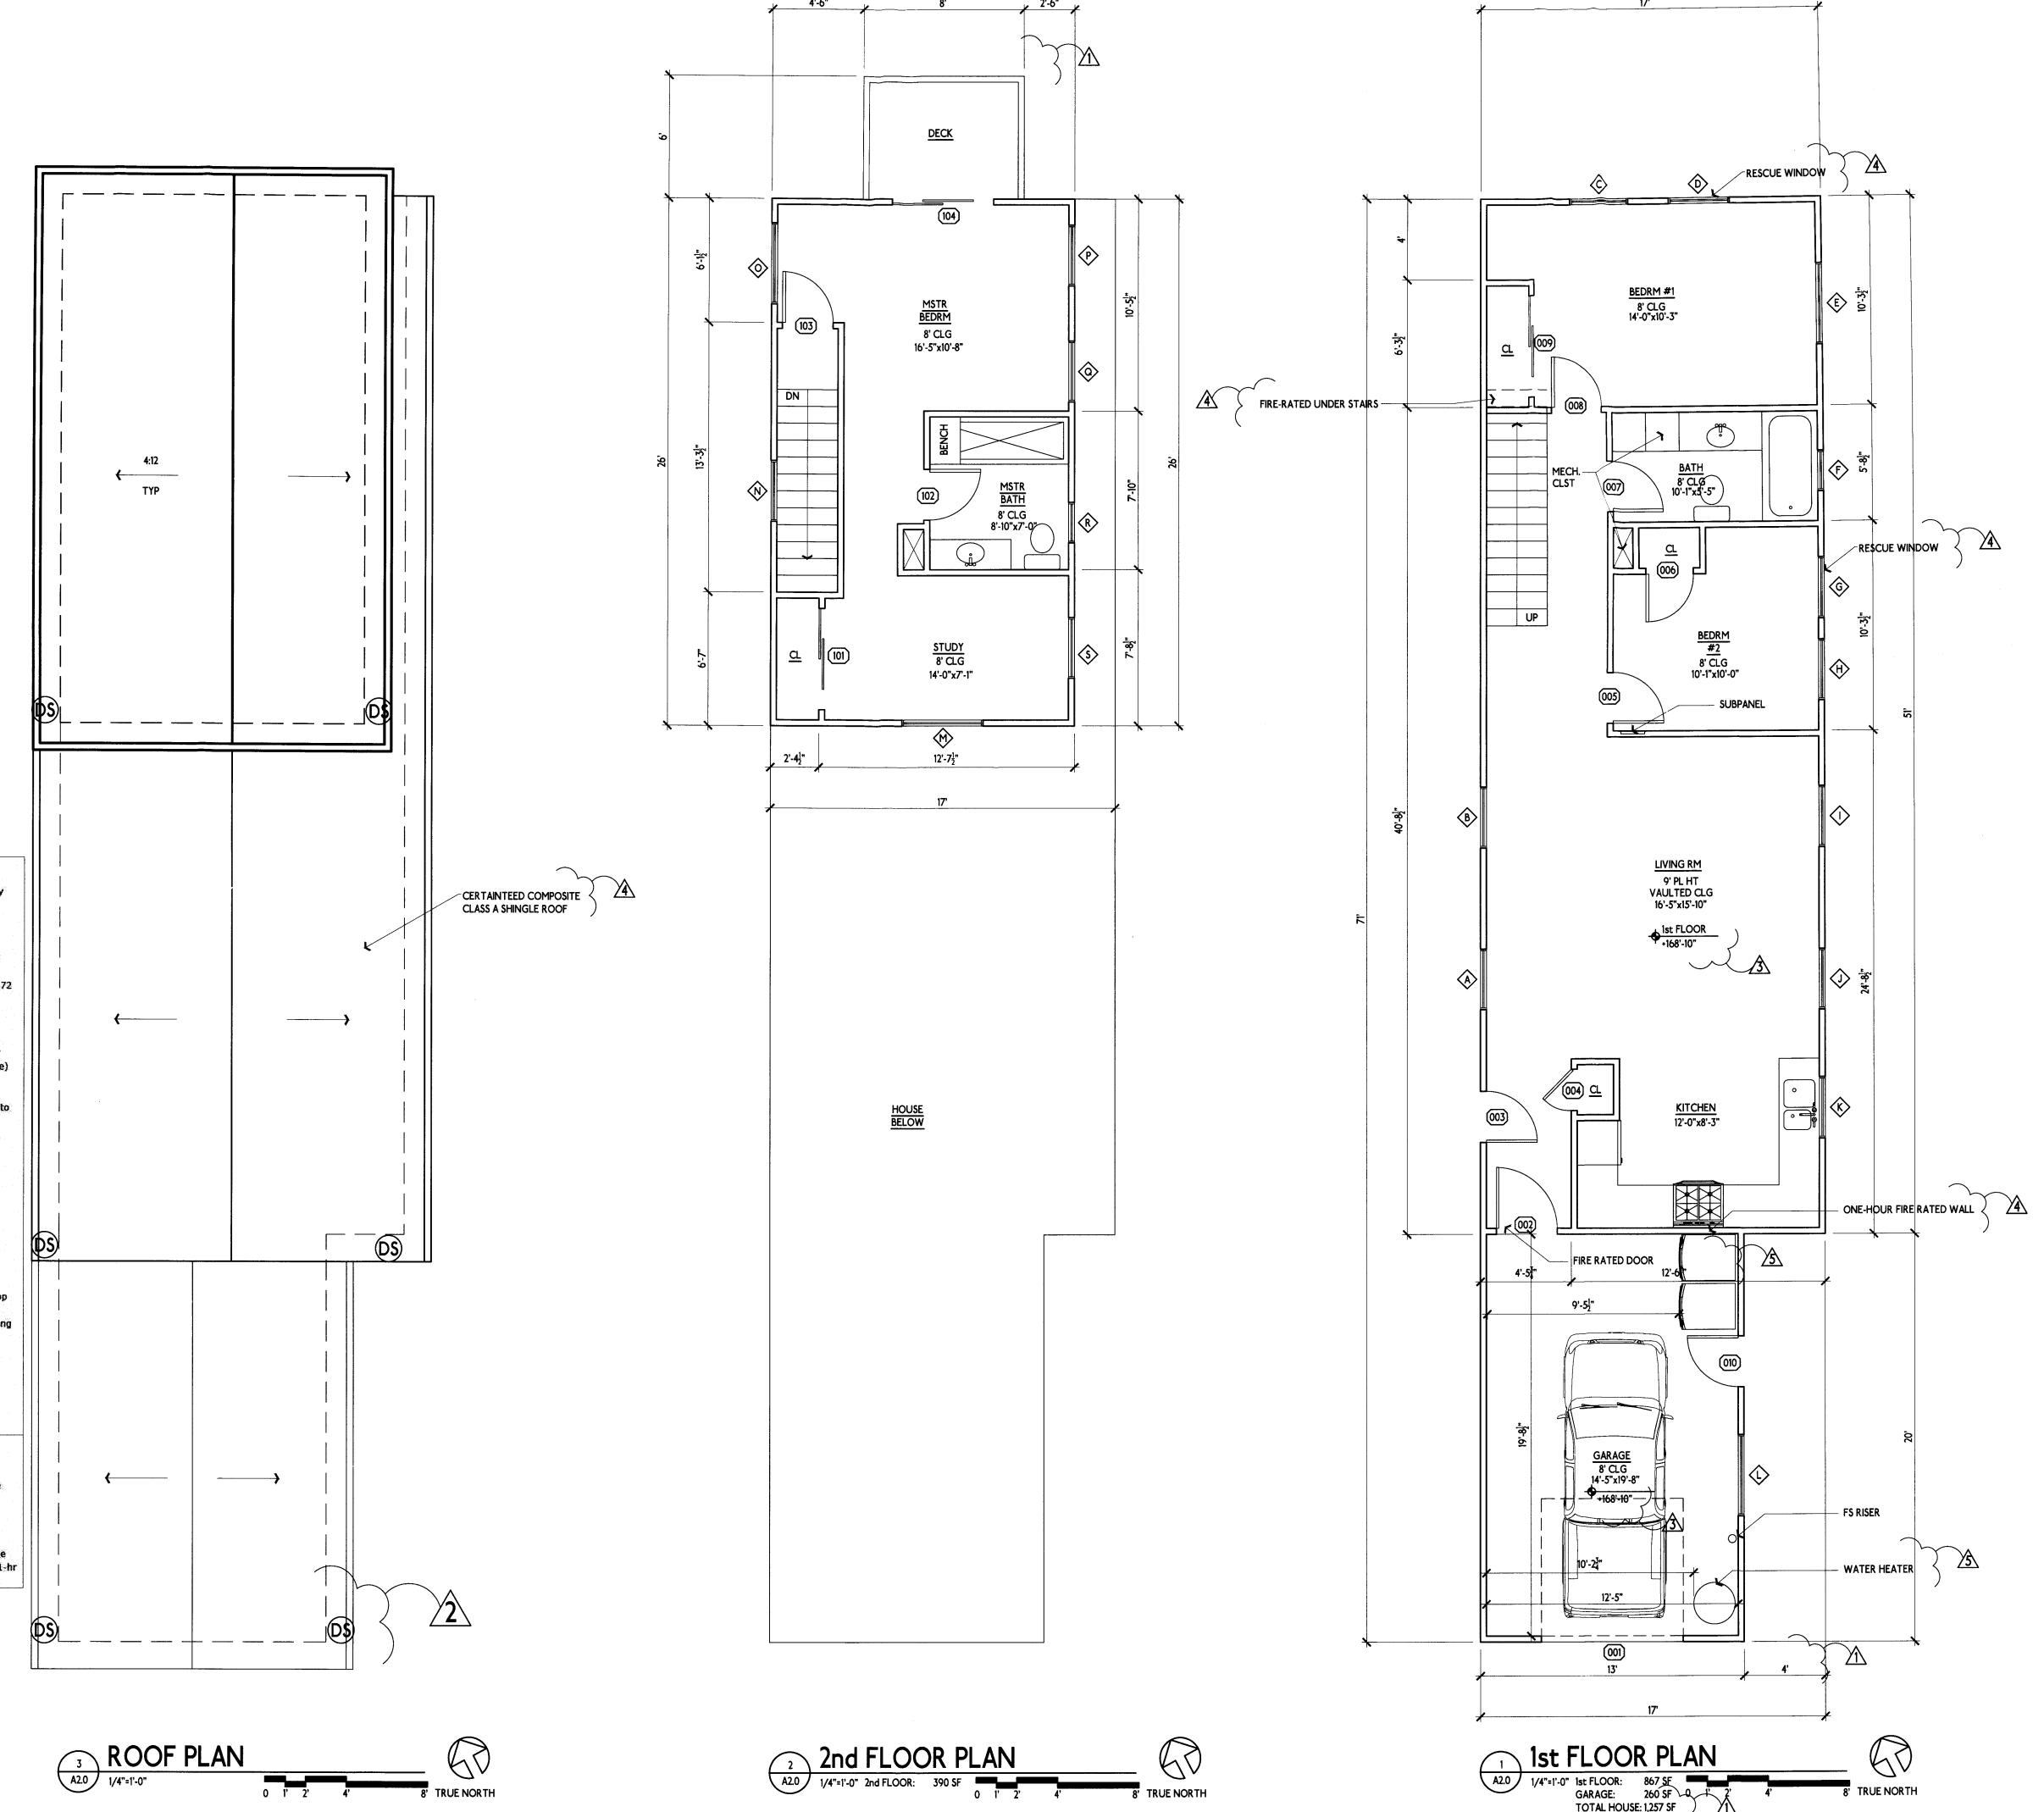

Leila Mashhoodi
Design & Development

945 Brentwood Ave Vallejo, CA 94591 (925) 658-2116

NEW RESIDENCE

PROJECT ADDRESS: 0 Vue De Mer Ave Moss Beach, CA 94038

OWNER: Emily Humphreys (434) 249-1908

FLOOR PLANS & ROOF PLAN

R	EVISI	0 N
No.	Description	Date
\triangle	PLAN CHECK	7/1/18
<u>^</u>	PLAN CHECK	7/18/18
<u>\$</u>	PLANNING	8/13/18
4	PLANNING	11/5/18
<u>\$</u>	PLANNING	11/18/18
		1

PROJECT No. :


DRAWN BY: LPM

CHECKED BY: LPM

DATE: 11/18/18

A2.0



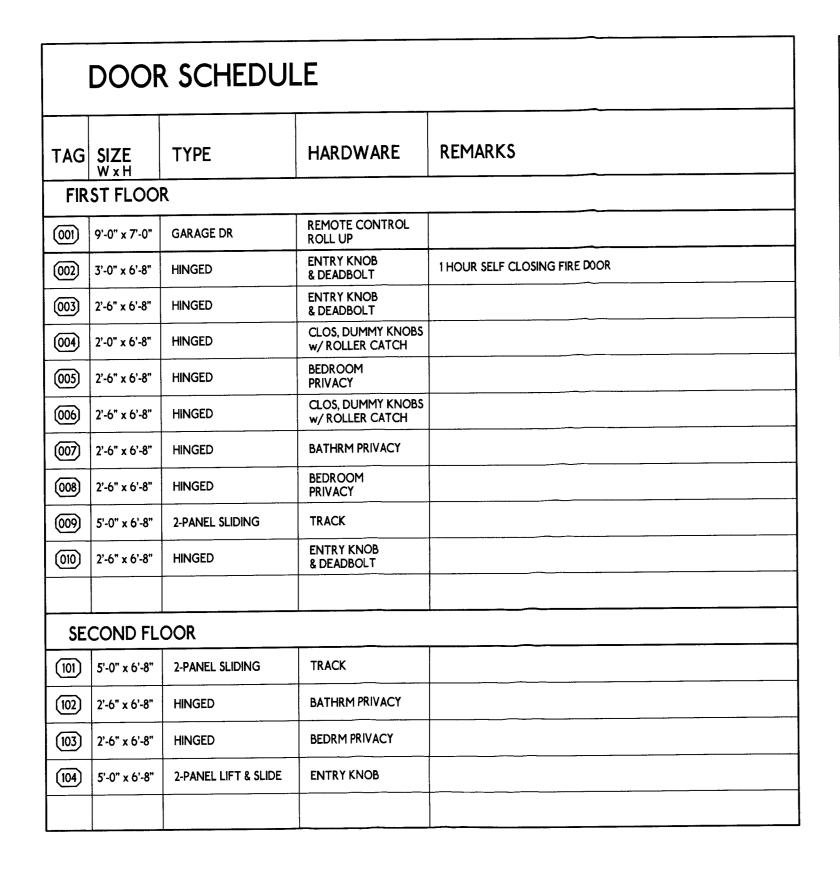

AG		HD. HT.	TYPE	REMARKS
Â	3'-0"x5'-0"	7'-0"	SINGLE HUNG	
<u>\$</u>	3'-0"x5'-0"	7'-0"	SINGLE HUNG	
\$ \$	3'-0"x5'-0"	7'-0"	SINGLE HUNG	EGRESS WINDOW
<u> </u>	3'-0"x5'-0"	7'-0"	SINGLE HUNG	
É E	4'-0"x2'-0"	7'-0"	SLIDER	
Ē)	2'-0"x3'-0"	7'-0"	SLIDER	
Ĝ>	3'-0"x5'-0"	7'-0"	SINGLE HUNG	EGRESS WINDOW
Ĥ>	3'-0"x5'-0"	7'-0"	SINGLE HUNG	
\bigcirc	3'-0"x5'-0"	7'-0"	SINGLE HUNG	
ŷ	3'-0"x5'-0"	7'-0"	SINGLE HUNG	
ķ>	3'-0"x3'-0"	7'-0"	SINGLE HUNG	
<u>\$</u>	4'-0"x3'-0"	7'-0"	SLIDER	
Ŷ)	4'-0"x2'-0"	7'-0"	SLIDER	
ŷ	3'-0"x5'-0"	7'-0"	SINGLE HUNG	
§	4'-0"x2'-0"	7'-0"	SLIDER	
P	3'-0"x5'-0"	7'-0"	SINGLE HUNG	
<u></u>	3'-0"x5'-0"	7'-0"	SINGLE HUNG	
R >	2'-0"x3'-0"	7'-0"	SINGLE HUNG	
\$	3'-0"x5'-0"	7'-0"	SINGLE HUNG	

Design & Development

945 Brentwood Ave

Leila Mashhoodi

945 Brentwood Ave Vallejo, CA 94591 (925) 658-2116

NEW RESIDENCE

TYPICAL MATERIALS:

SIDING: SHINGLE SIDING

ROOF: CLASS A ASPHALT COMPOSITION SHINGLE ROOF

WINDOWS: DUAL-PANE LOW-E VINYL, PAINTED WOOD CASING/SILL, TYP

DOORS: WOOD CLAD SLIDER AND FIBERBLASS

PROJECT ADDRESS: 0 Vue De Mer Ave Moss Beach, CA 94038

> *OWNER:* Emily Humphreys (434) 249-1908

SECTION & MATERIALS

REVISION

No. Description Date

PLAN CHECK 7/1/18

PLAN CHECK 7/18/18

PLANNING 8/13/18


PROJECT No. :

 DRAWN BY:
 LI

 CHECKED BY:
 LI

 DATE:
 8/13

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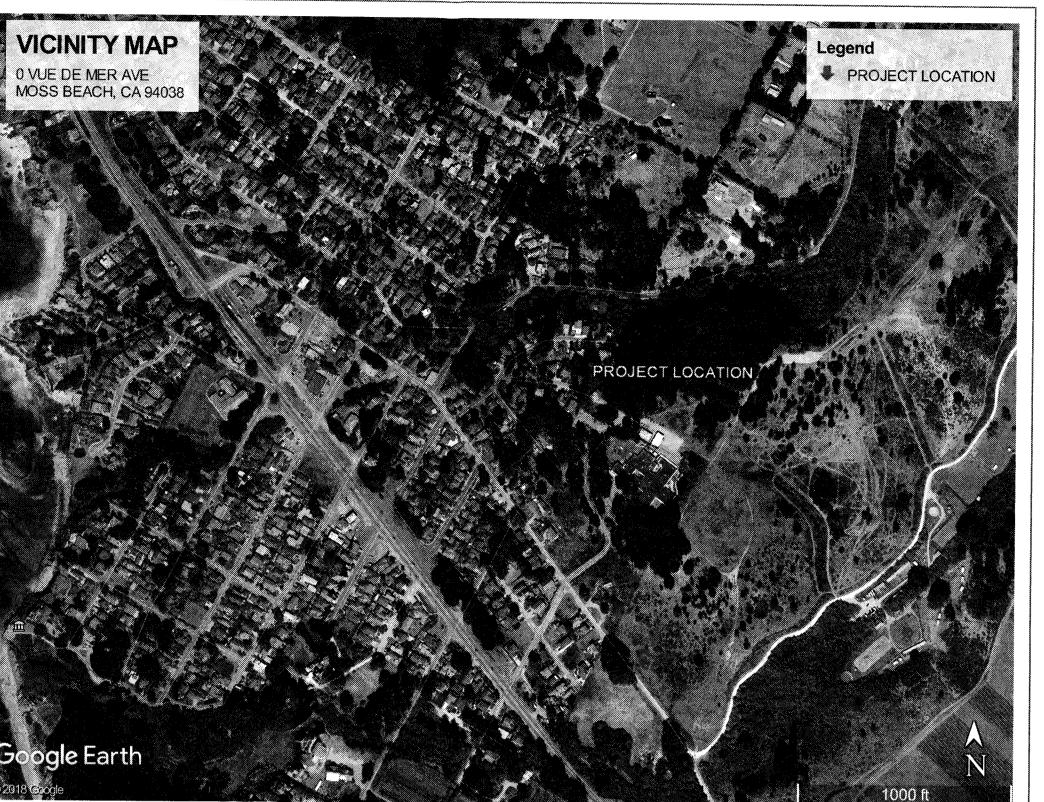
GENERAL NOTES TO CONTRACTOR

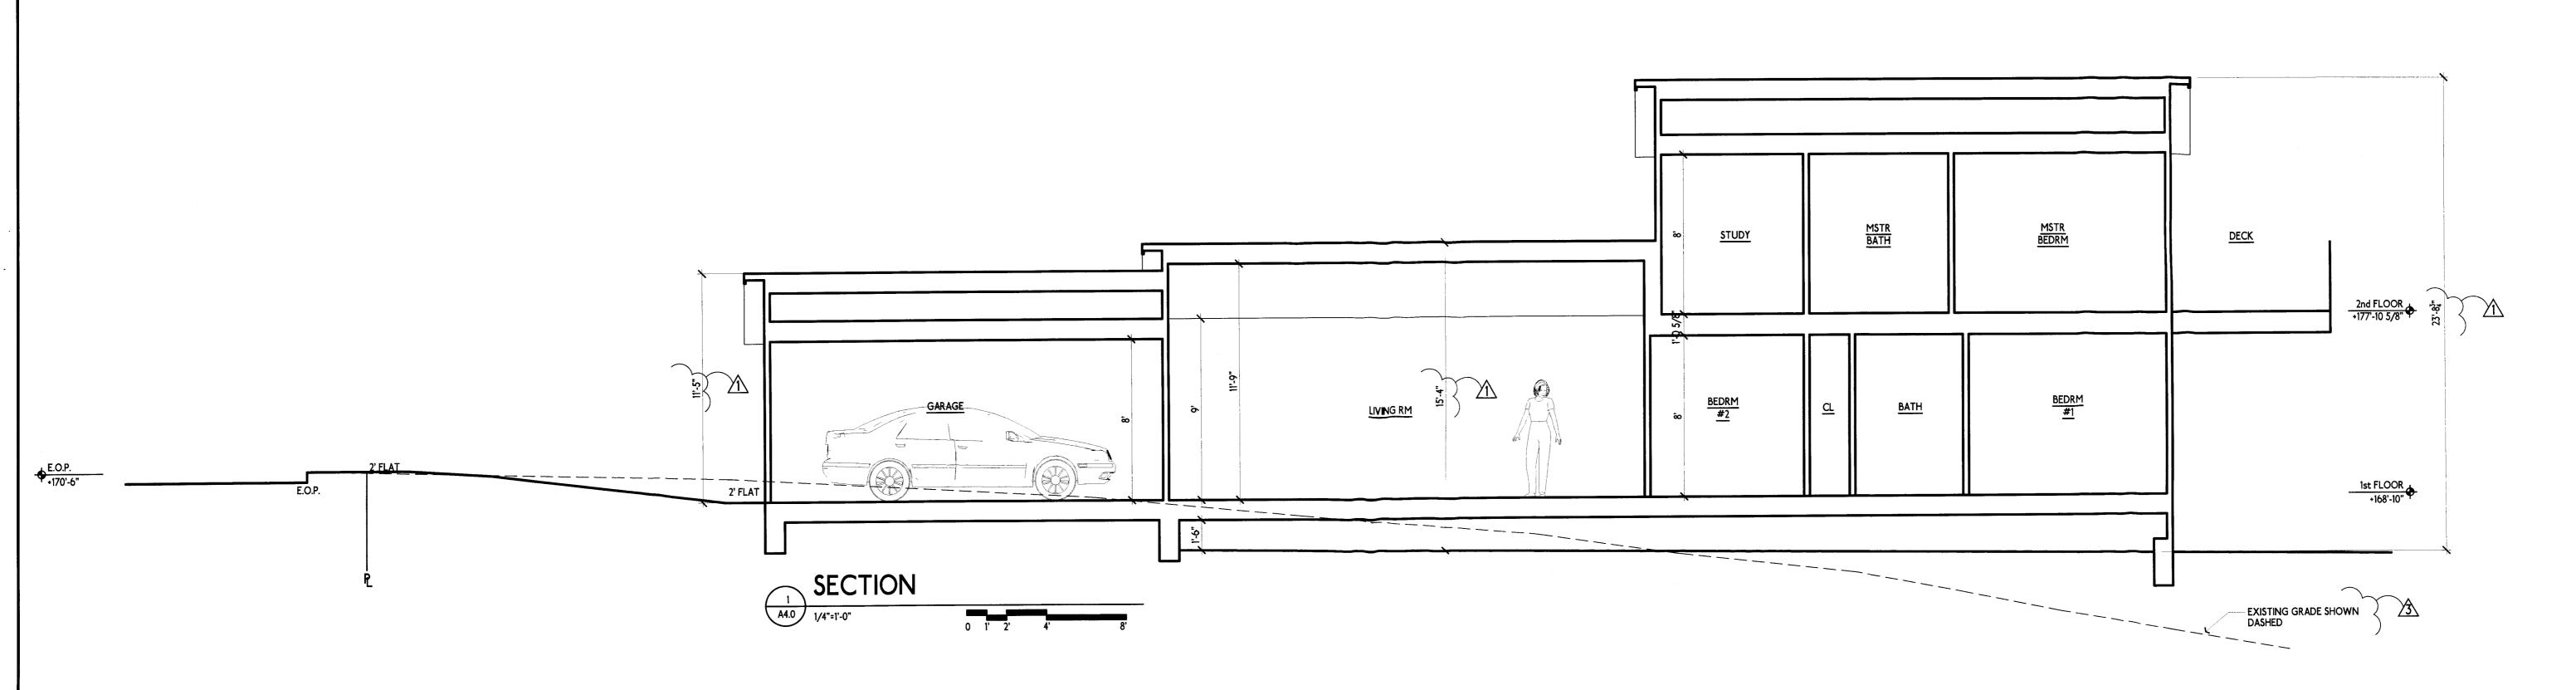- NOTES ARE APPLICABLE TO ALL "C" SERIES DRAWINGS
- CONTRACTOR SHALL FIELD VERIFY ELEVATIONS AND LOCATIONS OF ALL EXISTING UTILITIES PRIOR TO START OF CONSTRUCTION. CONTRACTOR SHALL NOTIFY ENGINEER OF ANY DISCREPANCIES WITH PROJECT SURVEY PROVIDED BY SAVIOR P. MICALLEF LAND SURVEYING.
- CONTRACTOR SHALL VERIFY ALL DIMENSIONS, CONDITIONS, AND QUANTITIES AFFECTING THE WORK AT THE JOB SITE.
- CONTRACTOR IS RESPONSIBLE FOR PROJECTING FROM DAMAGE ALL EXISTING SITE FEATURES AND
- ANY WORK IN THE PUBLIC RIGHT OF WAY SHALL CONFORM TO COUNTY OF SAN MATEO STANDARDS.
- ANY QUANTITIES SHOWN ARE APPROXIMATE AND SHALL BE THE RESPONSIBILITY OF THE
- CONSTRUCTION CONTRACTOR TO VERIFY. ALL REFERENCED STANDARDS OR CODES SHALL BE OF LATEST EDITION UNLESS NOTED OTHERWISE.
- ALL DETAILS, SECTIONS, AND NOTES SHOWN ON DRAWINGS ARE INTENDED TO BE TYPICAL AND SHALL APPLY TO SIMILAR SITUATIONS ELSEWHERE, UNLESS NOTED OTHERWISE.
- THE CONTRACTOR SHALL NOTIFY THE OWNER A MINIMUM OF 24 HOURS BEFORE COMMENCING WORK WHICH REQUIRES INSPECTION. INSPECTION SHALL BE PER THE LATEST VERSION OF THE CBC.
- ALL OMISSIONS OR CONFLICTS BETWEEN INFORMATION SHOWN ON THE DRAWINGS AND/OR THE SPECIFICATIONS SHALL BE BROUGHT TO THE ATTENTION OF THE OWNER BEFORE PROCEEDING WITH THE WORK INVOLVED. SPECIFICATION REQUIREMENTS SHALL GOVERN UNTIL THE OMISSION OR CONFLICT IS RESOLVED
- THE CONTRACTOR SHALL PROVIDE PROTECTIVE MEASURES FOR SAFETY OF PERSONS IN ACCORDANCE WITH GOVERNING CODES AND OSHA.
- WHERE CONFLICTS BETWEEN PLANS, SPECIFICATIONS, OR CODES OCCUR, THE MOST STRINGENT REQUIREMENTS SHALL CONTROL.
- THE CONTRACTOR SHALL COMPLY WITH THE PROJECT STORMWATER POLLUTION PREVENTION PLAN
- CONTRACTOR SHALL PROVIDE AS-BUILT DRAWING(S) TO THE CIVIL ENGINEER AT COMPLETION OF CONSTRUCTION PRIOR TO DEMOBILIZATION. AS-BUILT DRAWING(S) SHALL BE CLEARLY AND NEATLY REDLINED WITH ALL CHANGERS MADE, SIGNED, AND DATED.

GRADING NOTES

8/1/2018 11:37 PM

- NOTES APPLICABLE TO ALL "C"SERIES DRAWINGS
- ALL GRADING SHALL BE DONE IN ACCORDANCE WITH THE RECOMMENDATIONS OF THE PROJECT GEOTECHNICAL EVALUATIONS PROVIDED BY MOORE TWINING ASSOCIATES, DATED JULY 16, 2018.
- AREAS TO BE GRADED SHALL BE CLEARED OF ALL VEGETATION, INCLUDING ROOTS AND OTHER MATERIAL UNSUITABLE FOR STRUCTURAL FILL, AND SCARIFIED TO A MINIMUM DEPTH OF 12".
- NO CHANGES TO THE PROPOSED SOIL COVER SHALL BE COMPLETED WITHOUT APPROVAL FROM THE ENGINEER OF RECORD. AN UPDATE TO THE HYDROLOGY REPORT WILL BE REQUIRED.
- FILL MATERIAL, APPROVED BY THE SUPERVISING SOILS ENGINEER, SHALL BE PLACED IN LIFTS NOT EXCEEDING 8" IN COMPACTED THICKNESS, MOISTENED OR DRIED AS NECESSARY TO NEAR OPTIMUM MOISTURE CONTENT, AND COMPACTED BY AN APPROVED METHOD.
- FILL MATERIAL SHALL BE COMPACTED TO MINIMUM OF 90% OF MAXIMUM DENSITY AS DETERMINED BY ASTM D-1557-78. SOILS TEST SHALL BE CONDUCTED AT NOT LESS THAN ONE TEST FOR EACH 18" OF FILL AND FOR EACH 500 CY OF FILL.
- GRADE SHALL SLOPE UNIFORMLY BETWEEN FINISH SPOT ELEVATIONS AND CONTOURS SHOWN ON THE PLANS.
- A SMOOTH VERTICAL TRANSITION SHALL BE PROVIDED AT ROAD INTERSECTIONS.
- SLOPE SHALL BE 2H:1V OR FLATTER, UNLESS NOTED OTHERWISE.
- THE CONTRACTOR IS RESPONSIBLE FOR TYING FINISHED CONTOURS INTO EXISTING CONTOURS IN AREAS WHERE THERE IS INSUFFICIENT SURVEY DATA OF THE EXISTING GRADE.
- FINISHED GRADE SHOULD SLOPE AWAY FROM BUILDINGS AT A MINIMUM SLOPE OF 1%.
- SPOILS FROM TRENCHING AND EXCAVATION MAY BE SPREAD EVENLY ACROSS THE PROJECT SITE.
- ALL UNSUITABLE SOILS MATERIALS AND RUBBISH AND DEBRIS RESULTING FROM GRADING 13.
- OPERATIONS SHALL BE REMOVED FROM THE JOB SITE AND DISPOSED OF PROPERLY.
- PRIOR TO ANY GRADING THE CONTRACTOR SHALL BE RESPONSIBLE FOR SCHEDULING A PRE-CONSTRUCTION MEETING WITH THE COUNTY OF SAN MATEO AND OTHER AFFECTED AGENCIES. THE CONTRACTOR SHALL NOTIFY THE COUNTY OF SAN MATEO AT LEAST 48 HOURS PRIOR TO ANY WORK BEING PERFORMED AND ARRANGE FOR INSPECTION.
- A SOILS ENGINEER SHALL SUPERVISE THE GRADING AND CERTIFY THAT ALL GRADING HAS BEEN COMPLETED IN CONFORMANCE WITH THESE PLANS AND SPECIFICATIONS, CURRENT AND APPLICABLE EDITION OF THE CBC, AND THE RECOMMENDATION OF THE FINAL SOILS REPORT. A FINAL SOILS REPORT SHALL BE PROVIDED IN ACCORDANCE WITH THE CURRENT AND APPLICABLE EDITION OF THE
- IN-PLACE DENSITY TESTS SHOULD BE DONE IN ACCORDANCE WITH ASTM D6938 AT A FREQUENCY OF AT LEAST:
- 16.1. MASS FILLS OR SUBGRADE: 1 TEST PER 2,500 SQUARE FEET PER COMPACTED LIFT
- 16.2. UTILITY LINES: 1 TEST PER 50 FEET WHERE SOIL BACKFILL IS USED



VICINITY MAP

45 CUBIC YARDS
5 CUBIC YARDS

NOTES: QUANTITIES DO NOT INCLUDE SPOILS FROM FOR FOUNDATION EXCAVATION. QUANTITIES ARE FOR PERMITTING PURPOSES ONLY. CONTRACTOR IS RESPONSIBLE FOR VERIFYING EARTHWORK QUANTITIES

SHEET INDEX

-	SHEET NUMBER	DESCRIPTION
***************************************	C1.0	KEY MAP AND NOTES
	C2.0	GRADING AND DRAINAGE PLAN
	C3.0	DRIVEWAY PLAN AND PROFILE
	C4.0	TYPICAL DETAILS


CIVIL ENGINEER

AE ENGINEERING SERVICES ADOLFO ESPINO, RCE 88310 P:562.822.2014 1414 HARBOUR WAY SOUTH RICHMOND, CA 94804

GEOTECHNICAL ENGINEER

MOORE TWINING ASSOCIATES READ L. ANDERSON, RGE P:559.268.7021 2527 FRESNO ST FRESNO, CA 93721

LEGEND

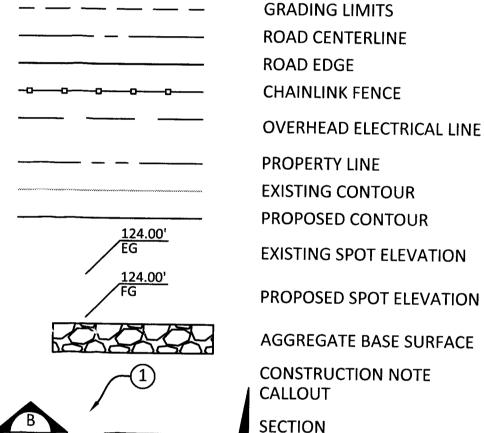

ABBREVIATIONS

APPROX

CONST

DIA

DBC

DWG

ETW

0&M

TYP

UNO

ACCESS ROAD

APPROXIMATE

ARRAY LAYOUT

CENTERLINE

CONDUIT

DIAMETER

DRAWING

EASTING

EXISTING

FLOWLINE

HIGHWAY NORTHING

TYPICAL

VEHICLE

FOUNDATION

PROPERTY LINE

TOP OF CONCRETE TOP OF PAVEMENT

RELATIVE COMPACTION

UNLESS NOTED OTHERWISE

DETAIL

BOTTOM OF PIPE

CONSTRUCTION

DIRECT BURIED CABLE

EDGE OF TRAVEL WAY

OPERATIONS AND MAINTENANCE

EXISTING GRADE

FINISHED GRADE

AE ENGINEERING SERVICES 1333 POWELL ST UNIT 301 EMERYVILLE, CA 94608 562.822.2014



ENGINEER'S STAMP

NEW RESIDENCE

0 VUE DE MER MOSS BEACH, CA 94038

NOTES


KEY MAP AND


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	PR	PROJECT		
	DATE DRAWN DRAWN BY			


8-1-18

Know what's **below.**Call 811 before you dig.



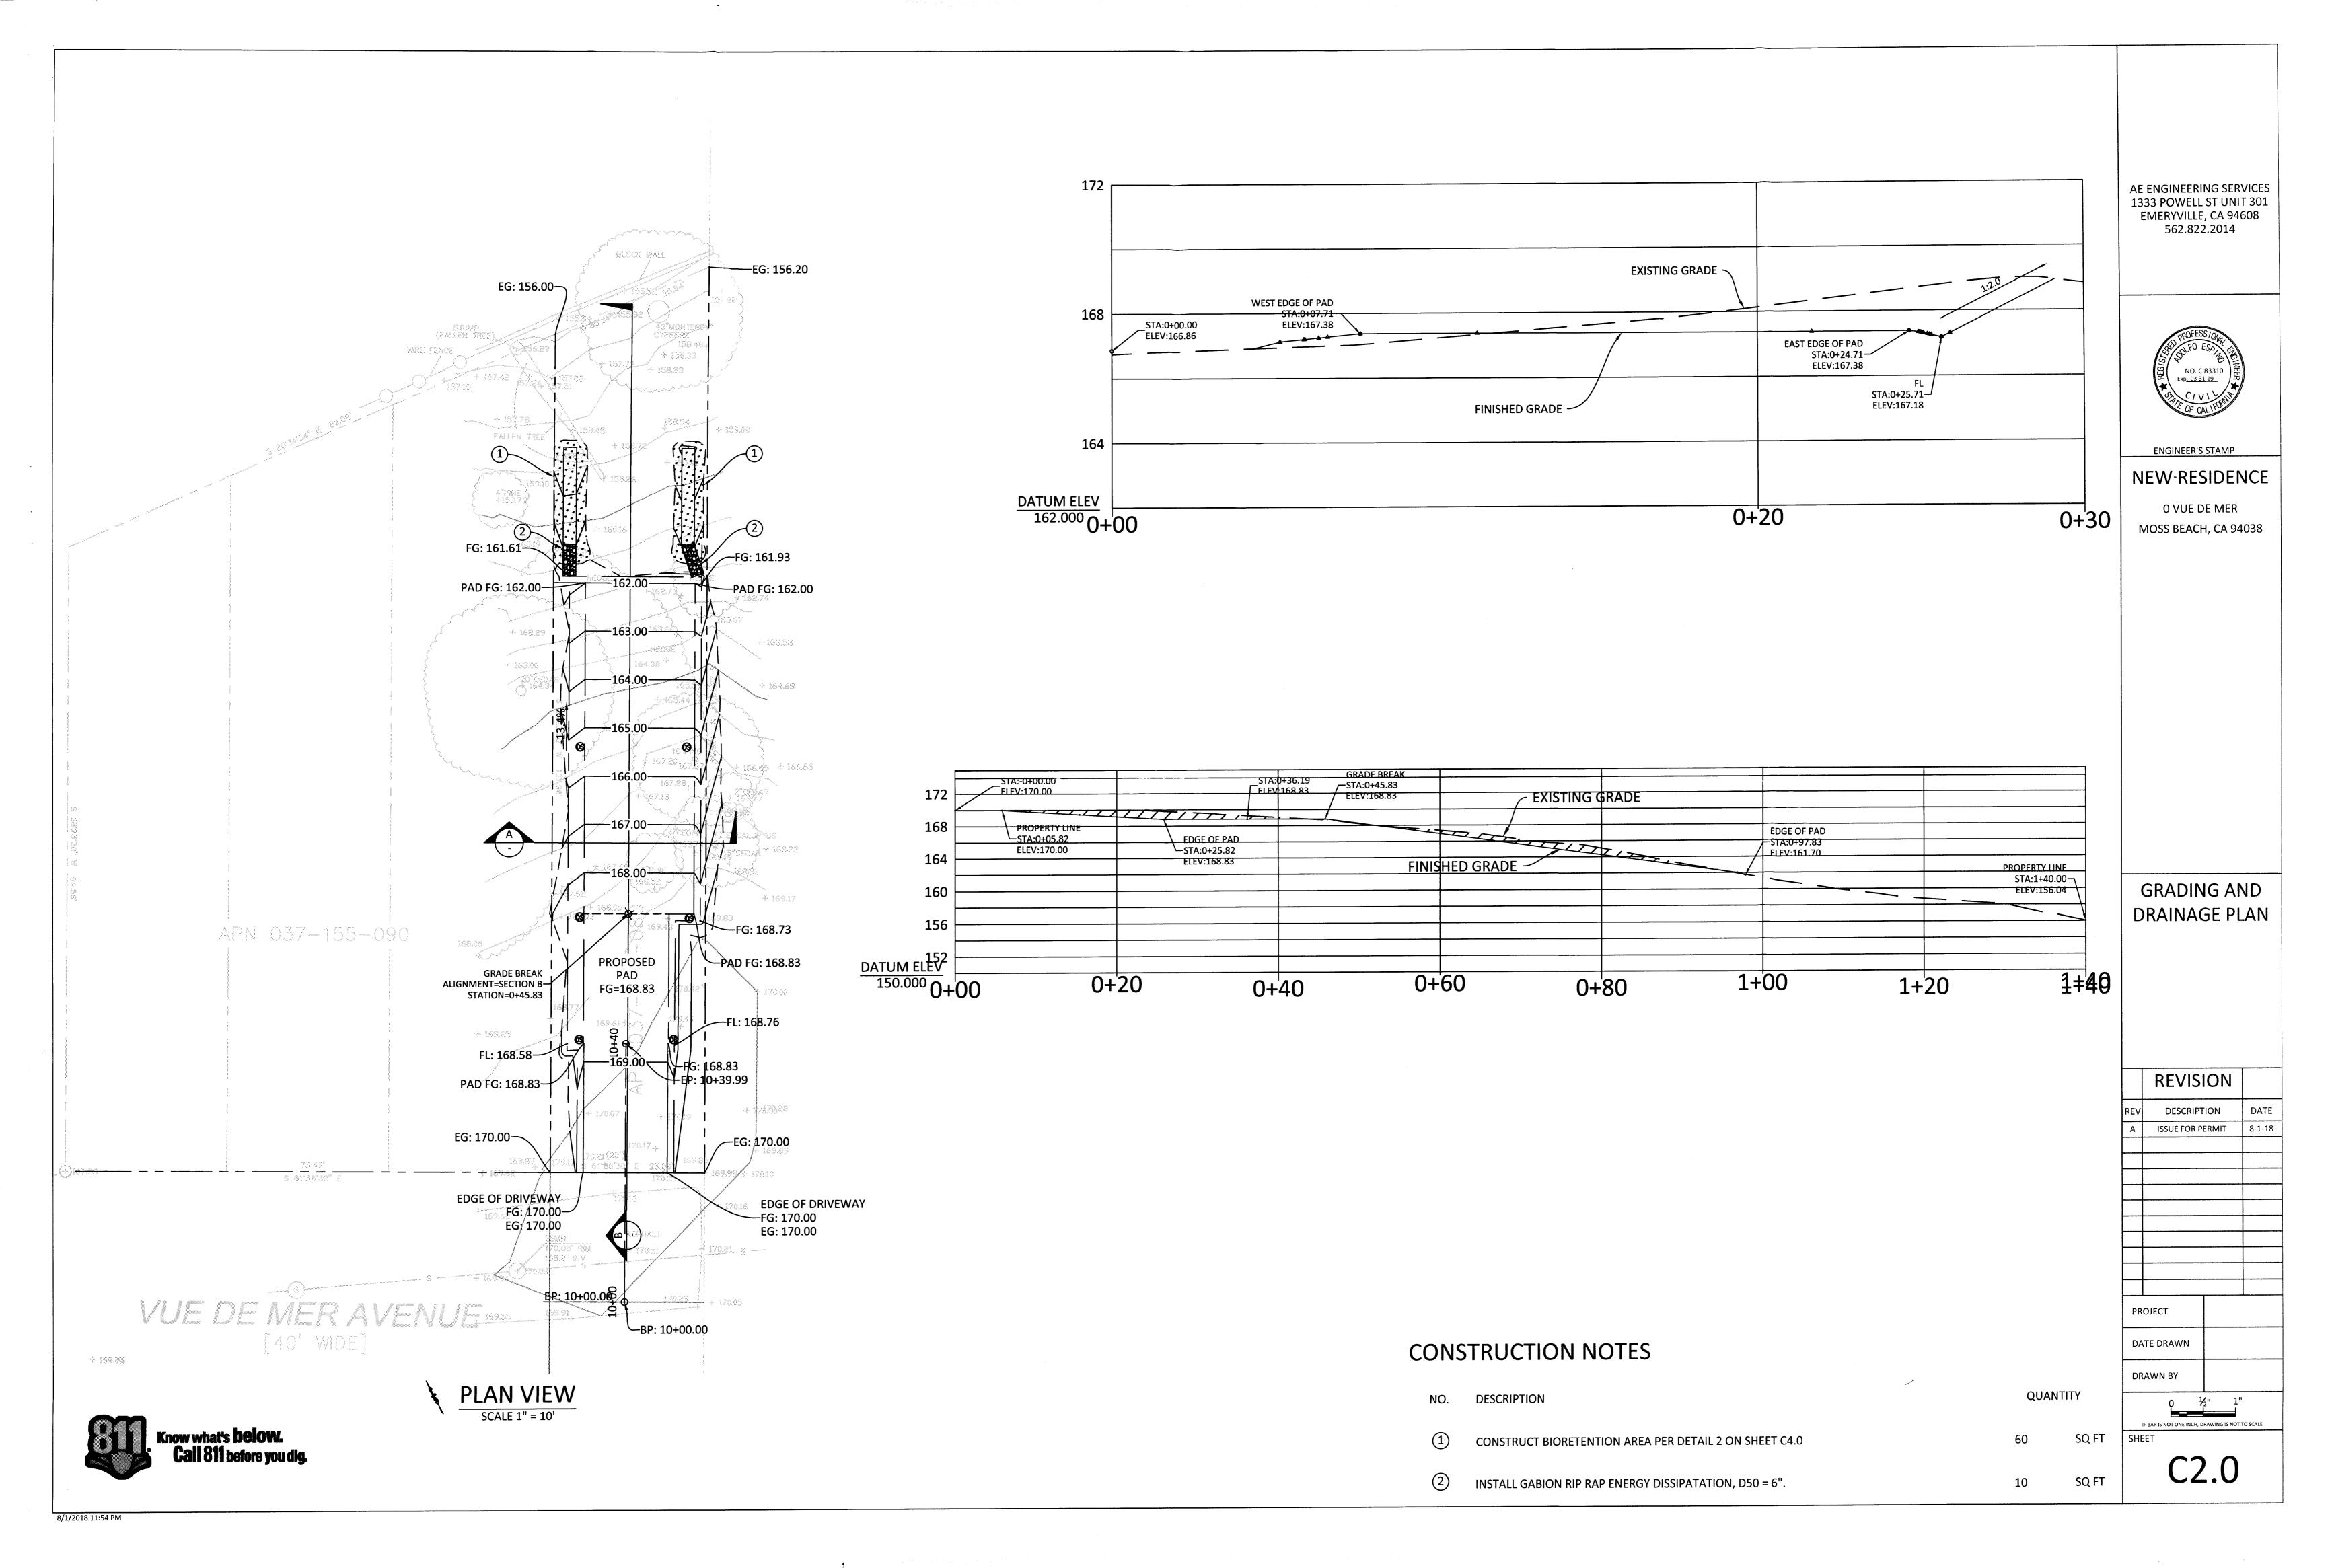

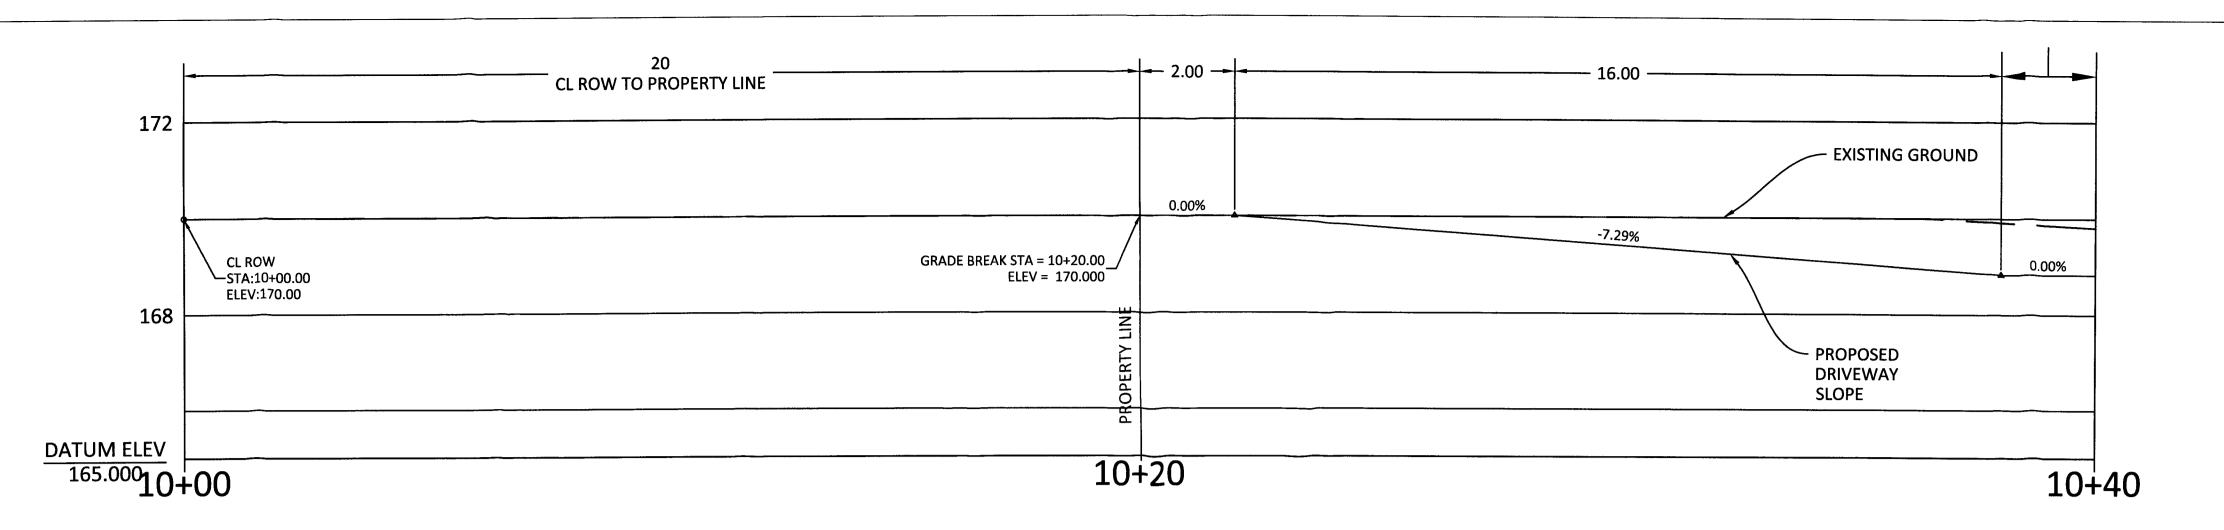DRIVEWAY PROFILE VIEW SCALE 1" = 2'

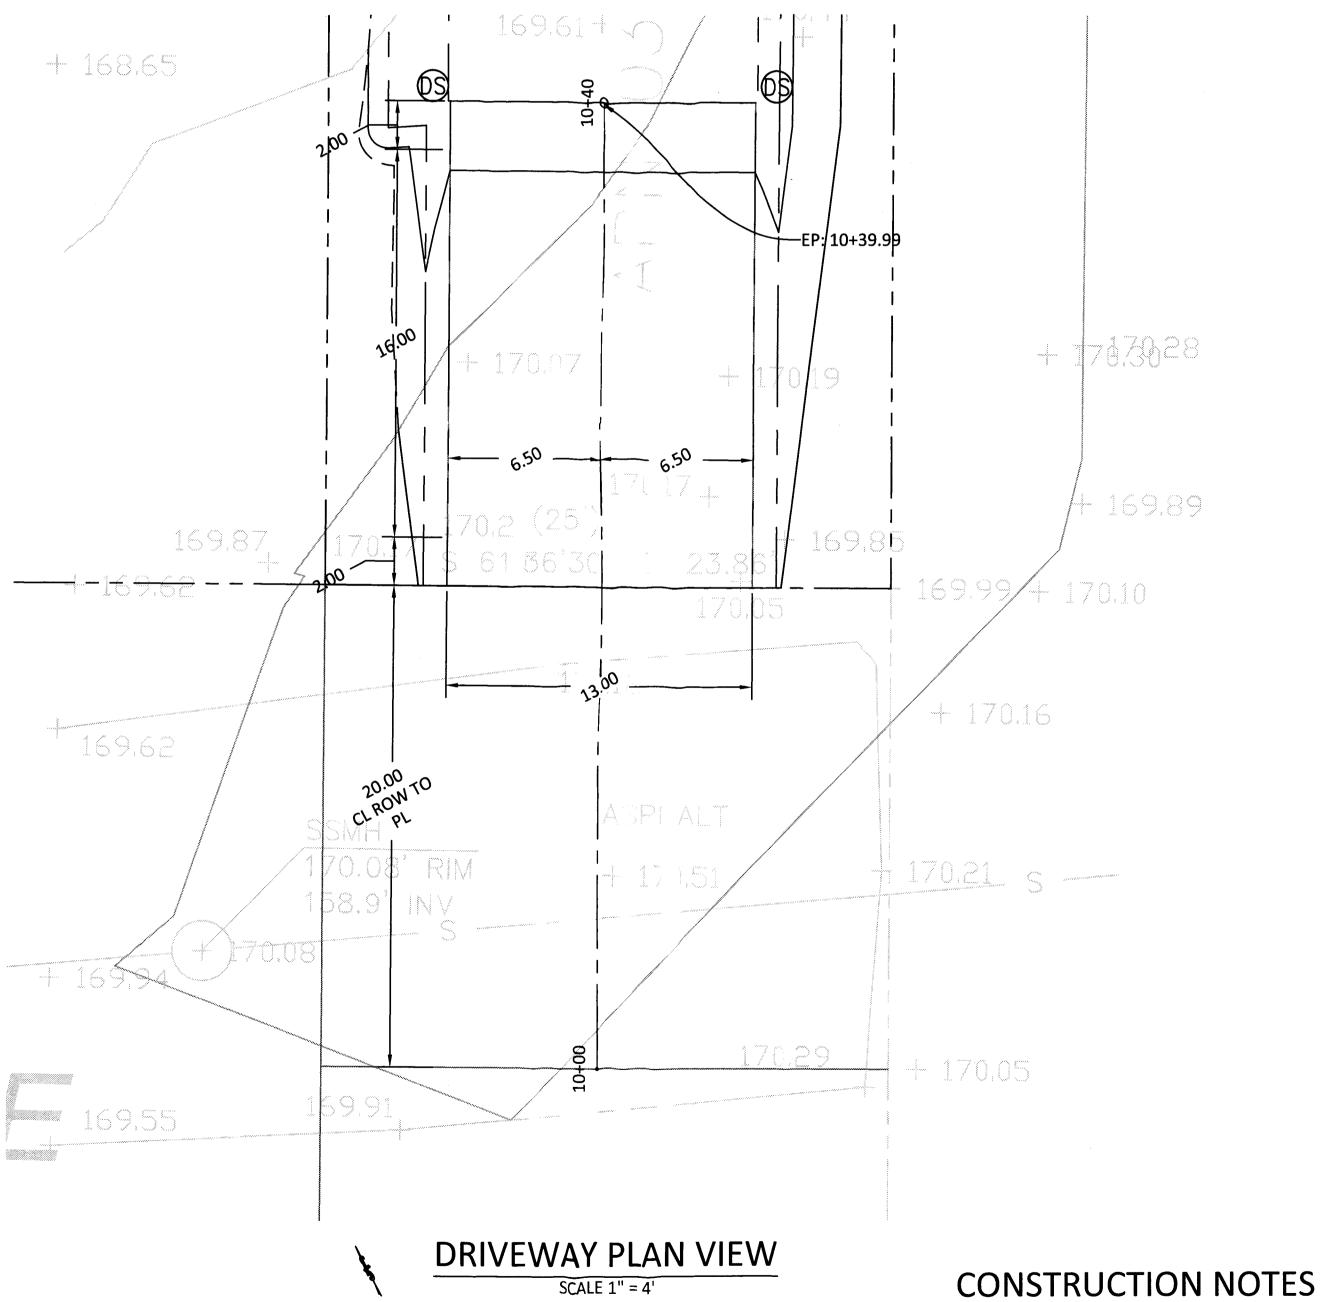

Know what's **below. Call 811** before you dig.

8/2/2018 12:24 AM

NO. DESCRIPTION

CONSTRUCT 13' WIDE COMPACTED EARTH DRIVEWAY

QUANTITY

260 SQ FT AE ENGINEERING SERVICES 1333 POWELL ST UNIT 301 EMERYVILLE, CA 94608 562.822.2014



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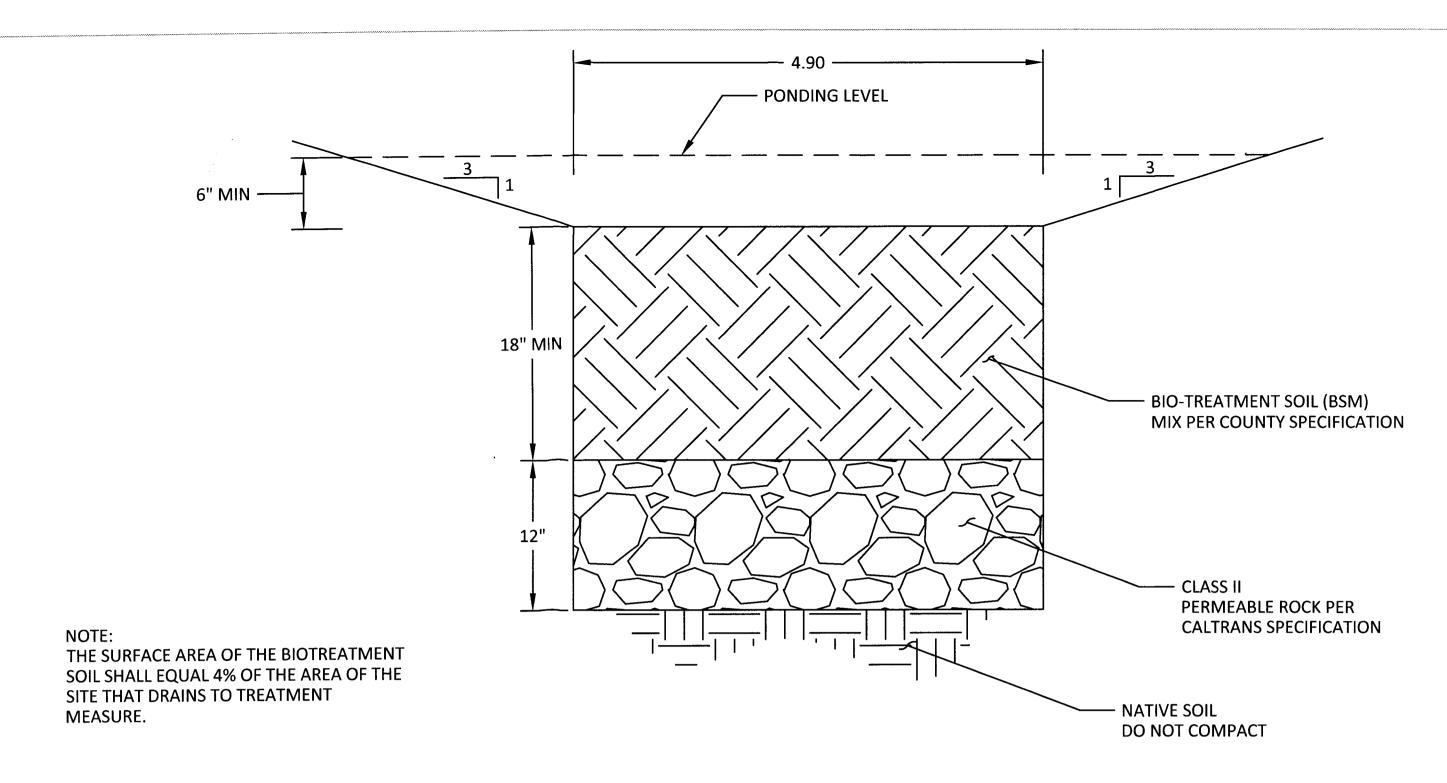
NEW RESIDENCE

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DRIVEWAY PLAN **AND PROFILE**

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PR	OJECT				
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	0 ½	<u>′</u> " 1"			
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SHE	ET				
C3.0					





IMPERVIOUS AREAS					
ZONE	IMPERVIOUS AREA	BIORETATION AREA REQUIRED	BIORETENTION AREA PROVIDED		
ZONE A	282.5	27.4 SQ FT	30 SQ FT		
ZONE B	245.0				
ZONE C	158.0				
ZONE D	225.0	27.3 SQ FT	30 SQ FT		
ZONE E	300.0				
ZONE F	158.0				

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> TYPICAL DETAILS

REVISION

REV DESCRIPTION DATE

A ISSUE FOR PERMIT 8-1-18


PROJECT

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SHEET

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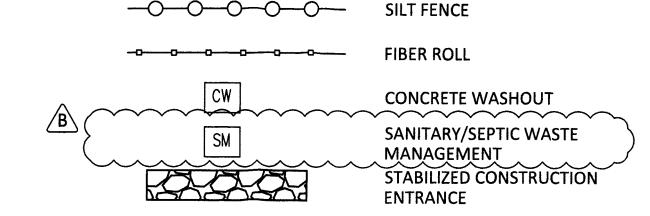
EROSION CONTROL NOTES:

1. EROSIONCONTROL PLAN POINT OF CONTACT: ADOLFO ESPINO, PE, QSD/QSP ADOLFO.ESPINO@GMAIL.COM P:(562) 822-2014

AS TO PREVENT THEIR CONTACT WITH STORMWATER.

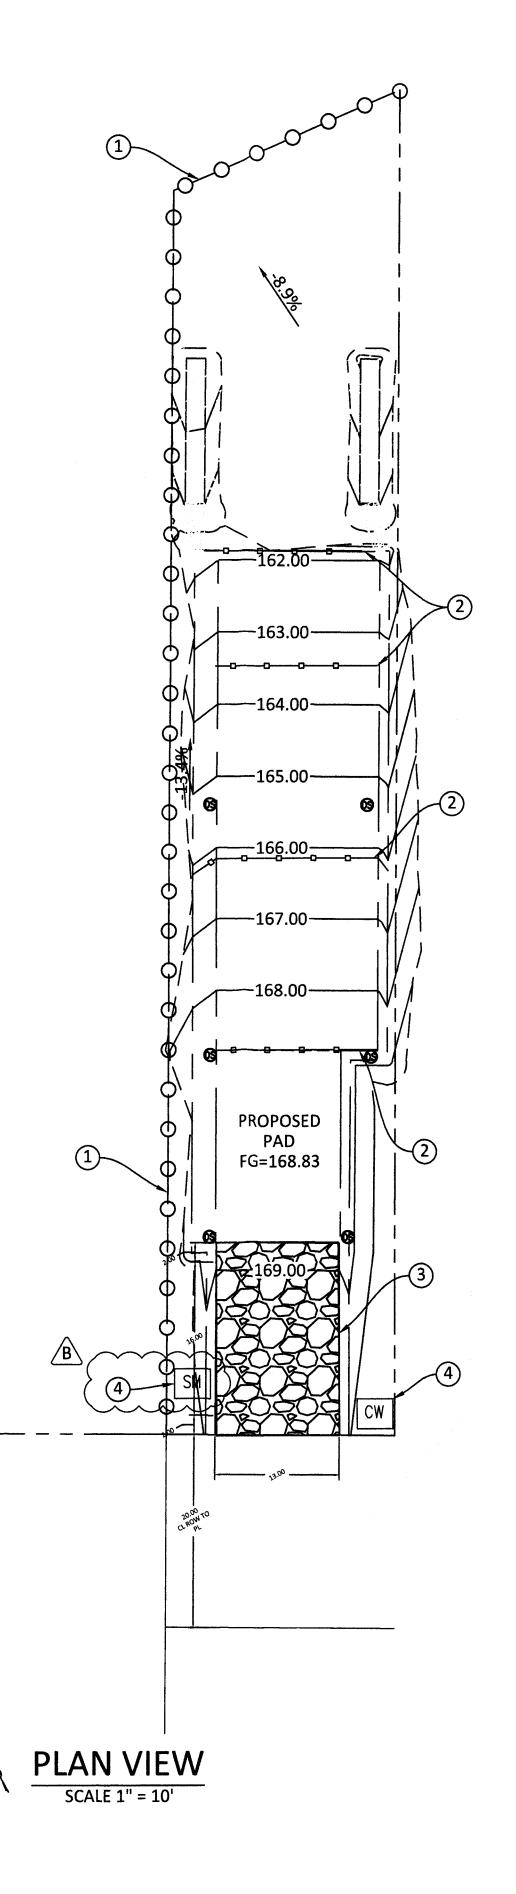- 2. PERFORM CLEARING AND EARTH-MOVING ACTIVITIES ONLY DURING DRY WEATHER. 3. MEASURES TO ENSURE ADEQUATE EROSION AND SEDIMENT CONTROL SHALL BE INSTALLED
- PRIOR TO EARTH-MOVING ACTIVITIES AND CONSTRUCTION. 4. MEASURES TO ENSURE ADEQUATE EROSION AND SEDIMENT CONTROL ARE REQUIRED
- YEAR-ROUND. STABILIZE ALL DENUDED AREAS AND MAINTAIN EROSION CONTROL MEASURES CONTINUOUSLY BETWEEN OCTOBER 1 AND APRIL 30. 5. STORE, HANDLE, AND DISPOSE OF CONSTRUCTION MATERIALS AND WASTES PROPERLY, SO
- 6. CONTROL AND PREVENT THE DISCHARGE OF ALL POTENTIAL POLLUTANTS, INCLUDING PAVEMENT CUTTING WASTES, PAINTS, CONCRETE, PETROLEUM PRODUCTS, CHEMICALS, WASH WATER OR SEDIMENTS, AND NON-STORMWATER DISCHARGES TO STORM DRAINS AND WATERCOURSES.
- 7. USE SEDIMENT CONTROLS OR FILTRATION TO REMOVE SEDIMENT WHEN DEWATERING SITE AND OBTAIN REGIONAL WATER QUALITY CONTROL BOARD (RWQCB) PERMIT(S) AS NECESSARY.
- 8. AVOID CLEANING, FUELING, OR MAINTAINING VEHICLES ON-SITE, EXCEPT IN A DESIGNATED AREA WHERE WASH WATER IS CONTAINED AND TREATED.
- 9. LIMIT AND TIME APPLICATIONS OF PESTICIDES AND FERTILIZERS TO PREVENT POLLUTED
- 10. LIMIT CONSTRUCTION ACCESS ROUTES TO STABILIZED, DESIGNATED ACCESS POINTS. 11. AVOID TRACKING DIRT OR OTHER MATERIALS OFF-SITE; CLEAN OFF-SITE PAVED AREAS AND
- SIDEWALKS USING DRY SWEEPING METHODS.
- 12. TRAIN AND PROVIDE INSTRUCTION TO ALL EMPLOYEES AND SUBCONTRACTORS REGARDING THE WATERSHED PROTECTION MAINTENANCE STANDARDS AND CONSTRUCTION BEST MANAGEMENT PRACTICES.
- 13. PLACEMENT OF EROSION MATERIALS AT THESE LOCATIONS ARE REQUIRED ON WEEKENDS AND DURING RAIN EVENTS: (LIST LOCATIONS) 14. THE AREAS DELINEATED ON THE PLANS FOR PARKING, GRUBBING, STORAGE, ETC., SHALL
- NOT BE ENLARGED OR "RUN OVER." 15. CONSTRUCTION SITES ARE REQUIRED TO HAVE EROSION CONTROL MATERIALS ON-SITE
- DURING THE "OFF-SEASON." DUST CONTROL IS REQUIRED YEAR-ROUND.
- 16. EROSION CONTROL MATERIALS SHALL BE STORED ON-SITE.
- 17. USE OF PLASTIC SHEETING BETWEEN OCTOBER 1 AND APRIL 30 IS NOT ACCEPTABLE, UNLESS FOR USE ON STOCKPILES WHERE THE STOCKPILE IS ALSO PROTECTED WITH FIBER
- 18. TREE PROTECTION SHALL BE IN PLACE BEFORE ANY DEMOLITION, GRADING, EXCAVATING OR GRUBBING IS STARTED AND IMPLEMENTED PER TREE PROTECTION PLAN PREPARED BY DAVID FOWLER DESIGNS

EROSION CONTROL PLAN LEGEND



EROSION AND SEDIMENT CONTROL PLAN

REVISION

DESCRIPTION **ISSUE FOR PERMIT**

B RESPONSE TO COMMENT 11-26-18

CONSTRUCTION NOTES DESCRIPTION QUANTITY INSTALL SILT FENCE ALONG EDGE OF PROPERTY PER DETAIL 1 ON SHEET EC2.0 160 LFT PROJECT DATE DRAWN INSTALL FIBER ROLLS ALONG GRADED SLOPE PER DETAIL 2 ON SHEET EC2.0 80 LFT CONSTRUCT TEMPORARY STABILIZED CONSTRUCTION ENTRANCE PER DETAIL 3 ON SHEET EC2.0 260 SQ FT IF BAR IS NOT ONE INCH, DRAWING IS NOT TO SCALE EΑ EC1.0

HANDBOOK DETAIL WM-9 OR APPROVED EQUIVALENT.


AE ENGINEERING SERVICES 1333 POWELL ST UNIT 301 EMERYVILLE, CA 94608 562.822.2014



ENGINEER'S STAMP

NEW RESIDENCE

0 VUE DE MER MOSS BEACH, CA 94038

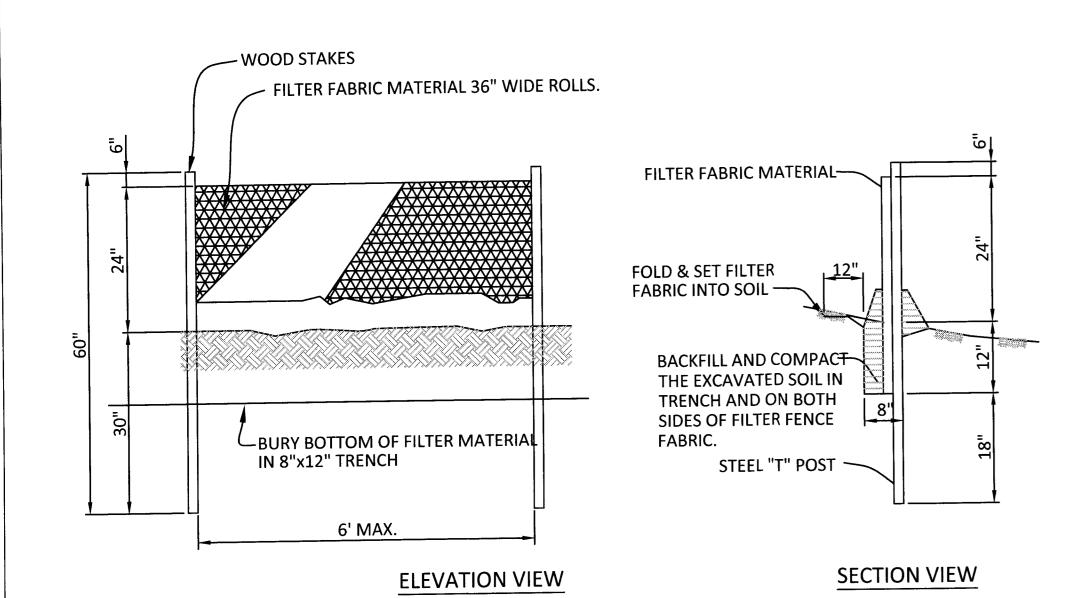

SILT FENCE NOTES:

10 MIL —/ PLASTIC LINING

 CONSTRUCT THE LENGTH OF EACH REACH SO THAT THE CHANGE IN BASE ELEVATION ALONG THE REACH DOES NOT EXCEED ⅓ THE HEIGHT OF THE LINEAR BARRIER, IN NO CASE SHALL THE REACH LENGTH EXCEED 500'.

THE LAST 8'-0" OF THE FENCE SHALL BE TURNED UP SLOPE.
 STAKE DIMENSIONS ARE NOMINAL.

4. DIMENSION MAY VARY TO FIT FIELD CONDITION.

5. STAKES SHALL BE SPACED AT 8'-0" MAXIMUM AND SHALL BE POSITIONED ON DOWNSTREAM SIDE OF FENCE.

6. STAKES TO OVERLAP AND FENCE FABRIC TO FOLD AROUND EACH STAKE ONE FULL TURN. SECURE FABRIC STAKE WITH 4 STAPLES.

7. STAKES SHALL BE DRIVEN TIGHTLY TOGETHER TO PREVENT POTENTIAL FLOW-THROUGH OF SEDIMENT AT JOINT. THE TOPS OF THE STAKES SHALL BE

SECURED WITH 4 STAPLES.


8. FOR END STAKE, FENCE FABRIC SHALL BE FOLDED AROUND TWO STAKES ONE FULL TURN AND SECURED WITH 4 STAPLES.

MINIMUM 4 STAPLES PER STAKE. DIMENSIONS SHOWN ARE TYPICAL.
 MAINTENANCE OPENINGS SHALL BE CONSTRUCTED IN A MANNER TO ENSURE


SEDIMENT REMAINS BEHIND SILT FENCE.

11. JOINING SECTIONS SHALL NOT BE PLACED AT SUMP LOCATIONS.

12. SANDBAG ROWS AND LAYERS SHALL BE OFFSET TO ELIMINATE GAPS.

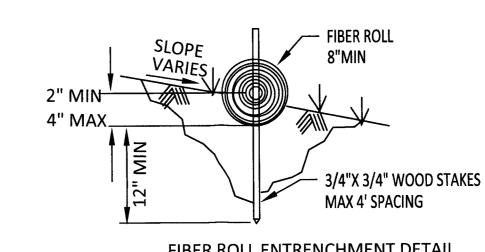


FIBER ROLL ENTRENCHMENT DETAIL N.T.S.

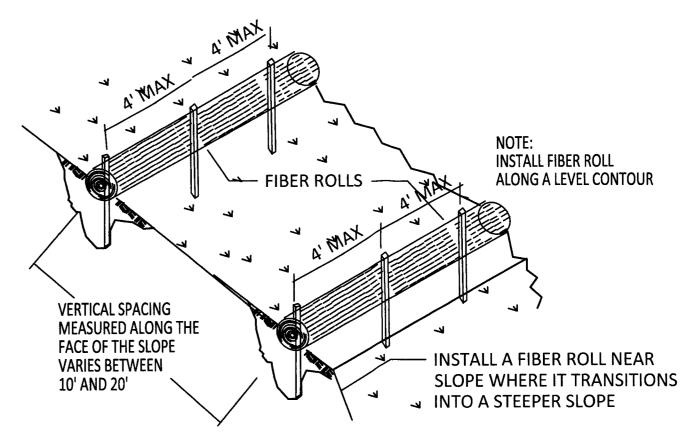


2 FIBER ROLL DETAILS SCALE:NTS



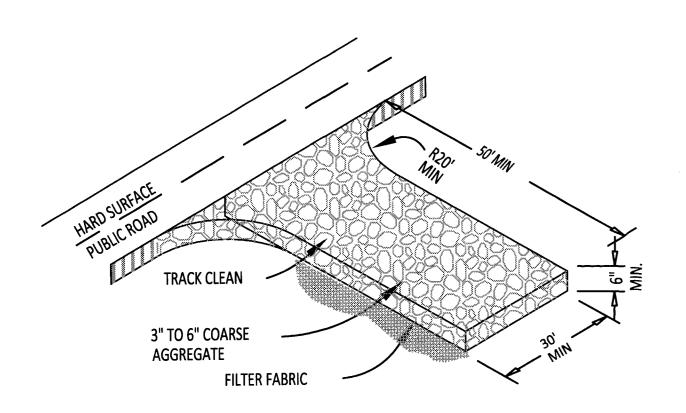

3 STABILIZED CONSTRUCTION ENTRANCE SCALE:NTS

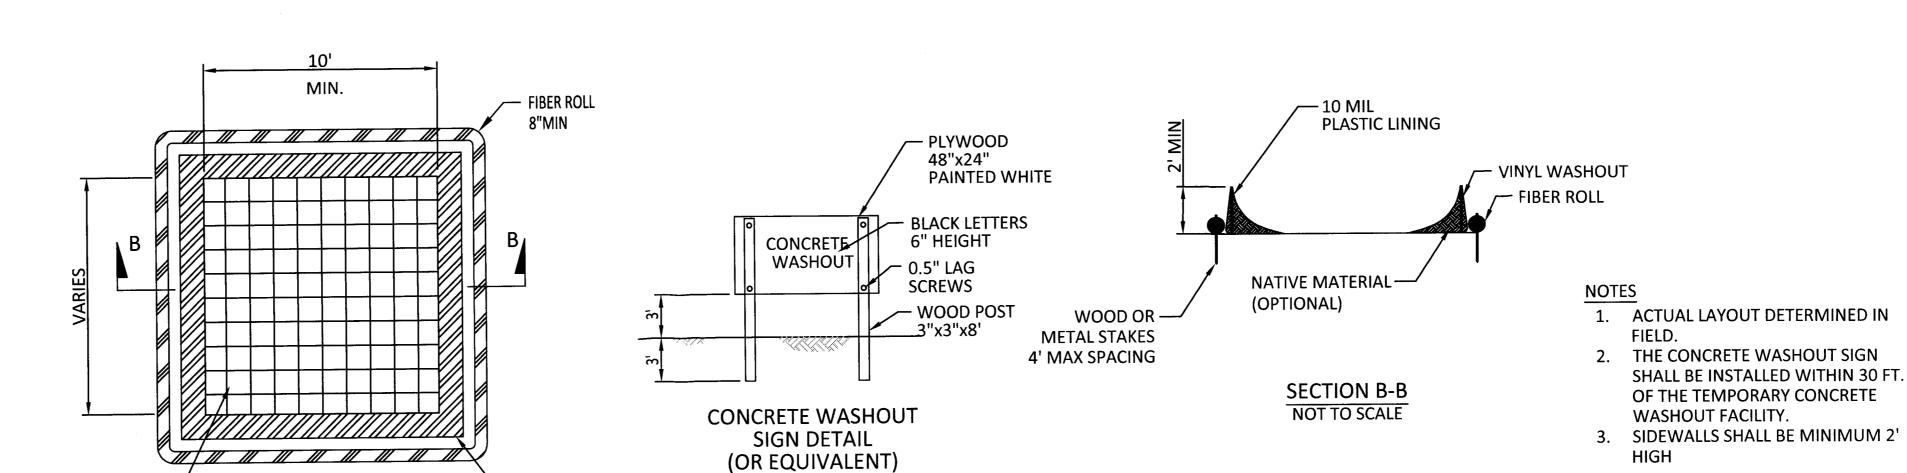

4 CONCRETE WASHOUT DETAIL
SCALE:NTS

VINYL WASHOUT

EROSION AND
SEDIMENT
CONTROL PLAN
DETAILS

AE ENGINEERING SERVICES

1333 POWELL ST UNIT 301

EMERYVILLE, CA 94608

562.822.2014

NO. C 83310 Exp<u>. 03-31-19</u>

ENGINEER'S STAMP

NEW RESIDENCE

O VUE DE MER

MOSS BEACH, CA 94038

REVISION

REV DESCRIPTION DATE

A ISSUE FOR PERMIT 8-17-18

PROJECT

DATE DRAWN

DRAWN BY

EC2.0

IF BAR IS NOT ONE INCH, DRAWING IS NOT TO SCALE

SHEET

8/26/2018 11:00 PM

1/8"=1'-0"

RAIN FIRD ESPASHEE

OUTSSEE VALL HEAVY

INDH PIVE SON AG CONSULT
AND FINENACE

(3) VIPES TO REMOTE CONTROL.

STANDARD MODINE FOR 4-STATION CONTROLLER

(1) OPTIONAL HODDLES FOR 22-STATION CONTRILLER

D ESP-SMTE SMART CONTROL SYSTEM

OUTDOOR MEDEL

100518

DESCRIPTION

Hydrozone Legend Irrigation Legend RAINBIRD SMART IRRIGATION CONTROLLER-LOW WATER USE SEE SPECS ON THIS SHEET **HYDROZONE NEW VALVE LOCATION** — POINT OF CONNECTION — MAIN LINE - - - - 5" POLY IRRIGATION LINE FROM VALVE **BACKFLOW PREVENTION DEVICE AND** MANUAL SHUTOFF LOCATION - USE RAINBIRD SMART CONTROLLER WITH RAIN SENSOR AND SEASONAL ADJUSTMENT - ALL PLANTINGS TO USE DRIP IRRIGATION UNLESS OTHERWISE NOTED - BERM AROUND ALL TREES. PLACE MULTIPLE EMITTERS AT LEAST 6-12" AWAY FROM

Irrigation Notes

- USE BELOW GROUND VALVES AND LOCATE IN AREAS HIDDEN FROM VIEW IF POSSIBLE.

- TRUNK OF TREE. TREES TO BE ON SEPARATE VALVE FROM LANDSCAPE PLANTS - SEE PLANTING PLAN FOR EXACT NUMBER OF EMITTERS NECESSARY
- NO SPRINKLERS OR OVERHEAD SPRAY DEVICES ARE TO BE USED ON THIS PROJECT

WELO - NOTES:

RECOMMENDED CONTROLLER

AND SENSOR LOCATION.

ENSURE THAT SENSOR IS

OVERHANGS AND CLEAR

BACK FLOW PREVENTER

ZONE 1 - 220SF

SHRUBS (LOW)

ZONE 2 - 20SF

TREE (LOW)

FREE FROM ROOF


OF TREES


- 1. Backflow preventer and shut-off valves are located upstream of the mainline.
- 2. Calculations for the Maximum Allowable Water Allotment (WELO Appendix A)
- 3. Control system has the ability to run multiple operating cycles, and implement global increase or decrease by percentage to match plant water requirements, environmental conditions, and the soil's infiltration rate.
- 4. Hydrozones are seperated by plant type, solar exposure, soil type, and microclimate. Flow rate, application rate, and design pressures are shown for each hydrozone.
- 5. No overhead spray irrigation is used on this project.
- 6. Drip irrigation has integrated check valves and pressure regulation, and will provide even coverage throughout planted areas.
- 7. Station operation times shall not exceed the soil's infiltration rate.
- 8. Upon completion of the installation the contractor shall submit to the building department a completed and signed "Certificate of Completion" stating that the project has been installed as designed.
- 9. The Certificate of Completion shall be accompanied by an irrigation audit, irrigation schedule, and maintenance schedule as described in the City Ordinance.
- 10. A final City inspection shall be performed. The installation contractor shall attend this inspection, and make all required repairs and adjustments to achieve approval and completion from the City.

(PF x HA

Project Notes:

- Total landscaped area: 230 sf
- 100% of landscaped area on drip irrigation (no spray heads)
- Low and moderate water use plants on separate valves
- Trees on separate valves
- Dedicated irrigation meter not required because landscaped area is less than 5000 sf
- Certificate of completion: applicant shall submit a landscape audit report verifying installation and irrigation efficiency per design on a form provided by the East Bay **Municipal Utility District**

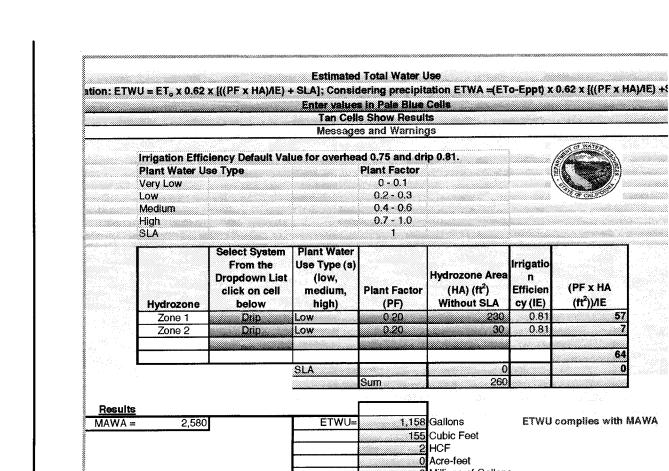

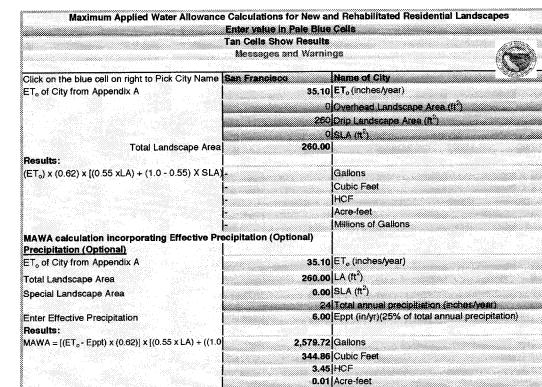

42"MONTERE

BACKYARD TO REMAIN IN ITS

NATURAL STATE

PATIO

RESIDENCE

ZONE 2 VALVE - 10 GPH

GARAGE

DRIVEWAY

VUE DE MAR AVENUE

POINT OF CONNECTION -1

ZONE 1 VALVE - 31 GPH

modification). Вр (V (Cd) V Bottom of root ball **SECTION VIEW** rests on existing or VUE DE MAR AVENUE 1- Shrubs shall be of quality as prescribed in the root observations detail and specification. 2- See specifications for further requirements related to this detail SHRUB ON SLOPE 5% (20:1) TO 50% (2:1) - MODIFIED SOIL 3/4" = 1'-0"

Plant List

TREES

SHRUBS

GRASSES

1- Trees shall be of quality

2- See specifications for

further requirements related to

Trunk caliper shall meet ANSI Z60 current

edition for root ball size.

Root ball modified as

Round-topped soil

berm 4" high x 8" wide above root ball surface shall

be centered on the downhill side of the root ball for 240°. Berm shall begin at root ball

varies. (See soil preparation

4" layer of mulch. No more than 1" of

mulch on top of

root ball. (See

Modified soil.

Depth varies. (See

specifications for soil

specifications for

Original slope should pass through the point where the trunk meets substrate/soil.

1/2" = 1'-0"

prescribed in crown observations and root observations details and

specifications.

Latin Name

Baccharis pillularis 'Pigeon Point'

Phormium tenax 'Rainbow Queen'

Verbena canadensis 'Purple Spreader'

Nandina domestica

Loropetalum chinese var. rubrum 'Blush'

42"MONTERE

BACKYARD TO REMAIN IN ITS

NATURAL STATE

PATIO

RESIDENCE

GARAGE

Ph

(Lc 🄀

(Cd) No

(Cq) Lu

Cd

(Cd) No

გ (Cd)

Soil and Planting Notes:

- 1. A minimum of 8" of non-mechanically compacted soil shall be available for water absorption and root growth in planting areas.
- 2. Incorporate compost or natural fertilizer into the soil to a minimum depth of 8" at a minimum rate of 6 cubic yards per 1000 square feet or per specific amendment recommendations from a soils laboratory report.
- A minimum 3" layer of mulch shall be applied on all exposed soil surfaces of planting areas except in turf areas, creeping or rooting groundcovers or direct seeding applications.

"I have complied with the criteria of the ordinance and applied them for the efficient use of water in the planting design"

Size Quantity WELO

low

Central leader. (See crown

Original slope should pass through the point where the

Prior to mulching, lightly tamp

soil around the root ball in 6" lifts to brace tree. Do not ove compact. When the planting

water around the root ball to

- 4" laver of mulch. No more than 1" of mulch on top of root

ball. (See specifications for

Bottom of root ball rests on

existing or recompacted soil

4" high x 8" wide round - topped soil berm

above root ball surface shall be centered on the downhill side of the root ball for

Prior to mulching, lightly tamp soil around

not over compact. When the planting hole

has been backfilled, pour water around the

the root ball in 6" lifts to brace shrub. Do

240°. Berm shall begin at root ball

root ball to settle the soil.

Existing soil

trunk base meets

substrate/soil.


settle the soil.


- Original grade

24 box

SECTION VIEW

TREE ON SLOPE 5% (20:1) TO 50% (2:1) (EXISTING SOIL MODIFIED)

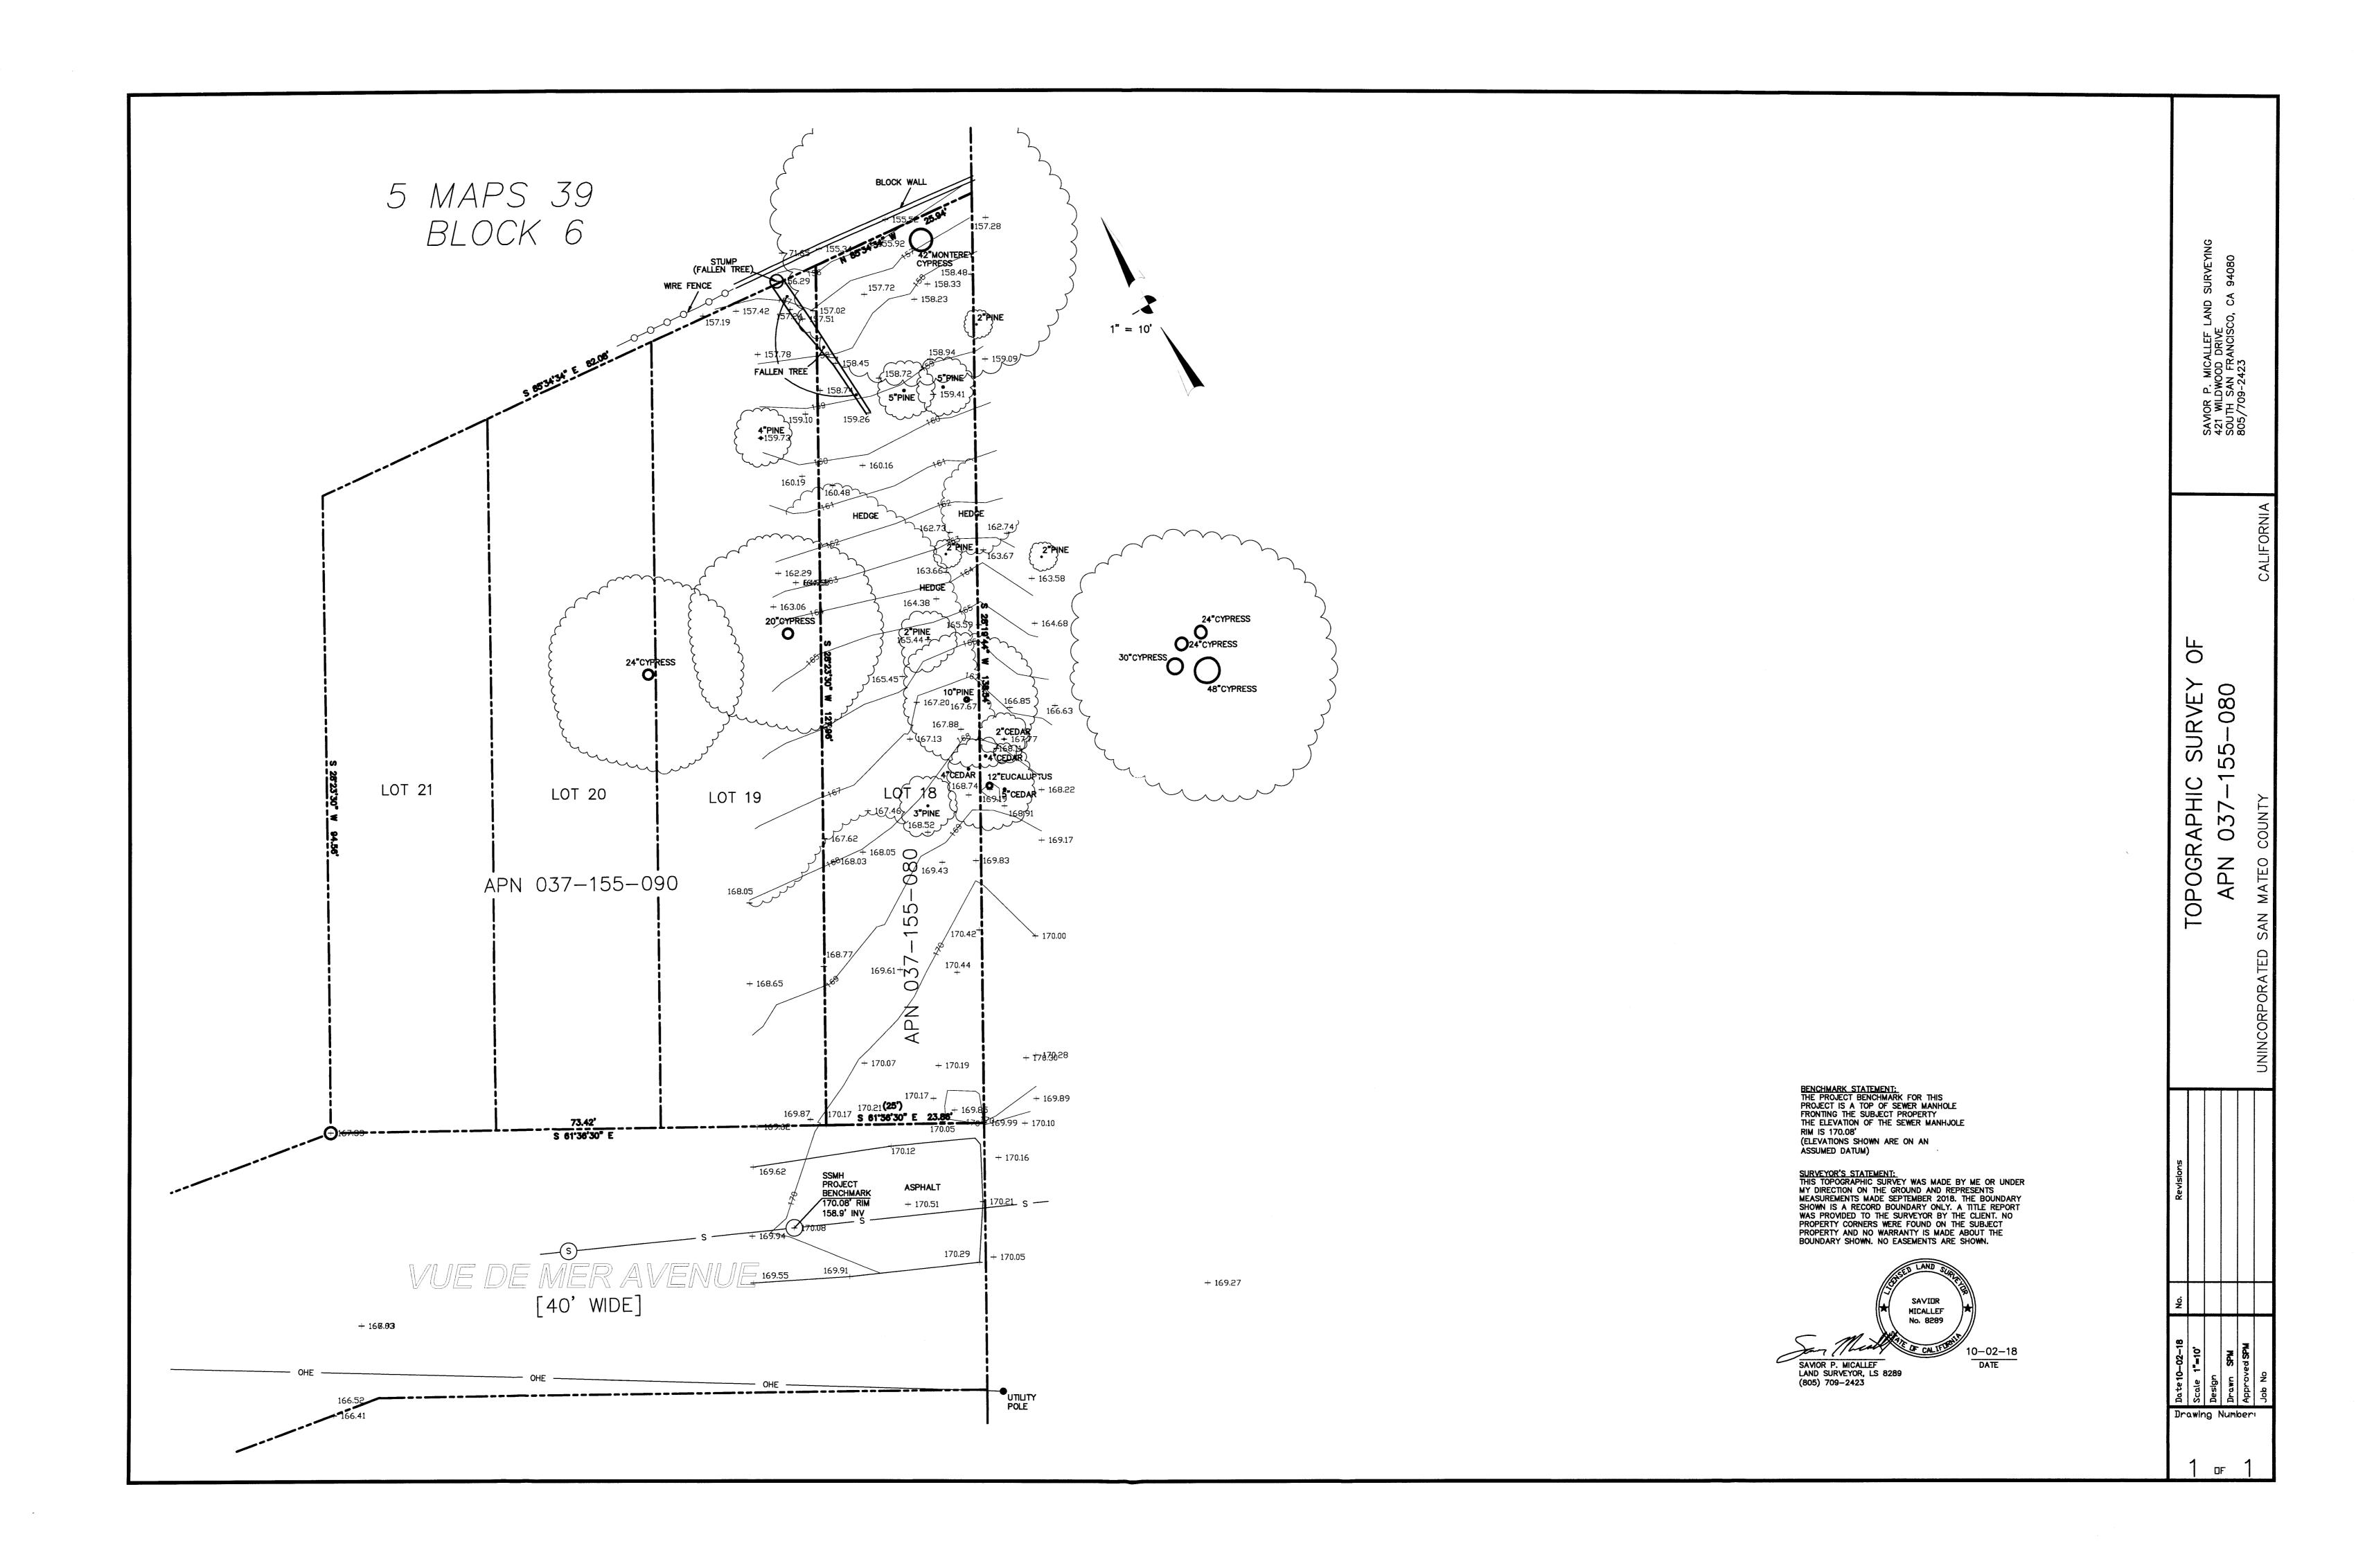

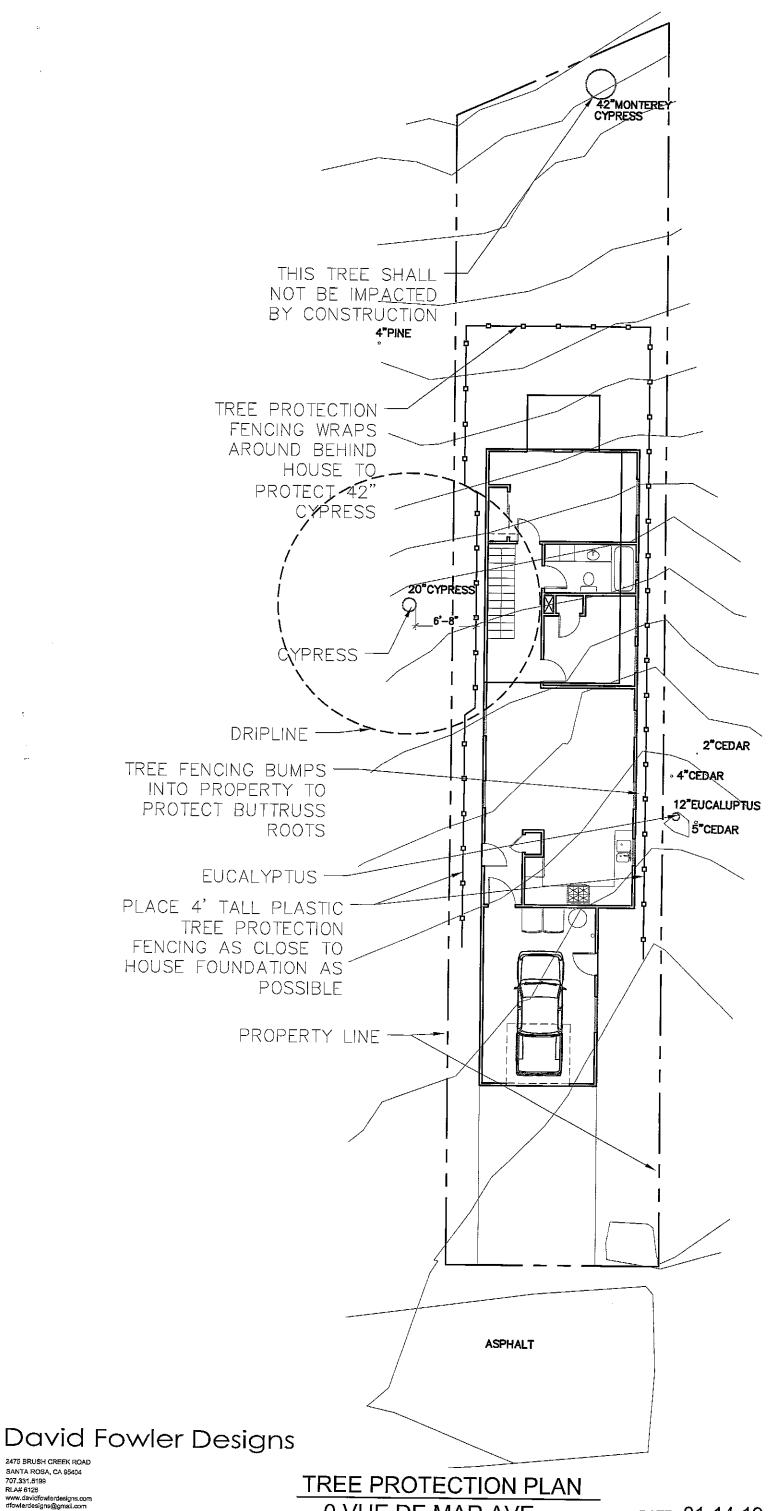

2475 BRUSH CREEK ROAD SANTA ROSA, CA 95404 707.331.5199 RLA# 6126 www.davidfowlerdesigns.com dfowlerdesigns@gmail.com

0 VUE DE MAR AVE MOSS BEACH, CA

DATE 01-14-19 SCALE 3/32"=1'-0"

0 Vue de Mar Ave Moss Beach, CA 94038

TREE PROTECTION MEASURES

November 16, 2018

- 1. Where pruning for clearance or hazard reduction is required on any trees to remain, it should be done by trained, qualified tree workers according to ISA & ANSI A300 Pruning Guidelines, prior to construction. Pruning should be the minimum necessary for hazard reduction, (i.e. the removal of deadwood. 2" and larger, broken branches, etc.) and for clearance.
- 2. Plastic tree protection fencing should be installed at the outer edge of the driplines of trees (on the side facing construction) within the zone of construction activity. If access within dripline will be required, fence to be placed at expected limit of grading. Fence should be installed prior to the start of clearing or grading operations, and kept in place throughout construction activities.
- 3. If any roots larger than 1" are encountered during construction activities which can't be preserved, they should be cut cleanly across the face of the root with a sharp saw, past any damaged portions.
- 4. No parking, operation of equipment, storage of materials, disposal of waste or other construction activity shall occur within driplines of protected trees.
- 5. If any issues arise during construction relating to trees, project arborist shall be notified to visit site and/or provide recommendations