

Application for Design Review by the County Coastside Design Review Committee

County Government Center • 455 County Center • Redwood City CA 94063
Mail Drop PLN 122 • 650-363-4161 • FAX 650-363-4849

Permit #: PLN 2015-00380

Other Permit #:

Applicant:

Name: Moss Beach Associates LLC

Address: PO Box 377

Santa Cruz , CA Zip: 95061

Phone,W: 8314571331 H: 8312128594

Email: owen@lawlorlanduse.com

Owner (if different from Applicant):

Name:

Address: PO Box 377

Zip: 59715

Phone,W: H:

Email:

Architect or Designer (if different from Applicant):

Name: Pearson Design Group/Larry Pearson

Address: 102 North Broadway Ave., Bozeman MT

Zip: 59715

Phone,W: 4075871997

H:

Email: bernst@pearsondesigngroup.com

Project location:

APN: 37086250 37086260

Address: 0 Vallemare Ave (Lot 2)*

Moss Beach CA Zip: 94,083

Zoning: RM-CZ/DR

Parcel/lot size: 22220 (proposed) sq. ft.

Site Description:

Vacant Parcel

Existing Development (Please describe):

Project:

3994

New Single Family Residence: 4859 sq. ft

Addition to Residence: _____ sq. ft.

Other: _____

Describe Project:

Construct a new 4859 SFD residence including a 776 SF 3rd story mezzanine with a 585 SF attached garage

Additional Permits Required:

- Certificate of Compliance Type A or Type B
- Coastal Development Permit
- Fence Height Exception (not permitted on coast)
- Grading Permit or Exemption
- Home Improvement Exception
- Non-Conforming Use Permit
- Off-Street Parking Exception
- Variance

Fill in Blanks:	Material	Color/Finish	Check if matches existing
(If different from existing, attach sample)			
a. Exterior walls	rough sawn wood/cement panels/CMU		<input type="checkbox"/>
b. Trim	Metal/rough sawn wood		<input type="checkbox"/>
c. Windows	Kolbe Vistalux or similar		<input type="checkbox"/>
d. Doors	Kolbe Vistalux or similar		<input type="checkbox"/>
e. Roof	Standing Seam Bonderized		<input type="checkbox"/>
f. Chimneys	CMU or board formed conc		<input type="checkbox"/>
g. Decks & railings	Stainless Steel Cables		<input type="checkbox"/>
h. Stairs	rough sawn wood		<input type="checkbox"/>
i. Retaining walls	Board Form conc or CMU		<input type="checkbox"/>
j. Fences	wood		<input type="checkbox"/>
k. Accessory buildings	N/A		<input type="checkbox"/>
l. Garage/Carport	rough sawn wood		<input type="checkbox"/>

To approve this application, the County must determine that this project complies with all applicable regulations including the required findings that the project does conform to the standards and guidelines for design review applicable to the location of the project pursuant to Section 6565.10.

(optional) Applicant's Statement of project compliance with standards and guidelines (check if attached).

I hereby certify that the information stated above and on forms, plans, and other materials submitted herewith in support of the application is true and correct to the best of my knowledge. It is my responsibility to inform the County of San Mateo through my assigned project planner of any changes to information represented in these submittals.

Moss Beach
Associates LLC

Owner:

Applicant:

June 23, 2017

Date:

June 23, 2017

Date:

SECTION 6565.20(C), SITE PLANNING AND STRUCTURE PLACEMENT.

The houses are designed to use existing site topography and natural grading. The low, single-story entrance facades allow whitewater ocean view corridors between and through the houses from both Vallemar Street and Highway 1.

Corresponding to the steep topography, a “bridge” connects the motorcourt to the houses – allowing natural grade and vegetation to flow between the buildings; thereby, limiting grading beyond the footprints.

SECTION 6565.20(D), ELEMENTS OF DESIGN.

Utilizing the Facade Articulation Option, all sides of every house are heavily detailed with wall recesses, projections, decks, cantilevered roofs, and roof dormers adding visual intrigue to each property.

While the forms of the houses complement the nearby neighborhoods, the material palette is comprised of non-reflective, high-quality, exterior materials that provide a symbiotic aesthetic to the natural surrounding features - while also being durable within a marine climate.

Materials include rough-sawn wood siding applied as a water-resistant rainscreen, rigid cementitious paneling, stainless steel railings and flashings, natural looking board-formed concrete site walls, and a lasting metal roof with a “weathered” appearance. Additionally, extensive landscaping of native trees (existing and new), gabion walls comprised of indigenous rock, and locally-inspired “grape-stake” fencing seamlessly softens and blends the structure to the land.

SECTION 6565.20(E), ADDITIONAL SITE PLANNING AND DESIGN CONSIDERATIONS.

While each house is similar in style, through the use of alternating roof pitches, differing orientations, landscaping, and a variable color scheme - each lot becomes a unique (non cookie-cutter) house.

SECTION 6565.20(F), LANDSCAPING, PAVED AREAS, FENCES, LIGHTING AND NOISE.

The landscape architectural design for the Moss Beach project incorporates the protection and rehabilitation of native plant communities. It also includes measures to protect and expand the existing coastal prairie landscape adjacent to the bluffs, with boundaries to limit disturbance.

Selected trees will be preserved and protected to allow for the planting and successional establishment of new trees of varying canopy size. The planting design includes native species of shrubs and grasses adjacent to the proposed homes, which are suited to the coastal climate. The plant palette includes mostly drought tolerant planting irrigated with a water-efficient drip system. The goal is to limit impacts on the established biological systems while mindfully integrating the new landscape design.

The proposed homes at Moss Beach will improve and preserve the existing native landscape, enhance the built neighborhood, and ultimately maintain public access to the coastal trail for perpetuity.



Project Name: **Proposed Moss Beach Homes**
Project Location: **Vallemar St. and Juliana Ave.
Moss Beach, CA 94038**

Project Narrative:

The proposed development is situated near Vallemar Bluffs within a majestic unbuilt lot in San Mateo County.

Formerly submitted as 6 houses densely built on 7 lots. The existing lot lines are being amended to facilitate 4 houses on 4 lots to minimize visual impact and reduce intrusion into the nearby sensitive natural habitat.

In concordance with the San Mateo County Design Review Standards, [*Chapter 28.1 Design Review Standards – Section 6565.20 Standards for Design for One-Family and Two-Family Residential Development in the Midcoast (Moss Beach)*] the architectural and landscape aesthetics of the houses strive to become endearing figures of the neighborhood yet in harmony with, and emboldened by, the unique natural surroundings of Vallemar Bluffs.

SECTION 6565.20(B). NEIGHBORHOOD DEFINITION AND NEIGHBORHOOD CHARACTER.

The immediate surroundings contain a biodiverse habitat consisting of cypress trees, native grasslands, rare flowers, and dramatic cliff-side bluffs. The larger (built) neighborhood context within 300' of the houses lies the Cabrillo Highway (Highway 1), and a handful of houses with similar ocean views.

Within this context, the houses perform the difficult task of responding to the limited nearby neighborhood character, while also taking visual cues to respect, preserve, and blend within the immediate natural habitat.


On the top (northwest) portion of the site, the houses are nestled between existing (and new) cypress trees at the edge of the 50' road setback. However, taking visual cues from the adjacent bluffs, the houses dramatically expand down the natural slope to encapsulate the breadth of the coastline vistas.

Through the extensive use of natural materials - the houses blend with the natural site features to reduce visual intrusion and harmonize within the existing context.



San Mateo County

DRC Mailing
01/22/2019

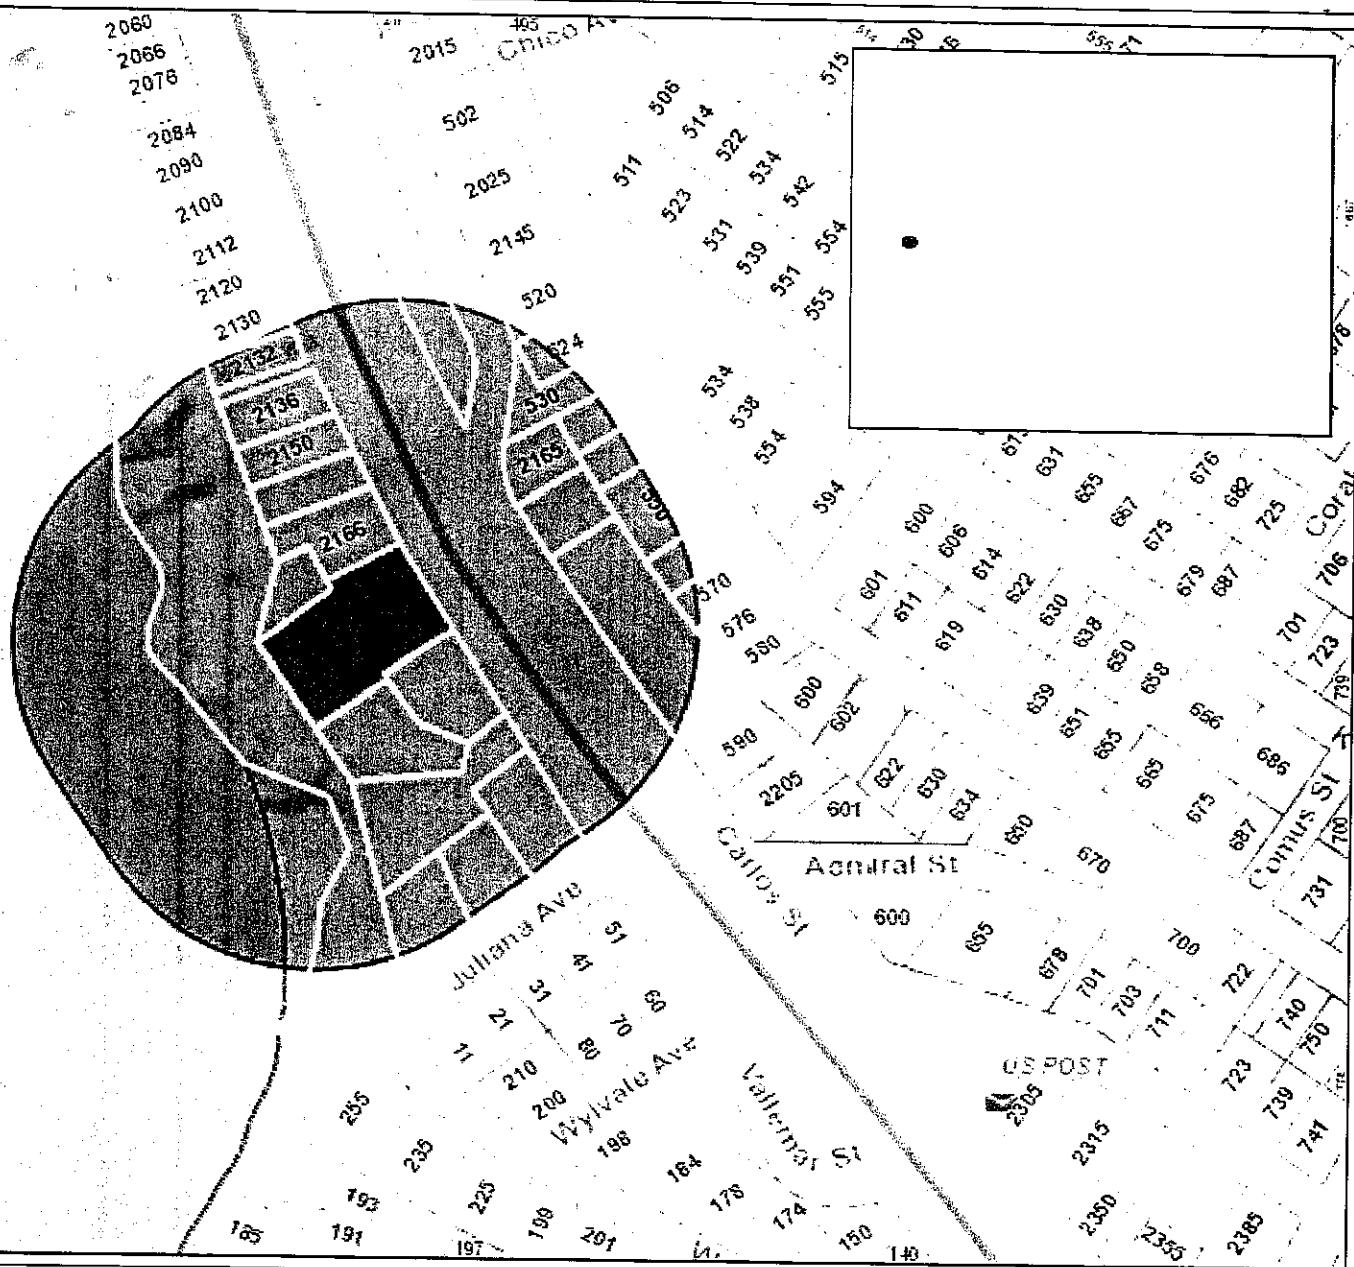

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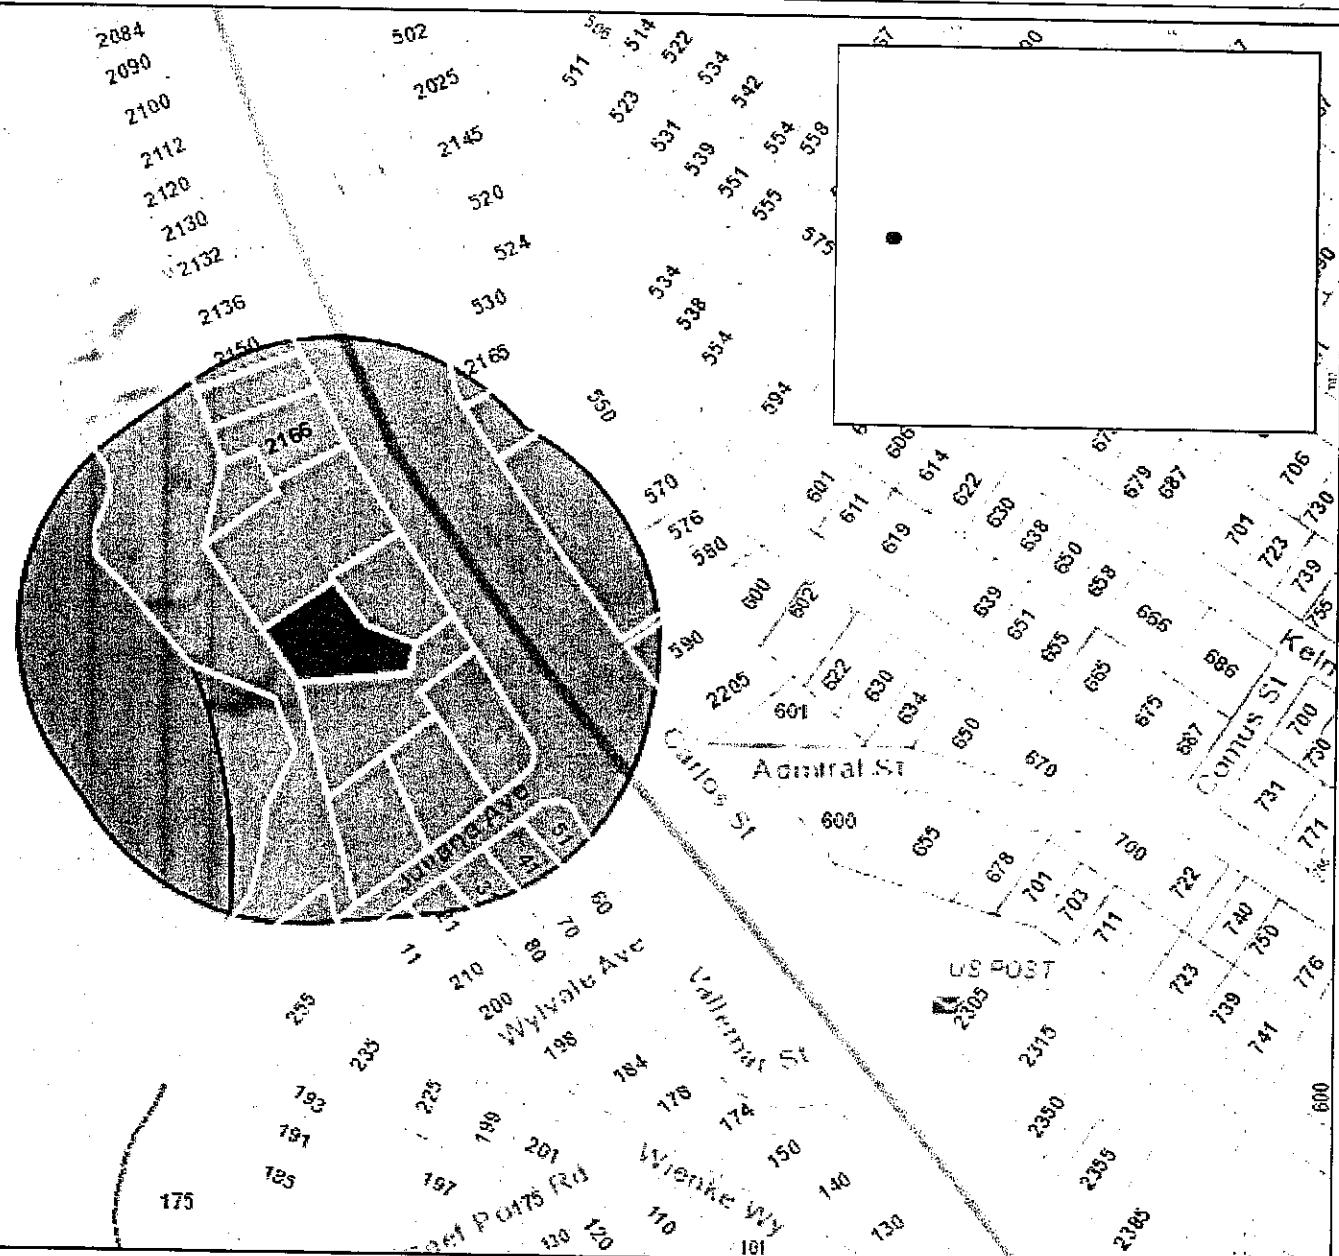
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San Mateo County



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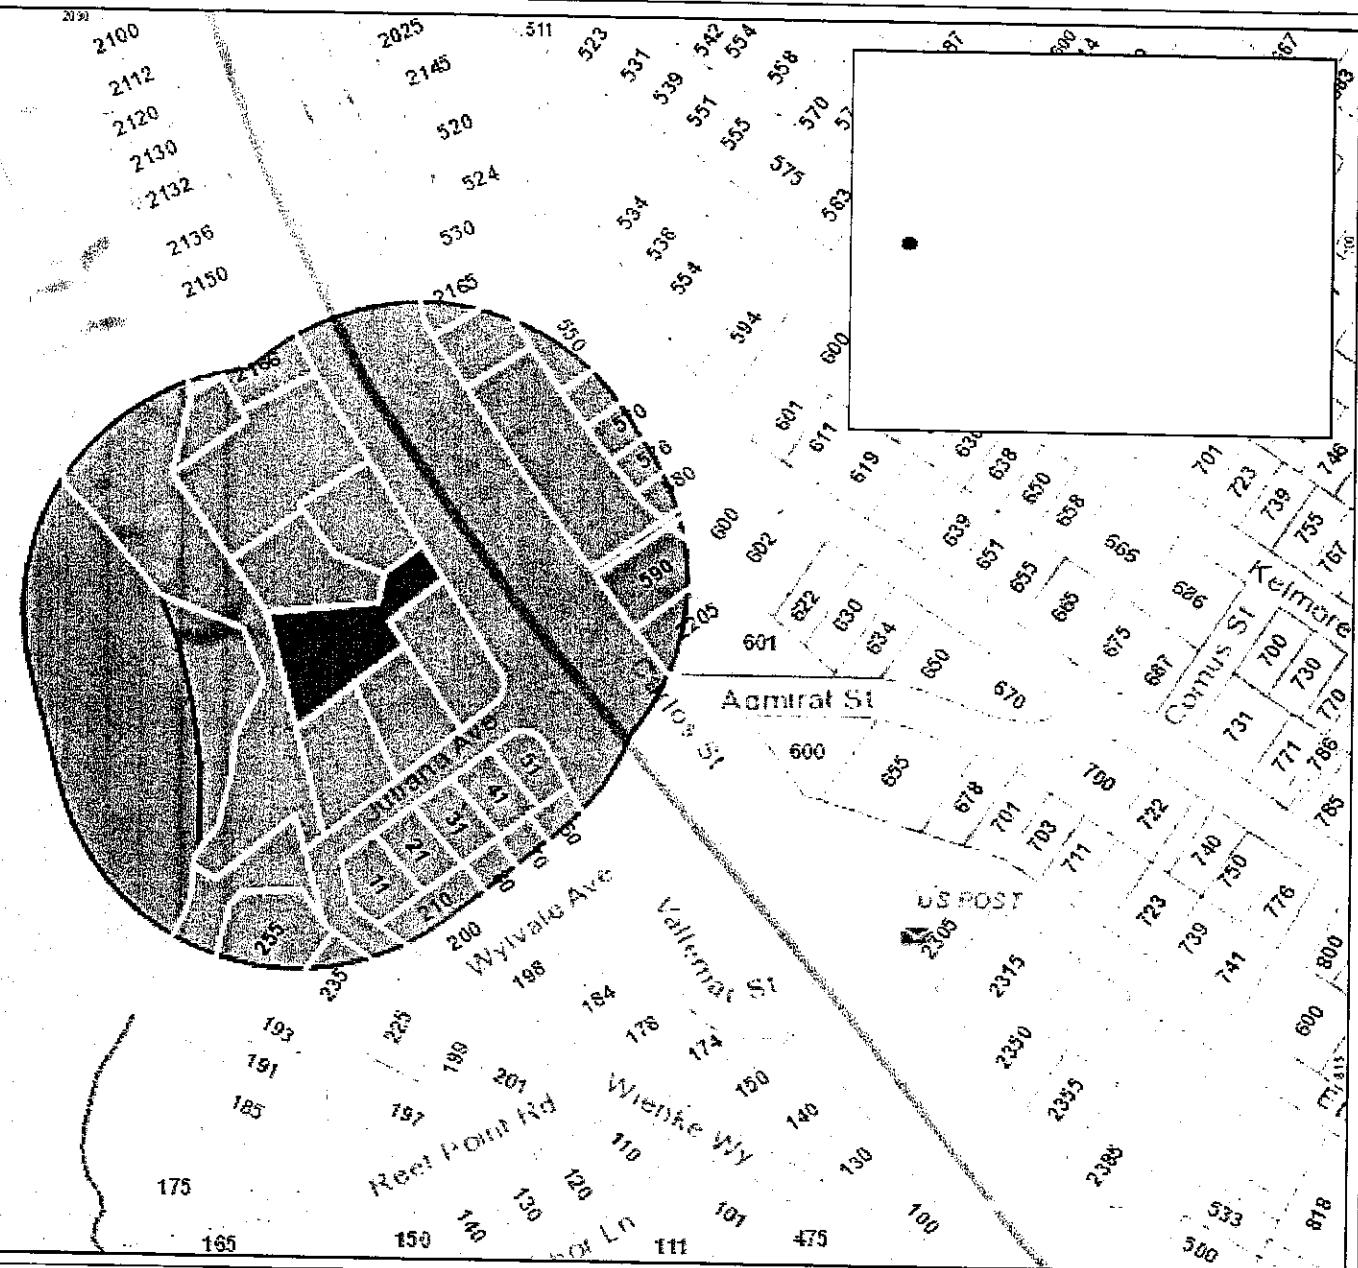


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San Mateo County



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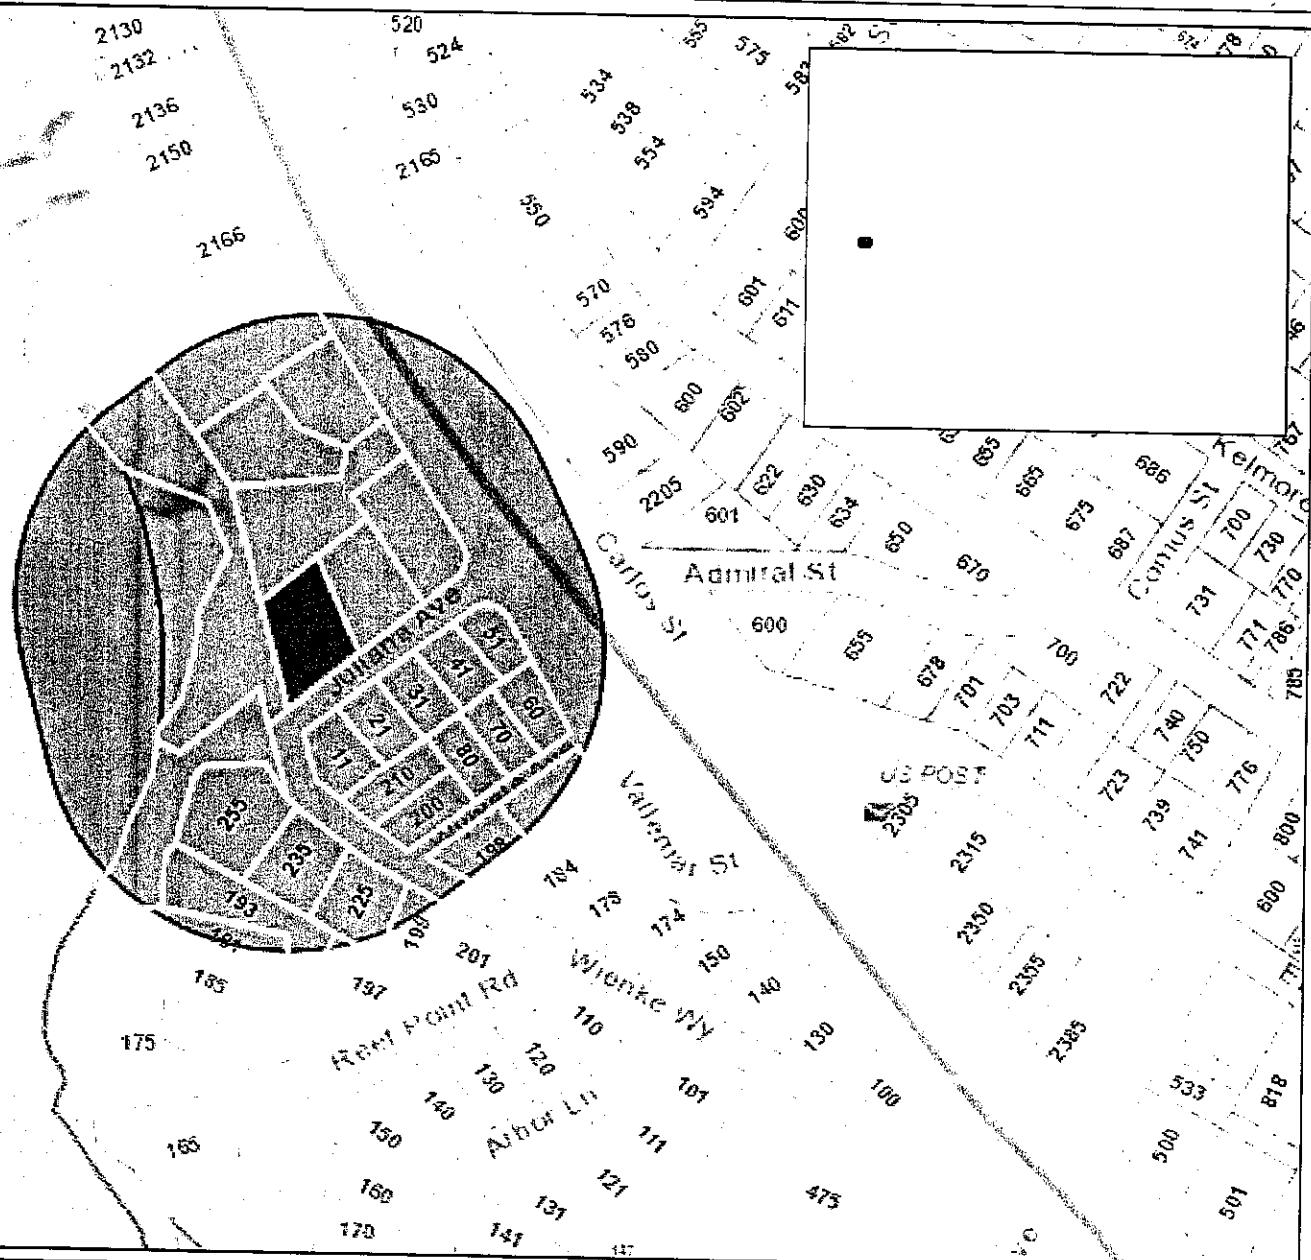
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San Mateo County



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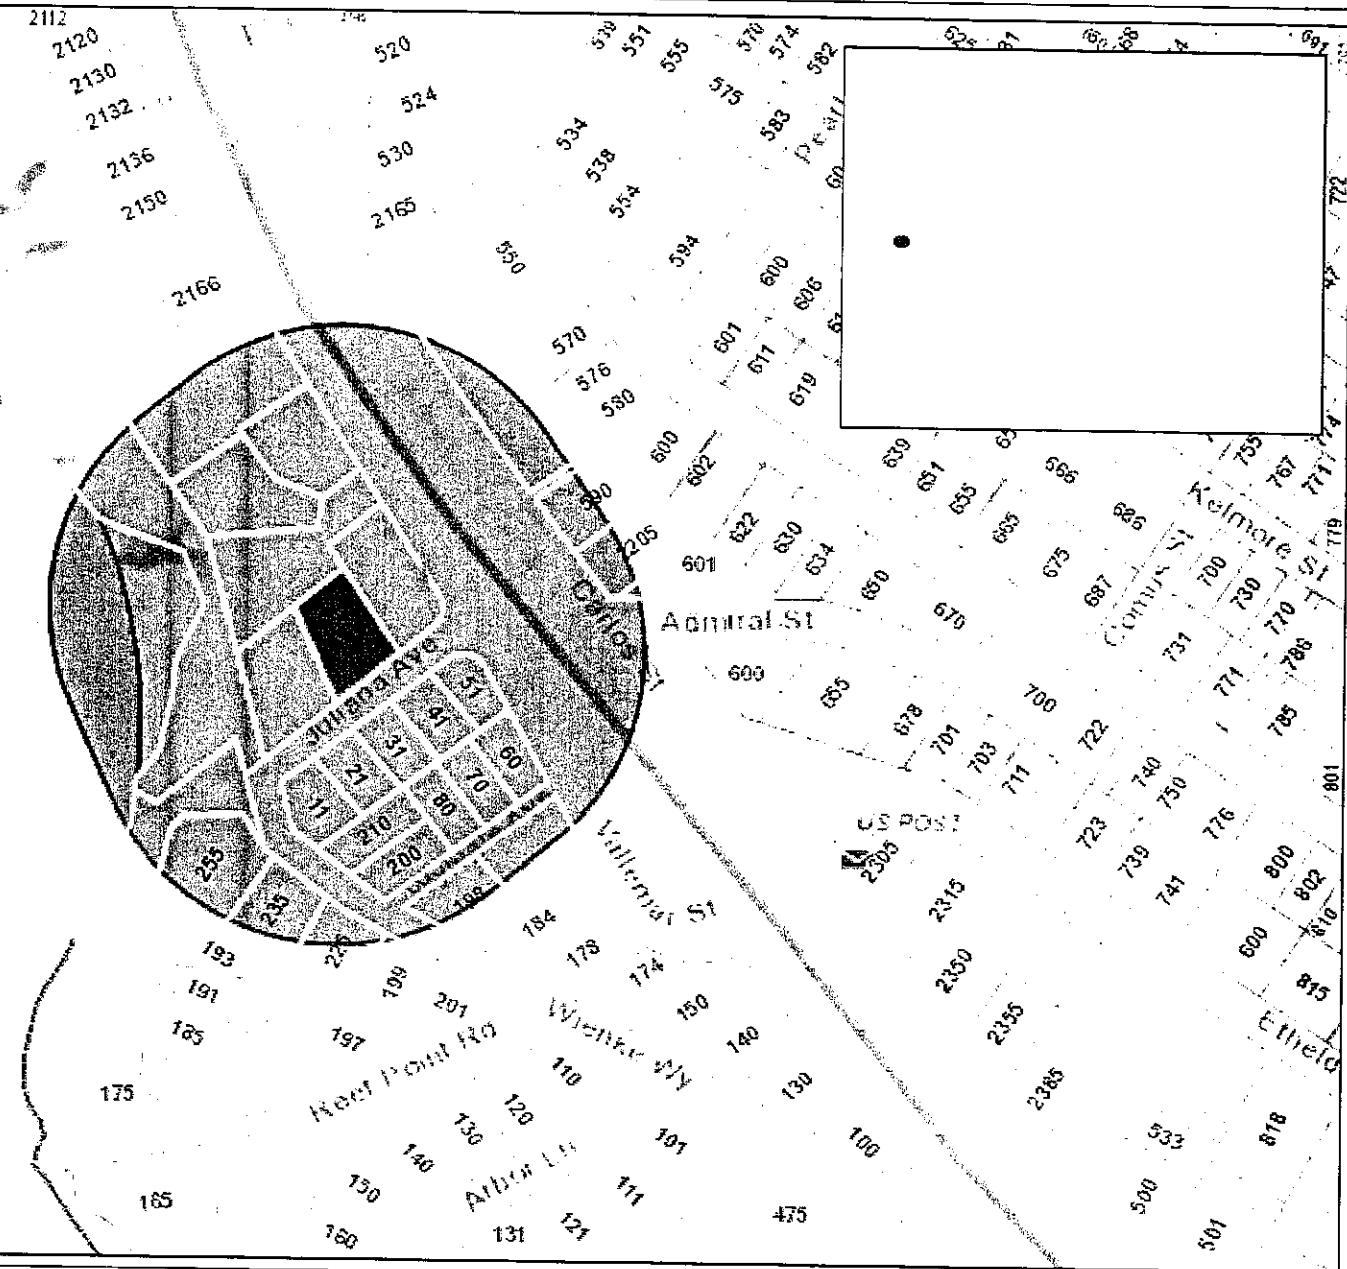


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San Mateo County



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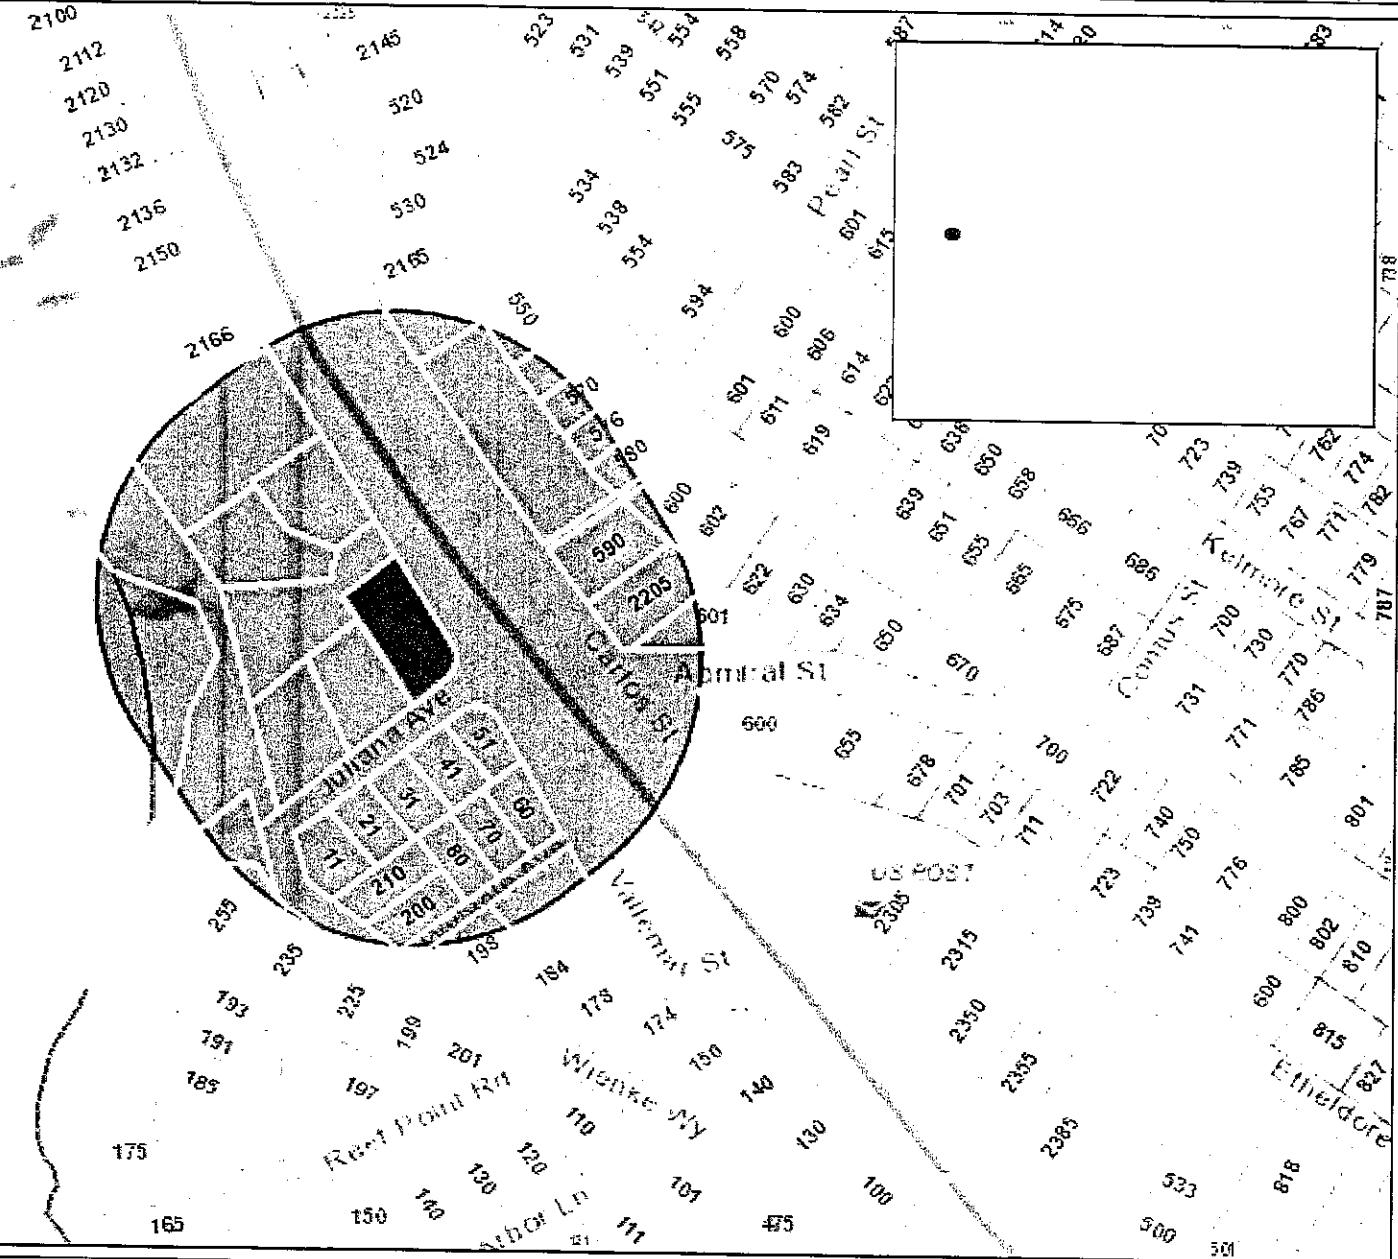
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San Mateo County



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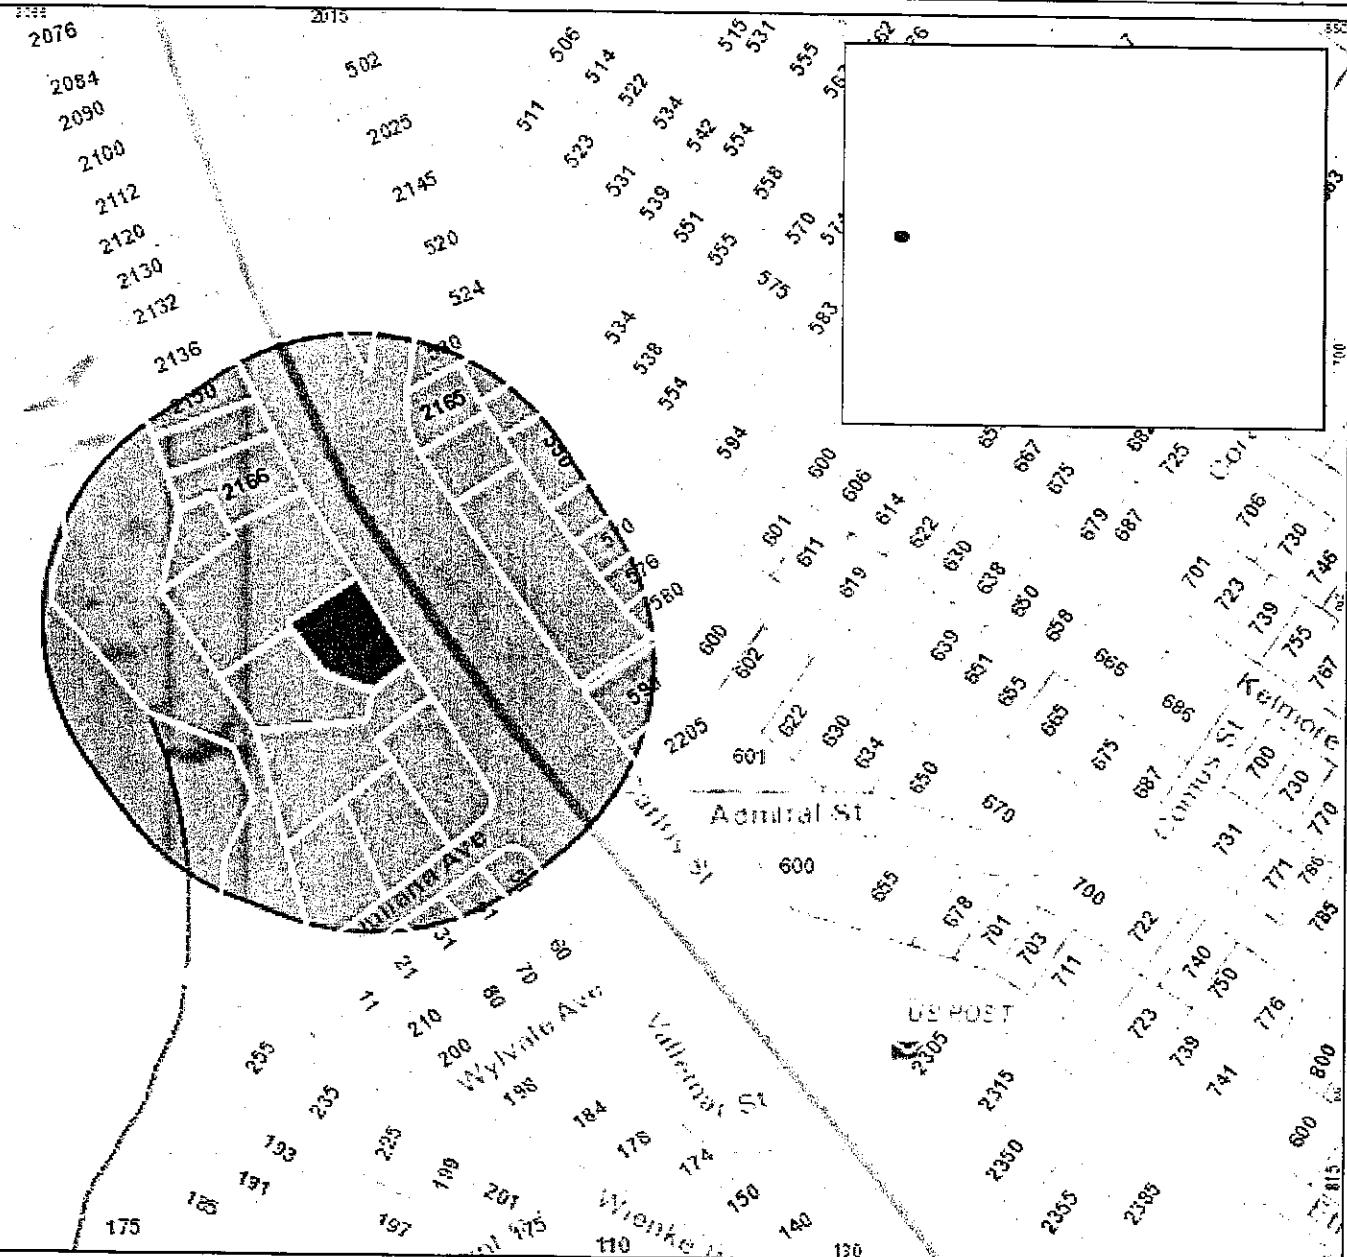
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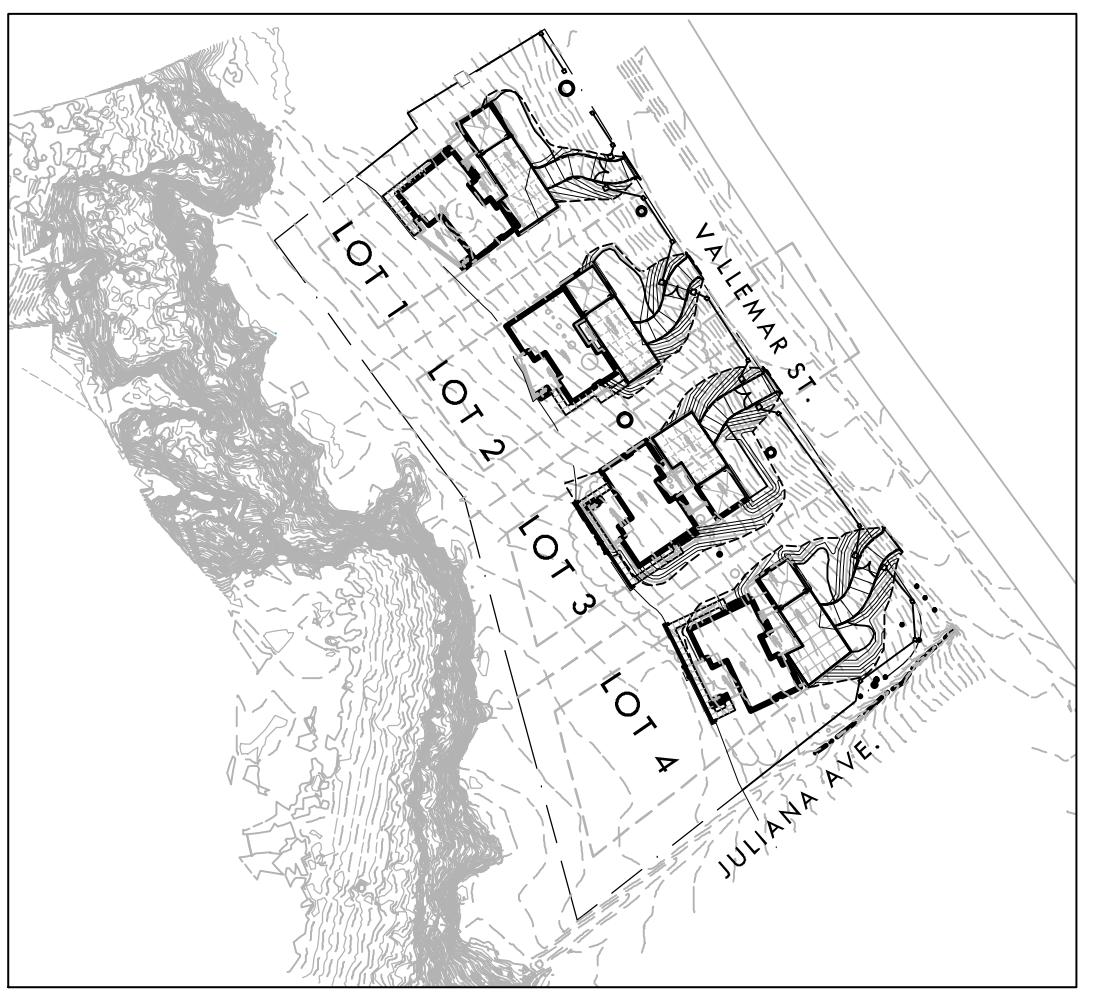
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PROJECT MAPS



VICINITY MAP



SITE MAP

APPLICABLE CODES

1. 2013 CBC CHAPTER 35; PROVIDE ALL THE APPLICABLE/ADOPTED STANDARDS, WHERE A PARTICULAR STANDARD IS REFERENCED IN THE CODE BUT DOES NOT APPEAR AS AN ADOPTED STANDARD IT MAY STILL BE USED. APPLY ONLY THE PORTION OF THE STANDARD THAT IS APPLICABLE TO THE CODE SECTION WHERE THE STANDARD IS REFERENCED, NOT THE ENTIRE STANDARD.
- 2013 BUILDING STANDARDS ADMINISTRATIVE CODE, PART 1, TITLE 24 C.C.R.
2013 CALIFORNIA BUILDING CODE (CBC), PART 2, TITLE 24 C.C.R.
(2012 INTERNATIONAL BUILDING CODE VOLUMES 1-2 AND 2013 CALIFORNIA AMENDMENTS)
- 2013 CALIFORNIA ELECTRICAL CODE (CEC), PART 3, TITLE 24 C.C.R.
(2011 NATIONAL ELECTRICAL CODE AND 2013 CALIFORNIA AMENDMENTS)
- 2013 CALIFORNIA MECHANICAL CODE (CMC) PART 4, TITLE 24 C.C.R.
(2012 UNIFORM MECHANICAL CODE AND 2013 CALIFORNIA AMENDMENTS)
- 2013 CALIFORNIA PLUMBING CODE (CDC), PART 5, TITLE 24 C.C.R.
(2012 UNIFORM PLUMBING CODE AND 2013 CALIFORNIA AMENDMENTS)
- 2013 CALIFORNIA ENERGY CODE, PART 6, TITLE 24 C.C.R.
(2012 INTERNATIONAL ENERGY CODE AND 2013 CALIFORNIA AMENDMENTS)
- 2013 CALIFORNIA FIRE CODE, PART 9, TITLE 24 C.C.R.
(2012 INTERNATIONAL FIRE CODE AND 2013 CALIFORNIA AMENDMENTS)
- CALIFORNIA EXISTING BUILDING CODE, PART 10, TITLE 24 C.C.R.
(2011 INTERNATIONAL EXISTING BUILDING CODE AND 2013 CALIFORNIA AMENDMENTS)
- 2013 CALIFORNIA "GREEN" BUILDING REQUIREMENTS OR CAL GREEN, PART 11, TITLE 24 C.C.R.
- 2013 CALIFORNIA REFERENCED STANDARDS, PART 12, TITLE 24 C.C.R.
(2012 INTERNATIONAL REFERENCED STANDARDS AND 2013 CALIFORNIA AMENDMENTS)
- 2013 TITLE 19 C.C.R., PUBLIC SAFETY, STATE FIRE MARSHAL REGULATIONS.
- LIST OF FEDERAL CODES AND STANDARDS (IF APPLICABLE)
AMERICANS WITH DISABILITIES ACT (ADA), TITLE II OR TITLE III
FOR TITLE II: UNIFORM FEDERAL ACCESSIBILITY STANDARDS (UFAS)
FOR ADA STANDARDS FOR ACCESSIBLE DESIGN (APPENDIX A OF 28 CFR PART 36)
FOR TITLE III: ADA STANDARDS FOR ACCESSIBLE DESIGN (APPENDIX A OF 28 CFR PART 36)
2010 AMERICANS WITH DISABILITIES ACT (ADA) STANDARDS FOR ACCESSIBLE DESIGN
- NOTE: TITLE II APPLIES TO PROJECTS FUNDED AND/OR USED BY STATE AND LOCAL GOVERNMENT SERVICES. TITLE III COVERS PUBLIC ACCOMMODATIONS AND COMMERCIAL FACILITIES. DEPENDING ON THE USE AND FUNDING, BOTH TITLE MAY APPLY TO THE PROJECT.
- | | | |
|-----------|--|--------------|
| NFFPA 13 | AUTOMATIC SPRINKLER SYSTEMS | 2013 EDITION |
| NFFPA 14 | STANDPIPE SYSTEMS | 2013 EDITION |
| NFFPA 17 | DRY CHEMICAL EXTINGUISHING SYSTEMS | 2013 EDITION |
| NFFPA 17A | WET CHEMICAL SYSTEMS | 2013 EDITION |
| NFFPA 20 | STATIONARY PUMPS | 2013 EDITION |
| NFFPA 24 | PRIVATE MAINS | 2013 EDITION |
| NFFPA 72 | NATIONAL FIRE ALARM CODE (CALIFORNIA AMENDED)
(NOTE SEE STANDARD 1977 FOR "VISUAL DEVICES") | 2013 EDITION |
| NFFPA 253 | CRITICAL RADIANT FLUX OF FLOOR COVERING SYSTEMS | 2011 EDITION |
| NFPA 2001 | CLEAN AGENT FIRE EXTINGUISHING SYSTEMS | 2012 EDITION |
| ASME 17.1 | ELEVATOR STANDARD | 2013 EDITION |
- REFERENCE CODE SECTIONS FOR APPLICABLE STANDARDS - 2013 CALIFORNIA BUILDING CODE (FOR SFM) REFERENCED STANDARDS CHAPTER 35
- ADA STANDARD FOR ACCESSIBLE DESIGN (APPENDIX A OF 28 CFR PART 36)

DESIGN REVIEW DRAWINGS FOR PROPOSED MOSS BEACH HOMES

Vallemar St. and Juliana Ave
Moss Beach, CA 94038

PREPARED BY



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BOZEMAN, MT 59715
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Civil Engineering
Sport Planning & Design
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CONTACT INFORMATION

ORGANIZATION	NAME	PHONE
APPLICANT MOSS BEACH ASSOCIATES, LLC	OWEN LAWLOR	(831) 457-1331
CIVIL ENGINEER MESITI-MILLER ENGINEERING, INC.	RODNEY CAHILL	(831) 426-3186
LANDSCAPE ARCHITECT VERDE DESIGN INC.	MARK BAGINSKI	(408) 850-3411
ARCHITECT PEARSON DESIGN GROUP	LARRY PEARSON	(406) 587-1997

PROJECT DESCRIPTION

THE PROPOSED PROJECT CONSISTS OF 5 NEW SINGLE-FAMILY DWELLINGS ON 7 LOTS OF RECORD. THE HOMES ARE DESIGNED TO BE CONSISTENT WITH THE COUNTY'S DESIGN GUIDELINES AND THE SAN MATEO COUNTY MID-COAST 2013 LOCAL COASTAL PLAN. THE HOMES SETTLE INTO THE SITE AND UTILIZE THE NATURAL TOPOGRAPHY TO MINIMIZE THE VISUAL IMPACT OF THE PROPOSED DEVELOPMENT FROM AS SEEN FROM HIGHWAY 1. THE HOMES ARE PROPOSED TO USE NATURAL AND LOGICALLY-CONSISTENT MATERIALS INCLUDING ROUGH-SAWN CEDAR OR REDWOOD, BOARD FORMED CONCRETE, AND SCREED BALLAST ON THE FLAT ROOF PORTIONS.


THE LOTS ARE LOCATED WEST OF VALLEMAR ST, EAST OF THE VALLEMAR BLUFF PATH (THE STRAND). THE HOMES ARE DESIGNED TO BE CONSISTENT WITH THE COUNTY'S DESIGN GUIDELINES AND THE SAN MATEO COUNTY MID-COAST 2013 LOCAL COASTAL PLAN. THE HOMES SETTLE INTO THE SITE AND UTILIZE THE NATURAL TOPOGRAPHY TO MINIMIZE THE VISUAL IMPACT OF THE PROPOSED DEVELOPMENT FROM AS SEEN FROM HIGHWAY 1. THE HOMES ARE PROPOSED TO USE NATURAL AND LOGICALLY-CONSISTENT MATERIALS INCLUDING ROUGH-SAWN CEDAR OR REDWOOD, BOARD FORMED CONCRETE, AND SCREED BALLAST ON THE FLAT ROOF PORTIONS.

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	ARCHITECTURAL PLANS	A1.1	SITE PLAN
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		A2.3	MAIN LEVEL PLAN
		A2.4	COURTYARD PLAN
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		A4.1-4.2	EXTERIOR ELEVATIONS
			BUILDING SECTIONS
	LOT 1		
A0.1	VICINITY MAP & PROPERTY SUMMARY		
A1.1	AREA PLAN CALCULATIONS		
A2.1	SITE PLAN		
A2.2	LOWER LEVEL PLAN		
A2.3	MAIN LEVEL PLAN		
A2.4	COURTYARD PLAN		
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A3.1-3.4	EXTERIOR ELEVATIONS		
A4.1-4.2	BUILDING SECTIONS		

PROPOSED PERSPECTIVE VIEW



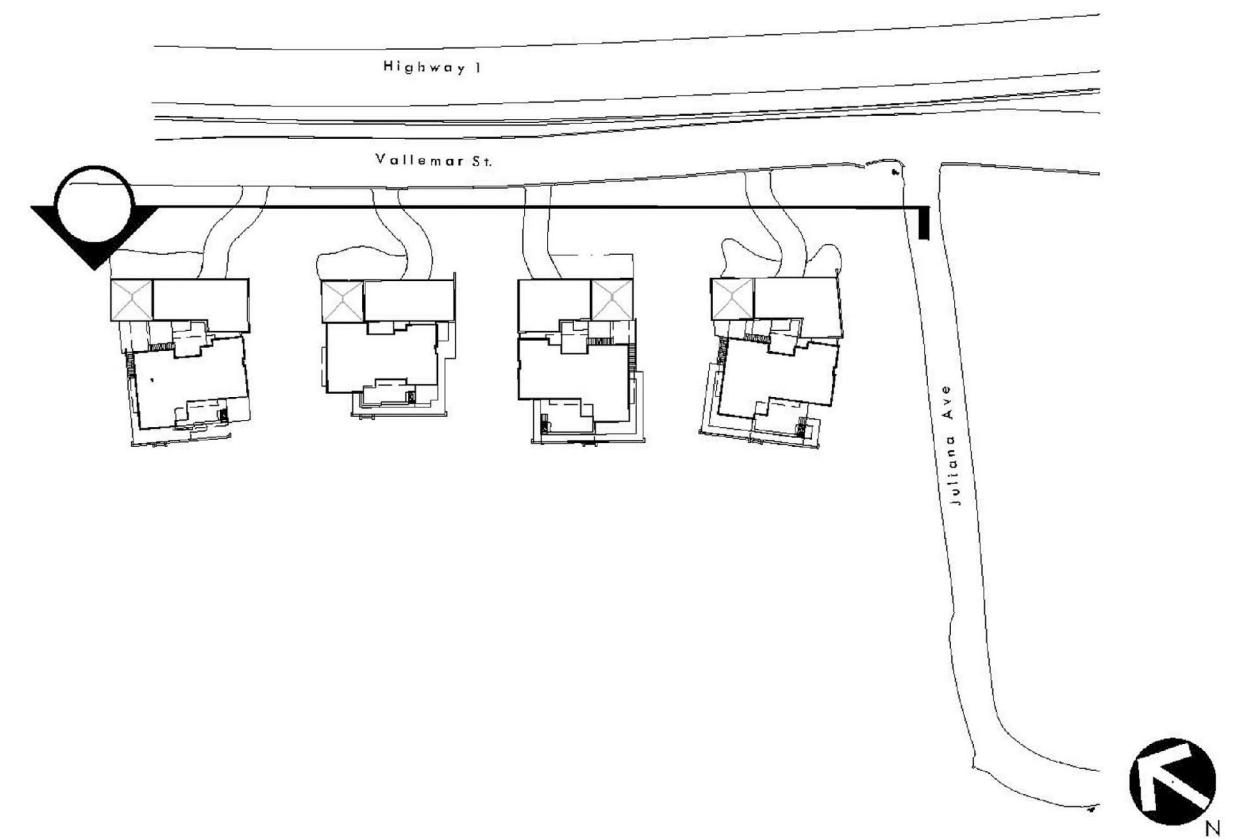

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STAMP
REGISTERED LANDSCAPE ARCHITECT
MARK S. BAGINSKI
No. 4089
Signature
EXPIRATION DATE
JULY 2019
STATE OF CALIFORNIA

CONSULTANT

SHEET TITLE
**VALLEMAR ST.
ELEVATION/
PERSPECTIVE**

PROJECT NAME
**MOSS BEACH
OCEAN
DEVELOPMENT**

PROJECT ADDRESS
**VALLEMAR ST. &
JULIANA AVE
MOSS BEACH, CA**

SUBMITTAL	DATE
DESIGN REVIEW APPLICATION	08/21/15
DESIGN REVIEW RESUBMITTAL	08/09/16


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DATE ISSUED 08/23/17	SCALE AS SHOWN

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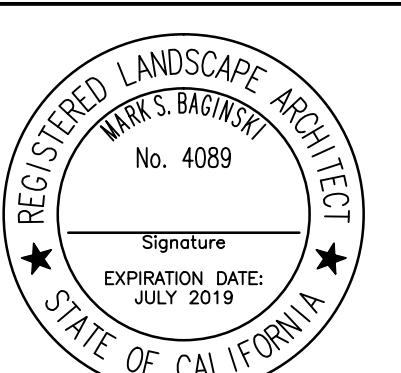
SHEET NO.
L1.1

OF SHEETS



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CIVIL ENGINEERING
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Santa Clara, CA 95050
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CONSULTANT

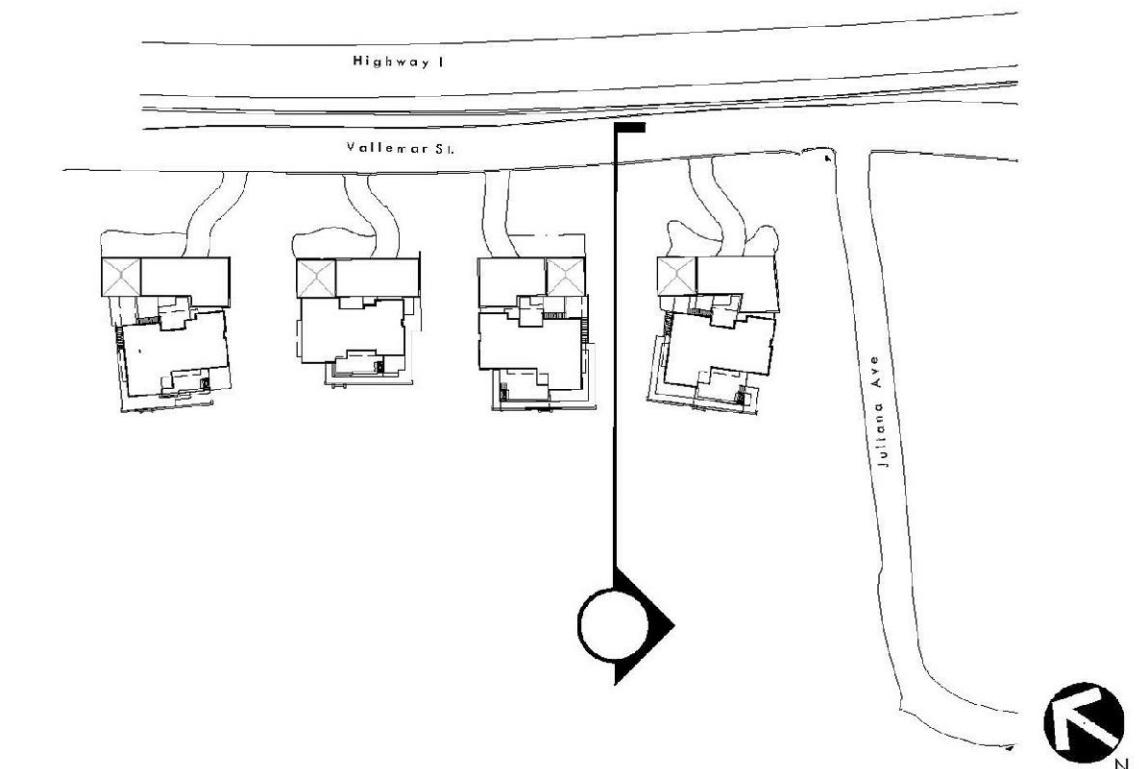SHEET TITLE

SITE SECTION

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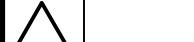
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08/09/16

NO.

REVISIONS

DATE



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DATE ISSUED

08/23/17

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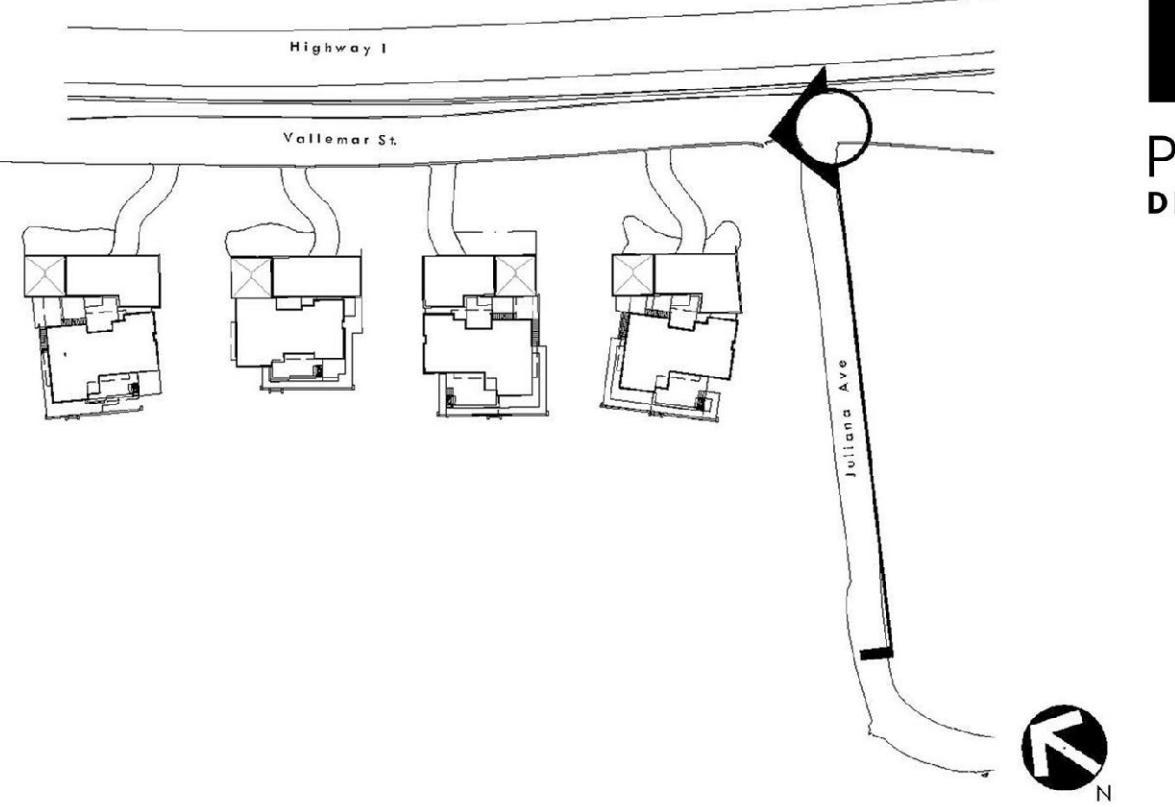
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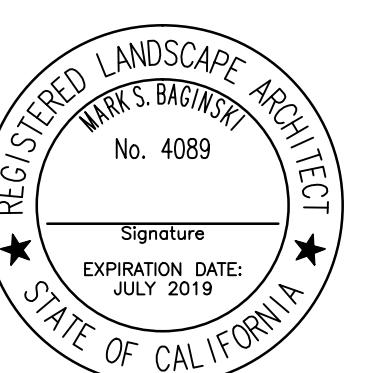
L1.2

OF

SHEETS



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CONSULTANT

SHEET TITLE
**JULIANA AVE.
SECTION/
PERSPECTIVE**


PROJECT NAME
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PROJECT ADDRESS
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DATE ISSUED 08/23/17	SCALE AS SHOWN
PROJ. NO. 1500600-1668	
SHEET NO. L1.3	OF SHEETS



Legend

MONUMENT /OUND AS NOTED
SAN. SEWER MANHOLE
STORM DRAIN MANHOLE
LIRE DRANT
TELEMAR
INDICATES RECORD DATA
INDICATES RADIAL LEARNIN
RECORD D CALULATED DATA
INV. INVERT ELEVATION

ATR VALVE
DRAIN INLET
SURVEY CONTROL POINT
SAN. SEWER CLEANOUT
UTILITO LINE

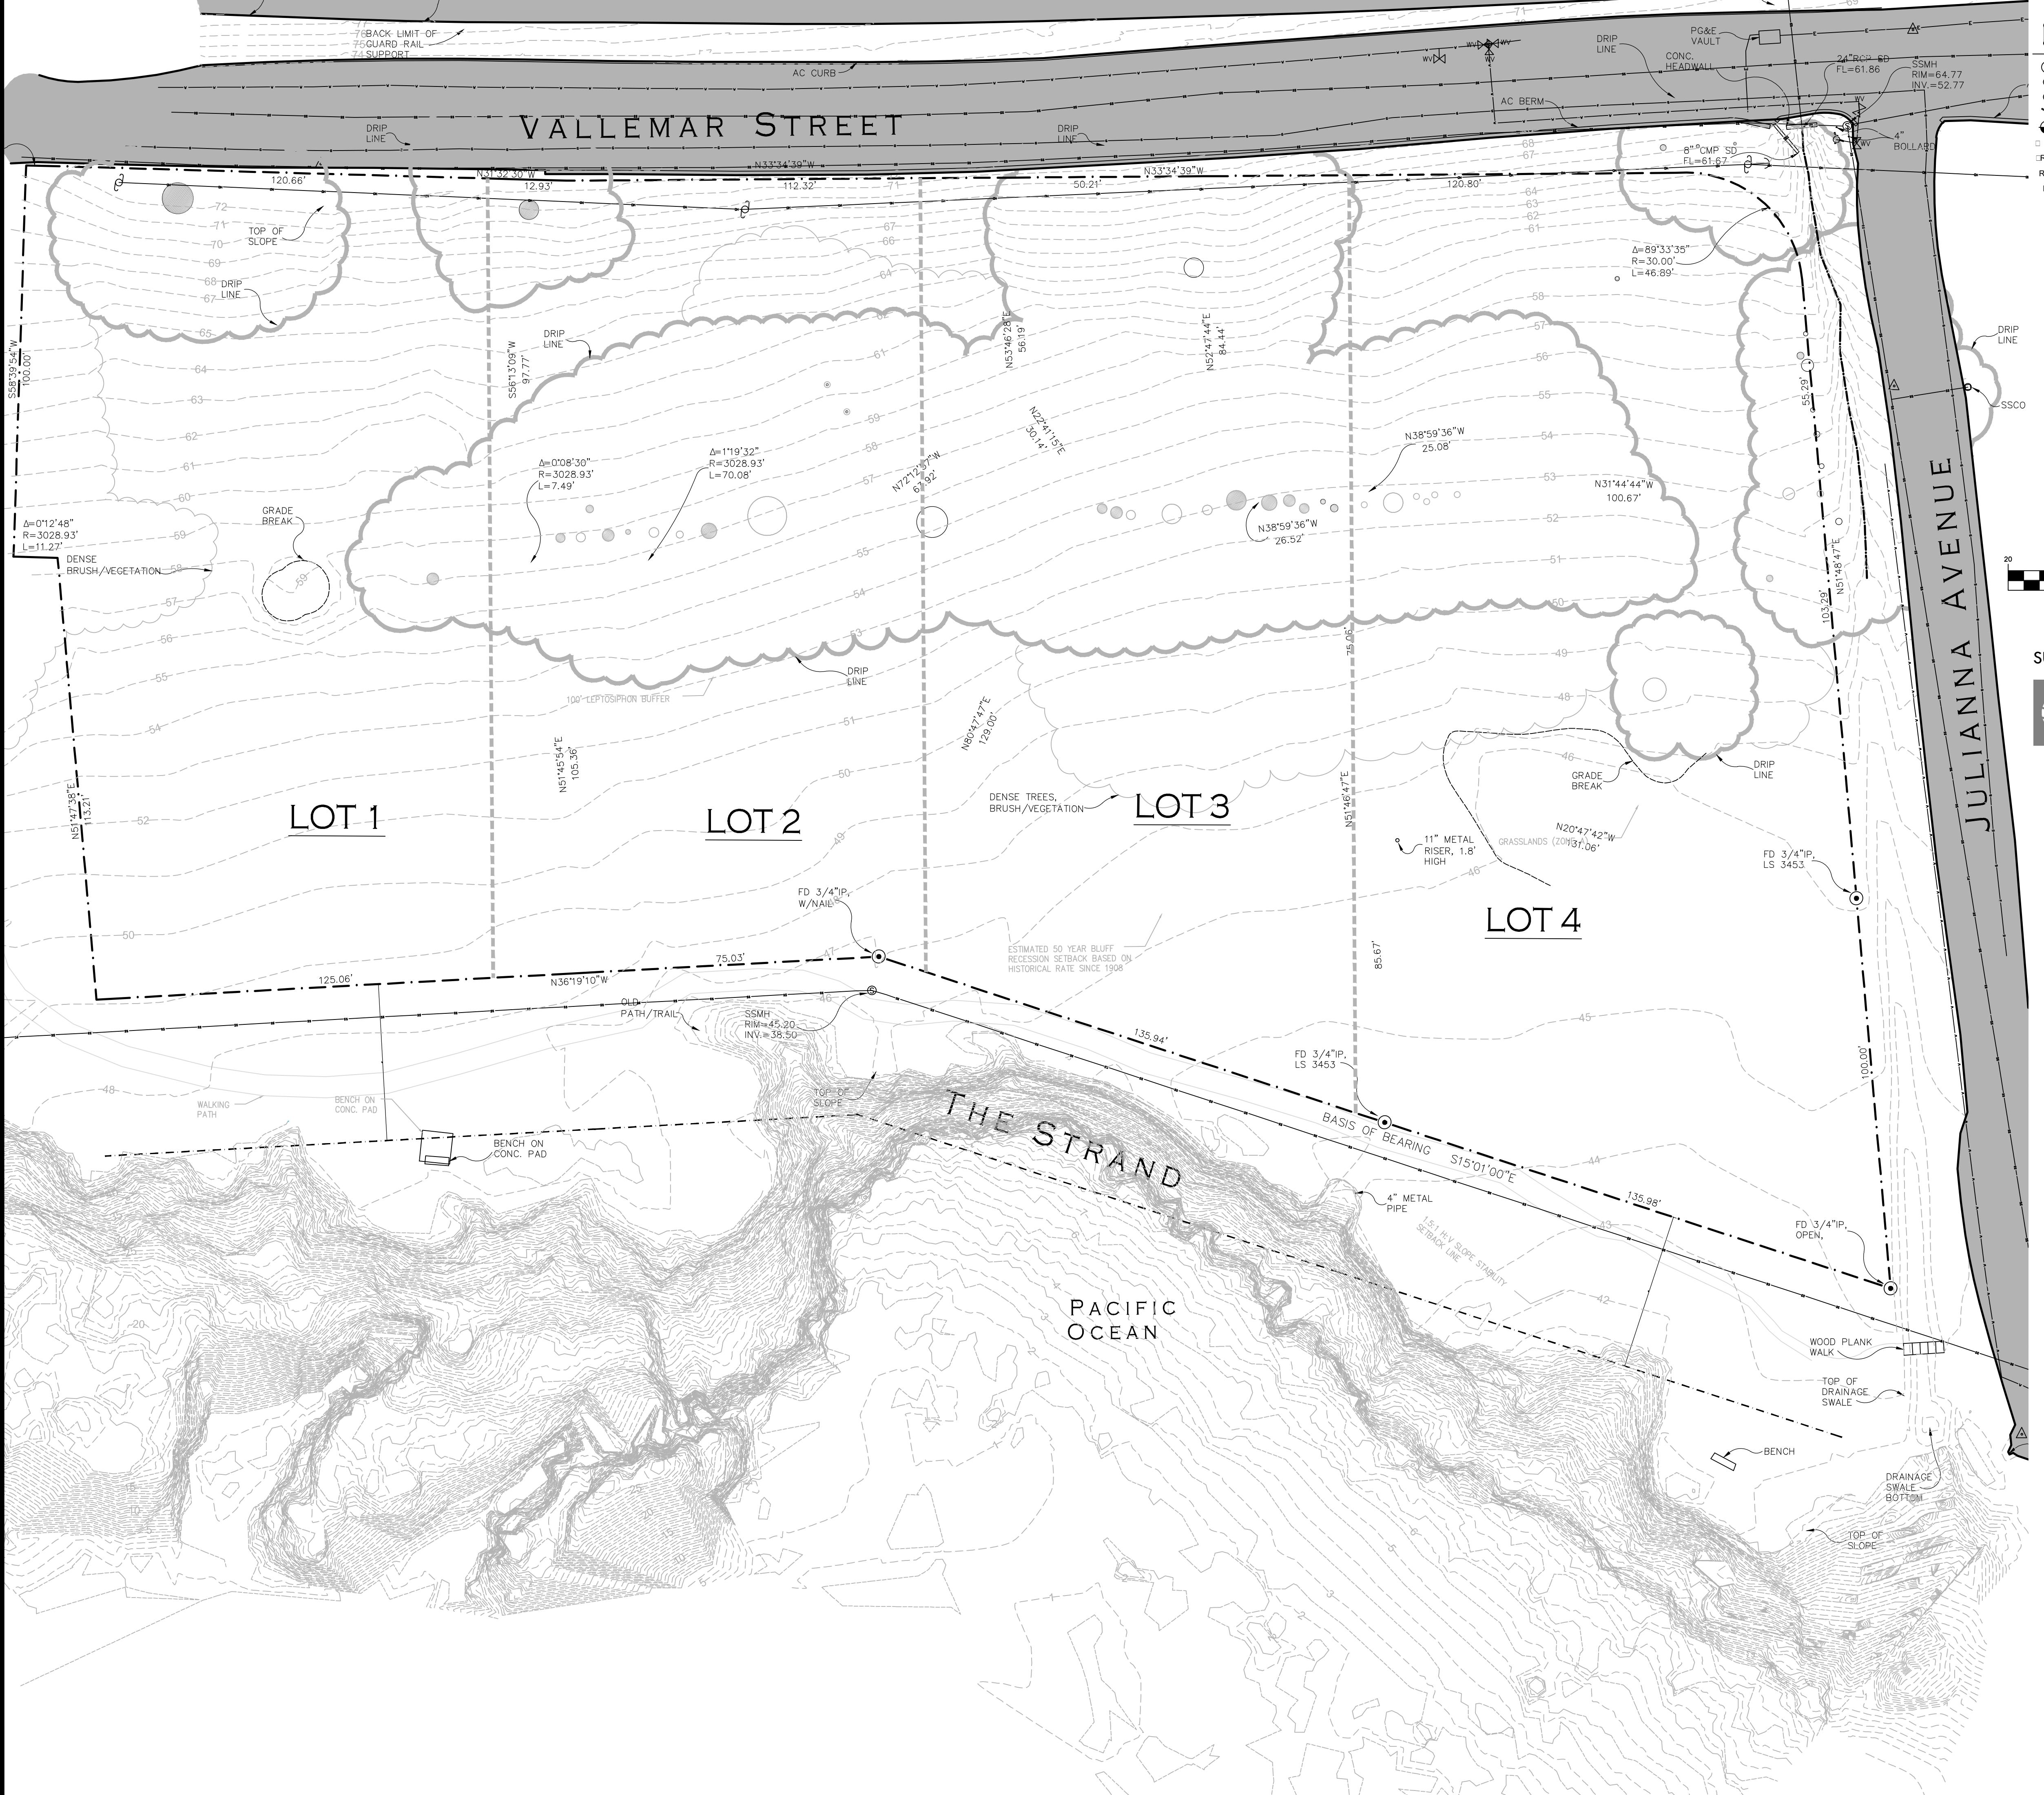CUD CIRE
GRT RATE

MULTIPLE TREES
TO IN TREES

ASCE 7-16 CONCRETE SLABDED

Drip Line

DENSE TREES/ROUSE VEGETATION

ATER LINE (ER) PAINT MARKINGS

SANITAR SEWER LINE

STORM DRAIN LINE

OVERHEAD UTILIT LINE

DAS LINE (ER) PAINT MARKINGS

VERDE DESIGN
LANDSCAPE ARCHITECTURE
CIVIL ENGINEERING
SPORT PLANNING & DESIGN
2455 The Alameda
Santa Clara, CA 95050
tel: 408.985.7200
fax: 408.985.7260
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CONSULTANT

SURVEY PERFORMED BY:

IFLAND SURVEY
Surveying - Mapping - GPS

303 Potrero Street, Suite 43-108, Santa Cruz, CA 95060
Tel 831.426.7941 Fax 831.426.6266

Basis of Bearings

The Basis of Bearings for this Survey is Set Between Monuments /ound Along the North-East Line of The Strand as shown on the Record of Survey filed in Volume 13 of the San Mateo County Records.

BASIS OF BEARINGS = S 15°01'00" E

Benchmark

N.S. EN. MAR. S 1240
2.12' PASS DIS STAM ED "S 1240" 1973 SET IN THE CONCRETE
EAD ALL O. A 24" TIE ON THE SOUTH EAST END AT THE INTERSECTION O
STATE C. A. 1 AND E. ELDORO STREET.

EN. MAR. ELEVATION 60.91 NAVD 88

EXISTING CONDITIONS PLAN

PROJECT NAME

**MOSS BEACH
OCEAN
DEVELOPMENT**

PROJECT ADDRESS

**VALLEMAR ST. &
JULIANA AVE
MOSS BEACH, CA**

SUBMITTAL

DATE

DESIGN REVIEW APPLICATION

08/21/15

DESIGN REVIEW RESUMMITAL

08/09/16

NO. REVISIONS

DATE

DRAWN BY

CHECKED BY

PH MB

DATE ISSUED

SCALE

08/23/17 AS SHOWN

PROJ. NO.


1500600-1668

SHEET NO.

L2.1

OF SHEETS

EXISTING CONDITIONS PLAN

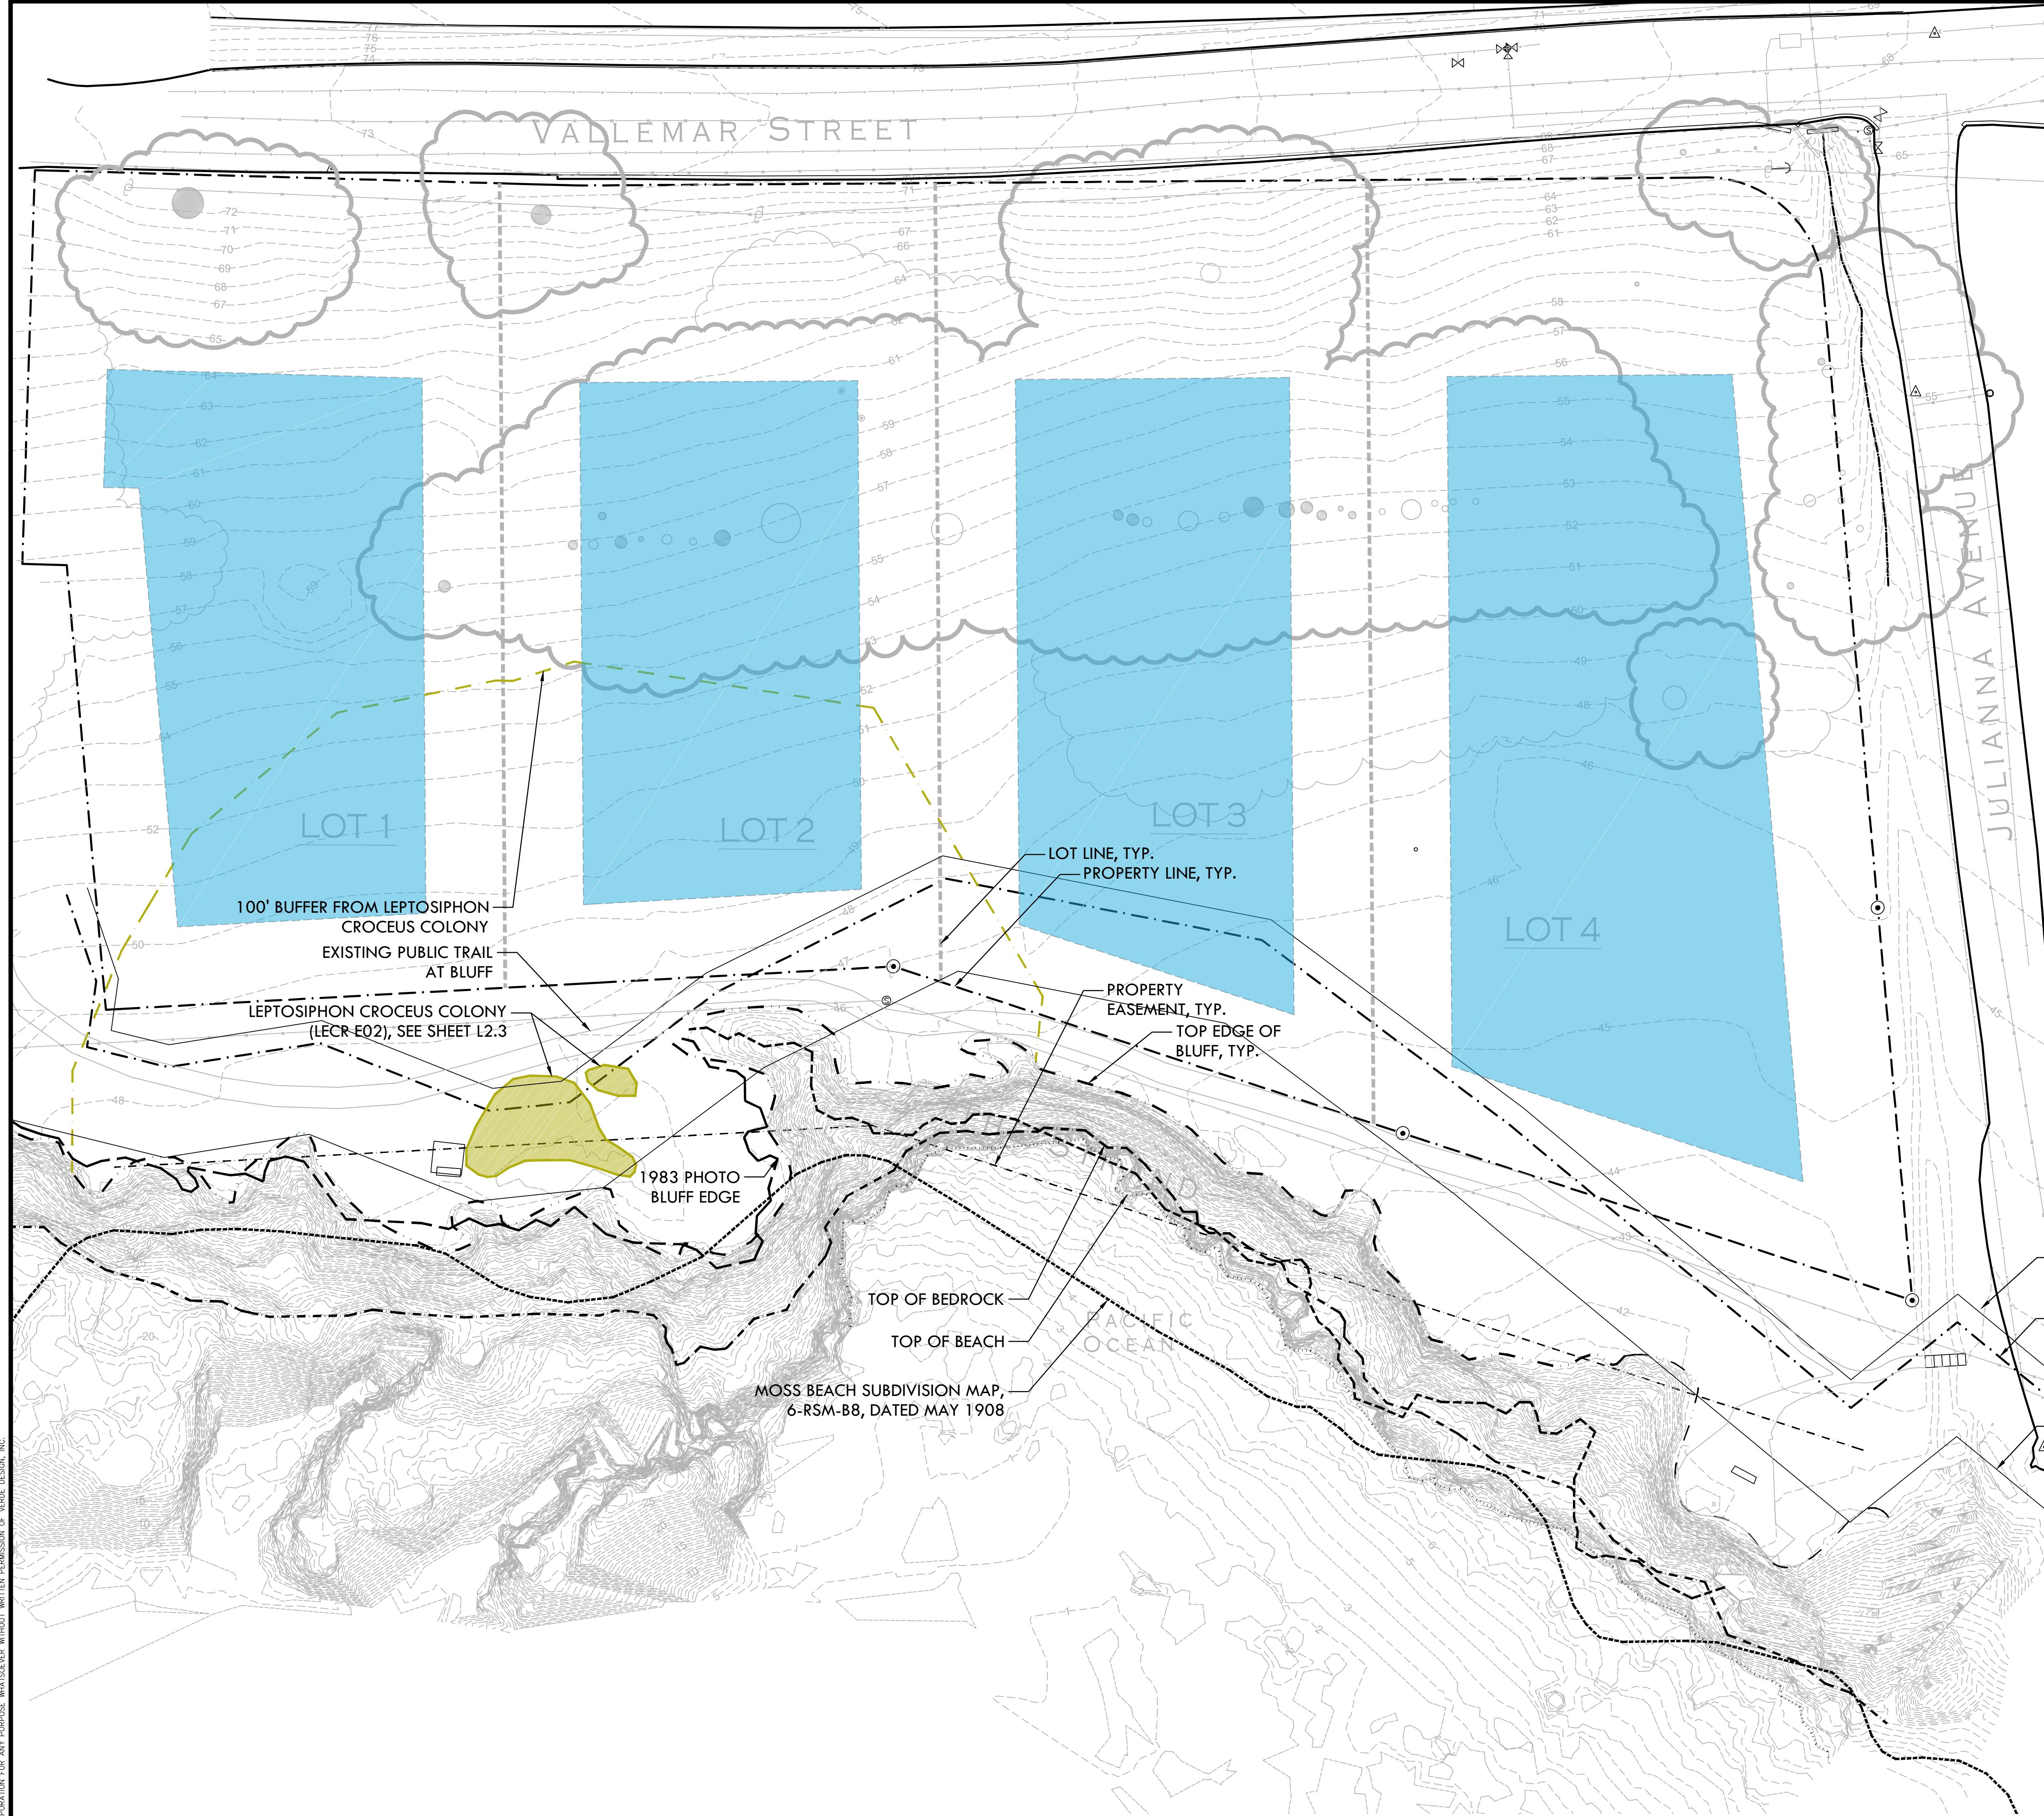

SITE PLAN LEGEND	
SYMBOL	DESCRIPTION
Dashed line	TOP EDGE OF BLUFF
Dash-dot line	TOP OF BEDROCK
Dotted line	1983 BLUFF EDGE
Dash-dot-dot line	TOP OF BEACH
Dash-dot-dot-dot line	MOSS BEACH HEIGHTS SUBDIVISION MAP 6-RSM-B8, DATED MAY 1908
Blue shaded area	PROPOSED BUILDING ENVELOPE

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SITE CONSTRAINTS PLAN

PROJECT NAME
MOSS BEACH OCEAN DEVELOPMENT

PROJECT ADDRESS
VALLEMAR ST. & JULIANA AVE MOSS BEACH, CA

SUBMITTAL DATE
DESIGN REVIEW APPLICATION 08/21/15
DESIGN REVIEW RESUBMITTAL 08/09/16

NO. REVISIONS DATE


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PH MB
DATE ISSUED SCALE
08/23/17 AS SHOWN

PROJ. NO. 1500600-1668


SHEET NO. L2.2 OF SHEETS

SITE CONSTRAINTS PLAN

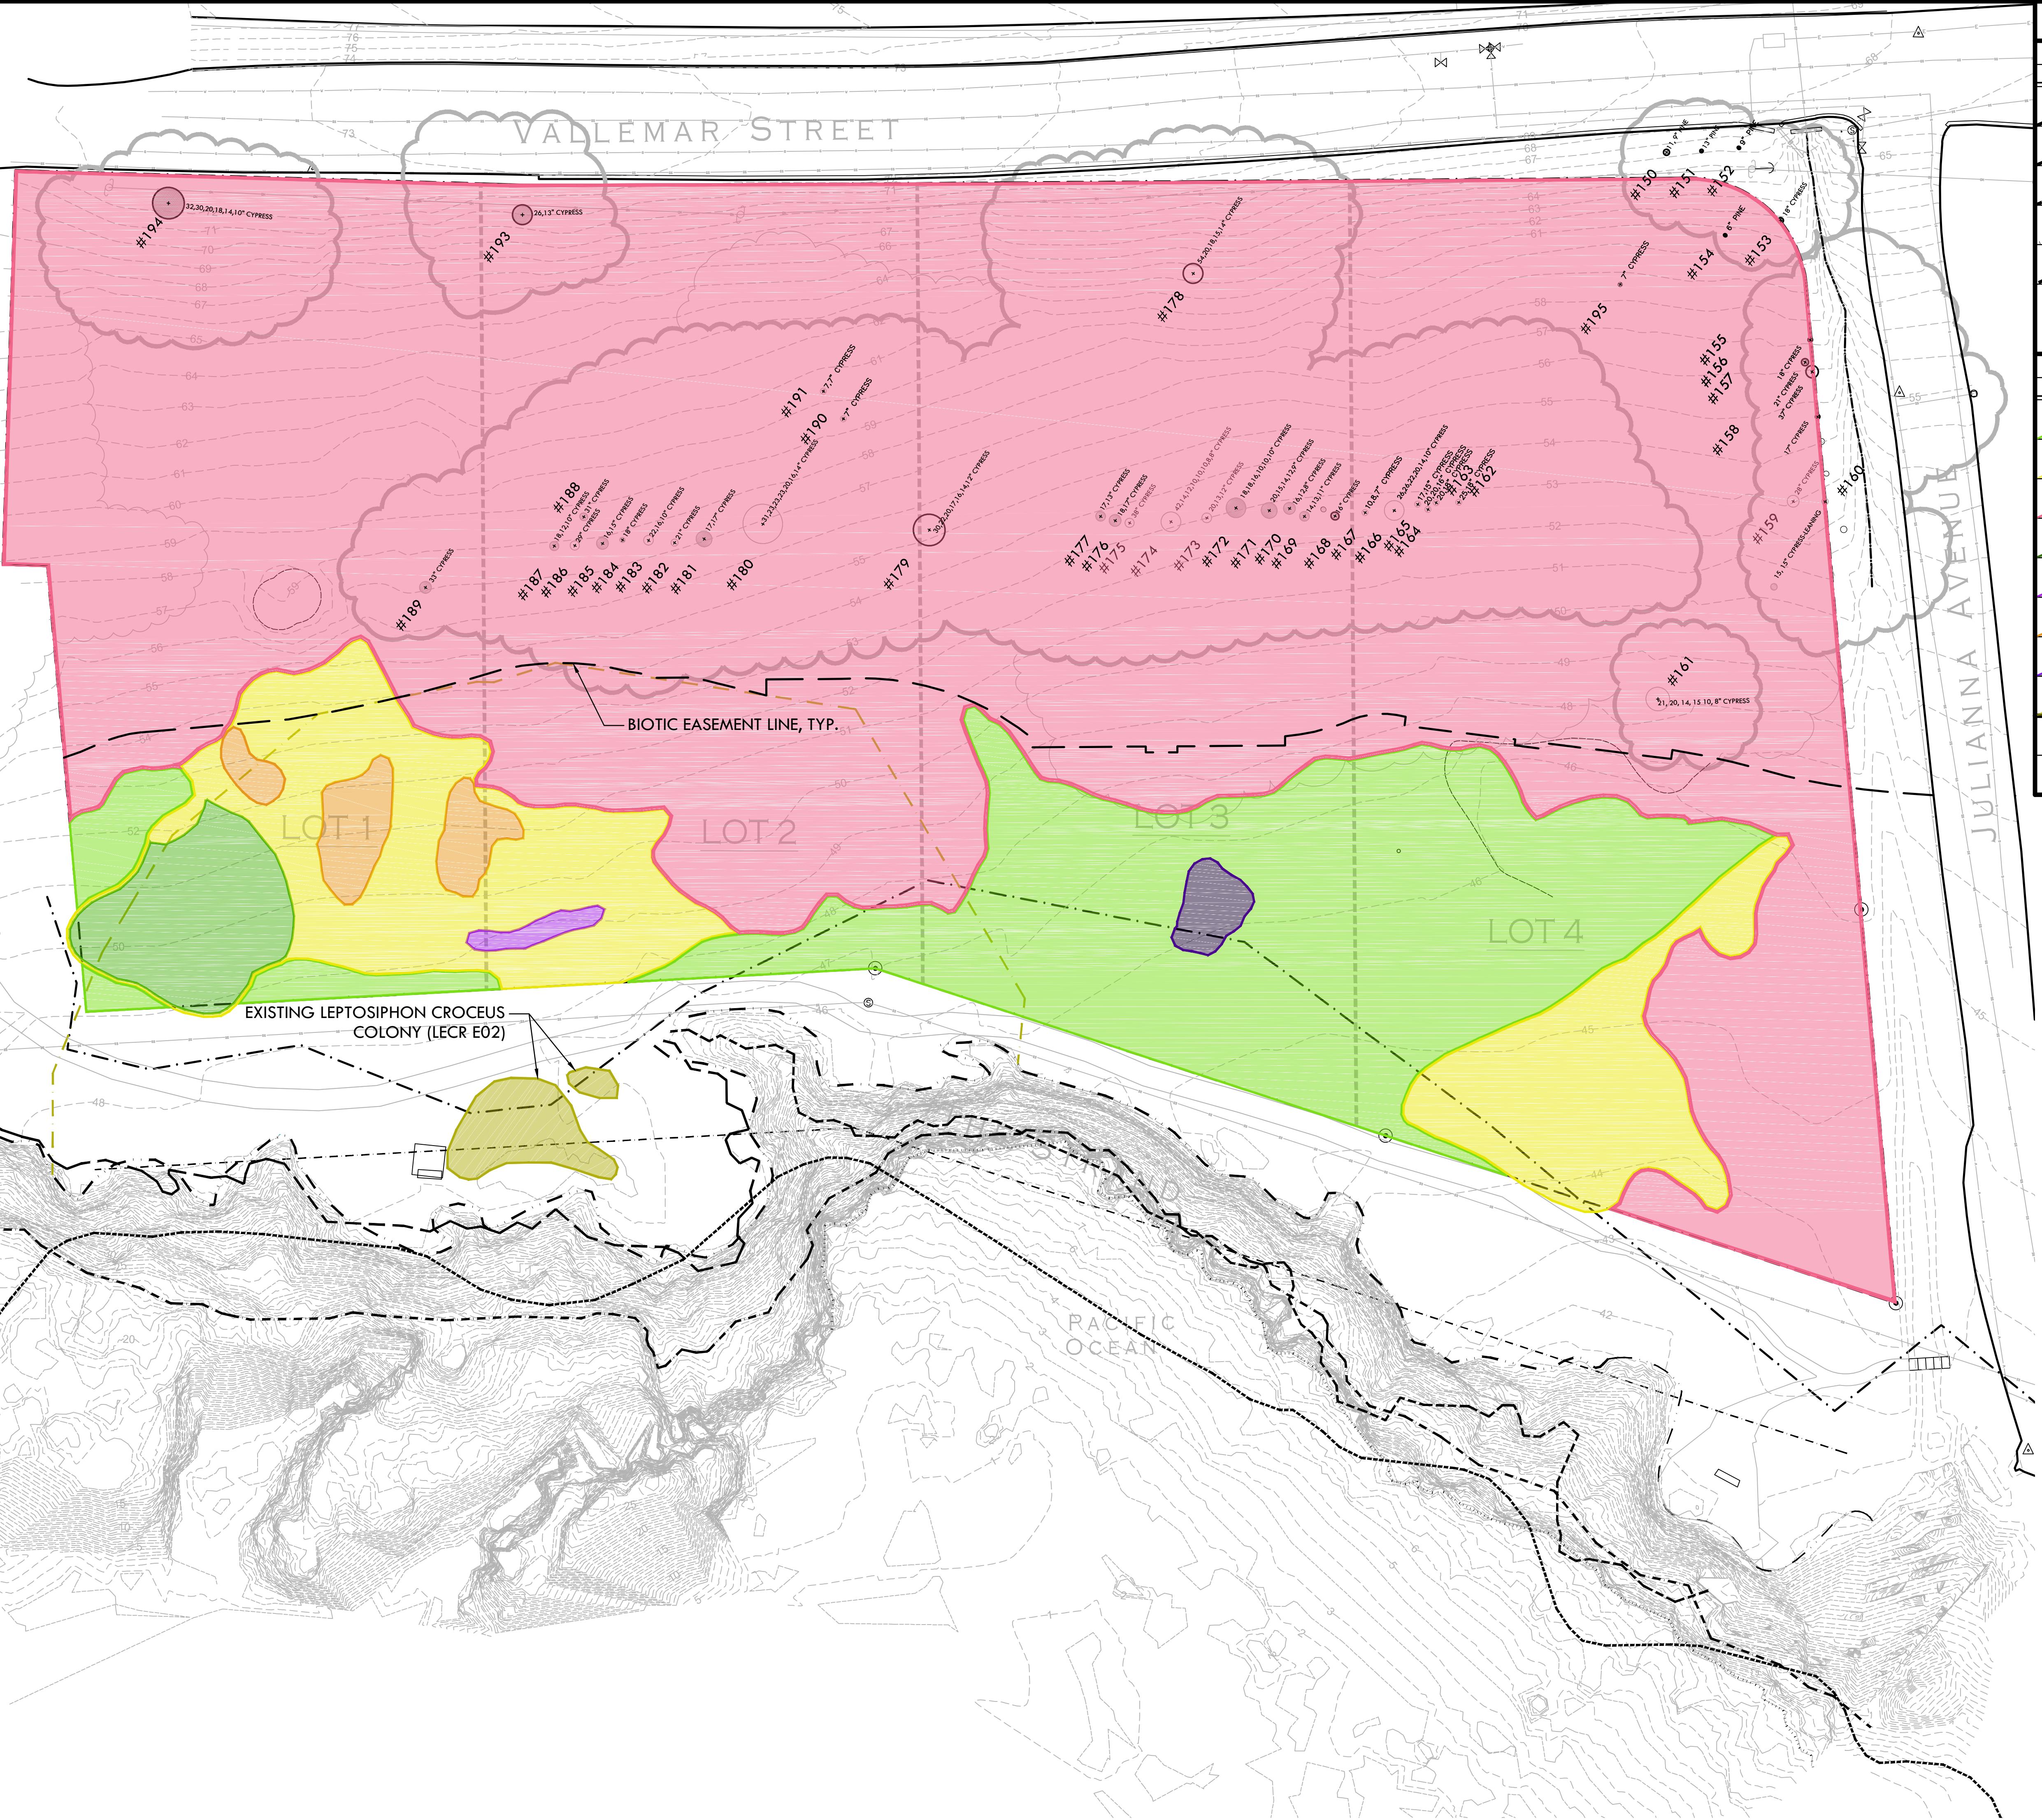

SITE PLAN LEGEND

SYMBOL	DESCRIPTION
- - - - -	TOP EDGE OF BLUFF
- - - - -	TOP OF BEDROCK
- - - - -	1983 BLUFF EDGE
- - - - -	TOP OF BEACH
- - - - -	MOSS BEACH HEIGHTS SUBDIVISION MAP 6-RSM-88, DATED MAY 1908

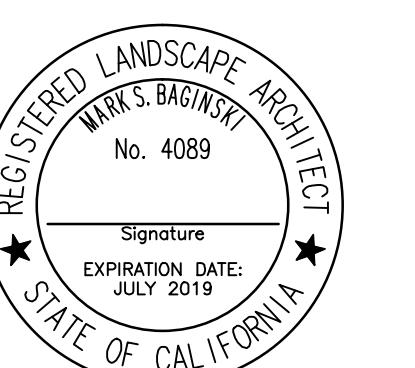

EXISTING TREES AND VEGETATION TYPES LEGEND

SYMBOL	DESCRIPTION
ZONE A - COASTAL PRAIRIE GRASSLAND	
ZONE B - TRANSITIONAL AREA	
ZONE C - NON-NATIVE VEGETATION	
ICEPLANT MAT	
DESCHAMPSIA-DOMINATED AREA	
DANTHONIA-DOMINATED AREA	
BEECH STRAWBERRY	
LEPTOSIPHON CROCEUS - LECR ELEMENT OCCURRENCE 02 PER CALIFORNIA NATIVE PLANT SOCIETY MEMORANDUM, 5/25/2016	
(○) 12" CYPRESS	EXISTING TREE, DIAMETER OF TRUNK(S) AND SPECIES TYPE
#174	TREE NO.

CONSULTANT

EXISTING TREES AND VEGETATION

MOSS BEACH OCEAN DEVELOPMENT

VALLEMAR ST. & JULIANA AVE MOSS BEACH, CA

SUBMITTAL	DATE
DESIGN REVIEW APPLICATION	08/21/15
DESIGN REVIEW RESUBMITTAL	08/09/16


NO.	REVISIONS	DATE
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DRAWN BY PH	CHECKED BY MB
DATE ISSUED 08/23/17	SCALE AS SHOWN

PROJ. NO.
1500600-1668

SHEET NO.
L2.3

OF SHEETS

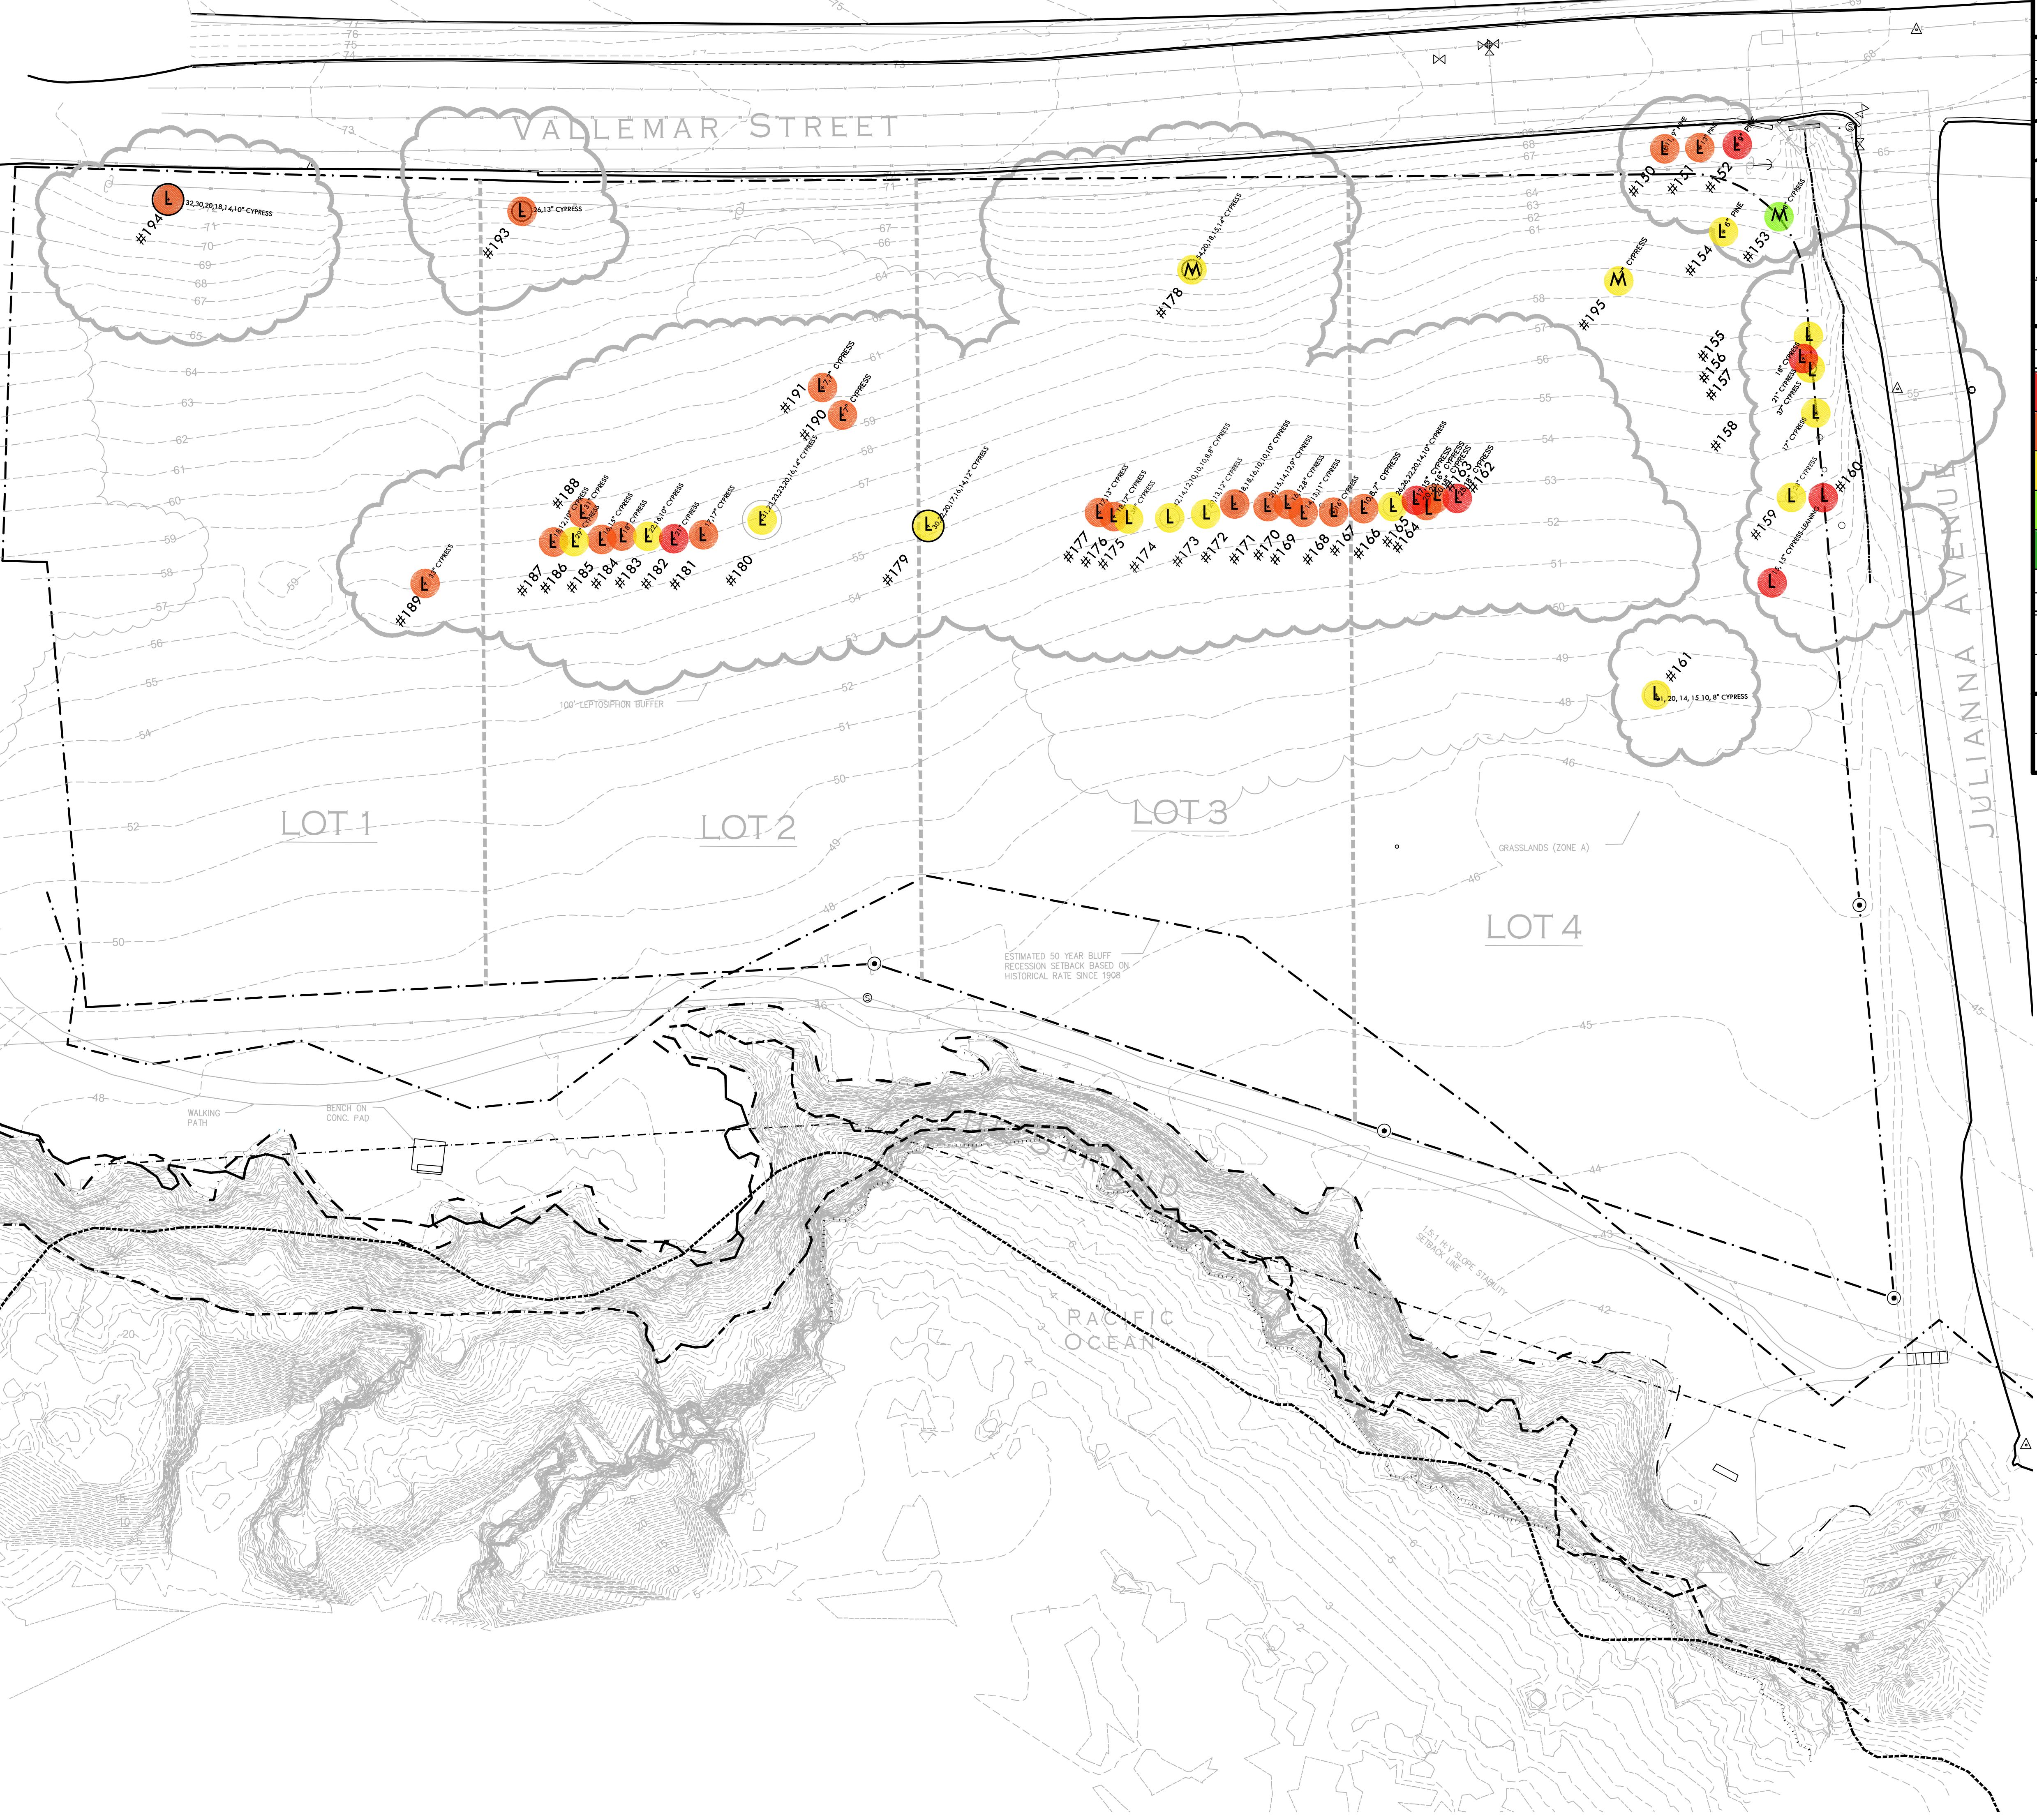

SITE PLAN LEGEND


SYMBOL	DESCRIPTION
- - -	TOP EDGE OF BLUFF
- - -	TOP OF BEDROCK
- - -	1983 BLUFF EDGE
- - -	TOP OF BEACH
- - -	MOSS BEACH HEIGHTS SUBDIVISION MAP 6-RSM-88, DATED MAY 1908

TREE HEALTH/SUITABILITY LEGEND

SYMBOL	TREE HEALTH	QUANTITY
Red	1 (POOR)	6
Orange	2	22
Yellow	3	16
Green	4	1
Dark Green	5 (EXCELLENT)	0
SYMBOL	SUITABILITY FOR PRESERVATION	QUANTITY
L	LOW	42
M	MODERATE	3
○ 128" CYPRESS	EXISTING TREE, DIAMETER OF TRUNK(S) AND SPECIES TYPE	
#174	TREE NO.	



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TREE HEALTH AND SUITABILITY FOR PRESERVATION

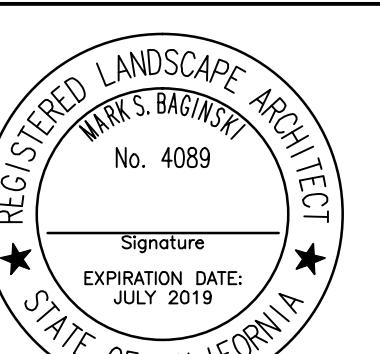PROJECT NAME

MOSS BEACH
OCEAN
DEVELOPMENT


PROJECT ADDRESS
VALLEMAR ST. &
JULIANA AVE
MOSS BEACH, CA

SUBMITTAL	DATE
DESIGN REVIEW APPLICATION	08/21/15
DESIGN REVIEW RESUBMITTAL	08/09/16

NO.	REVISIONS	DATE
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PROJ. NO.
1500600-1668
SHEET NO.

L2.5
OF SHEETS

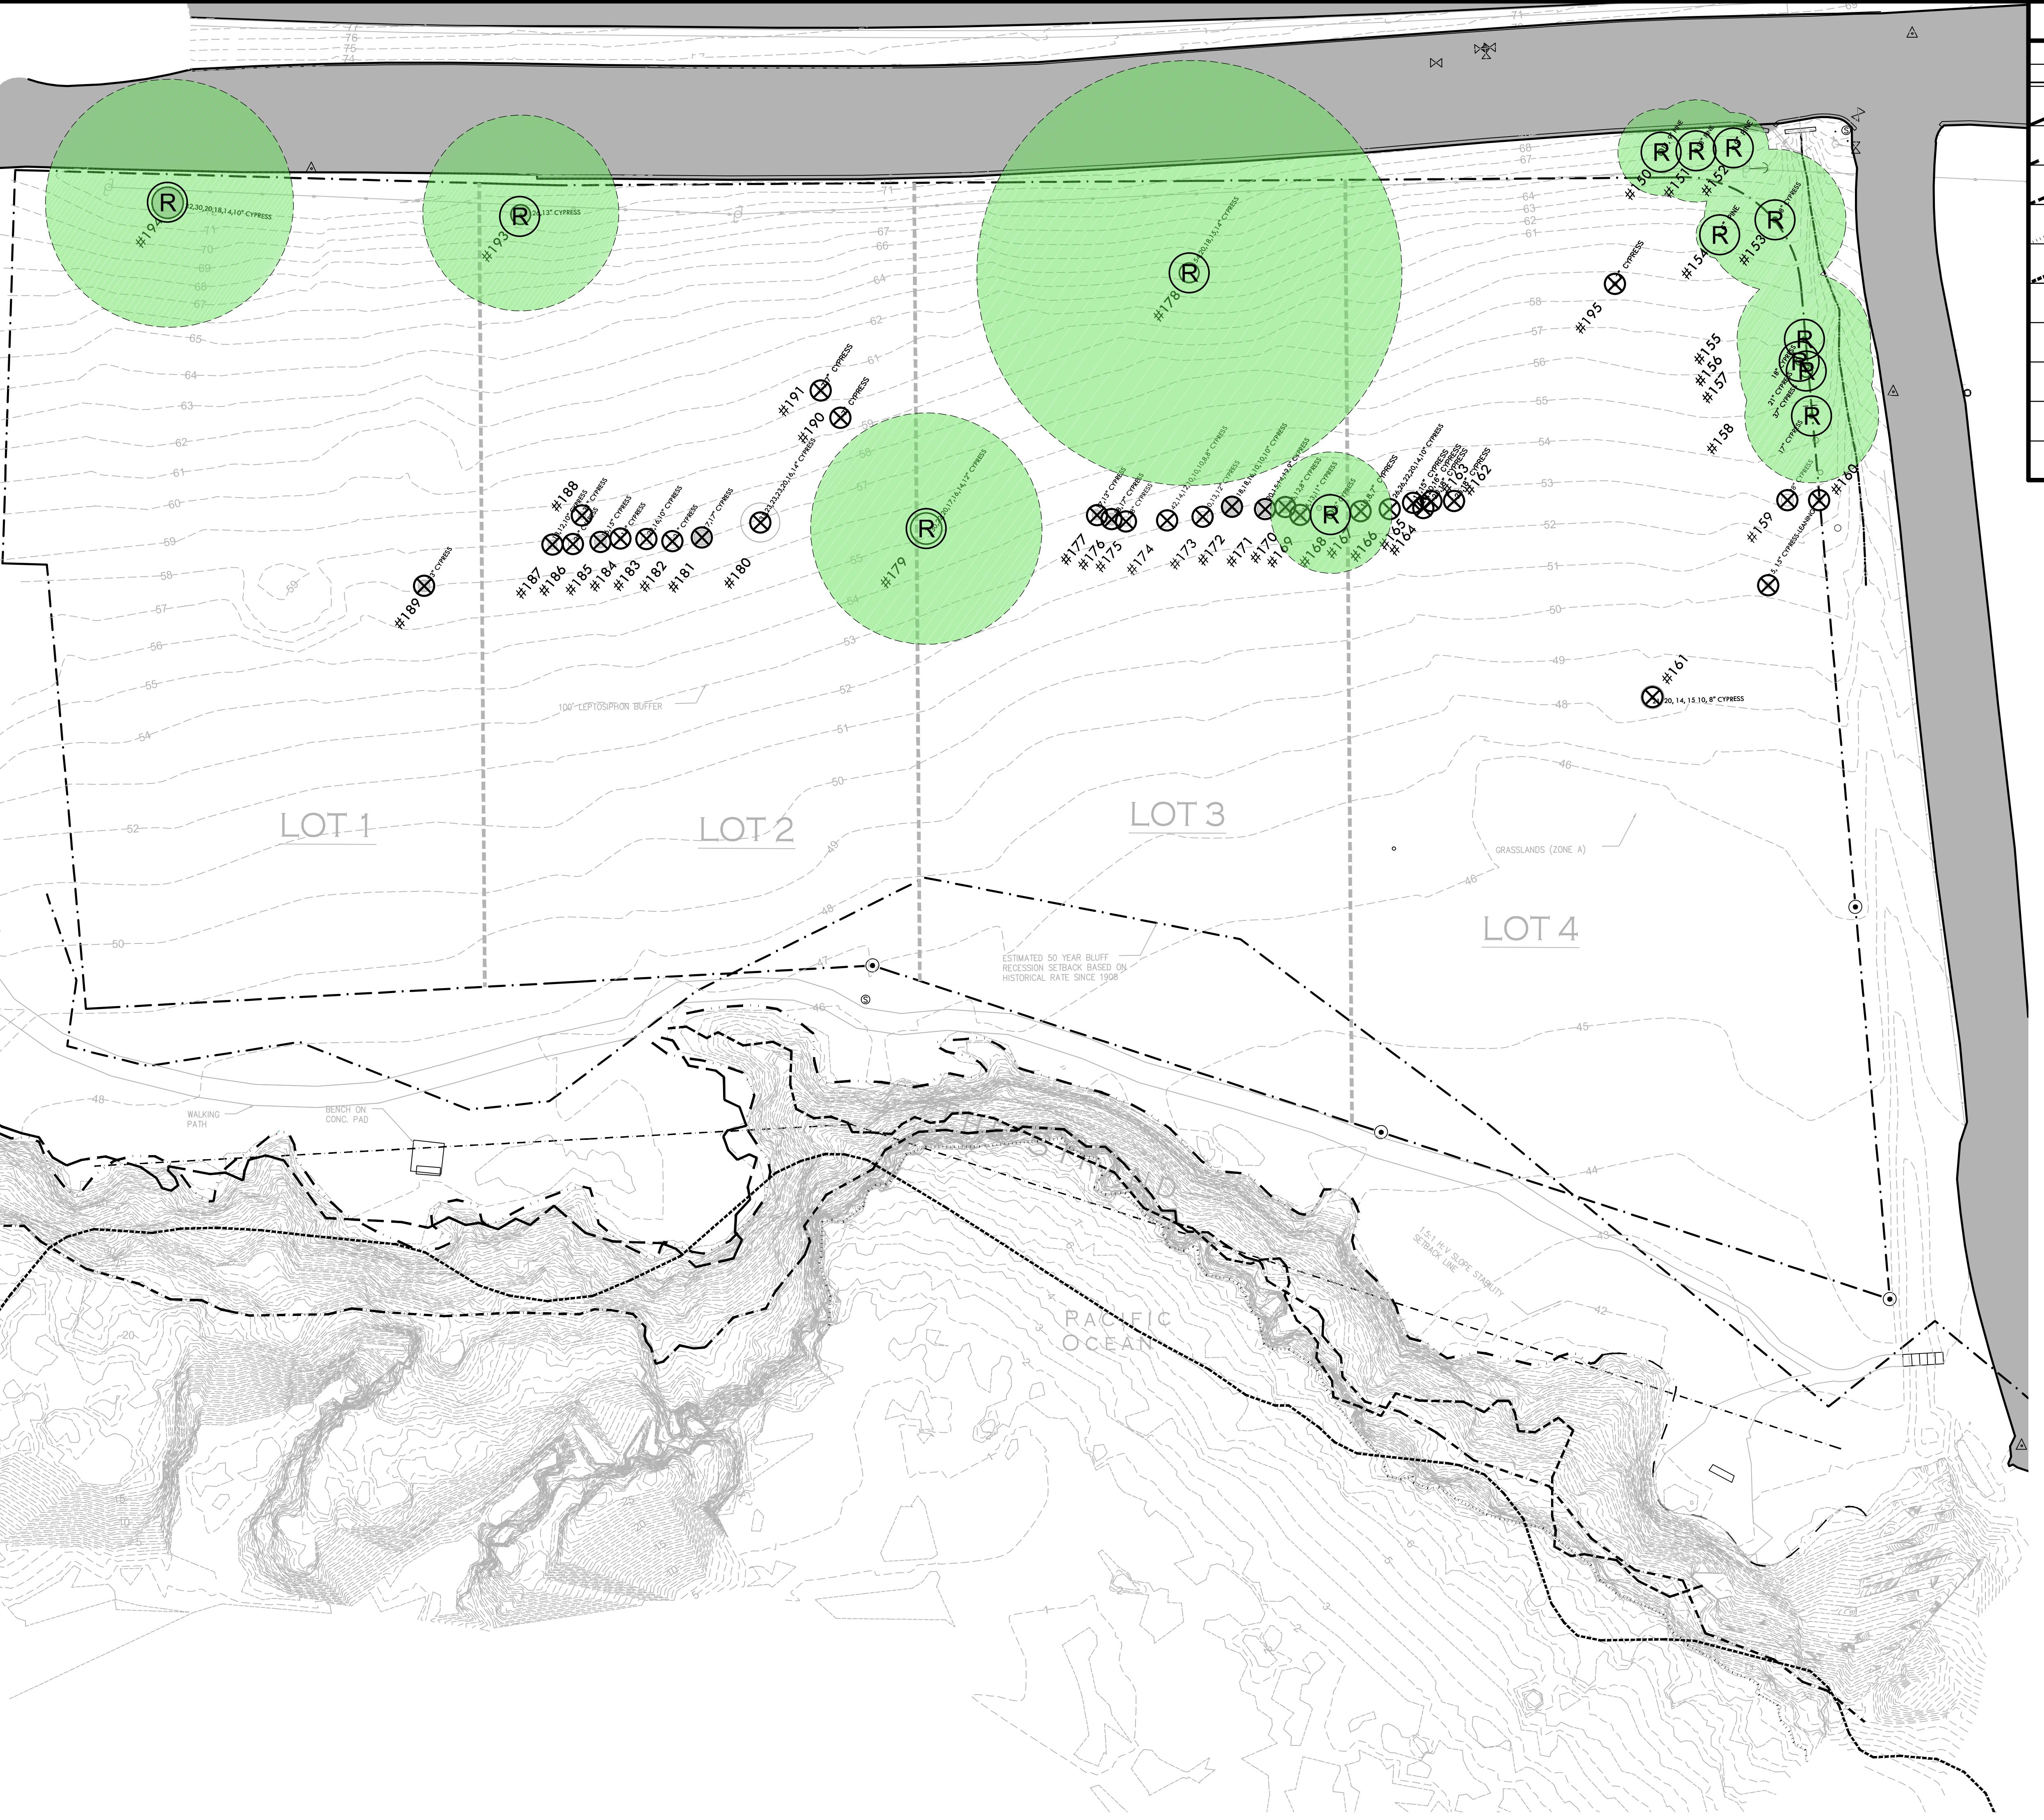

SITE PLAN LEGEND

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REGISTERED LANDSCAPE ARCHITECT
M. S. BAGINSKI
No. 4089
Signature
EXPIRATION DATE
JULY 2019
STATE OF CALIFORNIA

CONSULTANT

TREE REMOVAL PLAN

PROJECT NAME

MOSS BEACH
OCEAN
DEVELOPMENT

PROJECT ADDRESS

VALLEMAR ST. &
JULIANA AVE
MOSS BEACH, CA

SUBMITTAL

DATE

DESIGN REVIEW APPLICATION

08/21/15

DESIGN REVIEW RESUBMITTAL

08/09/16

NO.

REVISIONS

DATE

DRAWN BY

PH

CHECKED BY

MB

DATE ISSUED

08/23/17

SCALE

AS SHOWN

PROJ. NO.


1500600-1668

SHEET NO.

L3.1

OF SHEETS

TREE REMOVAL PLAN

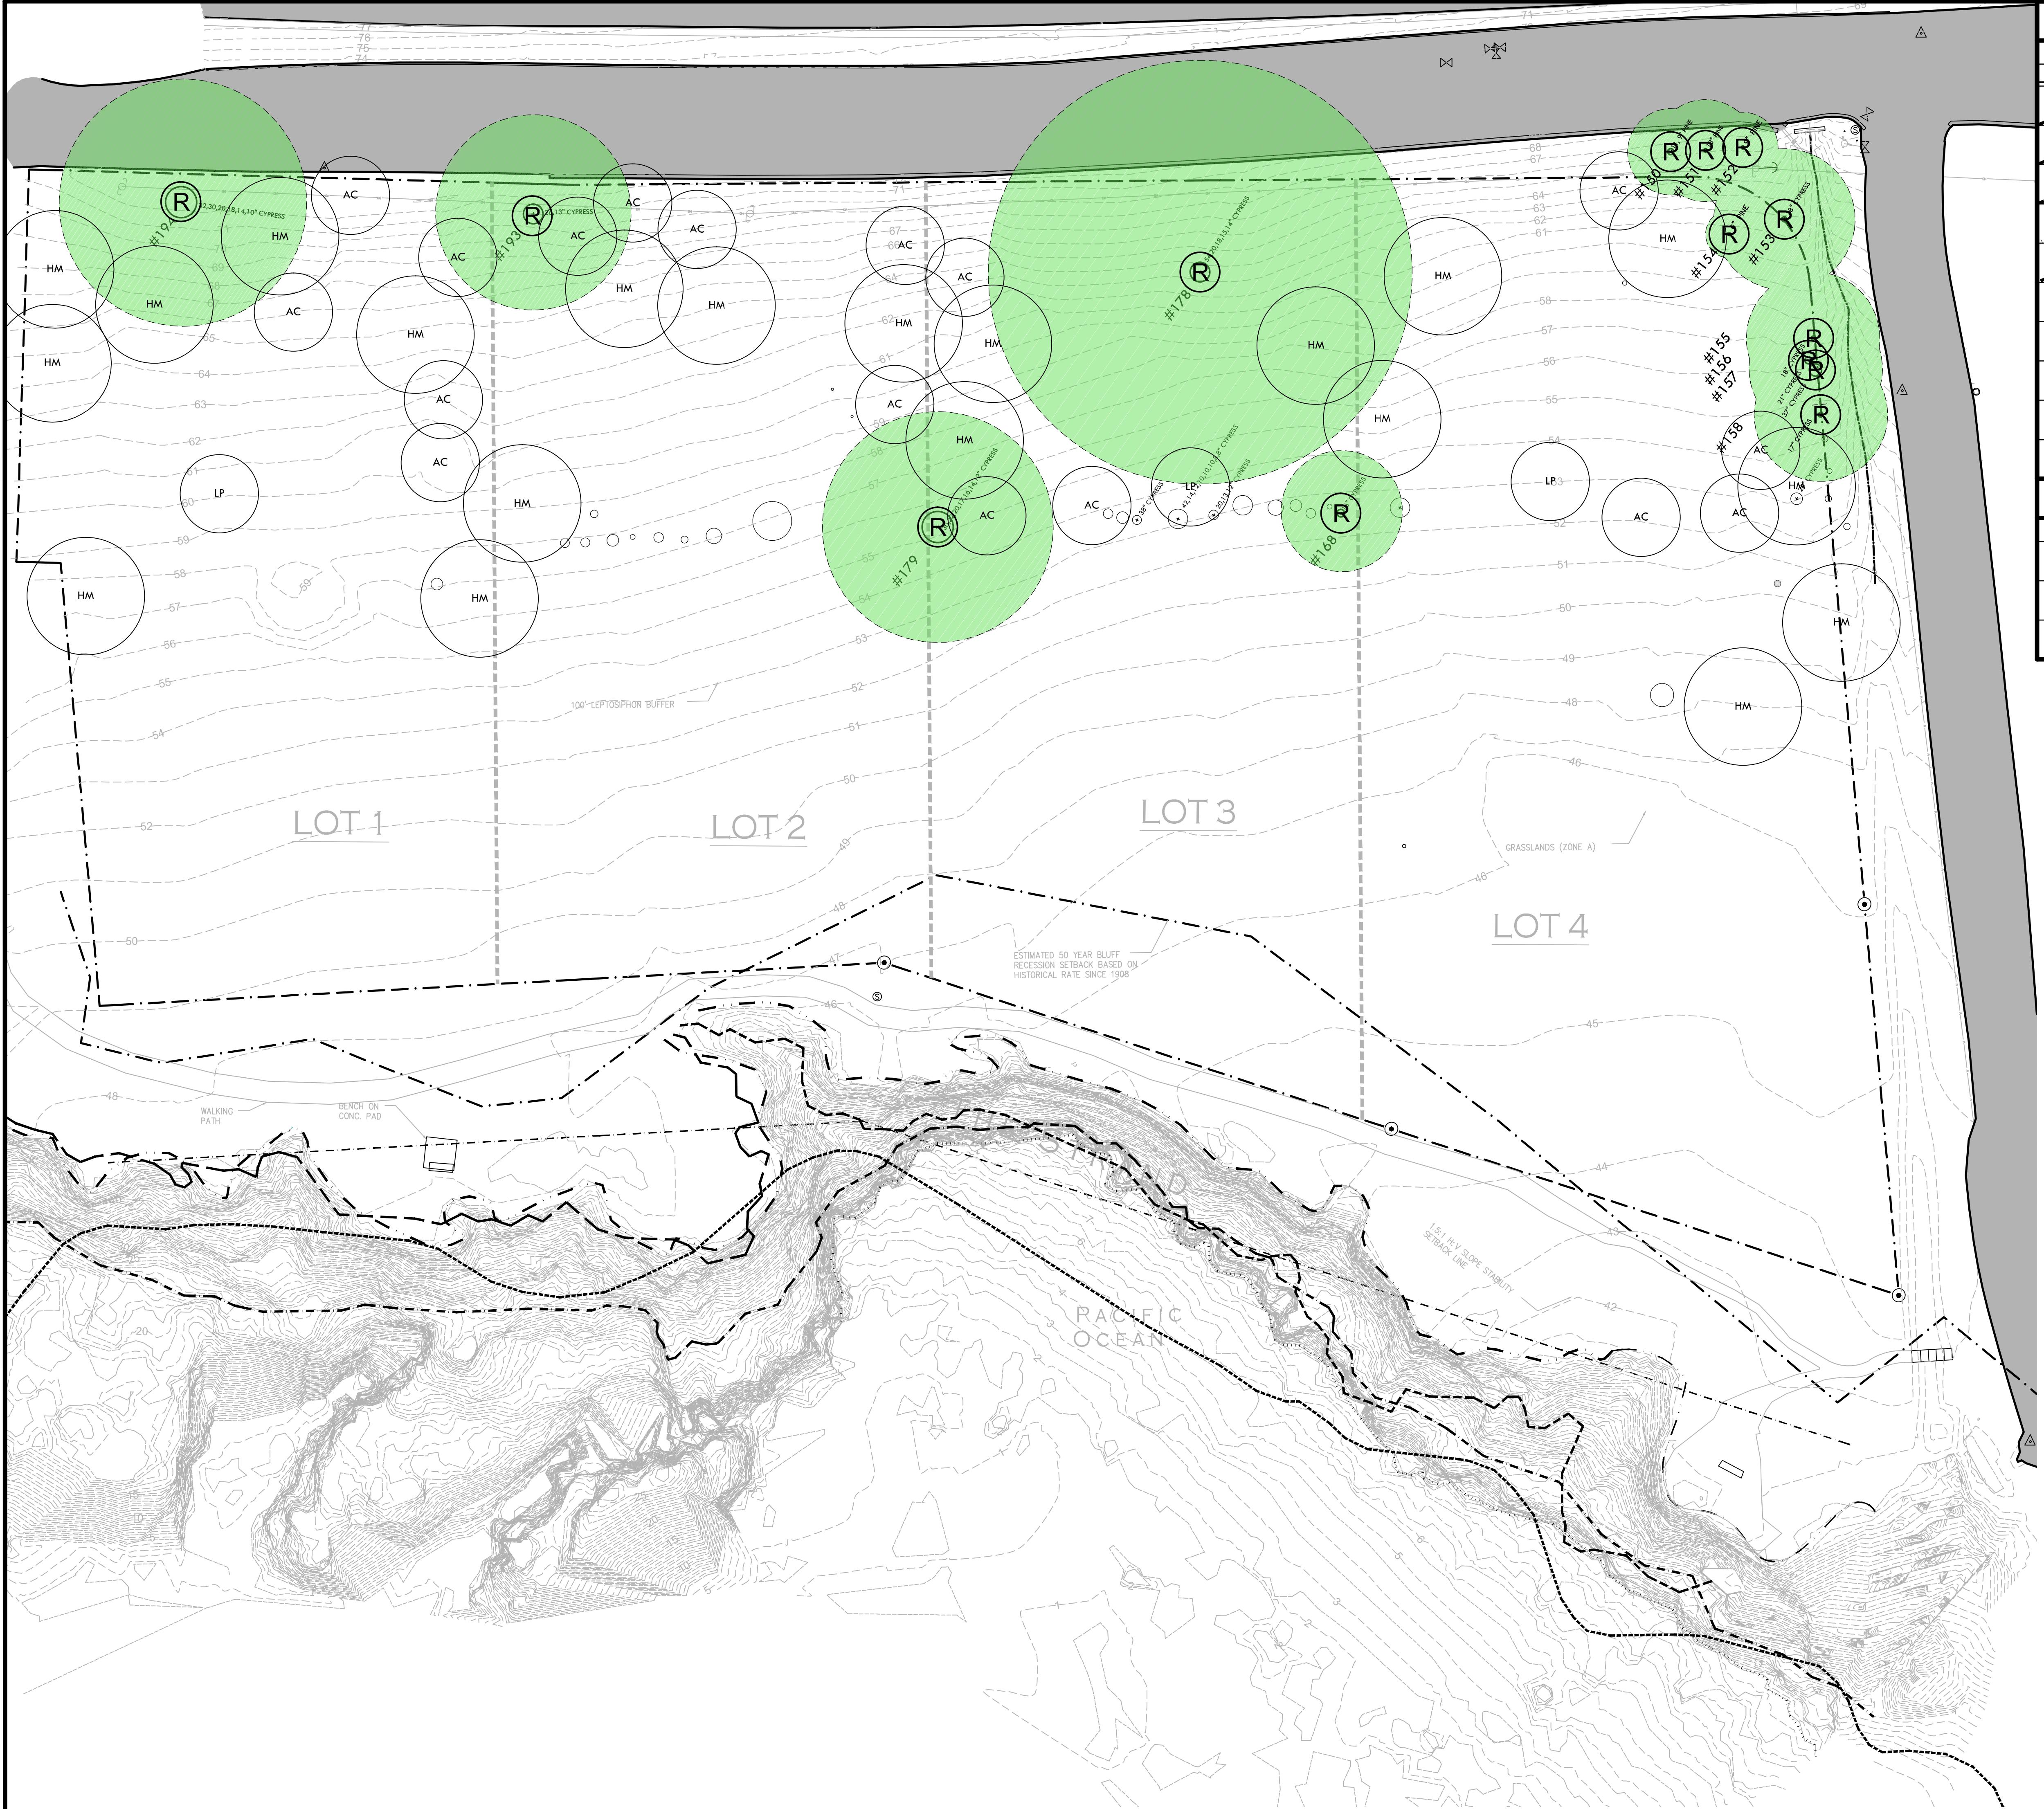

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STAMP

REGISTERED LANDSCAPE ARCHITECT
MARK S. BAGINSKI
No. 4089
Signature
EXPIRATION DATE: JULY 2019
STATE OF CALIFORNIA

CONSULTANT

SHEET TITLE
TREE REPLACEMENT PLAN

PROJECT NAME
MOSS BEACH OCEAN DEVELOPMENT

PROJECT ADDRESS
VALLEMAR ST. & JULIANA AVE MOSS BEACH, CA

SUBMITTAL **DATE**
DESIGN REVIEW APPLICATION 08/21/15
DESIGN REVIEW RESUBMITTAL 08/09/16

NO. REVISIONS **DATE**

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DRAWN BY **CHECKED BY**
PH MB

DATE ISSUED **SCALE**
08/23/17 AS SHOWN

PROJ. NO. **SHEET NO.**
1500600-1668


L3.2 **OF** **SHEETS**


TREE REPLACEMENT PLAN



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MATERIAL LEGEND

SYM	DESCRIPTION	DTL REF
	PERMEABLE CONCRETE PAVERS WITH 6" CONCRETE EDGEBOARD	A L4.2
	STAMPED CONCRETE AT DRIVEWAY ENTRANCES	B L4.2
	DECKING - REFER TO ARCHITECTURAL PLANS	
	NATIVE COASTAL GRASS LAWN	
	GABION WALL W/ GRAPE STAKE (4' MAX)	C L4.2
	GRAPE STAKE FENCE AT PROPERTY LINE (18-30" HIGH) MIN. 50% TRANSPARENCY	D L4.2
(A)	EXISTING PUBLIC TRAIL AT BLUFF	
(1)	PERMEABLE PAVERS/PAVEMENT	
(2)	NON-PERMEABLE PAVEMENT	
(3)	PATHWAY/PATIO W/ COMMON PAVERS OR STONE	
(4)	GRAPE STAKE FLANK GATE	C L4.2
(5)	BIOTIC EASEMENT LINE	
(6)	GABION RETAINING WALL / SEAT WALL	E L4.2

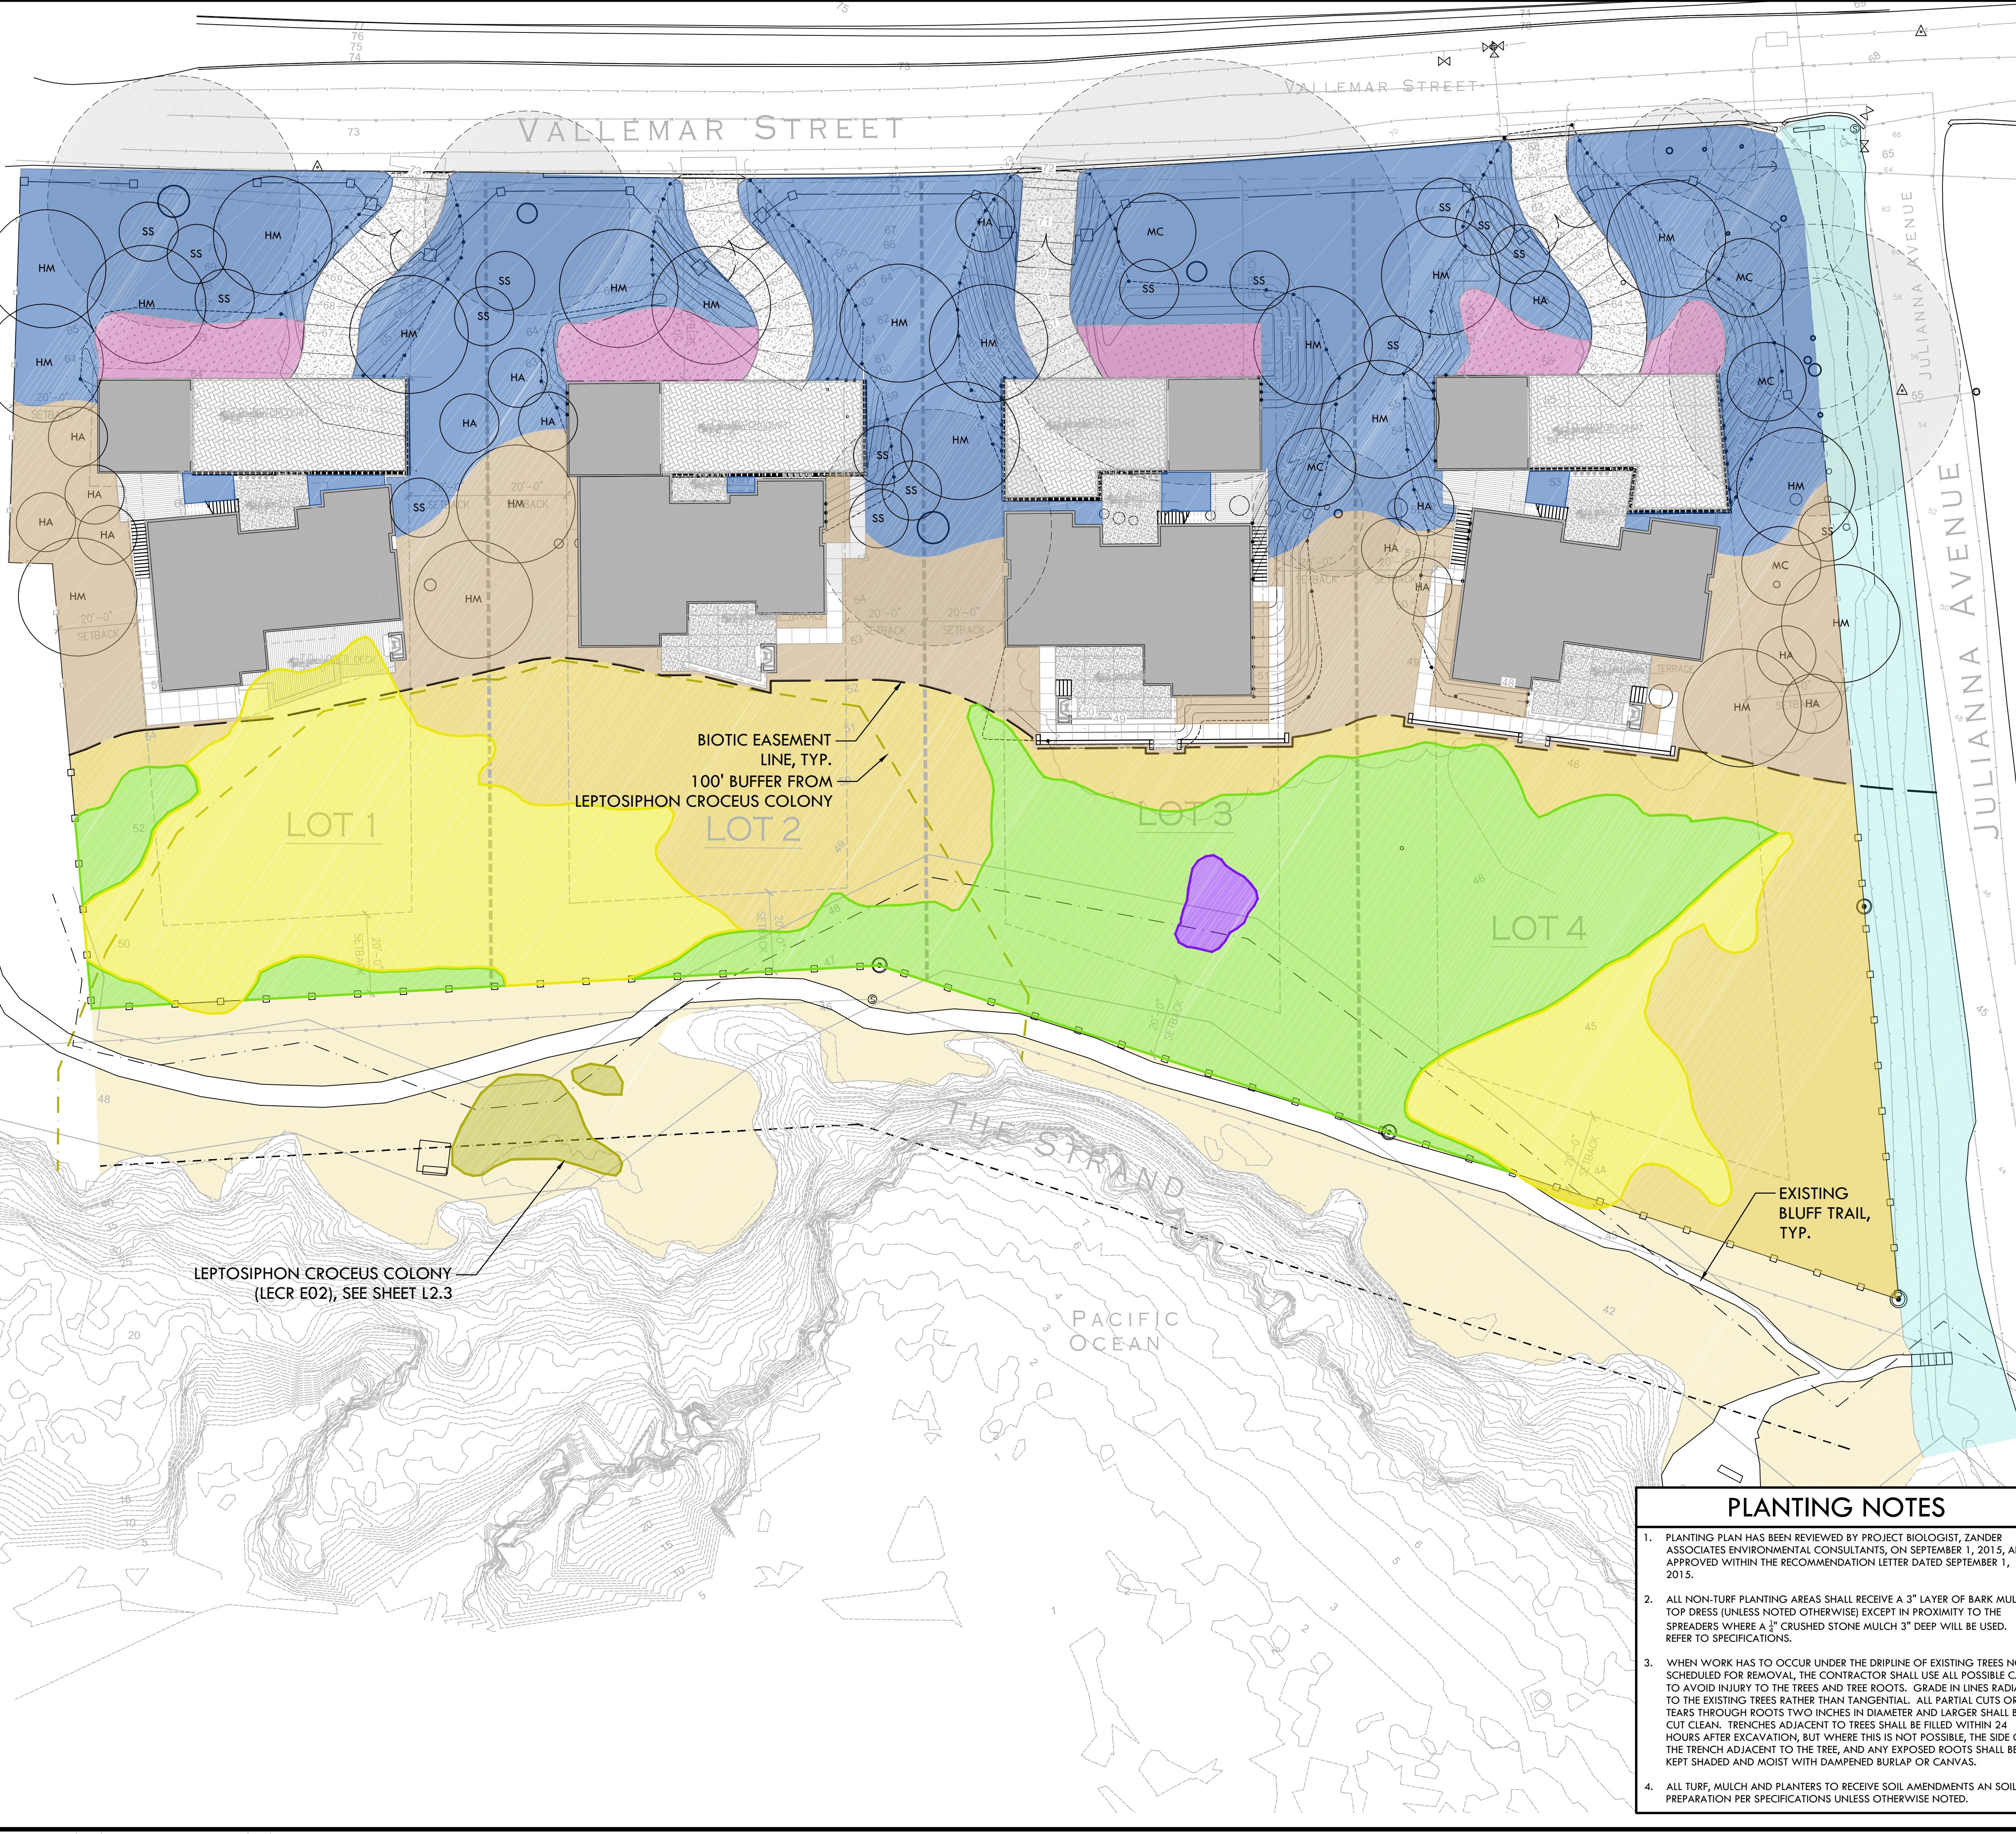

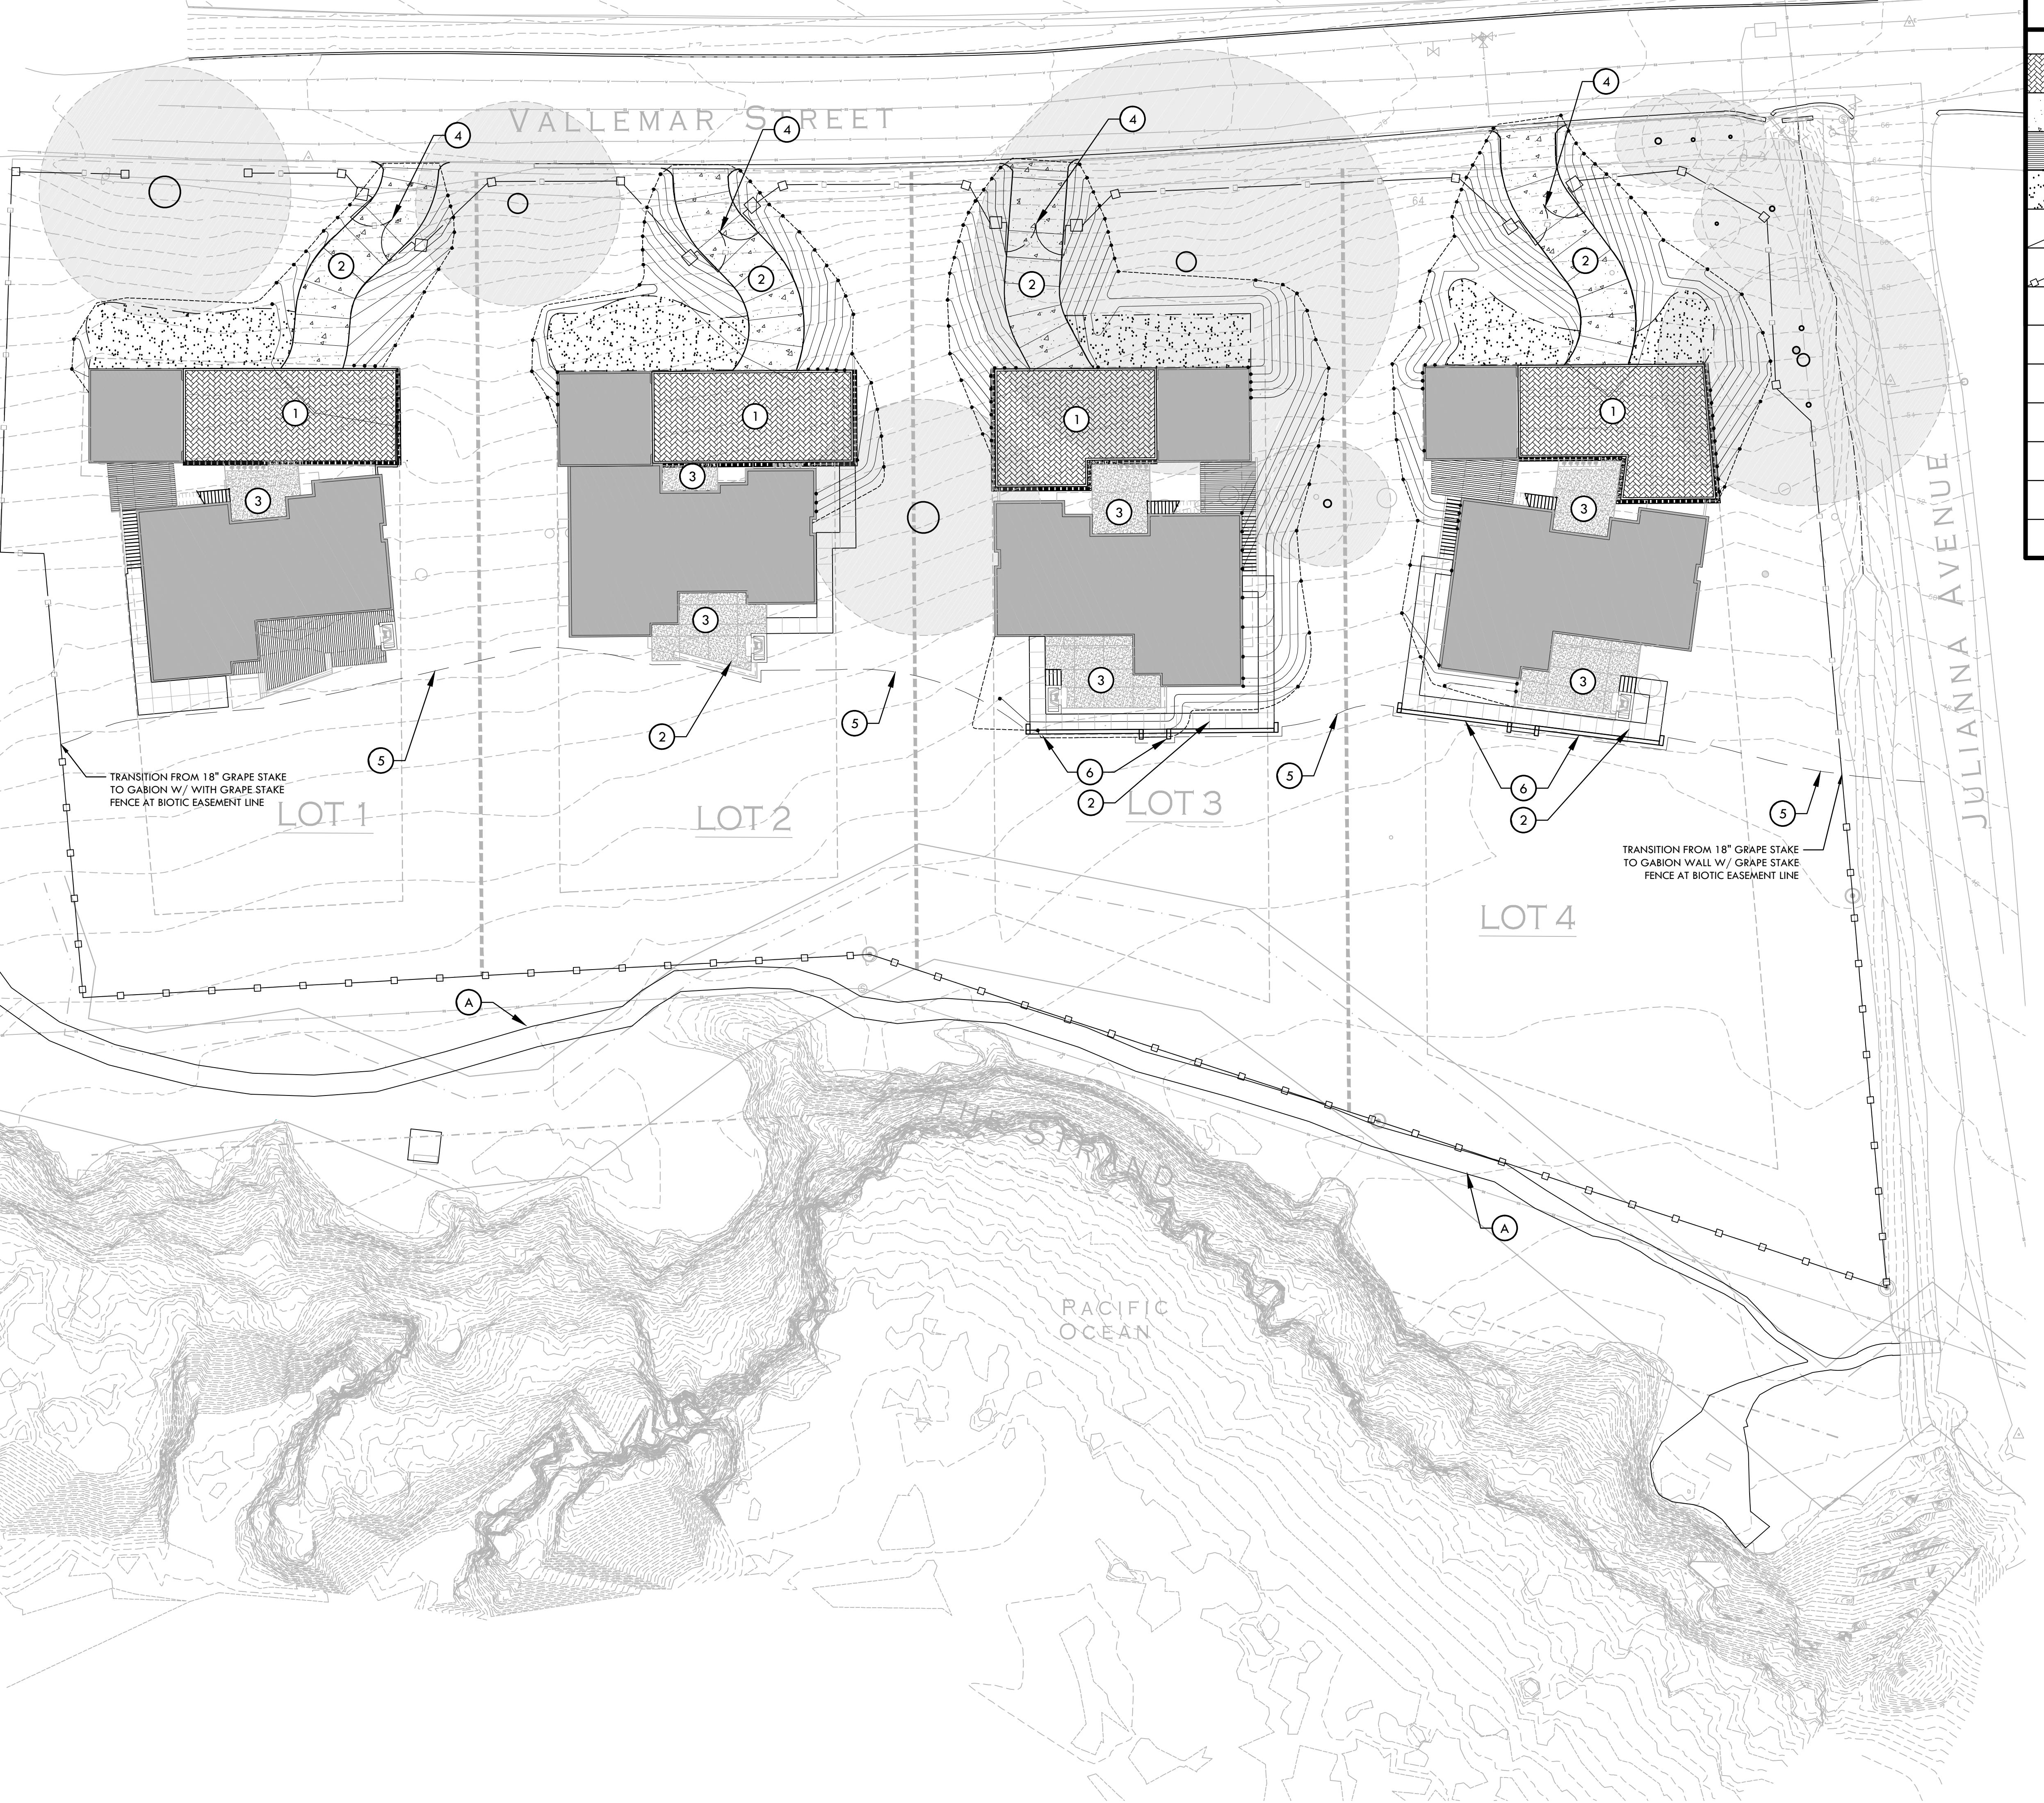MOSS BEACH
OCEAN
DEVELOPMENT

PROJECT ADDRESS
VALLEMAR ST. &
JULIANA AVE
MOSS BEACH, CA

SUBMITTAL DATE
DESIGN REVIEW APPLICATION 08/21/15
DESIGN REVIEW RESUMMITAL 08/09/16

NO. REVISIONS DATE
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PROJ. NO. 1500600-1668
SHEET NO. L4.1 OF SHEETS

MOSS BEACH - OVERALL

VALLEMAR ST. & JULIANNA AVE.

COASTSIDE DESIGN
REVIEW APPLICATION


DRAWING:
SITE PLAN

PROJECT NUMBER: 1507

DATE: JULY 24, 2017
△ 08-25-2017
DESIGN REVIEW SET

SHEET NO.

A1.0

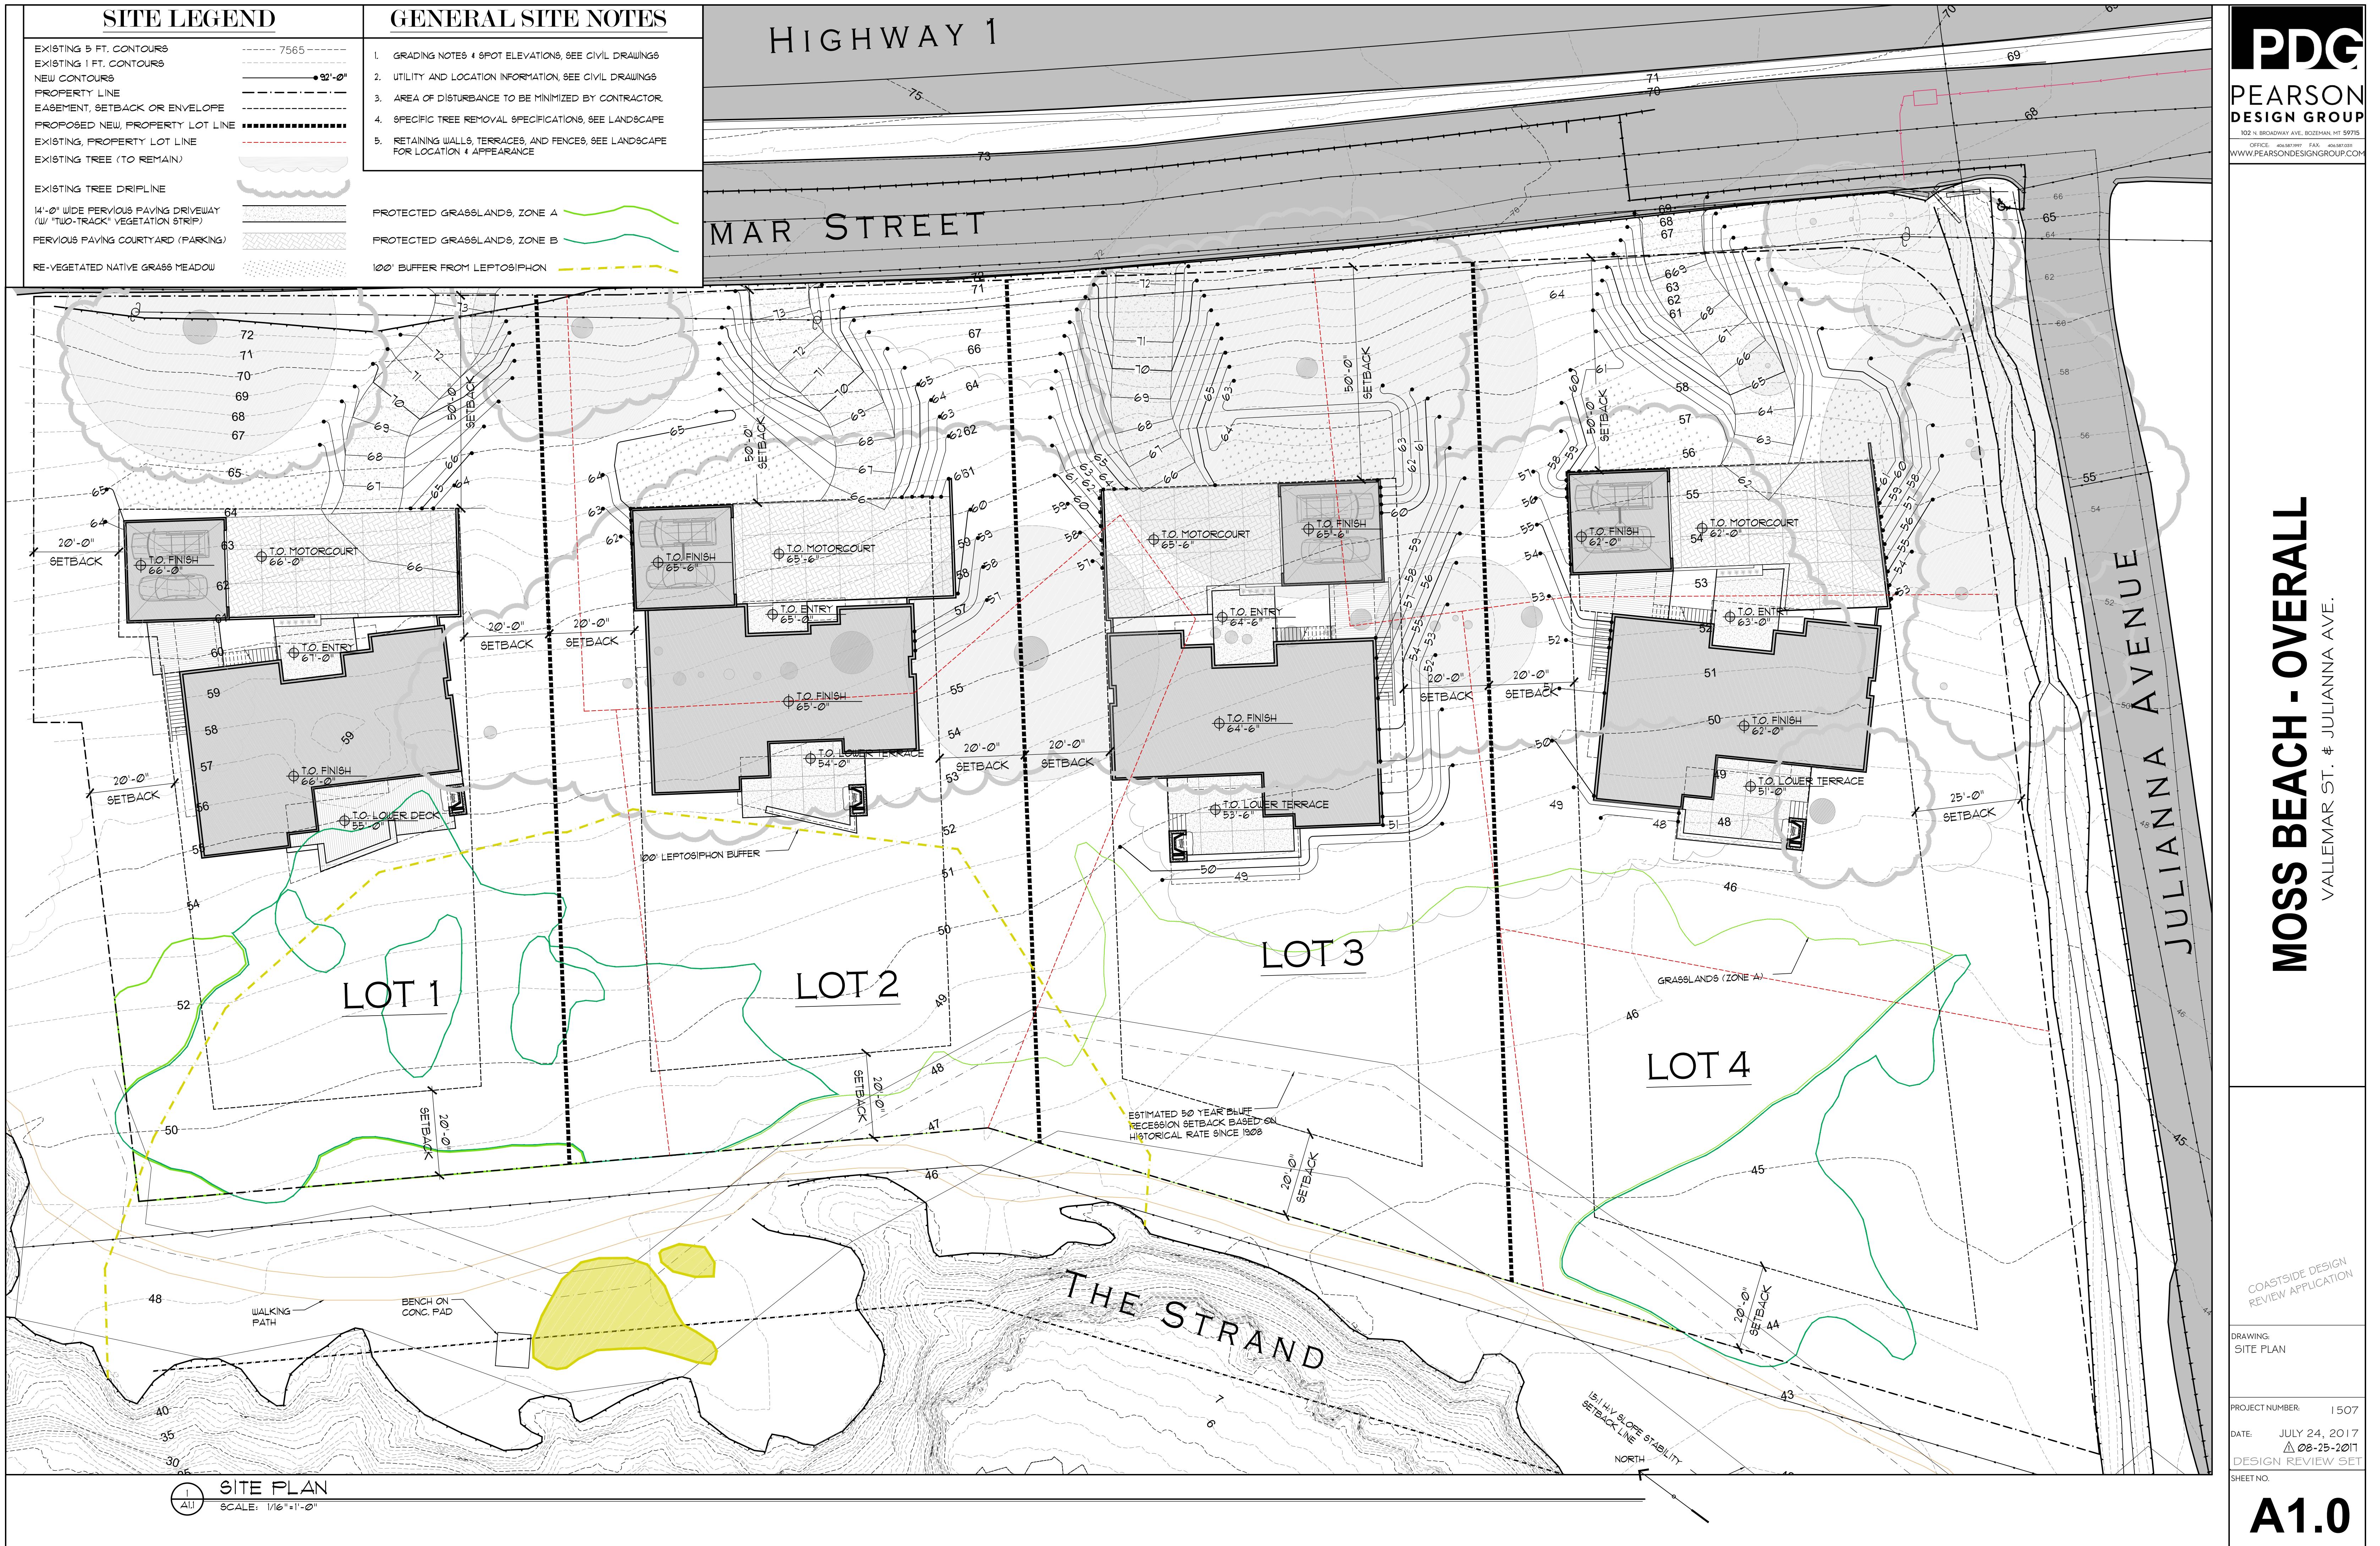

MOSS BEACH - LOT 2

VALLEMAR ST. & JULIANNA AVE.


COASTSIDE DESIGN
REVIEW APPLICATION

DRAWING:
SITE PLAN

PROJECT NUMBER: 1507
DATE: JULY 24, 2017
DESIGN REVIEW SET

SHEET NO.

A1.1

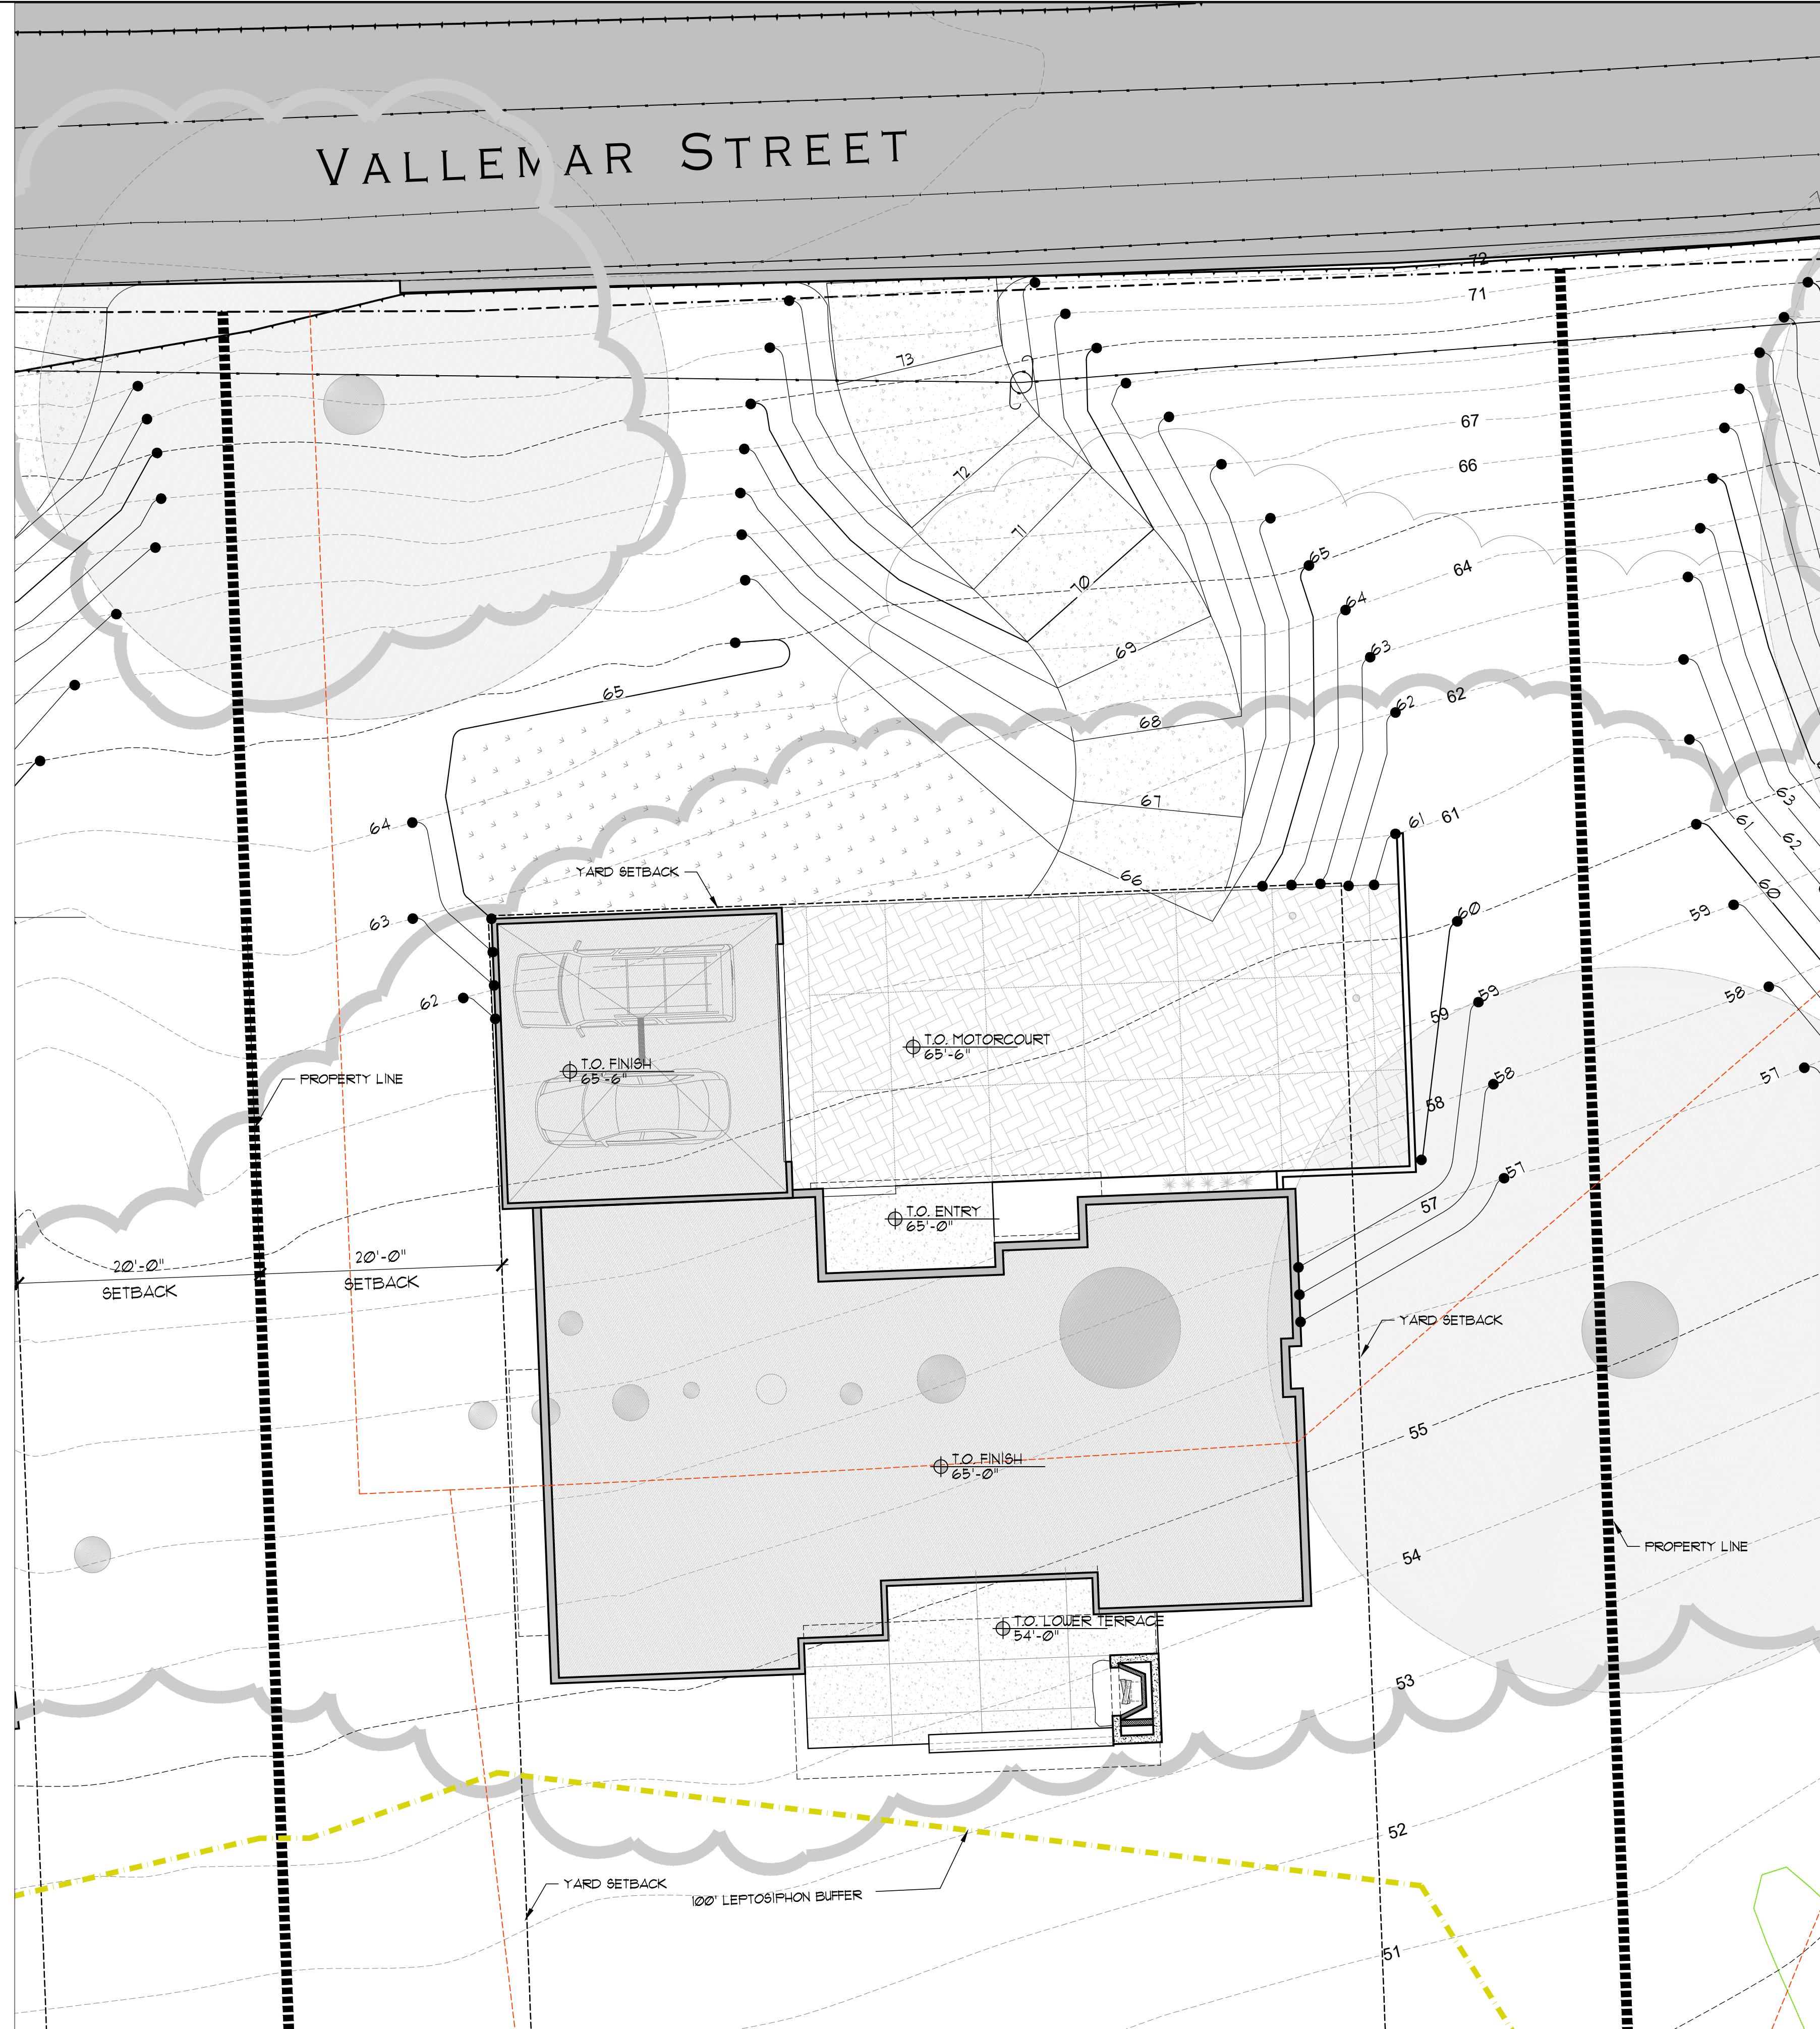

SITE PLAN - LOT 2
SCALE: 1/8"=1'-0"

SITE LEGEND

EXISTING 5 FT. CONTOURS	7565
EXISTING 1 FT. CONTOURS	7565
NEW CONTOURS	7565
PROPERTY LINE	7565
EASEMENT, SETBACK OR ENVELOPE	7565
PROPOSED NEW, PROPERTY LOT LINE	7565
EXISTING, PROPERTY LOT LINE	7565
EXISTING TREE (TO REMAIN)	7565
EXISTING TREE DRIPLINE	7565
14'-0" WIDE PERVIOUS PAVING DRIVEWAY (W/ "TWO-TRACK" VEGETATION STRIP)	7565
PERVIOUS PAVING COURTYARD (PARKING)	7565
RE-VEGETATED NATIVE GRASS MEADOW	7565
PROTECTED GRASSLANDS, ZONE A	7565

GENERAL SITE NOTES




1. GRADING NOTES & SPOT ELEVATIONS, SEE CIVIL DRAWINGS
2. UTILITY AND LOCATION INFORMATION, SEE CIVIL DRAWINGS
3. AREA OF DISTURBANCE TO BE MINIMIZED BY CONTRACTOR
4. SPECIFIC TREE REMOVAL SPECIFICATIONS, SEE LANDSCAPE
5. RETAINING WALLS, TERRACES, AND FENCES, SEE LANDSCAPE FOR LOCATION & APPEARANCE

ELEVATION
0'-0" = 53'-9"

LOWER LEVEL ELEVATION
0'-3" = 54'-0"

GARAGE FLOOR ELEVATION
11'-9" = 65'-6"

MAIN LEVEL ELEVATION
11'-3" = 65'-0"

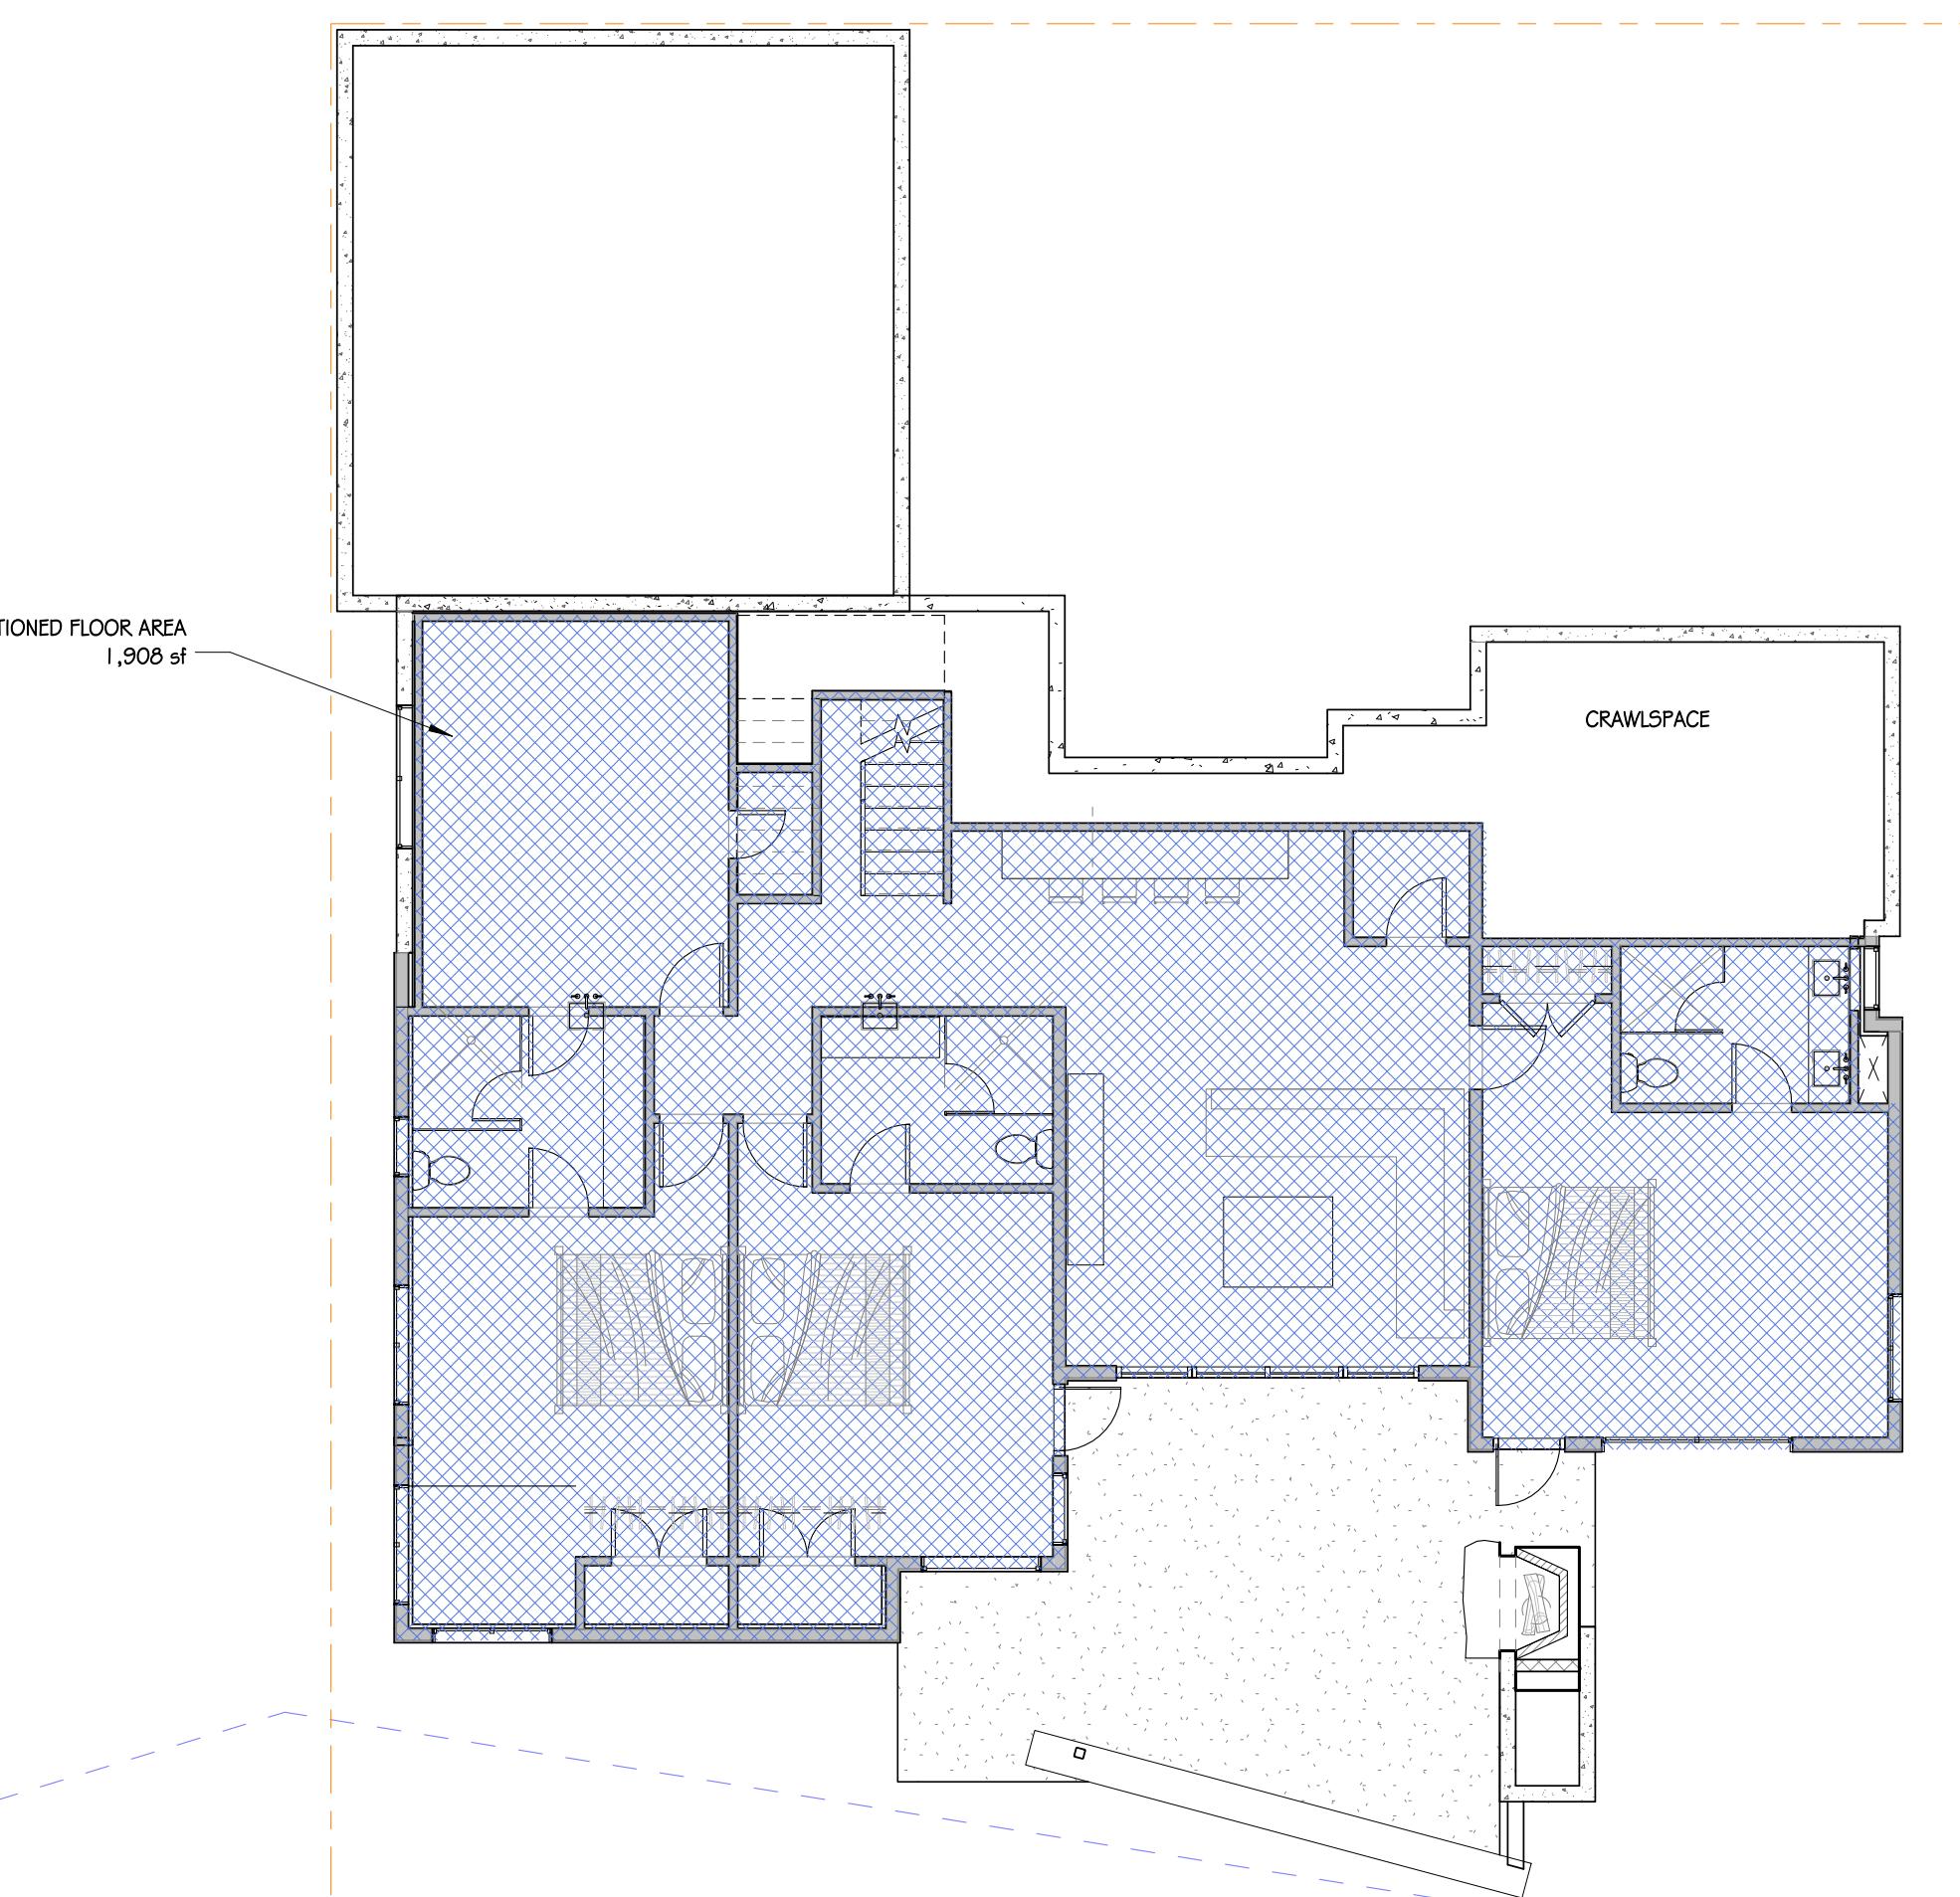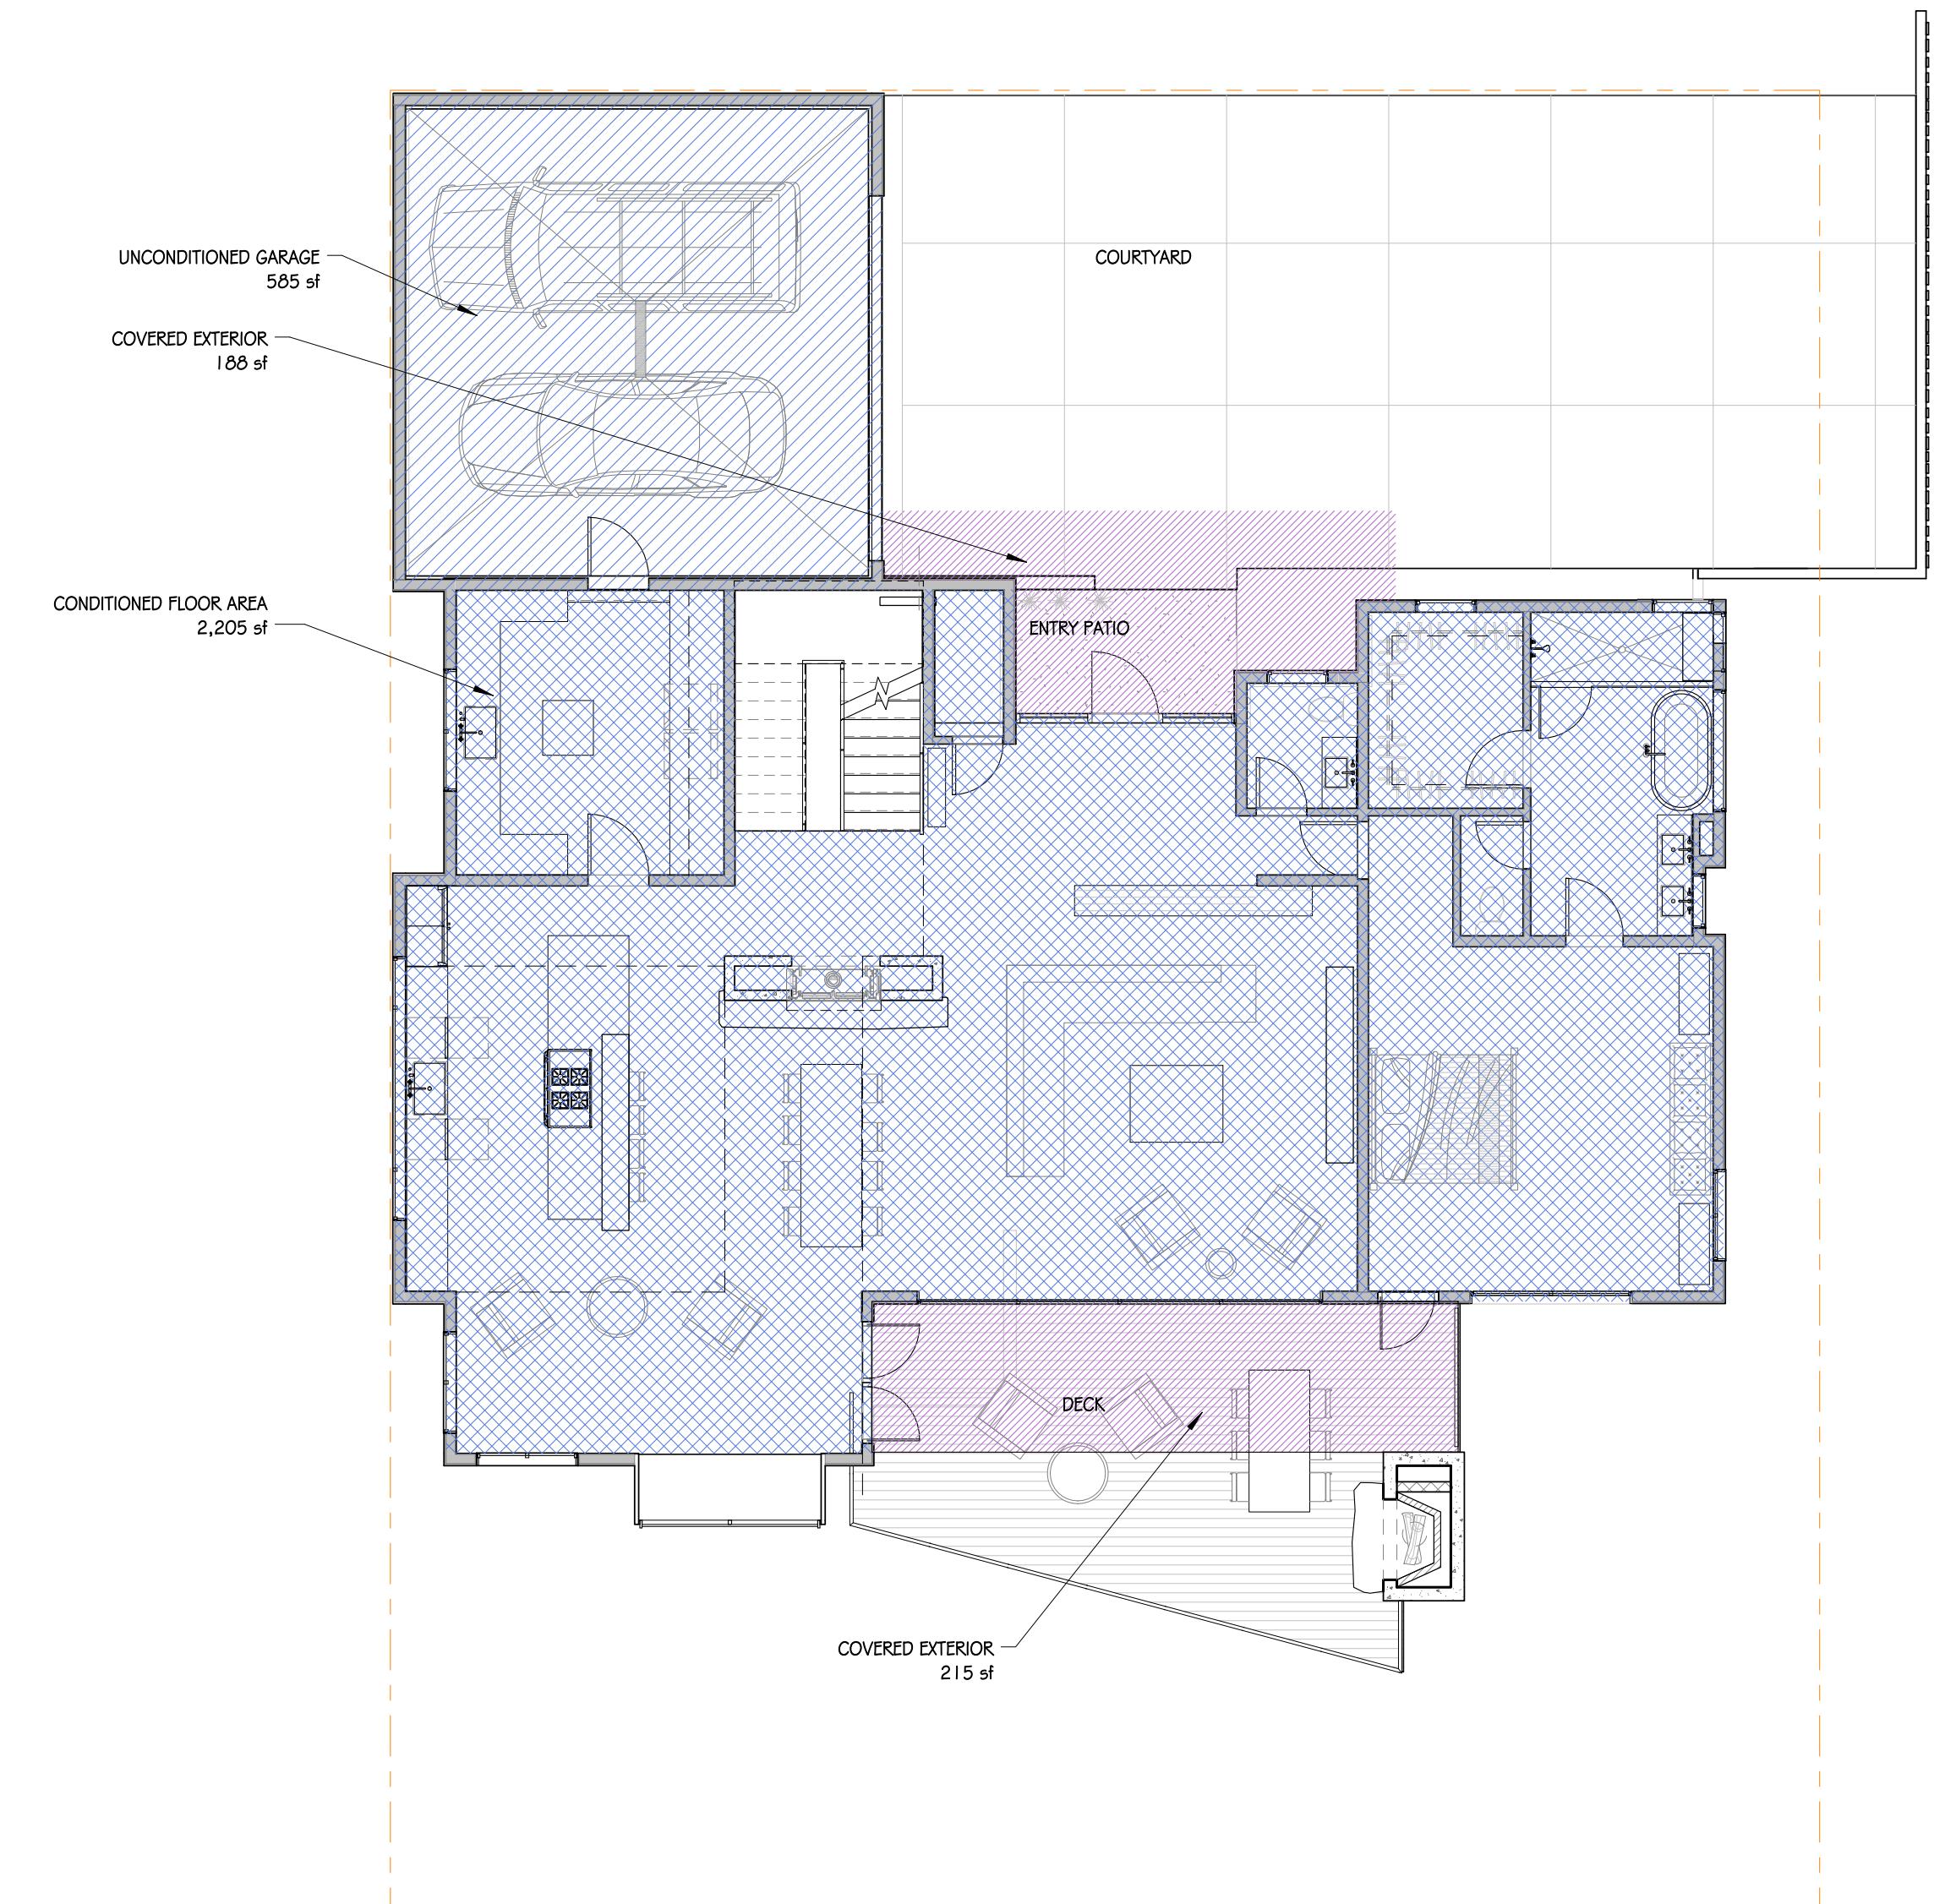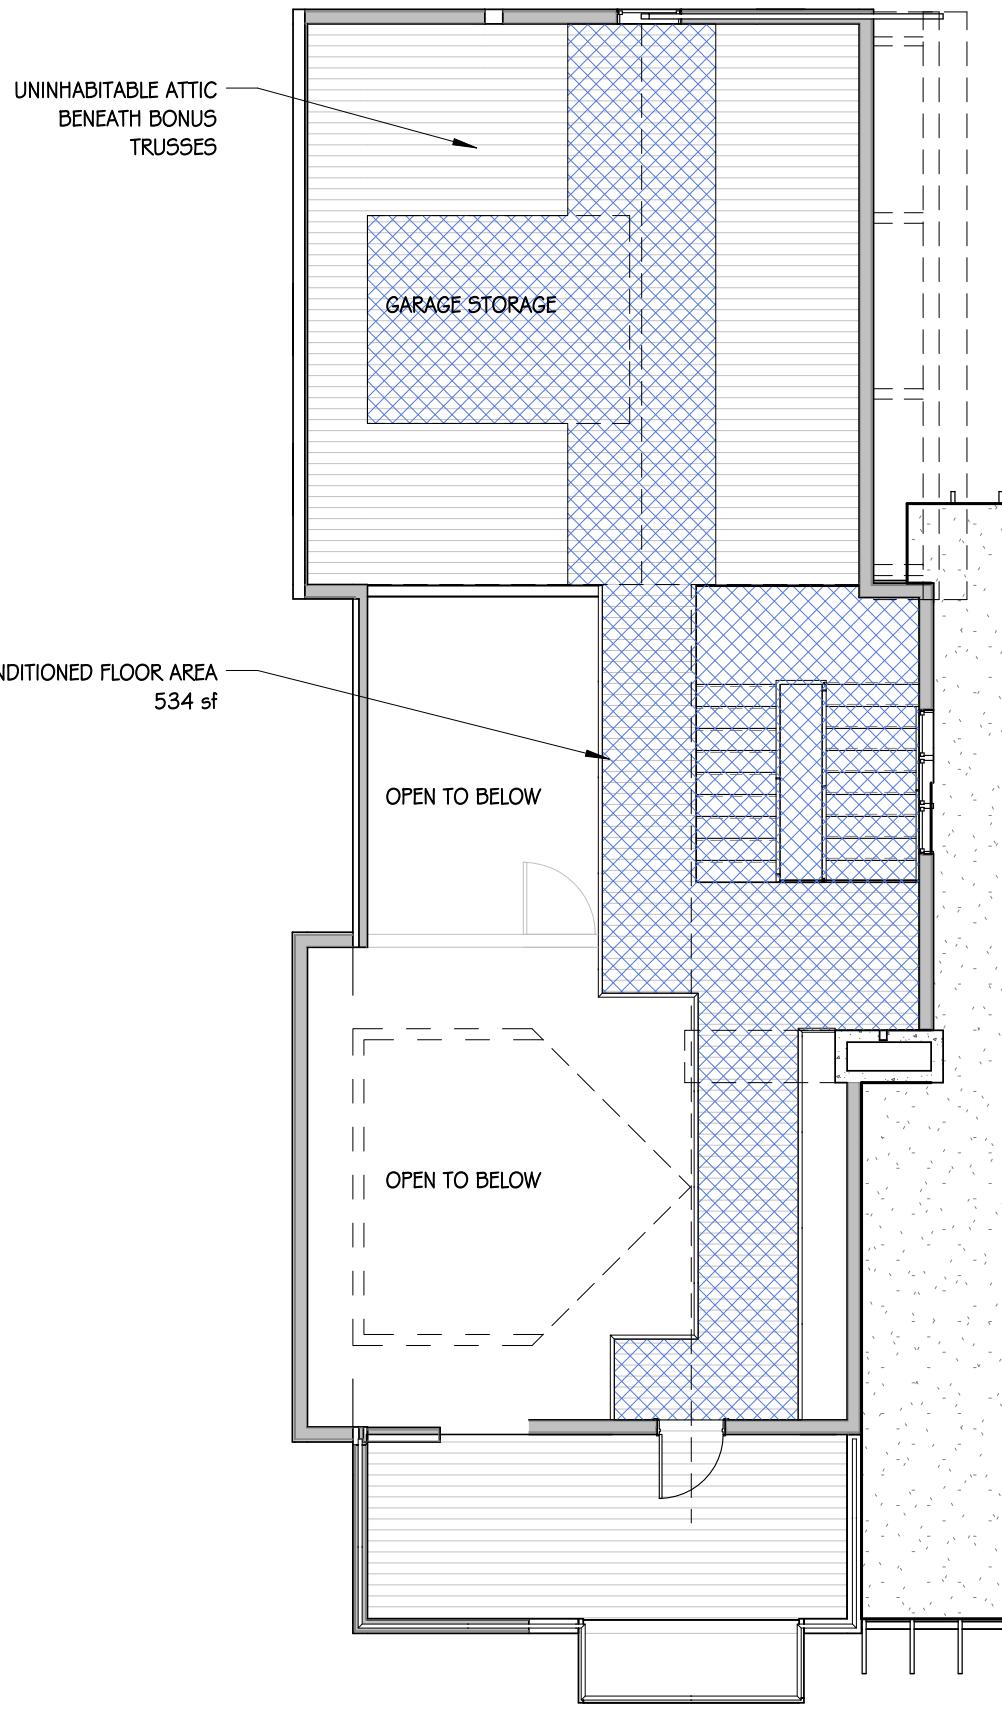

3 GARAGE STORAGE - AREA PLAN
1/8" = 1'-0"

2 MAIN LEVEL - AREA PLAN
1/8" = 1'-0"

1 LOWER LEVEL - AREA PLAN
1/8" = 1'-0"

HATCH LEGEND

CONDITIONED FLOOR AREA per SECTION G308C SUBSECTION a. (1) The floor area of all stories excluding uninhabitable attics as measured from the outside face of all exterior perimeter walls.
COVERED PATIO OR DECK per SECTION G308C SUBSECTION a. (2) The area of all decks, porches, balconies or other areas covered by a waterproof roof which extends four (4) or more feet from exterior walls.
UNCONDITIONED (GARAGE) FLOOR AREA per SECTION G308C SUBSECTION a. (3) The area of all garages and carports

SQUARE FOOTAGES

LOWER LEVEL (GROSS)	1,862 sf
MAIN LEVEL (GROSS)	2,132 sf
TOTAL SQ. FT.	3,994 sf
<hr/>	
GARAGE (GROSS)	56 sf
GARAGE STR/Roof ACCESS (GROSS)	534 sf
ELEVATED DECKS	420 sf
COVERED ENTRY PATIO	188 sf
COVERED REAR DECK	215 sf
<hr/>	
(1,862' + 56' + 420') / 22,220' = 12.91%	
TOTAL LOT COVERAGE	
(4,614' x 22,220' = .21)	
FLOOR AREA RATIO (FAR)	

MOSS BEACH - LOT 2

VALLEMAR ST. & JULIANNA AVE.

REVISION NO. DATE
COASTSIDE DESIGN REVIEW APPLICATION
DRAWING AREA PLANS
PROJECT NUMBER: 1507
DATE: JULY 24, 2017
DESIGN REVIEW SET
SHEET NO.


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MOSS BEACH - LOT 2

VALLEMAR ST. & JULIANNA AVE.

REVISION NO.	DATE
COASTSIDE DESIGN REVIEW APPLICATION	
DRAWING:	FLOOR PLANS
PROJECT NUMBER:	I507
DATE:	JULY 24, 2017
DESIGN REVIEW SET	
SHEET NO.	

A2.1

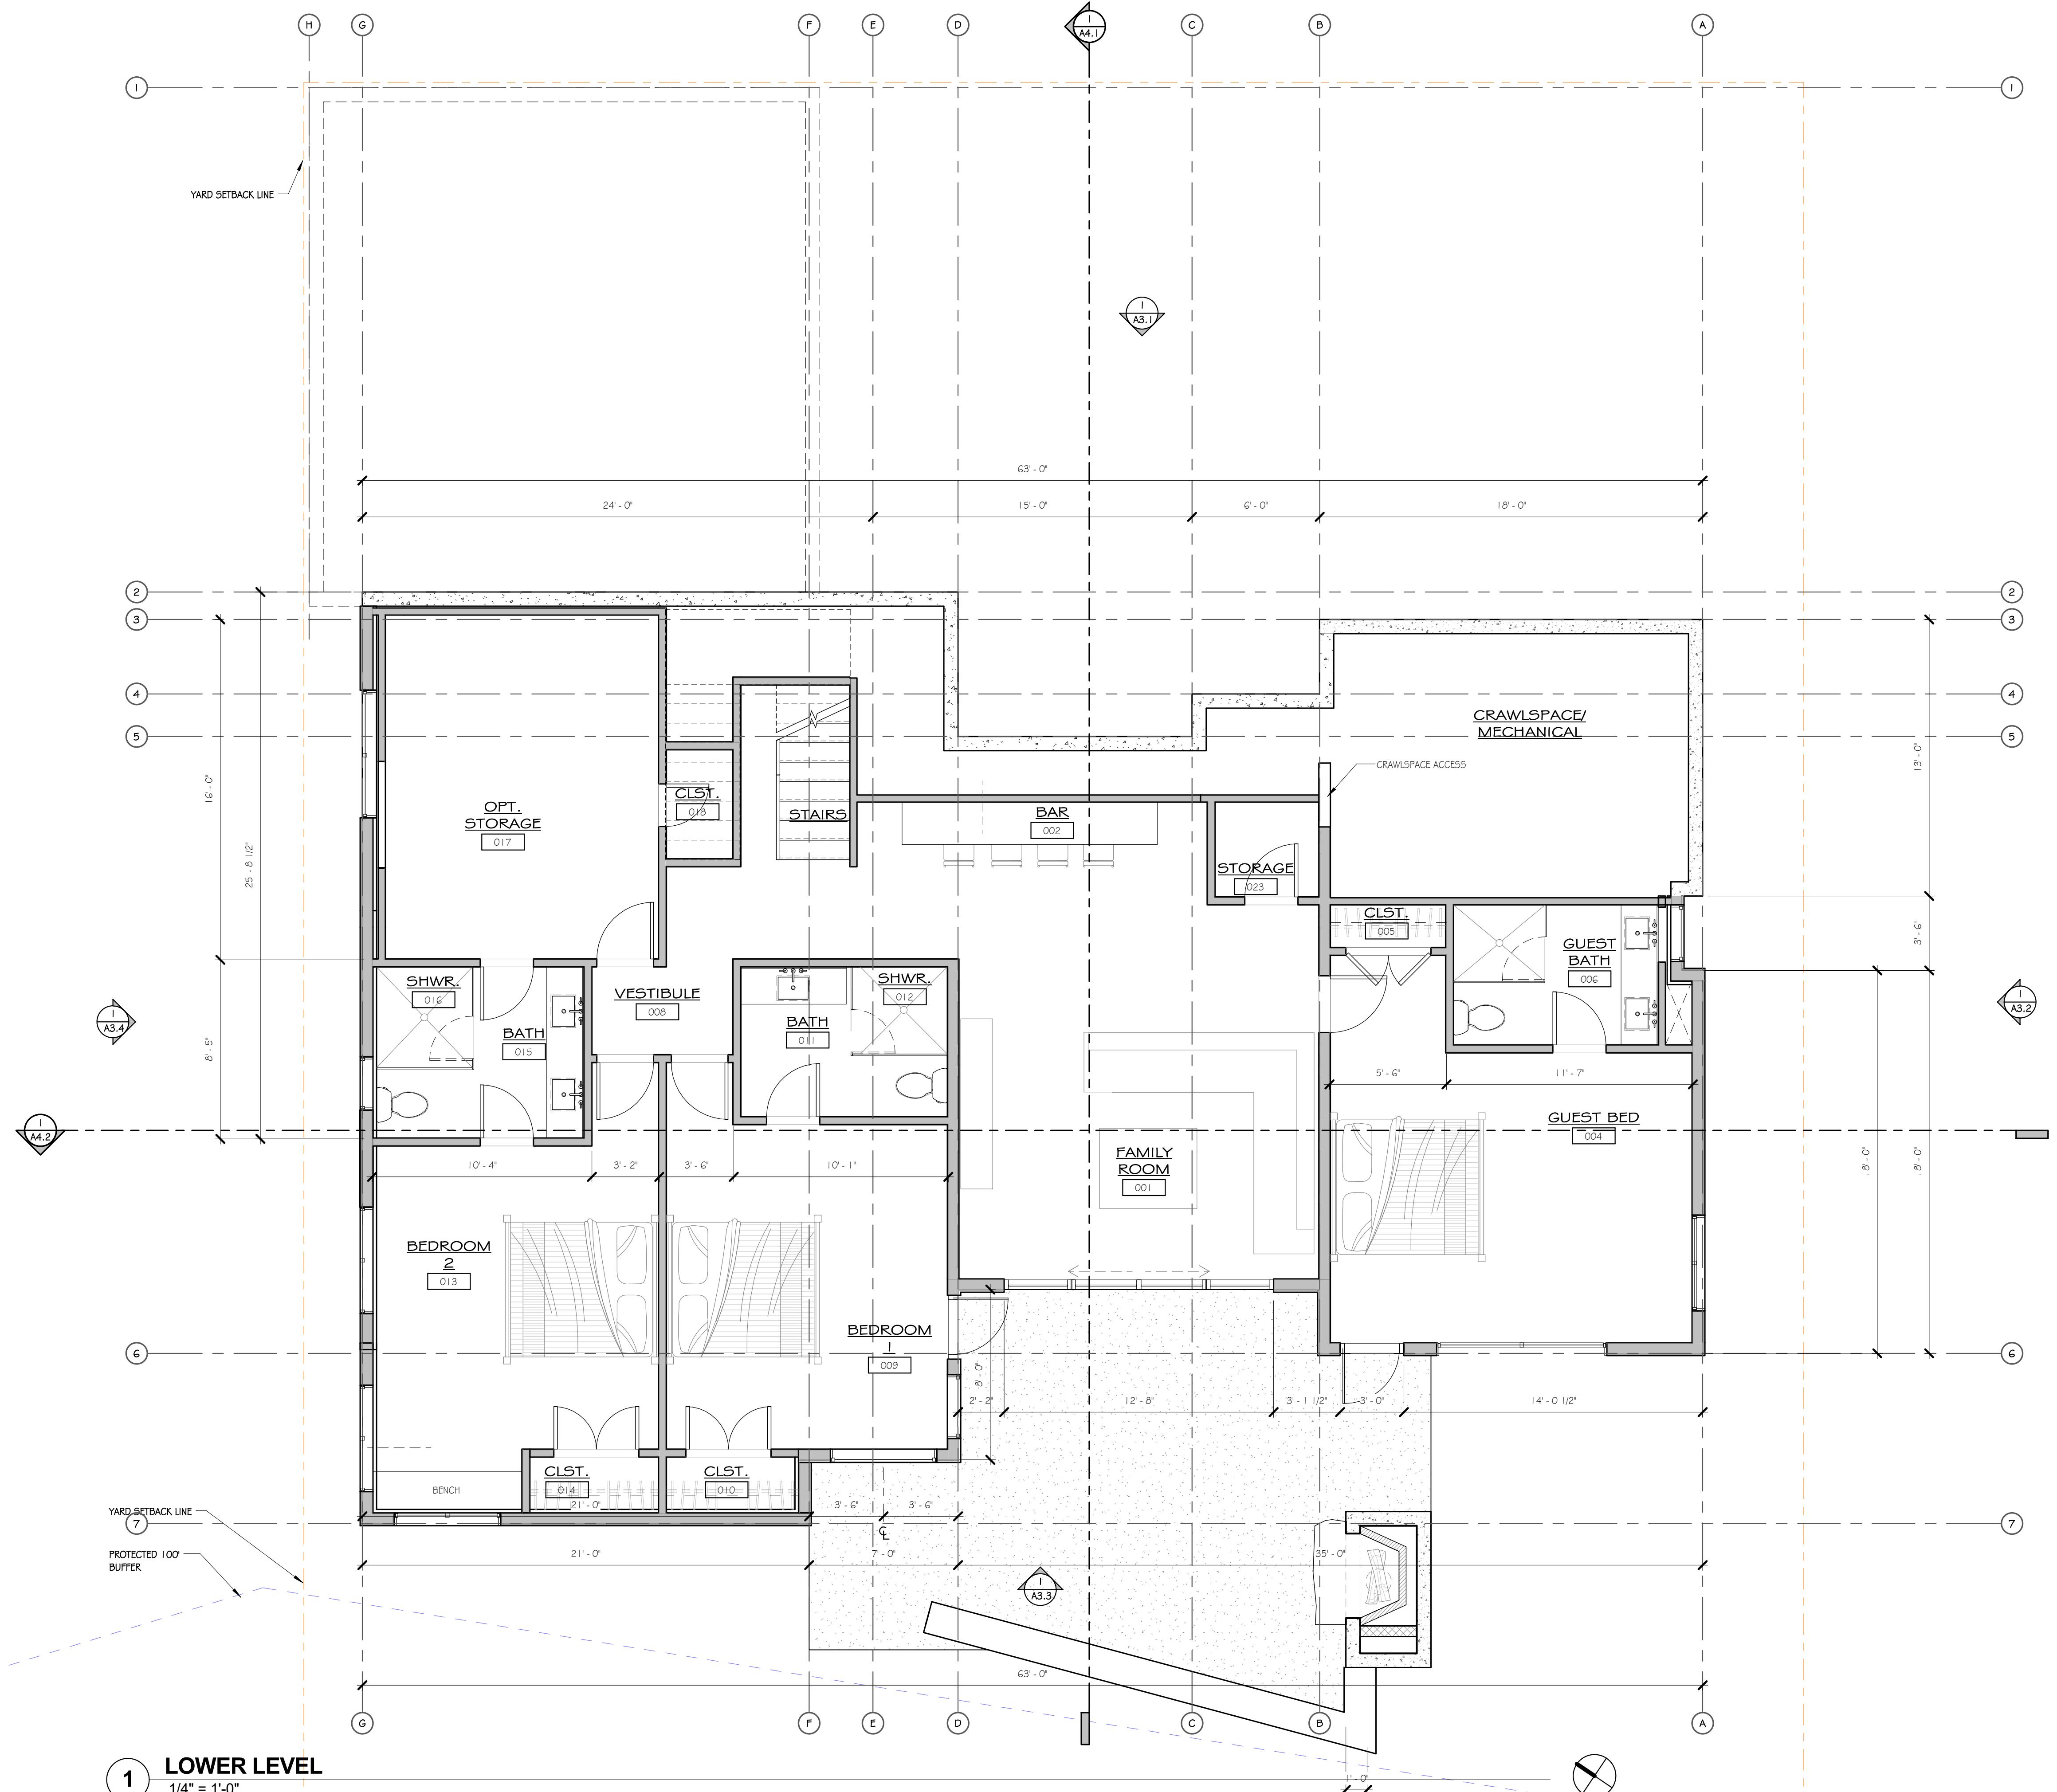

MOSS BEACH - LOT 2

VALLEMAR ST. & JULIANNA AVE.

COASTSIDE DESIGN
REVIEW APPLICATION

DRAWING:
FLOOR PLANS

PROJECT NUMBER: 1507
DATE: JULY 24, 2017


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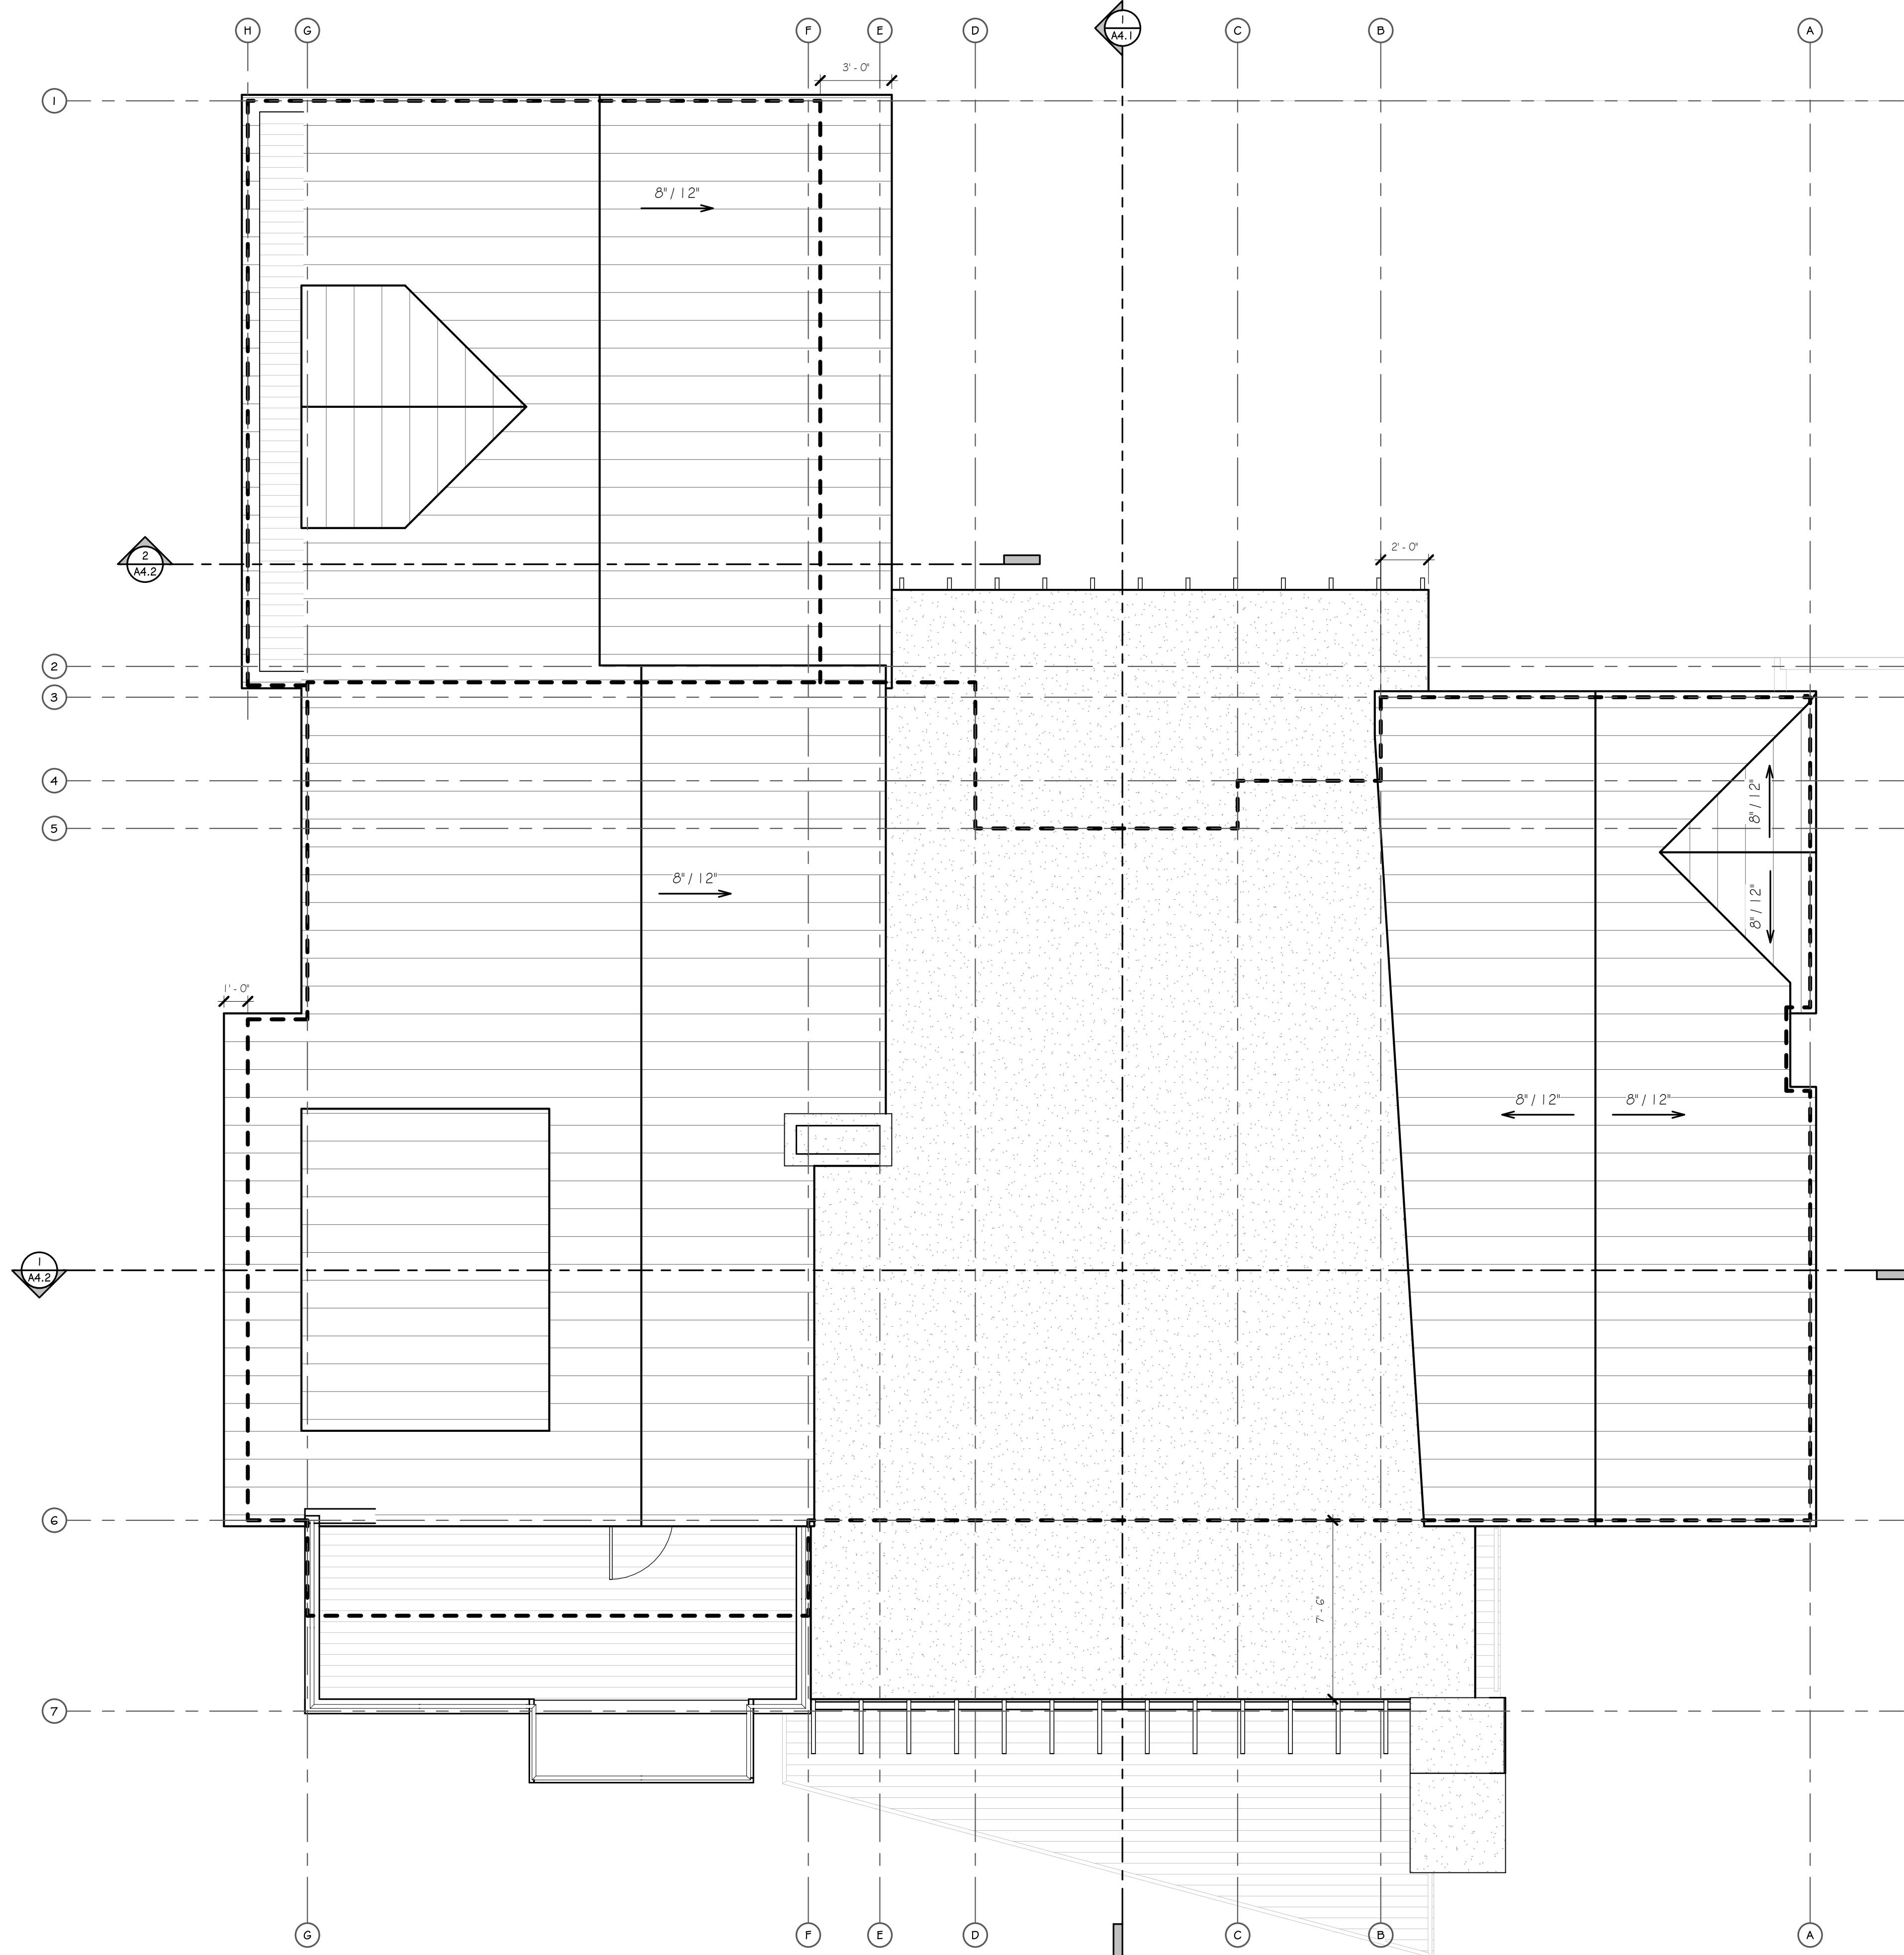
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A2.2


THESE DRAWINGS ARE THE ORIGINAL UNPUBLISHED WORK
OF THE ARCHITECT AND MAY NOT BE DUPLICATED OR USED
WITHOUT THE WRITTEN CONSENT OF THE ARCHITECT.

FILE PATH: P:\CURRENT\1507 MOSS BEACH, SAN MATEO, CA\1.0 DRAWINGS\1_CURRENT
SET1.REV1\02.LOT_NEW.mif



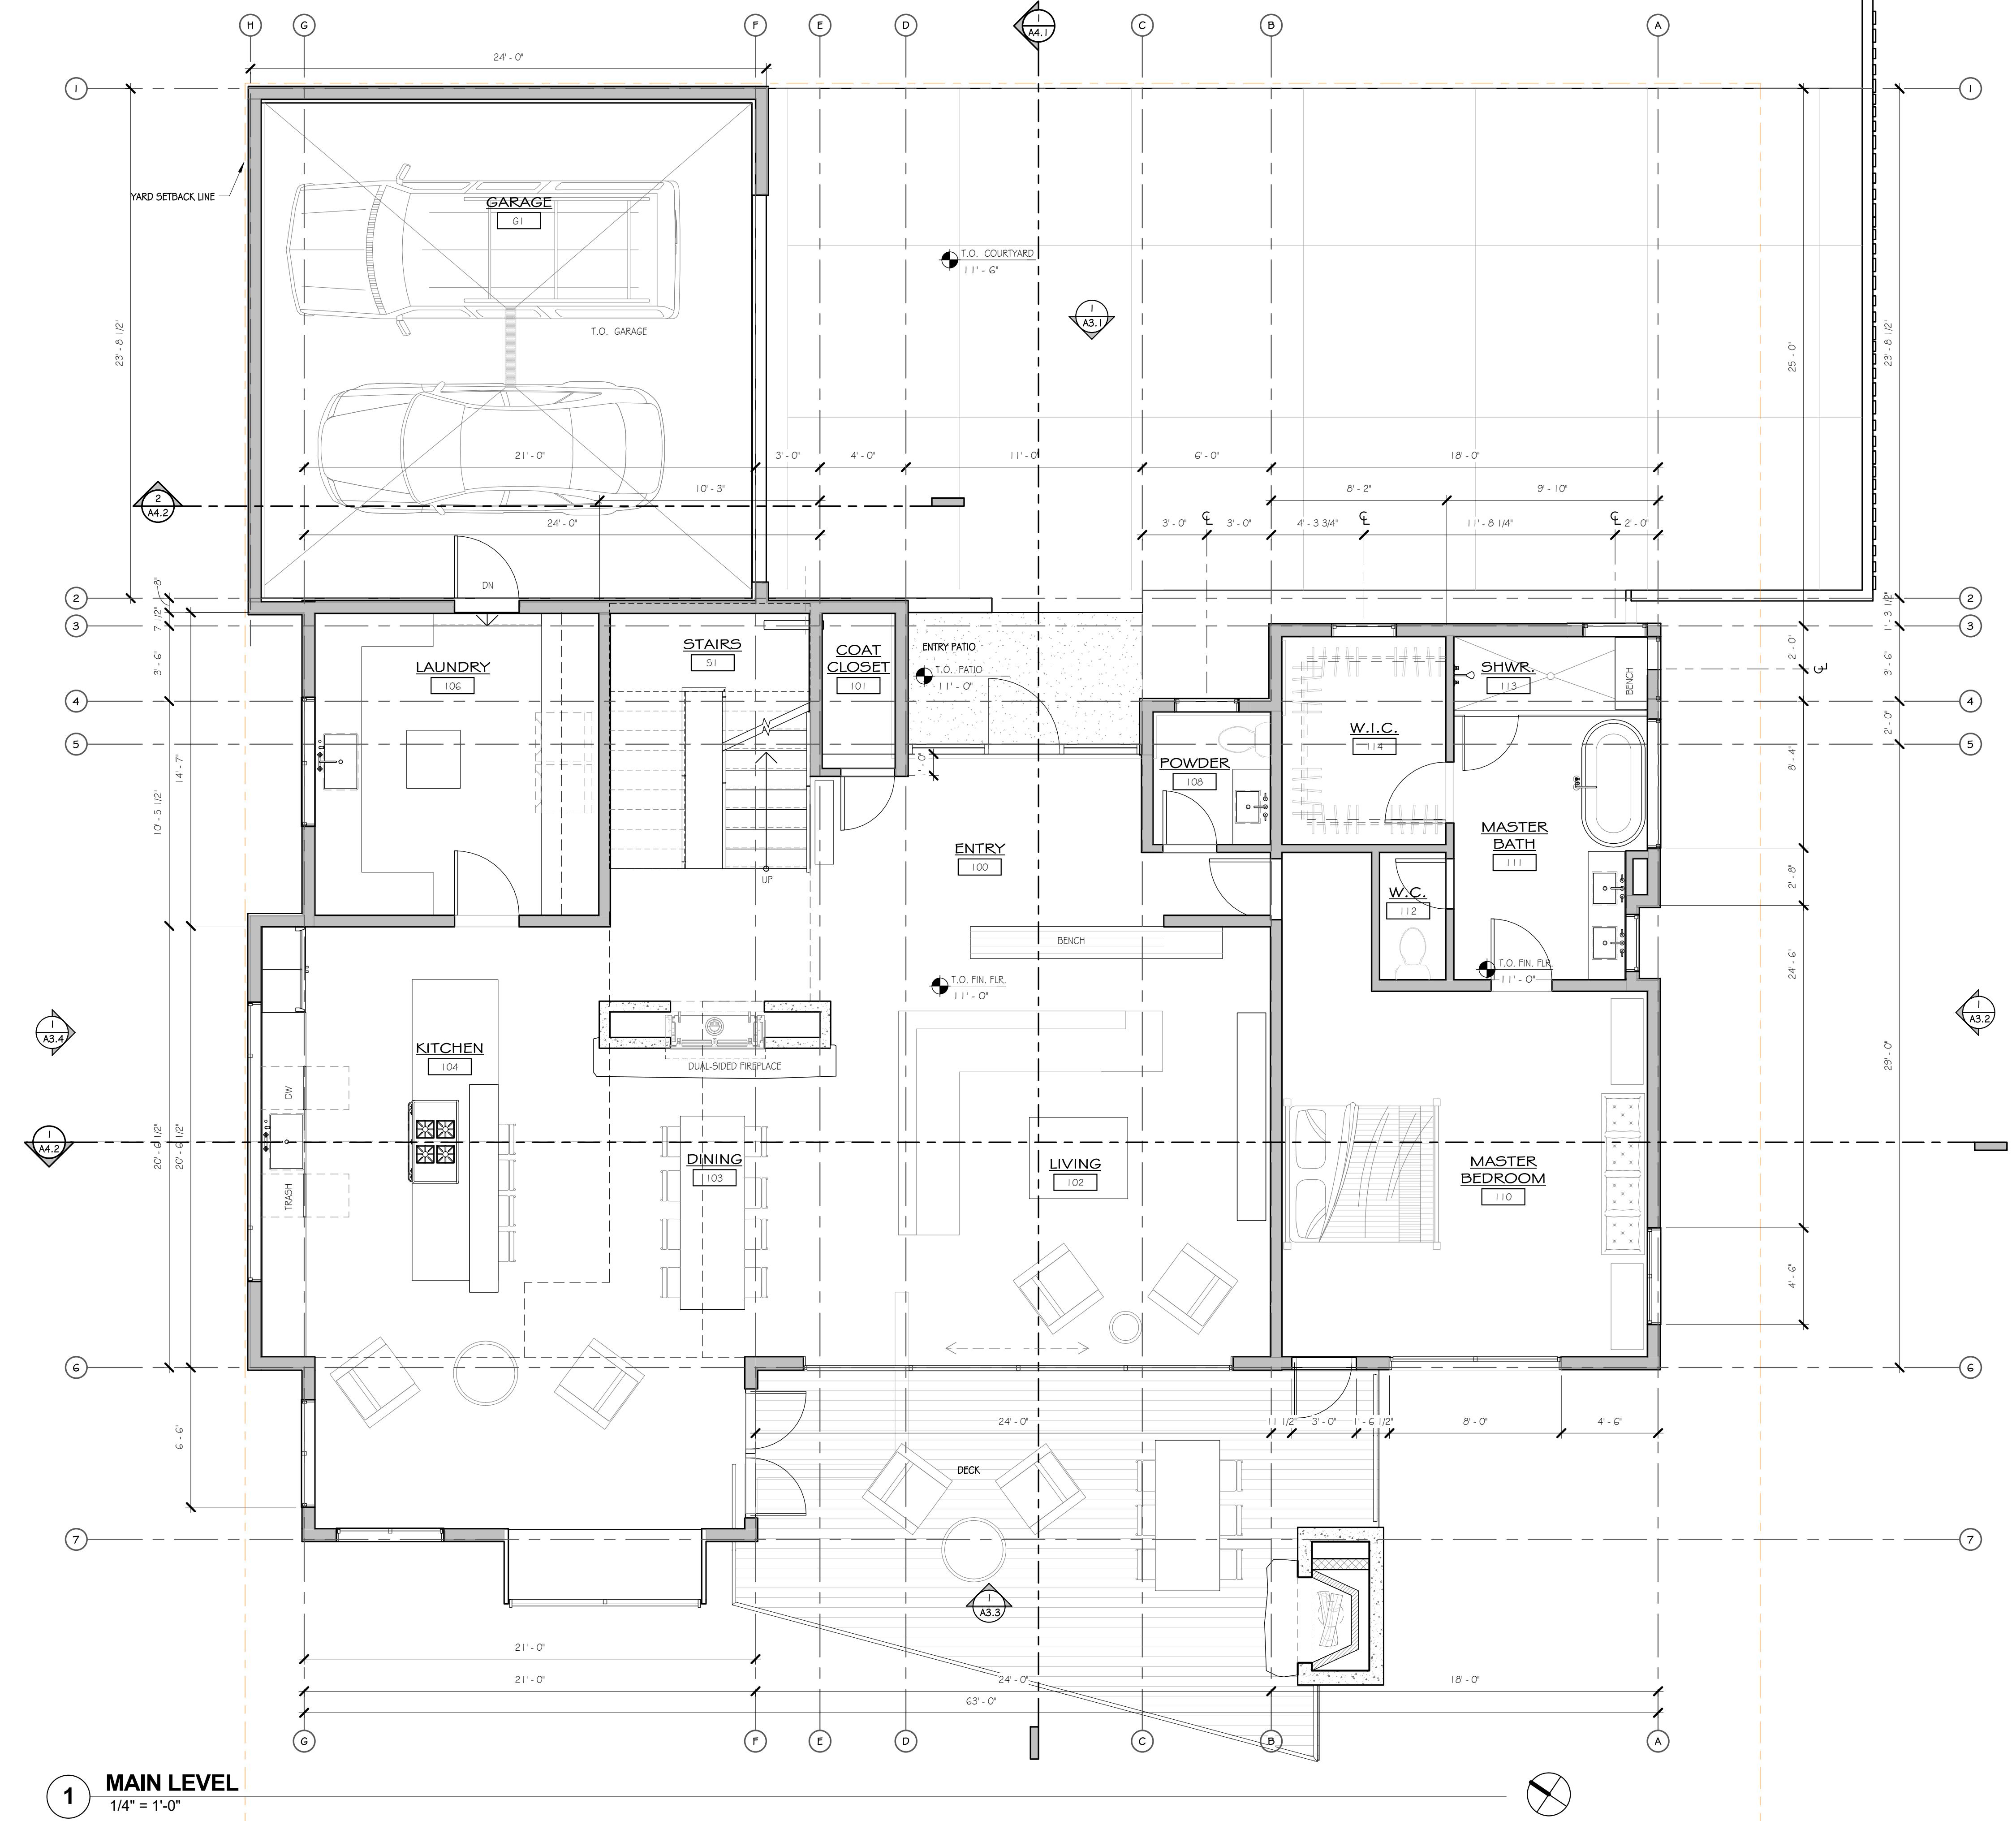

2 ROOF PLAN
1/4" = 1'-0"

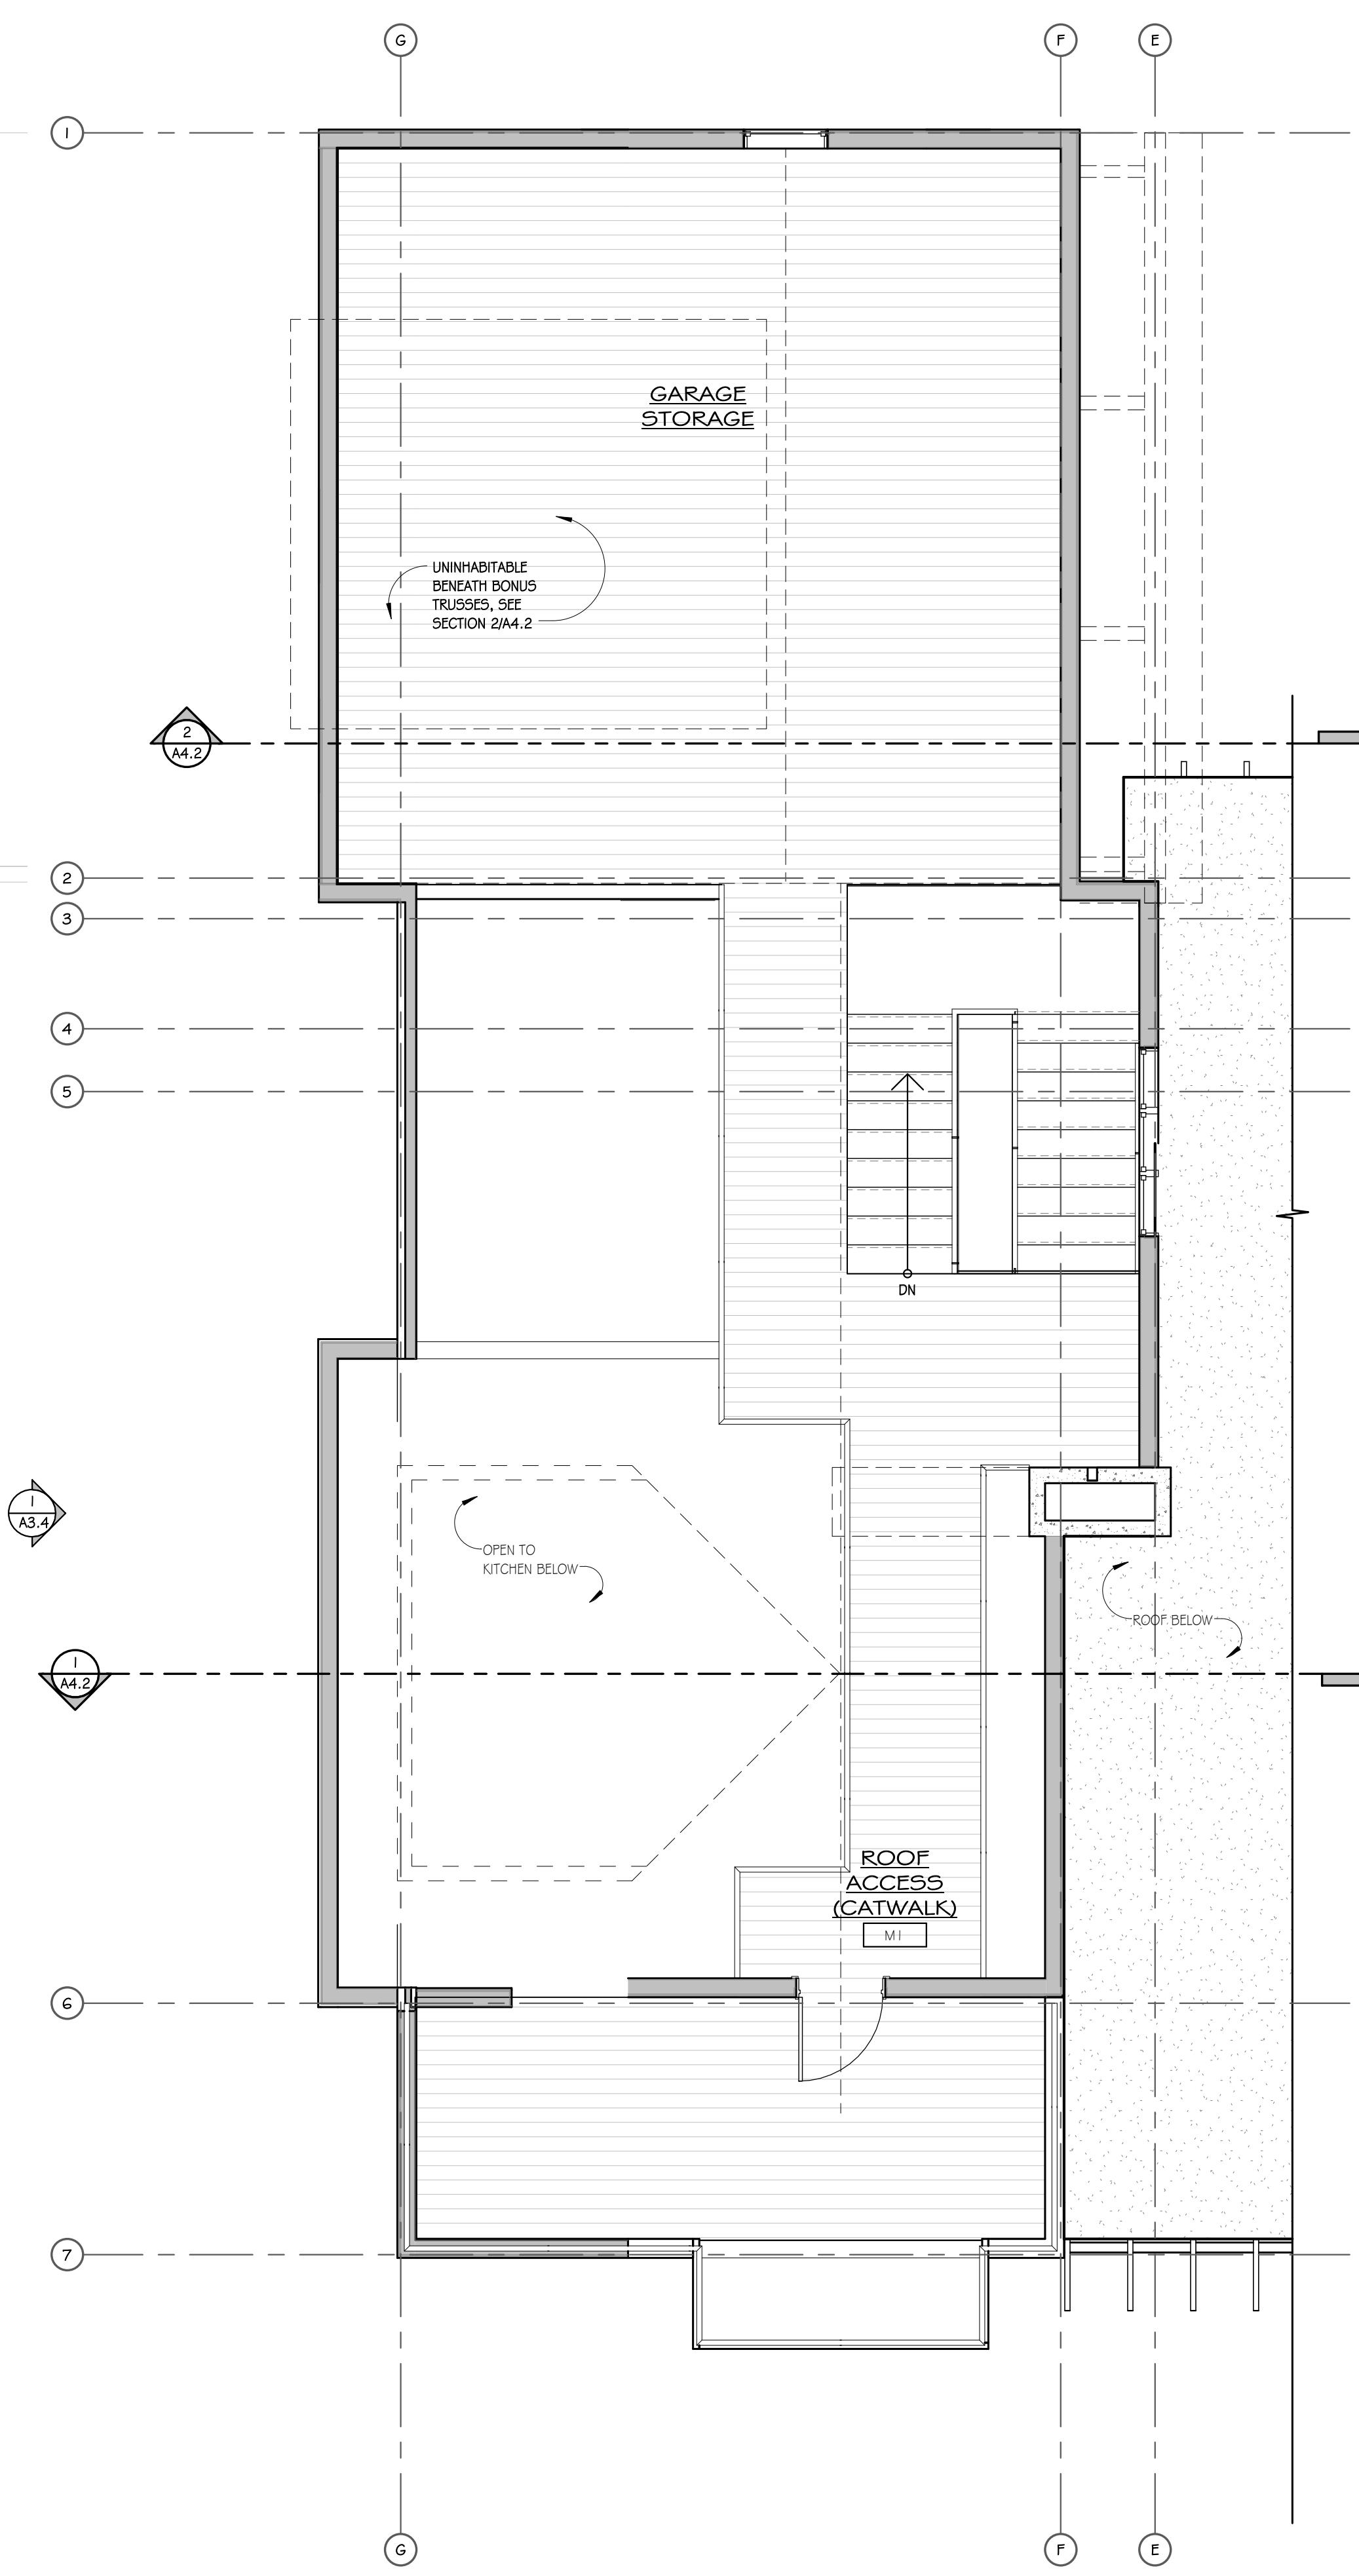

1 ROOF ACCESS
1/4" = 1'-0"

A2.3

MOSS BEACH - LOT 2

VALLEMAR ST. & JULIANNA AVE.

REVISION
NO. DATE

COASTSIDE DESIGN
REVIEW APPLICATION

DRAWING
ROOF PLAN & ROOF
ACCESS

PROJECT NUMBER: 1507
DATE: JULY 24, 2017
DESIGN REVIEW SET

SHEET NO.

MATERIALS



SIDING
1X8 ROUGH-SAWN CEDAR, OR REDWOOD
HORIZONTAL PLANK W/ REVEAL EVERY THIRD
BOARD



COLOR
SIDING
CEMENTITIOUS PANELS




WALLS
CMU VENEER,
(OR BOARD-FORMED CONCRETE)




ROOF
STANDING SEAM
METAL ROOF
W/ BONDERIZED FINISH




FLAT ROOF
EPDM MEMBRANE
W/ SCREE BALLAST

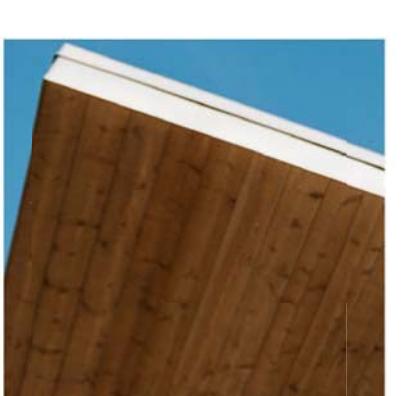

SOFFITS
ROUGH-SAWN CEDAR
(OR REDWOOD)

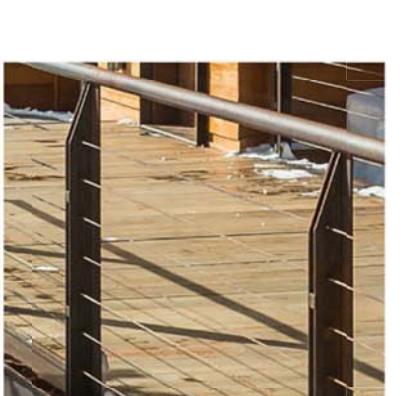

RAILINGS & TRIM
STAINLESS STEEL CABLE RAILINGS
& STAINLESS STEEL TRIM

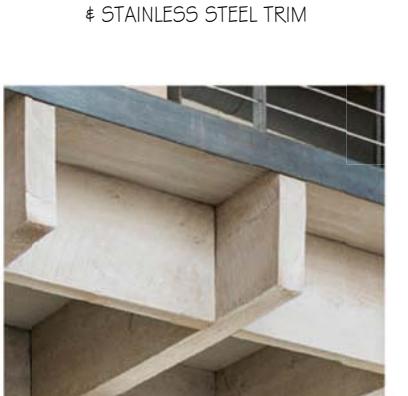

RAFTERS
ROUGH SAWN FIR

MOSS BEACH - LOT 2

VALLEMAR ST. & JULIANNA AVE.

PDC
PEARSON
DESIGN GROUP

102 N. BROADWAY AVE., BOZEMAN, MT 59715
OFFICE: 406.587.9997 FAX: 406.587.0391
WWW.PEARSONDESIGNGROUP.COM

REVISION
NO. DATE

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REVIEW APPLICATION


DRAWING
ELEVATIONS

PROJECT NUMBER: 1507
DATE: JULY 24, 2017

DESIGN REVIEW SET

SHEET NO.

A3.1

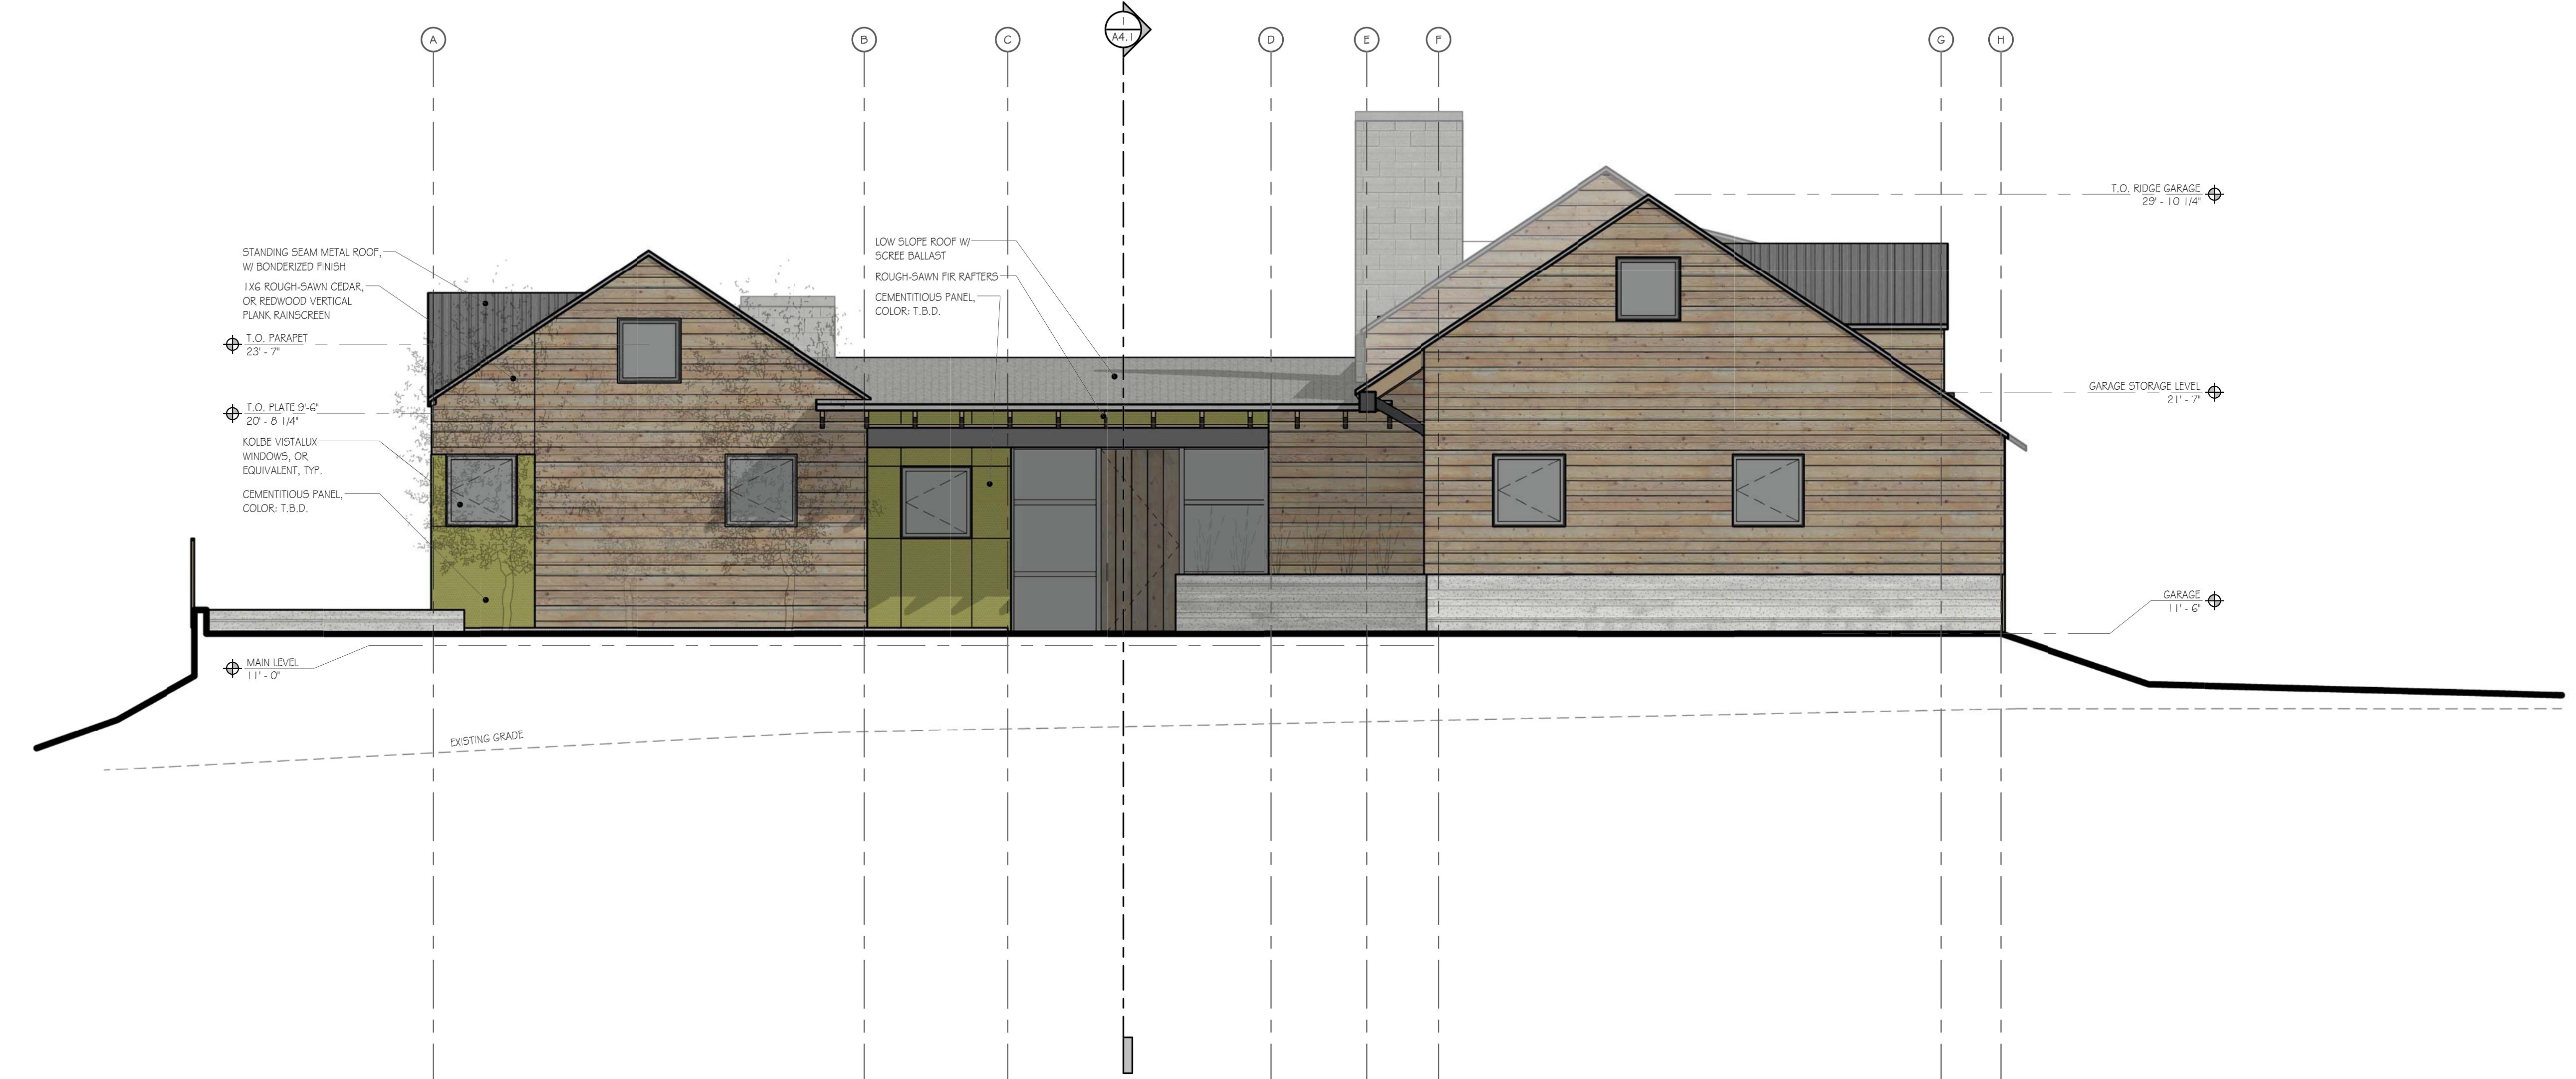



MATERIALS



SIDING
1X8 ROUGH-SAWN CEDAR, OR REDWOOD
HORIZONTAL PLANK W/ REVEAL EVERY THIRD
BOARD



COLOR



WALLS
CMU VENEER,
(OR BOARD-FORMED CONCRETE)




ROOF
STANDING SEAM
METAL ROOF
W/ BONDERIZED FINISH



FLAT ROOF
EPDM MEMBRANE
W/ SCREE BALLAST



SOFFITS
ROUGH-SAWN CEDAR
(OR REDWOOD)

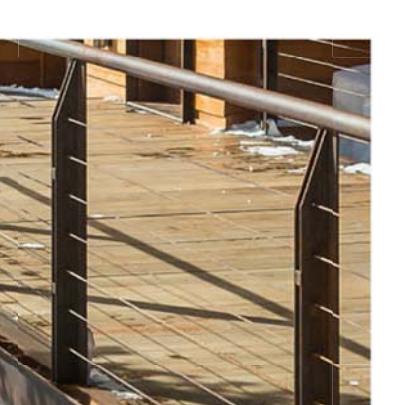

RAILINGS & TRIM
STAINLESS STEEL CABLE RAILINGS
& STAINLESS STEEL TRIM



RARTERS
ROUGH-SAWN FIR

MOSS BEACH - LOT 2

VALLEMAR ST. & JULIANNA AVE.

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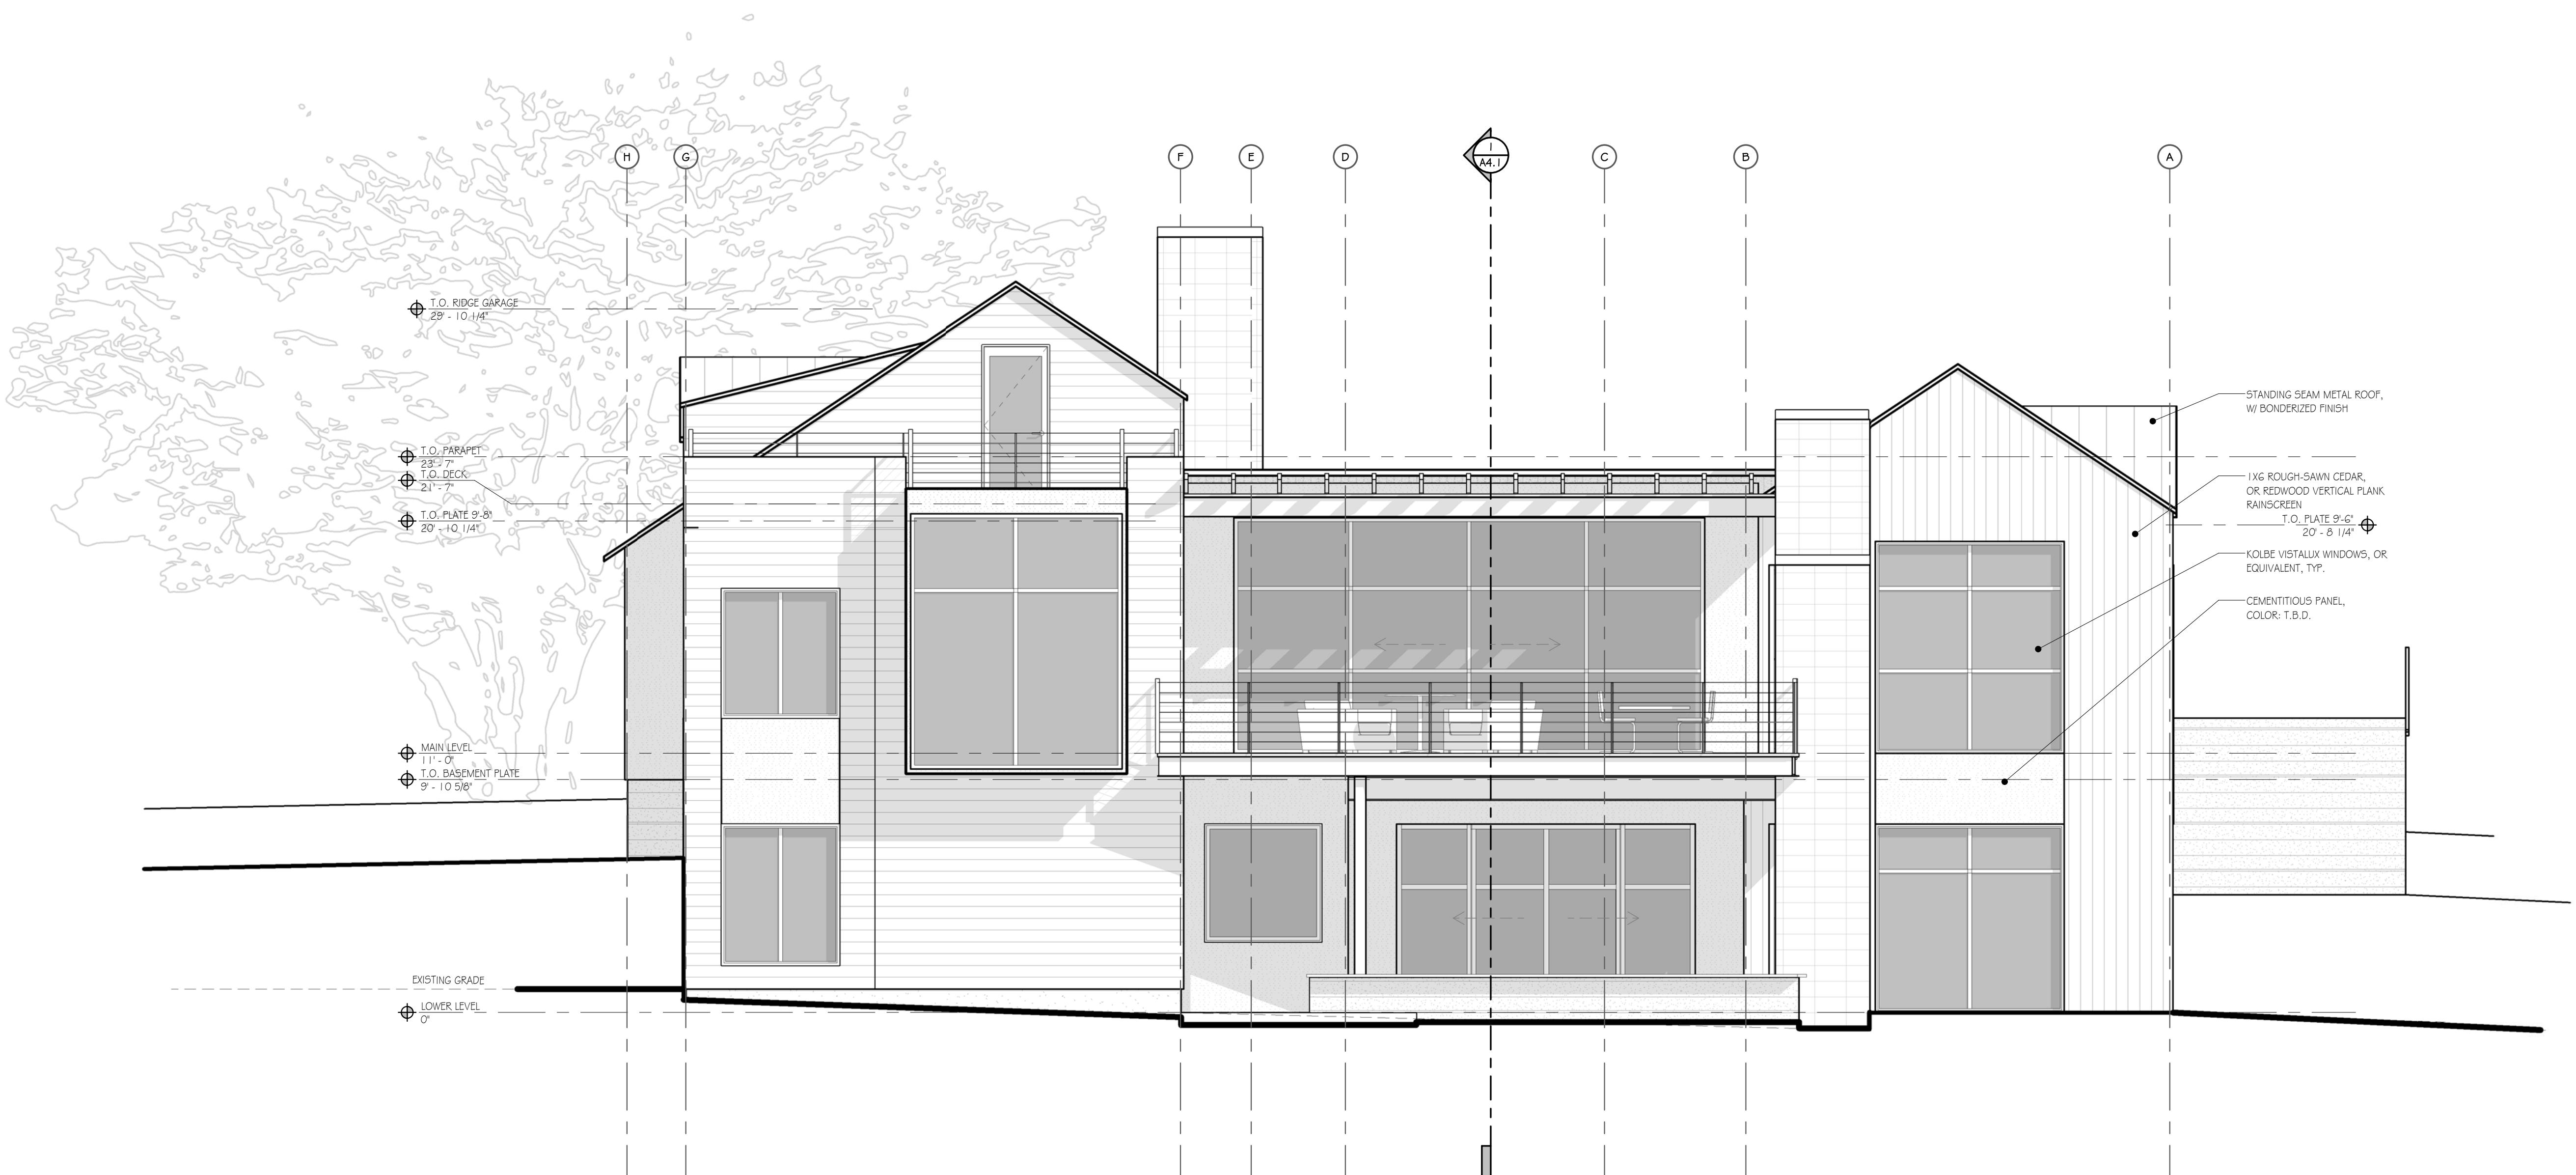
COASTSIDE DESIGN
REVIEW APPLICATION

DRAWING:
ELEVATIONS

PROJECT NUMBER: 1507
DATE: JULY 24, 2017

DESIGN REVIEW SET
SHEET NO.

A3.2



1 SOUTH ELEVATION
1/4" = 1'-0"

MATERIALS



SIDING
1x8 ROUGH-SAWN CEDAR, OR REDWOOD
HORIZONTAL PLANK W/ REVEAL EVERY THIRD
BOARD



SIDING
CEMENTITIOUS PANELS
COLOR




WALLS
CMU VENEER,
(OR BOARD-FORMED CONCRETE)




ROOF
STANDING SEAM
METAL ROOF
W/ BONDERIZED FINISH




ROOF
EPDM MEMBRANE
W/ SCREE BALLAST

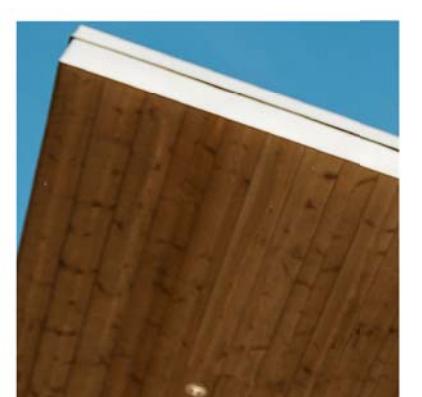

SOFFITS
ROUGH-SAWN CEDAR
(OR REDWOOD)

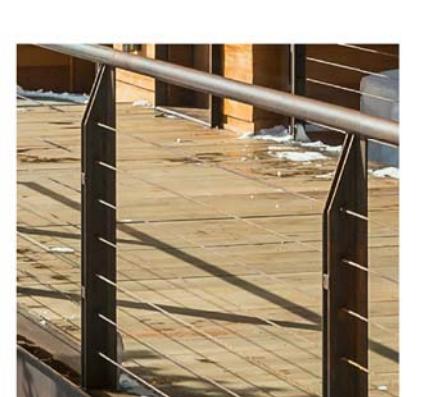

RAILINGS & TRIM
STAINLESS STEEL CABLE RAILINGS
& STAINLESS STEEL TRIM

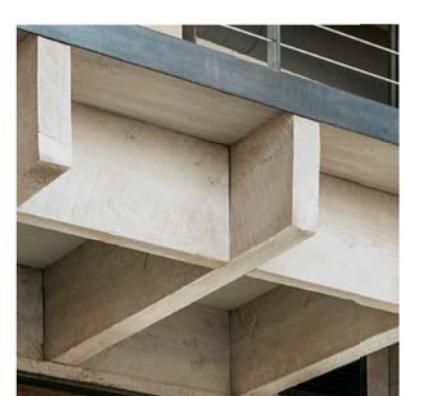

RAFTERS
ROUGH SAWN FIR

MOSS BEACH - LOT 2



VALLEMAR ST. & JULIANNA AVE.

REVISION
NO. DATE
COASTSIDE DESIGN
REVIEW APPLICATION

DRAWING
ELEVATIONS

PROJECT NUMBER: 1507
DATE: JULY 24, 2017
DESIGN REVIEW SET
SHEET NO.

A3.3

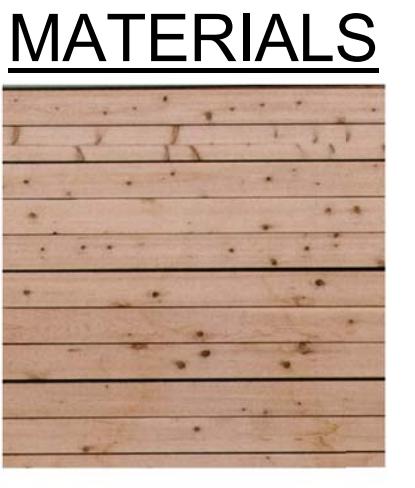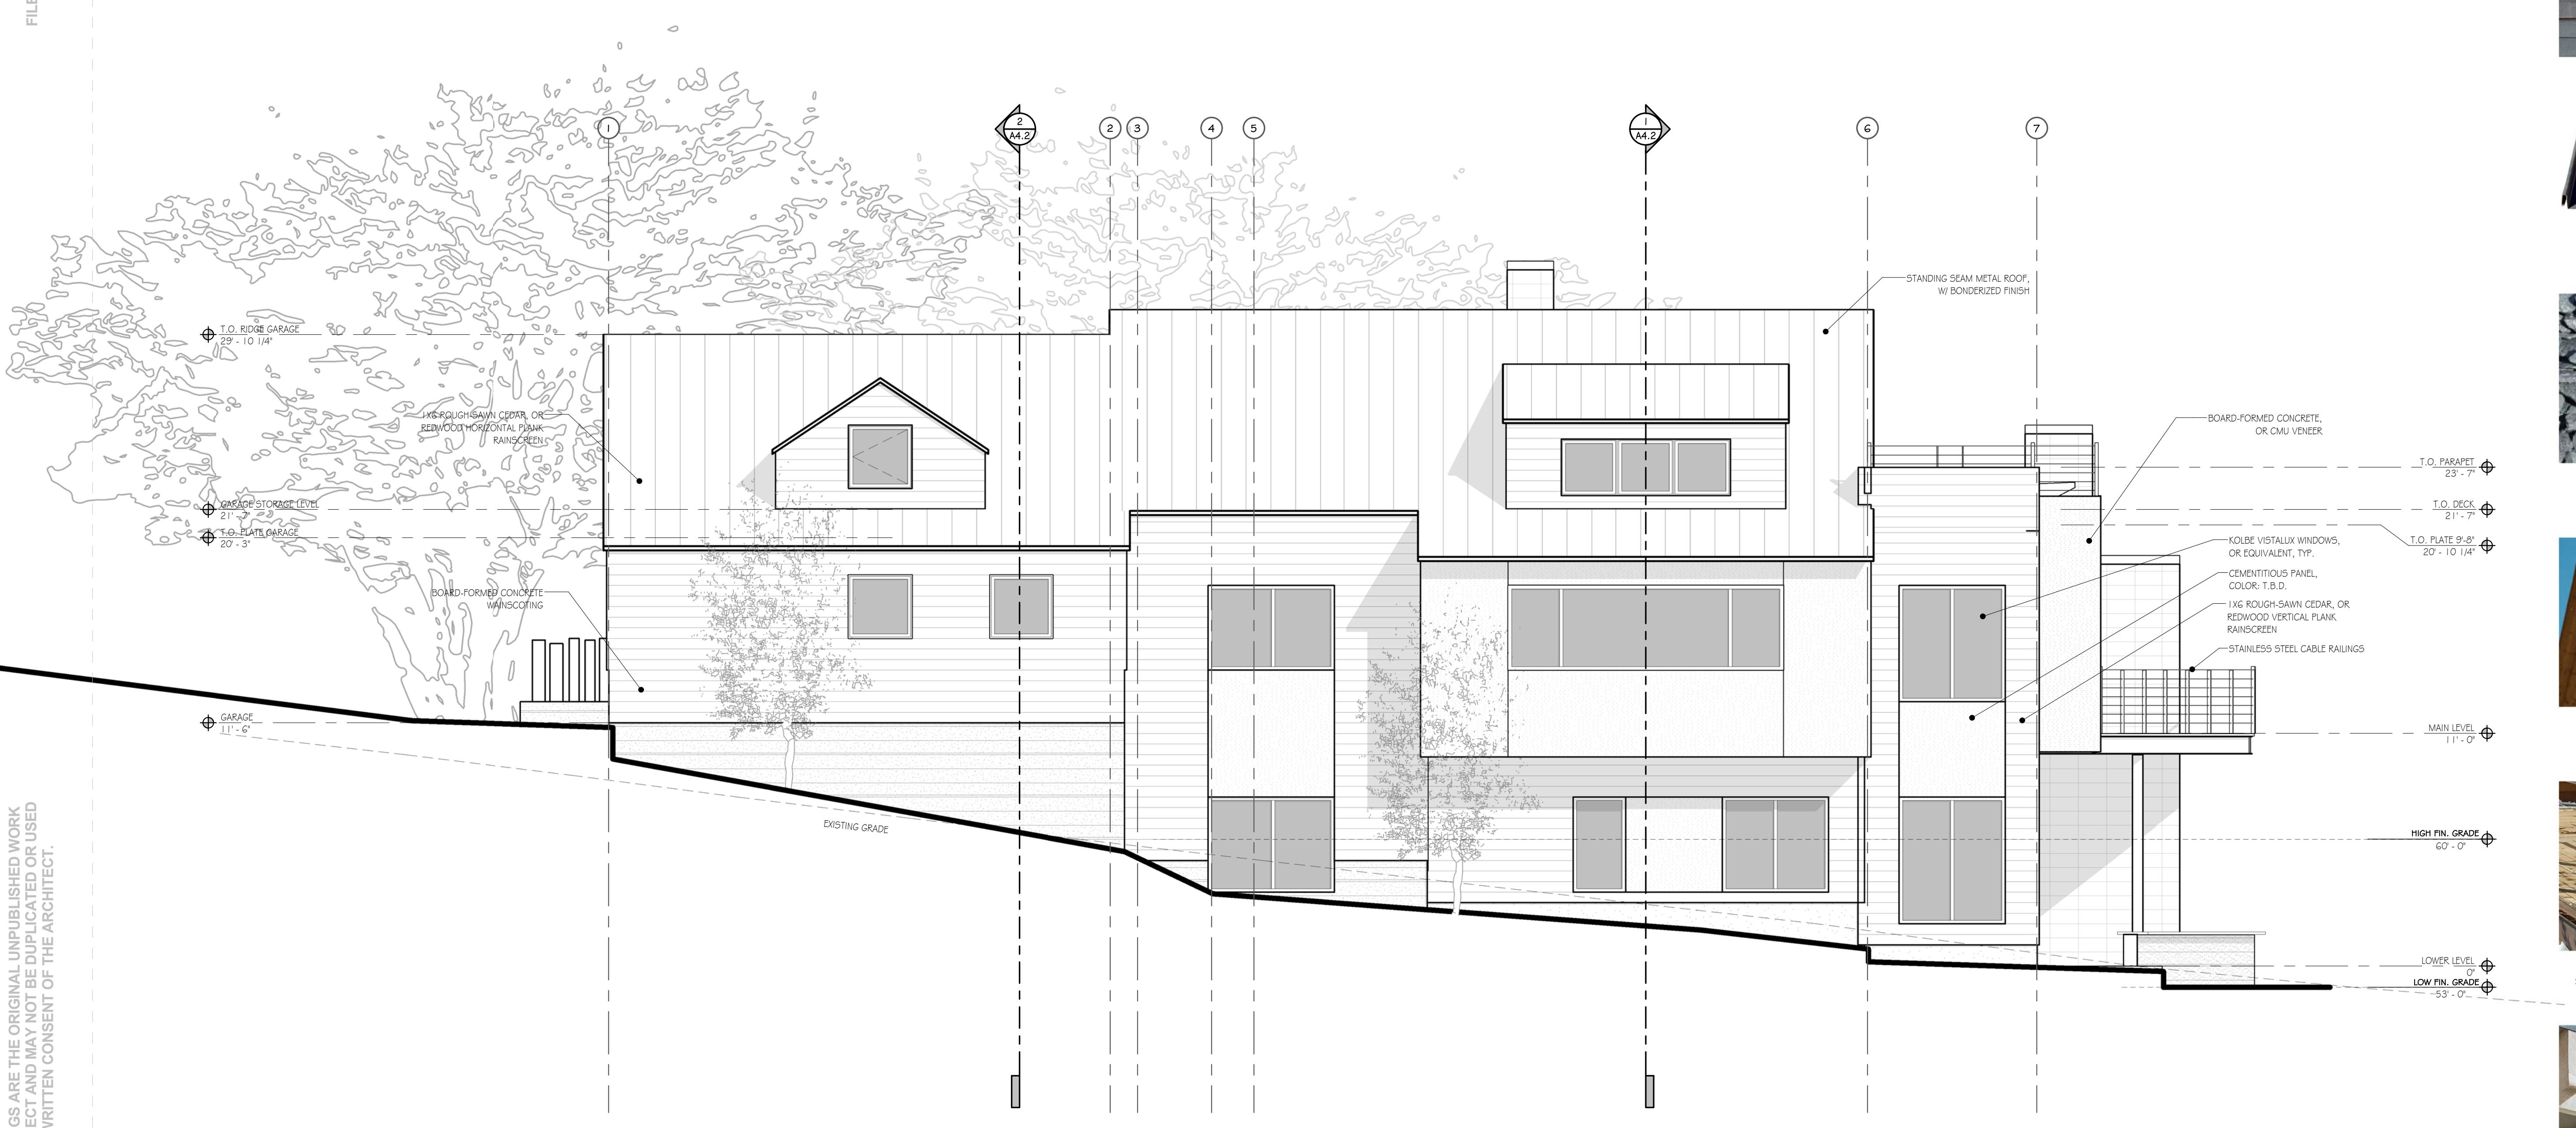

SIDING
1X8 ROUGH-SAWN CEDAR, OR REDWOOD
HORIZONTAL PLANK W/ REVEAL EVERY THIRD
BOARD



COLOR
CEMENTITIOUS PANELS




WALLS
CMU VENEER,
(OR BOARD-FORMED CONCRETE)




ROOF
STANDING SEAM
METAL ROOF
W/ BONDERIZED FINISH



FLAT ROOF:
EPDM MEMBRANE
W/ SCREE BALLAST

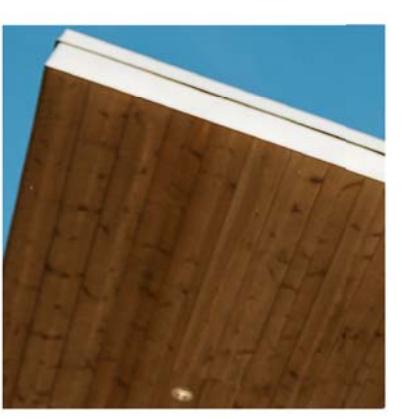

SOFFITS
ROUGH-SAWN CEDAR
(OR REDWOOD)

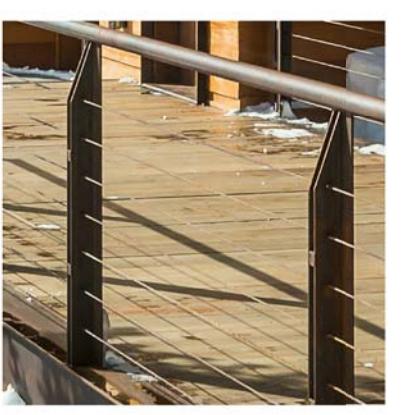

RAILINGS + TRIM
STAINLESS STEEL CABLE RAILINGS
& STAINLESS STEEL TRIM



RAFTERS
ROUGH SAWN FIR

MATERIALS

MOSS BEACH - LOT 2

VALLEMAR ST. & JULIANNA AVE.

COASTSIDE DESIGN
REVIEW APPLICATION

REVISION
NO. DATE

PROJECT NUMBER: 1507

DATE: JULY 24, 2017

DESIGN REVIEW SET

DRAWING
ELEVATIONS

FILE NUMBER:

JULY 24, 2017

DESIGN REVIEW SET

A3.4

MOSS BEACH - LOT 2

VALLEMAR ST. & JULIANNA AVE.

COASTSIDE DESIGN
REVIEW APPLICATIONDRAWING
SECTIONS


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DATE: JULY 24, 2017


DESIGN REVIEW SET

SHEET NO.

A4.1

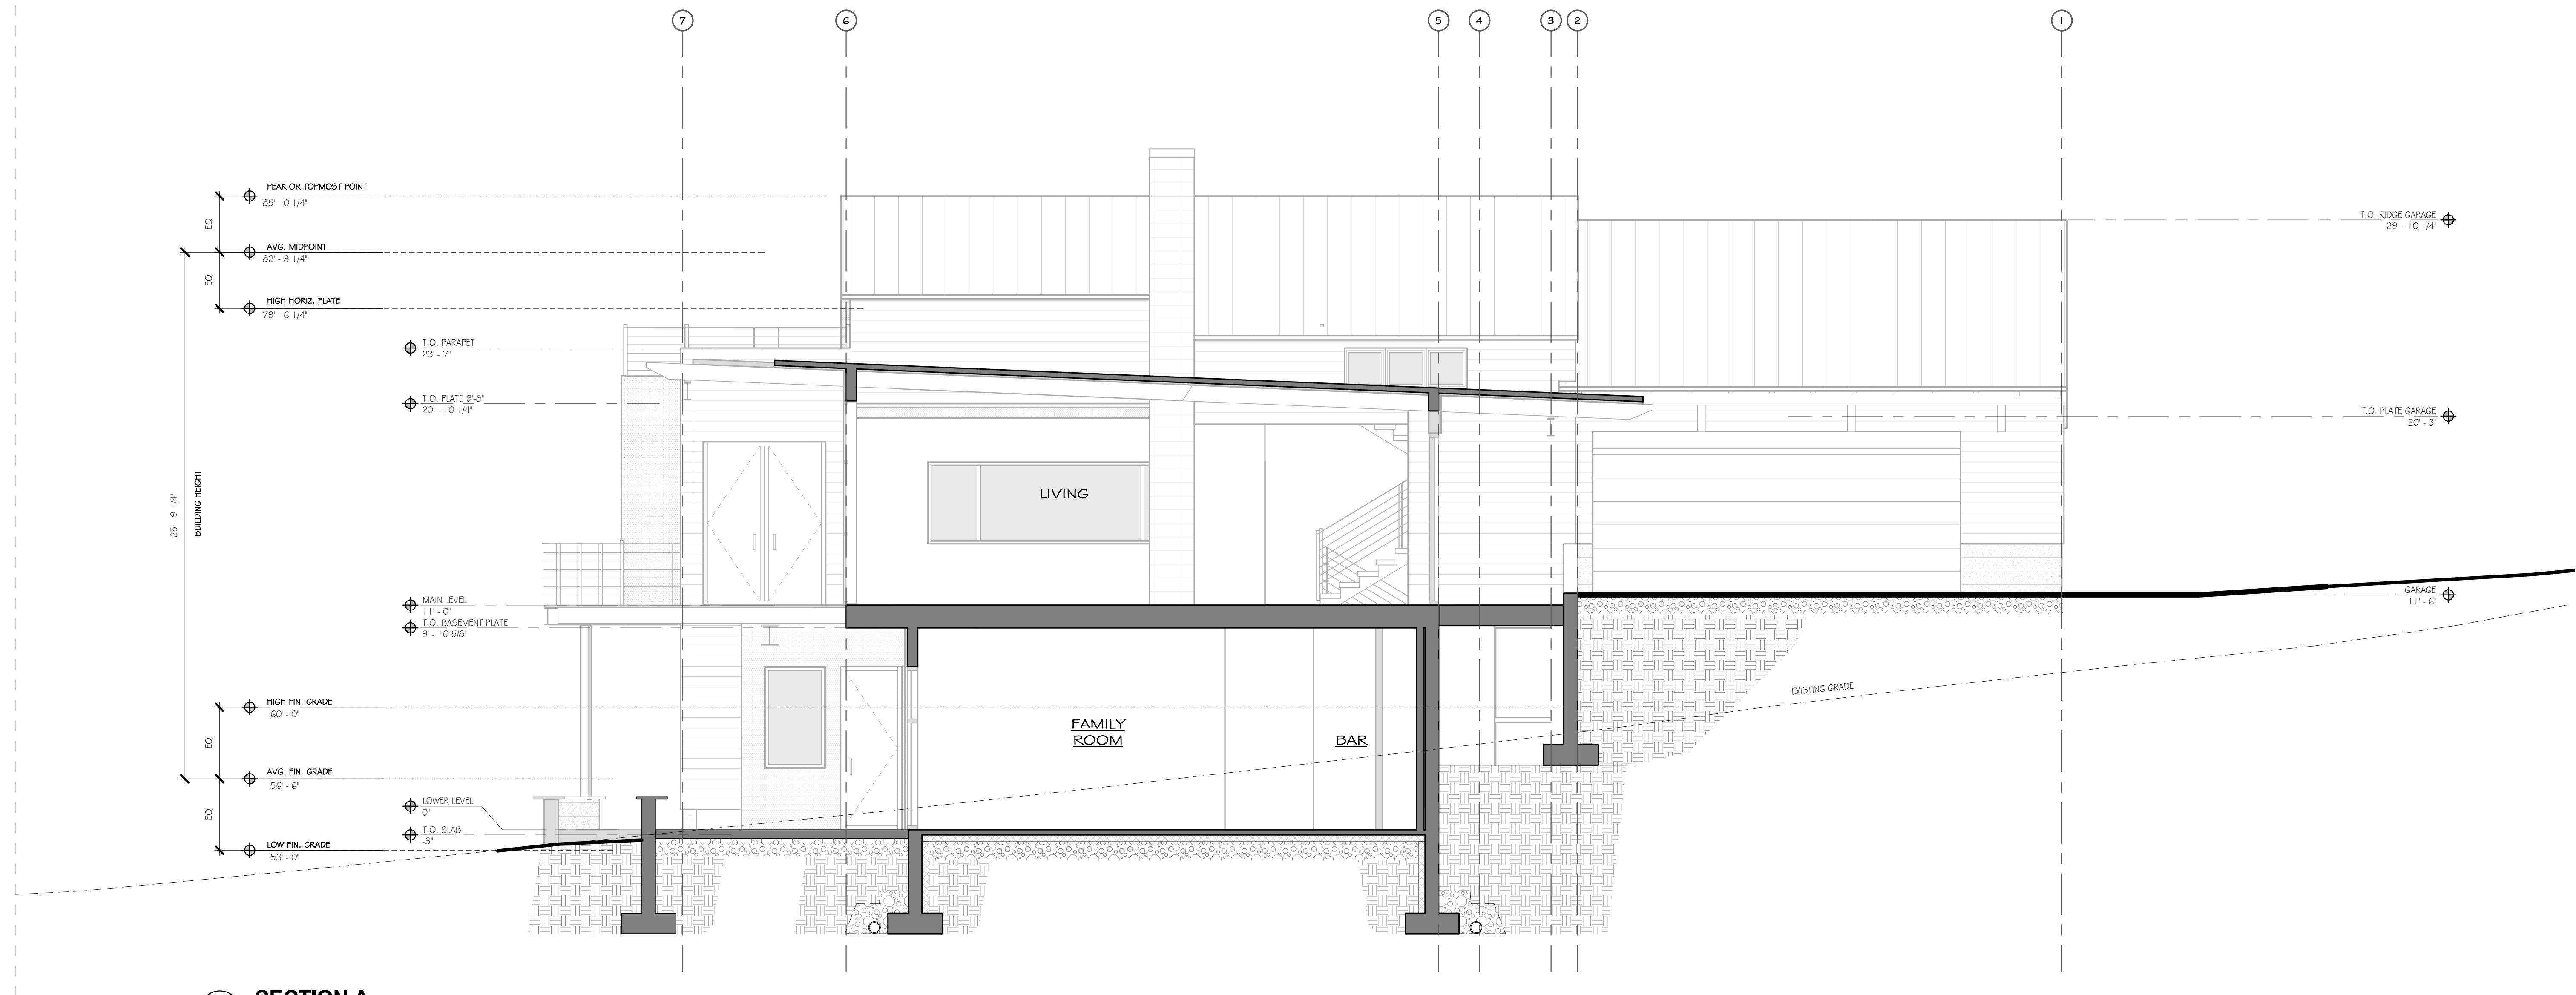

MAXIMUM BUILDING HEIGHT CALCULATIONS

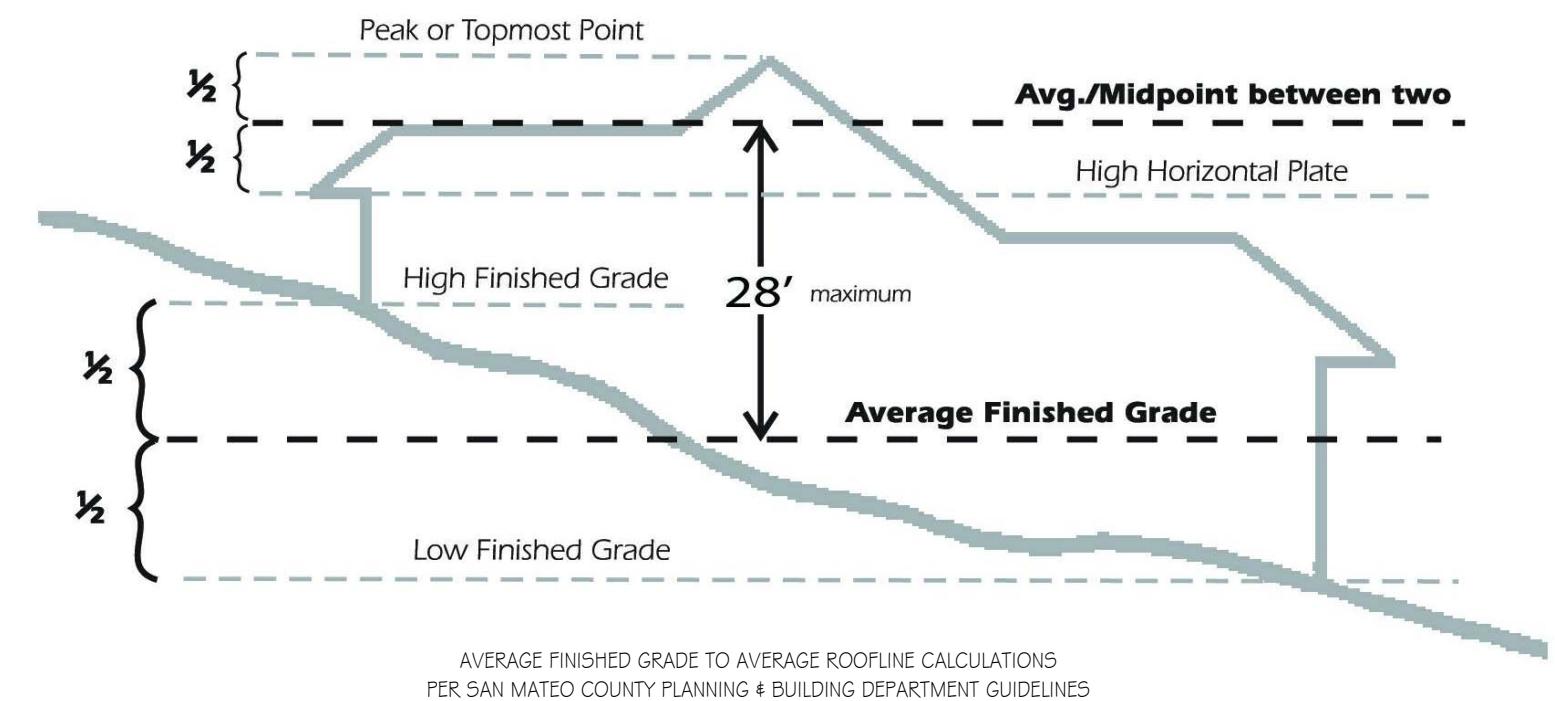

A4.1

MOSS BEACH - LOT 2

VALLEMAR ST. & JULIANNA AVE.


COASTSIDE DESIGN
REVIEW APPLICATION

REVISION NO.	DATE



DRAWING SECTIONS

PROJECT NUMBER: 1507
DATE: JULY 24, 2017
DESIGN REVIEW SET

A4.2

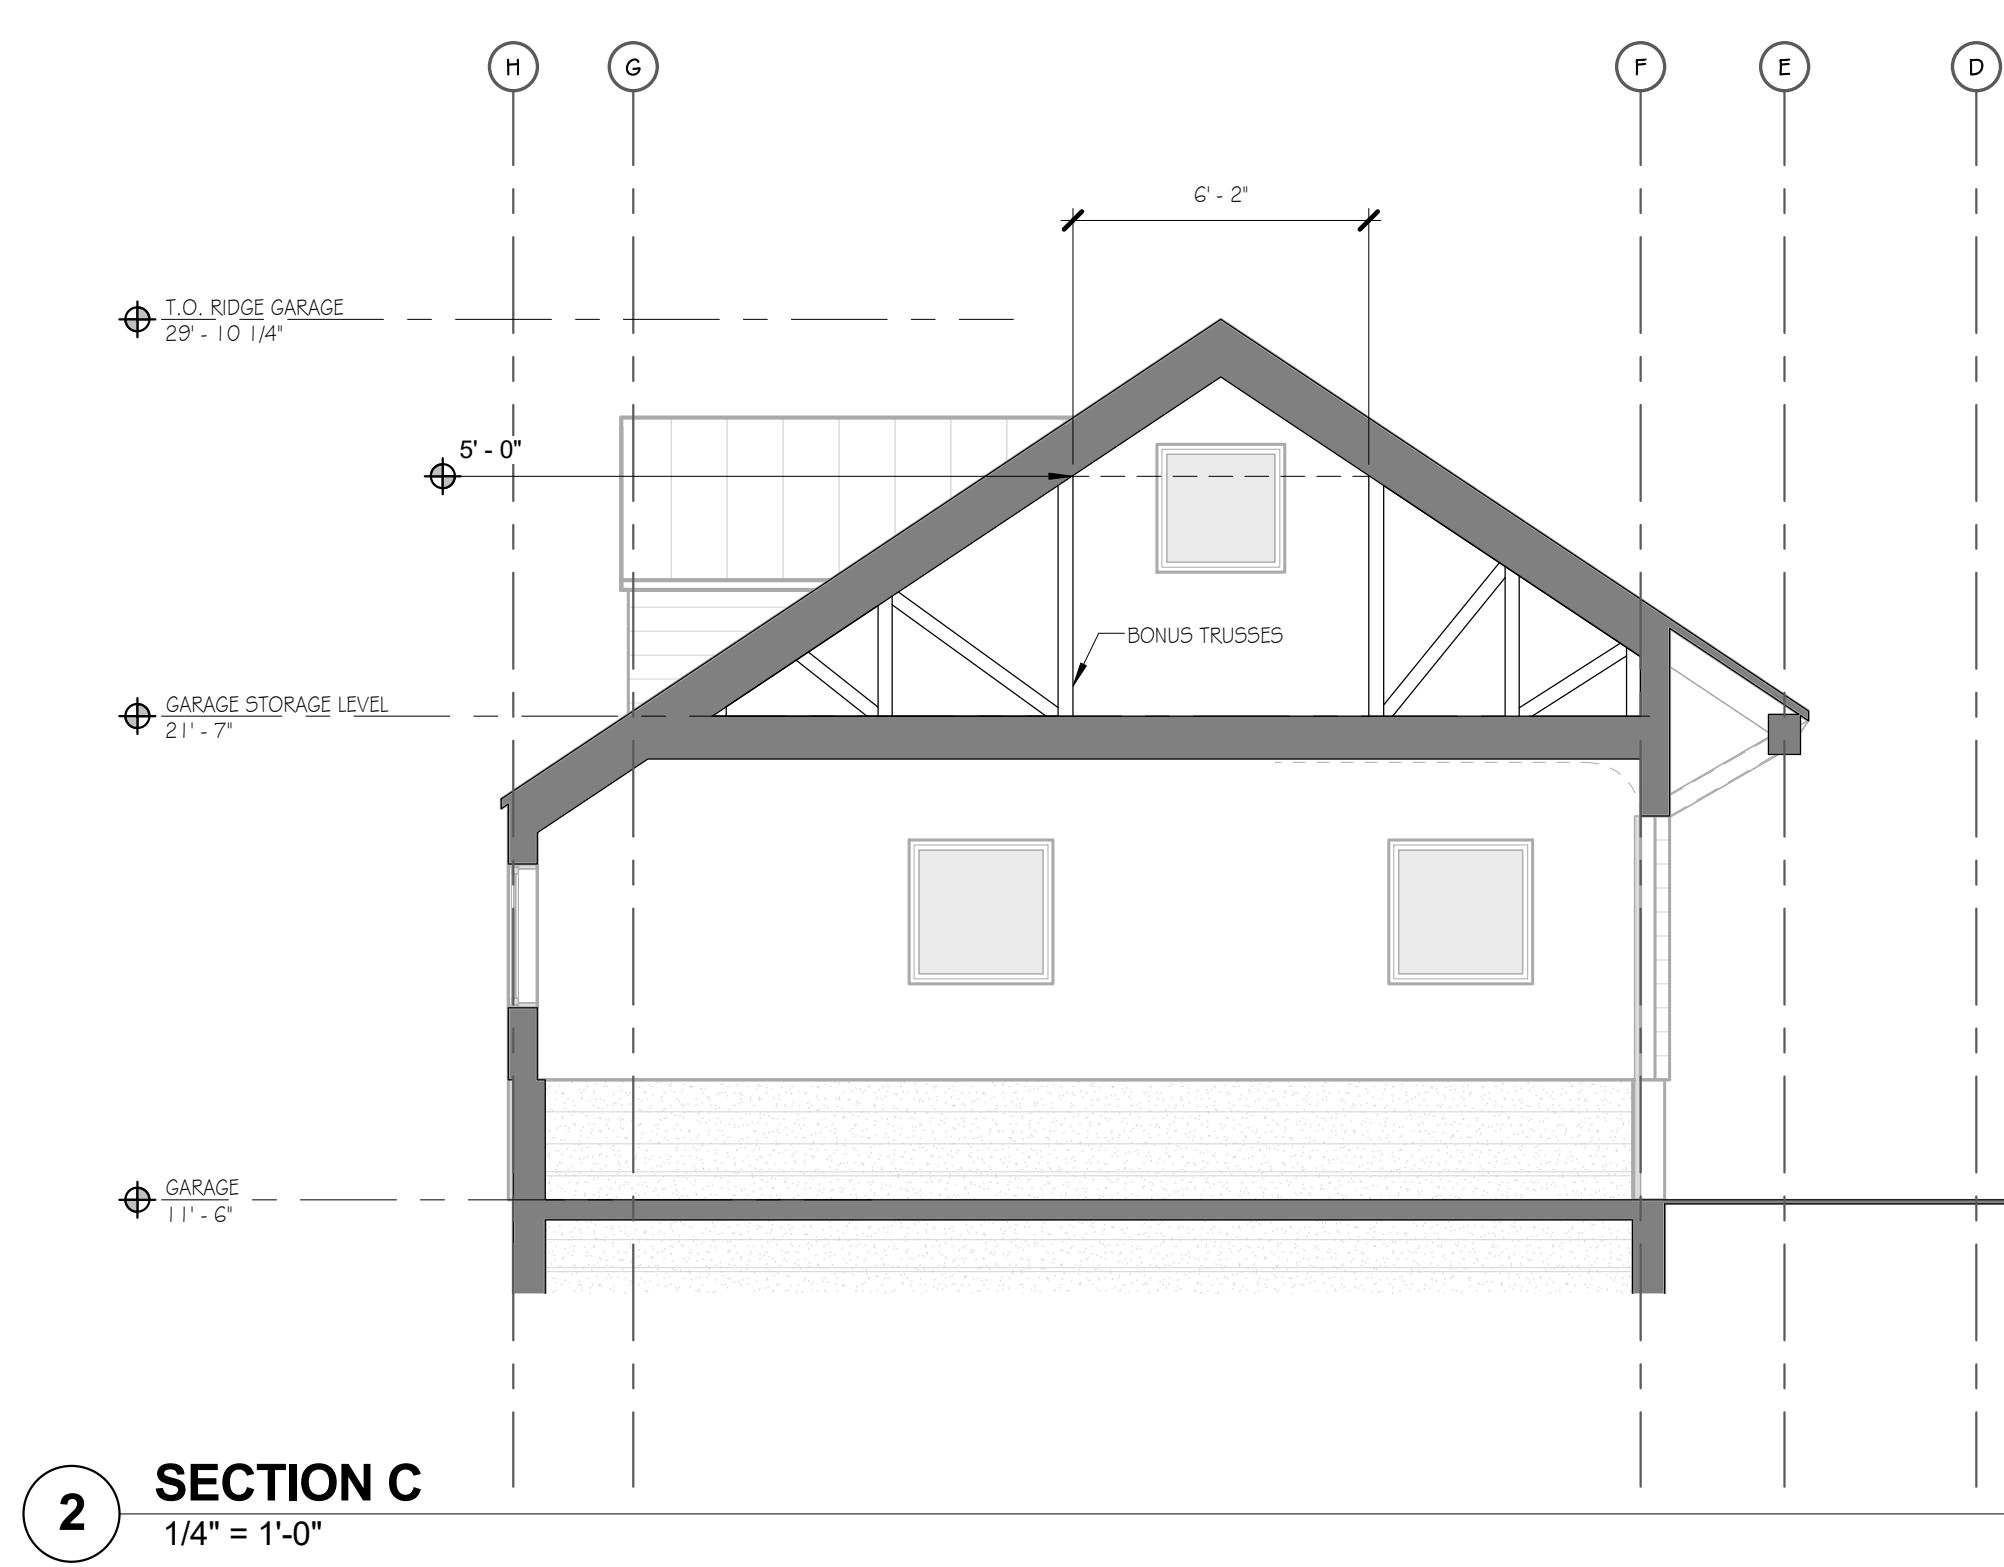


MAXIMUM BUILDING HEIGHT CALCULATIONS

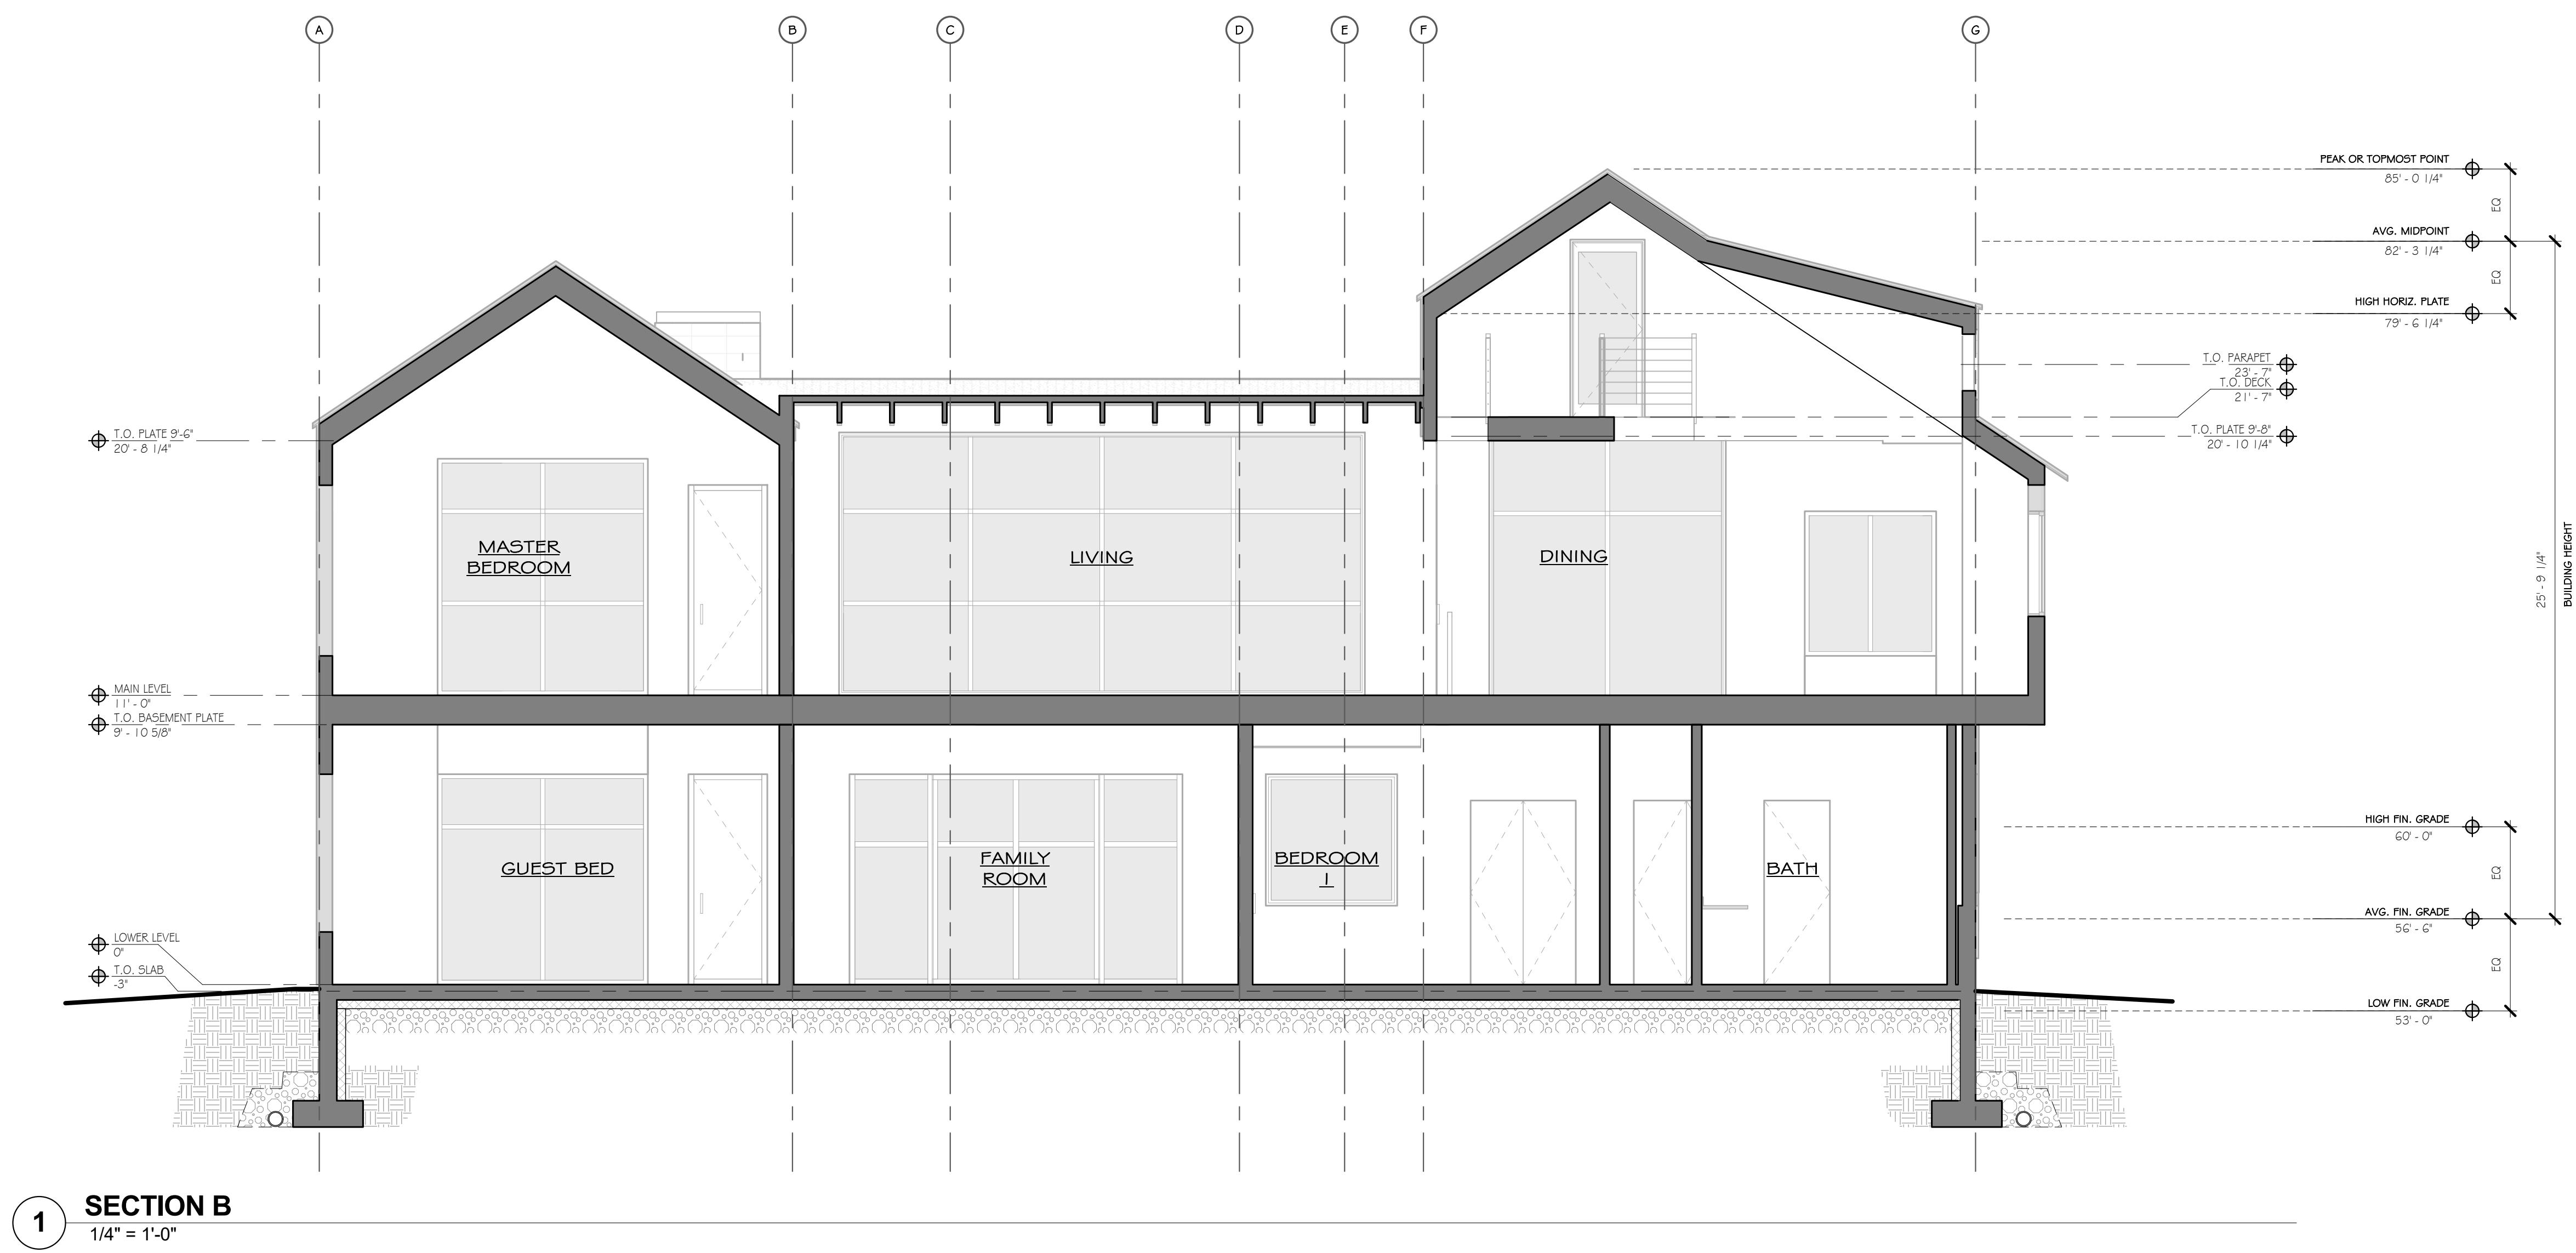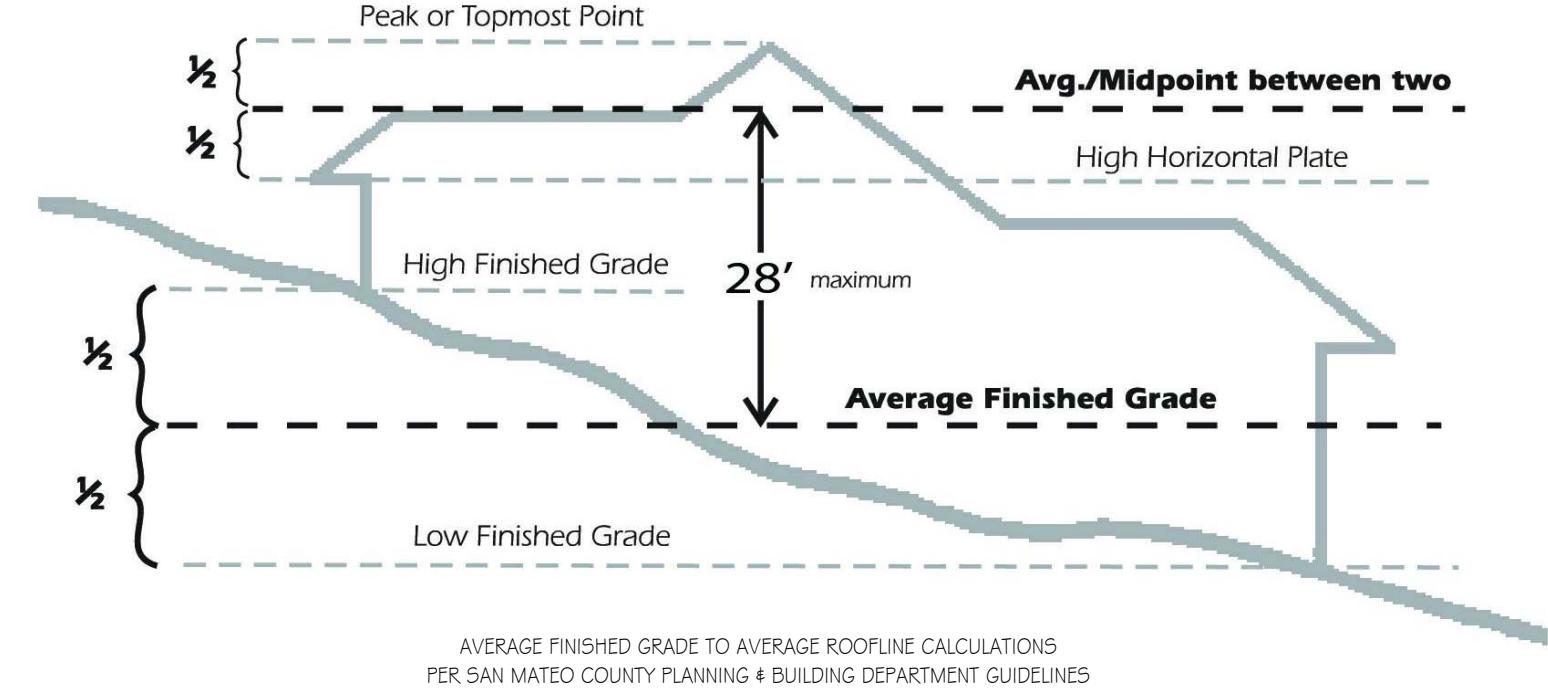

CABRILLO
HIGHWAY

VALLEMAR
STREET

JULIANA
AVENUE

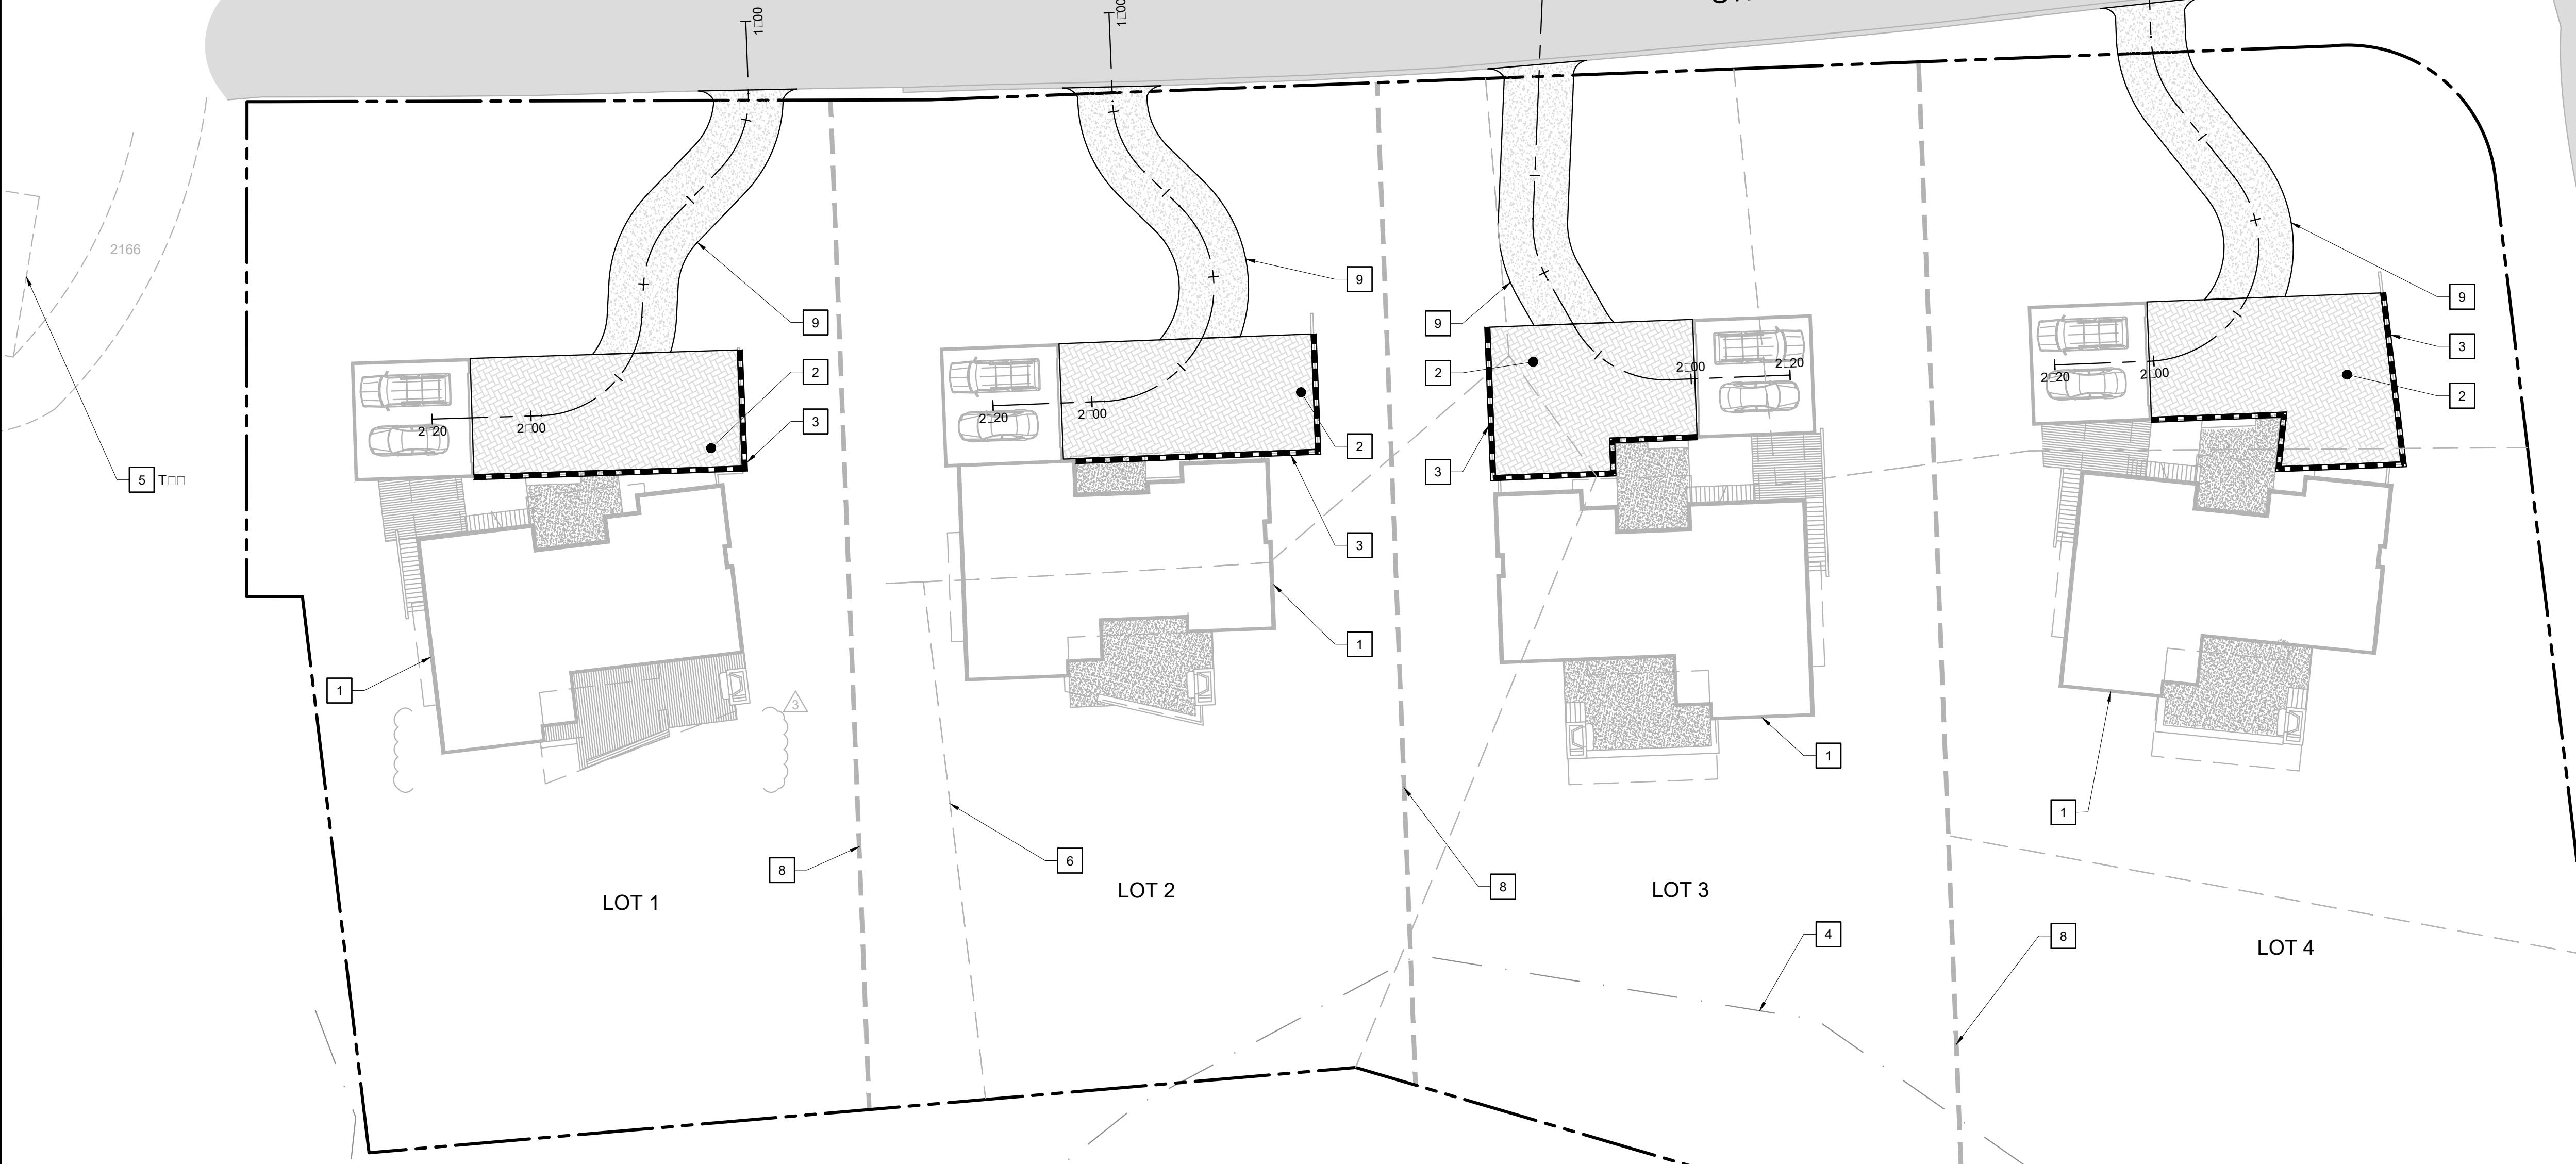

SHEET NOTES

- [1] HOUSE SEE ARCHITECTURAL PLANS
- [2] CONCRETE CURVING GAVERS SEE LANDSCAPE ARCHITECT PLANS
- [3] RETAINING WALLS SEE LANDSCAPE ARCHITECT PLANS
- [4] SEA LEVEL COASTAL SETBACK SEE COASTAL REPORT
- [5] APPROXIMATE LOCATION OF DESTINATION NEAR HOUSE AND DRIVE AS ESTIMATED FROM ELOCATION MAPS
- [6] EXISTING PROPERTY LINE TO COORDINATE SURVEY MAP
- [7] EXISTING EASEMENT SEE COORDINATE SURVEY MAP
- [8] PROPOSED PROPERTY LINE TO
- [9] CONCRETE DRIVE AIDS SEE LANDSCAPE ARCHITECT PLANS


CIVIL SHEET INDEX

- [1.0] SITE PLAN
- [2.0] RADIAL PLAN
- [3.0] UTILITIES DRAINAGE PLAN
- [4.0] DRIVEWAY LOCATIONS
- [5.0] SEWER PROFILE
- [6.0] EROSION CONTROL PLAN
- [7.0] CONSTRUCTION MTS
- [8.0] DETAILS

PACIFIC OCEAN

SITE PLAN

SCALE 1" = 20'

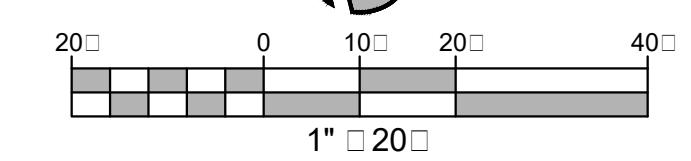

DESIGNATION	REV.	DATE
LANDFILL SUBMITTAL	R1	9/1/2015
DESIGN REVIEW SUBMITTAL	R1	8/9/2016
OUR LOT PLANNING SUBMITTAL	R1	4/26/2017
LOT 1 REVISIONS	R1	8/23/2017

Mesiti-Miller Engineering, Inc.
CIVIL AND STRUCTURAL DESIGN
831.426.1886 Santa Cruz www.m-m-e.com

SITE PLAN


DRAWDN ALCDAM


CLOSED RT






JO NUMBER 15147

SHEET

1.0

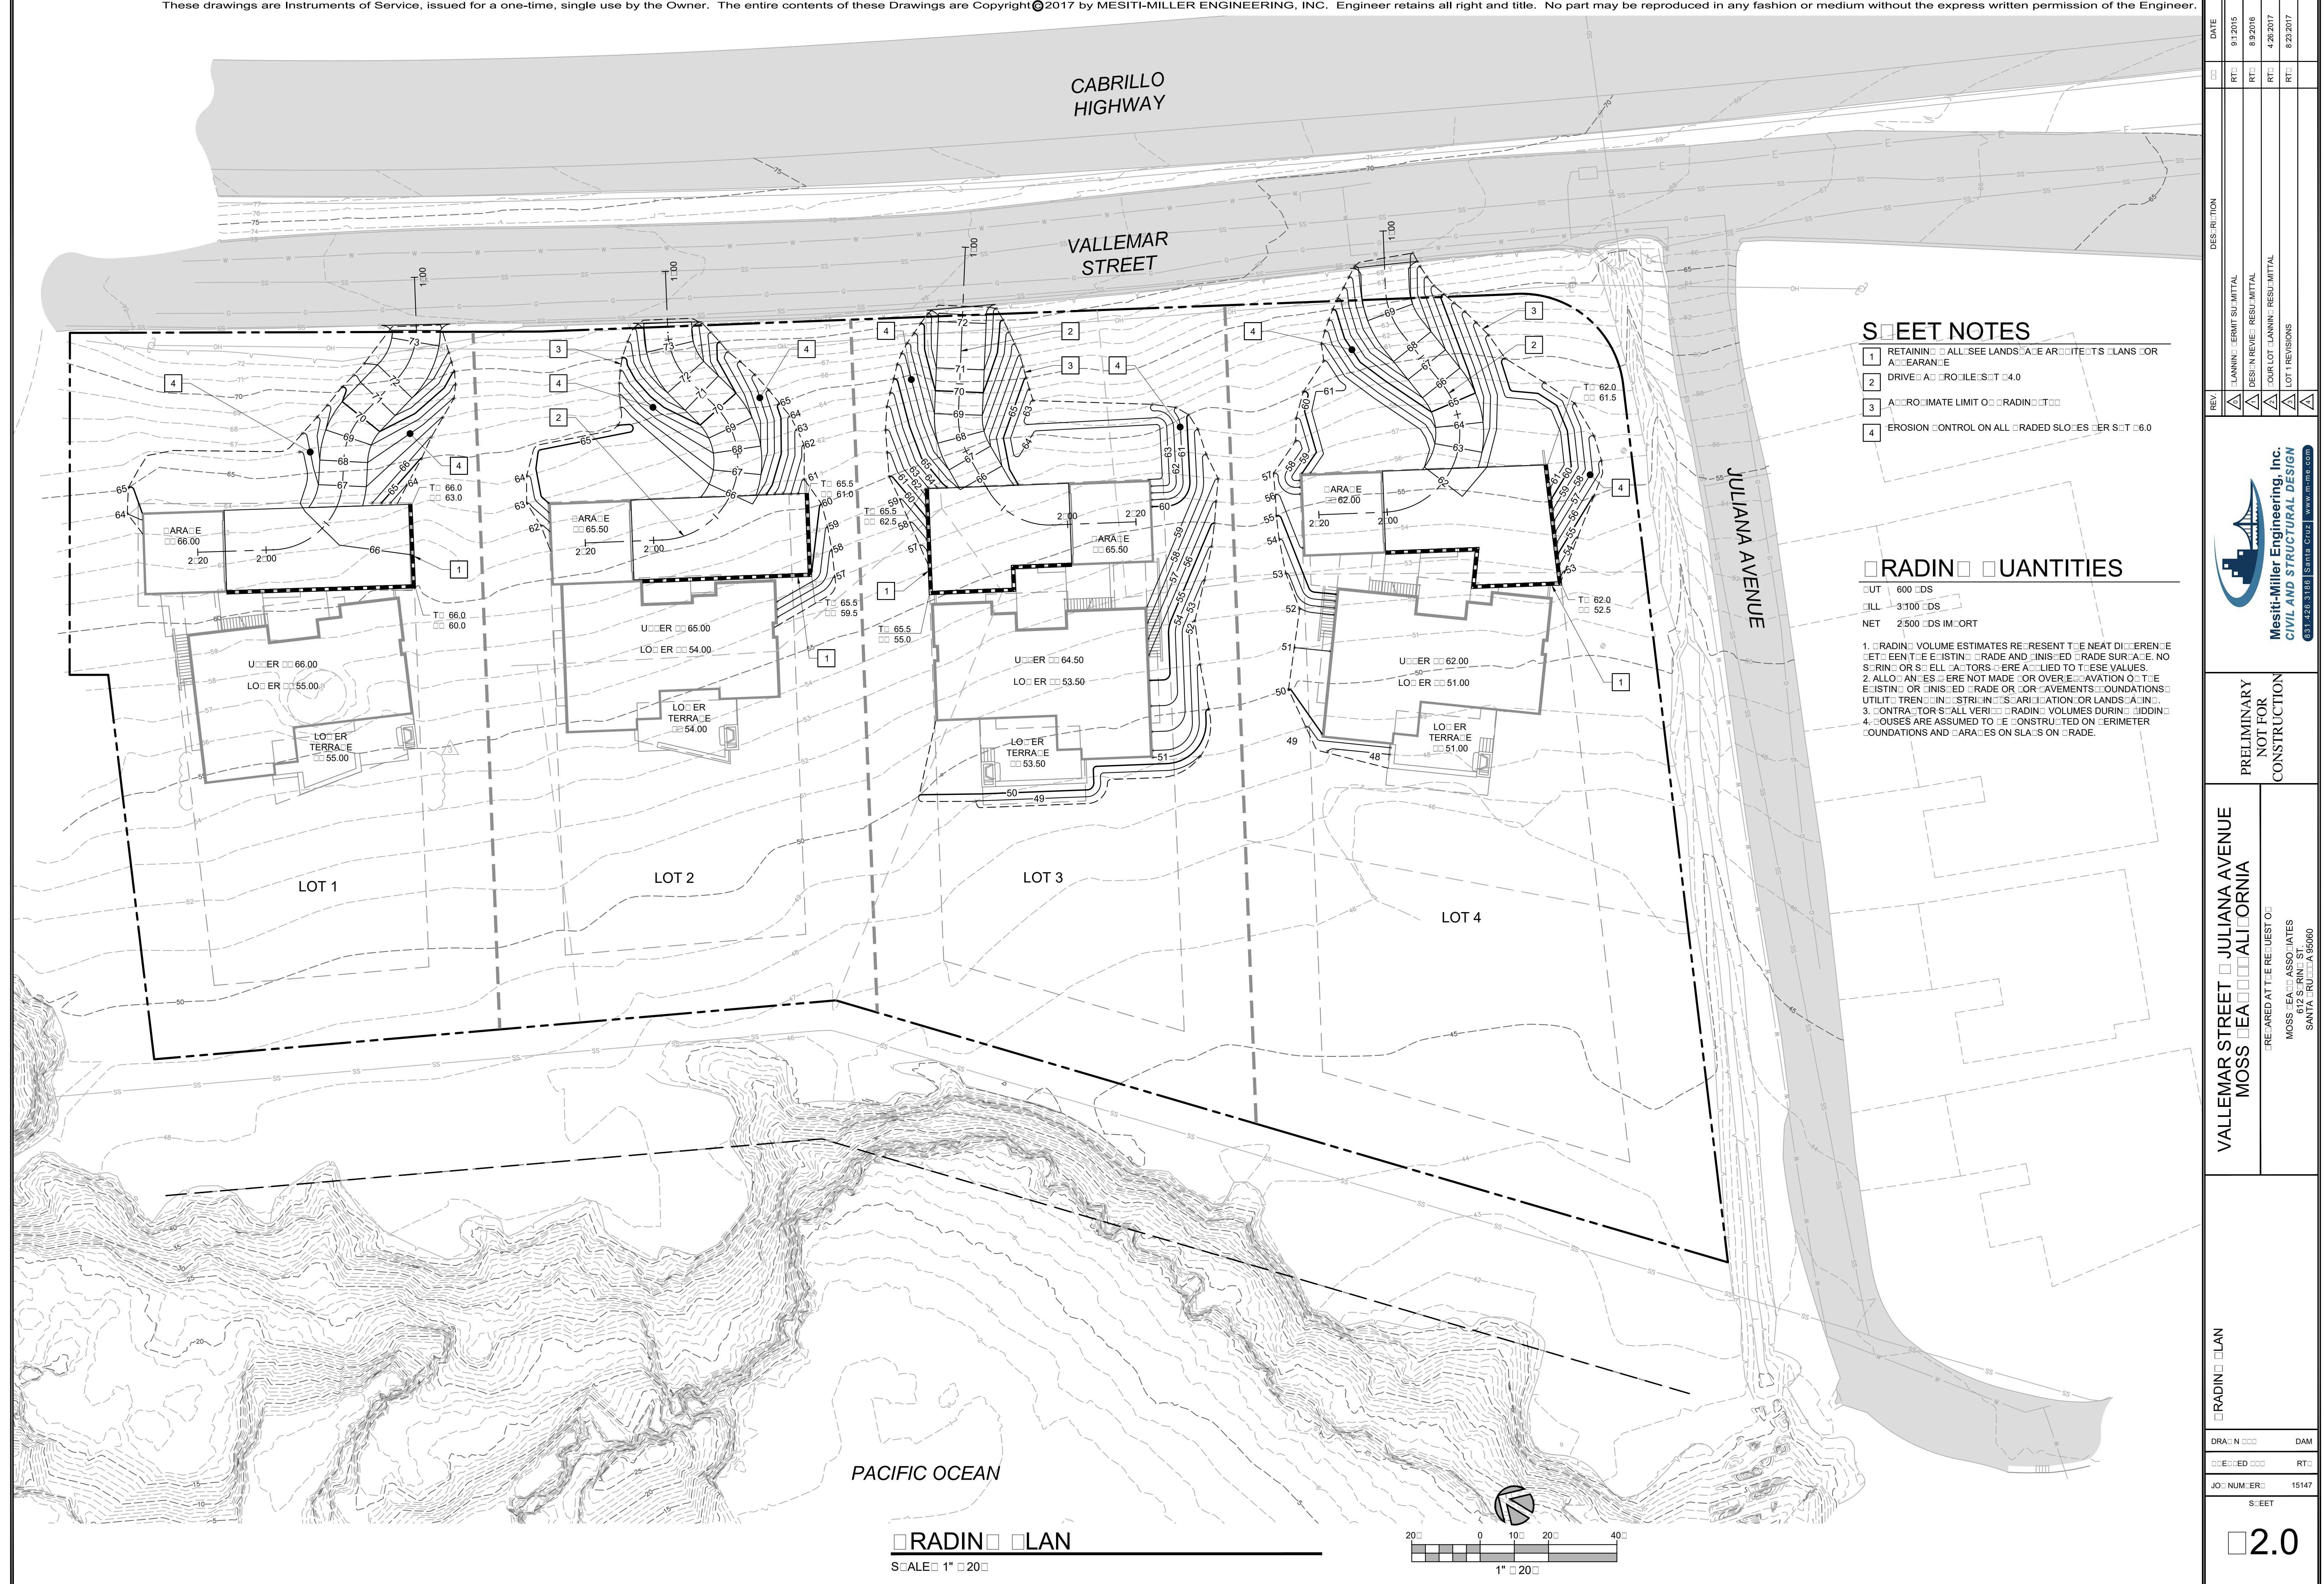

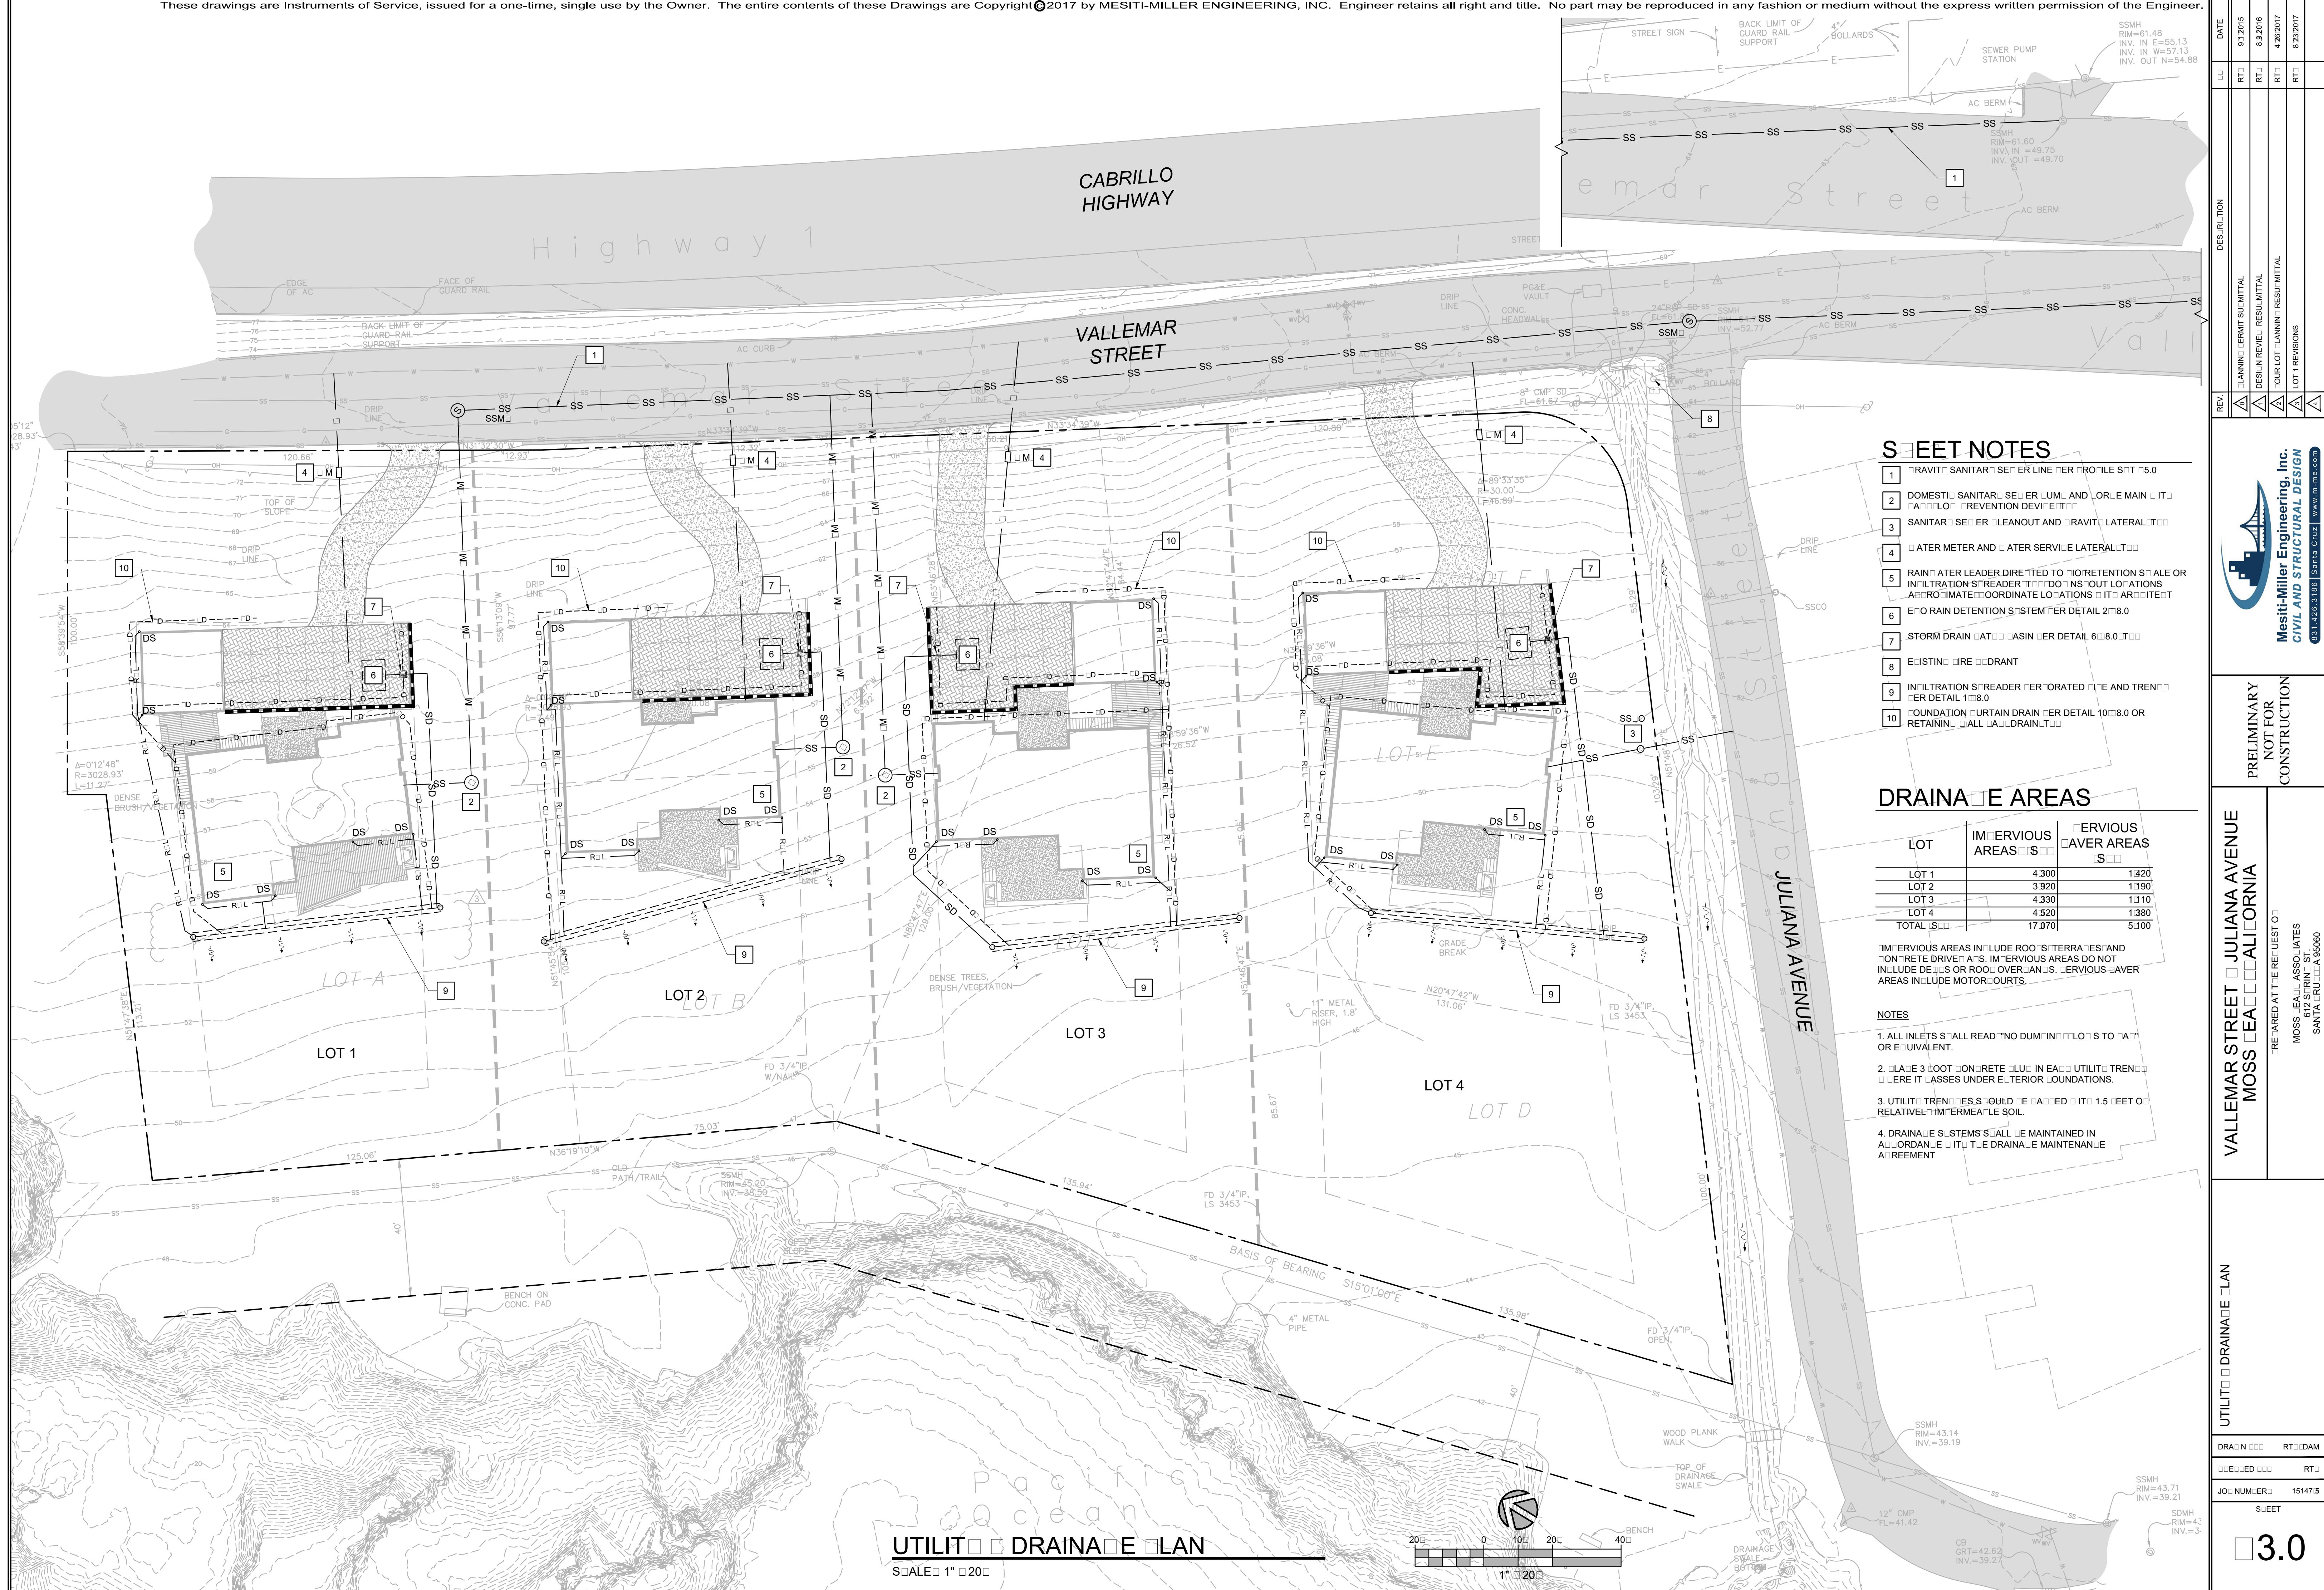

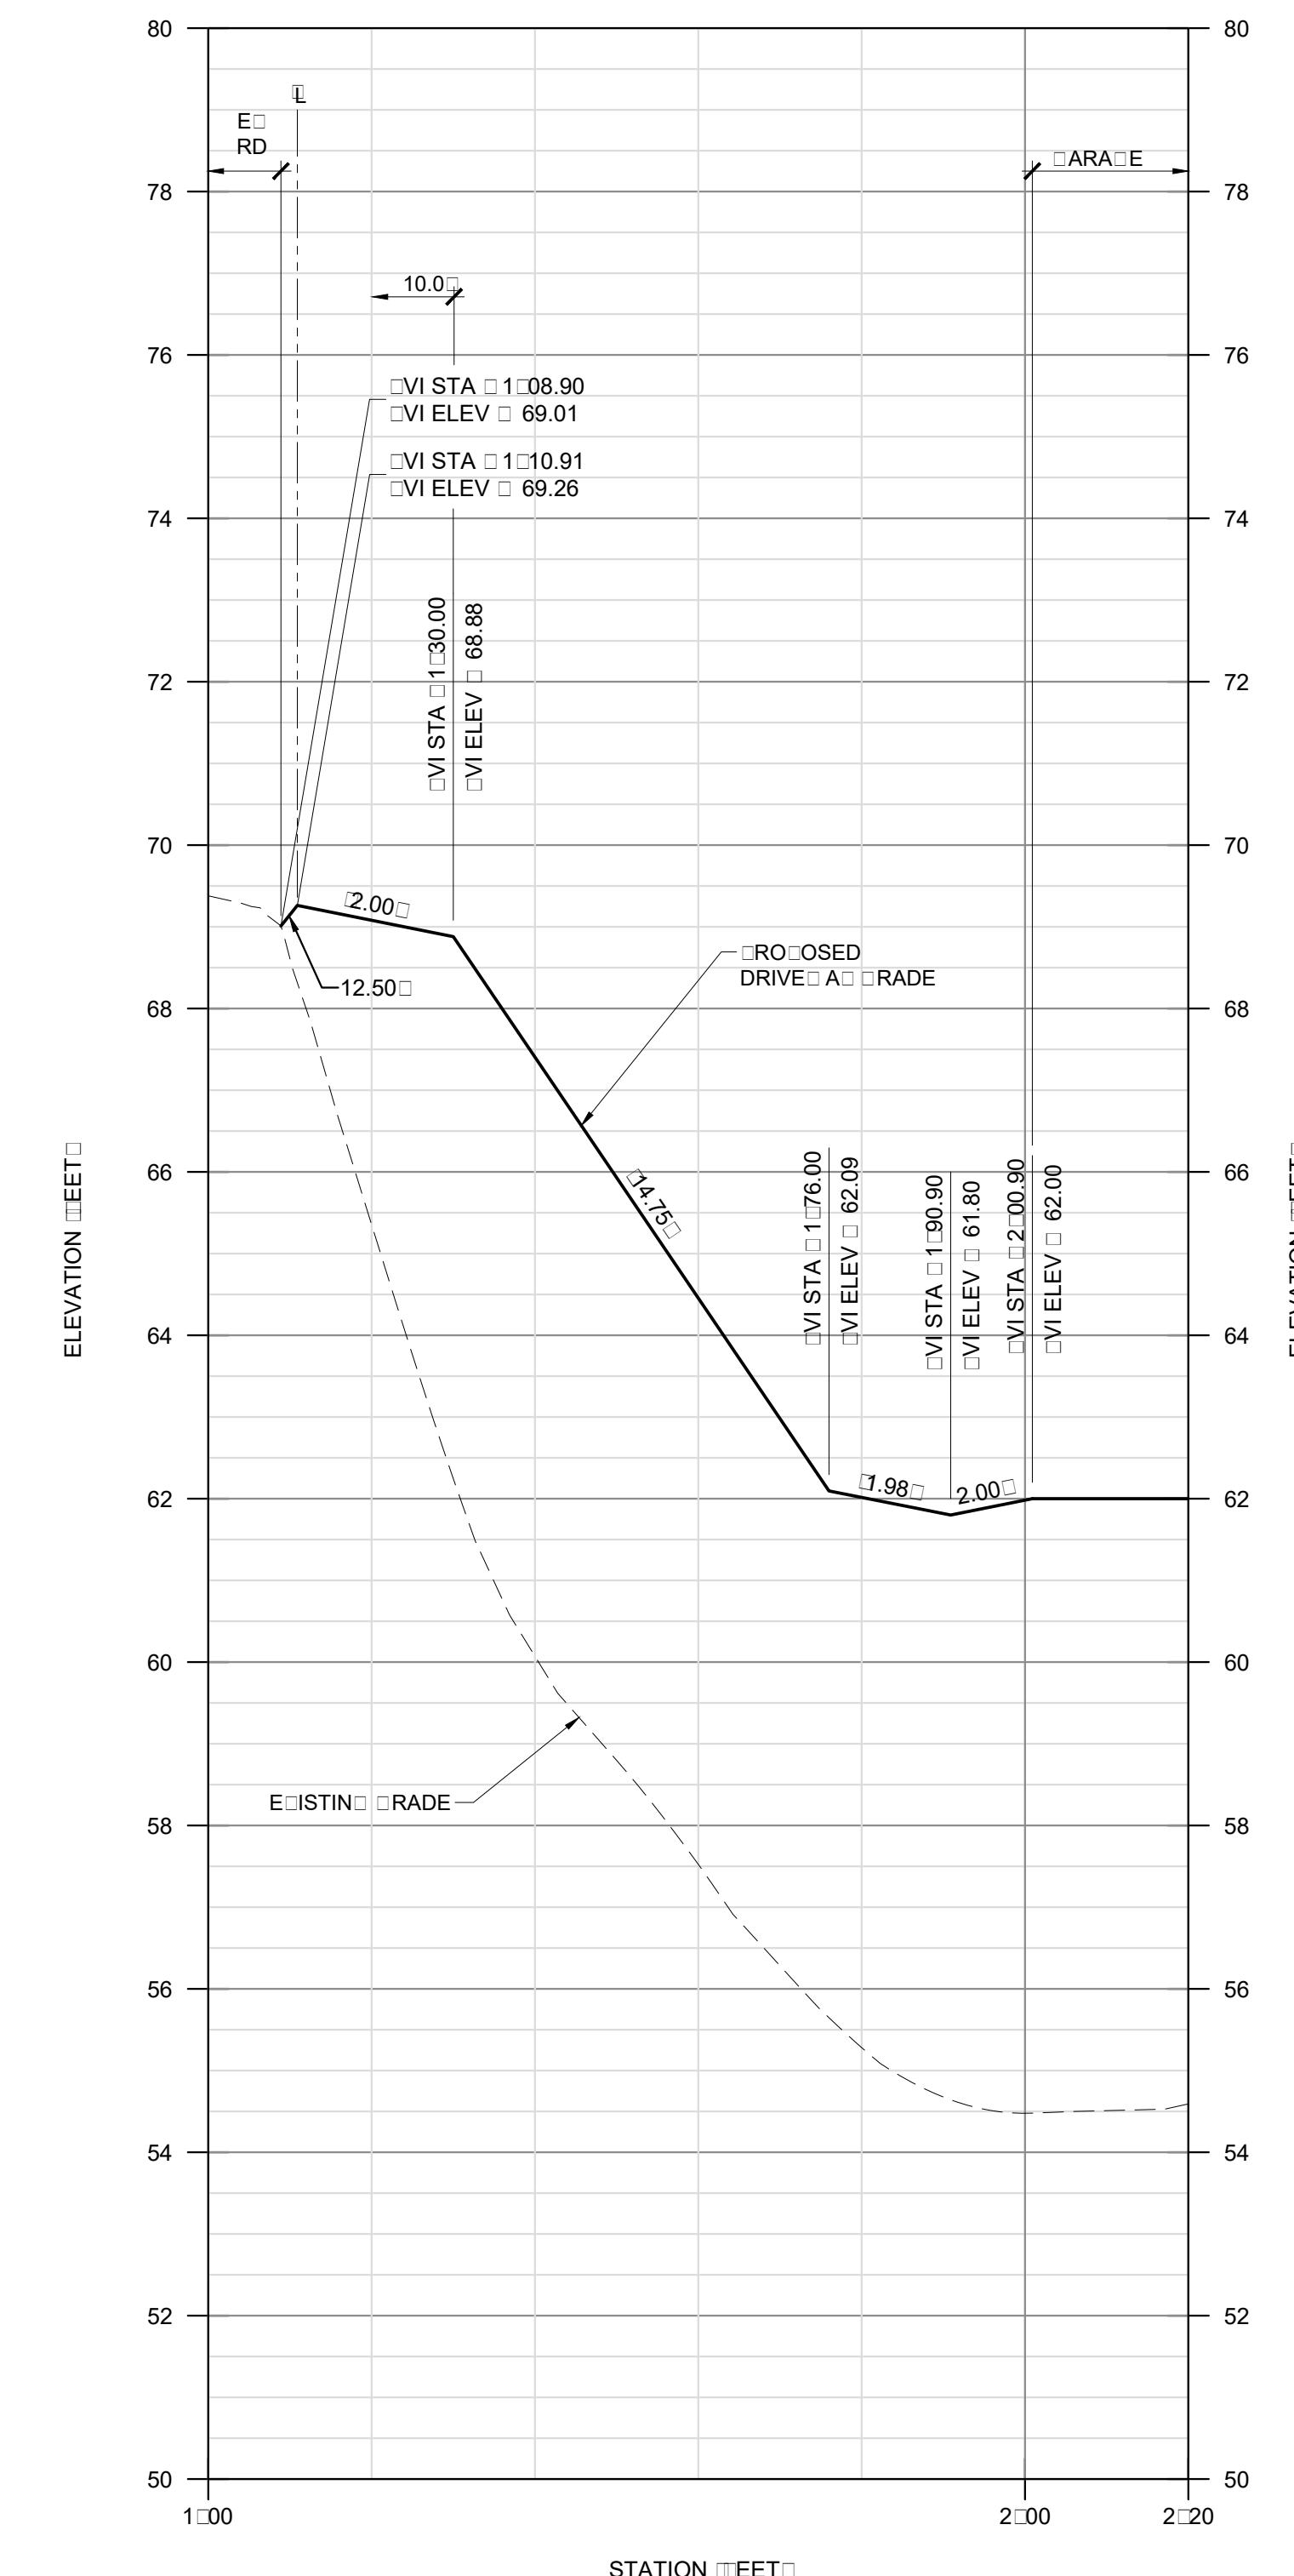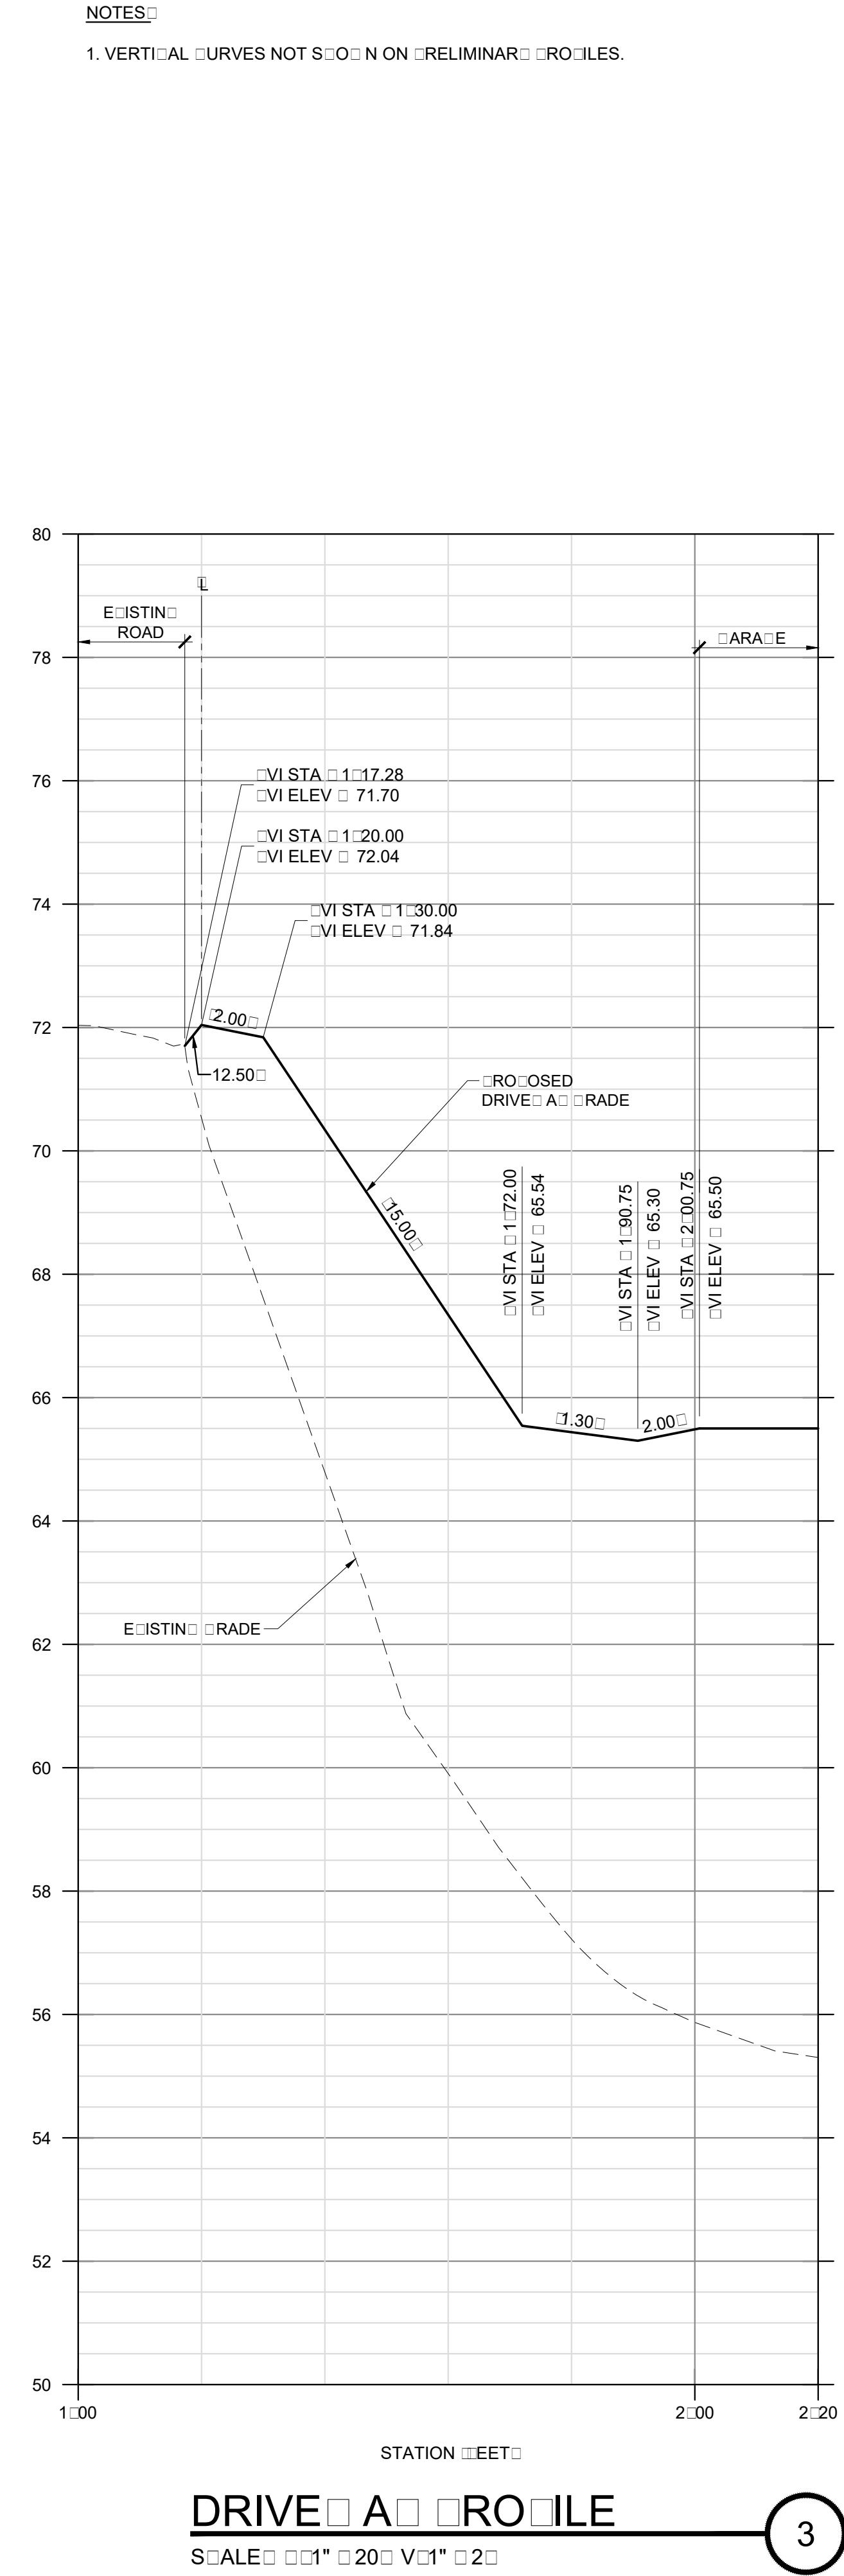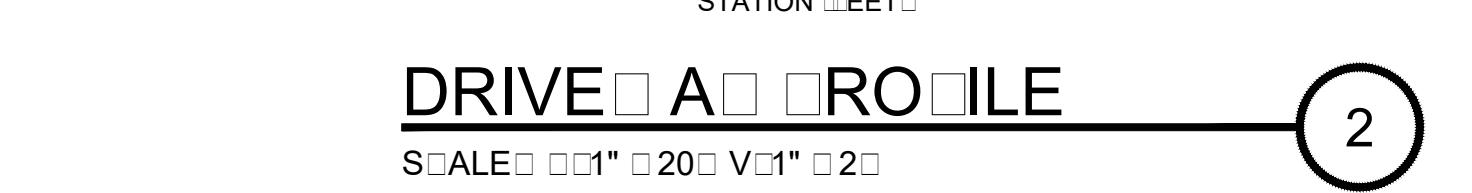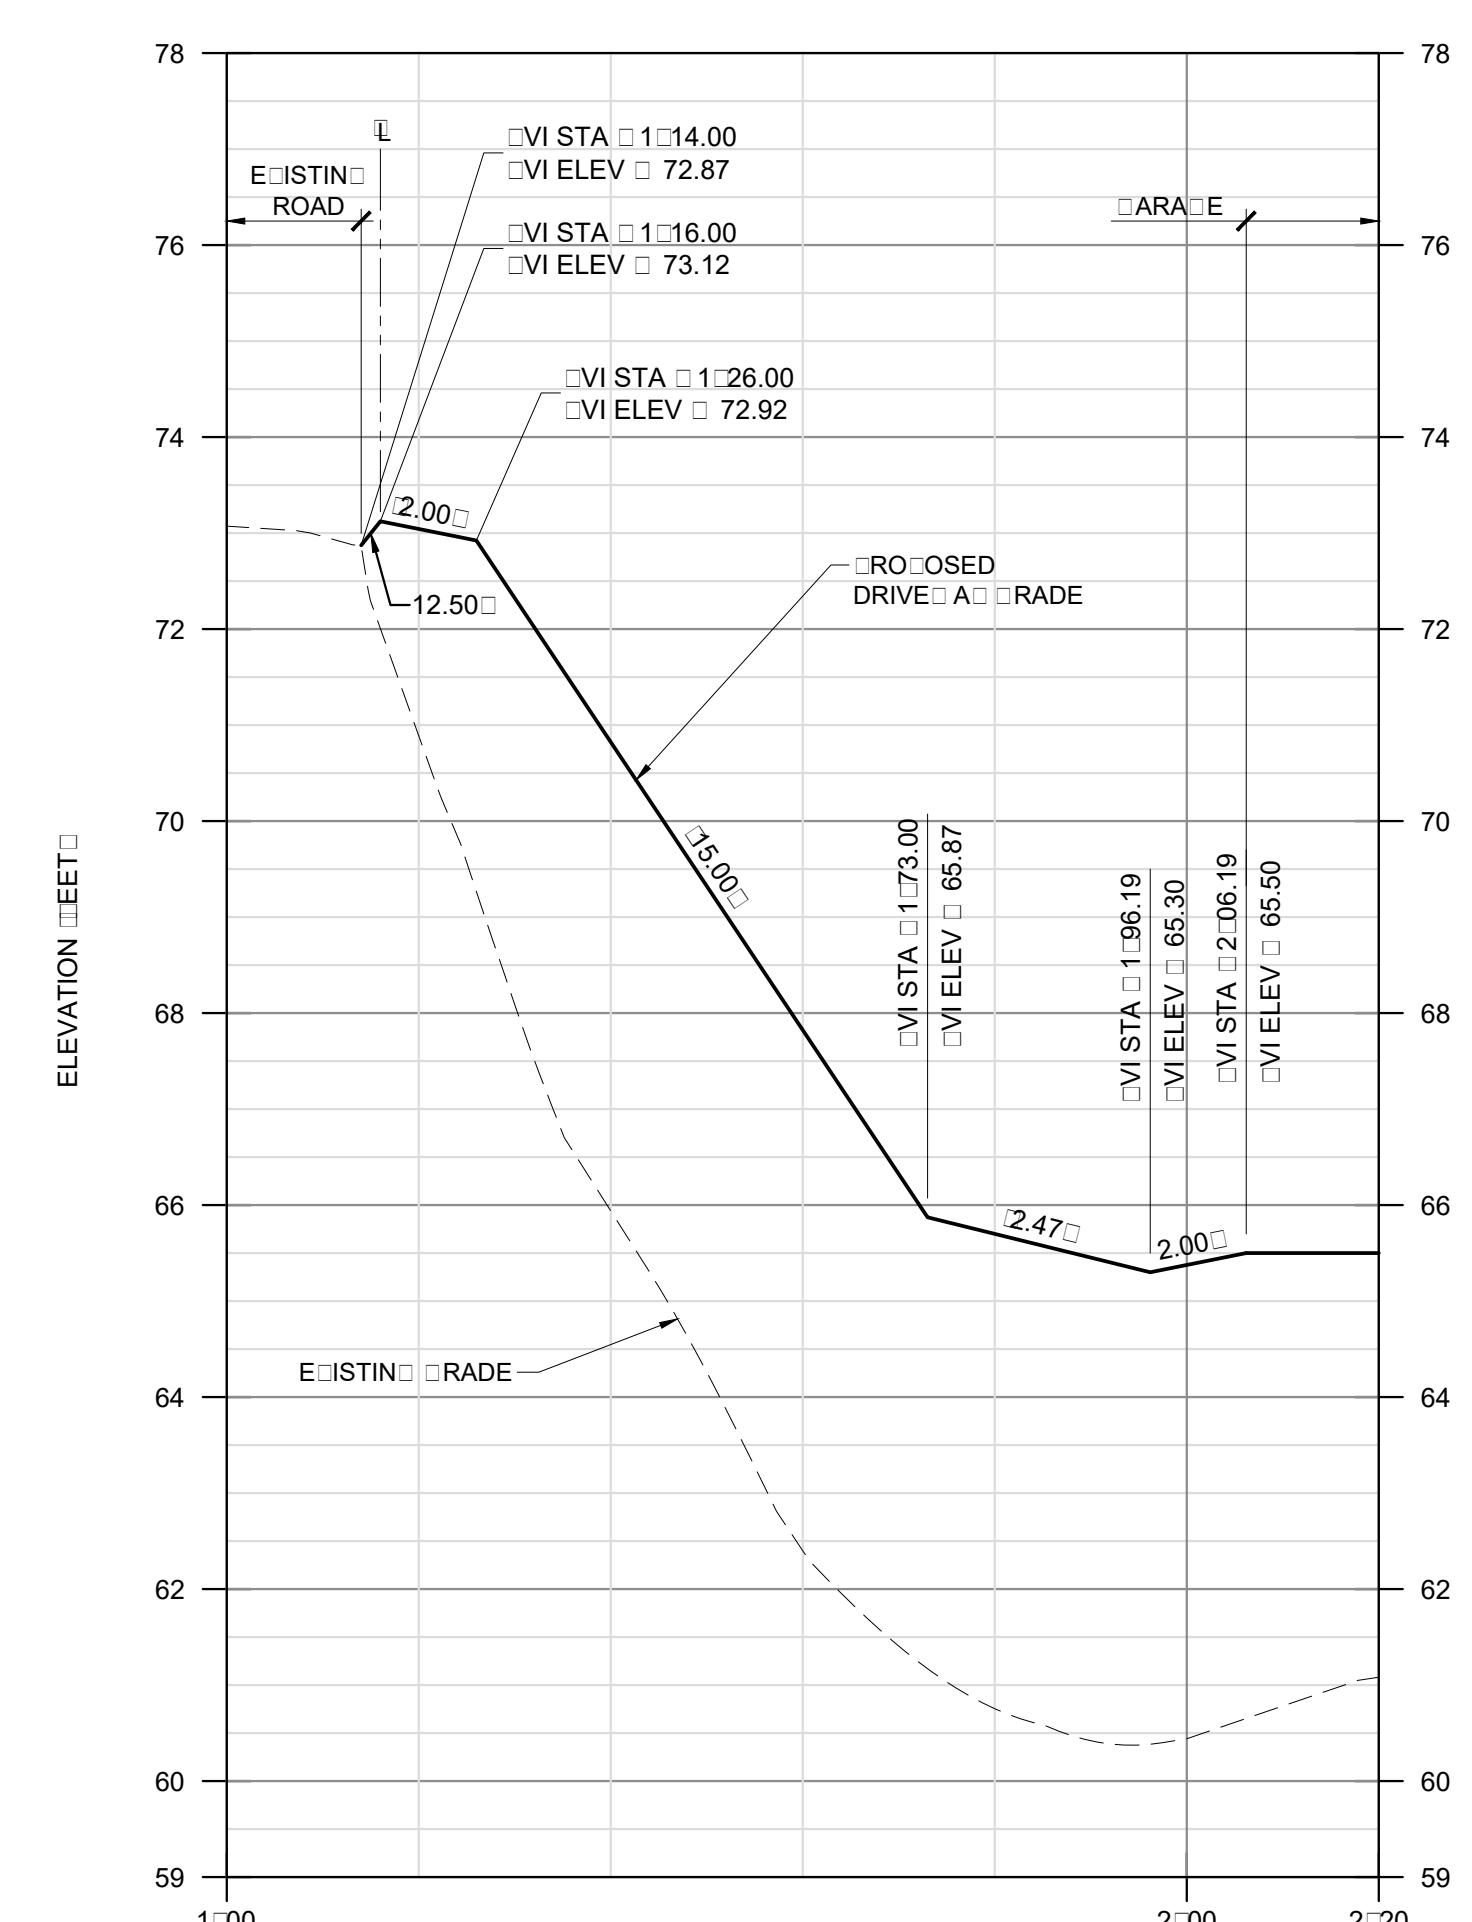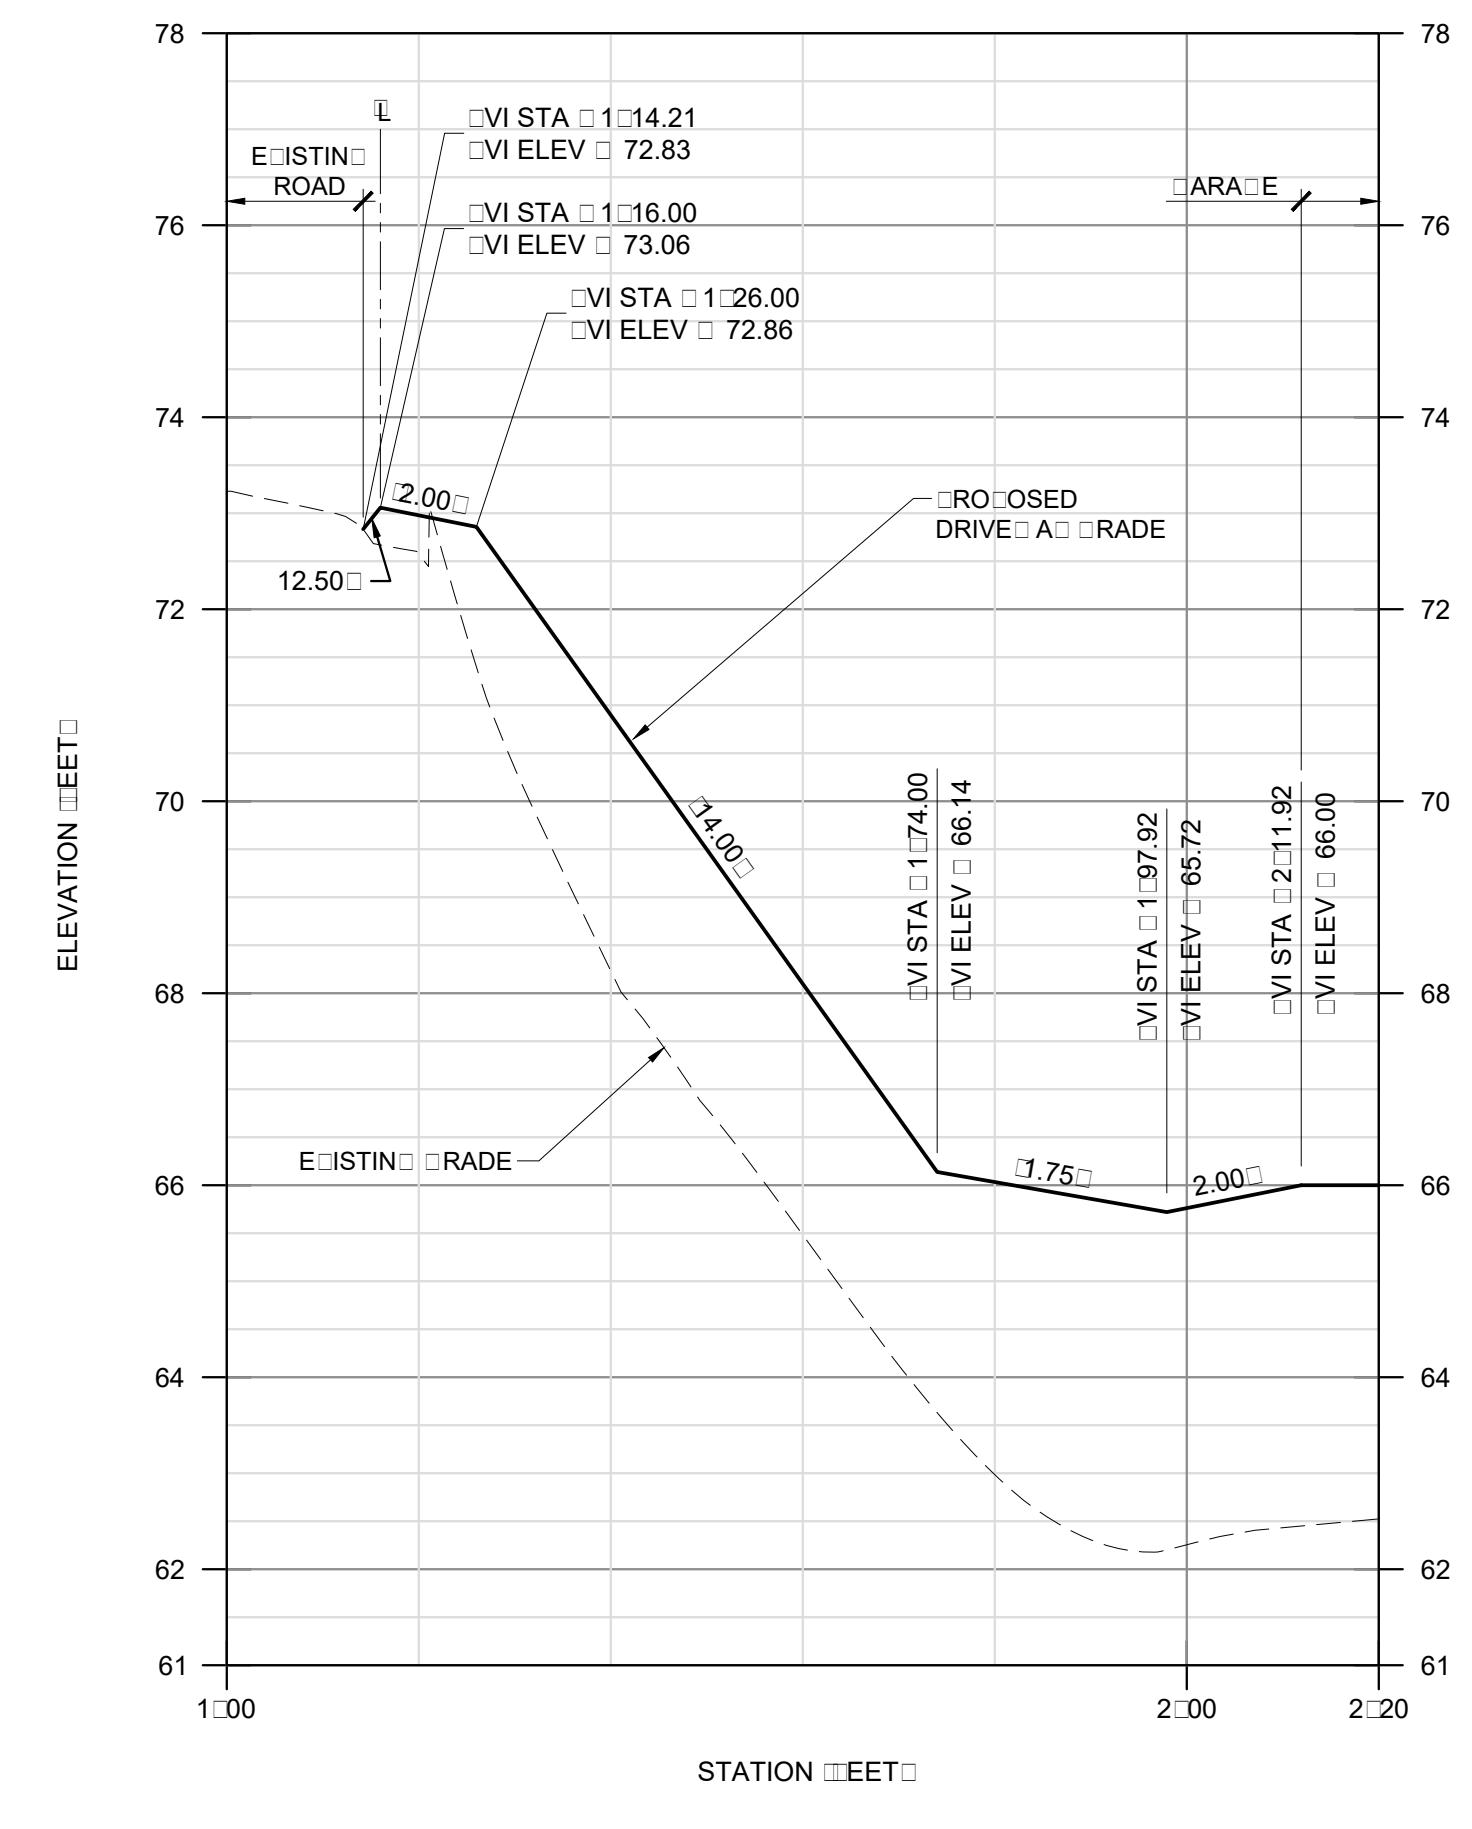


DRIVE A PROFILES	VALLEMAR STREET JULIANA AVENUE MOSS EA CALIFORNIA	PRELIMINARY NOT FOR CONSTRUCTION	REV. LANNIN - ERIN SU-MITTAL DES IN REVIE RESUMMITAL OUR LOT LANNIN RESUMMITAL LOT 1 REVISIONS	DATE 9/20/15 8/20/16 4/26/2017 8/23/2017
DRIVE A PROFILES	VALLEMAR STREET JULIANA AVENUE MOSS EA CALIFORNIA	PRELIMINARY NOT FOR CONSTRUCTION	REV. LANNIN - ERIN SU-MITTAL DES IN REVIE RESUMMITAL OUR LOT LANNIN RESUMMITAL LOT 1 REVISIONS	DATE 9/20/15 8/20/16 4/26/2017 8/23/2017

DRIVE A PROFILES

DRAINED DAM
CLOSED RT
JOB NUMBER 15147
SHEET 4.0

Mesiti-Miller Engineering, Inc.
CIVIL AND STRUCTURAL DESIGN
831.426.1886 Santa Cruz www.m-m-e.com

PREPARED AT THE REQUEST OF
MOSS EA ASSOCIATES
613 S. RINCON ST.
SANTA CRUZ, CA 95060

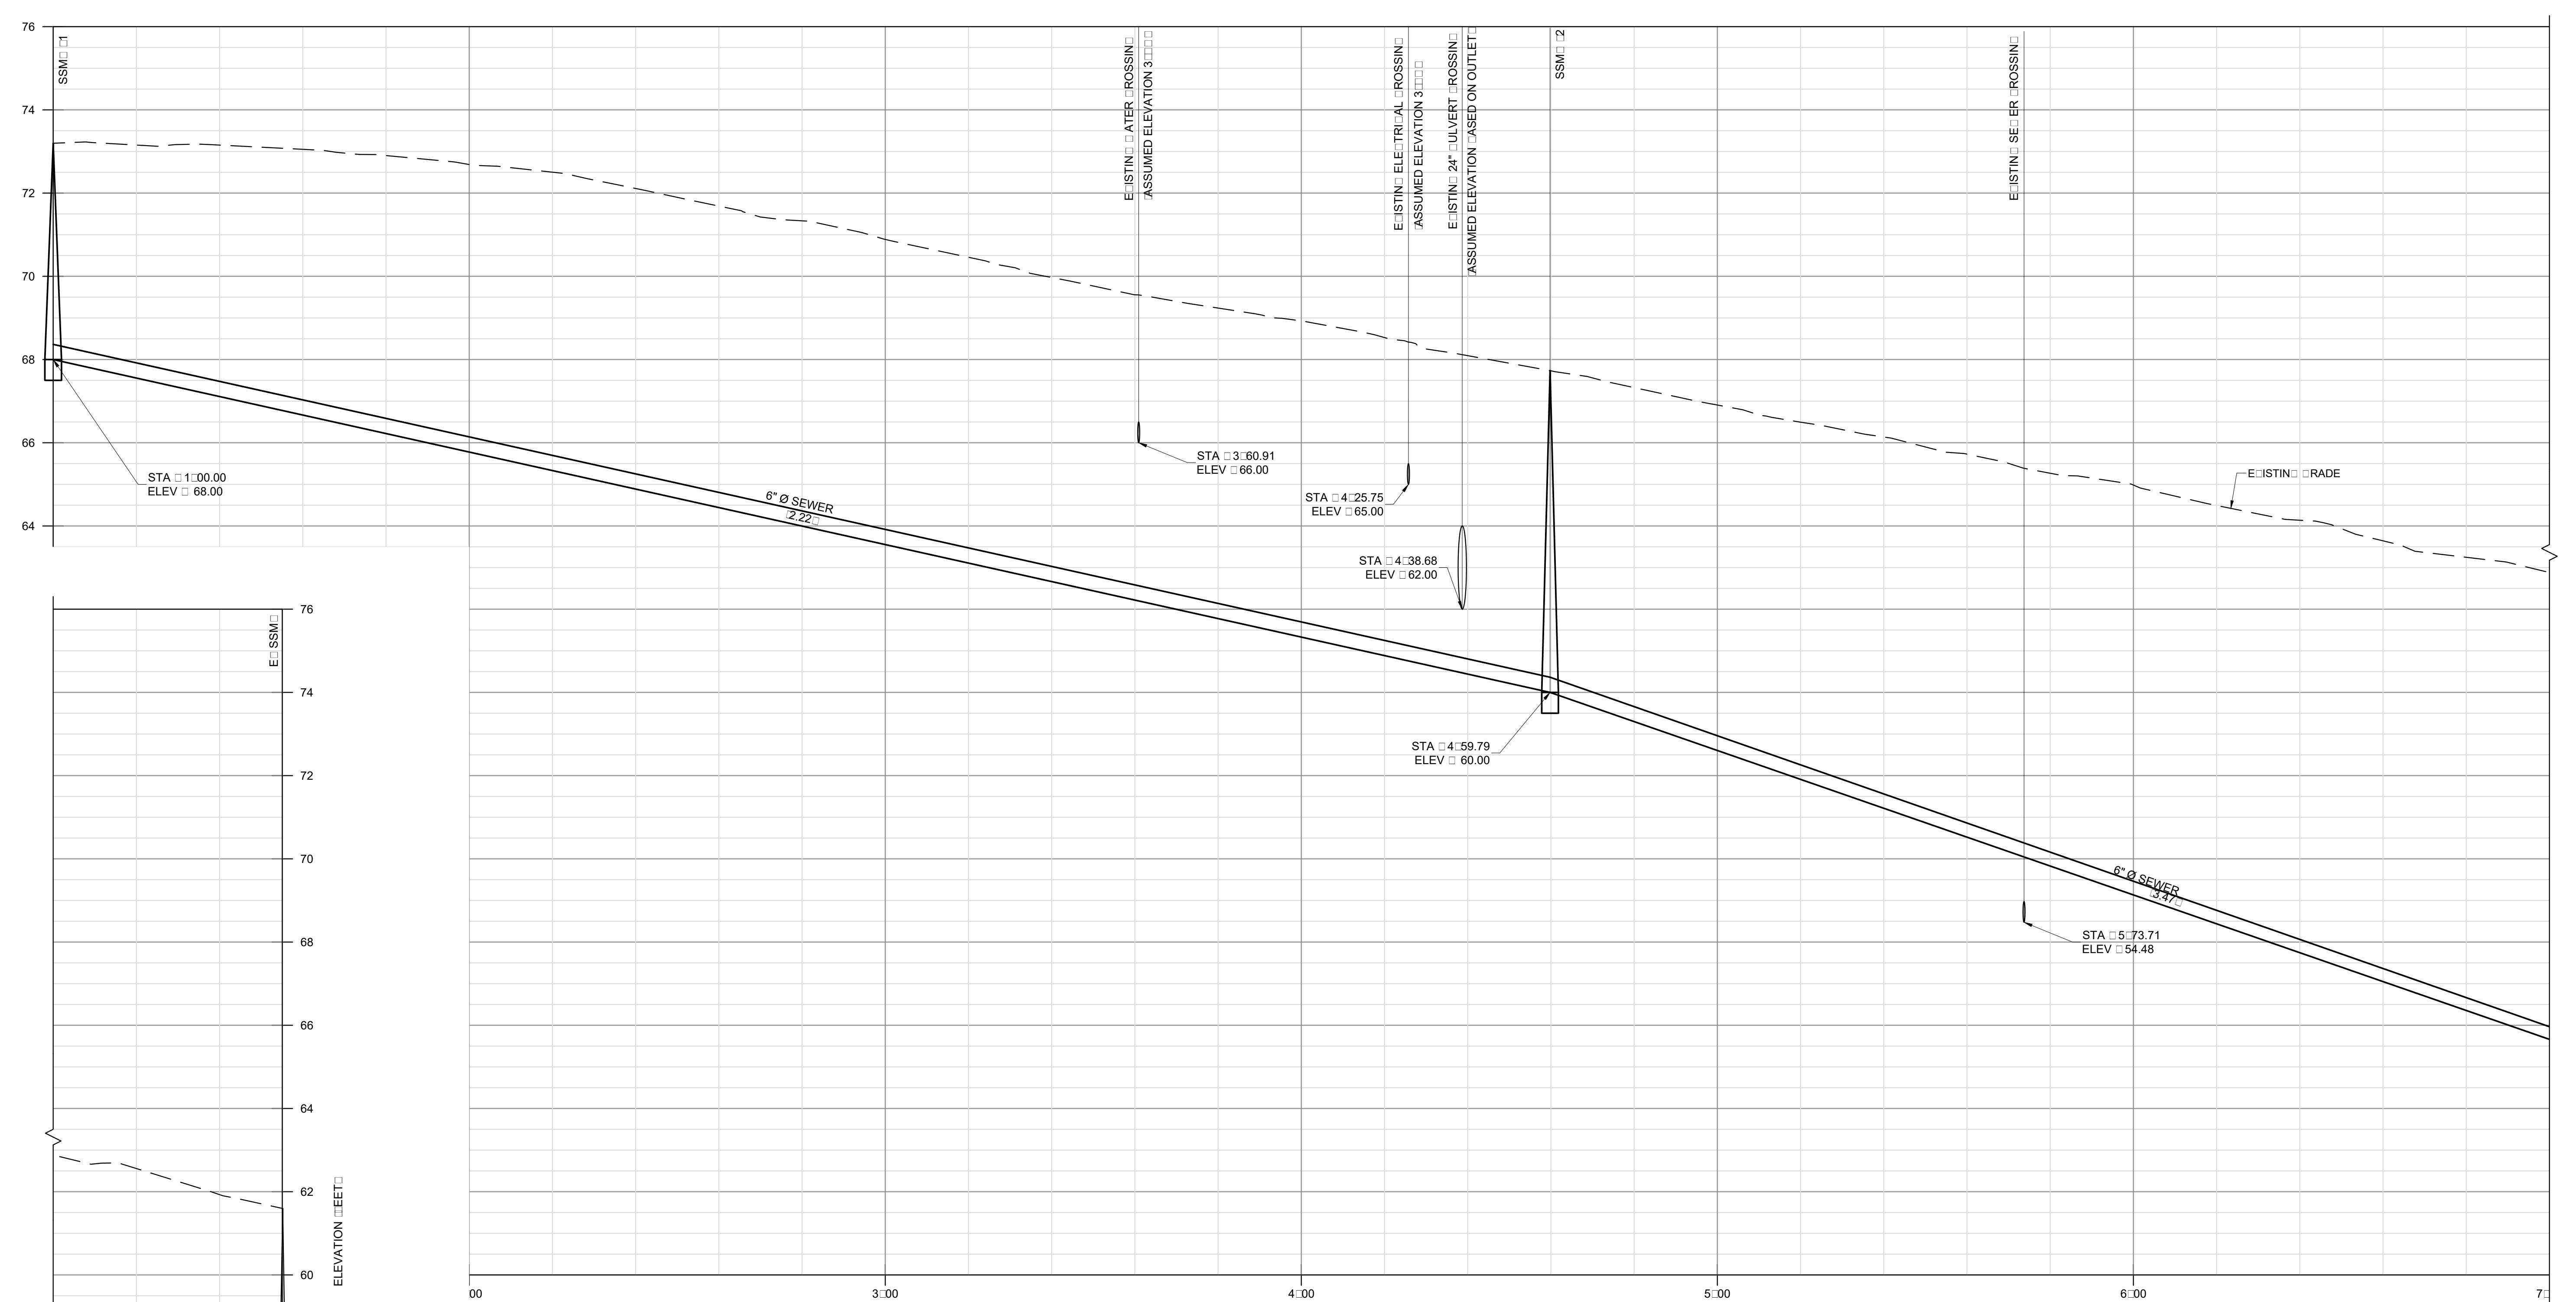

LOCATIONS OF EXISTING UTILITIES SHOWN ON THESE PLANS ARE ONLY APPROXIMATE. THE EXISTING UTILITIES SHOWN WERE PLOTTED USING INCOMPLETE AND INACCURATE RECORDS. IT SHOULD BE EMPHASIZED THAT THIS INFORMATION DOES NOT NECESSARILY REPRESENT ACTUAL SITE CONDITIONS OR SOIL DETAILS OF EXACT LOCATION, DEPTH OR OTHER CONSTRUCTION FEATURES OF THESE UTILITIES. NO WARRANT EITHER EXPRESSED OR IMPLIED AS TO THE COMPLETENESS OR ACCURACY OF THIS INFORMATION IS SET FORTH HEREIN. IT IS THE CONTRACTOR'S RESPONSIBILITY TO VERIFY THIS INFORMATION AND TO LOCATE EXISTING UTILITIES PRIOR TO STARTING WORK. THE CONTRACTOR SHALL CALL "UNDERGROUND SERVICE ALERT" AT 1-800-642-2444 OR THE MARIN COUNTY UNDERGROUND FACILITIES AND SEAL LOCATE AND PROTECT PRIOR TO CONSTRUCTION.

SEWER PROFILE	VALLEMAR STREET □ JULIANA AVENUE □ MOSS □ EA □ CALIFORNIA	PRELIMINARY NOT FOR CONSTRUCTION	Mesiti-Miller Engineering, Inc. CIVIL AND STRUCTURAL DESIGN 831-426-1886 Santa Cruz www.m-m-e.com
REV. 1	LANNAN - ERNST SUBMITTAL	REV. 1	DATE 01/20/15
DESIGN REVIEW: RESUBMITTAL	DESIGN REVIEW: RESUBMITTAL	DESIGN REVIEW: RESUBMITTAL	RT 8/20/16
OUR LOT: LANNAN RESUBMITTAL	OUR LOT: LANNAN RESUBMITTAL	OUR LOT: LANNAN RESUBMITTAL	RT 4/26/17
LOT 1 REVISIONS	LOT 1 REVISIONS	LOT 1 REVISIONS	RT 8/23/17
DRADE			
COPIED			
JO. NUMBER	15147	SHEET	
			5.0

CABRILLO HIGHWAY

VALLEMAR STREET

SHEET NOTES

- [1] PROTECT ALL CUT AND DELL SLOPES WITH EROSION CONTROL CARRIERS AND OR MULCH
- [2] PROTECT ALL STORM DRAIN SYSTEMS AND DRAWS ALEAS FROM SEDIMENT DURING CONSTRUCTION WITH DRAWDROP INLET COVERS AND OR GRAVEL CARRIERS
- [3] PROTECT DITCHES FROM SEDIMENT DURING CONSTRUCTION WITH SILT ENCE AND/OR DRY ROLLS
- [4] PREVENT CONCENTRATED RUNOFF FROM LOGGING OVER SLOPE TEMPORARY SILT ENCE
- [5] TREE PROTECTION TEMPORARY ENSURE TO ENSURE ALTRANS STANDARD PLAN T65 REMOVE DENSE LOGGING OVERFLOW ORIGINAL STABILIZATION
- [6] TREE PROTECTION TEMPORARY ENSURE TO ENSURE ALTRANS STANDARD PLAN T65 REMOVE DENSE LOGGING OVERFLOW ORIGINAL STABILIZATION



Mesiti-Miller Engineering, Inc.


CIVIL AND STRUCTURAL DESIGN

831.426.4186 Santa Cruz, CA 95060

PREPARED AT THE REQUEST OF
MOSS LEAD ASSOCIATES
613 SPRUCE ST
SANTA CRUZ, CA 95060

PREPARED AT THE REQUEST OF
VALLEMAR MOSS
MOSS LEAD ASSOCIATES
613 SPRUCE ST
SANTA CRUZ, CA 95060

EROSION CONTROL PLAN
DRAINAGE DAM
COFFEE RT
JO NUMBER 15147
SHEET 6.0

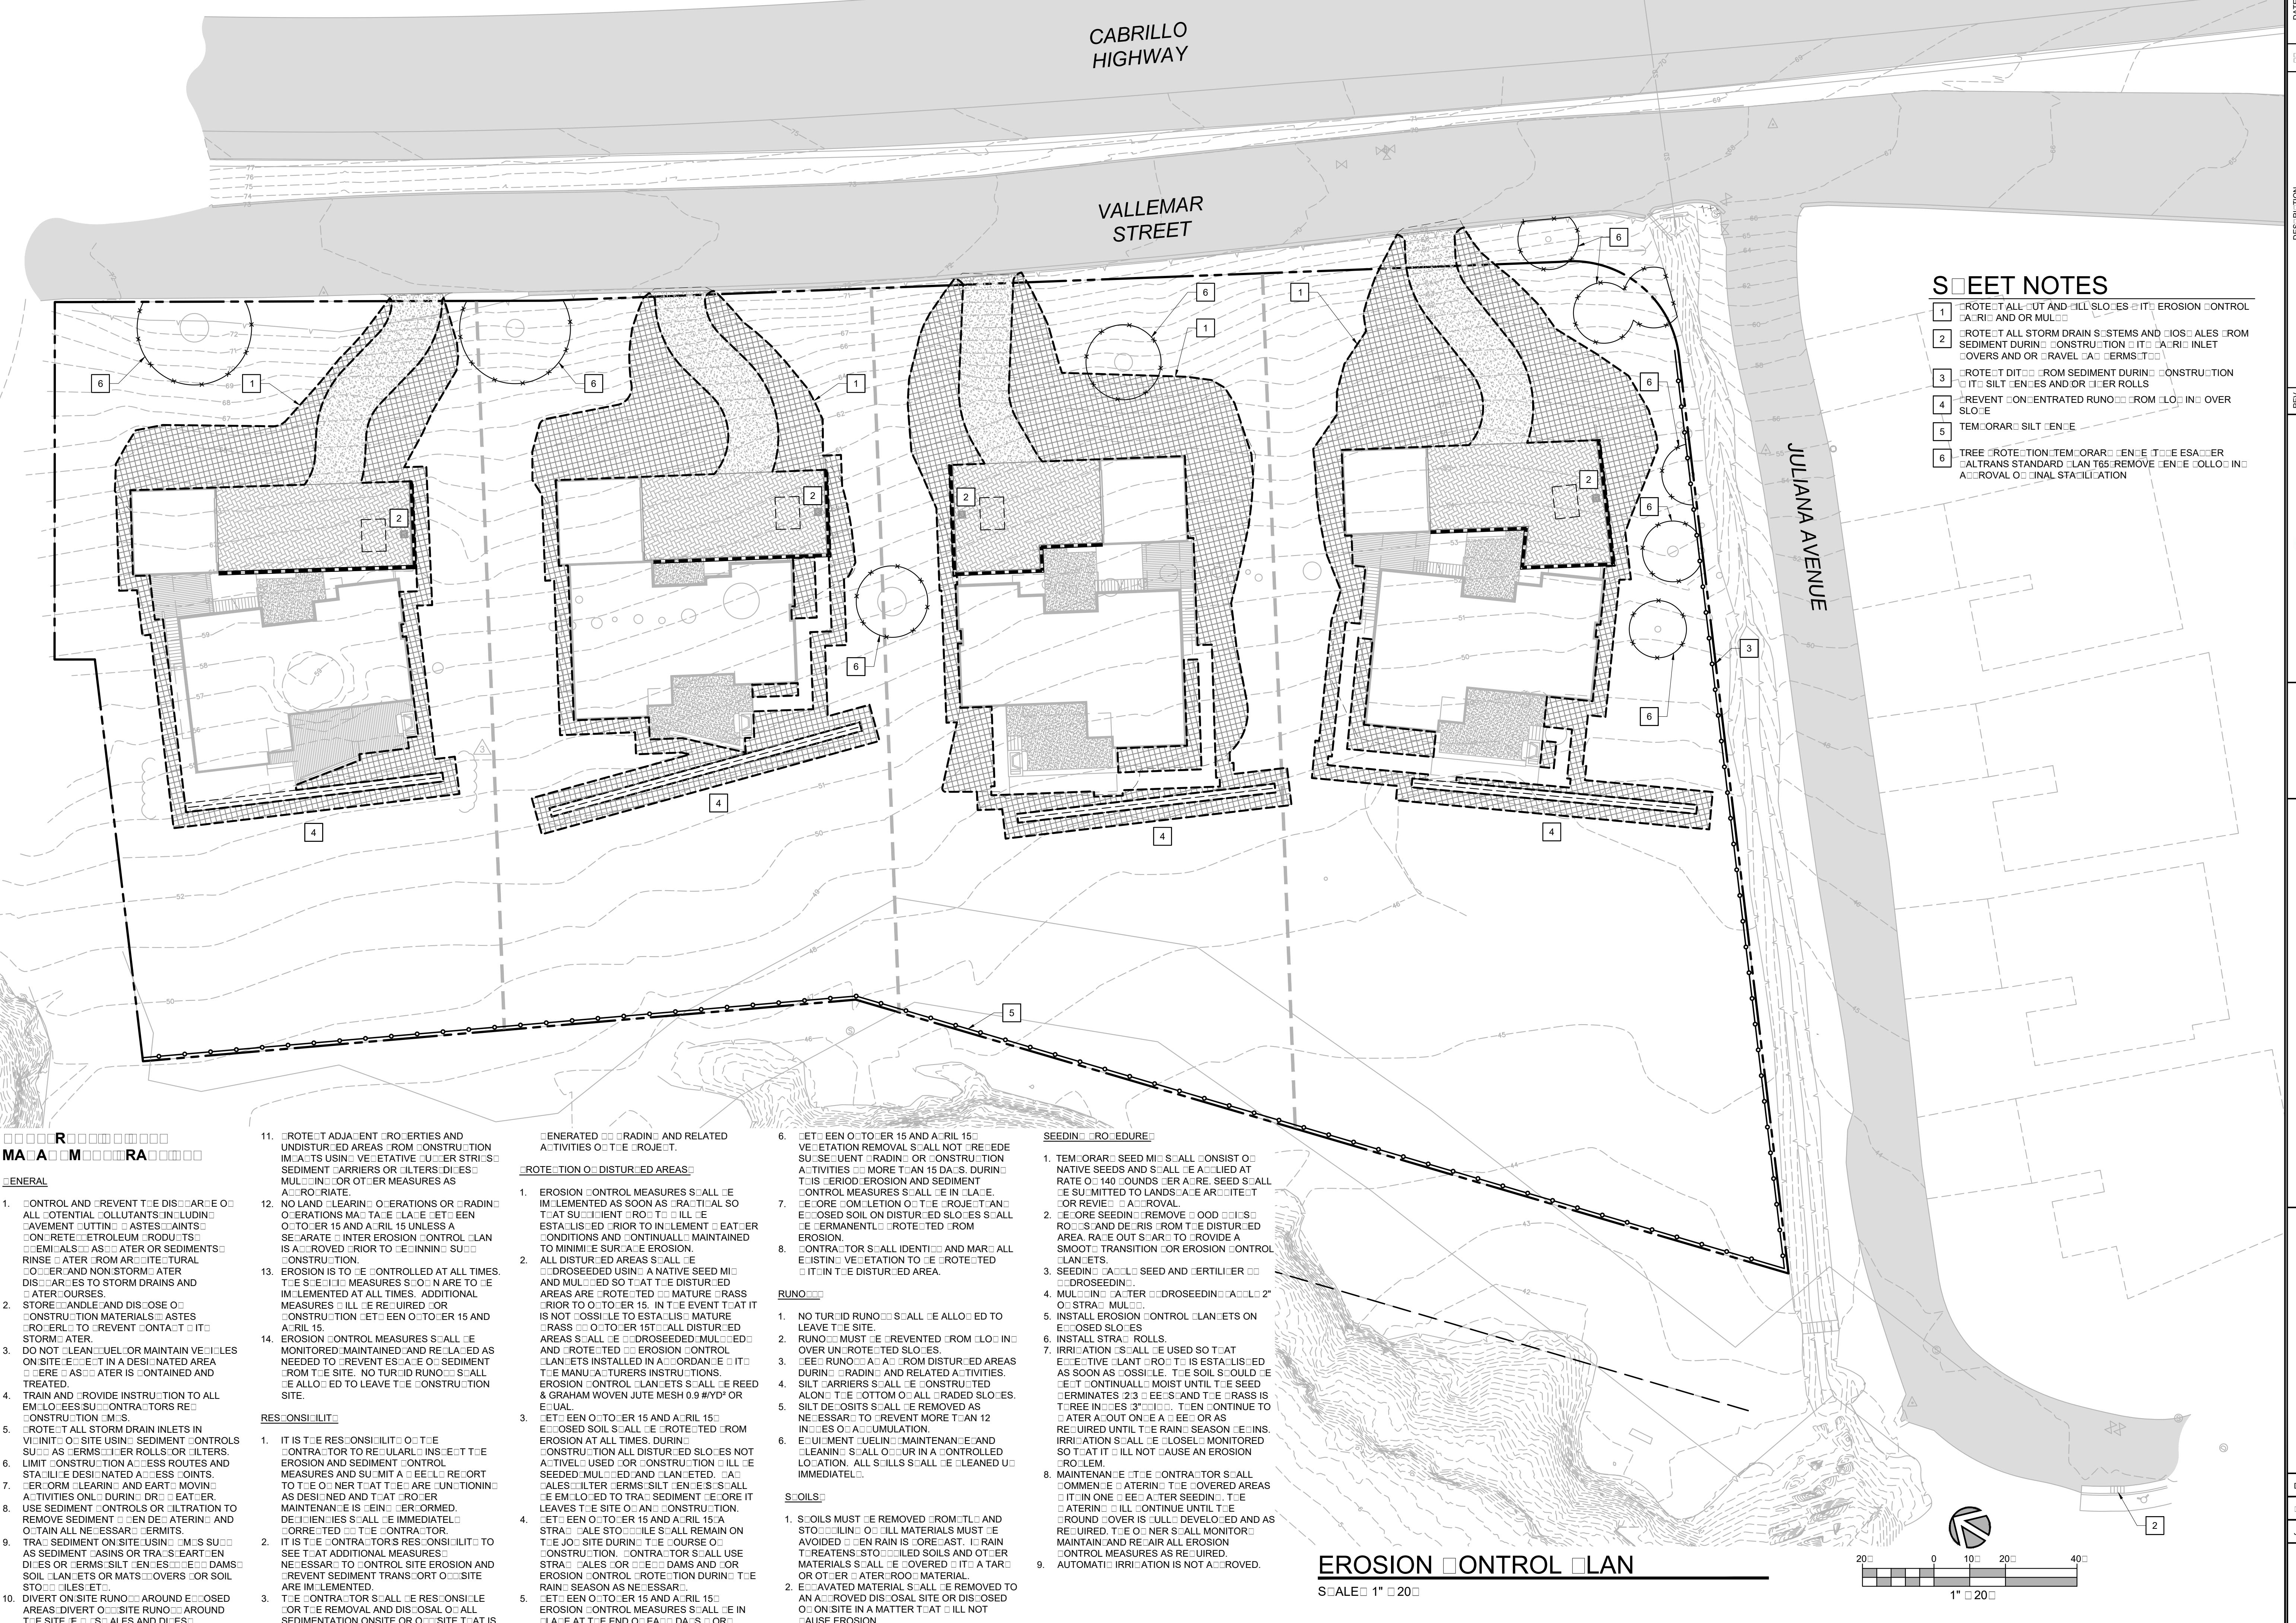




Construction Best Management Practices (BMPs)

Construction projects are required to implement the stormwater best management practices (BMP) on this page, as they apply to your project, all year long.

Materials & Waste Management

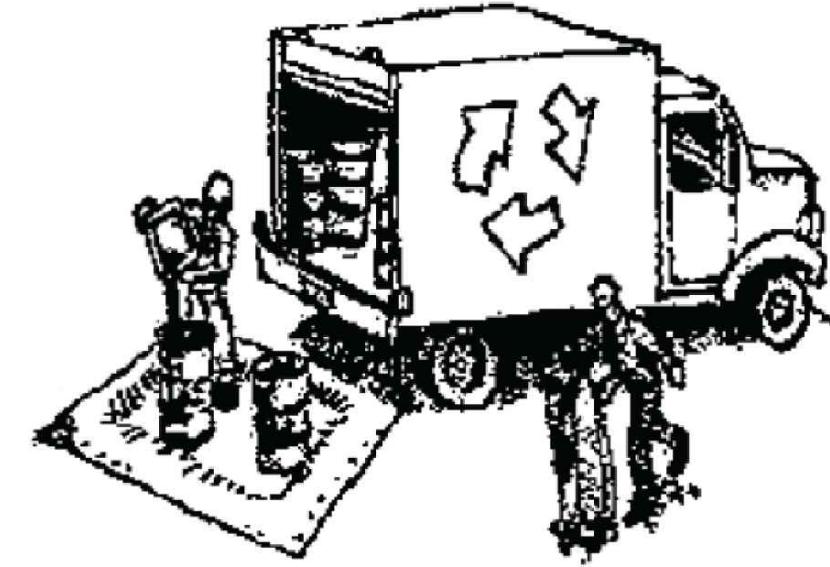

Non-Hazardous Materials

- Berm and cover stockpiles of sand, dirt or other construction material with tarps when rain is forecast or if not actively being used within 14 days.
- Use (but don't overuse) reclaimed water for dust control.

Hazardous Materials

- Label all hazardous materials and hazardous wastes (such as pesticides, paints, thinners, solvents, fuel, oil, and antifreeze) in accordance with city, county, state and federal regulations.
- Store hazardous materials and wastes in water tight containers, store in appropriate secondary containment, and cover them at the end of every work day or during wet weather or when rain is forecast.
- Follow manufacturer's application instructions for hazardous materials and be careful not to use more than necessary. Do not apply chemicals outdoors when rain is forecast within 24 hours.
- Arrange for appropriate disposal of all hazardous wastes.

Waste Management

- Cover waste disposal containers securely with tarps at the end of every work day and during wet weather.
- Check waste disposal containers frequently for leaks and to make sure they are not overfilled. Never hose down a dumpster on the construction site.
- Clean or replace portable toilets, and inspect them frequently for leaks and spills.
- Dispose of all wastes and debris properly. Recycle materials and wastes that can be recycled (such as asphalt, concrete, aggregate base materials, wood, gyp board, pipe, etc.)
- Dispose of liquid residues from paints, thinners, solvents, glues, and cleaning fluids as hazardous waste.

Construction Entrances and Perimeter

- Establish and maintain effective perimeter controls and stabilize all construction entrances and exits to sufficiently control erosion and sediment discharges from site and tracking off site.
- Sweep or vacuum any street tracking immediately and secure sediment source to prevent further tracking. Never hose down streets to clean up tracking.

Equipment Management & Spill Control




Maintenance and Parking

- Designate an area, fitted with appropriate BMPs, for vehicle and equipment parking and storage.
- Perform major maintenance, repair jobs, and vehicle and equipment washing off site.
- If refueling or vehicle maintenance must be done onsite, work in a bermed area away from storm drains and over a drip pan or drop cloth big enough to collect fluids. Recycle or dispose of fluids as hazardous waste.
- If vehicle or equipment cleaning must be done onsite, clean with water only in a bermed area that will not allow rinse water to run into gutters, streets, storm drains, or surface waters.
- Do not clean vehicle or equipment onsite using soaps, solvents, degreasers, or steam cleaning equipment.


Spill Prevention and Control

- Keep spill cleanup materials (e.g., rags, absorbents and cat litter) available at the construction site at all times.
- Inspect vehicles and equipment frequently for and repair leaks promptly. Use drip pans to catch leaks until repairs are made.
- Clean up spills or leaks immediately and dispose of cleanup materials properly.
- Do not hose down surfaces where fluids have spilled. Use dry cleanup methods (absorbent materials, cat litter, and/or rags).
- Sweep up spilled dry materials immediately. Do not try to wash them away with water, or bury them.
- Clean up spills on dirt areas by digging up and properly disposing of contaminated soil.
- Report significant spills immediately. You are required by law to report all significant releases of hazardous materials, including oil. To report a spill: 1) Dial 911 or your local emergency response number, 2) Call the Governor's Office of Emergency Services Warning Center, (800) 852-7550 (24 hours).

Earthmoving

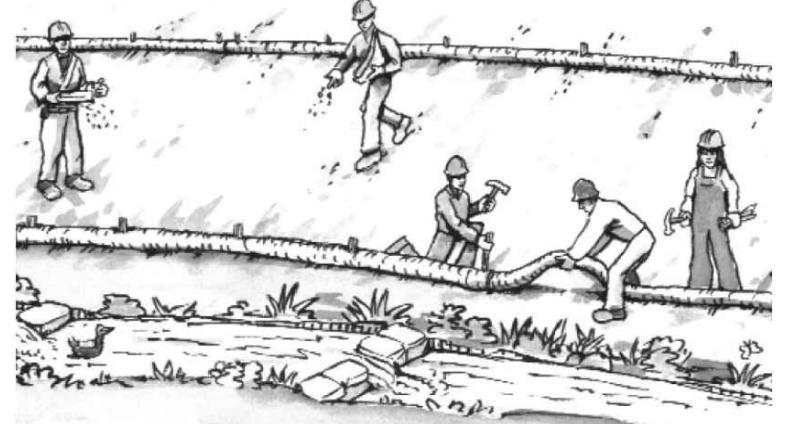

Paving/Asphalt Work

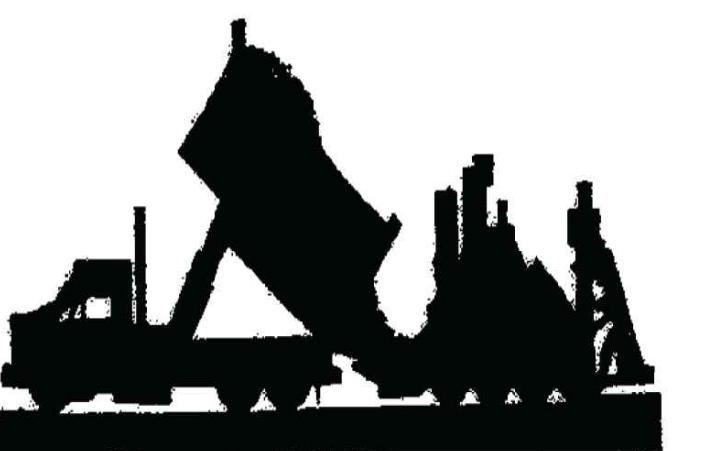

- Avoid paving and seal coating in wet weather or when rain is forecast, to prevent materials that have not cured from contacting stormwater runoff.

- Schedule grading and excavation work during dry weather.
- Stabilize all denuded areas, install and maintain temporary erosion controls (such as erosion control fabric or bonded fiber matrix) until vegetation is established.
- Remove existing vegetation only when absolutely necessary, and seed or plant vegetation for erosion control on slopes or where construction is not immediately planned.

Sawcutting & Asphalt/Concrete Removal

- Cover storm drain inlets and manholes when applying seal coat, tack coat, slurry seal, fog seal, etc.
- Collect and recycle or appropriately dispose of excess abrasive gravel or sand. Do NOT sweep or wash it into gutters.
- Do not use water to wash down fresh asphalt concrete pavement.

Concrete, Grout & Mortar Application



- Store concrete, grout, and mortar away from storm drains or waterways, and on pallets under cover to protect them from rain, runoff, and wind.

- Paint chips and dust from non-hazardous dry stripping and sand blasting may be swept up or collected in plastic drop cloths and disposed of as trash.
- Avoid paving and seal coating in wet weather or when rain is forecast, to prevent materials that have not cured from contacting stormwater runoff.

- For water-based paints, paint out brushes to the extent possible, and rinse into a drain that goes to the sanitary sewer. Never pour paint down a storm drain.
- For oil-based paints, paint out brushes to the extent possible and clean with thinner or solvent in a proper container. Filter and reuse thinners and solvents. Dispose of excess liquids as hazardous waste.

Landscaping




- Stack bagged material on pallets and under cover.

- Protect stockpiled landscaping materials from wind and rain by storing them under tarps all year-round.
- Do not use water to wash down fresh asphalt concrete pavement.

- Discontinue application of any erodible landscape material within 2 days before a forecast rain event or during wet weather.

- When dewatering, notify and obtain approval from the local municipality before discharging water to a street gutter or storm drain. Filtration or diversion through a basin, tank, or sediment trap may be required.
- In areas of known or suspected contamination, call your local agency to determine whether the ground water must be tested. Pumped groundwater may need to be collected and hauled off-site for treatment and proper disposal.


Painting & Paint Removal

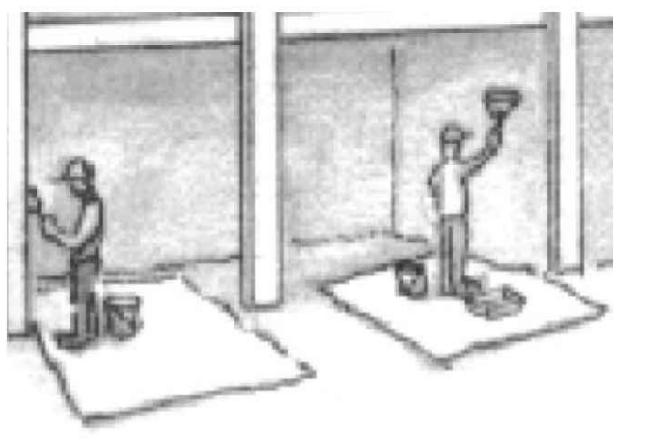

Painting Cleanup and Removal

- For water-based paints, paint out brushes to the extent possible, and rinse into a drain that goes to the sanitary sewer. Never pour paint down a storm drain.
- For oil-based paints, paint out brushes to the extent possible and clean with thinner or solvent in a proper container. Filter and reuse thinners and solvents. Dispose of excess liquids as hazardous waste.
- Paint chips and dust from non-hazardous dry stripping and sand blasting may be swept up or collected in plastic drop cloths and disposed of as trash.
- Chemical paint stripping residue and chips and dust from marine paints or paints containing lead, mercury, or tributyltin must be disposed of as hazardous waste. Lead based paint removal requires a state-certified contractor.

Dewatering

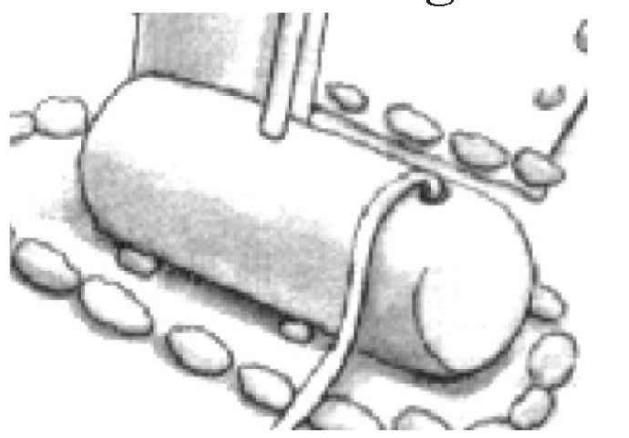

- Prevent sediment from migrating offsite and protect storm drain inlets, gutters, ditches, and drainage courses by installing and maintaining appropriate BMPs, such as fiber rolls, silt fences, sediment basins, gravel bags, berms, etc.
- Shovel, absorb, or vacuum saw-cut slurry and dispose of all waste as soon as you are finished in one location or at the end of each work day (whichever is sooner!).
- If sawcut slurry enters a catch basin, clean it up immediately.
- Divert run-on water from offsite away from all disturbed areas.
- When dewatering, notify and obtain approval from the local municipality before discharging water to a street gutter or storm drain. Filtration or diversion through a basin, tank, or sediment trap may be required.
- In areas of known or suspected contamination, call your local agency to determine whether the ground water must be tested. Pumped groundwater may need to be collected and hauled off-site for treatment and proper disposal.

Storm drain polluters may be liable for fines of up to \$10,000 per day!

CONSTRUCTION LMI'S	VALLEMAR STREET	JULIANA AVENUE	MOSS	PREPARED AT THE REQUEST OF:	NONE ASSOCIATES
DRA: IN	DRA: IN	DRA: IN	DRA: IN	DRA: IN	DRA: IN
DECODED	DECODED	DECODED	DECODED	DECODED	DECODED
JO: NUMBER	15147	SHEET		SHEET	
DRA: IN	DRA: IN	DRA: IN	DRA: IN	DRA: IN	DRA: IN
DECODED	DECODED	DECODED	DECODED	DECODED	DECODED
JO: NUMBER	15147	SHEET		SHEET	
DATE					
REV:	RTG:	RTG:	RTG:	RTG:	RTG:
△ LANIN - ERIN SUBMITTAL	△ DESIGN REVIEW RESULTS	△ OUR LOT - LANIN SUBMITTAL	△ LOT 1 REVISIONS	△ LOT 1 REVISIONS	△ LOT 1 REVISIONS
8/1/1863 Santa Cruz www.m-m-e.com					

