

LOT 1 VALLEMAR BLUFFS

San Mateo County

Application for Design Review by the County Coastside Design Review Committee

County Government Center • 455 County Center • Redwood City CA 94063
Mail Drop PLN 122 • 650 • 363 • 4161 • FAX 650 • 363 • 4849

Permit #: PLN 2015-00380

Other Permit #:

Applicant:

Name: Moss Beach Associates LLC

Address: P.O. Box 377

SANTA CRUZ CA Zip: 95061

Phone, W: 831-457-1331 H: 831-212-8594

Email: OPEN@LAWLORLANDUSE.COM

Architect or Designer (if different from Applicant):

Name: Pearson Design Group/Larry Pearson

Address: 102 North Broadway Ave., Bozeman MT

Zip: 59715

Phone, W: 406-587-1997 H:

Email: BRENT@PEARSONDESIGNGROUP.COM,
BERNST

Project location:

APN: 37086230 37086240

Address: 0 Vallemar Ave (Lot 1)*

Moss Beach, CA Zip: 94,083

Zoning: RM-CZ/DO

Parcel/lot size: 23473 (PROPOSED) sq. ft.

Project:

- New Single Family Residence: 3997 sq. ft.
 Addition to Residence: 4742 sq. ft.
 Other: _____

Describe Project:

Construct a new 4,740SF SFD residence including a 408 3rd story mezzanine area with a 576 sq ft detached 2-car garage

Site Description:

Vacant Parcel

Existing Development (Please describe):

Additional Permits Required:

- Certificate of Compliance Type A or Type B
 Coastal Development Permit
 Fence Height Exception (not permitted on coast)
 Grading Permit or Exemption
 Home Improvement Exception
 Non-Conforming Use Permit
 Off-Street Parking Exception
 Variance

Check if matches existing**Fill in Blanks:****Material****Color/Finish**

Check if matches existing

(If different from existing, attach sample)

a. Exterior walls	rough sawn wood/cement panels/CMU	<hr/> <input type="checkbox"/>
b. Trim	Metal/rough sawn wood	<hr/> <input type="checkbox"/>
c. Windows	Kolbe Vistalux or similar	<hr/> <input type="checkbox"/>
d. Doors	Kolbe Vistalux or similar	<hr/> <input type="checkbox"/>
e. Roof	Standing Seam Bonderized	<hr/> <input type="checkbox"/>
f. Chimneys	CMU or board formed conc	<hr/> <input type="checkbox"/>
g. Decks & railings	Stainless Steel Cables	<hr/> <input type="checkbox"/>
h. Stairs	rough sawn wood	<hr/> <input type="checkbox"/>
i. Retaining walls	Board Form conc or CMU	<hr/> <input type="checkbox"/>
j. Fences	wood	<hr/> <input type="checkbox"/>
k. Accessory buildings	N/A	<hr/> <input type="checkbox"/>
l. Garage/Carport	rough sawn wood	<hr/> <input type="checkbox"/>

To approve this application, the County must determine that this project complies with all applicable regulations including the required findings that the project does conform to the standards and guidelines for design review applicable to the location of the project pursuant to Section 6565.10.

(optional) Applicant's Statement of project compliance with standards and guidelines (check if attached).

I hereby certify that the information stated above and on forms, plans, and other materials submitted herewith in support of the application is true and correct to the best of my knowledge. It is my responsibility to inform the County of San Mateo through my assigned project planner of any changes to information represented in these submittals.

Moss Beach
Associates LLC

Owner:

Applicant:

June 23, 2017

Date:

June 23, 2017

Date:

SECTION 6565.20(C). SITE PLANNING AND STRUCTURE PLACEMENT.

The houses are designed to use existing site topography and natural grading. The low, single-story entrance facades allow whitewater ocean view corridors between and through the houses from both Vallemar Street and Highway 1.

Corresponding to the steep topography, a “bridge” connects the motorcourt to the houses – allowing natural grade and vegetation to flow between the buildings; thereby, limiting grading beyond the footprints.

SECTION 6565.20(D). ELEMENTS OF DESIGN.

Utilizing the Facade Articulation Option, all sides of every house are heavily detailed with wall recesses, projections, decks, cantilevered roofs, and roof dormers adding visual intrigue to each property.

While the forms of the houses complement the nearby neighborhoods, the material palette is comprised of non-reflective, high-quality, exterior materials that provide a symbiotic aesthetic to the natural surrounding features - while also being durable within a marine climate.

Materials include rough-sawn wood siding applied as a water-resistant rainscreen, rigid cementitious paneling, stainless steel railings and flashings, natural looking board-formed concrete site walls, and a lasting metal roof with a “weathered” appearance. Additionally, extensive landscaping of native trees (existing and new), gabion walls comprised of indigenous rock, and locally-inspired “grape-stake” fencing seamlessly softens and blends the structure to the land.

SECTION 6565.20(E). ADDITIONAL SITE PLANNING AND DESIGN CONSIDERATIONS.

While each house is similar in style, through the use of alternating roof pitches, differing orientations, landscaping, and a variable color scheme - each lot becomes a unique (non cookie-cutter) house.

SECTION 6565.20(F). LANDSCAPING, PAVED AREAS, FENCES, LIGHTING AND NOISE.

The landscape architectural design for the Moss Beach project incorporates the protection and rehabilitation of native plant communities. It also includes measures to protect and expand the existing coastal prairie landscape adjacent to the bluffs, with boundaries to limit disturbance.

Selected trees will be preserved and protected to allow for the planting and successional establishment of new trees of varying canopy size. The planting design includes native species of shrubs and grasses adjacent to the proposed homes, which are suited to the coastal climate. The plant palette includes mostly drought tolerant planting irrigated with a water-efficient drip system. The goal is to limit impacts on the established biological systems while mindfully integrating the new landscape design.

The proposed homes at Moss Beach will improve and preserve the existing native landscape, enhance the built neighborhood, and ultimately maintain public access to the coastal trail for perpetuity.

End of Narrative



Project Name: Proposed Moss Beach Homes
Project Location: Vallemar St. and Juliana Ave.
Moss Beach, CA 94038

Project Narrative:

The proposed development is situated near Vallemar Bluffs within a majestic unbuilt lot in San Mateo County.

Formerly submitted as 6 houses densely built on 7 lots. The existing lot lines are being amended to facilitate 4 houses on 4 lots to minimize visual impact and reduce intrusion into the nearby sensitive natural habitat.

In concordance with the San Mateo County Design Review Standards, [*Chapter 28.1 Design Review Standards – Section 6565.20 Standards for Design for One-Family and Two-Family Residential Development in the Midcoast (Moss Beach)*] the architectural and landscape aesthetics of the houses strive to become endearing figures of the neighborhood yet in harmony with, and emboldened by, the unique natural surroundings of Vallemar Bluffs.

SECTION 6565.20(B). NEIGHBORHOOD DEFINITION AND NEIGHBORHOOD CHARACTER.

The immediate surroundings contain a biodiverse habitat consisting of cypress trees, native grasslands, rare flowers, and dramatic cliff-side bluffs. The larger (built) neighborhood context within 300' of the houses lies the Cabrillo Highway (Highway 1), and a handful of houses with similar ocean views.

Within this context, the houses perform the difficult task of responding to the limited nearby neighborhood character, while also taking visual cues to respect, preserve, and blend within the immediate natural habitat.


On the top (northwest) portion of the site, the houses are nestled between existing (and new) cypress trees at the edge of the 50' road setback. However, taking visual cues from the adjacent bluffs, the houses dramatically expand down the natural slope to encapsulate the breadth of the coastline vistas.

Through the extensive use of natural materials - the houses blend with the natural site features to reduce visual intrusion and harmonize within the existing context.



San Mateo County

DRC Mailing
01/22/2019

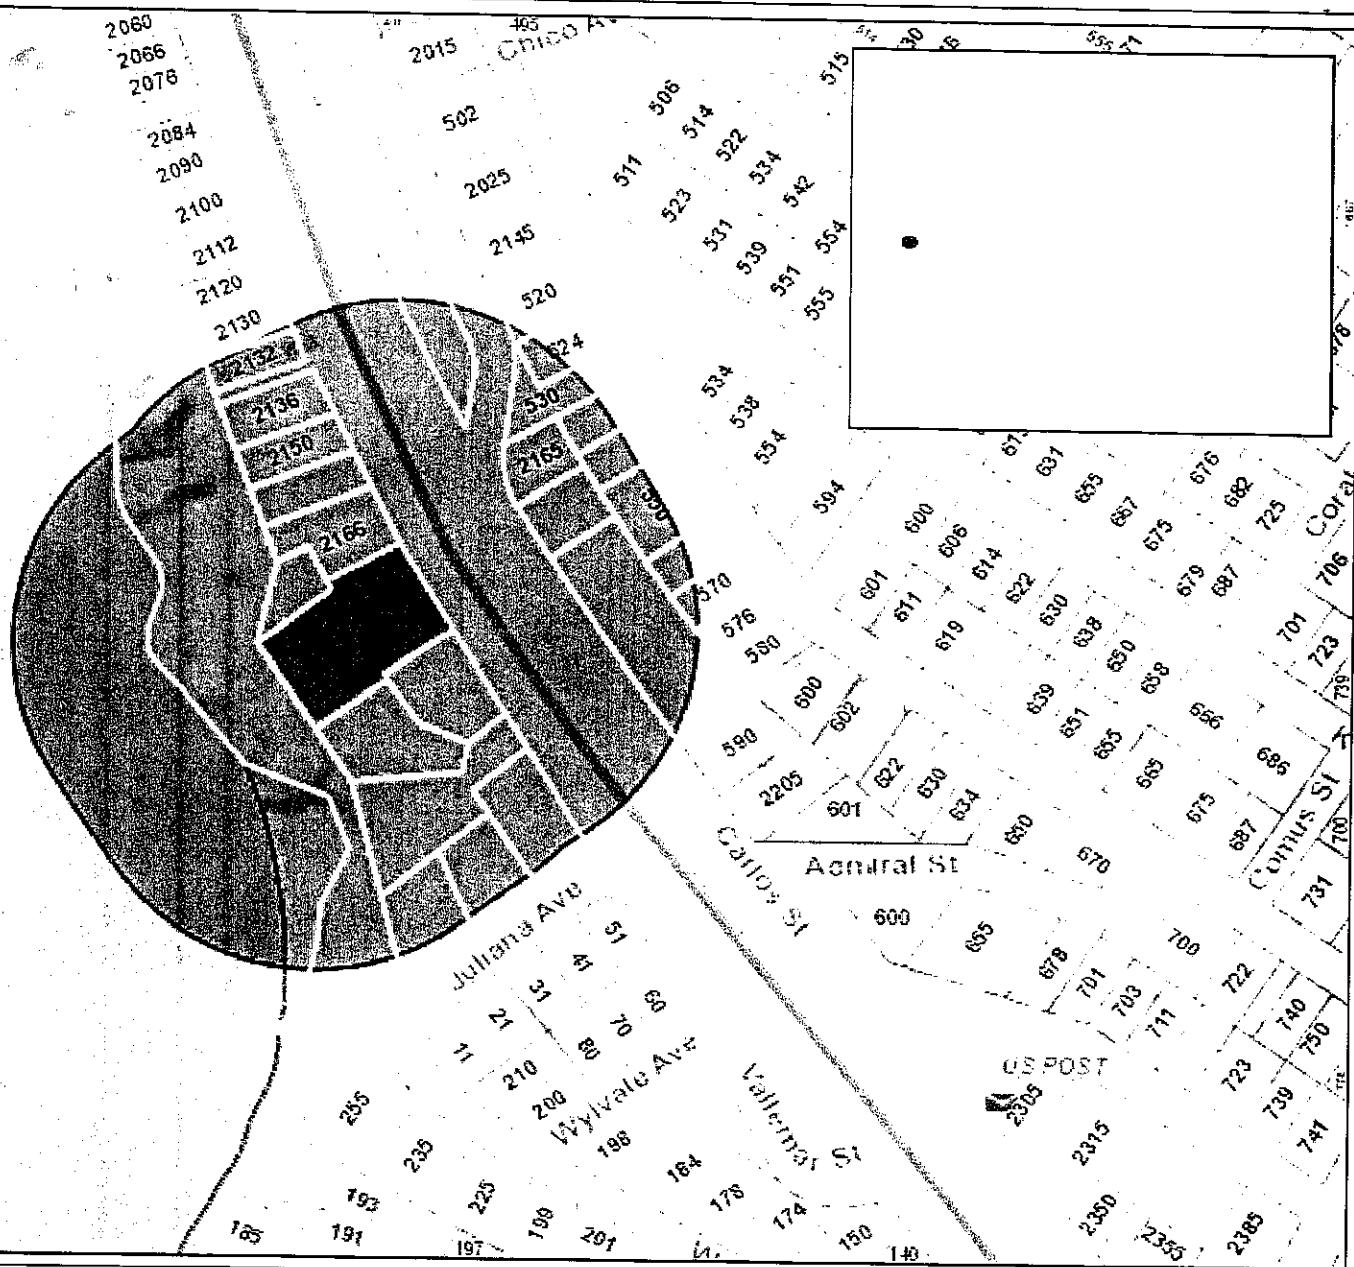

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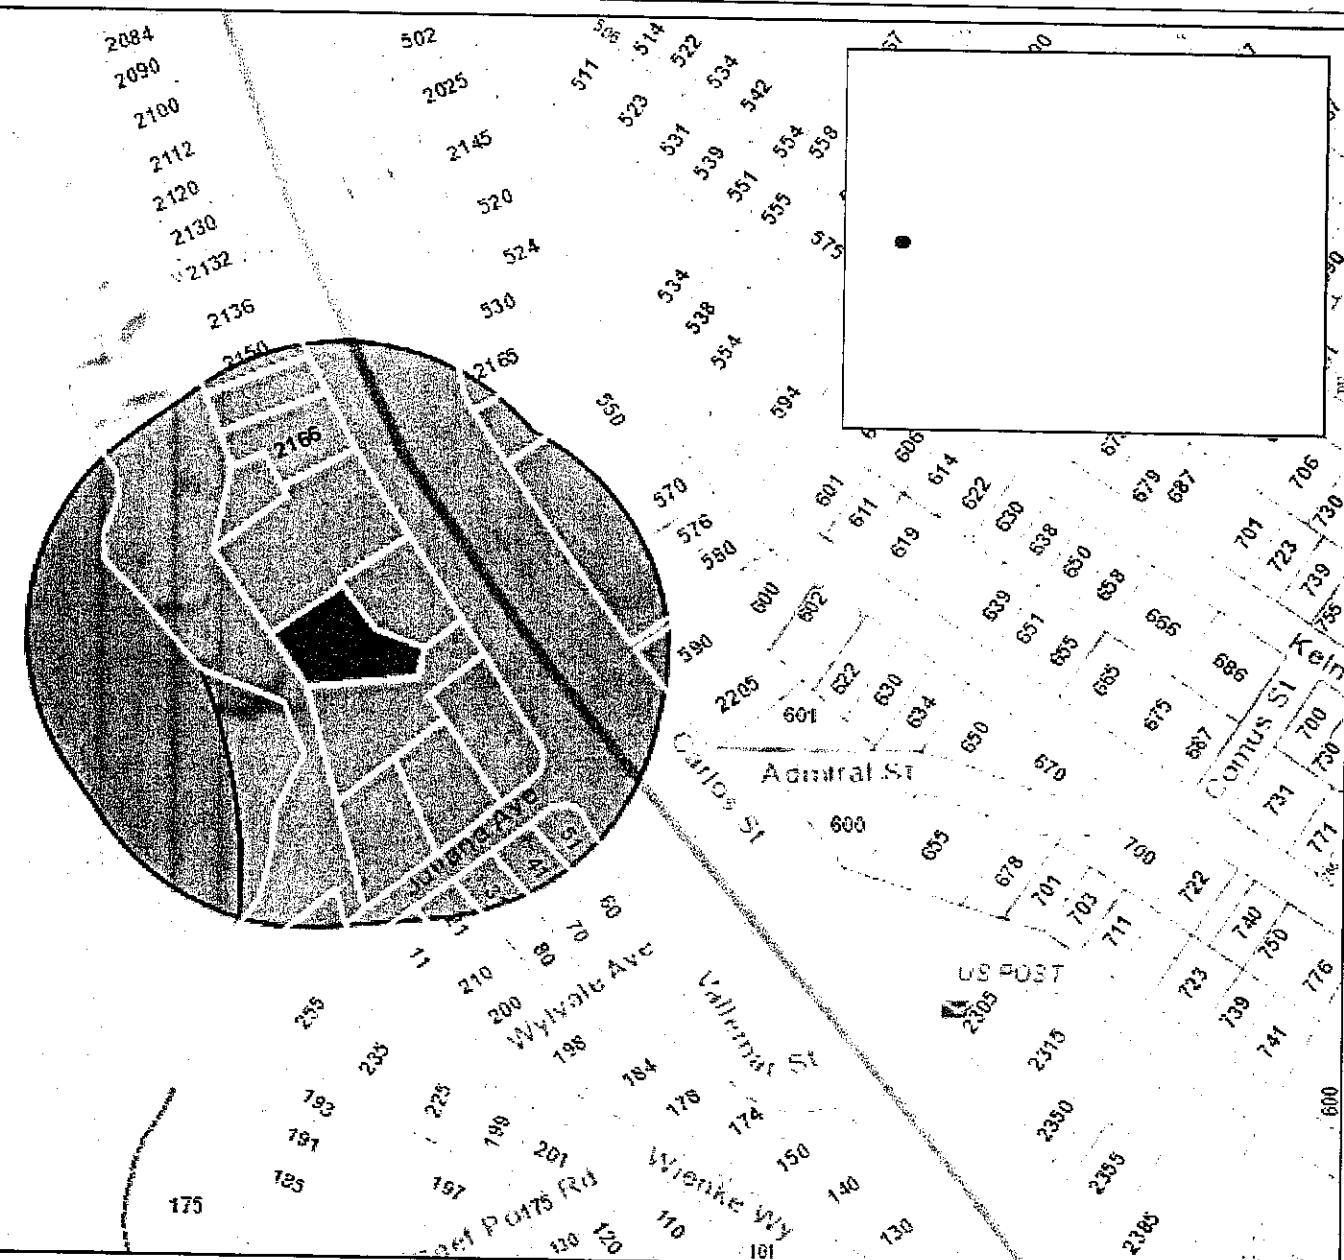
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San Mateo County



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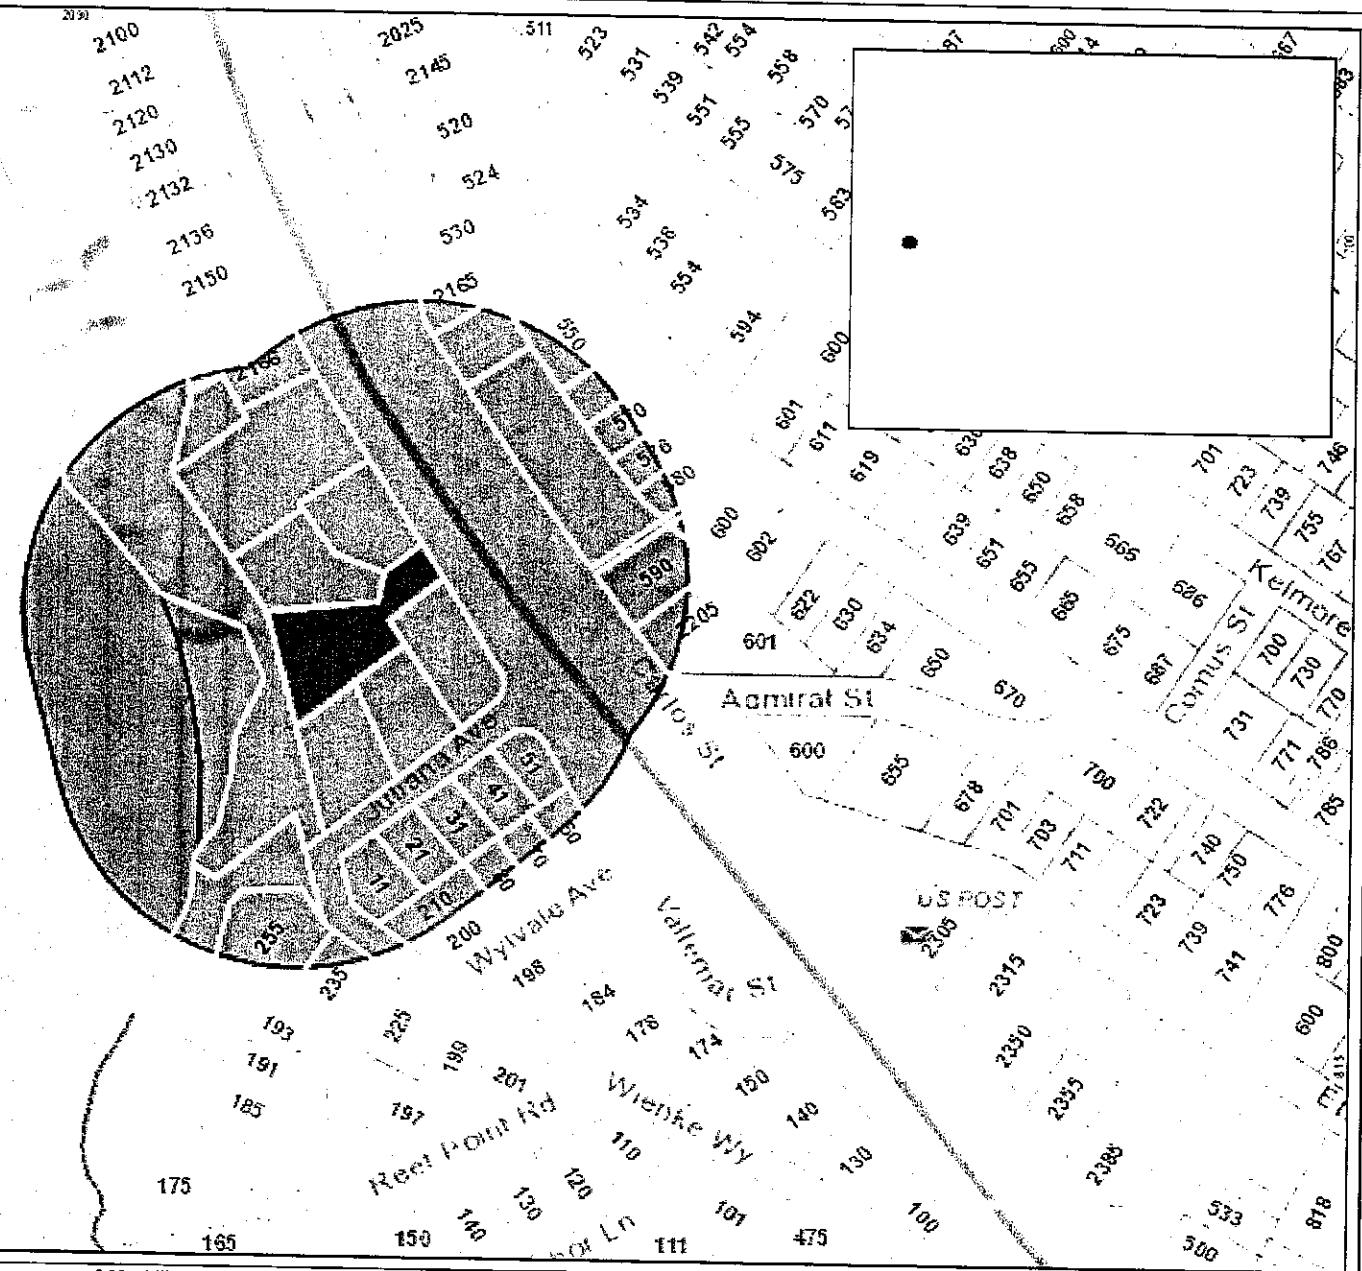


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San Mateo County



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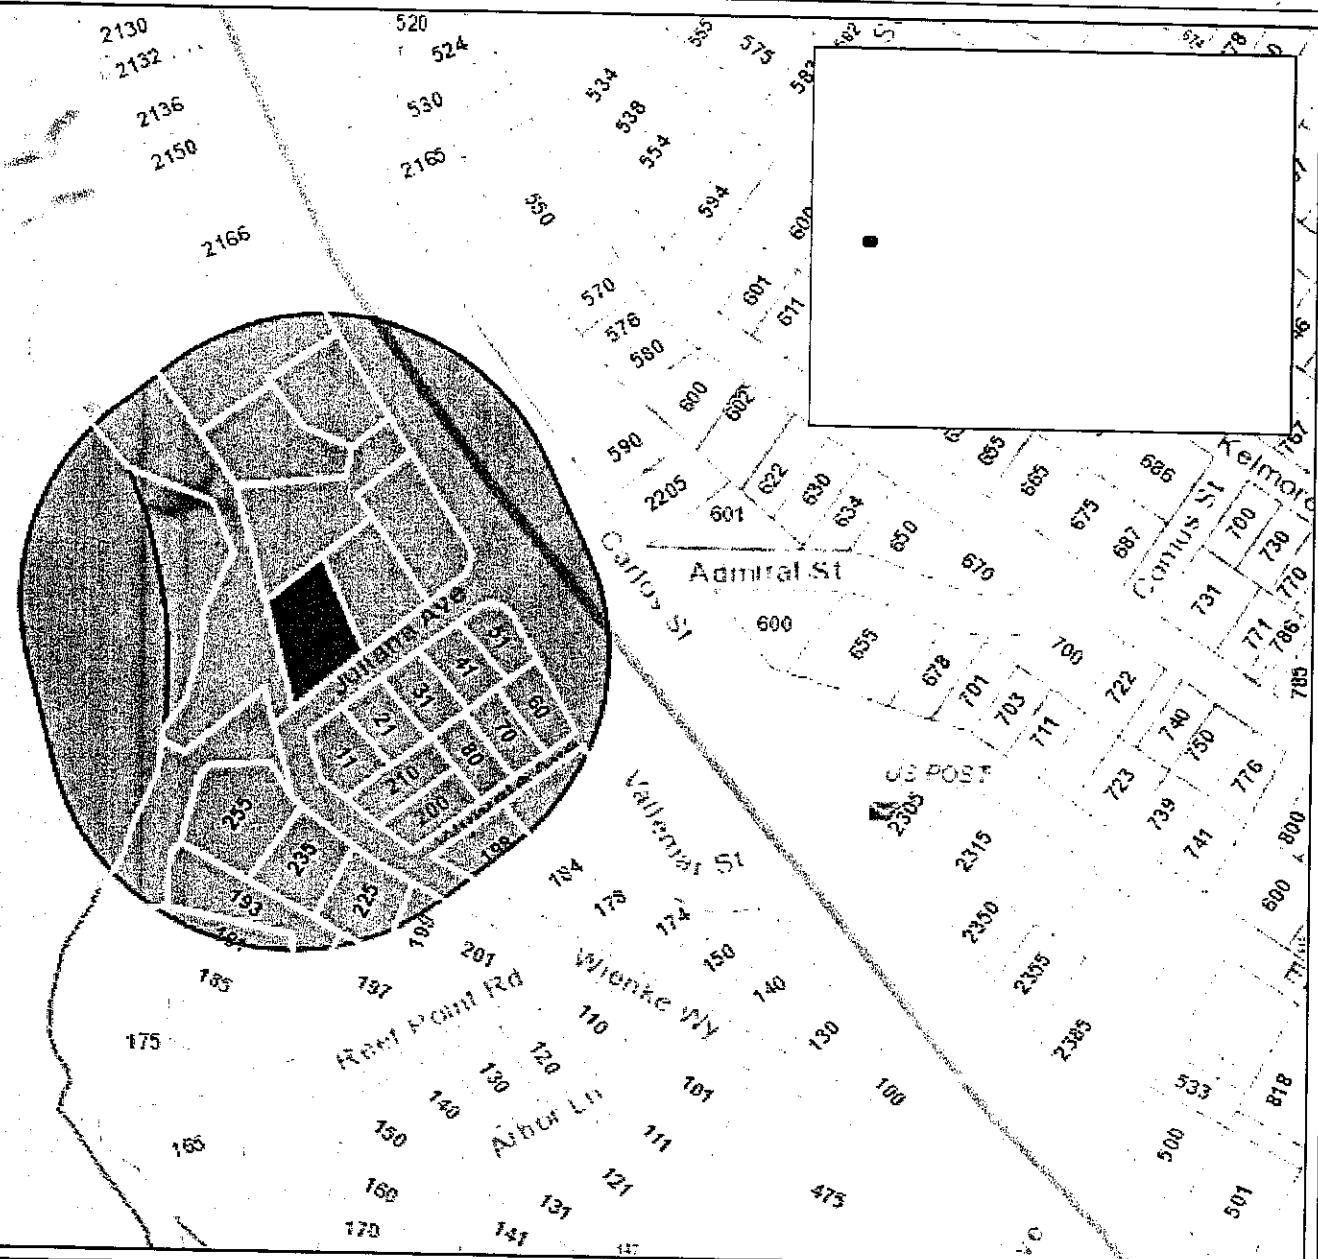
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San Mateo County



0.11 0 0.06 0.11 Miles

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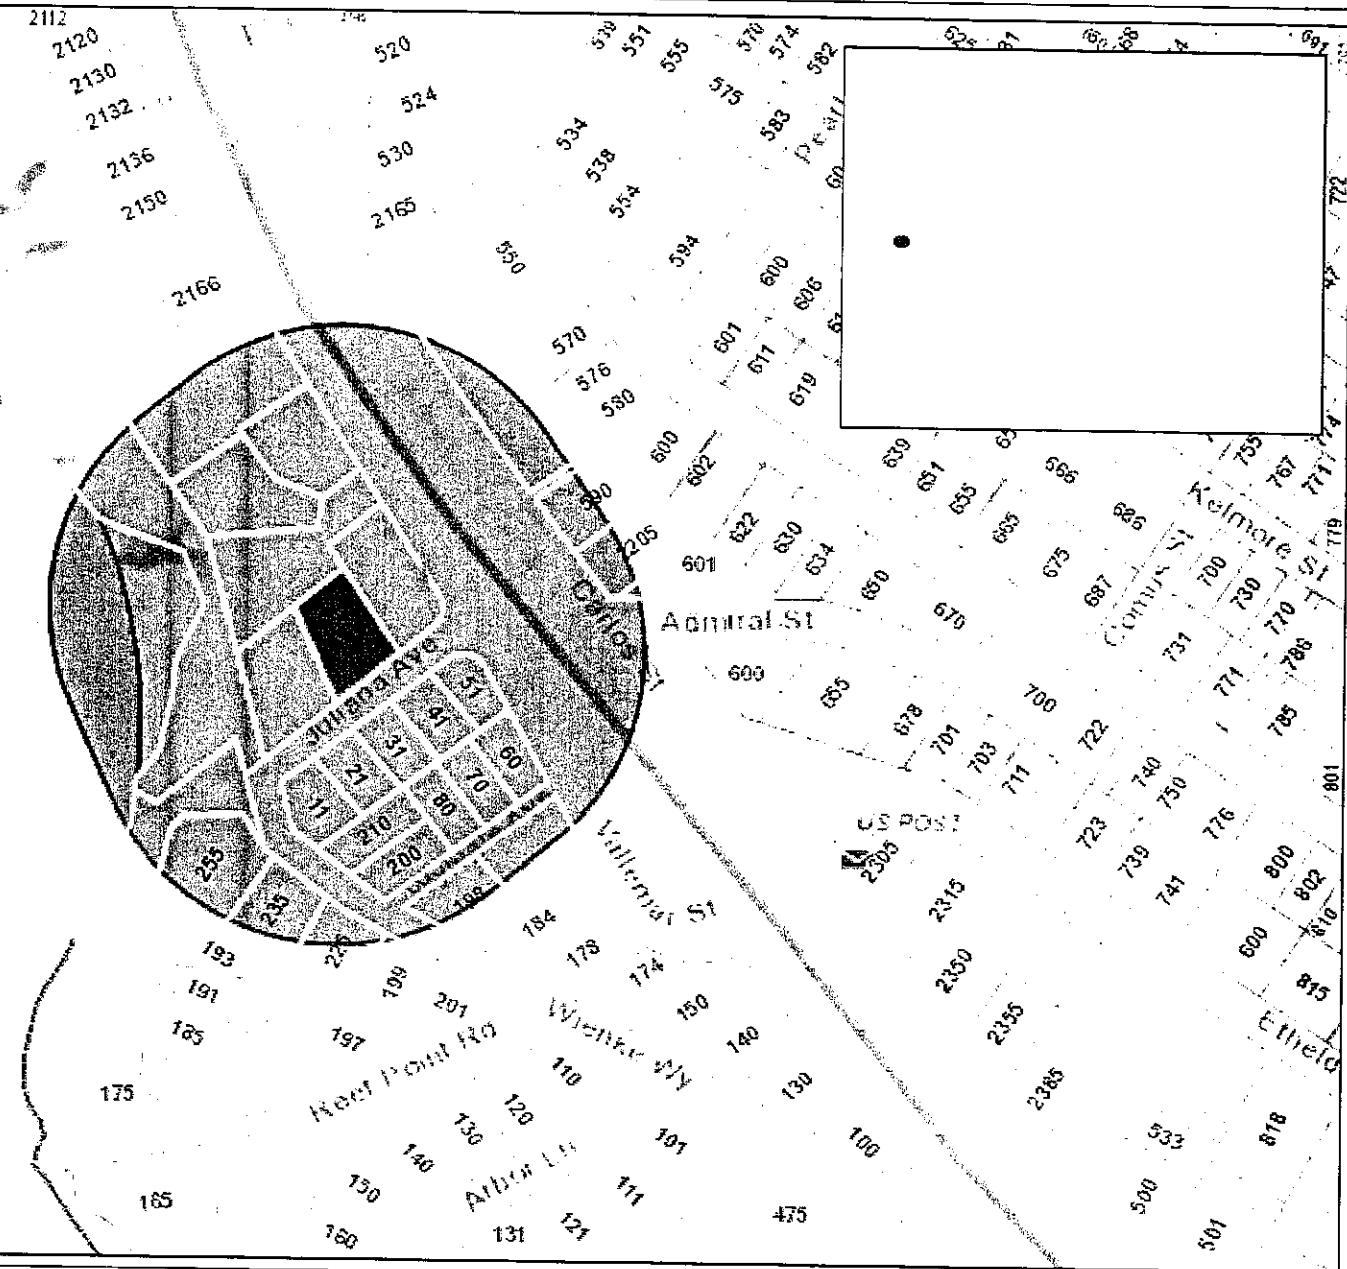
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San Mateo County



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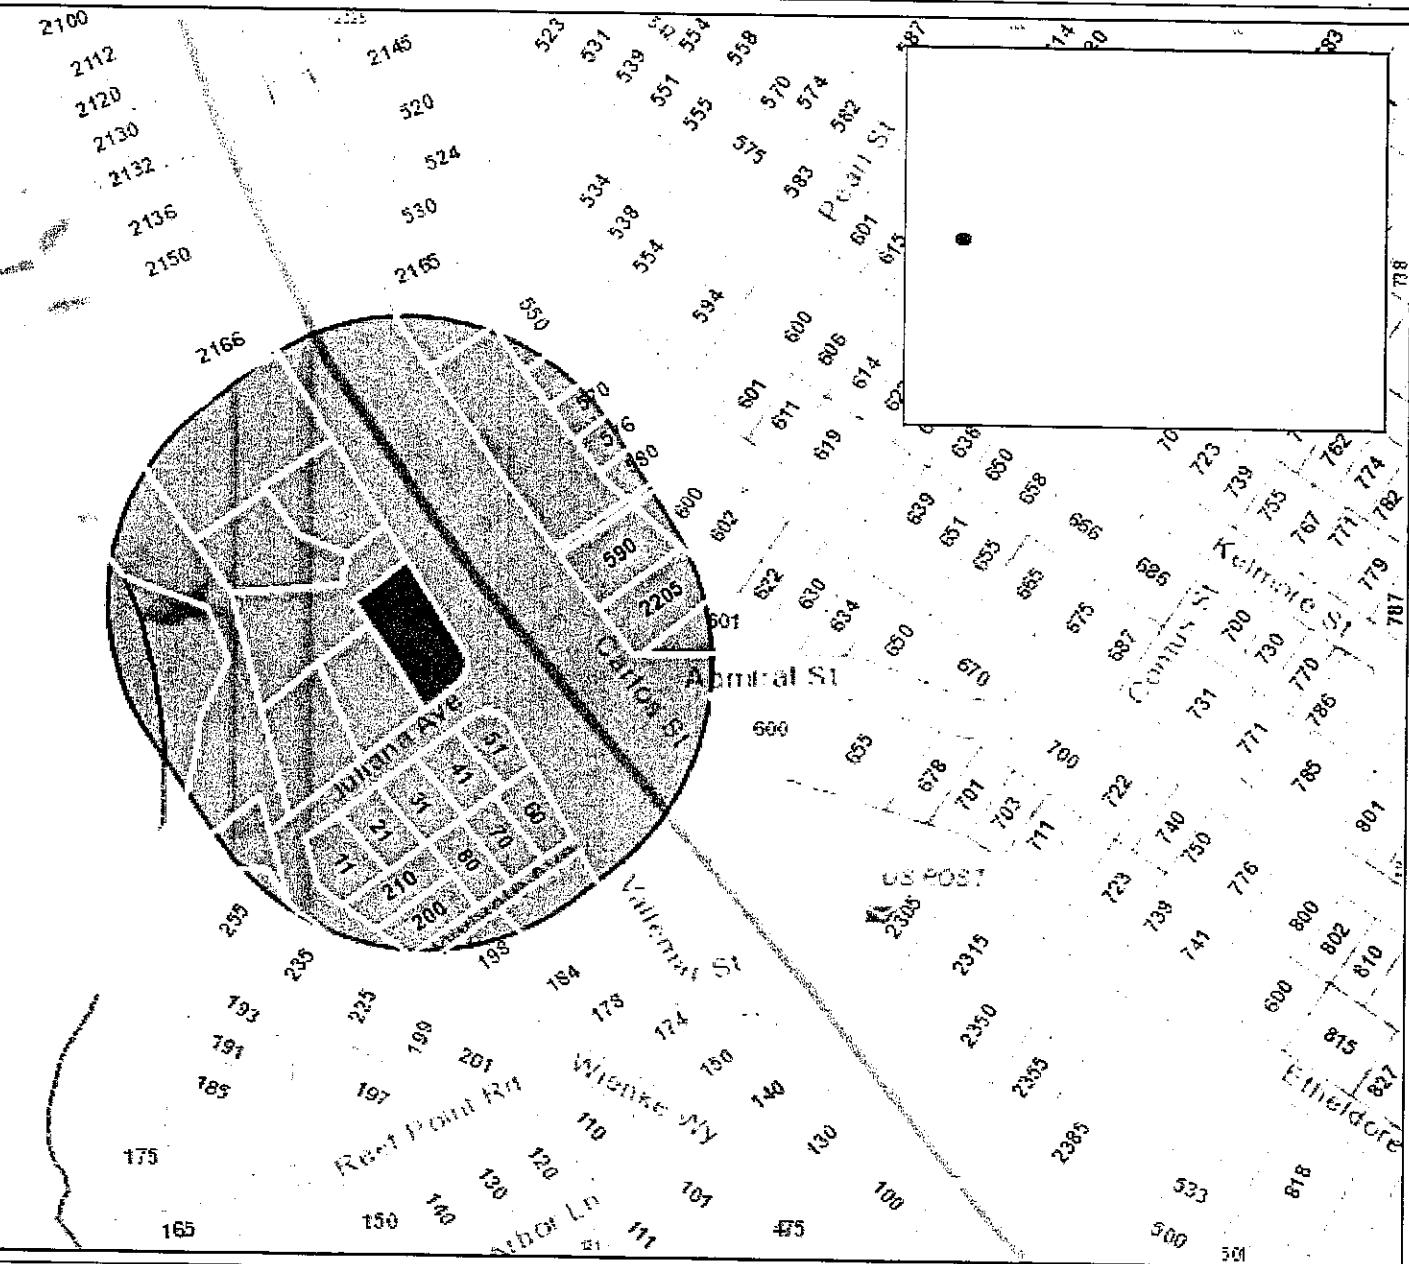
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San Mateo County



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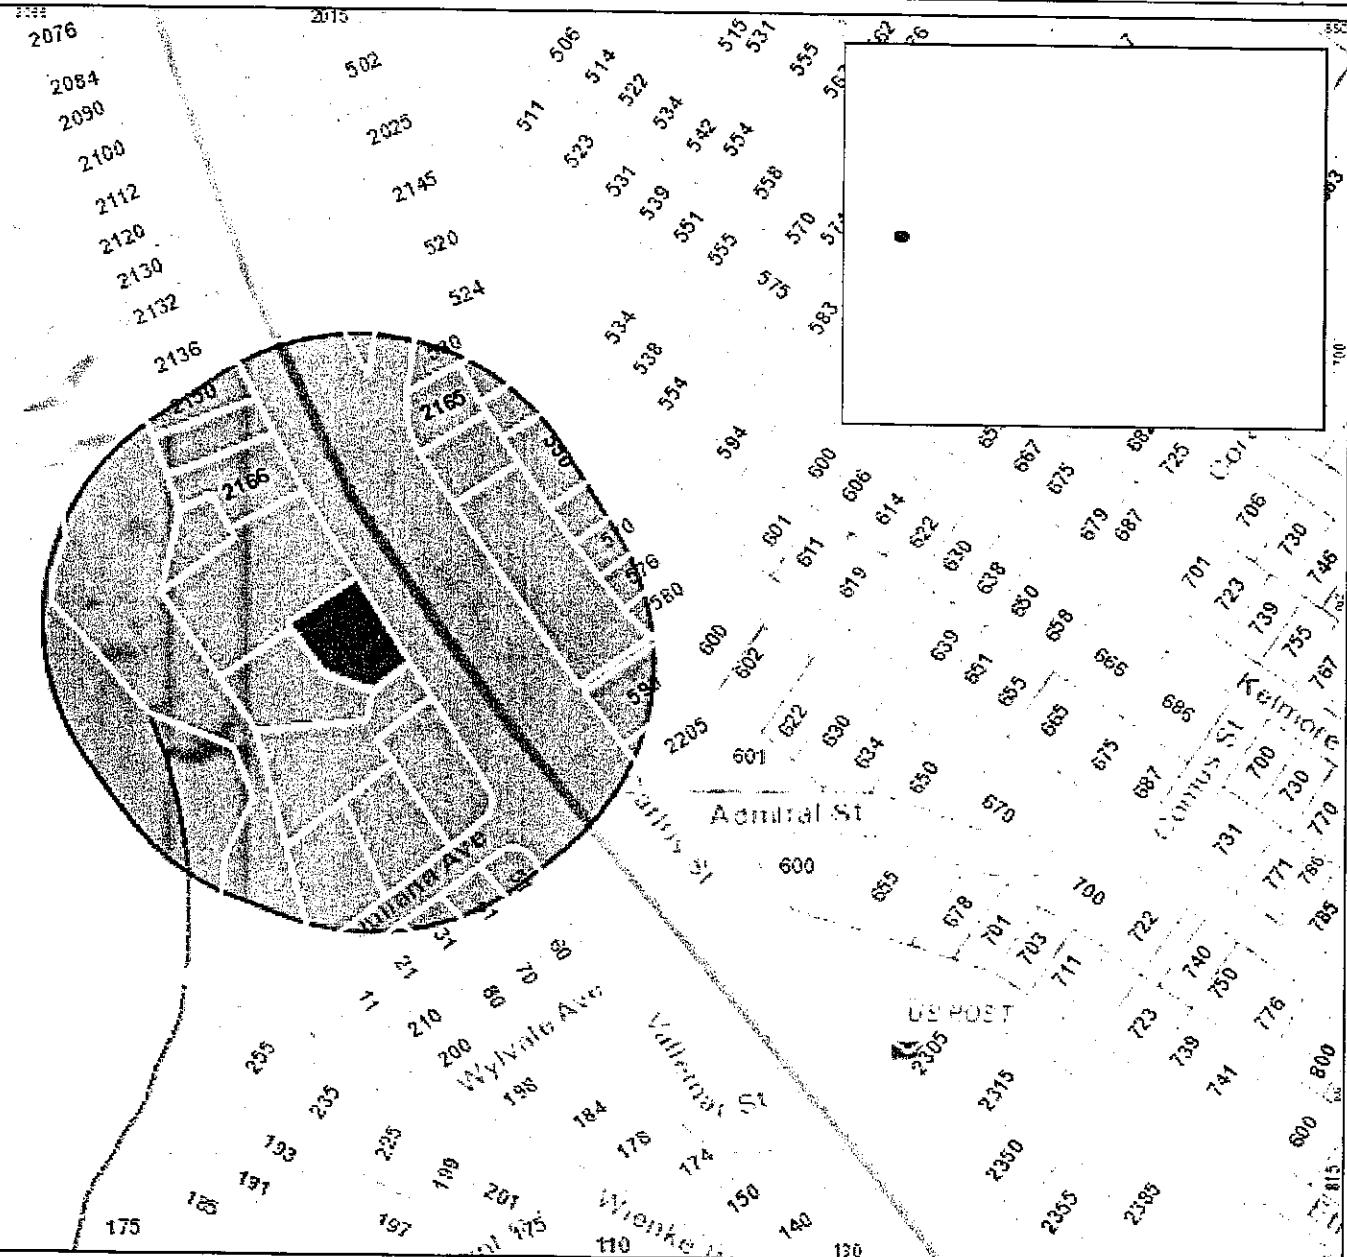
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PROJECT MAPS



VICINITY MAP



SITE MAP

APPLICABLE CODES

1. 2013 CBC CHAPTER 35; PROVIDE ALL THE APPLICABLE/ADOPTED STANDARDS. WHERE A PARTICULAR STANDARD IS REFERENCED IN THE CODE BUT DOES NOT APPEAR AS AN ADOPTED STANDARD IT MAY STILL BE USED. APPLY ONLY THE PORTION OF THE STANDARD THAT IS APPLICABLE TO THE CODE SECTION WHERE THE STANDARD IS REFERENCED, NOT THE ENTIRE STANDARD.

2013 BUILDING STANDARDS ADMINISTRATIVE CODE, PART 1, TITLE 24 C.C.R.
 2013 CALIFORNIA BUILDING CODE (CBC), PART 2, TITLE 24 C.C.R.
 (2012 INTERNATIONAL BUILDING CODE VOLUMES 1-2 AND 2013 CALIFORNIA AMENDMENTS)
 2013 CALIFORNIA ELECTRICAL CODE (CEC), PART 3, TITLE 24 C.C.R.
 (2011 NATIONAL ELECTRICAL CODE AND 2013 CALIFORNIA AMENDMENTS)
 2013 CALIFORNIA MECHANICAL CODE (CMC) PART 4, TITLE 24 C.C.R.
 (2012 UNIFORM MECHANICAL CODE AND 2013 CALIFORNIA AMENDMENTS)
 2013 CALIFORNIA PLUMBING CODE (CDC), PART 5, TITLE 24 C.C.R.
 (2012 UNIFORM PLUMBING CODE AND 2013 CALIFORNIA AMENDMENTS)
 2013 CALIFORNIA ENERGY CODE, PART 6, TITLE 24 C.C.R.
 2013 CALIFORNIA FIRE CODE, PART 9, TITLE 24 C.C.R.
 (2012 INTERNATIONAL FIRE CODE AND 2013 CALIFORNIA AMENDMENTS)
 CALIFORNIA EXISTING BUILDING CODE, PART 10, TITLE 24 C.C.R.
 (2011 INTERNATIONAL EXISTING BUILDING CODE AND 2013 CALIFORNIA AMENDMENTS)
 2013 CALIFORNIA "GREEN" BUILDING REQUIREMENTS OR CAL GREEN, PART 11, TITLE 24 C.C.R.
 2013 CALIFORNIA REFERENCED STANDARDS, PART 12, TITLE 24 C.C.R.
 2013 TITLE 19 C.C.R., PUBLIC SAFETY, STATE FIRE MARSHAL REGULATIONS.

LIST OF FEDERAL CODES AND STANDARDS (IF APPLICABLE)
 AMERICANS WITH DISABILITIES ACT (ADA), TITLE II OR TITLE III
 FOR TITLE II: UNIFORM FEDERAL ACCESSIBILITY STANDARDS (UFAS)
 OR ADA STANDARDS FOR ACCESSIBLE DESIGN (APPENDIX A OF 28 CFR PART 36)
 FOR TITLE III: ADA STANDARDS FOR ACCESSIBLE DESIGN (APPENDIX A OF 28 CFR PART 36)
 2010 AMERICANS WITH DISABILITIES ACT (ADA) STANDARDS FOR ACCESSIBLE DESIGN

NOTE: TITLE II APPLIES TO PROJECTS FUNDED AND/OR USED BY STATE AND LOCAL GOVERNMENT SERVICES. TITLE III COVERS PUBLIC ACCOMMODATIONS AND COMMERCIAL FACILITIES. DEPENDING ON THE USE AND FUNDING, BOTH TITLE MAY APPLY TO THE PROJECT.

NFPA 13	AUTOMATIC SPRINKLER SYSTEMS	2013 EDITION
NFPA 14	STANDPIPE SYSTEMS	2013 EDITION
NFPA 17	DRY CHEMICAL EXTINGUISHING SYSTEMS	2013 EDITION
NFPA 17A	WET CHEMICAL SYSTEMS	2013 EDITION
NFPA 20	STATIONARY PUMPS	2013 EDITION
NFPA 24	PRIVATE MAINS	2013 EDITION
NFPA 72	NATIONAL FIRE ALARM CODE (CALIFORNIA AMENDED) (NOTE SEE STANDARD 1971 FOR "VISUAL DEVICES")	2013 EDITION
NFPA 253	Critical Radiant Flux of Floor Covering Systems	2011 EDITION
NFPA 2001	CLEAN AGENT FIRE EXTINGUISHING SYSTEMS	2012 EDITION
ASME 17.1	ELEVATOR STANDARD	2013 EDITION

REFERENCE CODE SECTION FOR APPLICABLE STANDARDS - 2013 CALIFORNIA BUILDING CODE (FOR SFM) REFERENCED STANDARDS CHAPTER 35

ADA STANDARD FOR ACCESSIBLE DESIGN (APPENDIX A OF 28 CFR PART 36)

2. THE INTENT OF THESE DRAWINGS AND SPECIFICATIONS IS THAT WORK OF THE ALTERATION, REHABILITATION OR RECONSTRUCTION IS TO BE IN ACCORDANCE WITH TITLE 24, CALIFORNIA CODE OF REGULATIONS. SHOULD ANY EXISTING CONDITIONS SUCH AS DETERIORATION OR NON-COMPLYING CONSTRUCTION BE DISCOVERED WHICH IS NOT COVERED BY THE CONTRACT DOCUMENTS WHEREIN THE FINISHED WORK WILL NOT COMPLY WITH TITLE 24, CALIFORNIA CODE OF REGULATIONS, A CHANGE ORDER, OR A SEPARATE SET OF PLANS AND SPECIFICATIONS, DETAILING AND SPECIFYING THE REQUIRED WORK SHALL BE SUBMITTED TO AND APPROVED BY THE OWNER REPRESENTATIVE BEFORE PROCEEDING WITH THE WORK.

3. ALL EXISTING FIRE EXTINGUISHING SYSTEMS ARE IN COMPLIANCE WITH UL 300, CBC 904.11, CFC 904.11.

DESIGN REVIEW DRAWINGS FOR PROPOSED MOSS BEACH HOMES

Vallemar St. and Juliana Ave
Moss Beach, CA 94038

PREPARED BY



102 NORTH BROADWAY AVE.
BOZEMAN, MT 59715
OFFICE: 406.587.1997 FAX: 406.587.0311
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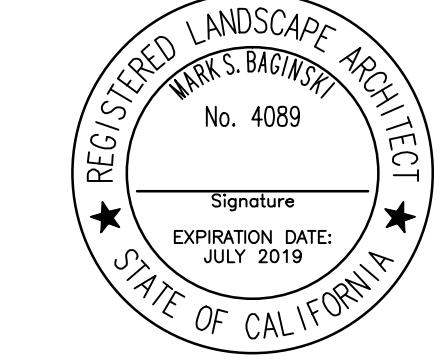


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Civil and Structural Engineering
831.426.3186 | Santa Cruz | www.m-me.com



PROPOSED PERSPECTIVE VIEW



VALLEMAR ST. PERSPECTIVE

CONTACT INFORMATION

ORGANIZATION	NAME	PHONE
APPLICANT MOSS BEACH ASSOCIATES, LLC	OWEN LAWLOR	(831) 457-1331
CIVIL ENGINEER MESITI-MILLER ENGINEERING, INC.	RODNEY CAHILL	(831) 426-3186
LANDSCAPE ARCHITECT VERDE DESIGN INC.	MARK BAGINSKI	(408) 850-3411
ARCHITECT PEARSON DESIGN GROUP	LARRY PEARSON	(406) 587-1997


PROJECT DESCRIPTION

THE PROPOSED PROJECT CONSISTS OF 5 NEW SINGLE-FAMILY DWELLINGS ON 7 LOTS OF RECORD. THE HOMES ARE DESIGNED TO BE CONSISTENT WITH THE COUNTY'S DESIGN GUIDELINES AND THE SAN MATEO COUNTY MID-COAST 2013 LOCAL COASTAL PLAN. THE HOMES SETTLE INTO THE SITE AND UTILIZE THE NATURAL TOPOGRAPHY TO MINIMIZE THE VISUAL IMPACT OF THE PROPOSED DEVELOPMENT FROM AS SEEN FROM HIGHWAY 1. THE HOMES ARE PROPOSED TO USE NATURAL AND LOCALLY-CONSISTENT MATERIALS INCLUDING ROUGH-SAWN CEDAR OR REDWOOD, BOARD FORMED CONCRETE, AND SCREWCAL BALLAST ON THE FLAT ROOF PORTIONS.

THE LOTS ARE LOCATED WEST OF VALLEMAR ST. EAST OF THE VALLEMAR BLUFF PATH (THE STRAND). THE HOMES ARE DESIGNED TO BE CONSISTENT WITH THE COUNTY'S DESIGN GUIDELINES AND THE SAN MATEO COUNTY MID-COAST 2013 LOCAL COASTAL PLAN. THE HOMES SETTLE INTO THE SITE AND UTILIZE THE NATURAL TOPOGRAPHY TO MINIMIZE THE VISUAL IMPACT OF THE PROPOSED DEVELOPMENT FROM AS SEEN FROM HIGHWAY 1. THE HOMES ARE PROPOSED TO USE NATURAL AND LOCALLY-CONSISTENT MATERIALS INCLUDING ROUGH-SAWN CEDAR OR REDWOOD, BOARD FORMED CONCRETE, AND SCREWCAL BALLAST ON THE FLAT ROOF PORTIONS.

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L1.3	JULIANA AVE. SECTION	A1.1	SITE PLAN
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C6.0	EROSION CONTROL PLAN	LOT 4	
C7.0	CONSTRUCTION BEST MANAGEMENT PRACTICES	-	VICINITY MAP & PROPERTY SUMMARY
C8.0	DETAILS	A0.1	AREA PLAN CALCULATIONS
	ARCHITECTURAL PLANS	A1.1	SITE PLAN
A1.0	SITE PLAN	A2.2	LOWER LEVEL PLAN
		A2.3	MAIN LEVEL PLAN
		A2.4	COURTYARD PLAN
		A2.5	GARAGE STORAGE PLAN & ROOF PLAN
		A3.1-3.4	MEZZANINE & ROOF PLAN
		A4.1-4.2	EXTERIOR ELEVATIONS
			BUILDING SECTIONS
LOT 1			
A0.1	VICINITY MAP & PROPERTY SUMMARY		
A1.1	AREA PLAN CALCULATIONS		
A2.1	SITE PLAN		
A2.2	LOWER LEVEL PLAN		
A2.3	MAIN LEVEL PLAN		
A2.4	COURTYARD PLAN		
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A3.1-3.4	MEZZANINE & ROOF PLAN		
A4.1-4.2	EXTERIOR ELEVATIONS		
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CONSULTANT

SHEET TITLE
**VALLEMAR ST.
ELEVATION/
PERSPECTIVE**

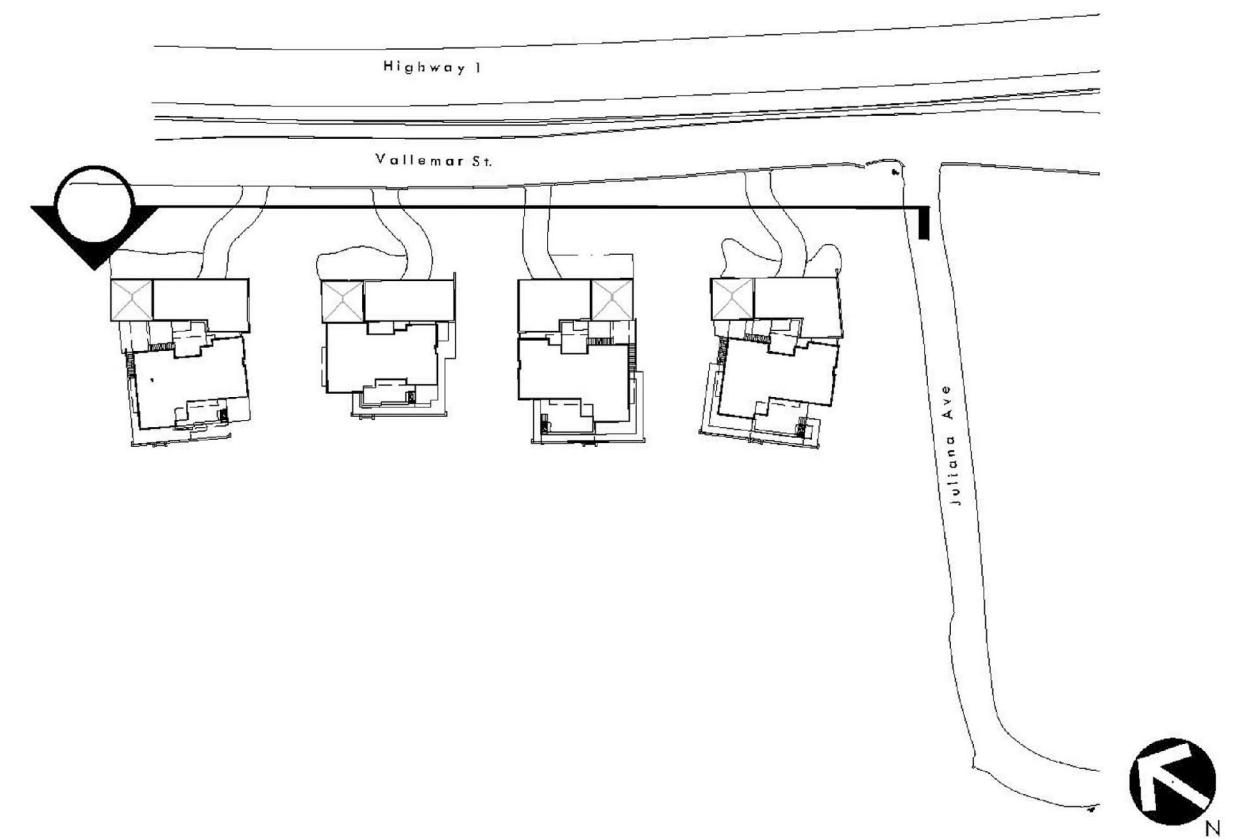
PROJECT NAME
**MOSS BEACH
OCEAN
DEVELOPMENT**

PROJECT ADDRESS
**VALLEMAR ST. &
JULIANA AVE
MOSS BEACH, CA**

SUBMITTAL	DATE
DESIGN REVIEW APPLICATION	08/21/15
DESIGN REVIEW RESUBMITTAL	08/09/16


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DATE ISSUED 08/23/17	SCALE AS SHOWN
PROJ. NO. 1500600-1668	
SHEET NO. L1.1	OF SHEETS

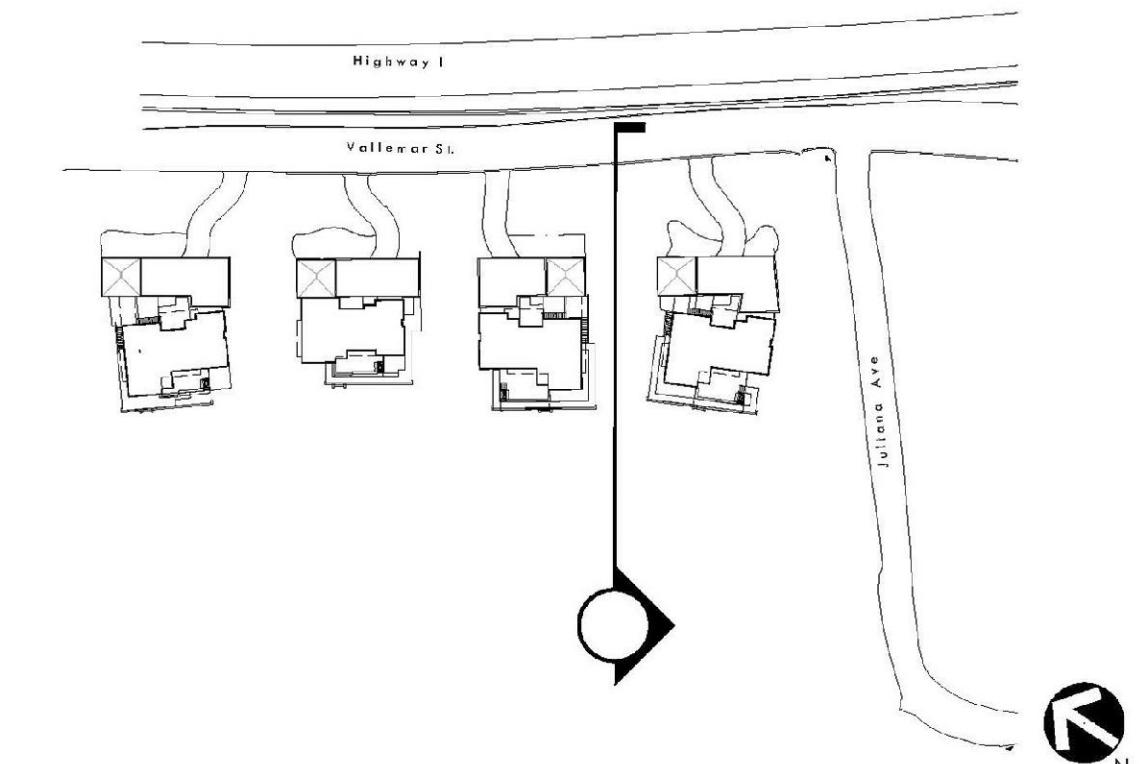

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SHEET TITLE

SITE SECTION

PROJECT NAME

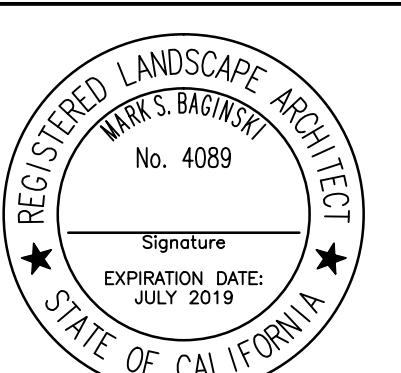MOSS BEACH
OCEAN
DEVELOPMENT

PROJECT ADDRESS

VALLEMAR ST. &
JULIANA AVE
MOSS BEACH, CA

SUBMITTAL

DATE

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REVISIONS

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SCALE

08/23/17

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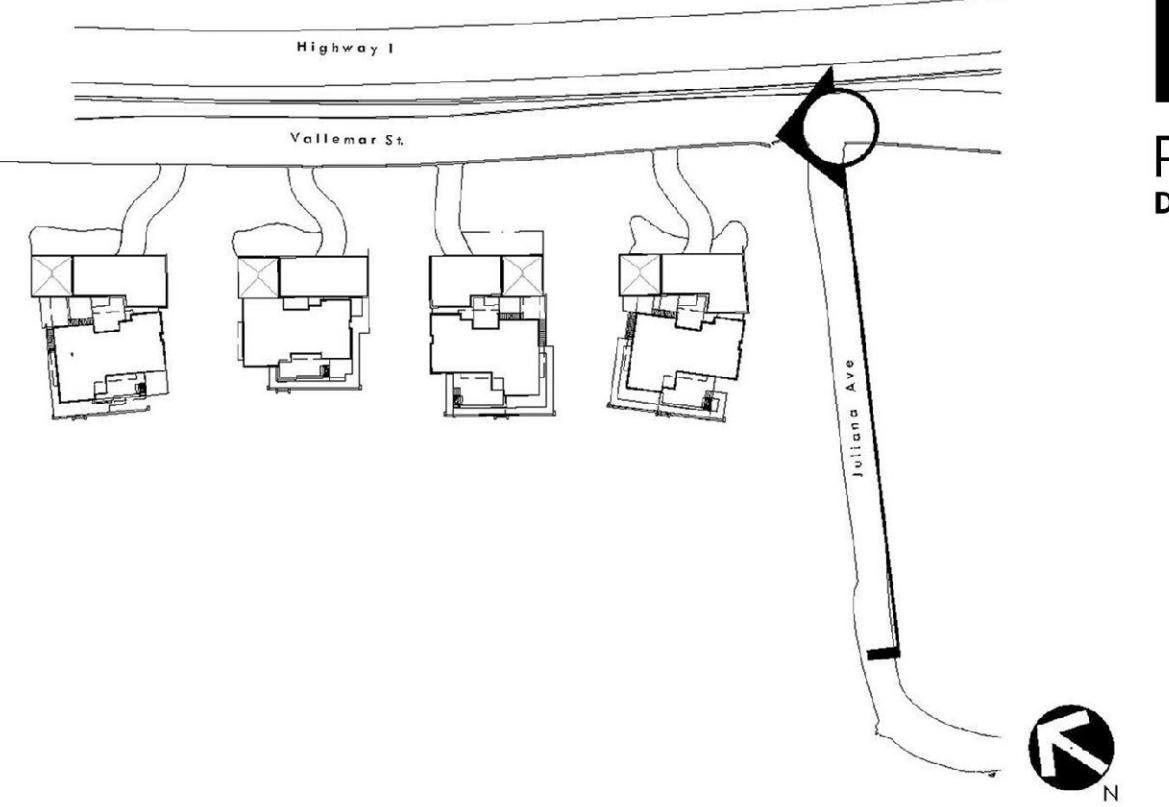
PROJ. NO.

1500600-1668

SHEET NO.

L1.2

OF SHEETS



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DESIGN GROUP



CONSULTANT

SHEET TITLE
**JULIANA AVE.
SECTION/
PERSPECTIVE**


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PROJECT ADDRESS
**VALLEMAR ST. &
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NO.	REVISIONS	DATE
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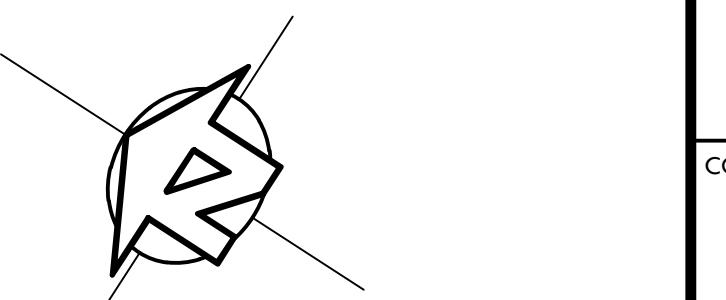
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PH	MB
DATE ISSUED	SCALE
08/23/17	AS SHOWN
PROJ. NO.	1500600-1668
SHEET NO.	L1.3
OF SHEETS	1



Legend

MONUMENT /OUND AS NOTED	
SAN. SEWER MANHOLE	
STORM DRAIN MANHOLE	
PIPE /DRAINT	
VALLEMAR	
INDICATES RECORD DATA	
INDICATES RADIAL ELEVATION	
RECORD /CALCULATED DATA	
INV. INVERT ELEVATION	
AS-BUILT CONCRETE SLABDED	
Drip Line	
Dense Trees, Brush/Vegetation	
Water Line (Painted Manhole)	
Sanitary Sewer Line	
Storm Drain Line	
Overhead Utility Line	
Gas Line (Painted Manhole)	

ALL DISTANCES SHOWN ARE IN FEET AND DECIMALS TO THREE DECIMAL PLACES.

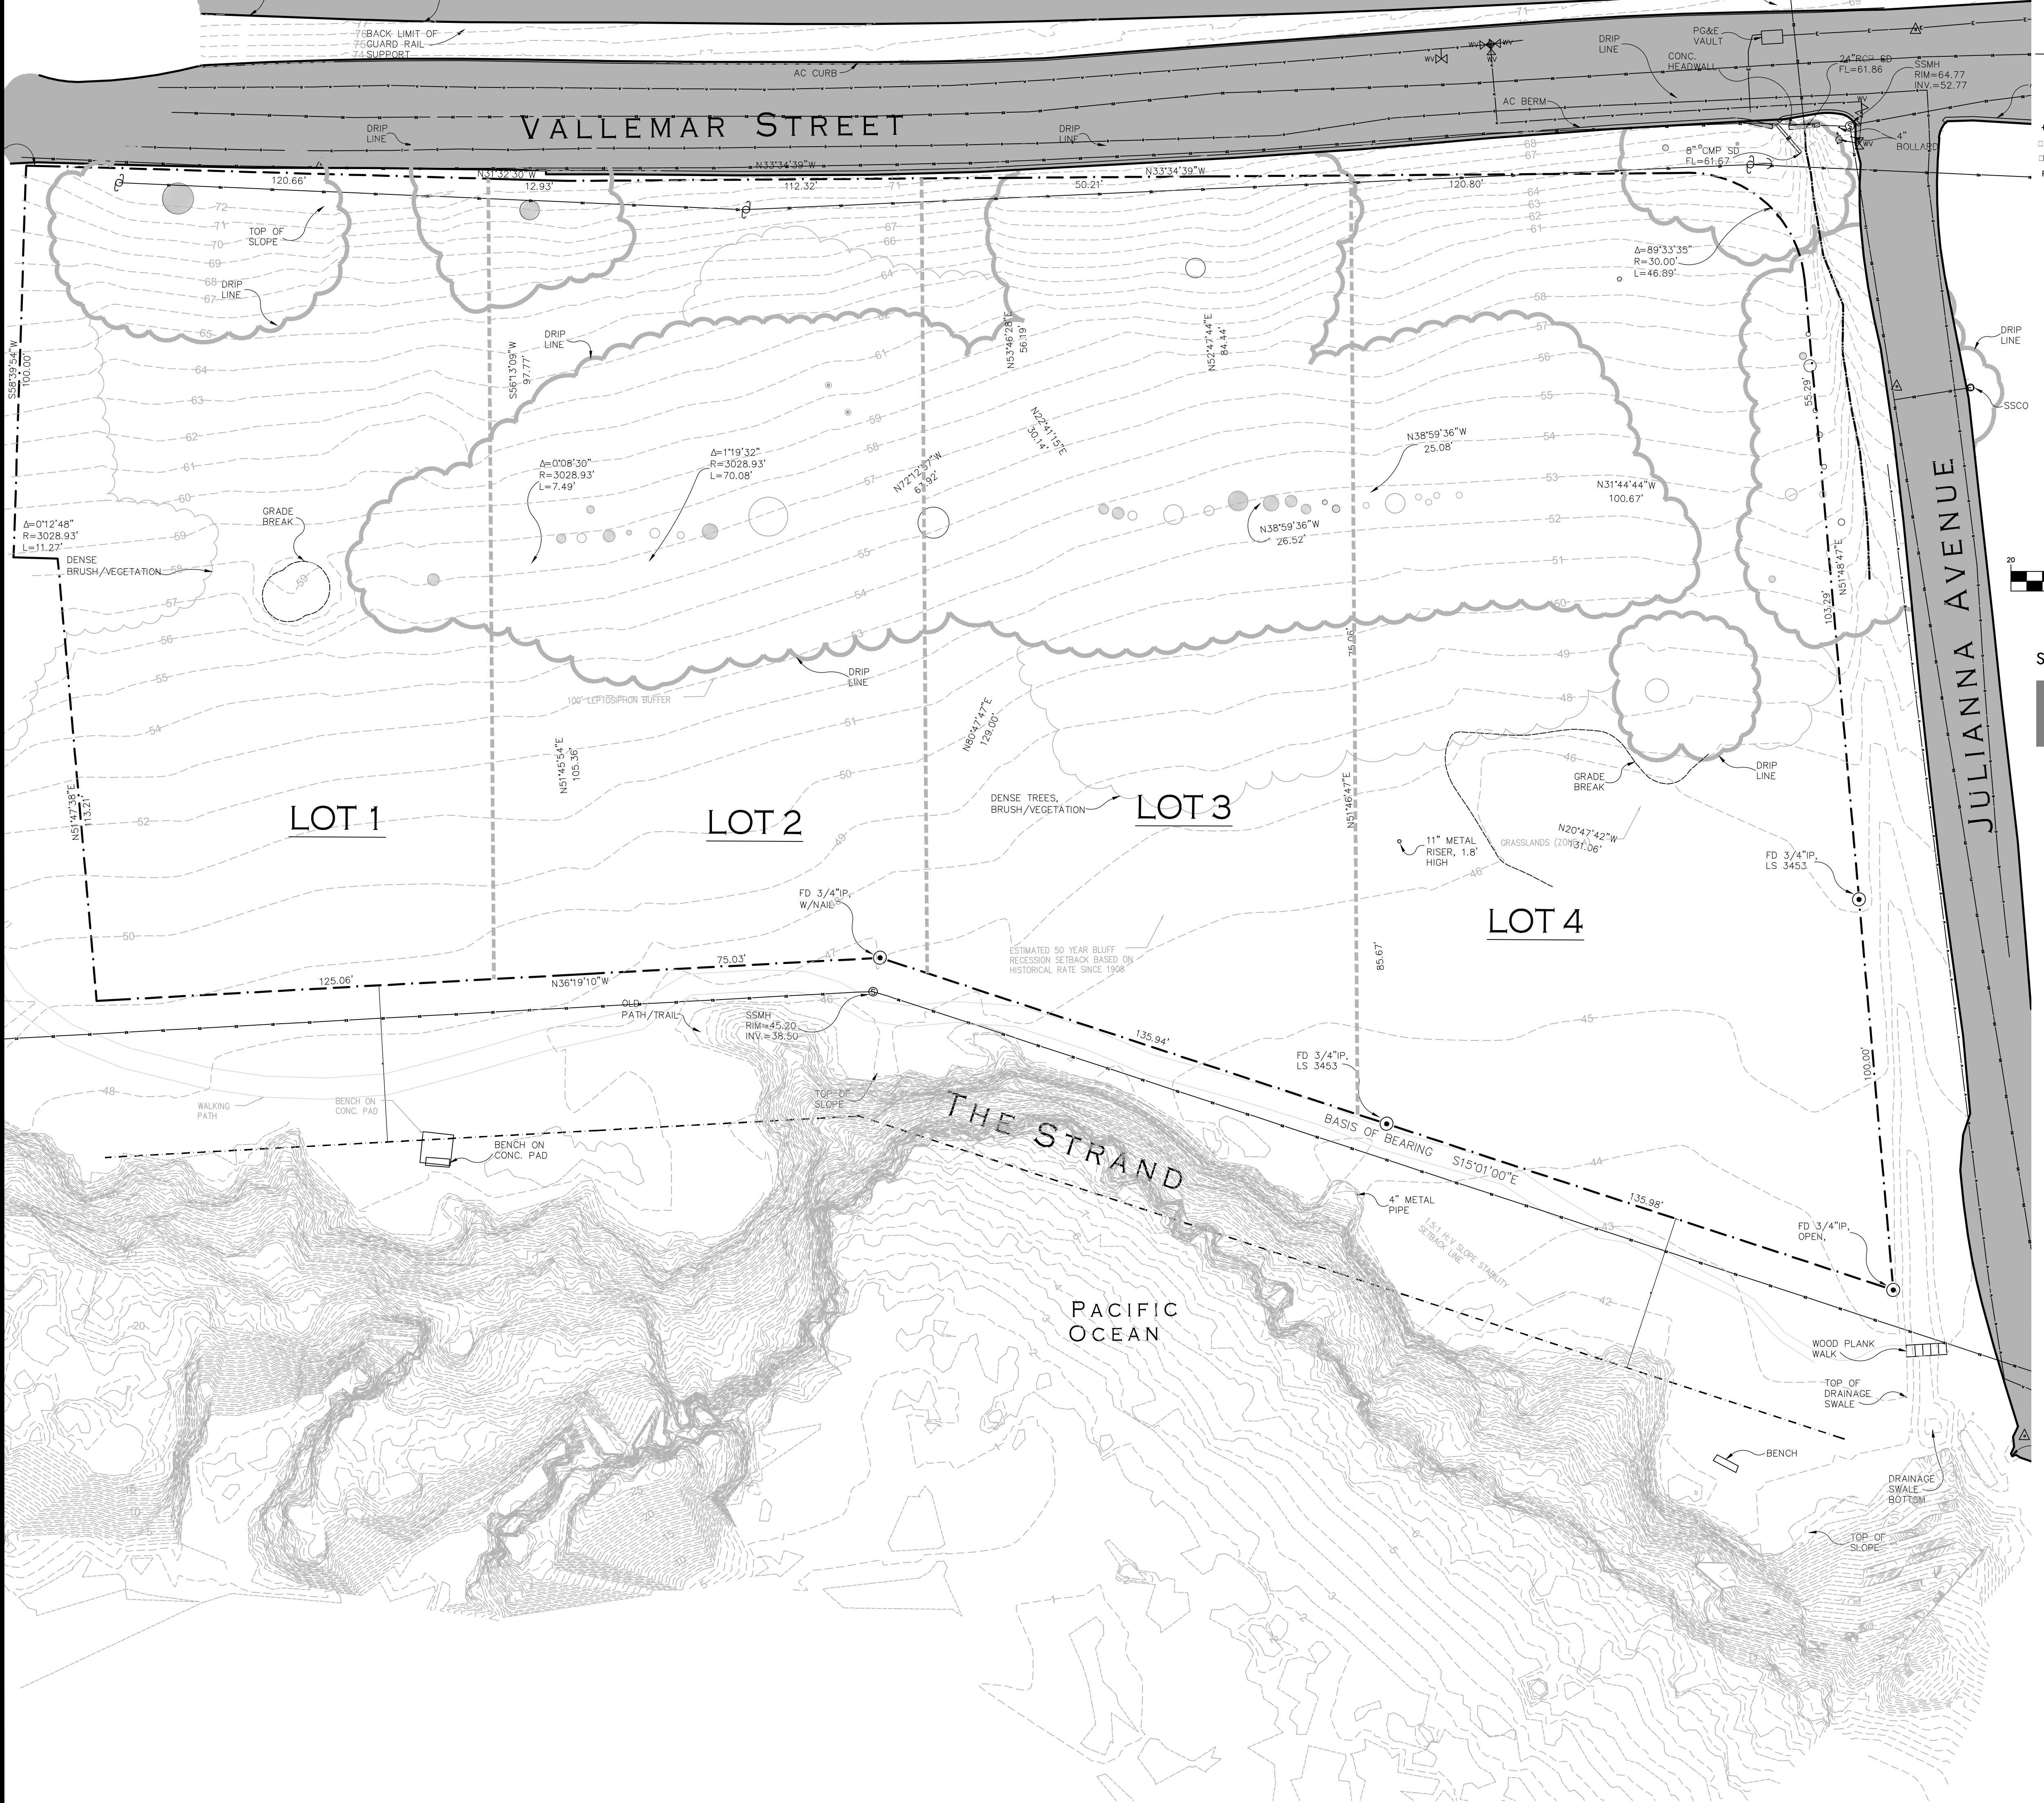

(IN FEET)
1 inch = 20 ft

SURVEY PERFORMED BY:

IFLAND SURVEY
Surveying - Mapping - GPS

303 Potrero Street, Suite 43-108, Santa Cruz, CA 95060
Tel 831.426.7941 Fax 831.426.6266

Basis of Bearings

The Basis of Bearings for this Survey is Set Between Monuments Found Along the North-East Line of The Strand as Shown on the Record of Survey Filed in Volume 13 of the San Mateo County Records.

Basis of Bearings = S 15°01'00" E

Benchmark

N.S. EN. MAR. S 124°21'27" PASS DIS STAM ED "S 124°21'23" SET IN THE CONCRETE
EAD ALL O. A 24° 1'E ON THE SOUT-EAST END AT THE INTERSECTION OF
STATE HIGHWAY 1 AND ELDORO STREET.

CONCRETE ELEVATION NAVD 1988

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EXISTING CONDITIONS PLAN

MOSS BEACH OCEAN DEVELOPMENT

VALLEMAR ST. & JULIANA AVE MOSS BEACH, CA

SUBMITTAL DATE
DESIGN REVIEW APPLICATION 08/21/15
DESIGN REVIEW RESUBMITTAL 08/09/16

NO. REVISIONS DATE
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08/23/17 AS SHOWN


PROJ. NO. 1500600-1668

SHEET NO.

L2.1

OF SHEETS

EXISTING CONDITIONS PLAN

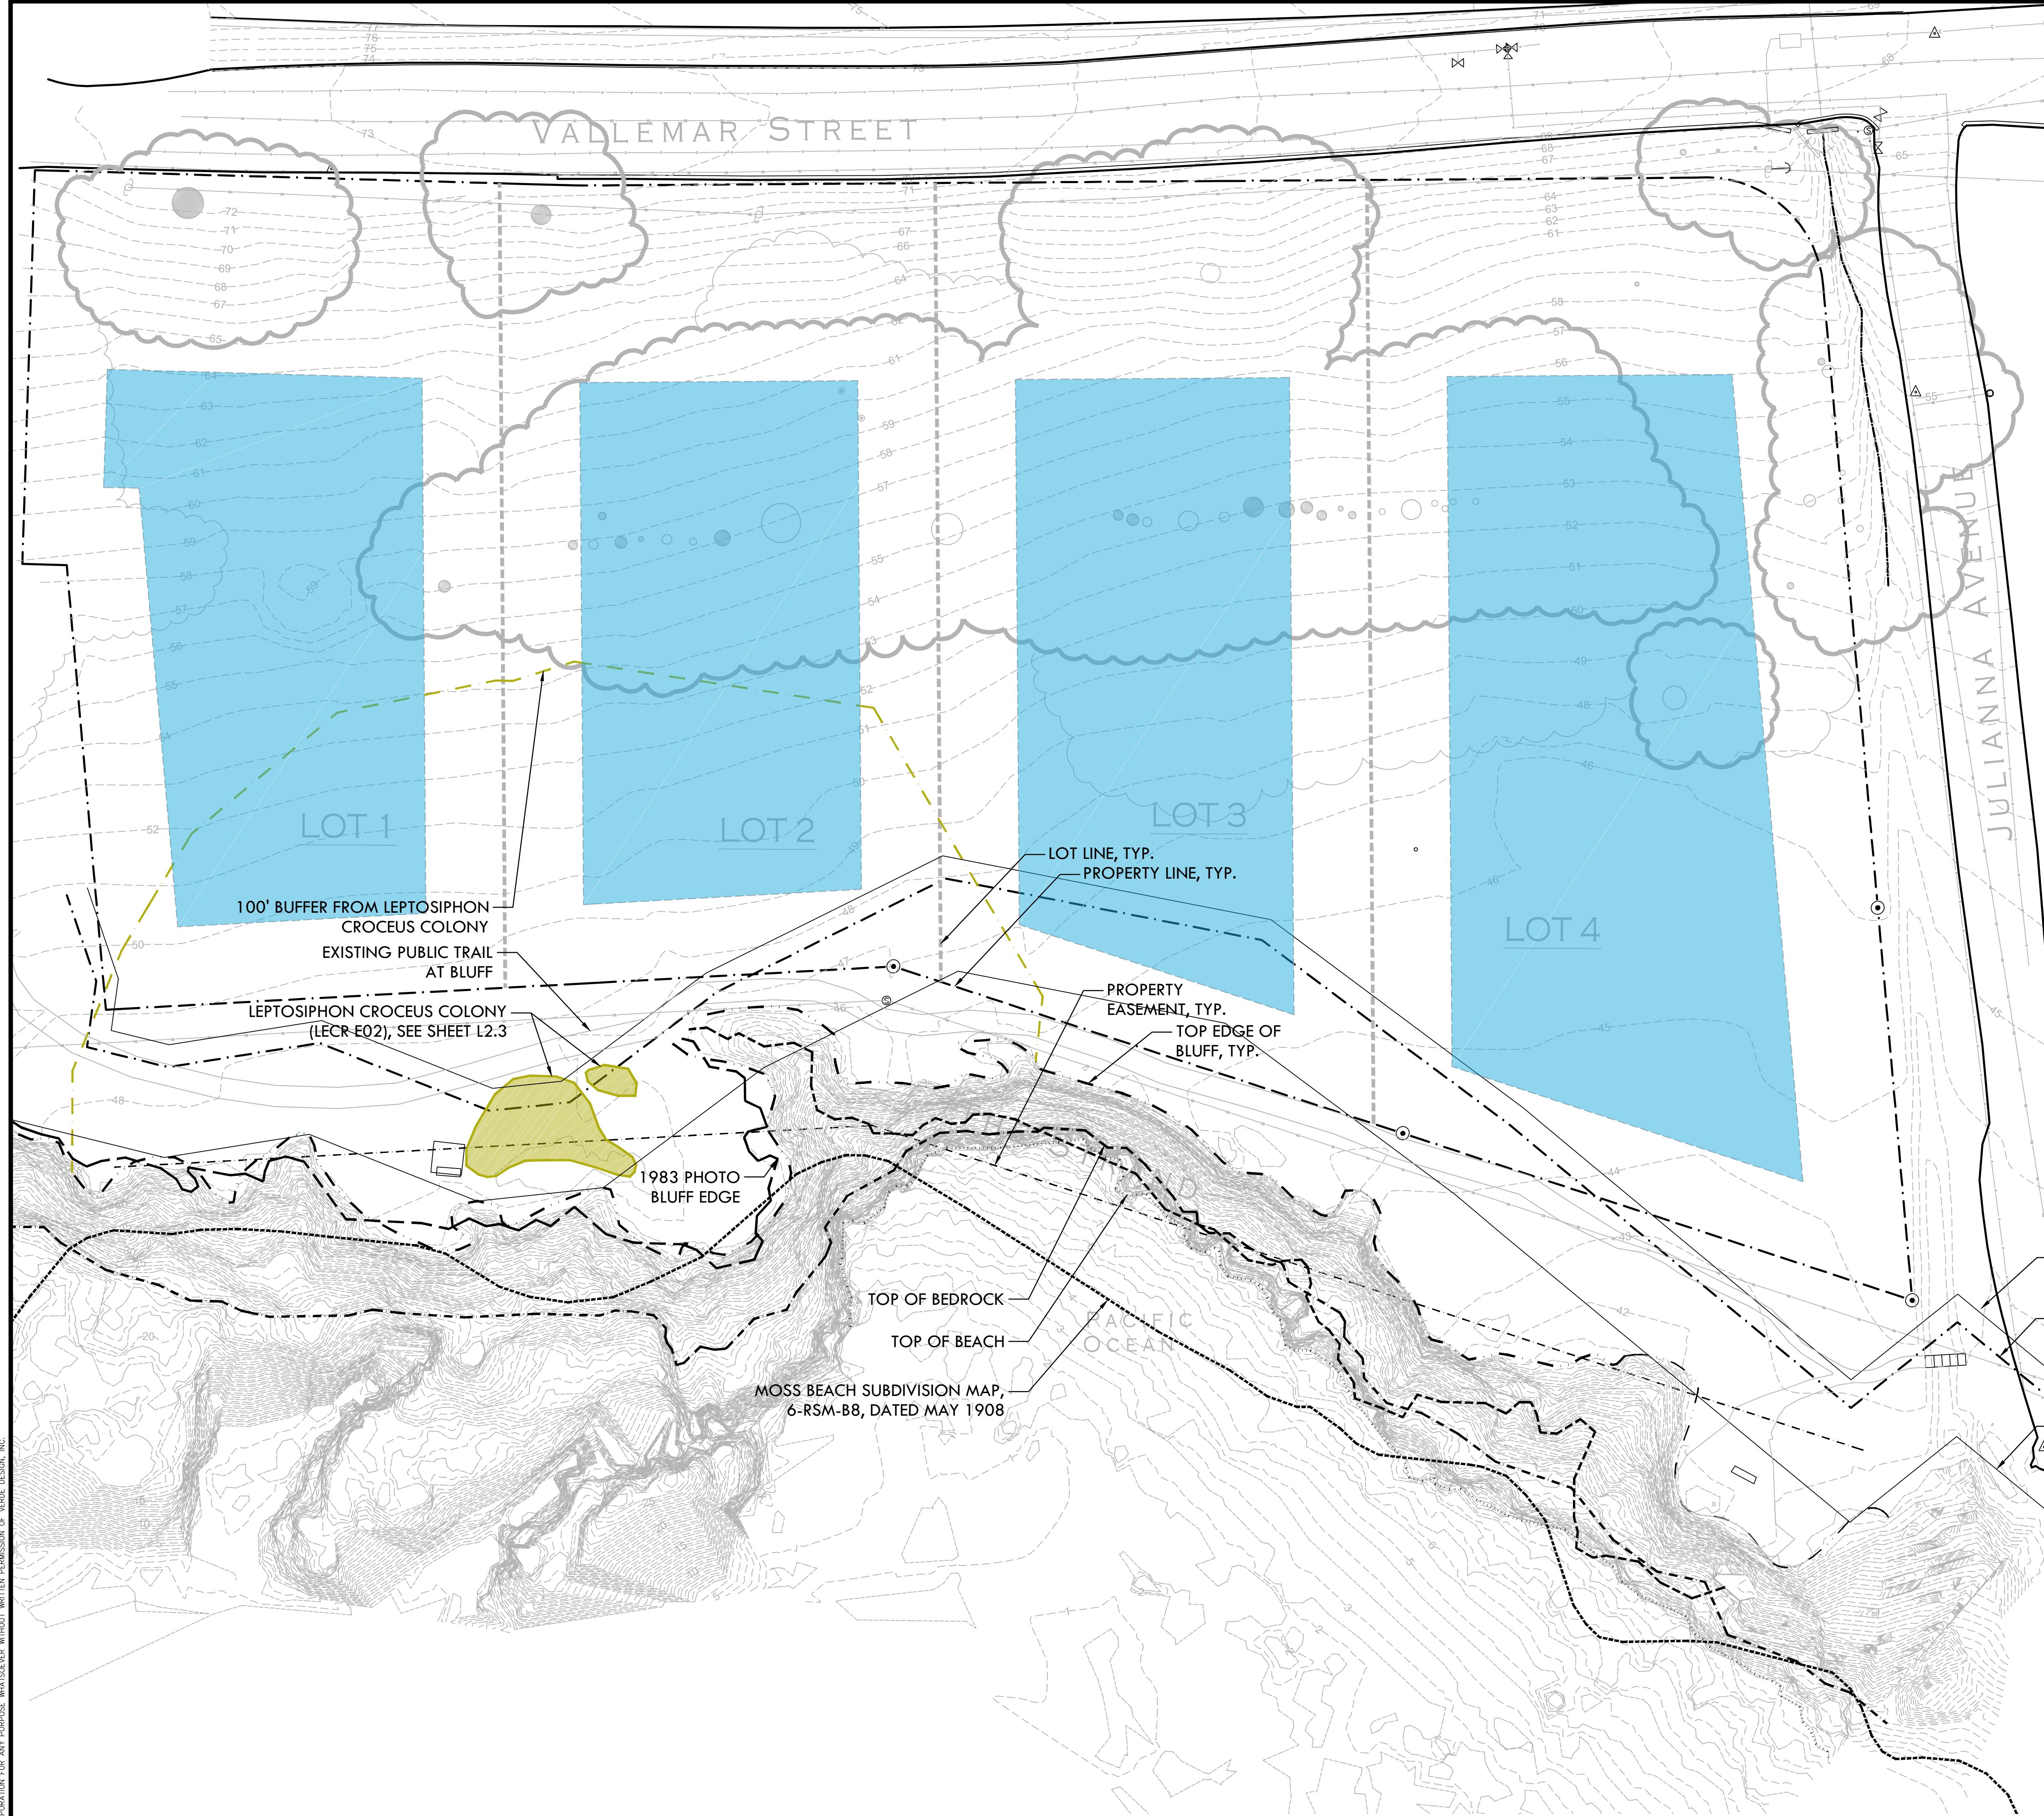

SITE PLAN LEGEND	
SYMBOL	DESCRIPTION
Dashed line	TOP EDGE OF BLUFF
Dashed line	TOP OF BEDROCK
Dashed line	1983 BLUFF EDGE
Dotted line	TOP OF BEACH
Dotted line	MOSS BEACH HEIGHTS SUBDIVISION MAP 6-RSM-B8, DATED MAY 1908
Blue shaded area	PROPOSED BUILDING ENVELOPE



CONSULTANT

SHEET TITLE
SITE CONSTRAINTS PLAN

PROJECT NAME
MOSS BEACH OCEAN DEVELOPMENT

PROJECT ADDRESS
VALLEMAR ST. & JULIANA AVE MOSS BEACH, CA

SUBMITTAL	DATE
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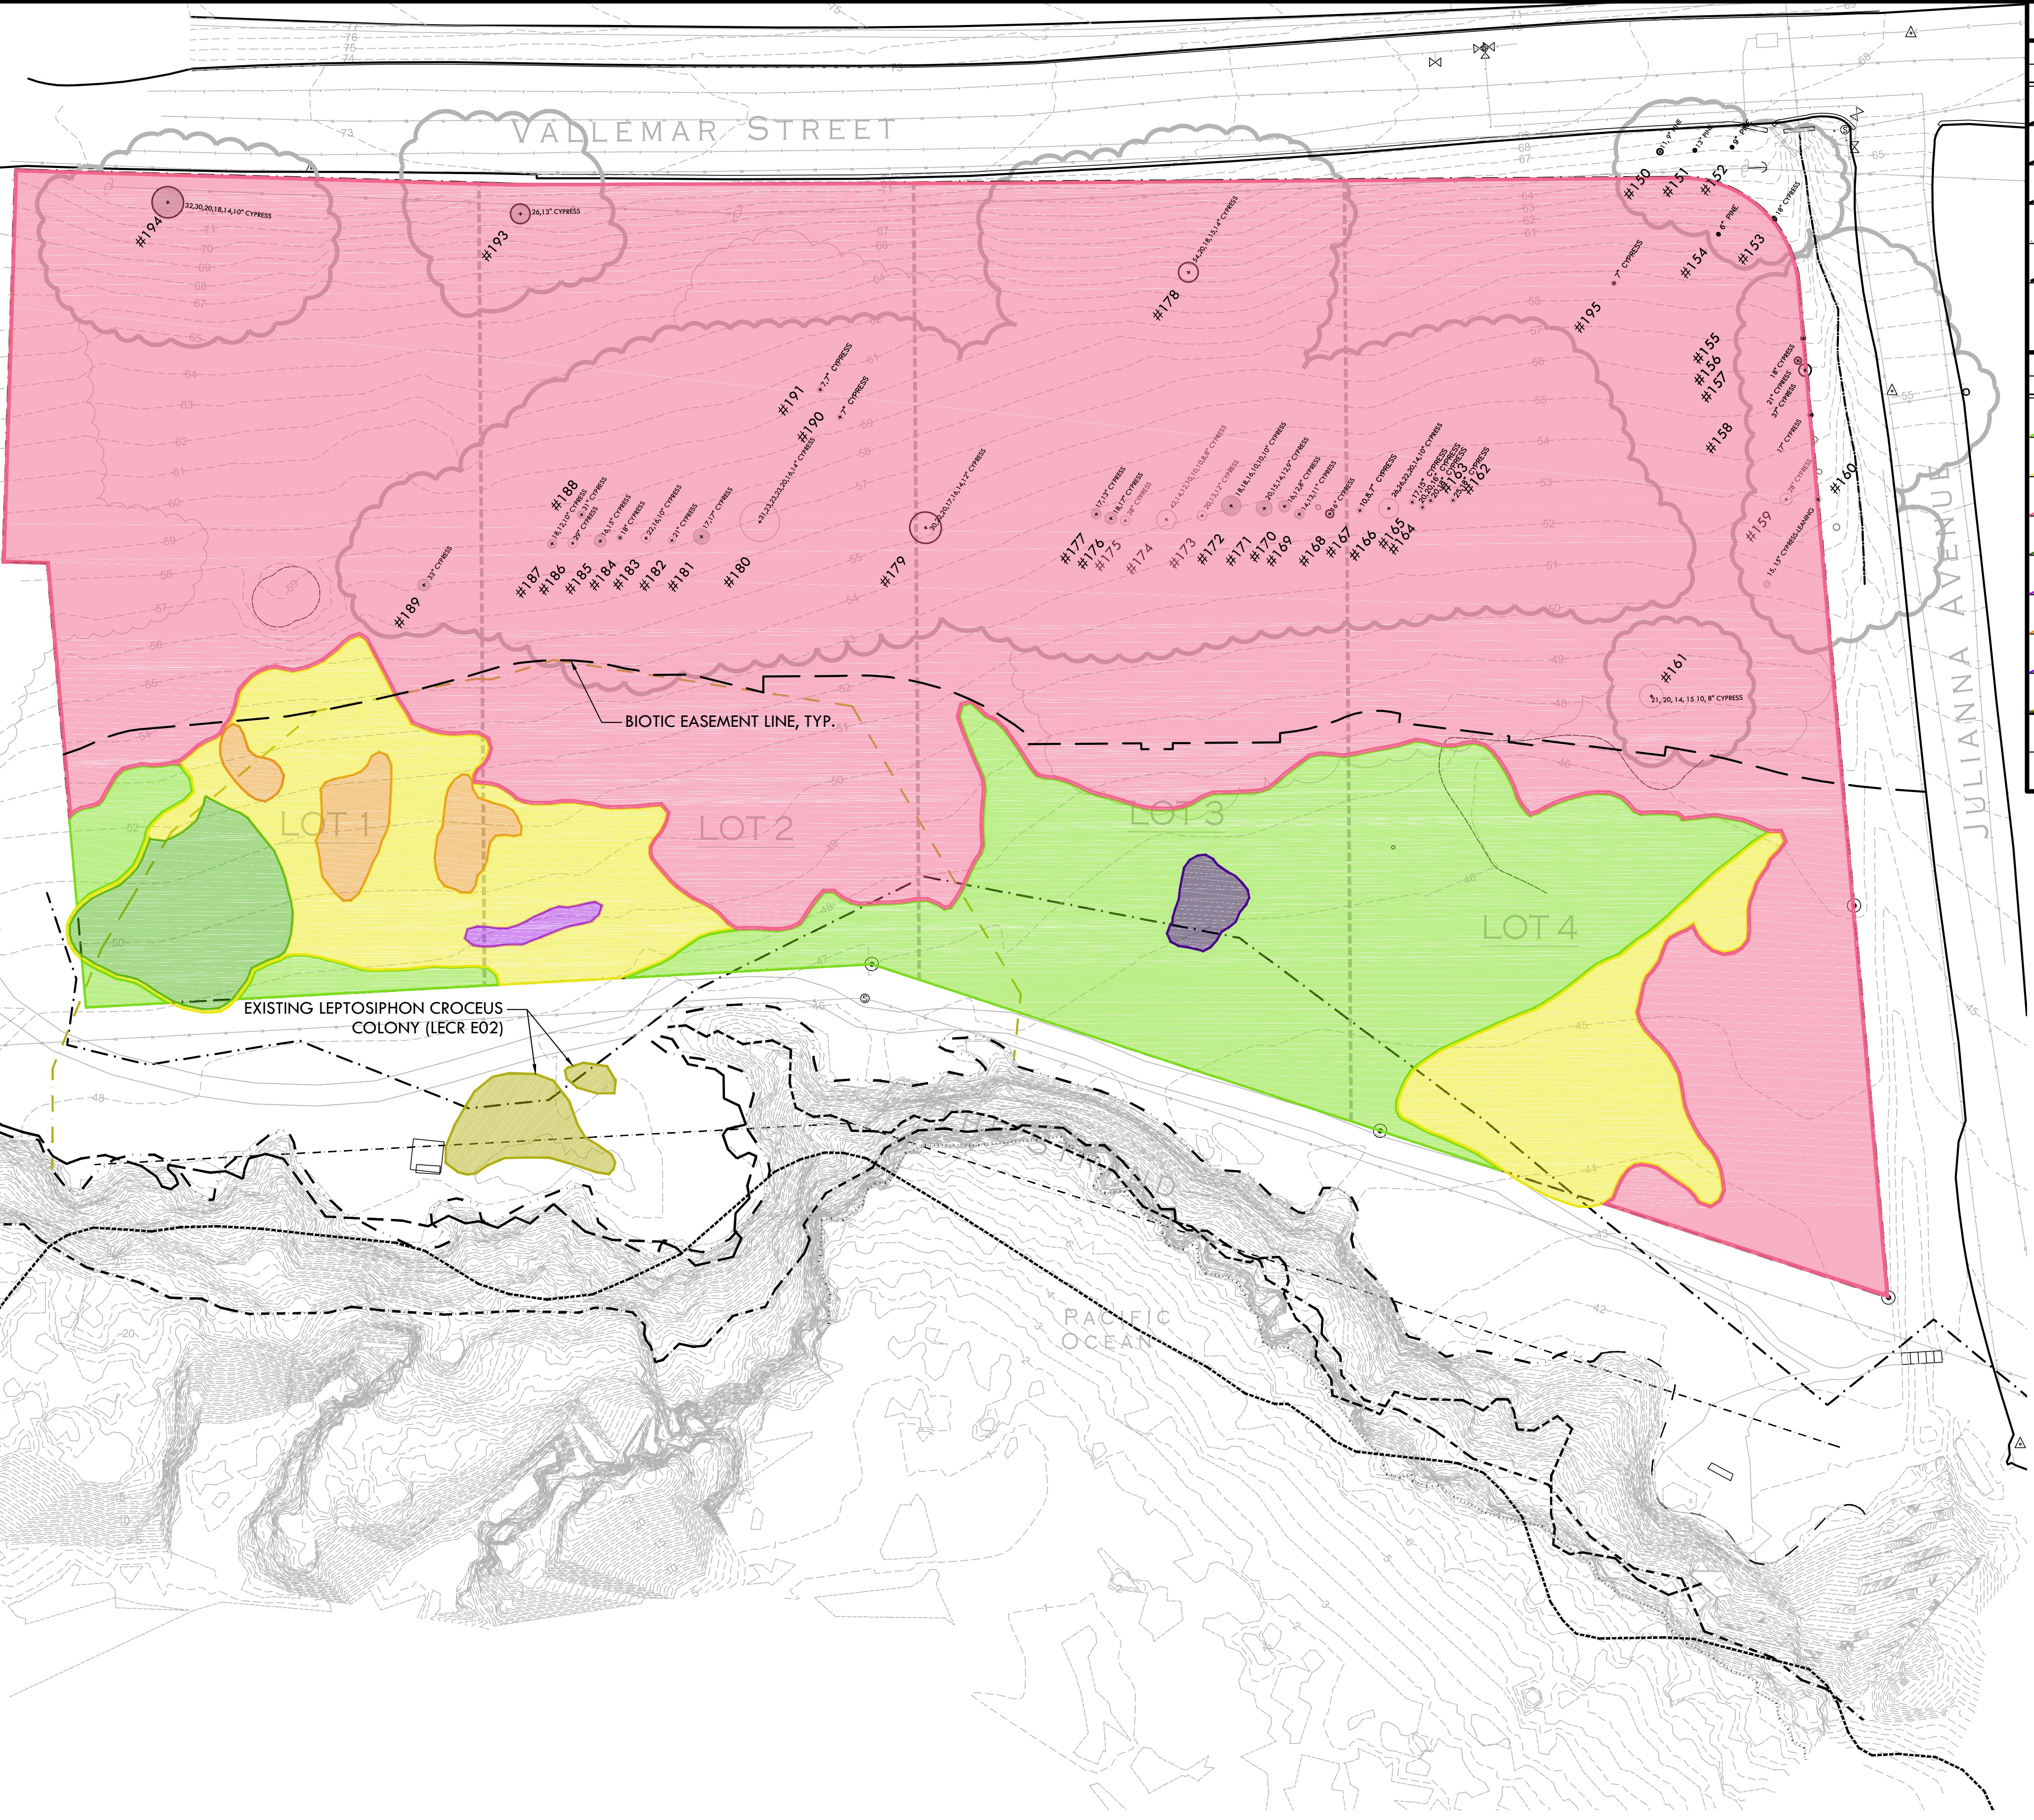
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PROJ. NO. 1500600-1668

SHEET NO. L2.2 OF SHEETS

SITE CONSTRAINTS PLAN



SITE PLAN LEGEND

SYMBOL	DESCRIPTION
- - - - -	TOP EDGE OF BLUFF
- - - - -	TOP OF BEDROCK
- - - - -	1983 BLUFF EDGE
- - - - -	TOP OF BEACH
- - - - -	MOSS BEACH HEIGHTS SUBDIVISION MAP 6-RSM-8B, DATED MAY 1908

EXISTING TREES AND VEGETATION TYPES LEGEND

SYMBOL	DESCRIPTION
ZONE A - COASTAL PRAIRIE GRASSLAND	
ZONE B - TRANSITIONAL AREA	
ZONE C - NON-NATIVE VEGETATION	
ICEPLANT MAT	
DESCHAMPSIA-DOMINATED AREA	
DANTHONIA-DOMINATED AREA	
BEECH STRAWBERRY	
LEPTOSIPHON CROCEUS - LECR ELEMENT OCCURRENCE 02 PER CALIFORNIA NATIVE PLANT SOCIETY MEMORANDUM, 5/25/2016	
(C) 12" CYPRESS	EXISTING TREE, DIAMETER OF TRUNK(S) AND SPECIES TYPE
#174	TREE NO.



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EXISTING TREES AND VEGETATION

MOSS BEACH OCEAN DEVELOPMENT

VALLEMAR ST. & JULIANA AVE MOSS BEACH, CA

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L2.3
OF SHEETS

EXISTING TREES & VEGETATION



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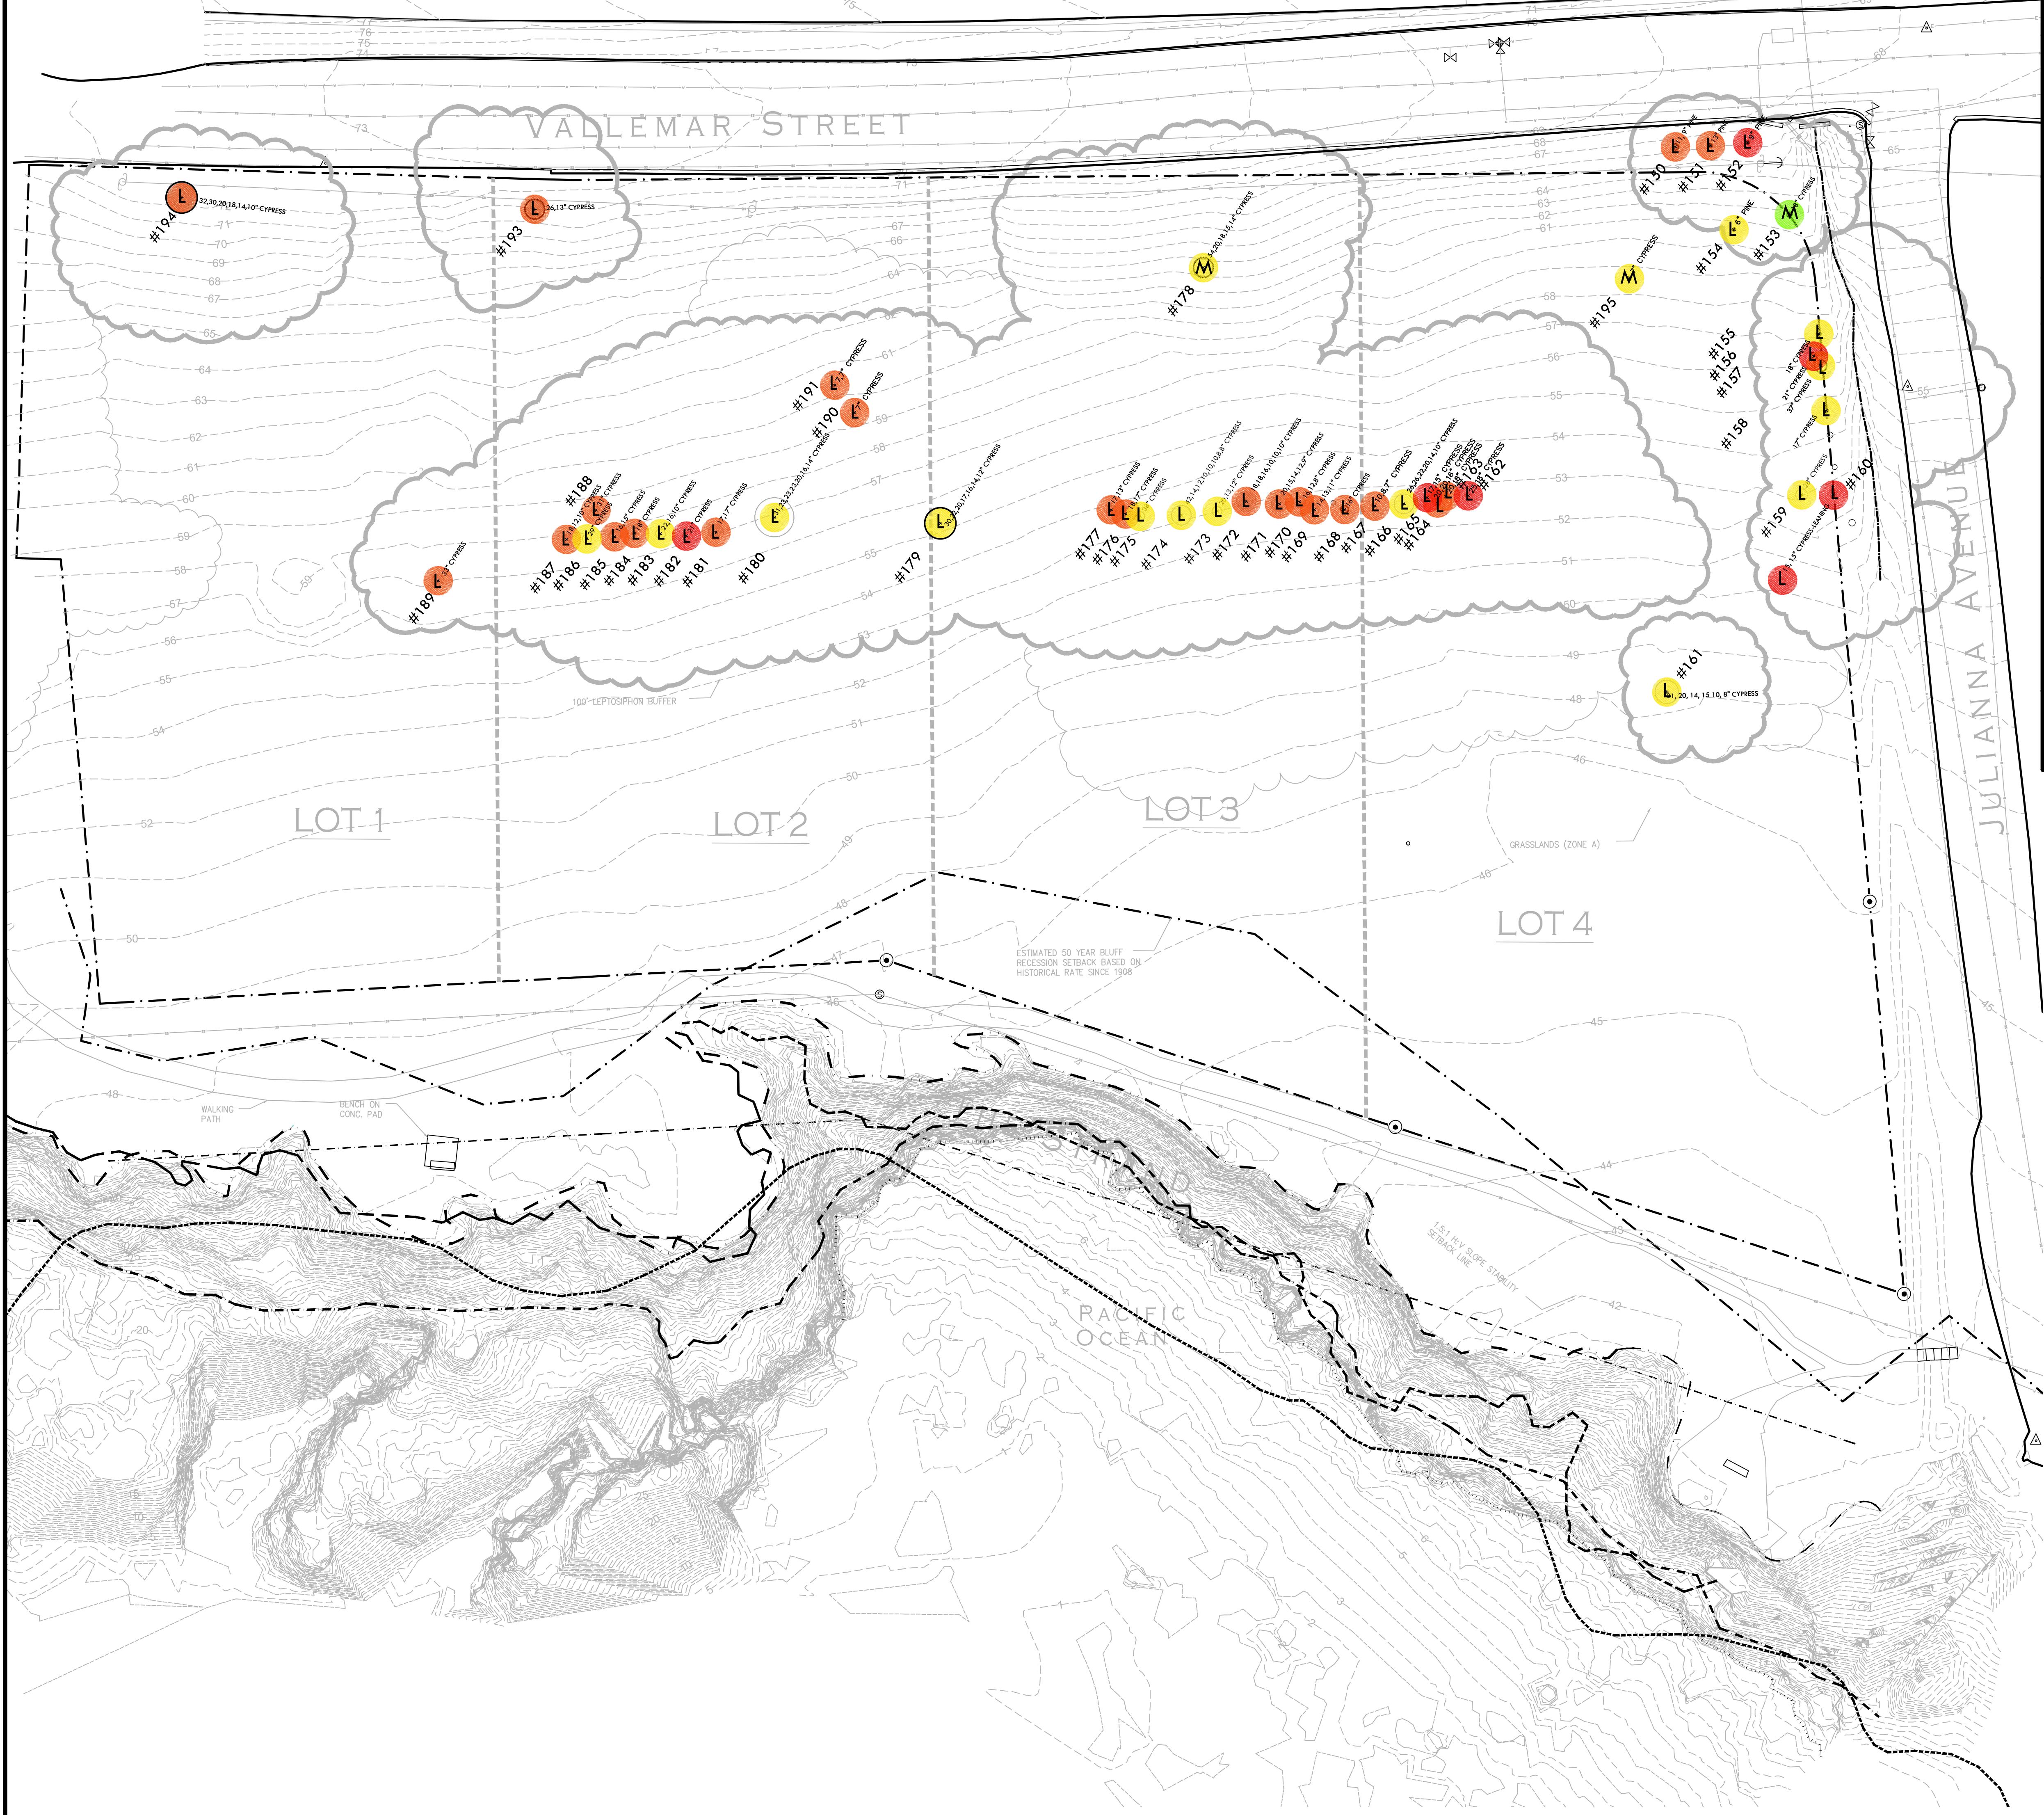
CONSULTANT

Tree Assessment

Juliana Avenue
Verde Design
Moss Beach CA
May 2015



Remove (Y/N)	TREE No.	SPECIES	TRUNK DIAMETER (in.)	STATUS?	CONDITION 1=poor 5=excell.	SUITABILITY for PRESERVATION	COMMENTS	Remove (Y/N)	TREE No.	SPECIES	TRUNK DIAMETER (in.)	STATUS?	CONDITION 1=poor 5=excell.	SUITABILITY for PRESERVATION	COMMENTS
N	150	Monterey pine	11,9	Significant	2	Low	Codominant trunks @ 1' with poor attachment; topped for overhead electrical lines.	Y	181	Monterey cypress	17,17	Significant	2	Low	Codominant trunks @ 3'; both lean S. & SW; with small high crowns; 17" on SE, with 2 additional sets of codominant trunks. Poor form & structure; collapsing.
N	151	Monterey pine	13	Significant	2	Low	Small crook @ 5'; topped for overhead electrical lines.	Y	182	Monterey cypress	21	Significant	1	Low	2 stems on W, generally vertical with small high crowns; stem on E, leans sharply & is poor.
N	152	Monterey cypress	9	--	1	Low	Failed @ base; on-ground but alive.	Y	183	Monterey cypress	22,16,10	Significant	3	Low	Multiple attachments @ 4'; 22" codominant again @ 6'; 2 stems on W, generally vertical with small high crowns; stem on E, leans sharply & is poor.
N	153	Monterey cypress	18	Significant	4	Moderate	Lost central leader @ 20' due to topping; otherwise okay.	Y	184	Monterey cypress	18	Significant	2	Low	Poor form & structure; multiple attachments @ 10'; 1 stem vertical with very small high crown; 2 stems bowed flat to SW.
N	154	Monterey cypress	6	--	3	Low	Suppressed by #153; one-sided to N.	Y	185	Monterey cypress	16, 15	Significant	2	Low	Codominant trunks @ 1'; both stems leaning & one-sided to SW, with small crowns.
N	155	Monterey cypress	18	Significant	3	Low	Suppressed; codominant trunks @ 8'; larger stem flat-topped to SE; 2nd stem flat to NW, with numerous broken branches.	Y	186	Monterey cypress	29	Significant	3	Low	One-sided to the W; heavy lateral limb low to SW.
N	156	Monterey cypress	21	Significant	1	Low	Poor form & structure; leaning & one-sided to N; series of branch failures; may be dead.	Y	187	Monterey cypress	18,12,10	Significant	2	Low	Codominant trunks @ 3' & 5'; 18" stem vertical but suppressed with rangy form; 12" a long stub on N; 10" poor on W.
N	157	Monterey cypress	37	Significant	3	Low	Leans S.; codominant trunks @ 4'; 1 stem dominates; leaned & bowed flat to SE; 2nd stem suppressed & poor.	Y	188	Monterey cypress	31	Significant	2	Low	Leans SE, with some correction; base of trunk largely outside of dripline; codominant trunks @ 8'; flat-topped; low branches lay along ground.
N	158	Monterey cypress	17	Significant	3	Low	Partly corrected lean SE; base basically outside dripline; small narrow crown; lost central leader.	Y	189	Monterey cypress	33	Significant	2	Low	Poor form & structure; leaning & bowed SE; lost central leader; most of canopy to NW.
Y	159	Monterey cypress	28	Significant	3	Low	Codominant trunks @ 8'; stem on S, dominates & flat-topped; stem on N, failed, leaving mass of dead, dying & broken branches.	Y	190	Monterey cypress	7	--	2	Low	Leans E, with base outside of dripline.
Y	160	Monterey cypress	15,15	Significant	1	Low	Failed @ base to W; on-ground but alive; codominant trunks @ 3'; sweeps upright @ tips.	Y	191	Monterey cypress	7, 7	--	2	Low	Poor form & structure; codominant trunks @ 1'; widely separated; 1 stem vertical; 2nd stem leans E.
Y	161	Monterey cypress	21,20,14,15,10, 8	Significant	3	Low	Multiple attachments @ base; one-sided to S; all stems lean to varying degrees; canopy on ground on 3 additional stems on ground;	N/A	192	Tag not used	--	--	--	--	--
Y	162	Monterey cypress	25,18	Significant	1	Low	codominant trunks @ 3'; both lean & are suppressed to the S.; flat-topped; lost central leaders	N	193	Monterey cypress	26, 13	Yes	2	Low	Codominant trunks @ base; several low branches to W, x'd; 3rd stem on N, @ base is dead; topped for overhead electrical lines; numerous dead branches & branch failures; 14" stem leans E.
Y	163	Monterey cypress	20,18	Significant	1	Low	Codominant trunks @ 1'; crowded; suppressed; flat-topped.	N	194	Monterey cypress	32, 30, 20, 18 14, 10	Yes	2	Low	Multiple attachments @ base; E, side of crown topped (20,18,14" stems); W, side of crown dense (32,30" stems).
Y	164	Monterey cypress	20, 20, 16	Significant	2	Low	Multiple attachments @ base; one-sided & bowed S; small gap in canopy to #165; overtops & collapse #162 & 163; 28" on E, & 20" on W, cracked & failing.	Y	195	Monterey cypress	7	--	3	Moderate	Narrow spindly crown.
Y	165	Monterey cypress	17,15	Significant	1	Low	Codominant trunks @ 1'; 17" bowed E, & failed @ 14"; 15" bowed flat to S.								
Y	166	Monterey cypress	26,26,22,20,14,	Significant	3	Low	Multiple attachments @ base to 5'; stems are squeezed @ attachment & twisted; 2 stems bowed flat to W, others vertical; numerous branch failures.								
Y	167	Monterey cypress	10,8,7	Significant	2	Low	Codominant trunks @ 2' & 4'; totally suppressed; bowed flat to S.								
N	168	Monterey cypress	16	Significant	2	Low	Codominant trunks @ 8'; stems separated; E, stem failed; W, stem small & crowded; low branches removed.								
Y	169	Monterey cypress	14, 13, 11	Significant	2	Low	Multiple attachments @ base; 14" bowed flat to W; 13" & 11" more vertical; very crowded.								
Y	170	Monterey cypress	16,12,8	Significant	2	Low	Multiple attachments @ 1'; 16" leans E, with small crown; 12" leans E, but failed mid-length; 8" leans SE, & is basically dead.								
Y	171	Monterey cypress	20, 15, 14, 12, 9	Significant	2	Low	Multiple attachments @ base & 1'; bowed SW; small canopy; heavy lateral limb.								
Y	172	Monterey cypress	18, 18, 16, 10, 10	Significant	2	Low	Multiple attachments @ 1'; mostly vertical with small canopy of foliage; 18" leans E, with base outside of dripline.								
Y	173	Monterey cypress	20, 13, 12	Significant	3	Low	Multiple attachments @ 3'; 20" vertical & dominant; both 12" stems suppressed.								
Y	174	Monterey cypress	42, 14, 12, 10, 10 8, 8	Significant	3	Low	Multiple attachments @ base & 1'; series of codominant attachments on 42" stem; 4 additional stems on ground to W; mix of vertical & leaning stems; high crown; 14" branch on W, hangs to ground.								
Y	175	Monterey cypress	38	Significant	3	Low	Measured @ 3'; 2 large heavy lateral branches cracked to W; main stem vertical with high crown; one-sided to W.								
Y	176	Monterey cypress	18, 17	Significant	2	Low	Codominant trunks @ 1'; 18" leans sharply to NE; 17" leans E, with small high crown.								
Y	177	Monterey cypress	17, 13	Significant	2	Low	Codominant trunks @ 3'; 17" leaning & one-sided to NE, with crook; 13" bowed N, with poor form.								
N	178	Monterey cypress	54, 20, 18, 15, 14	Significant	3	Moderate	54" stem codominant trunks @ 6, forming wide, flat-topped crown.								
N	179	Monterey cypress	30, 22, 20, 17	Significant	3	Low	Multiple attachments @ base; mostly vertical; 20" on S, leans; high crown.								
Y	180	Monterey cypress	31, 23, 23, 23, 20, 16, 14	Significant	3	Low	Multiple attachments @ base; mostly vertical; 16" leans sharply to S; 14" on E, sweeps vertical like a hazard beam; high crown; heavy lateral limb from 31" stem is poor.								




SITE PLAN LEGEND

SYMBOL	DESCRIPTION
- - -	TOP EDGE OF BLUFF
- - -	TOP OF BEDROCK
- - -	1983 BLUFF EDGE
- - -	TOP OF BEACH
- - -	MOSS BEACH HEIGHTS SUBDIVISION MAP 6-RSM-88, DATED MAY 1908
STAMP	VERDE DESIGN LANDSCAPE ARCHITECTURE CIVIL ENGINEERING SPORT PLANNING & DESIGN 2455 Th Alameda Santa Clara, CA 95050 tel: 408.985.7200 fax: 408.985.7260 www.VerdeDesignInc.com
CONSULTANT	MARK S. BAGINSKI No. 4089 Signature EXPIRATION DATE JULY 2019 REGISTERED LANDSCAPE ARCHITECT STATE OF CALIFORNIA

TREE HEALTH/SUITABILITY LEGEND

SYMBOL	TREE HEALTH	QUANTITY
1 (POOR)	6	
2	22	
3	16	
4	1	
5 (EXCELLENT)	0	
SYMBOL	SUITABILITY FOR PRESERVATION	QUANTITY
L	LOW	42
M	MODERATE	3
○ 128" CYPRESS	EXISTING TREE, DIAMETER OF TRUNK(S) AND SPECIES TYPE	
#174	TREE NO.	

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TREE HEALTH AND SUITABILITY FOR PRESERVATION

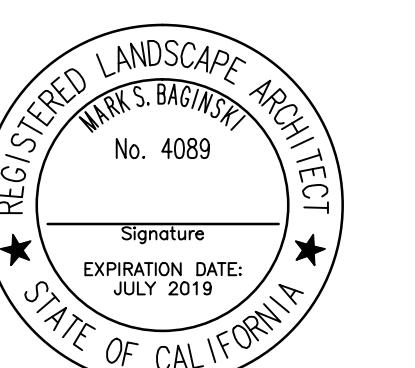PROJECT NAME
MOSS BEACH OCEAN DEVELOPMENT

PROJECT ADDRESS
VALLEMAR ST. & JULIANA AVE MOSS BEACH, CA

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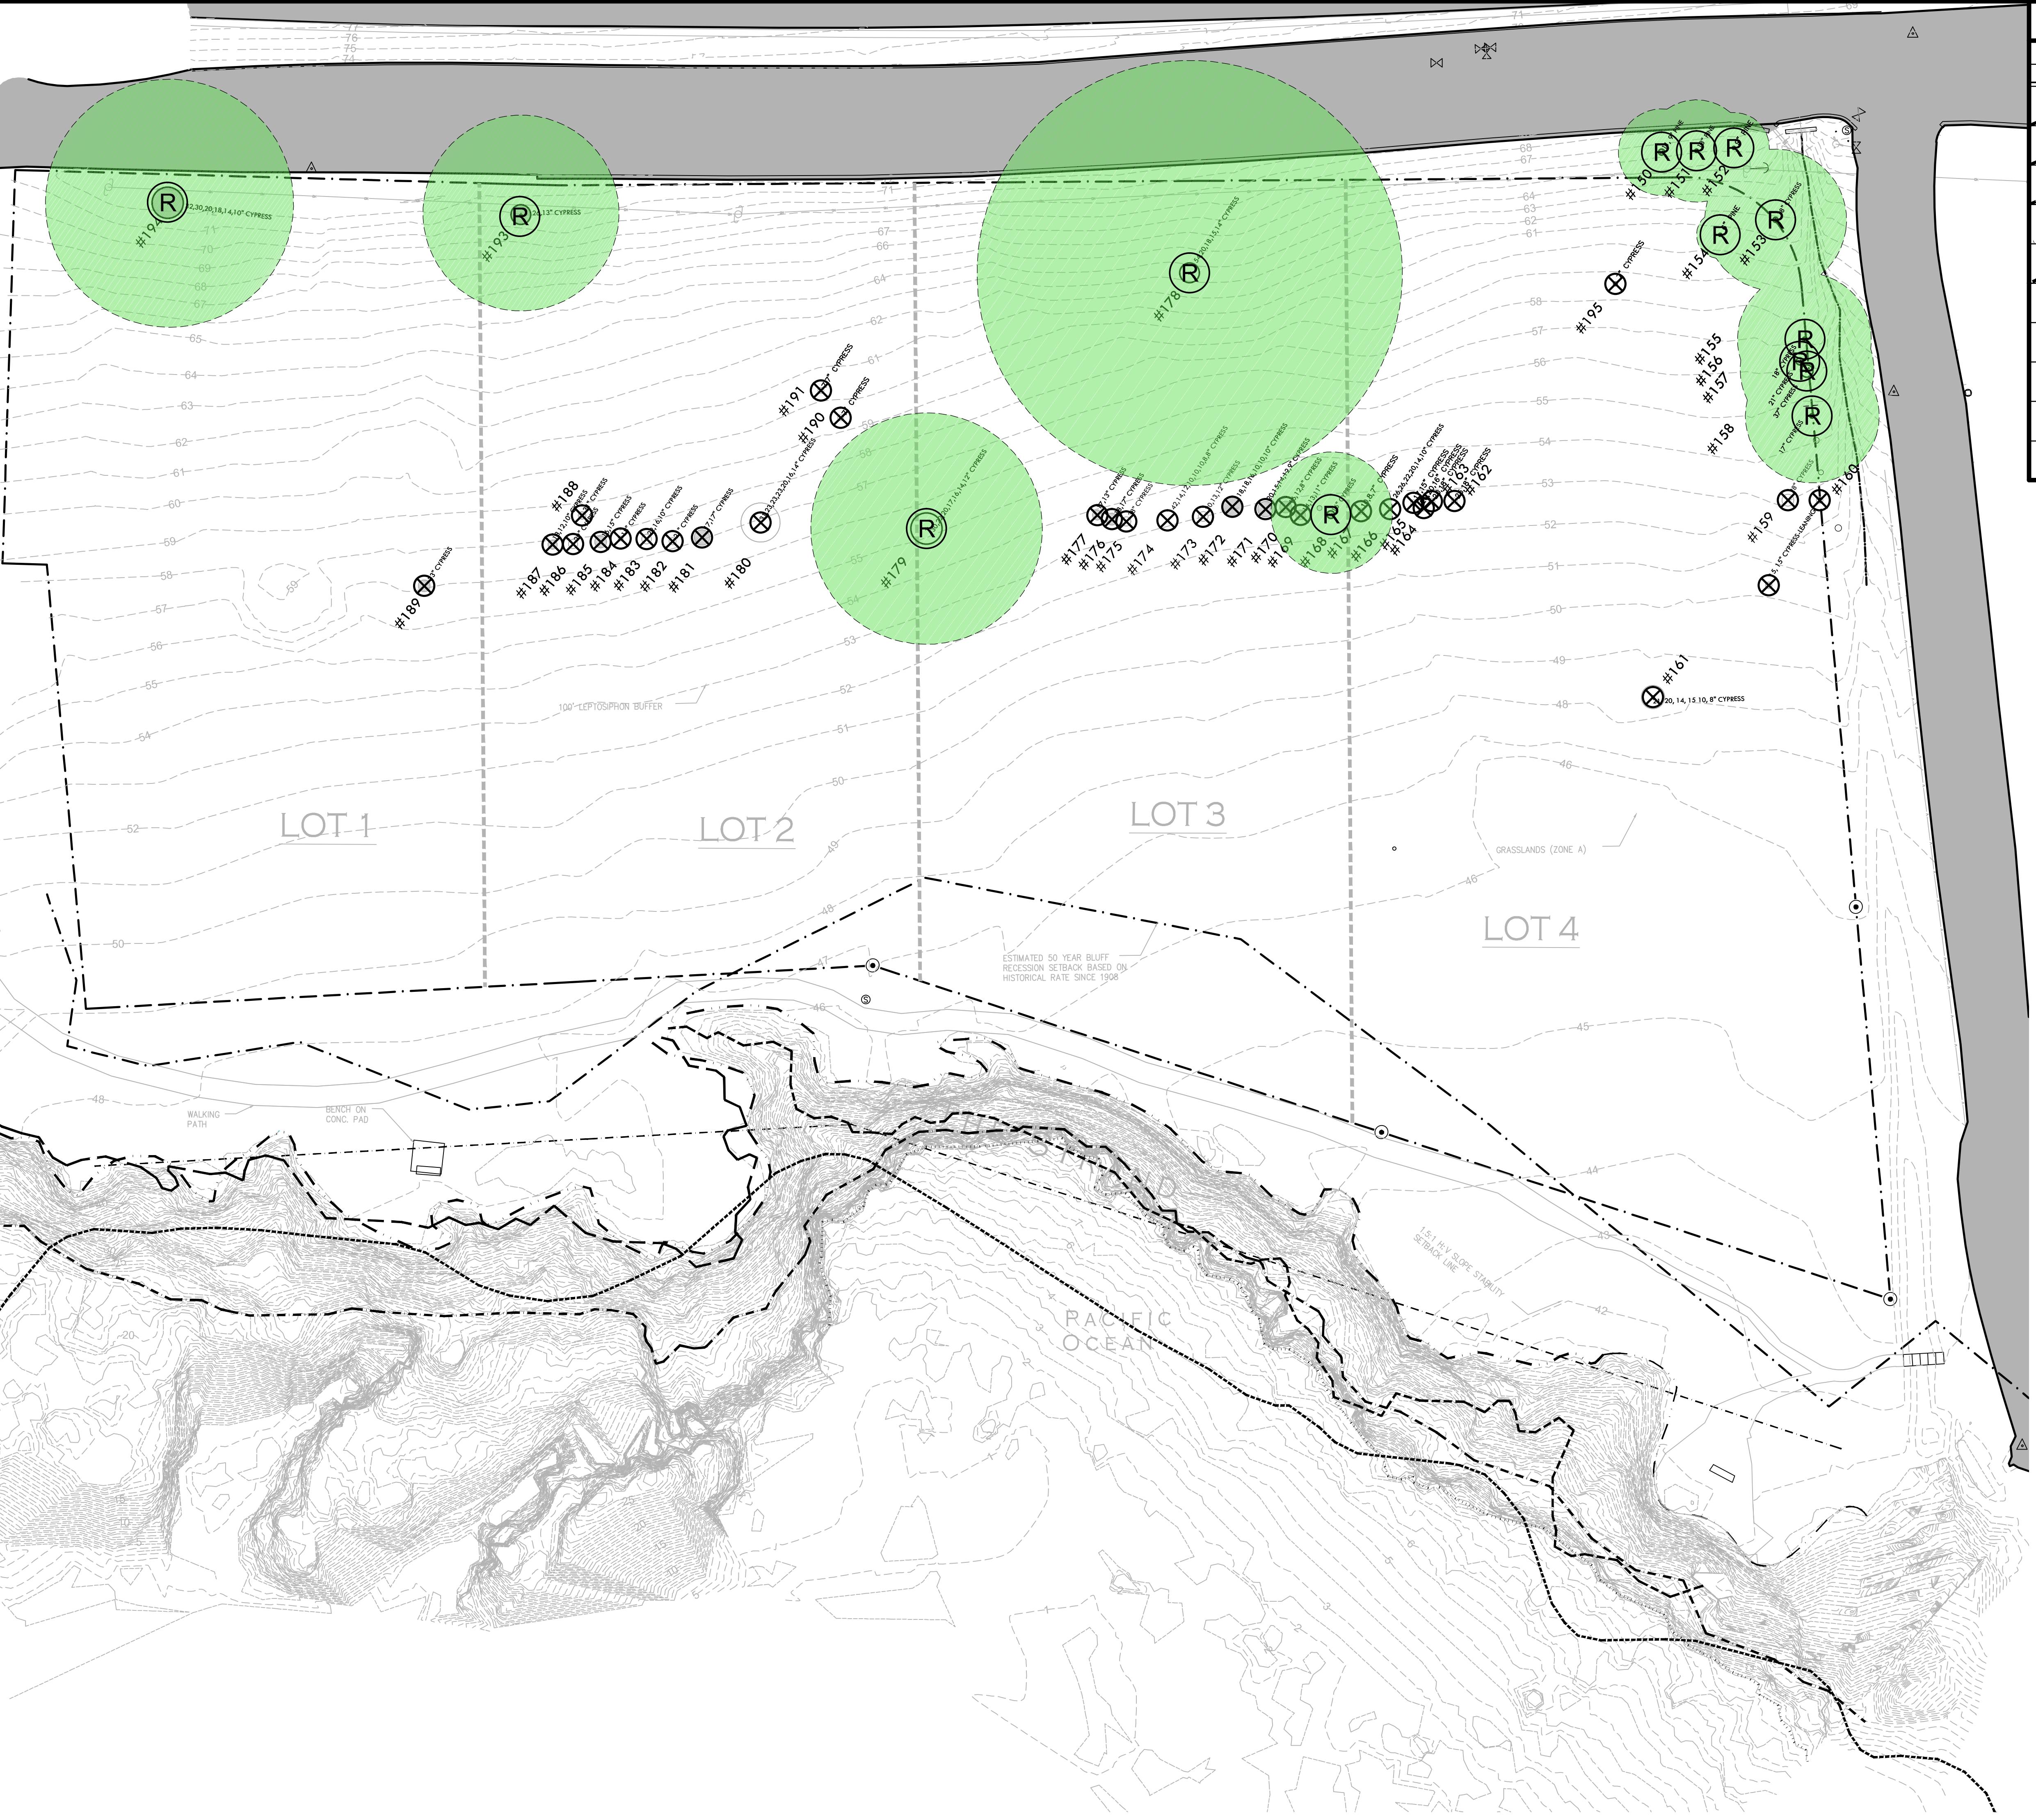
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SHEET NO.

L2.5 OF SHEETS

TREE HEALTH AND SUITABILITY FOR PRESERVATION



SITE PLAN LEGEND

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REGISTERED LANDSCAPE ARCHITECT
MARK S. BAGINSKI
No. 4089
Signature
EXPIRATION DATE
JULY 2019
STATE OF CALIFORNIA

CONSULTANT

SHEET TITLE
TREE REMOVAL PLAN

PROJECT NAME
MOSS BEACH OCEAN DEVELOPMENT

PROJECT ADDRESS
VALLEMAR ST. & JULIANA AVE MOSS BEACH, CA

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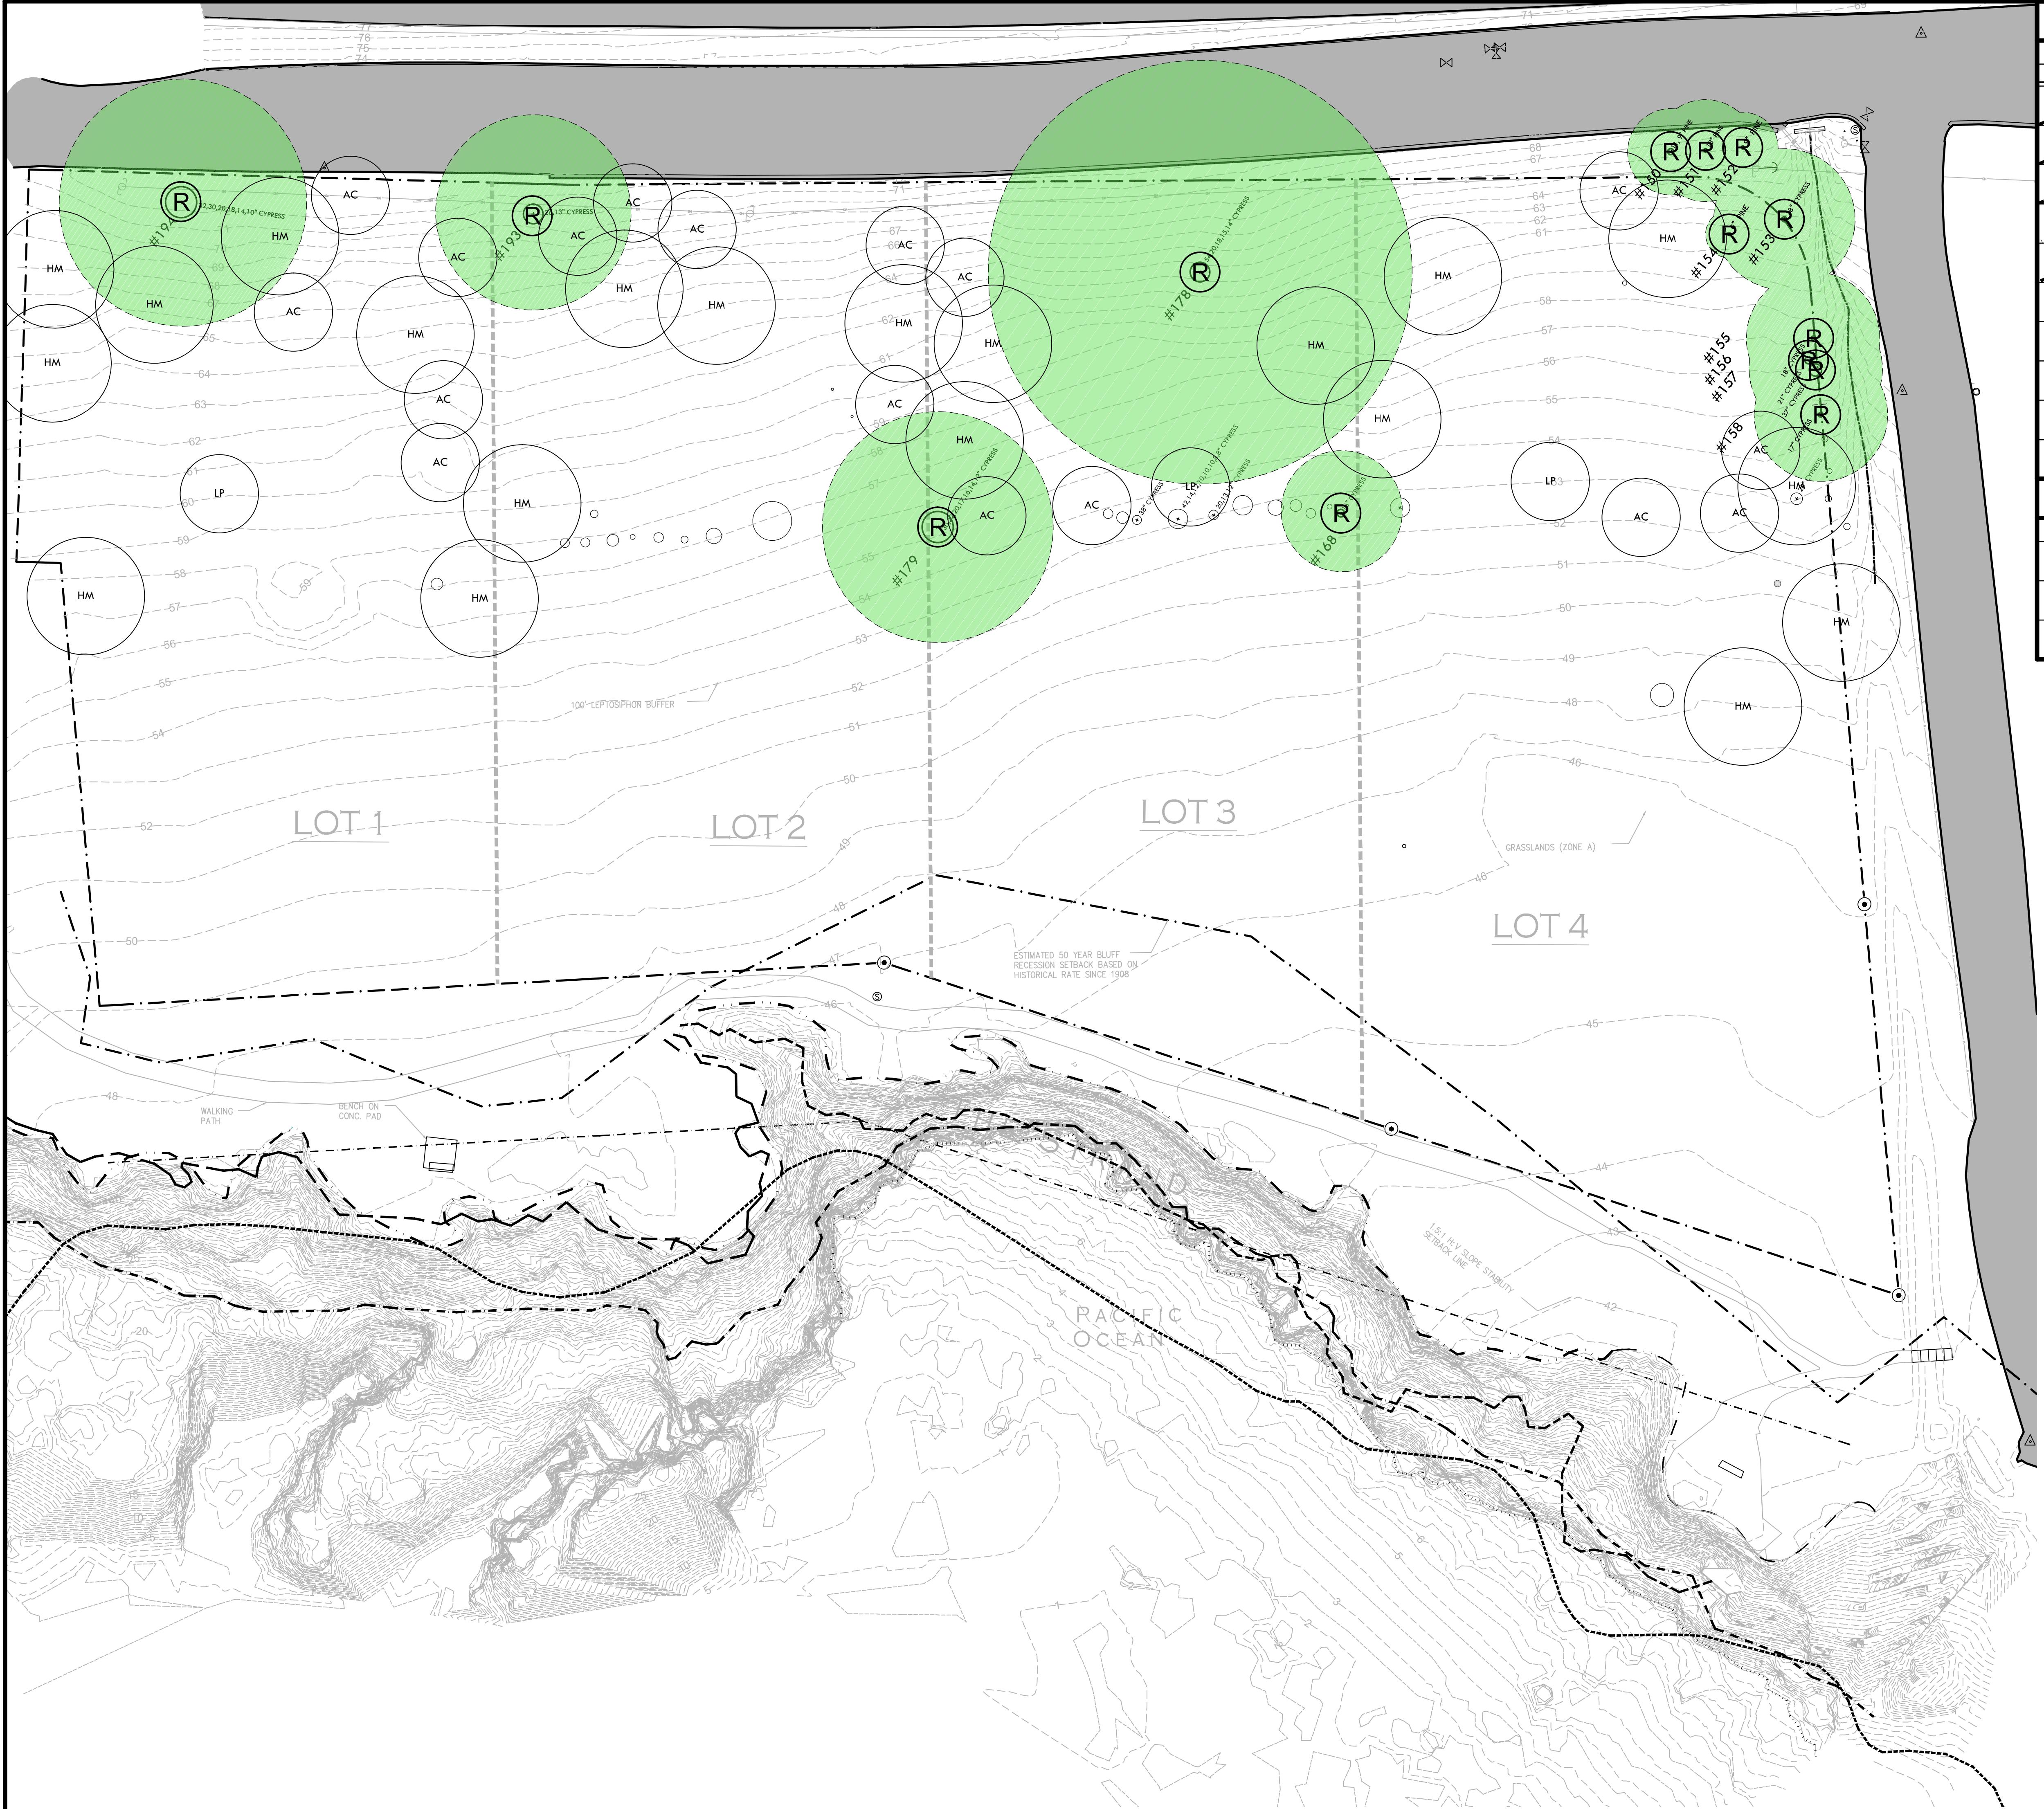
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SHEET NO. L3.1
OF SHEETS

TREE REMOVAL PLAN



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MARK S. BAGINSKI
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SHEET TITLE
TREE REPLACEMENT PLAN

PROJECT NAME
MOSS BEACH OCEAN DEVELOPMENT

PROJECT ADDRESS
VALLEMAR ST. & JULIANA AVE MOSS BEACH, CA

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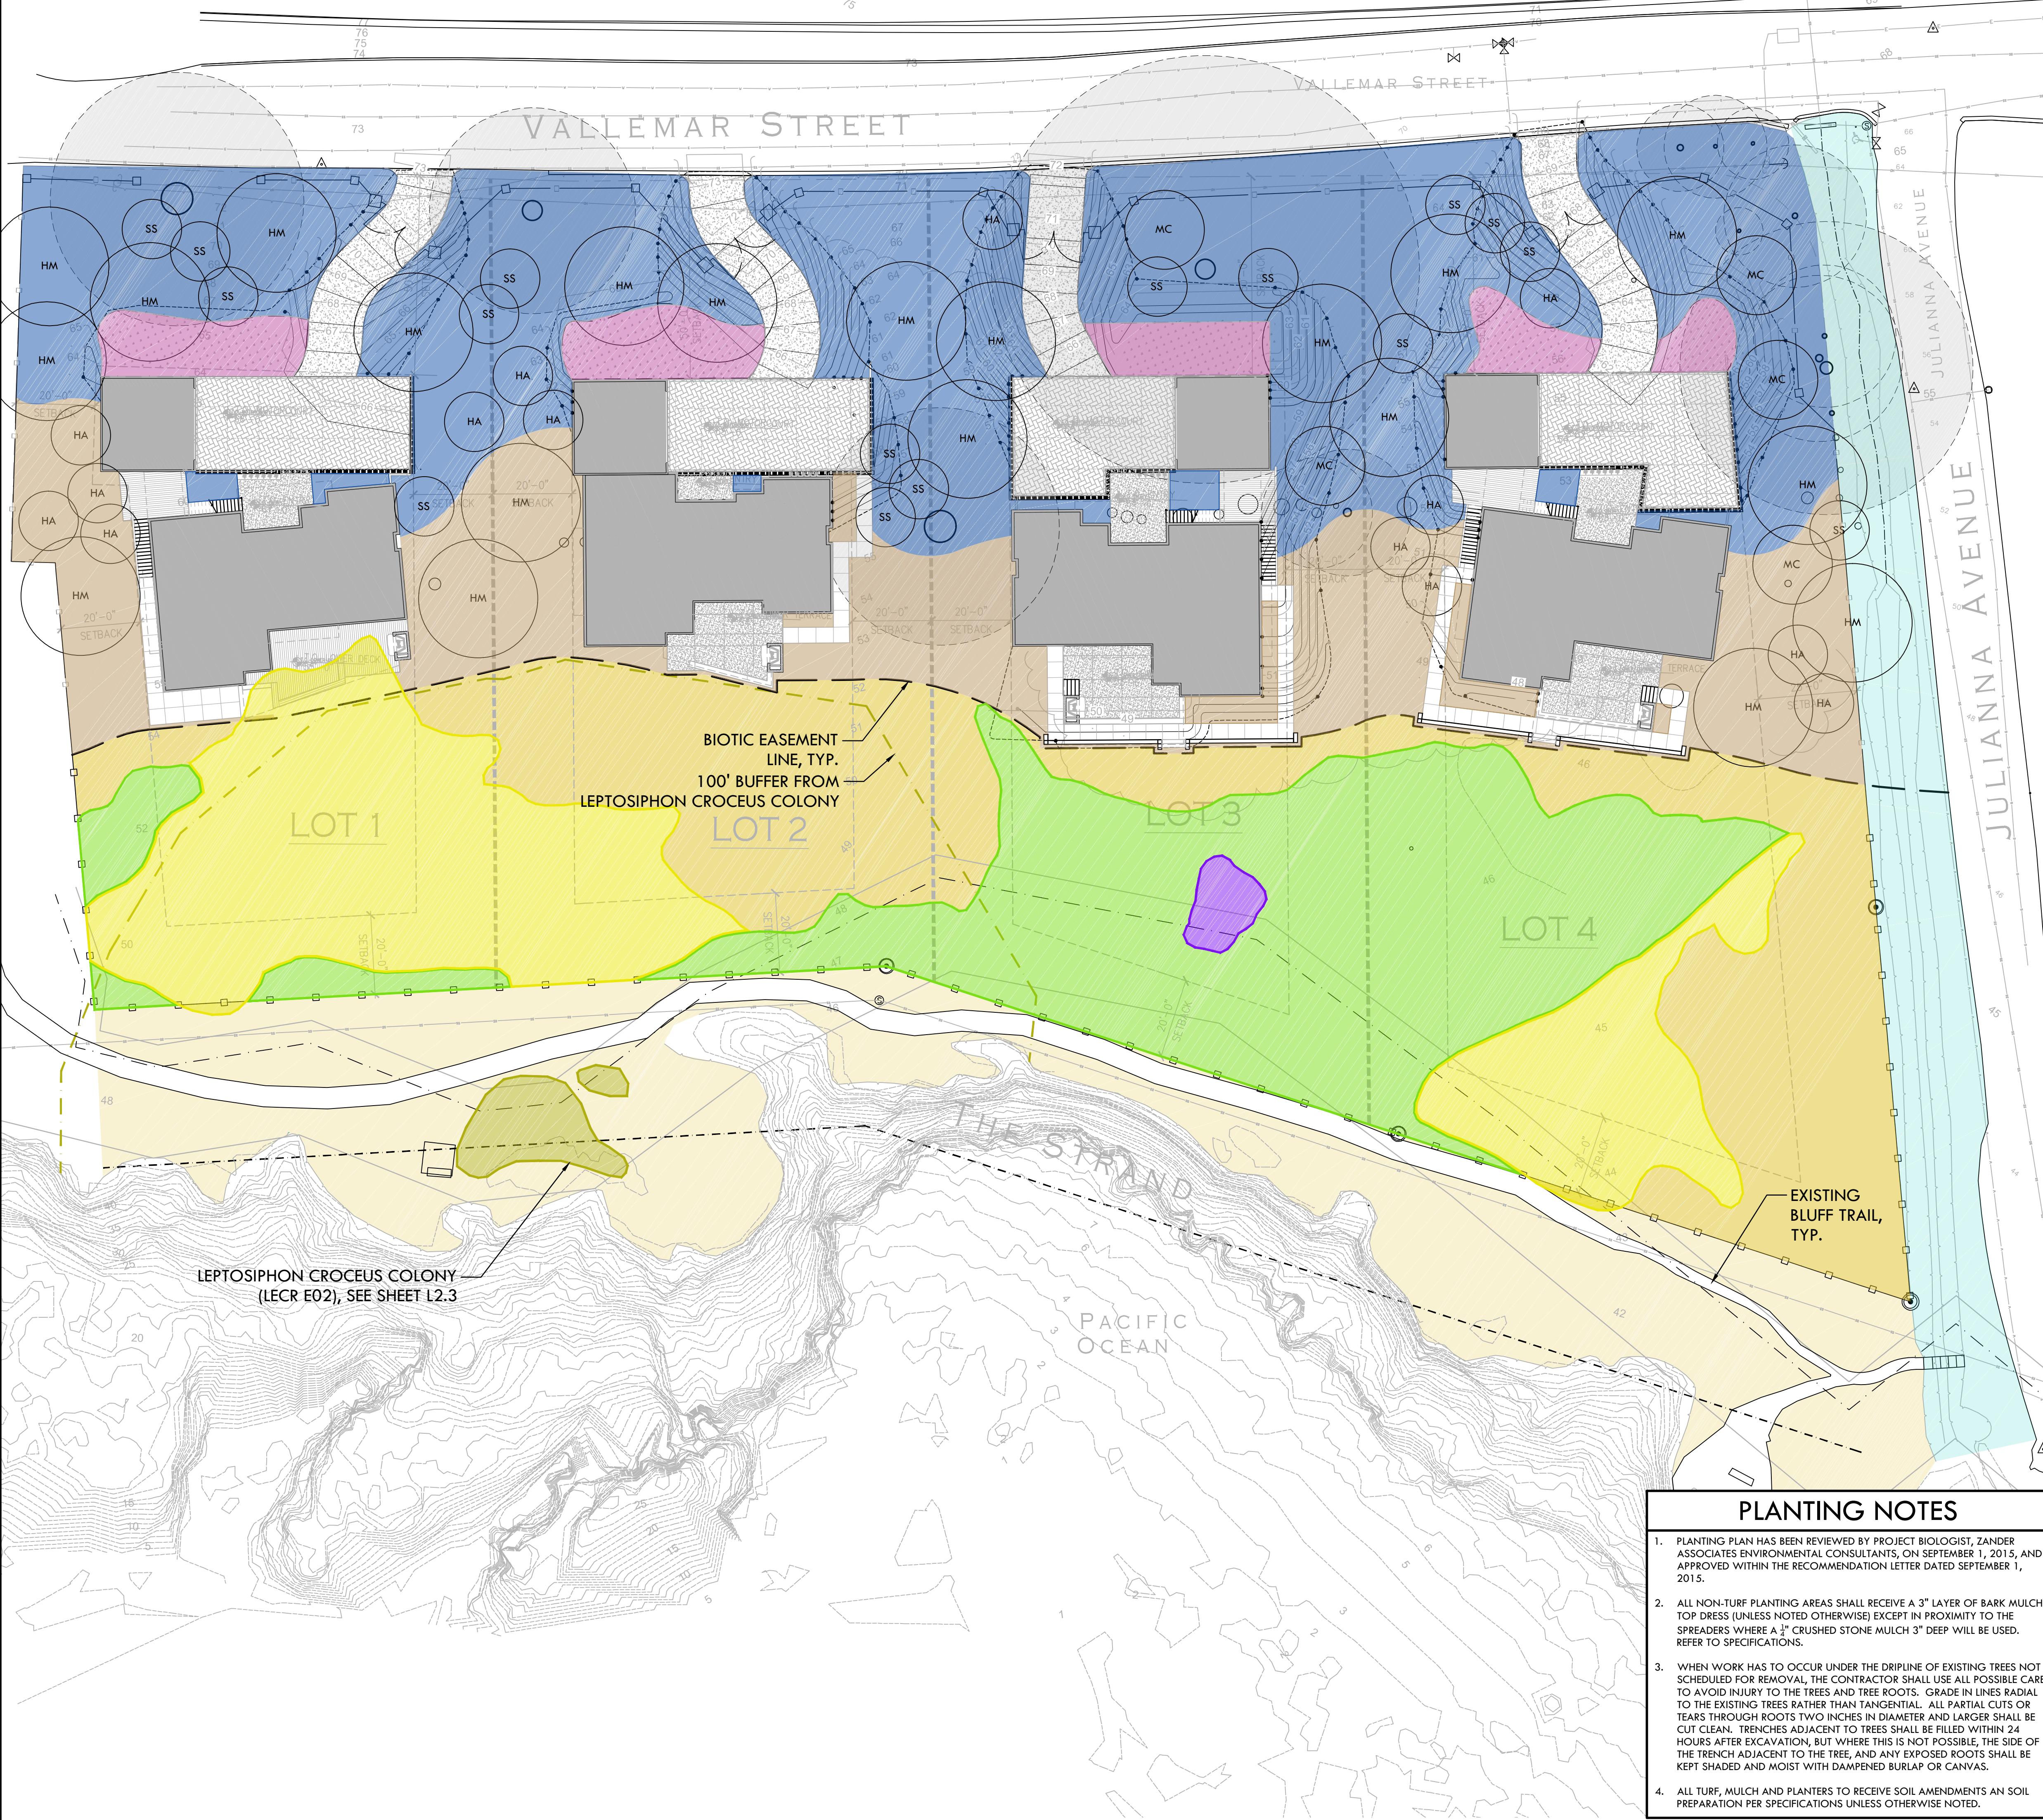
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TREE REPLACEMENT PLAN



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EXISTING VEGETATION			
SYM	QTY	SIZE	
14,424 SF	N/A	N/A	ZONE A - COASTAL PRAIRIE GRASSLAND TO REMAIN AND BE PROTECTED
11,683 SF	N/A	N/A	ZONE B - TRANSITIONAL AREA TO REMAIN AND BE PROTECTED, NON-NATIVE SPECIES TO BE REMOVED
498 SF	N/A	N/A	BEACH STRAWBERRY TO REMAIN AND BE PROTECTED
TREES			
SYM	QTY	SIZE	BOTANICAL/COMMON NAME SPACING SPREAD HEIGHT
TREES			
HM	20	24" BOX	HESPEROCYPARIS MACROCOPA MONTEREY CYPRESS 30' O.C. 60'
AC	17	24" BOX	AESCULUS CALIFORNICA CALIFORNIA BUCKEYE 25' O.C. 25'
LP	3	24" BOX	LAGUNARIA PATERNSONIA PRIMROSE TREE 20' O.C. 20'
HA	14	24" BOX	HETEROMELES ARBITIFOLIA TOYON 20' O.C. 15'
MC	5	24" BOX	MORELLA CALIFORNICA PACIFIC WAX MYRTLE 15' O.C. 20'
SS	16	24" BOX	SALIX SCOULERIANA SCOULER'S WILLOW 15' O.C. 15'
SHRUBS & GRASSES			
SYM	QTY	SIZE	BOTANICAL/COMMON NAME HEIGHT SPREAD
ORNAMENTAL NATIVES			
20%	1 GAL		ACHILLEA MILLEFOLIUM YARROW 2' X 2'
20%	1 GAL		ARMERIA MARITIMA SEA THRIFT 1' X 1'
23,806 SF			BACCHARIS PILULARIS 'PIGEON POINT' DWARF COYOTE BRUSH 3' X 6'
20%	1 GAL		FRANGULA CALIFORNICA 'EVE CASE' COFFEEBERRY 8' X 8'
20%	1 GAL		RIBES AUREUM GRACILIMUM GOLDEN CURRANT 6' X 6'
COASTAL PRAIRIE / NATIVE MIX			
30%	4" POTS		CAREX PRAEGRACILIS FIELD SEDGE 2' X 2'
15%	4" POTS		ERIGERON GLAUCUS SEASIDE DAISY 1' X 1'
10,777 SF			DANTHONIA CALIFORNICA CALIFORNIA OAT GRASS 1' X 1'
15%	4" POTS		MELICA CALIFORNICA CALIFORNIA MELOC 3' X 1'
25%	4" POTS		SISYRINCHIUM BELLUM BLUE-EYED GRASS 2' X 2'
ON-SITE COASTAL PRAIRIE RESTORATION			
80%	4" POTS		DANTHONIA CALIFORNICA CALIFORNIA OAT GRASS 1' X 1'
13,430 SF			DESCHAMPSIA CESPITOSA 'HOLCIIFORMIS' PACIFIC HAIRGRASS 3' X 2'
10%	4" POTS		STIPA PULCHRA PURPLE NEEDLE GRASS 2' X 2'
BLUFF COASTAL PRAIRIE RESTORATION (SUBJECT TO COUNTY APPROVAL)			
80%	4" POTS		DANTHONIA CALIFORNICA CALIFORNIA OAT GRASS 1' X 1'
14,868 SF			DESCHAMPSIA CESPITOSA 'HOLCIIFORMIS' PACIFIC HAIRGRASS 3' X 2'
10%	4" POTS		STIPA PULCHRA PURPLE NEEDLE GRASS 2' X 2'
DRAINAGE PLANTING (SUBJECT TO COUNTY APPROVAL)			
6,911 SF			JUNCUS EFFUSUS COMMON RUSH 3' X 2'
50%	1 GAL		JUNCUS PATENS CALIFORNIA GREY RUSH 3' X 3'
BIO-RETENTION SWALE PLANTING			
1,478 SF			JUNCUS EFFUSUS COMMON RUSH 3' X 2'
50%	1 GAL		JUNCUS PATENS CALIFORNIA GREY RUSH 3' X 3'
NATIVE COASTAL GRASS LAWN			
3,227 SF	100%	SEED	AGROSTIS PALLENS SEASHORE BENTGRASS N/A
EXISTING VEGETATION TO REMAIN AND BE PROTECTED			
766 SF	N/A	N/A	LEPTOSIPHON CROCEUS - LECR ELEMENT OCCURRENCE 02 PER CA NATIVE PLANT SOCIETY MEMORANDUM (5/25/2016)

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REGISTERED LANDSCAPE ARCHITECT
MARK S. BAGINSKI
No. 4089
Signature
EXPIRATION DATE: JULY 2019
STATE OF CALIFORNIA

TREE AND SHRUB PLANTING PLAN

PROJECT NAME
MOSS BEACH
OCEAN
DEVELOPMENT

PROJECT ADDRESS
VALLEMAR ST. &
JULIANNA AVE
MOSS BEACH, CA

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SHEET NO.	L3.3
OF SHEETS	1

PLANTING NOTES

- PLANTING PLAN HAS BEEN REVIEWED BY PROJECT BIOLOGIST, ZANDER ASSOCIATES ENVIRONMENTAL CONSULTANTS, ON SEPTEMBER 1, 2015, AND APPROVED WITHIN THE RECOMMENDATION LETTER DATED SEPTEMBER 1, 2015.
- ALL NON-TURF PLANTING AREAS SHALL RECEIVE A 3" LAYER OF BARK MULCH TOP DRESS (UNLESS NOTED OTHERWISE) EXCEPT IN PROXIMITY TO THE SPREADERS WHERE A 1" CRUSHED STONE MULCH 3" DEEP WILL BE USED. REFER TO SPECIFICATIONS.
- WHEN WORK HAS TO OCCUR UNDER THE DRIPLINE OF EXISTING TREES NOT SCHEDULED FOR REMOVAL, THE CONTRACTOR SHALL USE ALL POSSIBLE CARE TO AVOID INJURY TO THE TREES AND TREE ROOTS. GRADE IN LINES RADIAL TO THE EXISTING TREES RATHER THAN TANGENTIAL. ALL PARTIAL CUTS OR TEARS THROUGH ROOTS TWO INCHES IN DIAMETER AND LARGER SHALL BE CUT CLEAN. TRENCHES ADJACENT TO TREES SHALL BE FILLED WITHIN 24 HOURS AFTER EXCAVATION, BUT WHERE THIS IS NOT POSSIBLE, THE SIDE OF THE TRENCH ADJACENT TO THE TREE, AND ANY EXPOSED ROOTS SHALL BE KEPT SHADED AND MOIST WITH DAMPENED BURLAP OR CANVAS.
- ALL TURF, MULCH AND PLANTERS TO RECEIVE SOIL AMENDMENTS AND SOIL PREPARATION PER SPECIFICATIONS UNLESS OTHERWISE NOTED.

NORTH

0 15 30 60 90'

TREES / LARGE SHRUBS

HM	AC	HA	MC	SS
<i>HESPEROCYPARIS MACROCOPA</i> MONTEREY CYPRESS	<i>AESCULUS CALIFORNICA</i> CALIFORNIA BUCKEYE	<i>HETEROMELES ARBUTIFOLIA</i> TOYON	<i>MORELLA CALIFORNICA</i> PACIFIC WAX MYRTLE	<i>SALIX SCOULERIANA</i> SCOULER'S WILLOW

ORNAMENTAL NATIVES

AM	AR	BP	RC	RC
<i>ACHILLEA MILLEFOLIUM</i> 'CALIFORNICA' YARROW	<i>ARMERIA MARITIMA</i> SEA THRIFT	<i>BACCHARIS PILULARIS</i> 'PIGEON POINT' DWARF COYOTE BRUSH	<i>FRANGULA CALIFORNICA</i> 'EVE CASE' EVE CASE COFFEEBERRY	<i>RIBES AUREUM GRACILLIMUM</i> GOLDEN CURRANT

COASTAL PRAIRIE / NATIVE MIX

CP	EG	SB	DC	MC
<i>CAREX PRAEGRACILIS</i> FIELD SEDGE	<i>ERIGERON GLAUCUS</i> SEASIDE DAISY	<i>SISYRINCHIUM BELLUM</i> BLUE-EYED GRASS	<i>DANTHONIA CALIFORNICA</i> CALIFORNIA OATGRASS	<i>MELICA CALIFORNICA</i> CALIFORNIA MELIC

COASTAL PRAIRIE GRASSES

DC	DE	SP
<i>DANTHONIA CALIFORNICA</i> CALIFORNIA OATGRASS	<i>DESCHAMPSSIA CESPITOSA</i> PACIFIC HAIRGRASS	<i>STIPA PULCHRA</i> PURPLE NEEDLE GRASS

DRAINAGE PLANTING

JE	JP	AP
<i>JUNCUS EFFUSUS</i> COMMON RUSH	<i>JUNCUS PATENS</i> CALIFORNIA GREY RUSH	<i>AGROSTIS PALLENS</i> SEASHORE BENTGRASS

NATIVE COASTAL GRASS LAWN


EXISTING VEGETATION				
SYM	QTY	SIZE		
14,424 SF	N/A	N/A	ZONE A - COASTAL PRAIRIE GRASSLAND TO REMAIN AND BE PROTECTED	
498 SF	N/A	N/A	BEACH STRAWBERRY TO REMAIN AND BE PROTECTED	
TREES				
SYM	QTY	SIZE	BOTANICAL/COMMON NAME	SPACING / HEIGHT
TREES				
HM	20	24" BOX	<i>HESPEROCYPARIS MACROCOPA</i> MONTEREY CYPRESS	30' O.C. 60'
AC	17	24" BOX	<i>AESCULUS CALIFORNICA</i> CALIFORNIA BUCKEYE	25' O.C. 25'
LP	3	24" BOX	<i>LAGUNARIA PATERSONIA</i> PRIMROSE TREE	20' O.C. 20'
HA	14	24" BOX	<i>HETEROMELES ARBUTIFOLIA</i> TOYON	20' O.C. 15'
MC	5	24" BOX	<i>MORELLA CALIFORNICA</i> PACIFIC WAX MYRTLE	15' O.C. 20'
SS	16	24" BOX	<i>SALIX SCOULERIANA</i> SCOULER'S WILLOW	15' O.C. 15'
SHRUBS & GRASSES				
SYM	QTY	SIZE	BOTANICAL/COMMON NAME	HEIGHT / SPREAD
ORNAMENTAL NATIVES				
23,806 SF	20%	1 GAL	<i>ACHILLEA MILLEFOLIUM</i> YARROW	2' X 2'
	20%	1 GAL	<i>ARMERIA MARITIMA</i> SEA THRIFT	1' X 1'
	20%	1 GAL	<i>BACCHARIS PILULARIS</i> 'PIGEON POINT' DWARF COYOTE BRUSH	3' X 6'
	20%	1 GAL	<i>FRANGULA CALIFORNICA</i> 'EVE CASE' EVE CASE COFFEEBERRY	8' X 8'
	20%	1 GAL	<i>RIBES AUREUM GRACILLIMUM</i> GOLDEN CURRANT	6' X 6'
COASTAL PRAIRIE / NATIVE MIX				
10,777 SF	30%	4" POTS	<i>CAREX PRAEGRACILIS</i> FIELD SEDGE	2' X 2'
	15%	4" POTS	<i>ERIGERON GLAUCUS</i> SEASIDE DAISY	1' X 1'
	15%	4" POTS	<i>DANTHONIA CALIFORNICA</i> CALIFORNIA OAT GRASS	1' X 1'
	25%	4" POTS	<i>MELICA CALIFORNICA</i> CALIFORNIA MELIC	3' X 1'
	15%	4" POTS	<i>SISYRINCHIUM BELLUM</i> BLUE-EYED GRASS	2' X 2'
ON-SITE COASTAL PRAIRIE RESTORATION				
25,113 SF	80%	4" POTS	<i>DANTHONIA CALIFORNICA</i> CALIFORNIA OAT GRASS	1' X 1'
	10%	4" POTS	<i>DESCHAMPSIA CESPITOSA</i> 'HOLCIIFORMIS' PACIFIC HAIRGRASS	3' X 2'
	10%	4" POTS	<i>STIPA PULCHRA</i> PURPLE NEEDLE GRASS	2' X 2'
BLUFF COASTAL PRAIRIE RESTORATION (SUBJECT TO COUNTY APPROVAL)				
14,868 SF	80%	4" POTS	<i>DANTHONIA CALIFORNICA</i> CALIFORNIA OAT GRASS	1' X 1'
	10%	4" POTS	<i>DESCHAMPSIA CESPITOSA</i> 'HOLCIIFORMIS' PACIFIC HAIRGRASS	3' X 2'
	10%	4" POTS	<i>STIPA PULCHRA</i> PURPLE NEEDLE GRASS	2' X 2'
DRAINAGE PLANTING (SUBJECT TO COUNTY APPROVAL)				
6,911 SF	50%	1 GAL	<i>JUNCUS EFFUSUS</i> COMMON RUSH	3' X 2'
	50%	1 GAL	<i>JUNCUS PATENS</i> CALIFORNIA GREY RUSH	3' X 3'
BIO-RETENTION SWALE PLANTING				
1,478 SF	50%	1 GAL	<i>JUNCUS EFFUSUS</i> COMMON RUSH	3' X 2'
	50%	1 GAL	<i>JUNCUS PATENS</i> CALIFORNIA GREY RUSH	3' X 3'
NATIVE COASTAL GRASS LAWN				
NO.	REVISIONS	DATE		
DRAWN BY PH	CHECKED BY MB			
DATE ISSUED 08/23/17	SCALE AS SHOWN			
PROJ. NO. 1500600-1668	SHEET NO.			
L3.4 OF SHEETS				

PLANTING NOTES

- PLANTING PLAN HAS BEEN REVIEWED BY PROJECT BIOLOGIST, ZANDER ASSOCIATES ENVIRONMENTAL CONSULTANTS, ON SEPTEMBER 1, 2015, AND APPROVED WITHIN THE RECOMMENDATION LETTER DATED SEPTEMBER 1, 2015.
- ALL NON-TURF PLANTING AREAS SHALL RECEIVE A 3" LAYER OF BARK MULCH TOP DRESS (UNLESS NOTED OTHERWISE) EXCEPT IN PROXIMITY TO THE SPREADERS WHERE A 1" CRUSHED STONE MULCH 3" DEEP WILL BE USED. REFER TO SPECIFICATIONS.
- WHEN WORK HAS TO OCCUR UNDER THE DRILINE OF EXISTING TREES NOT SCHEDULED FOR REMOVAL, THE CONTRACTOR SHALL USE ALL POSSIBLE CARE TO AVOID INJURY TO THE TREES AND TREE ROOTS. GRADE IN LINES RADIAL TO THE EXISTING TREES RATHER THAN TANGENTIAL. ALL PARTIAL CUTS OR TEARS THROUGH ROOTS TWO INCHES IN DIAMETER AND LARGER SHALL BE CUT CLEAN. TRENCHES ADJACENT TO TREES SHALL BE FILLED WITHIN 24 HOURS AFTER EXCAVATION, BUT WHERE THIS IS NOT POSSIBLE, THE SIDE OF THE TRENCH ADJACENT TO THE TREE, AND ANY EXPOSED ROOTS SHALL BE KEPT SHADED AND MOIST WITH DAMPENED BURLAP OR CANVAS.
- ALL TURF, MULCH AND PLANTERS TO RECEIVE SOIL AMENDMENTS AN SOIL PREPARATION PER SPECIFICATIONS UNLESS OTHERWISE NOTED.



VERDE DESIGN
LANDSCAPE ARCHITECTURE
CIVIL ENGINEERING
SPORT PLANNING & DESIGN
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www.VerdeDesigninc.com

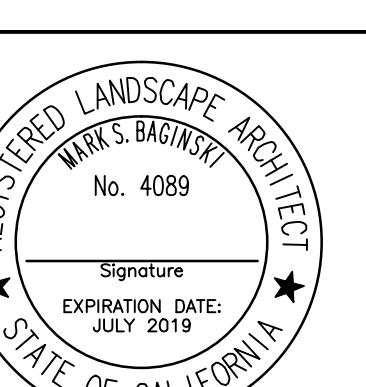

CONSULTANT

TREE AND SHRUB PLANT IMAGES
MOSS BEACH OCEAN DEVELOPMENT

PROJECT NAME
VALLEMAR ST. & JULIANA AVE
MOSS BEACH, CA

PROJECT ADDRESS
SUBMITTAL DATE
DESIGN REVIEW APPLICATION 08/21/15
DESIGN REVIEW RESUBMITTAL 08/09/16

NO. REVISIONS DATE

DRAWN BY PH
CHECKED BY MB
DATE ISSUED 08/23/17
SCALE AS SHOWN

PROJ. NO.
1500600-1668
SHEET NO.
L3.4 OF SHEETS



MATERIAL LEGEND		
SYM	DESCRIPTION	DTL REF
	PERMEABLE CONCRETE PAVERS WITH 6" CONCRETE EDGEBAND	A L4.2
	STAMPED CONCRETE AT DRIVEWAY ENTRANCES	B L4.2
	DECKING - REFER TO ARCHITECTURAL PLANS	
	NATIVE COASTAL GRASS LAWN	
	GABION WALL W/ GRAPE STAKE (4' MAX)	C L4.2
	GRAPE STAKE FENCE AT PROPERTY LINE (18-30" HIGH) MIN. 50% TRANSPARENCY	D L4.2
(A)	EXISTING PUBLIC TRAIL AT BLUFF	
(1)	PERMEABLE PAVERS/PAVEMENT	
(2)	NON-PERMEABLE PAVEMENT	
(3)	PATHWAY/PATIO W/ COMMON PAVERS OR STONE	
(4)	GRAPE STAKE FLANK GATE	C L4.2
(5)	BIOTIC EASEMENT LINE	
(6)	GABION RETAINING WALL / SEAT WALL	E L4.2



CONSULTANT

MATERIAL AND DETAIL REFERENCE PLAN

PROJECT NAME
**MOSS BEACH
OCEAN
DEVELOPMENT**

PROJECT ADDRESS
**VALLEMAR ST. &
JULIANA AVE
MOSS BEACH, CA**

SUBMITTAL	DATE
DESIGN REVIEW APPLICATION	08/21/15
DESIGN REVIEW RESUBMITTAL	08/09/16

NO.	REVISIONS	DATE
△		
△		
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DRAWN BY	CHECKED BY
PH	MB
DATE ISSUED 08/23/17	SCALE AS SHOWN
PROJ. NO. 1500600-1668	SHEET NO.

L4.1
OF SHEETS

PAVERS / PAVING



A PERMEABLE PAVERS AT DRIVEWAYS
(ASHLAR PATTERN)



B PERMEABLE PAVERS AT DRIVEWAYS
(RUNNING BOND)



C PERMEABLE PAVERS AT DRIVEWAYS
(HERRINGBONE PATTERN)




D STAMPED CONCRETE AT DRIVEWAY ENTRANCES

FENCING AND WALLS


E GABION WALL WITH GRAPE STAKE FENCE
(42-48" HEIGHT, TYP. W/ IRREGULAR PICKETS, FLAT TOP)

FENCING AND WALLS

F GABION RETAINING WALL / SEAT WALL

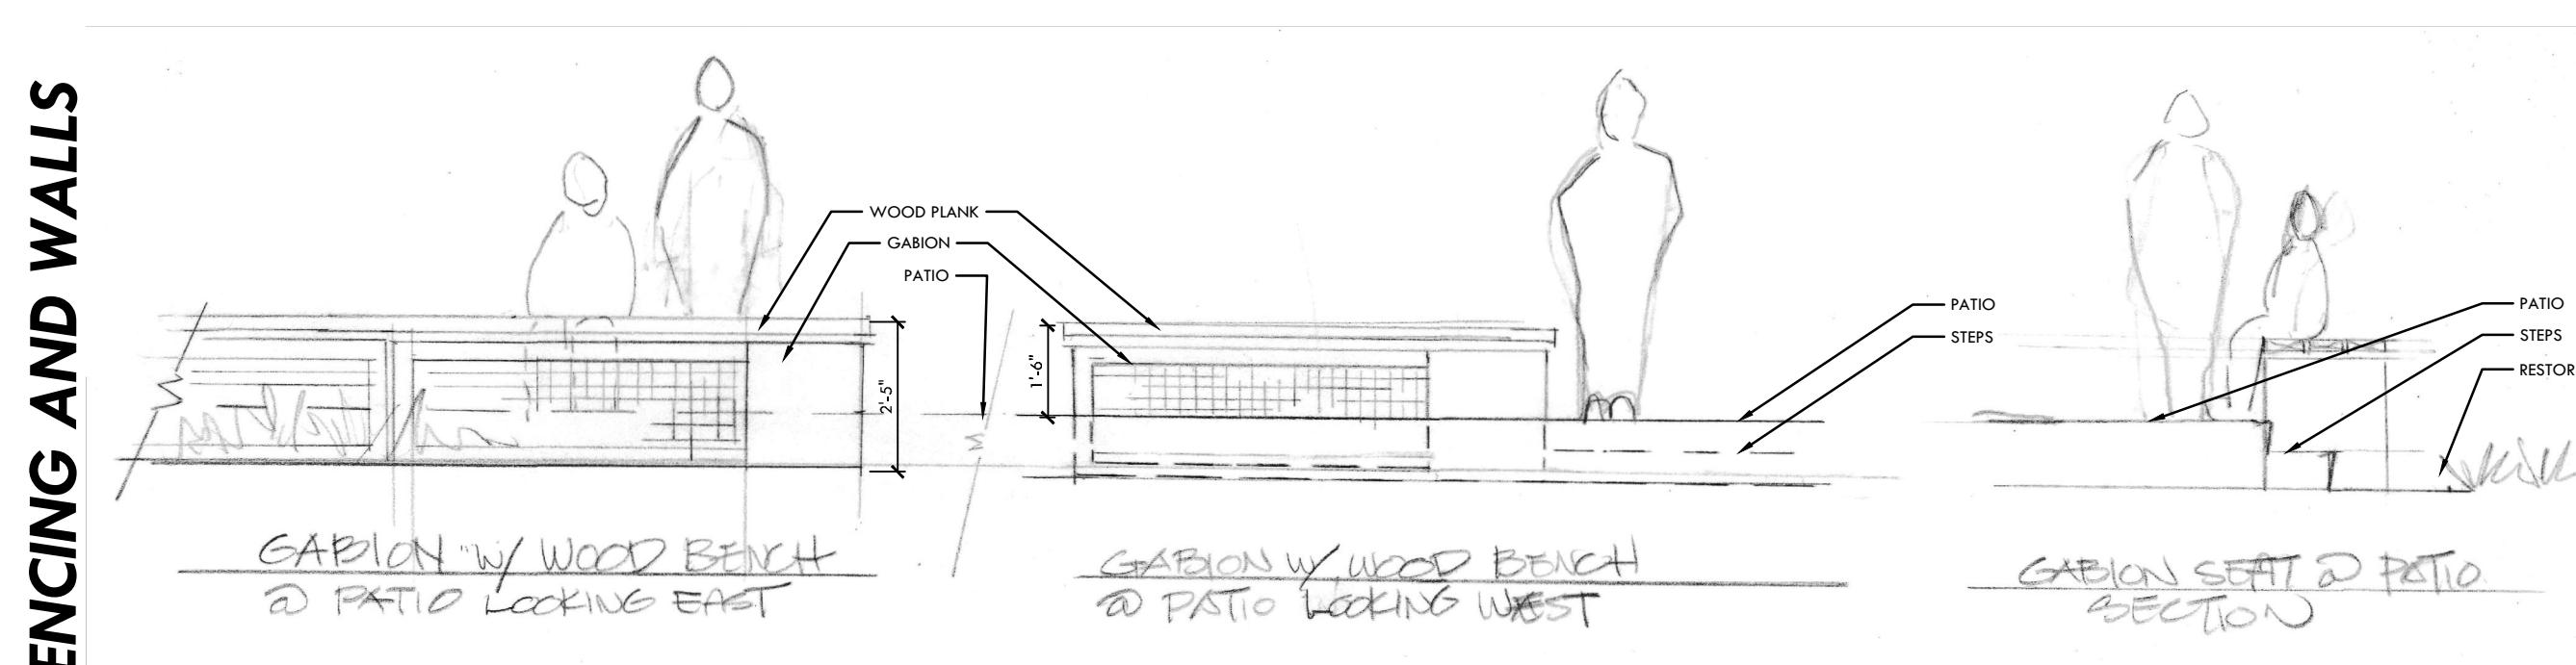

GRAPE STAKE FENCE

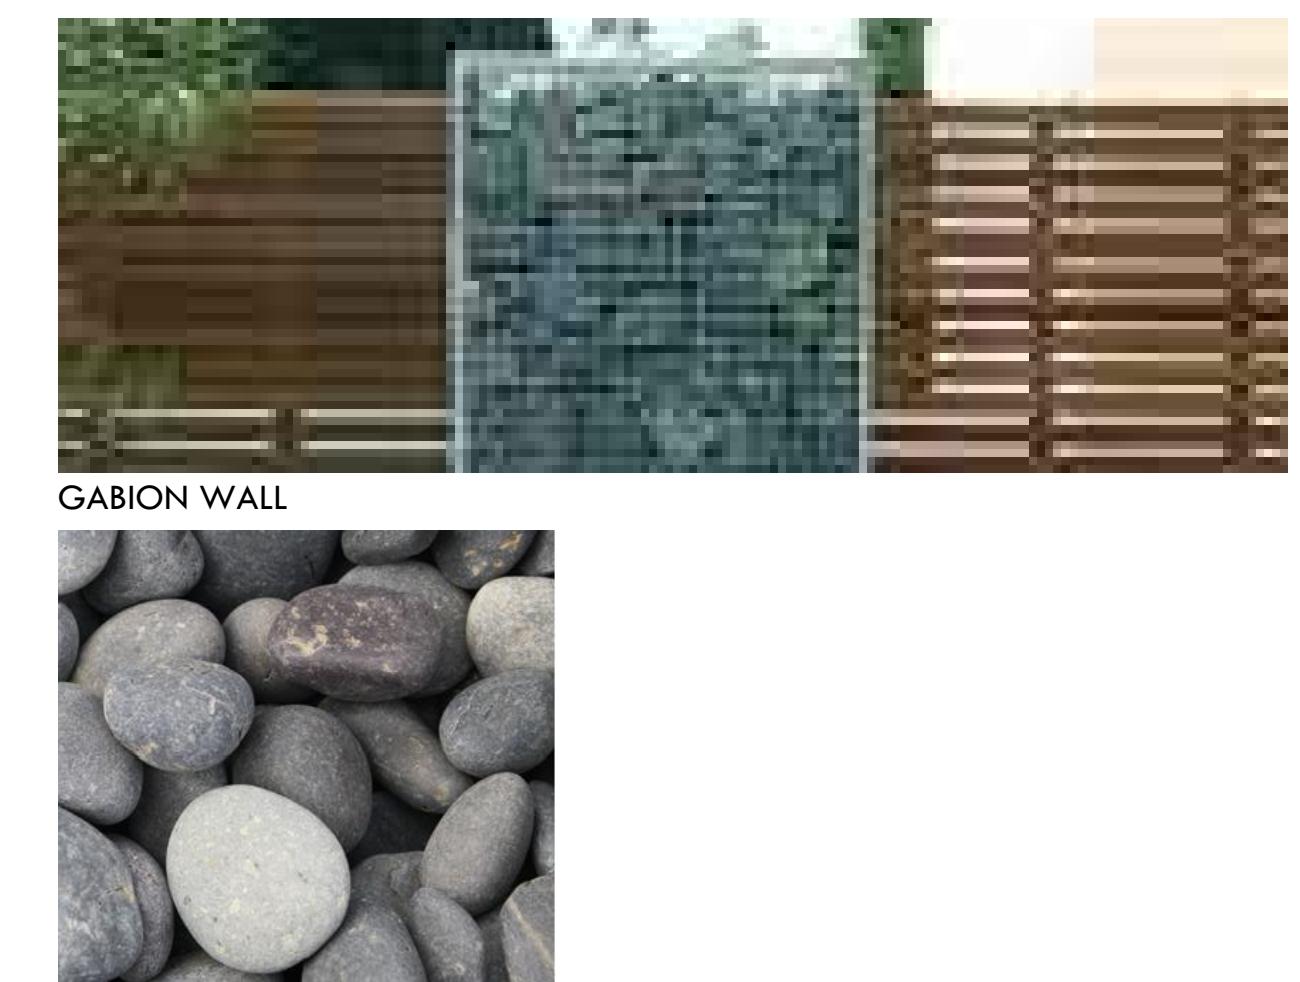

GABION WALL


ROUNDED COBBLE FILL



RETAINING WALL AT REAR YARDS
(HORIZONTAL BOARD FORM FINISH)




LANDSCAPE WALL AT DRIVEWAY
(HORIZONTAL BOARD FORM FINISH)

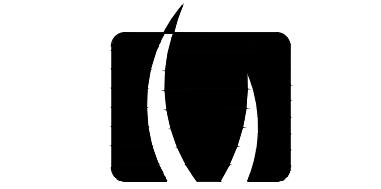

VERDE DESIGN

LANDSCAPE ARCHITECTURE
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fax: 408.985.7260
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CONSULTANT

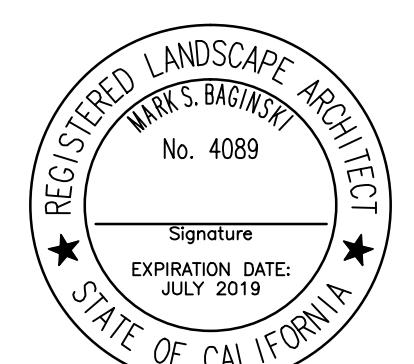SHEET TITLE

DESIGN MATERIALS &
IMAGERY

PROJECT NAME

MOSS BEACH
OCEAN
DEVELOPMENT

PROJECT ADDRESS

VALLEMAR ST. &
JULIANA AVE
MOSS BEACH, CA

SUBMITTAL

DATE

DESIGN REVIEW APPLICATION

08/21/15







DESIGN REVIEW RESUBMITTAL

08/09/16

NO.

REVISIONS

DATE

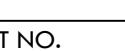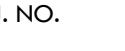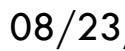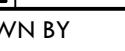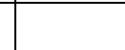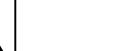

DRAWN BY PH CHECKED BY MB

DATE ISSUED

08/23/17

SCALE

AS SHOWN

PROJ. NO.

1500600-1668

SHEET NO.

L4.2

OF

1 SHEETS

MOSS BEACH - OVERALL

VALLEMAR ST. & JULIANNA AVE.

COASTSIDE DESIGN
REVIEW APPLICATION


DRAWING:
SITE PLAN

PROJECT NUMBER: 1507

DATE: JULY 24, 2017
△ 08-25-2017
DESIGN REVIEW SET

SHEET NO.

A1.0

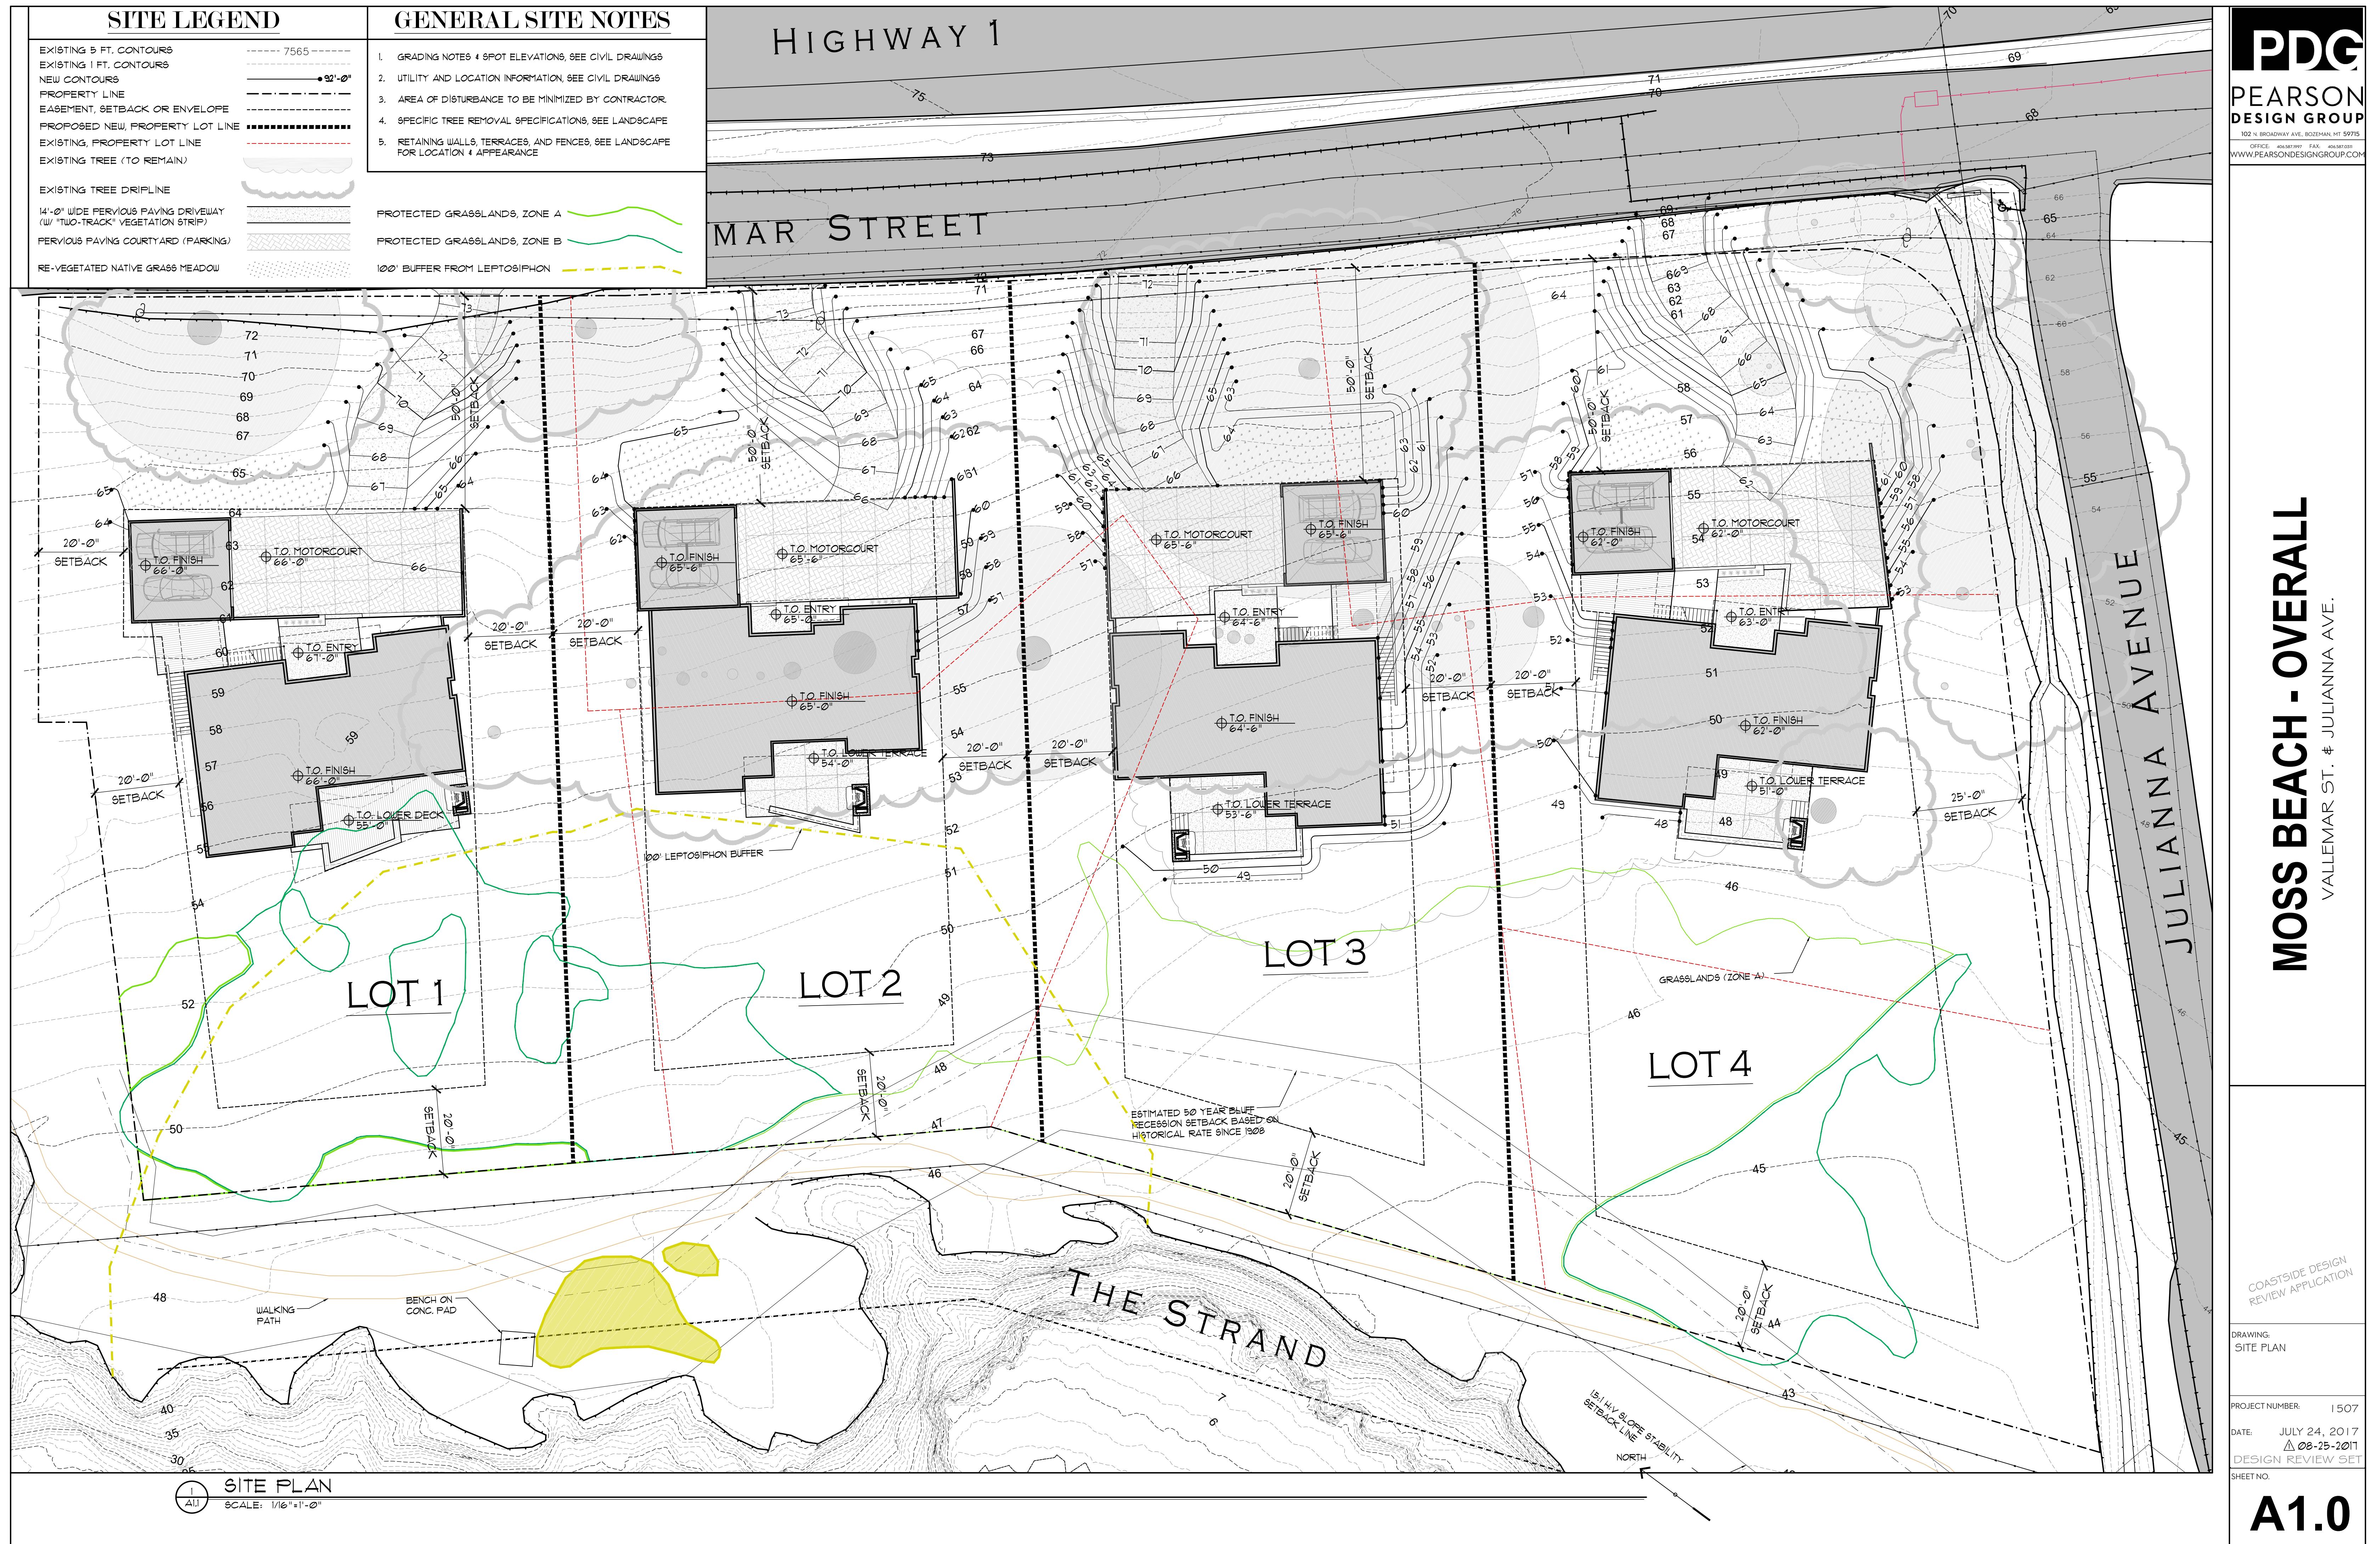

INDEX OF DRAWINGS

ARCHITECTURAL

COVER VICINITY MAP & PROPERTY SUMMARY
A01 AREA PLAN CALCULATIONS

A11 SITE PLAN

A21 LOWER LEVEL PLAN
A22 MAIN LEVEL PLAN
A23 COURTYARD PLAN
A24 GARAGE STORAGE PLAN & ROOF PLAN
A25 MEZZANINE & ROOF PLAN

A31 EXTERIOR ELEVATIONS
A32 EXTERIOR ELEVATIONS
A33 EXTERIOR ELEVATIONS
A34 EXTERIOR ELEVATIONS

A41 BUILDING CROSS-SECTION
A42 BUILDING CROSS-SECTION




LOT

MOSS BEACH - LOT 1

VALLEMAR ST. & JULIANNA AVE.

GENERAL NOTES

- DRAWINGS AND SPECIFICATIONS, AS INSTRUMENTS OF SERVICE, ARE THE EXCLUSIVE PROPERTY OF THIS ARCHITECT WHETHER THE PROJECT FOR WHICH THEY WERE PREPARED IS EXECUTED AND CONSTRUCTED OR NOT. THESE DOCUMENTS ARE NOT TO BE REPRODUCED IN ANY FORM AND THE ARE NOT TO BE USED BY THE PROJECT OWNER OR ANYONE OTHER THAN THE ARCHITECT FOR ANY OTHER PROJECT, WHETHER ADDED OR ALTERATIONS TO THE ORIGINAL PROJECT EXCEPT BY WRITTEN AUTHORIZATION AND PERMISSION FROM AND AGREEMENT WITH THIS ARCHITECT.
- CONTRACTOR SHALL VERIFY ALL DIMENSIONS AND CONDITIONS SHOWN IN THE DRAWINGS AT THE JOB SITE AND SHALL NOTIFY THE ARCHITECT OF ANY DISCREPANCIES, OMISSIONS, AND/OR CONFLICTS BEFORE PROCEEDING WITH THE WORK.
- CONTRACTOR MUST COMPLY WITH THE RULES AND REGULATIONS OF AGENCIES OVERNING JURISDICTION AND SHALL CONFORM TO ALL CITY, COUNTY, STATE AND FEDERAL CONSTRUCTION SAFETY AND SANITARY LAWS, CODES, STATUTES AND ORDINANCES, ALL FEES, TAXES, PERMITS, APPLICATIONS AND CERTIFICATES OF INSPECTION, AND THE FILING OF ALL WORK WITH GOVERNMENTAL AGENCIES SHALL BE THE RESPONSIBILITY OF THE CONTRACTOR.
- ALL WORK SHALL BE PERFORMED BY SKILLED AND QUALIFIED WORKMEN IN ACCORDANCE WITH THE BEST PRACTICES OF THOSE TRADES INVOLVED, AND IN COMPLIANCE WITH BUILDING REGULATIONS AND/OR GOVERNMENTAL LAWS, STATUTES OR ORDINANCES CONCERNING THE USE OF UNION LABOR.
- EACH TRADE WILL PROCEED IN A FASHION THAT WILL NOT DELAY THE TRADES FOLLOWING THEM.
- CONTRACTORS SHALL BE RESPONSIBLE FOR THE DISTRIBUTION OF DRAWINGS AND/OR SPECIFICATIONS TO THE TRADES UNDER THEIR JURISDICTION.
- ALL WORK SHALL BE ERECTED AND INSTALLED PLUMB, LEVEL, SQUARE, TRUE AND IN PROPER ALIGNMENT.
- ALL MATERIALS SHALL BE NEW, UNUSED AND OF THE HIGHEST QUALITY IN EVERY RESPECT, UNLESS NOTED OTHERWISE. MANUFACTURED MATERIALS AND EQUIPMENT SHALL BE INSTALLED PER MANUFACTURER'S RECOMMENDATIONS AND INSTRUCTIONS.
- THERE SHALL BE NO SUBSTITUTION OF MATERIALS WHERE A MANUFACTURER IS SPECIFIED, WHERE THE TERMS "EQUAL TO," "EQUIVALENT" OR "APPROVED EQUAL" ARE USED, THE ARCHITECT SHALL DETERMINE EQUALITY BASED ON INFORMATION SUBMITTED BY THE CONTRACTOR.
- ALL WORK AND MATERIALS SHALL BE GUARANTEED AGAINST DEFECTS FOR A PERIOD OF AT LEAST ONE (1) YEAR FROM APPROVAL FOR FINAL PAYMENT.
- CONTRACTOR SHALL BE RESPONSIBLE FOR ALL CUTTING AND PATCHING REQUIRED FOR THEIR WORK.
- CONTRACTOR SHALL AT ALL TIMES KEEP THE PREMISES FREE OF ACCUMULATION OF WASTE MATERIALS OR RUBBISH; PREMISES TO BE SWEEP CLEAN DAILY OF RELATED CONSTRUCTION DEBRIS, AT THE COMPLETION OF THE WORK, LEAVE THE JOB SITE FREE OF ALL MATERIALS AND BROOM CLEAN.
- DO NOT SCALE DRAWINGS; DIMENSIONS SHALL GOVERN. LARGER SCALE DRAWINGS SHALL GOVERN SMALLER SCALE.
- PATCH ALL AREAS WHERE FLOOR IS NOT LEVEL OR TRUE PRIOR TO THE INSTALLATION OF FLOORING OR CARPETING.
- TO INSURE PROPER AND ADEQUATE BLOCKING, ALL BLOCKING FOR CABINET WORK WILL BE THE RESPONSIBILITY OF THE CABINET CONTRACTOR.
- UPON COMPLETION OF THE WORK THE CONTRACTOR SHALL WALK THROUGH WITH THE ARCHITECT AND COMPILe A "PUNCH LIST" OF CORRECTIONS AND UNSATISFACTORY AND/OR INCOMPLETE WORK. FINAL PAYMENT WILL BE CONTINGENT UPON THE COMPLETION OF THESE ITEMS.
- ANY CHANGE WHICH RESULTS IN EXTRA COST SHALL NOT PROCEED WITHOUT WRITTEN AUTHORIZATION OF THE OWNER AND THE ARCHITECT.
- THE DESIGN, ADEQUACY, AND SAFETY OF ERECTION, BRACING, SHORING, TEMPORARY SUPPORTS, ETC. IS THE SOLE RESPONSIBILITY OF THE GENERAL CONTRACTOR AND HAS NOT BEEN CONSIDERED BY THE ARCHITECT OR ENGINEER. THE GENERAL CONTRACTOR IS RESPONSIBLE FOR THE STABILITY OF THE STRUCTURE THROUGHOUT CONSTRUCTION.
- ANY AMBIGUITIES, DISCREPANCIES, OR CONFLICTS DISCOVERED THROUGH THE USE OF THESE DRAWINGS SHALL BE REPORTED IMMEDIATELY TO THE ARCHITECT.

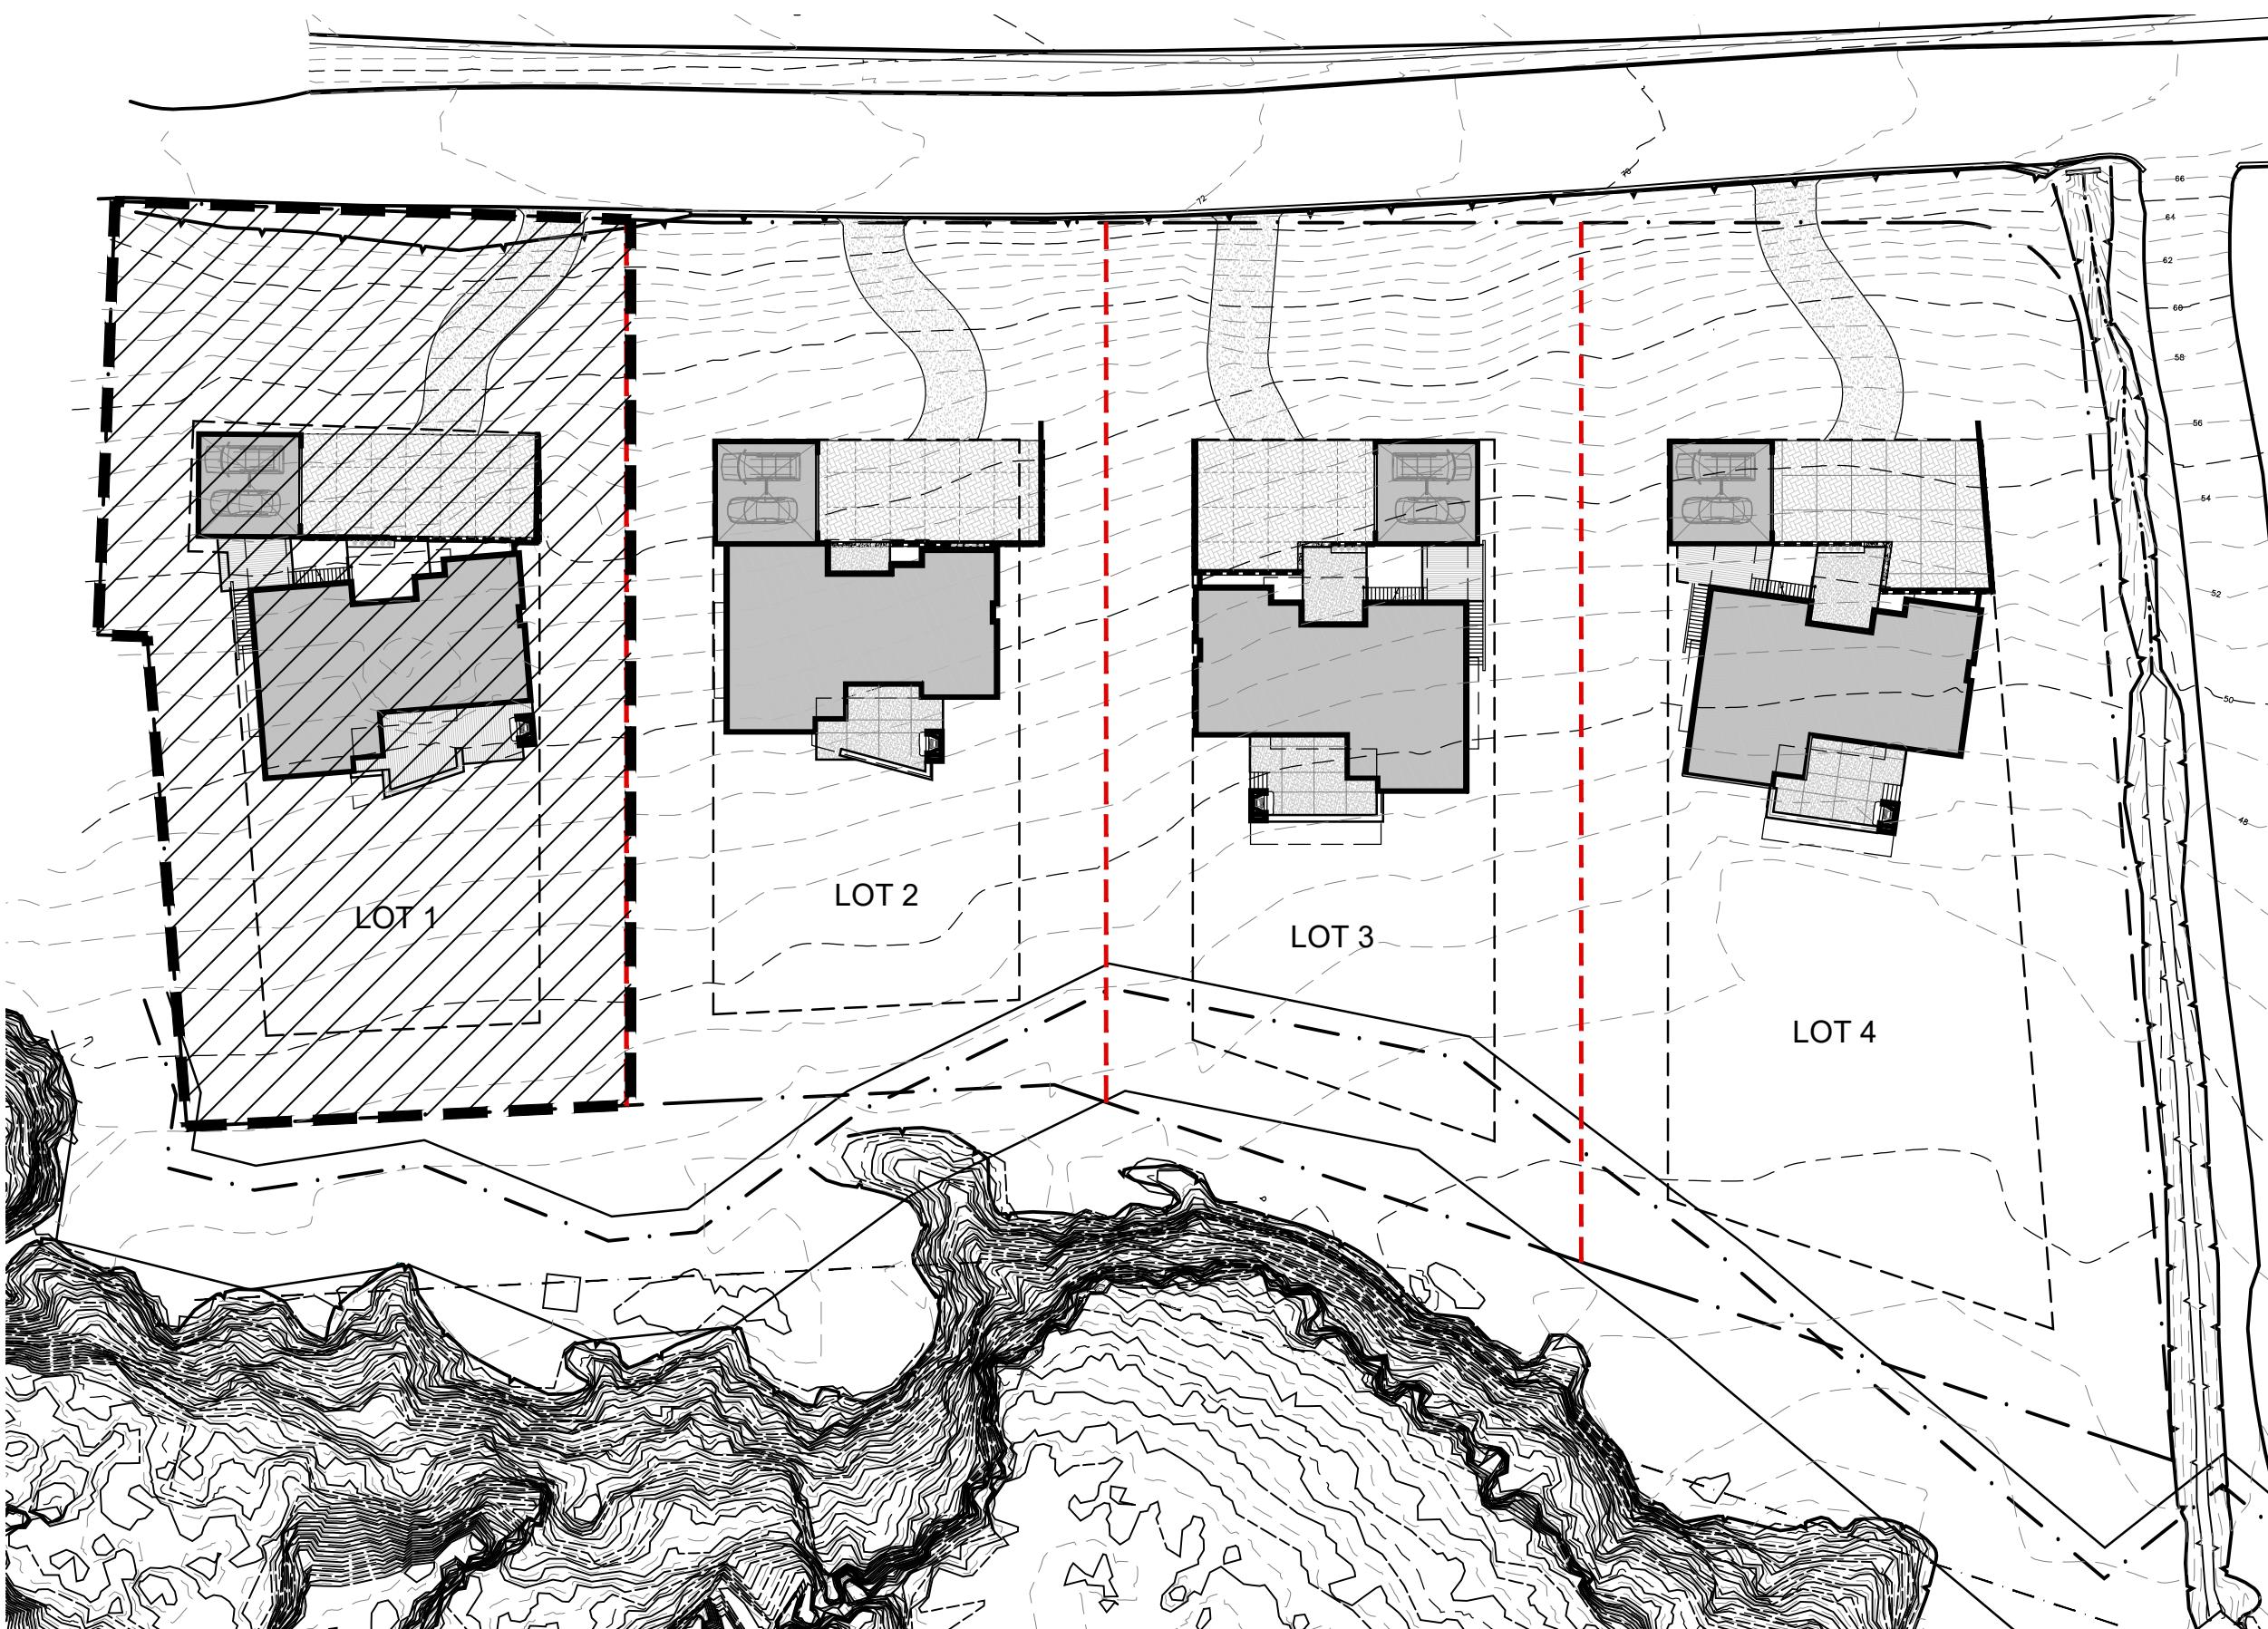

VICINITY MAP

NTS

PROPERTY SUMMARY

LOT:1

APN: 037086230
PARCEL ID: T.B.D.
CITY NAME: MOSS BEACH (UNINC)
ZIP CODE: 94038
MITIGATION FEE AREA: MIDCOAST URBAN

ZONING: RM-CZ/DR/CD
MIDCOAST LCP

Maximum Building Height: 20'

Parcel SF: 23,473 SF
Maximum Floor Building Area: 6,200 SF.

SQUARE FOOTAGE SUMMARY	
LOWER LEVEL (GROSS)	1763#
MAIN LEVEL (GROSS)	2234#
TOTAL FLOOR AREA (GROSS)	3997#
GARAGE (GROSS)	576#
GARAGE STORAGE (GROSS)	216#
ROOF ACCESS (HABITABLE)	239#
COVERED ENTRY PATIO	168#
COVERED REAR DECK	333#
ELEVATED DECKS	189#
ENTRY DECK	182#
GARAGE DECK	410#
REAR DECK	

ARCHITECT



102 NORTH BROADWAY AVE.
BOZEMAN, MT 59715
OFFICE: 406.587.1997 FAX: 406.587.0311
WWW.PEARSONDESIGNGROUP.COM

ISSUE DATE

COUNTY COASTSIDE DESIGN REVIEW SET

JULY 24, 2017

REVISION 1 - AUGUST 25, 2017

MOSS BEACH - LOT 1

VALLEMAR ST. & JULIANNA AVE.

COASTSIDE DESIGN
REVIEW APPLICATION

DRAWING:
SITE PLAN

PROJECT NUMBER: 1507
DATE: JULY 24, 2017
DESIGN REVIEW SET

SHEET NO.

A1.1

SITE LEGEND

EXISTING 5 FT. CONTOURS	7565
EXISTING 1 FT. CONTOURS	92'-0"
NEW CONTOURS	
PROPERTY LINE	
EASEMENT, SETBACK OR ENVELOPE	
PROPOSED NEW, PROPERTY LOT LINE	██████████
EXISTING, PROPERTY LOT LINE	-----
EXISTING TREE (TO REMAIN)	●
EXISTING TREE DRIPLINE	~~~~~
14'-0" WIDE PERVIOUS PAVING DRIVEWAY (W/ "TWO-TRACK" VEGETATION STRIP)	
PERVIOUS PAVING COURTYARD (PARKING)	
RE-VEGETATED NATIVE GRASS MEADOW
PROTECTED GRASSLANDS, ZONE A	—
PROTECTED GRASSLANDS, ZONE B	—
100' BUFFER FROM LEPTOSIPHON	—

GENERAL SITE NOTES

1. GRADING NOTES & SPOT ELEVATIONS, SEE CIVIL DRAWINGS
2. UTILITY AND LOCATION INFORMATION, SEE CIVIL DRAWINGS
3. AREA OF DISTURBANCE TO BE MINIMIZED BY CONTRACTOR
4. SPECIFIC TREE REMOVAL SPECIFICATIONS, SEE LANDSCAPE
5. RETAINING WALLS, TERRACES, AND FENCES, SEE LANDSCAPE FOR LOCATION & APPEARANCE

ELEVATION
 $0'-0" = 54'-9"$

LOWER LEVEL ELEVATION
 $0'-3" = 55'-0"$

GARAGE FLOOR ELEVATION
 $11'-3" = 66'-0"$

MAIN LEVEL ELEVATION
 $11'-3" = 66'-0"$




SITE PLAN - LOT 1
SCALE: 1/8"=1'-0"

A1.1

MOSS BEACH - LOT 1

VALLEMAR ST. & JULIANNA AVE.

REVISION NO.	DATE
COASTSIDE DESIGN REVIEW APPLICATION	
DRAWING AREA PLANS	
PROJECT NUMBER: 1507	
DATE: JULY 24, 2017	
REVISION 1 08.25.17	
DESIGN REVIEW SET	
SHEET NO.	

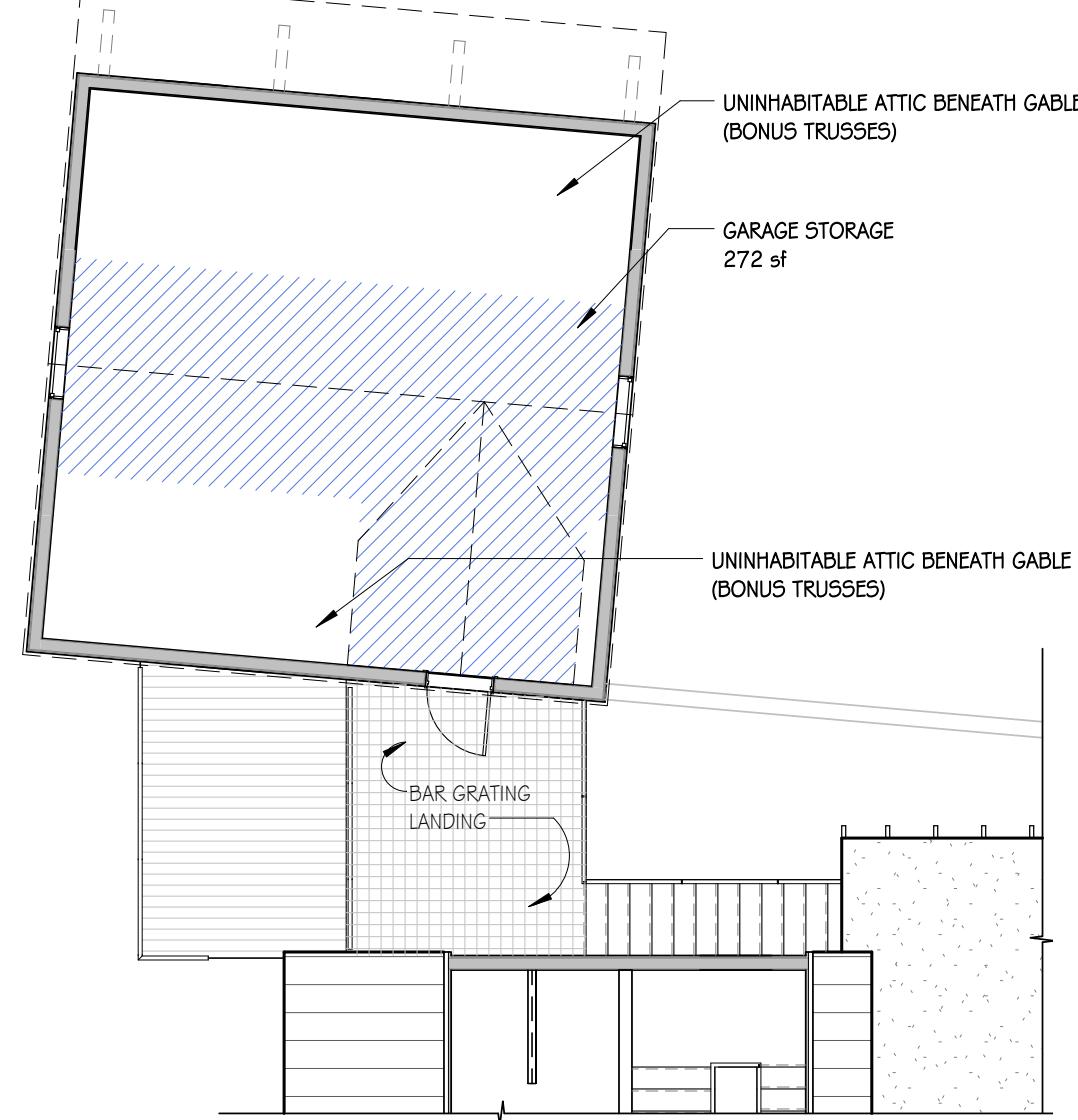A0.1**4 GARAGE STORAGE LEVEL AREA PLAN**

1/8" = 1'-0"

SQUARE FOOTAGES

LOWER LEVEL (GROSS)	1,763 sf
MAIN LEVEL (GROSS)	2,234 sf
TOTAL SQ. FT.	3,997 sf

GARAGE (GROSS)	576 sf
GARAGE STORAGE (GROSS)	272 sf

ROOF ACCESS (HABITABLE)	239 sf
-------------------------	--------

COVERED ENTRY PATIO	168 sf
COVERED REAR DECK	333 sf

ELEVATED DECKS

ENTRY DECK	189 sf
GARAGE DECK	182 sf
REAR DECK	410 sf
	781 sf

$$(1,763' + 576' + 781') / 23,473' =$$


TOTAL LOT COVERAGE 13.29%

$$(5084') / 23,473' =$$


FLOOR AREA RATIO (FAR) .21

HATCH LEGEND


CONDITIONED FLOOR AREA per SECTION G308C SUBSECTION a. (1) The floor area of all stories excluding uninhabitable attics as measured from the outside face of all exterior perimeter walls.	
COVERED PATIO OR DECK per SECTION G308C SUBSECTION a. (2) The area of all decks, porches, balconies or other areas covered by a waterproof roof which extends four (4) or more feet from exterior walls.	
UNCONDITIONED (GARAGE) FLOOR AREA per SECTION G308C SUBSECTION a. (3) The area of all garages and carports	

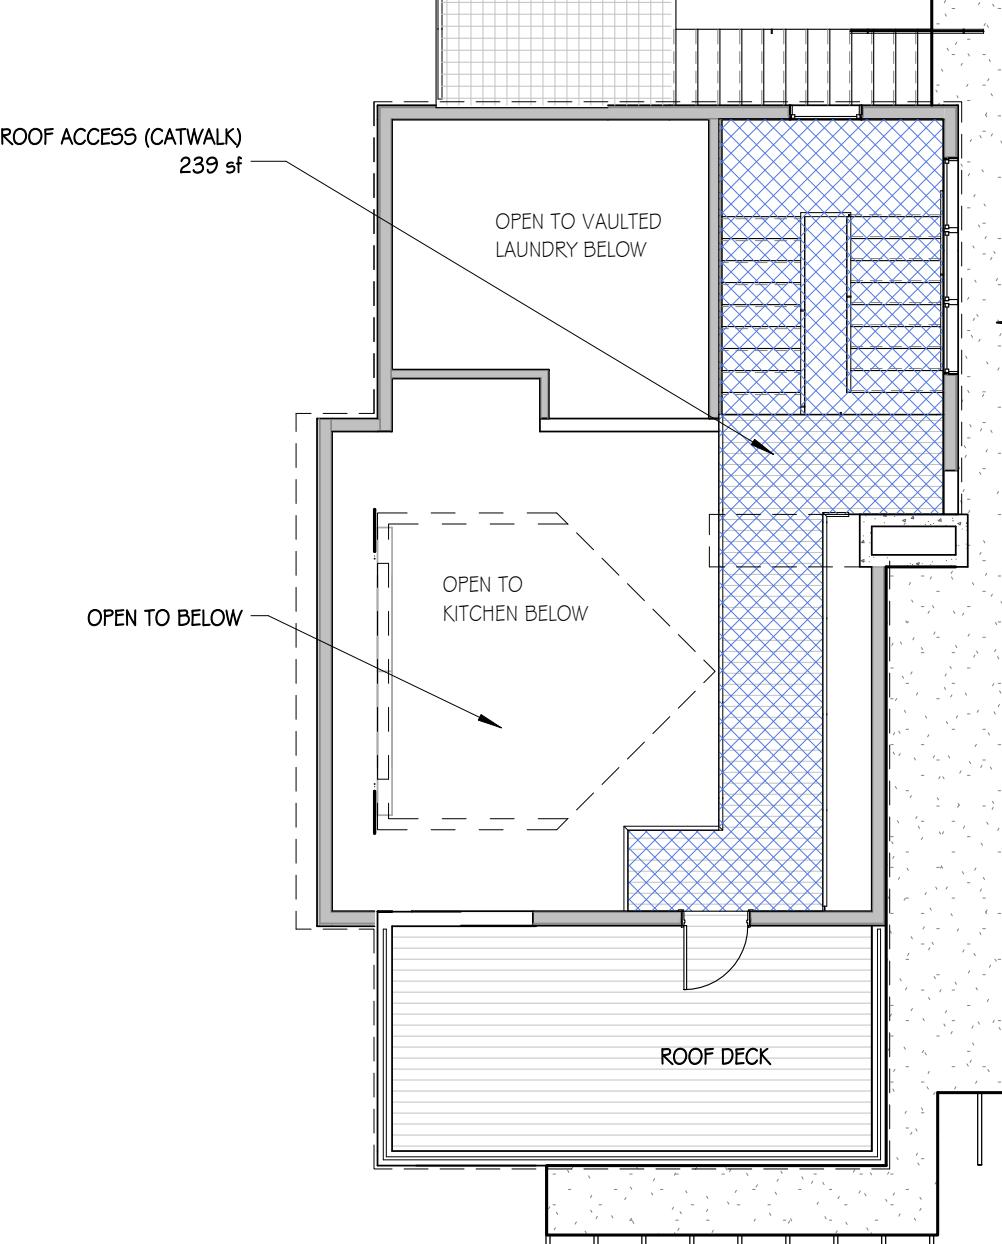**3 ROOF ACCESS - AREA PLAN**

1/8" = 1'-0"

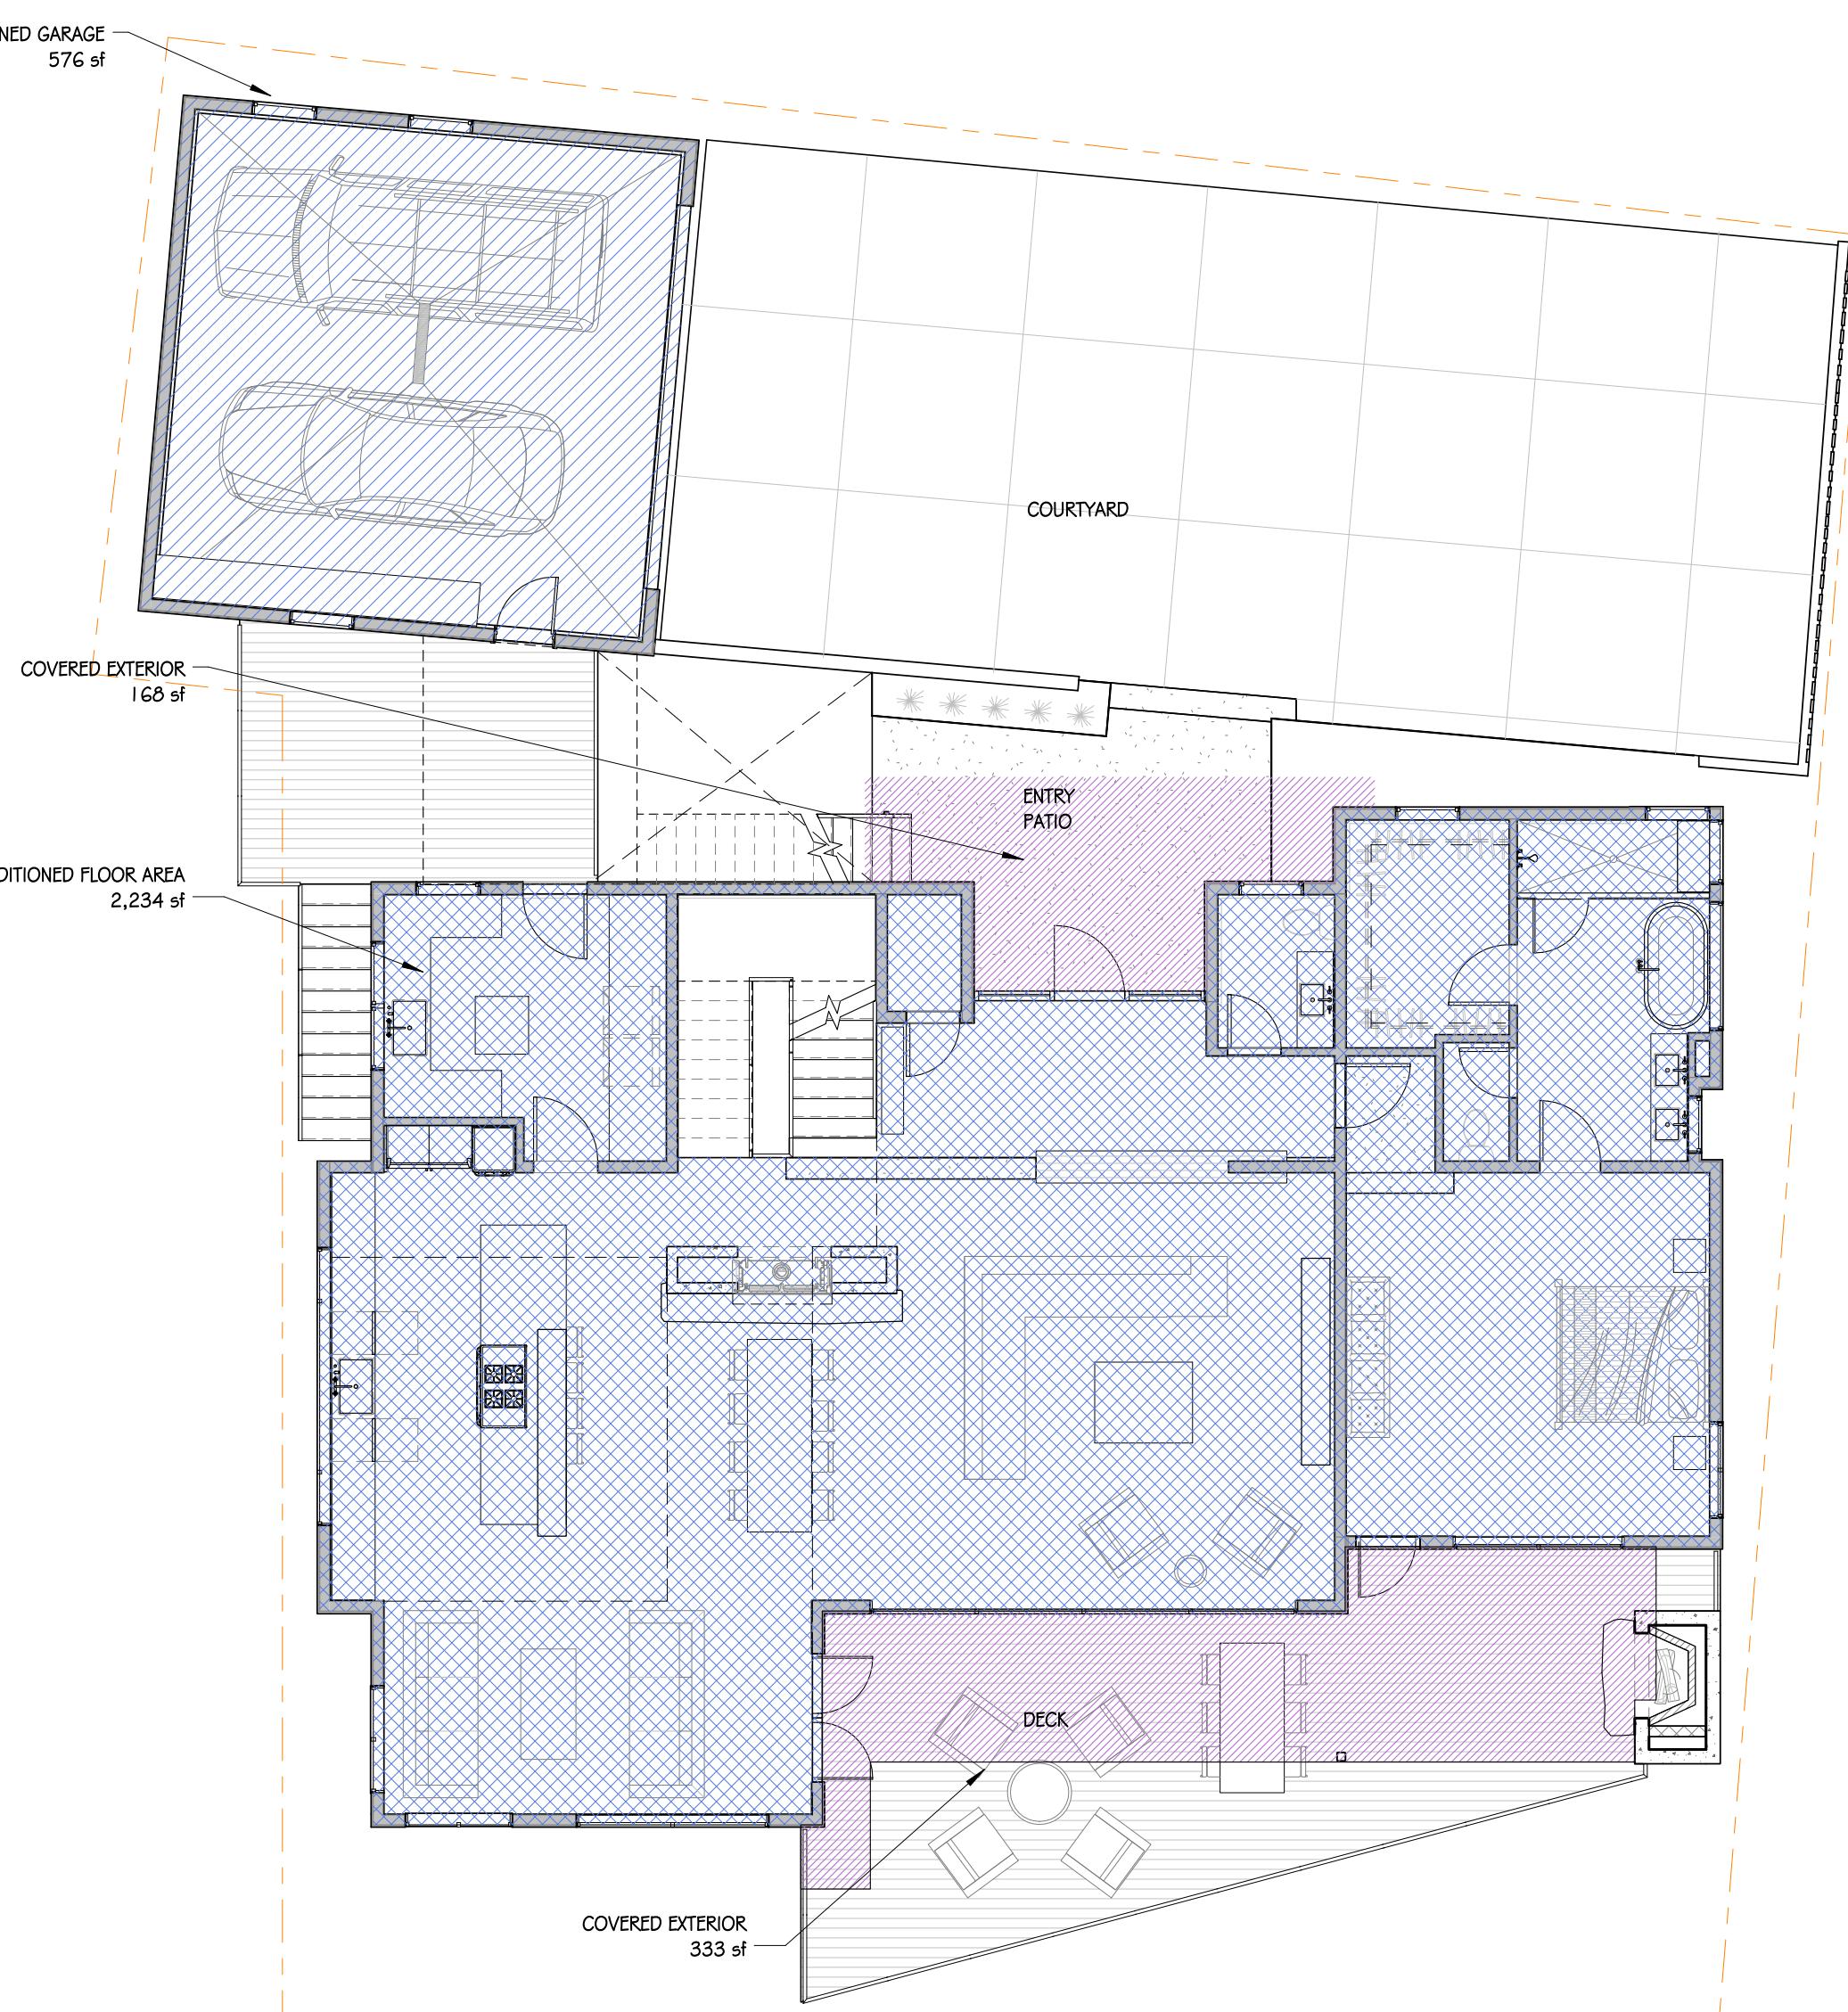**2 MAIN LEVEL - AREA PLAN**

1/8" = 1'-0"

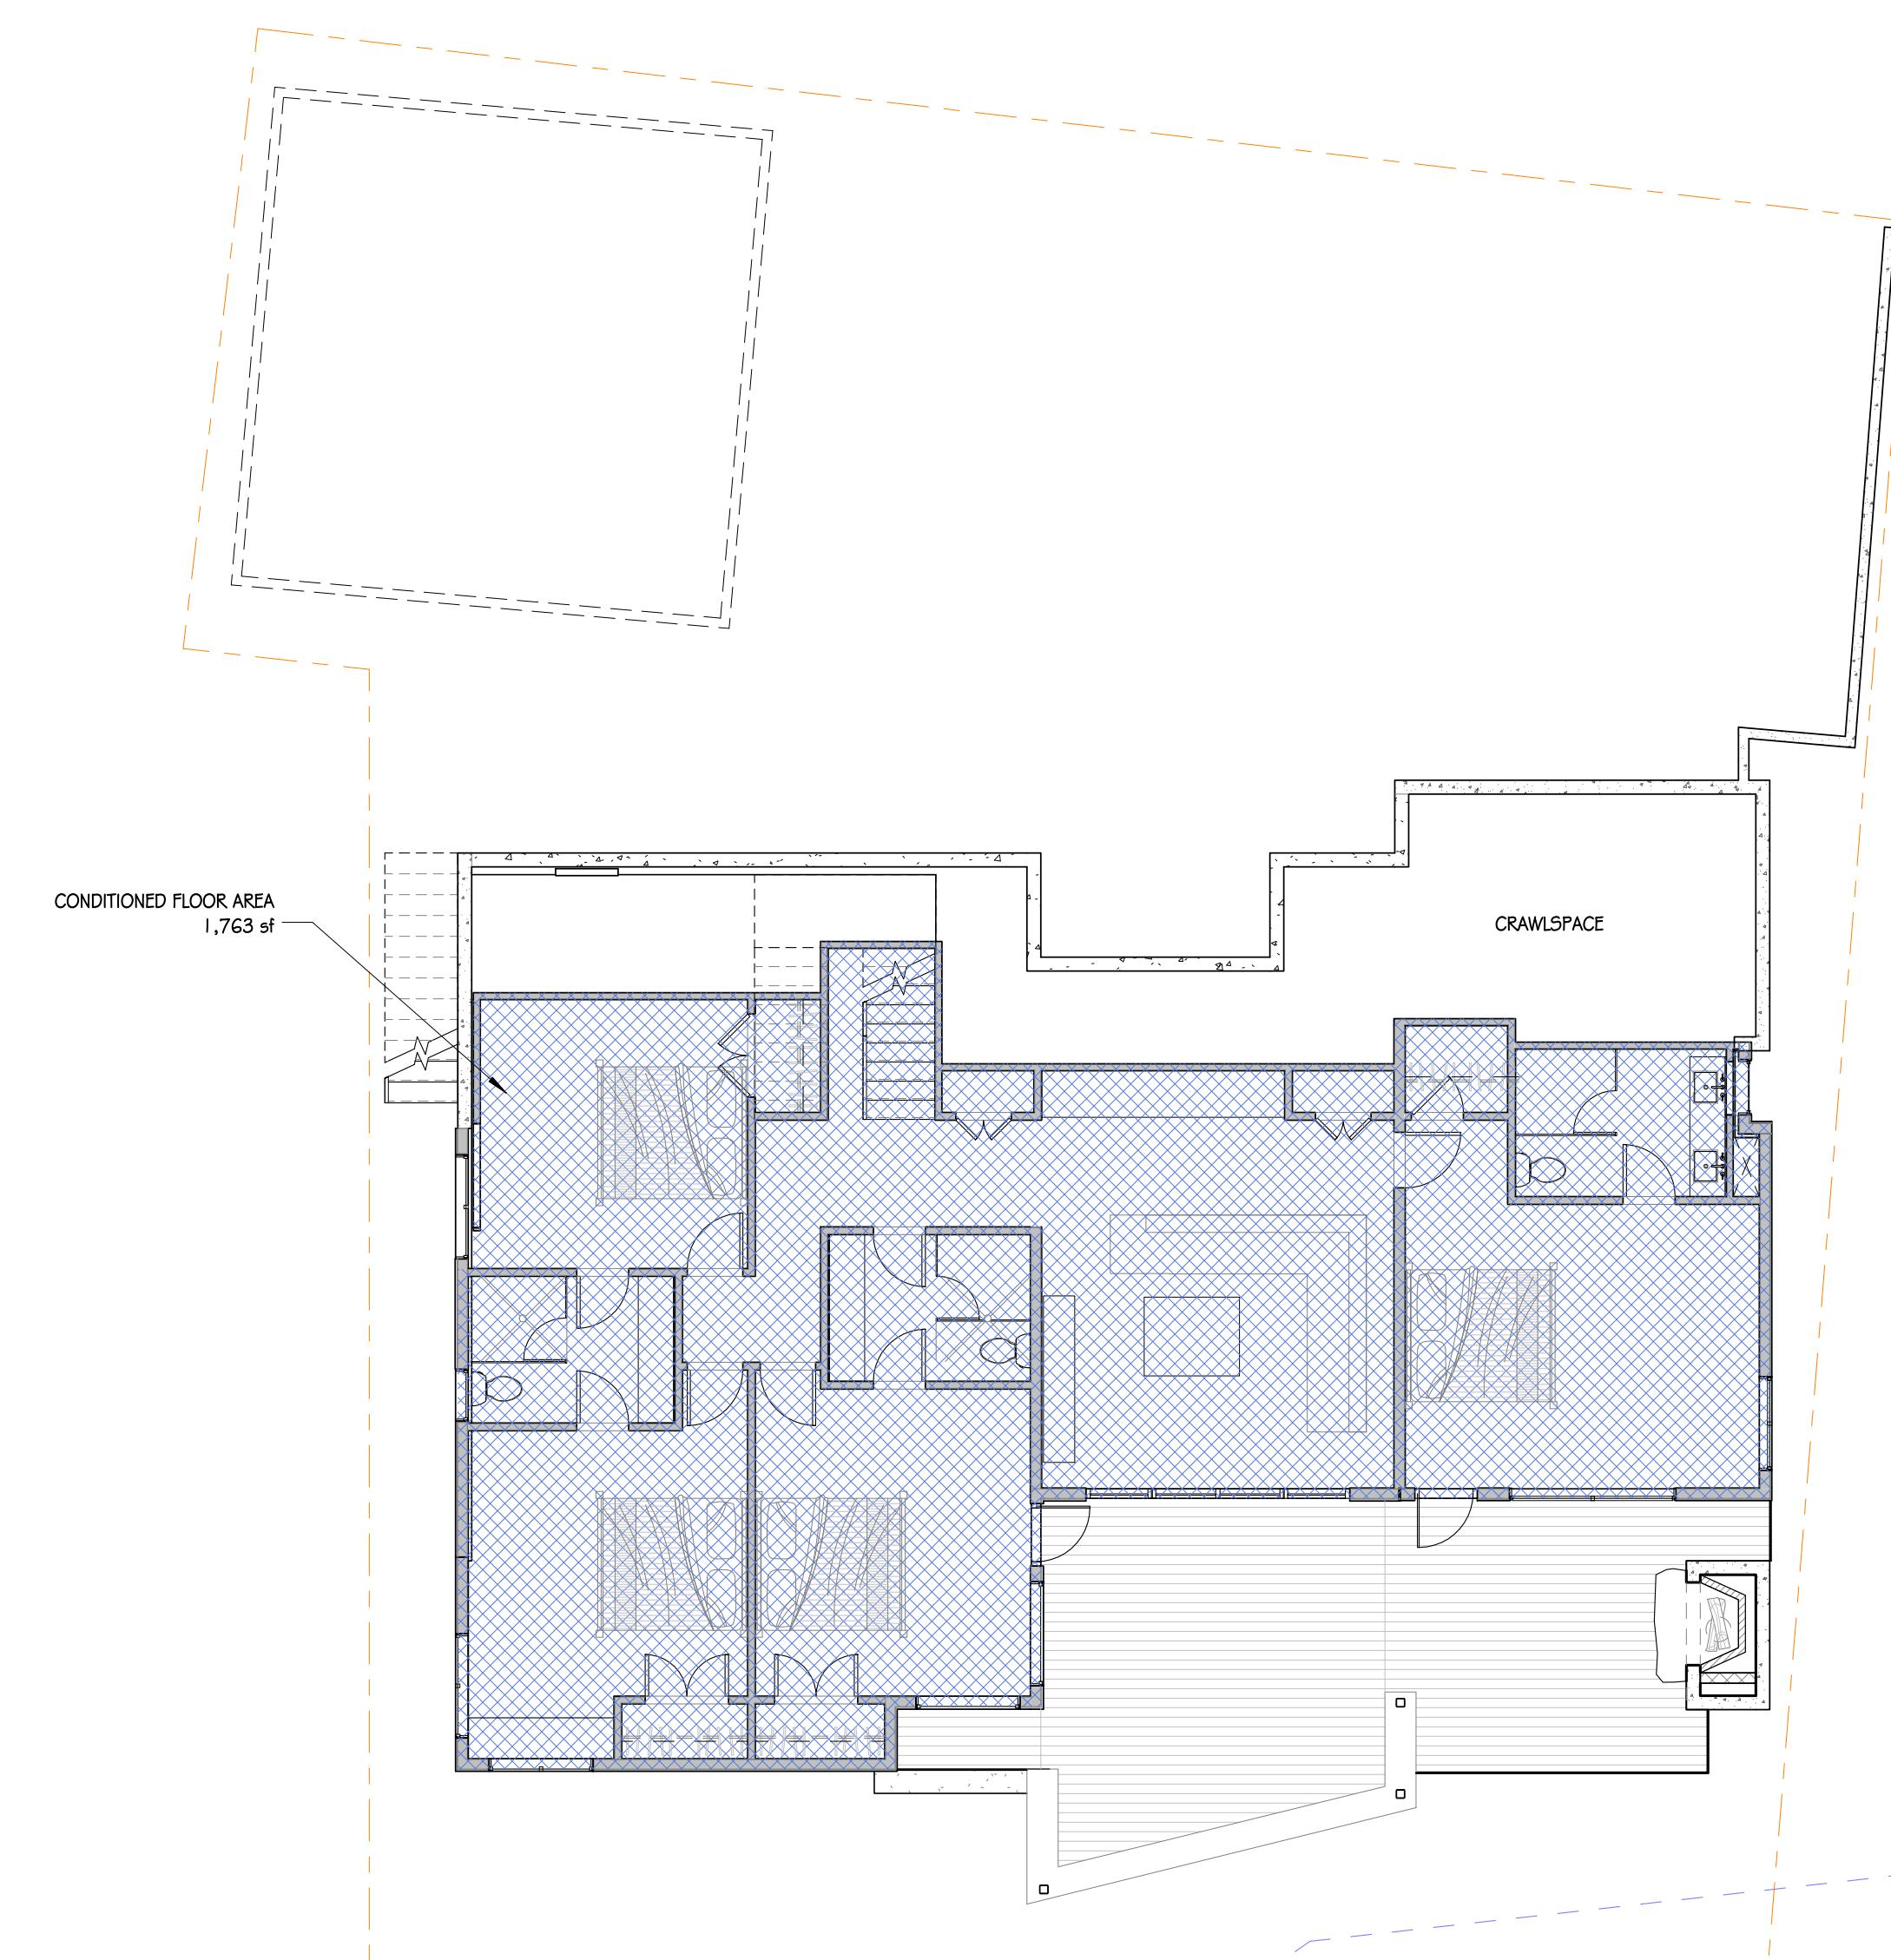**1 LOWER LEVEL - AREA PLAN**

1/8" = 1'-0"

MOSS BEACH - LOT 1

VALLEMAR ST. & JULIANNA AVE.

COASTSIDE DESIGN
REVIEW APPLICATION


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FLOOR PLANS


PROJECT NUMBER: 1507
DATE: JULY 24, 2017
REVISION I 08.25.17
DESIGN REVIEW SET

SHEET NO:

A2.1

1 LOWER LEVEL
1/4" = 1'-0"

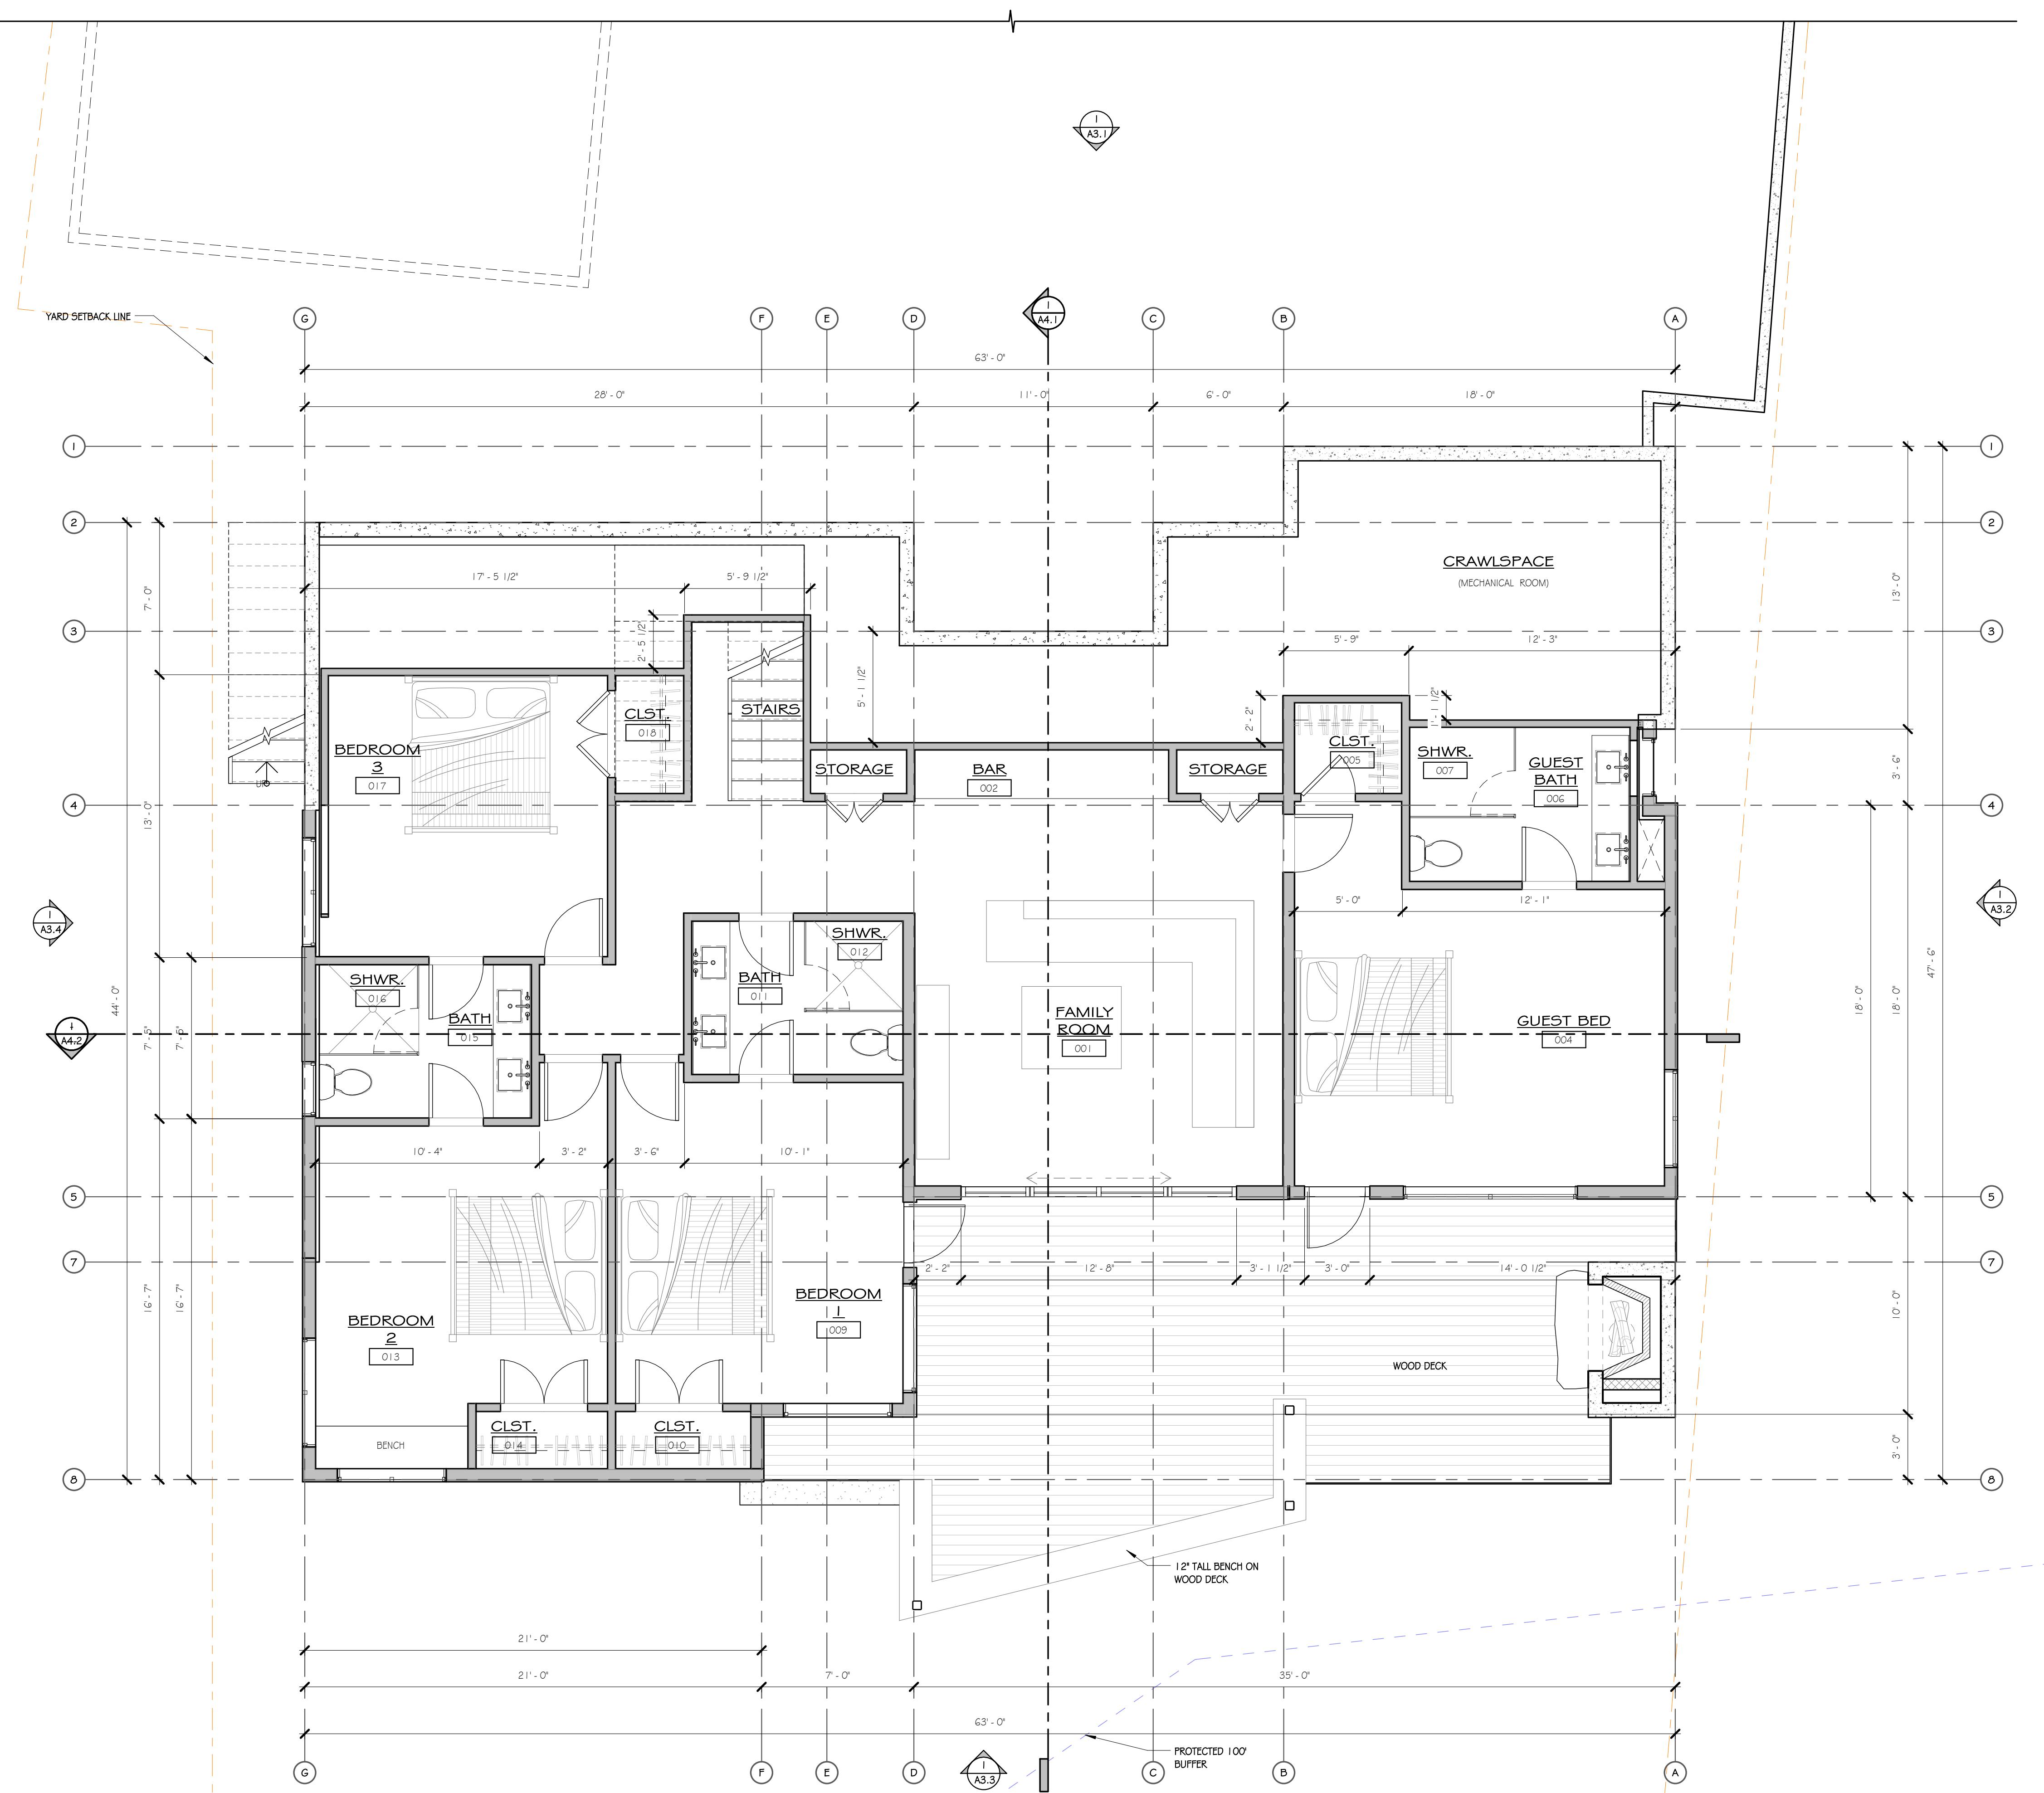

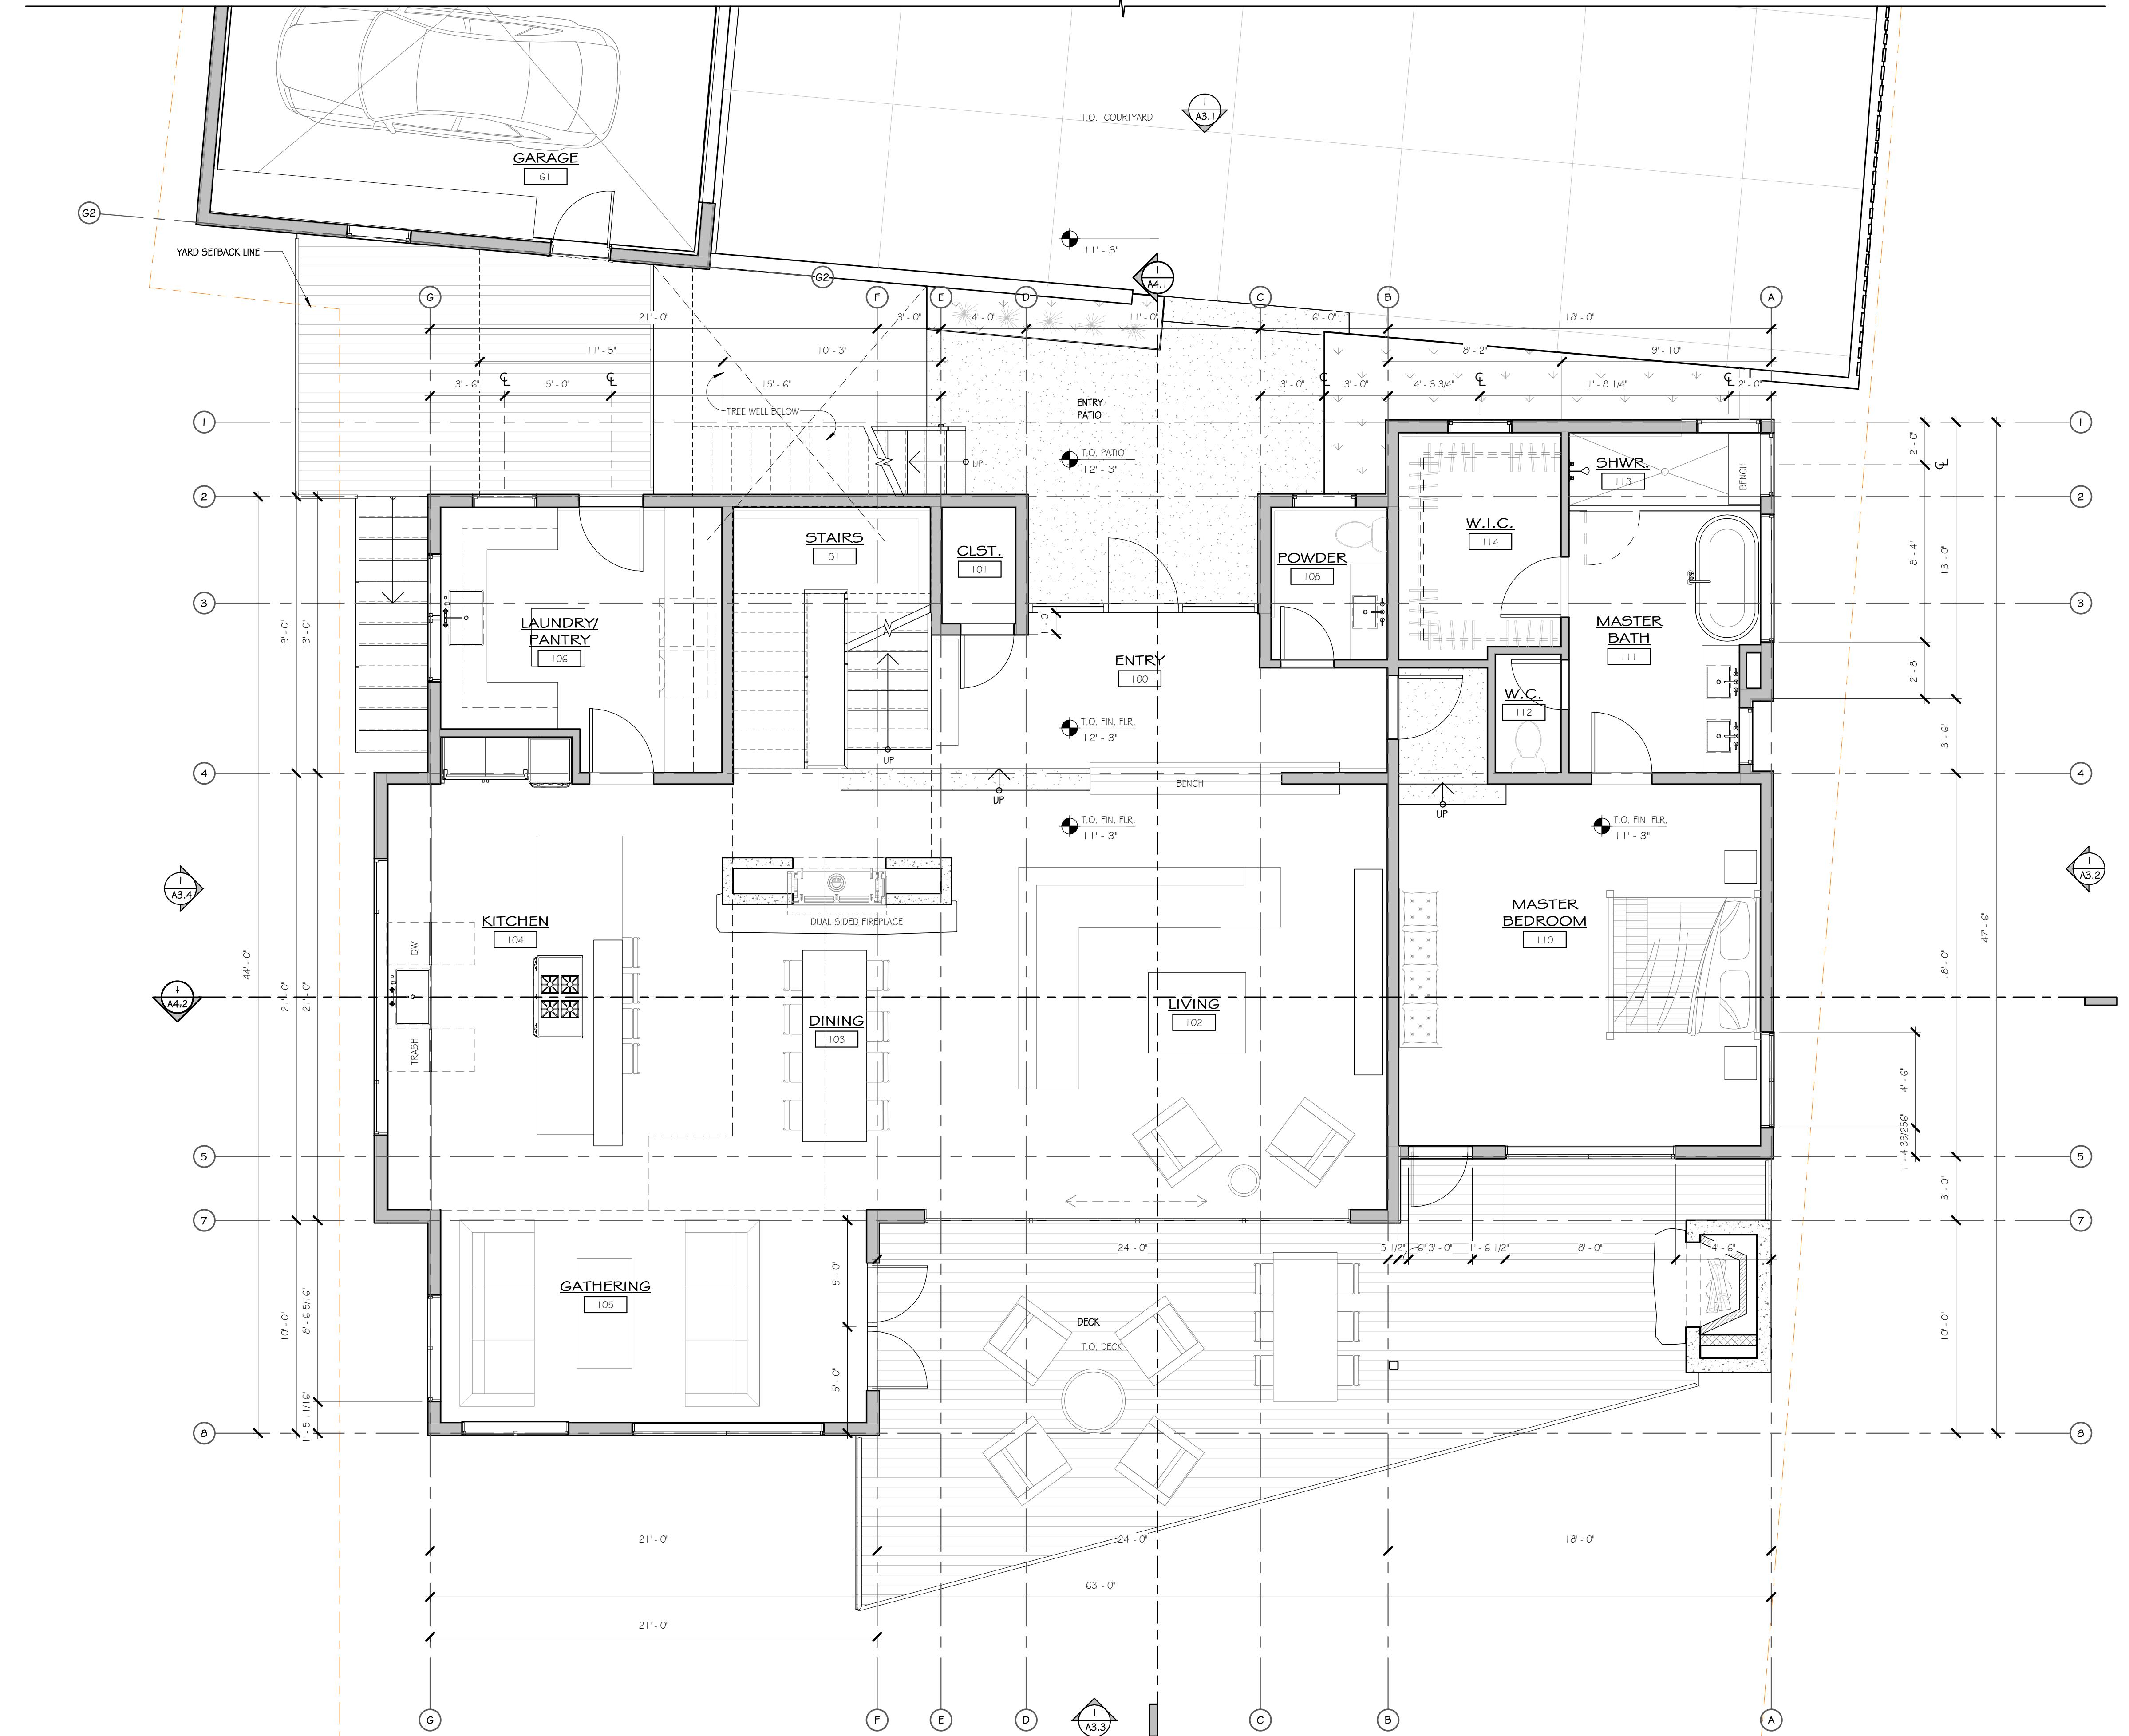

1 MAIN LEVEL
1/4" = 1'-0"

MOSS BEACH - LOT 1
VALLEMAR ST. & JULIANNA AVE.

COASTSIDE DESIGN
REVIEW APPLICATION

DRAWING:
FLOOR PLANS

PROJECT NUMBER: 1507
DATE: JULY 24, 2017
REVISION I 08.25.17
DESIGN REVIEW SET

SHEET NO:

A2.2

MOSS BEACH - LOT 1

VALLEMAR ST. & JULIANNA AVE.

COASTSIDE DESIGN
REVIEW APPLICATION

DRAWING
COURTYARD PLAN


PROJECT NUMBER: I507
DATE: JULY 24, 2017
REVISION I 08.25.17
DESIGN REVIEW SET

SHEET NO.

A2.3

THESE DRAWINGS ARE THE ORIGINAL UNPUBLISHED WORK
OF THE ARCHITECT AND MAY NOT BE DUPLICATED OR USED
WITHOUT THE WRITTEN CONSENT OF THE ARCHITECT.


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SET, REV\01.LOT_NEWM.RW

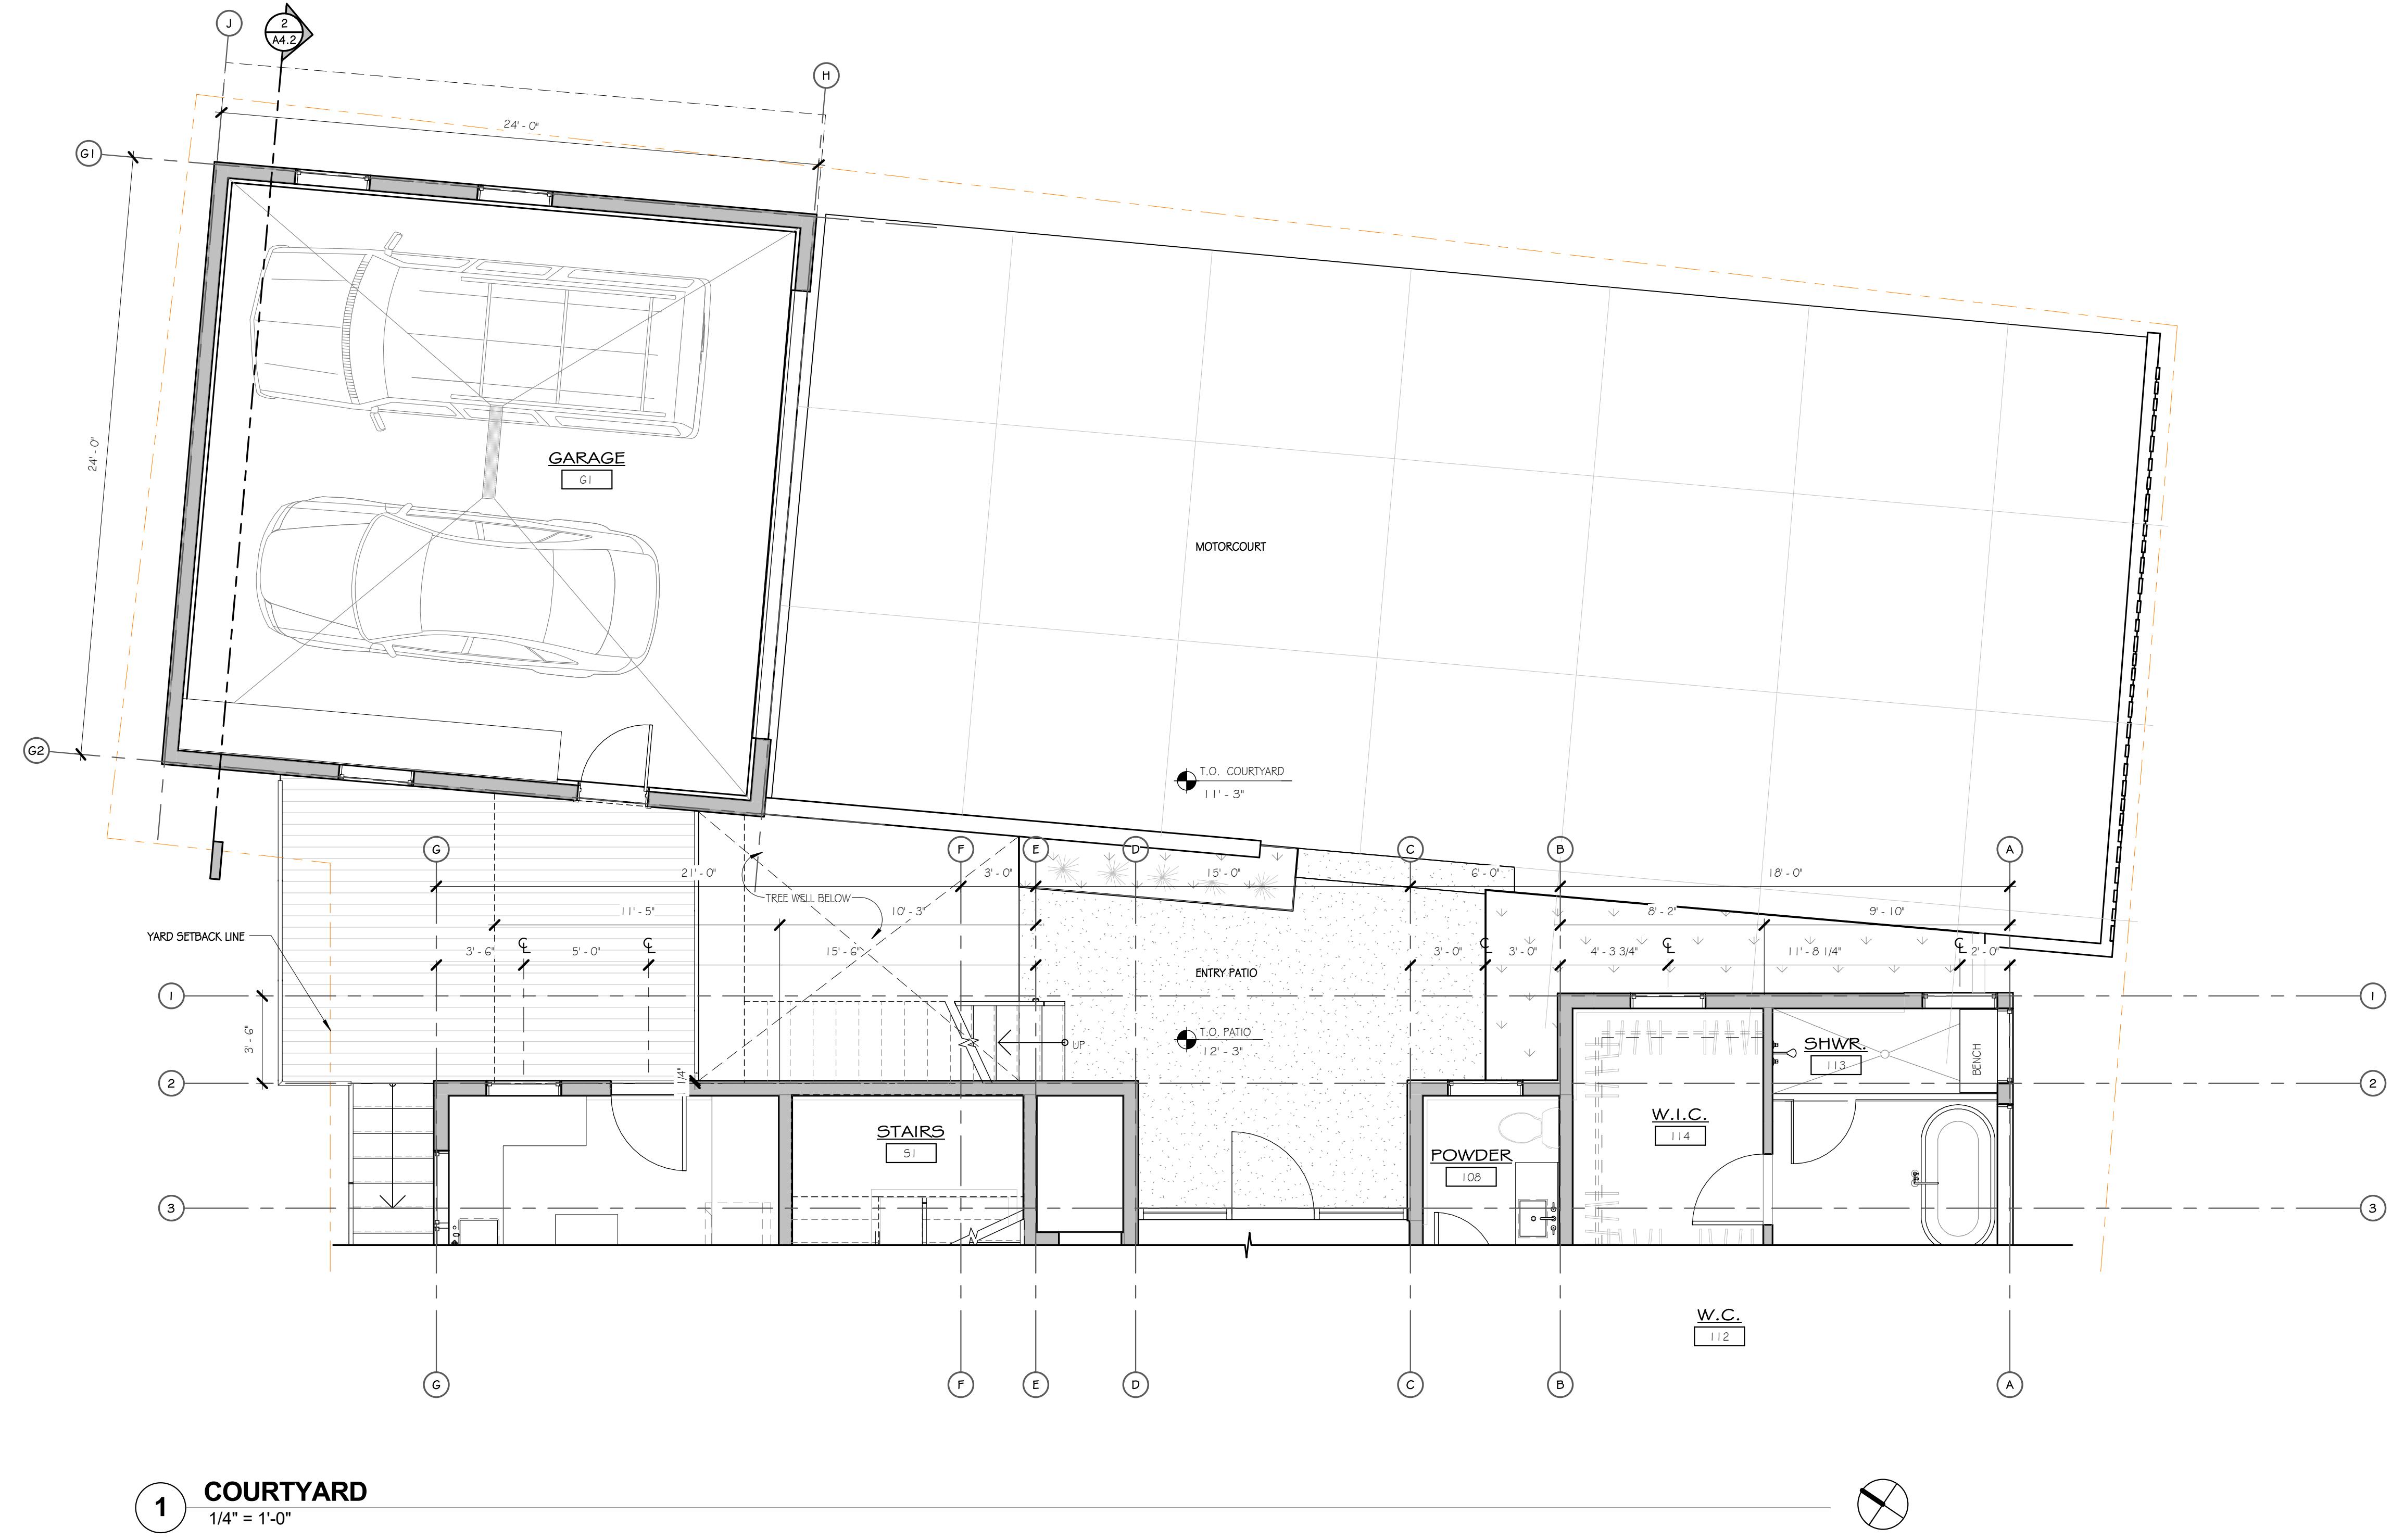


MOSS BEACH - LOT 1

VALLEMAR ST. & JULIANNA AVE.


REVISION NO.	DATE
COASTSIDE DESIGN REVIEW APPLICATION	
DRAWING	GARAGE STORAGE PLAN & ROOF PLAN
PROJECT NUMBER	I507
DATE	JULY 24, 2017
REVISION	I 08.25.17
DESIGN REVIEW SET	
SHEET NO.	A2.4

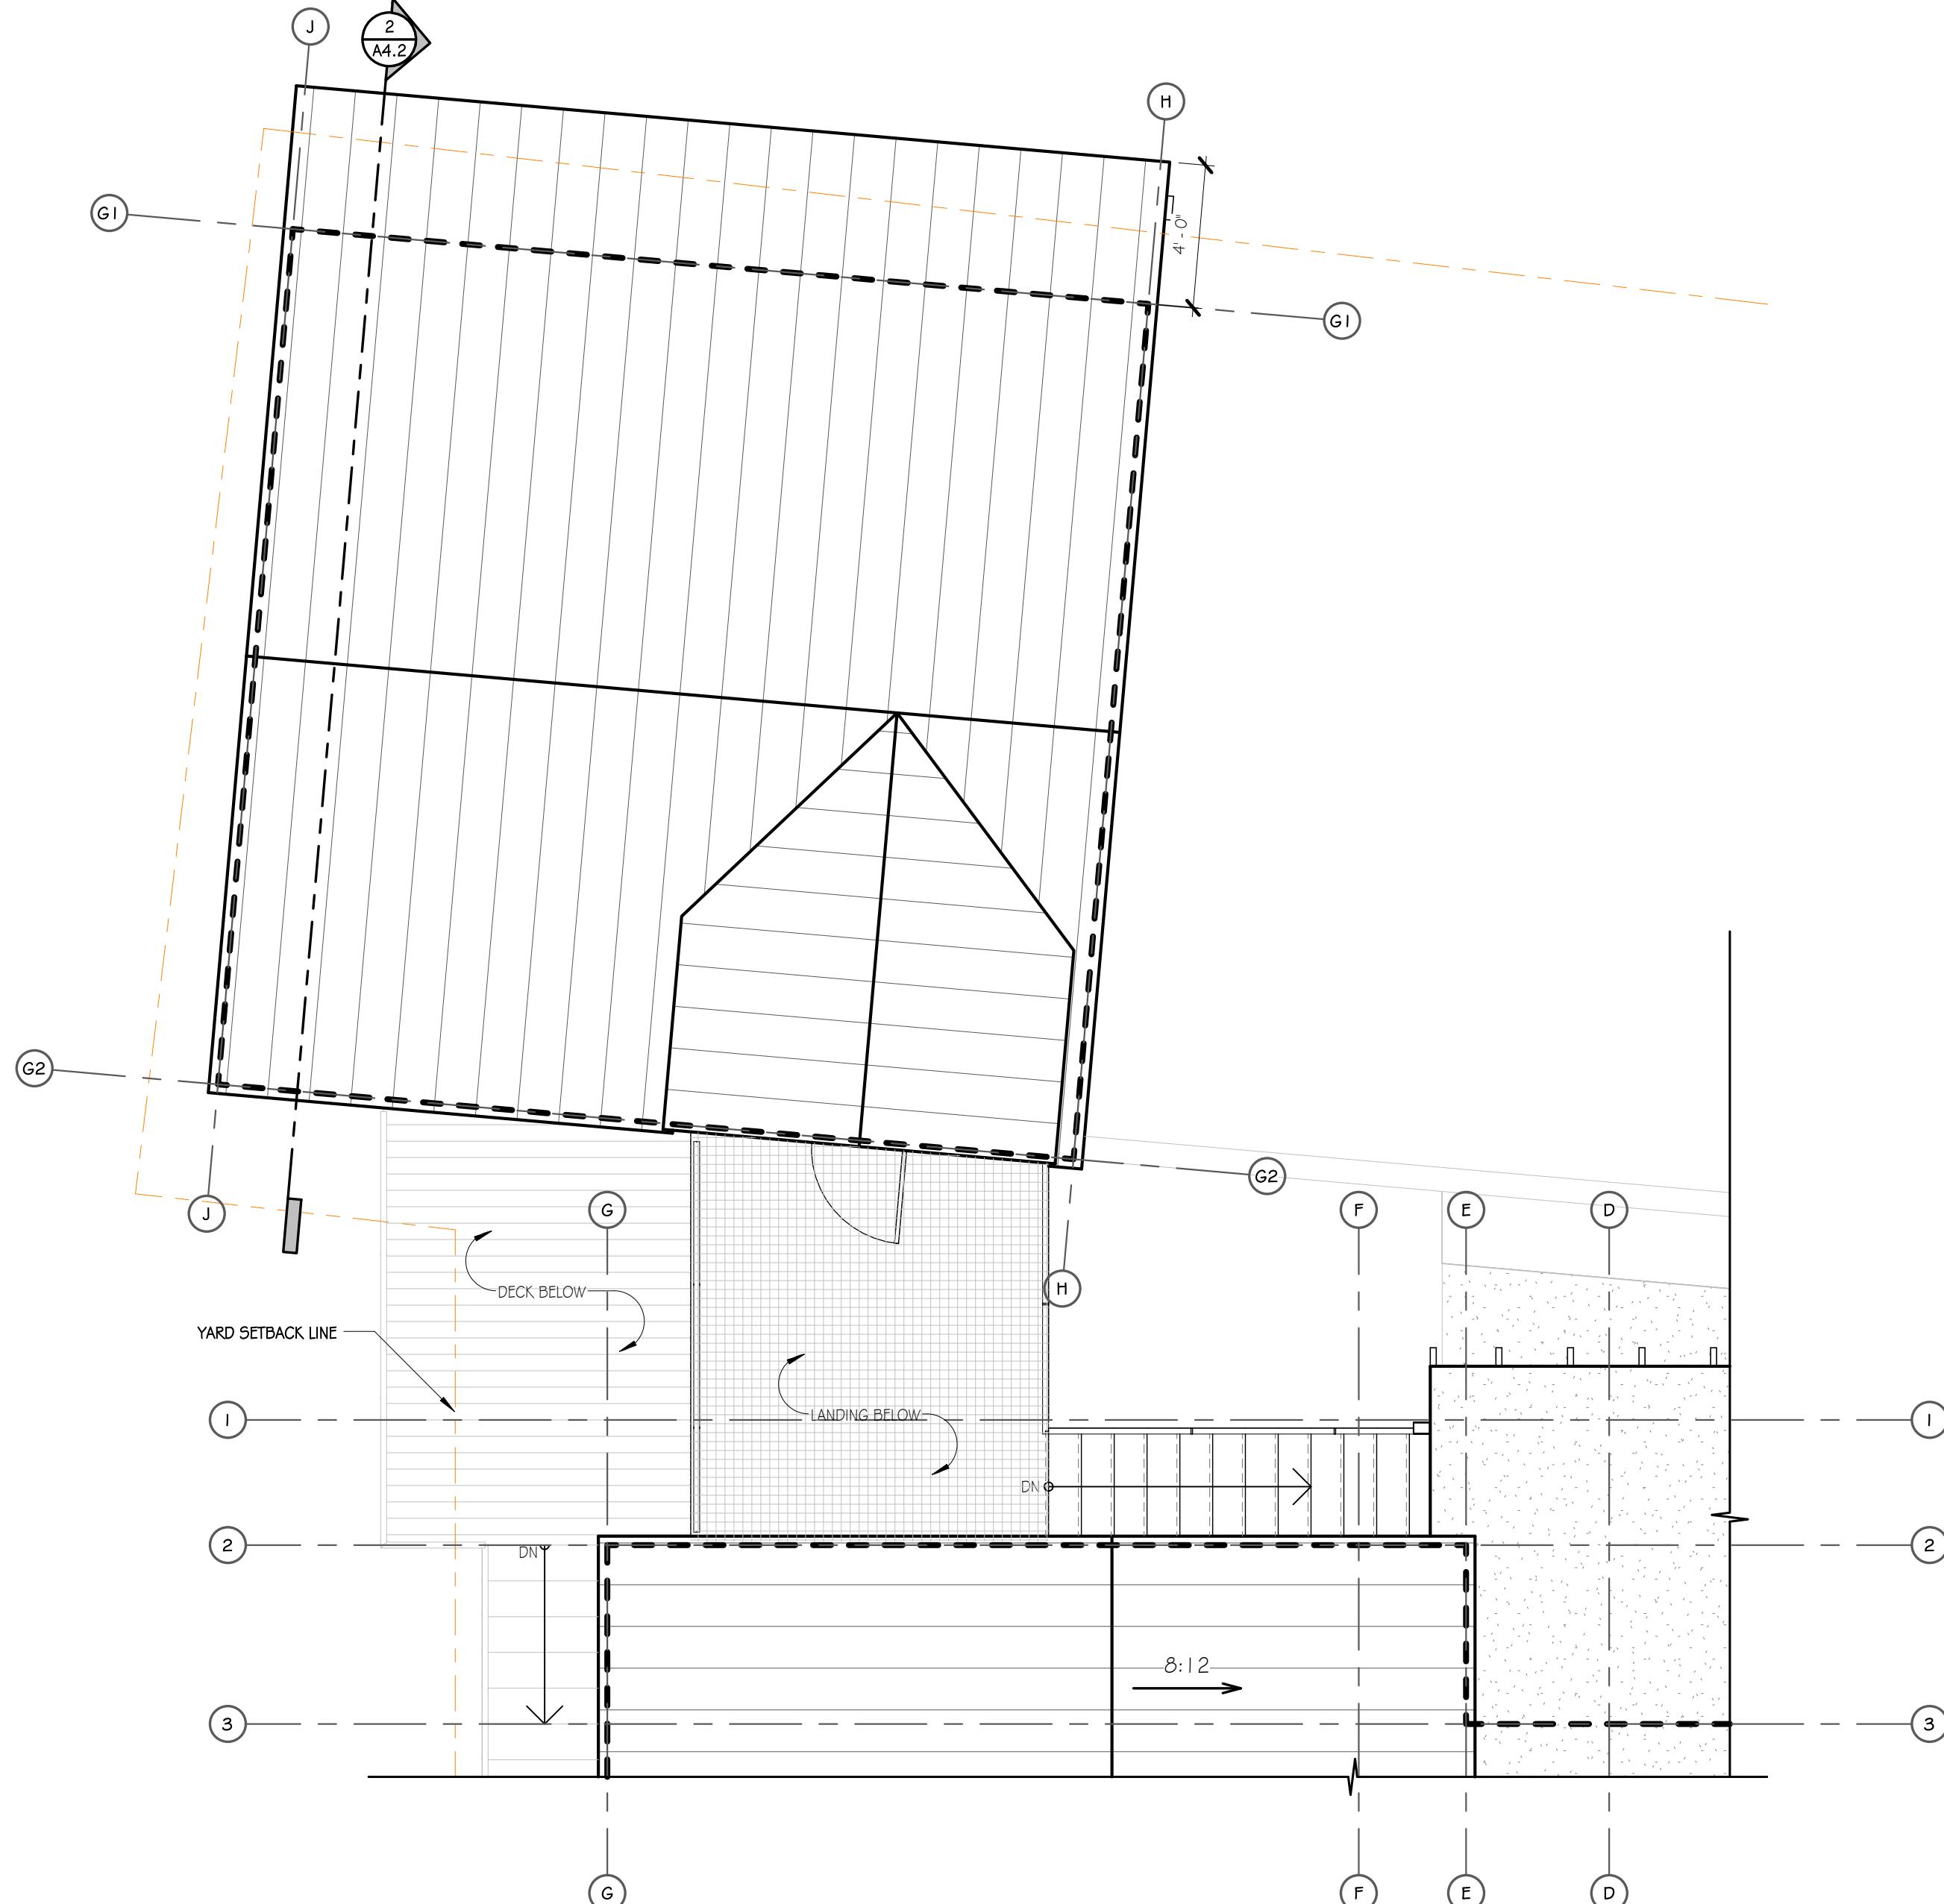


2 GARAGE ROOF PLAN
1/4" = 1'-0"

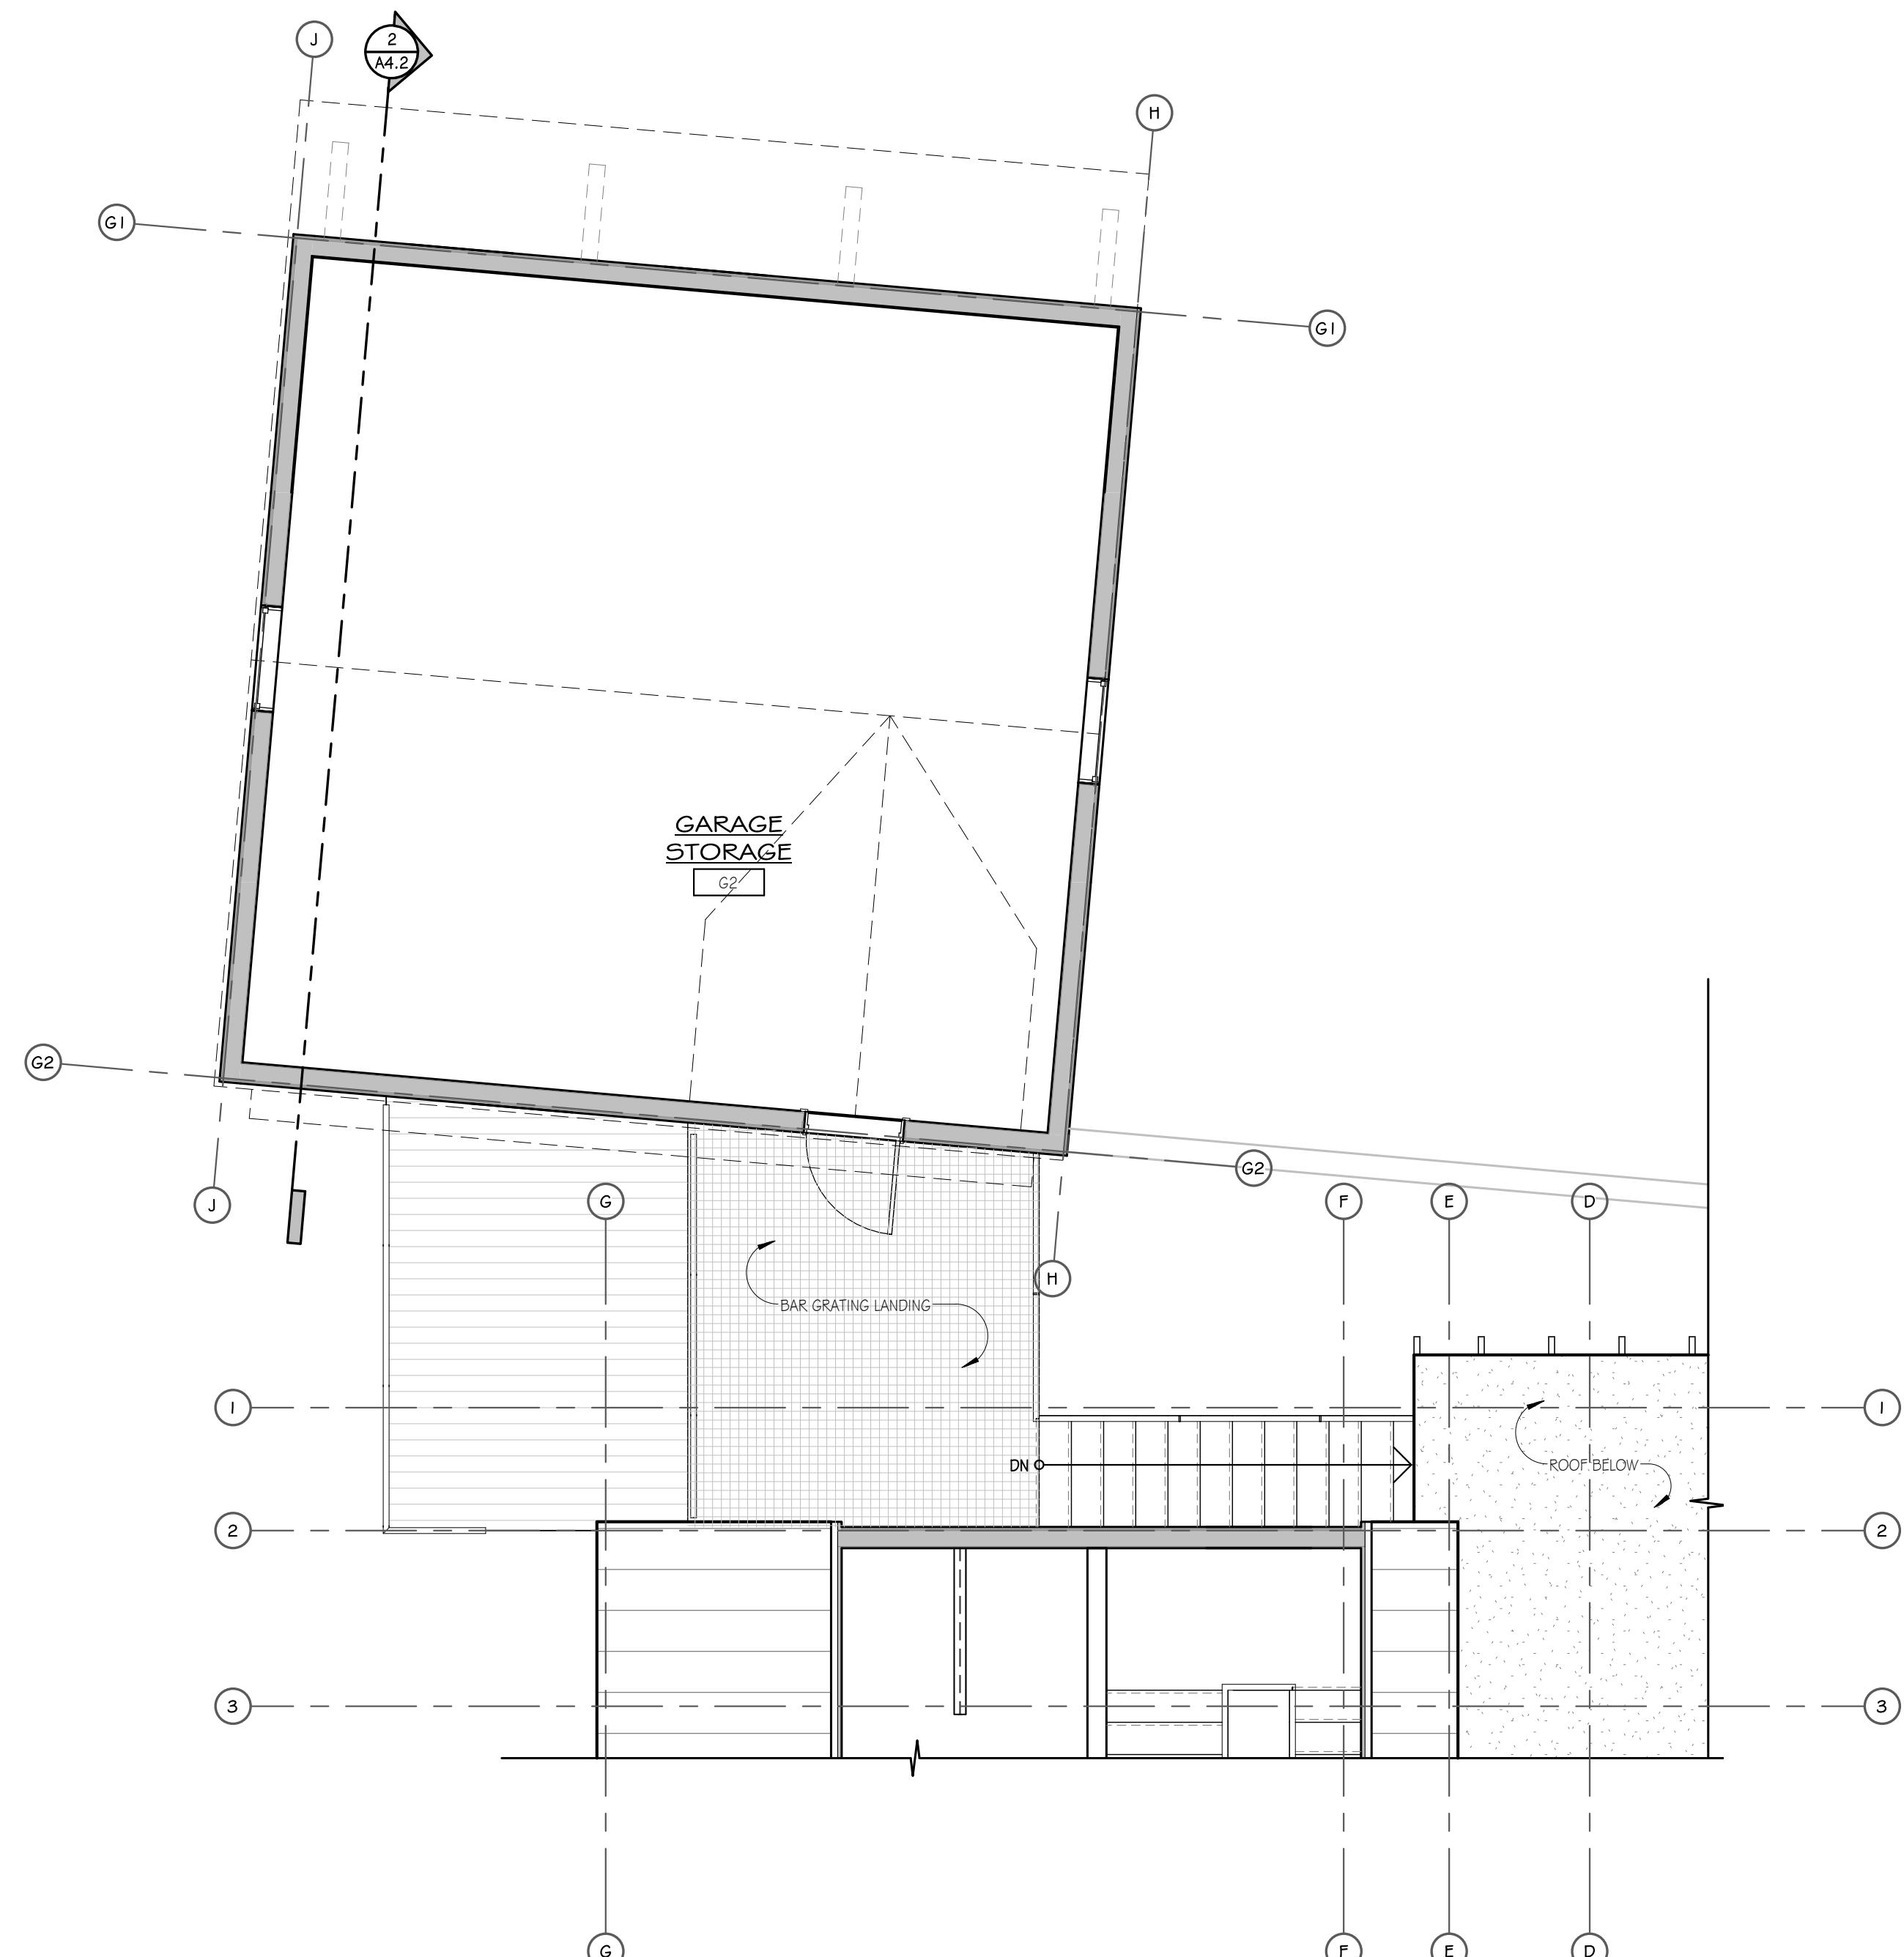

1 GARAGE STORAGE LEVEL
1/4" = 1'-0"

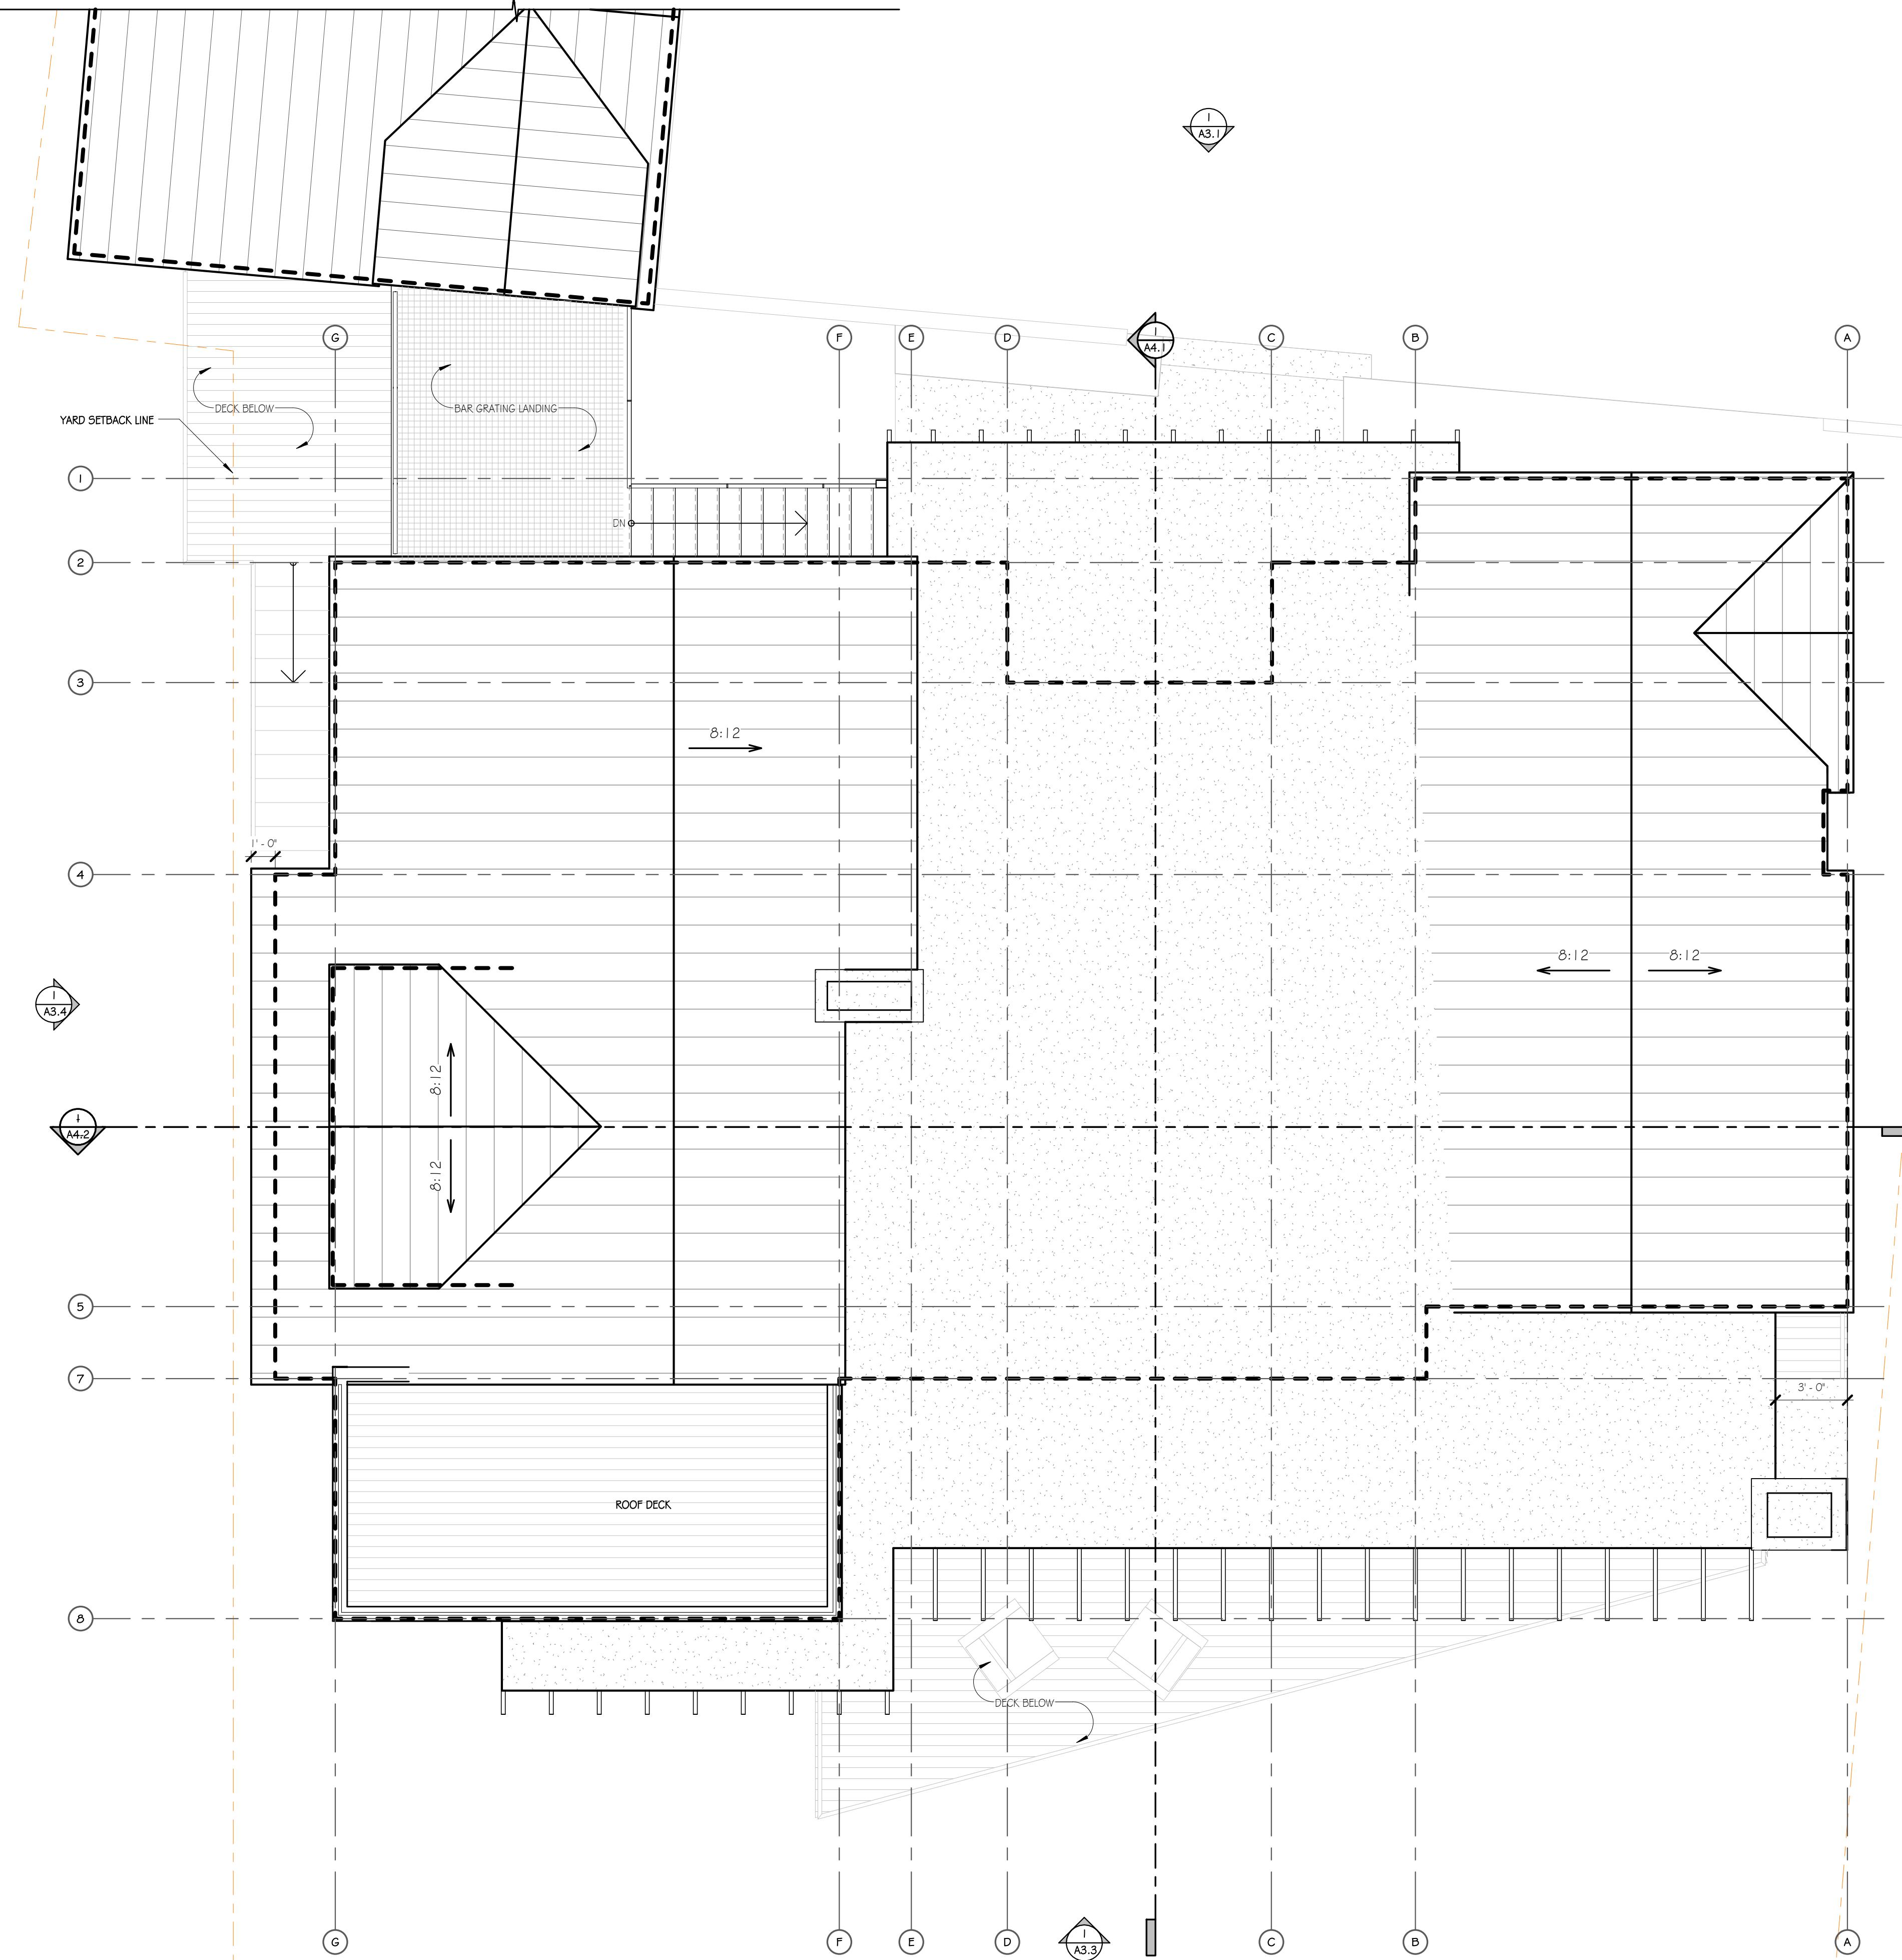

2 ROOF PLAN
1/4" = 1'-0"

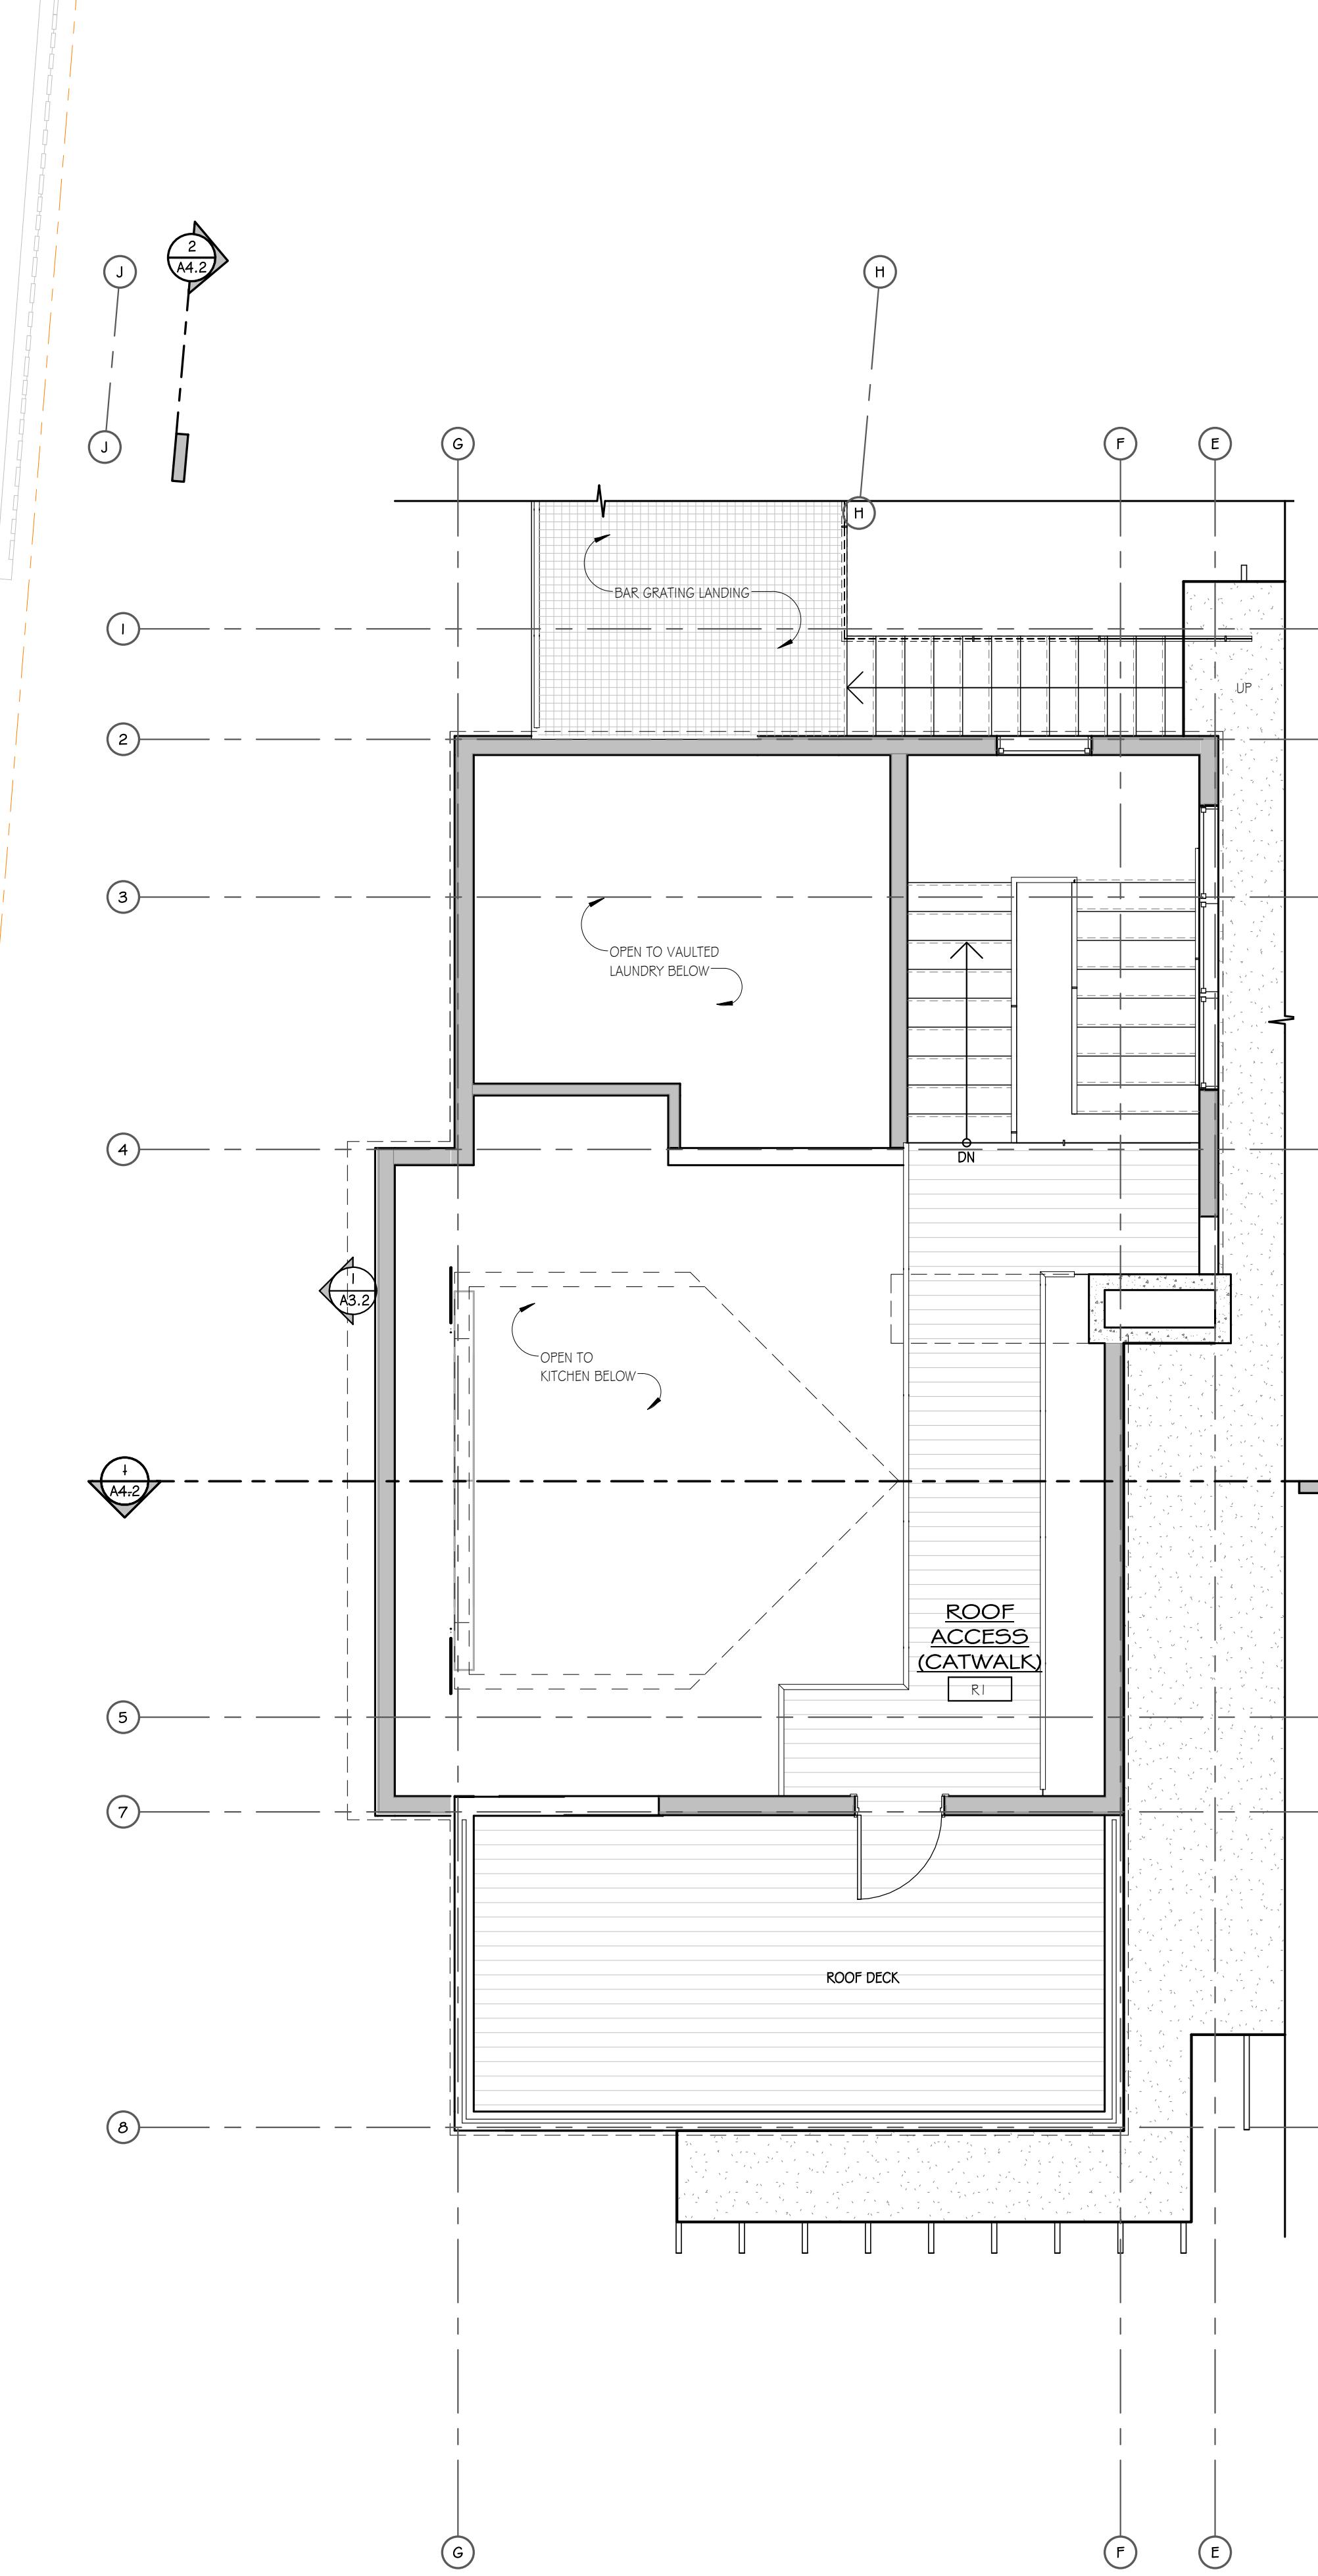

1 ROOF ACCESS
1/4" = 1'-0"

MOSS BEACH - LOT 1

VALLEMAR ST. & JULIANNA AVE.

REVISION NO.	DATE
COASTSIDE DESIGN REVIEW APPLICATION	
DRAWING ROOF PLAN & ROOF ACCESS	
PROJECT NUMBER: 1507	
DATE: JULY 24, 2017	
REVISION 1 08.25.17	
DESIGN REVIEW SET	
SHEET NO. A2.5	

MATERIALS



SIDING
1x8 ROUGH-SAWN CEDAR, OR REDWOOD
HORIZONTAL PLANK RAINSCREEN
W/ REVEAL EVERY THIRD BOARD



SIDING
CEMENTITIOUS PANELS



WALLS
CMU VENEER,
(OR BOARD-FORMED CONCRETE)




ROOF
STANDING SEAM
METAL ROOF
W/ BONDERIZED FINISH




FLAT ROOF
EPDM MEMBRANE
W/ SCREE BALLAST



SOFFITS
ROUGH-SAWN CEDAR
(OR REDWOOD)

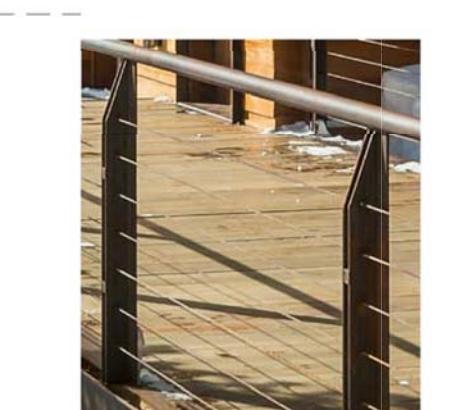

RAILINGS & TRIM
STAINLESS STEEL CABLE RAILINGS
& STAINLESS STEEL TRIM

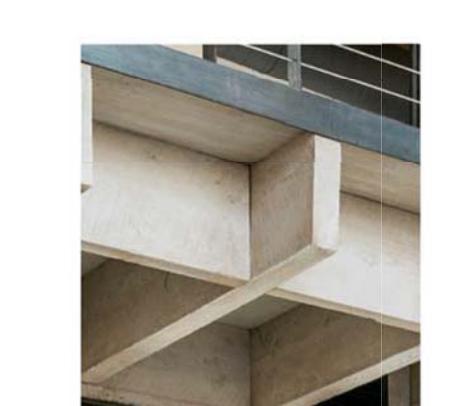

RAFTERS
ROUGH SAWN FIR

MOSS BEACH - LOT 1

VALLEMAR ST. & JULIANNA AVE.



1 NORTH ELEVATION
1/4" = 1'-0"

A3.1





COASTSIDE DESIGN
REVIEW APPLICATION

DRAWING:
ELEVATIONS

PROJECT NUMBER: 1507
DATE: JULY 24, 2017
REVISION: 08.25.17
DESIGN REVIEW SET

SHEET NO:

1 EAST ELEVATION
1/4" = 1'-0"

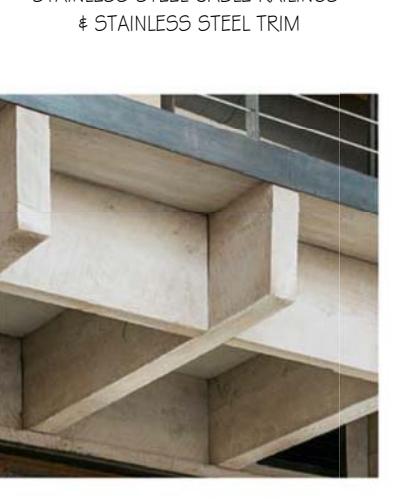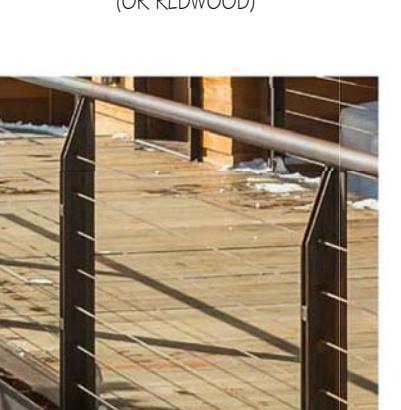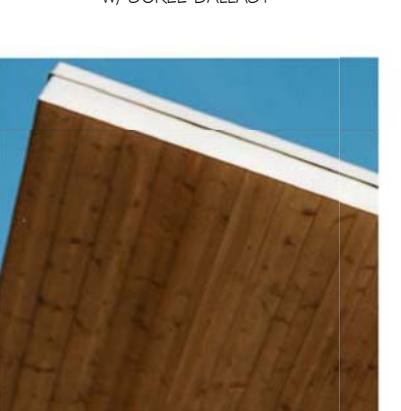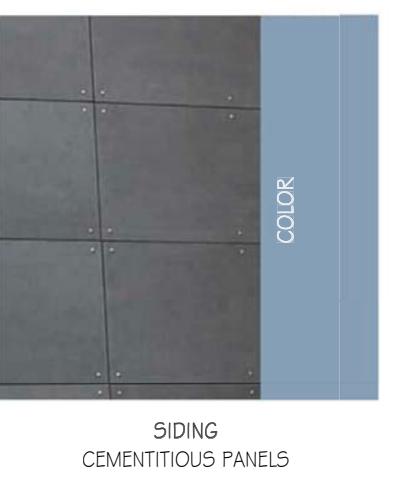

RAPTERS
ROUGH SAWN FIR

REVISION
NO. DATE

COASTSIDE DESIGN
REVIEW APPLICATION

DRAWING:
ELEVATIONS
PROJECT NUMBER: 1507
DATE: JULY 24, 2017
REVISION: 08.25.17
DESIGN REVIEW SET
SHEET NO:

MATERIALS
SIDING
1X8 ROUGH-SAWN CEDAR, OR REDWOOD
HORIZONTAL PLANK W/ REVEAL EVERY THIRD
BOARD






MOSS BEACH - LOT 1

VALLEMAR ST. & JULIANNA AVE.

PDC
PEARSON
DESIGN GROUP

102 N. BROADWAY AVE., BOZEMAN, MT 59715
OFFICE: 406.587.9991 FAX: 406.587.0391
WWW.PEARSONDESIGNGROUP.COM

A3.2

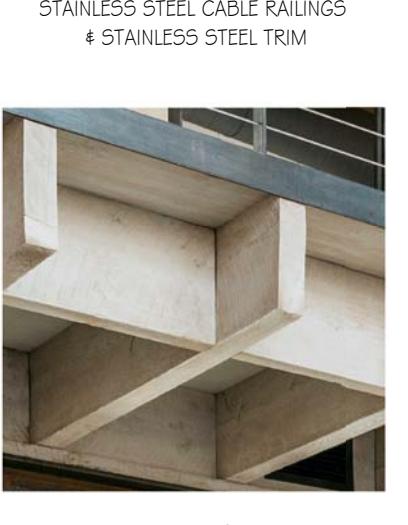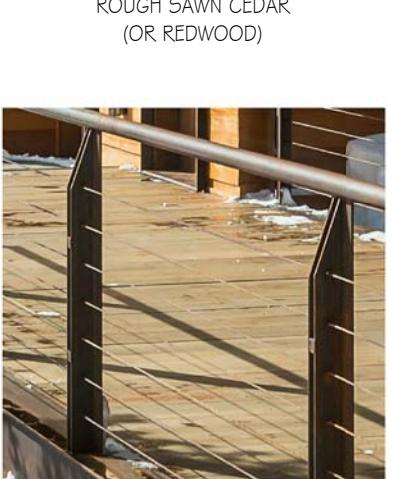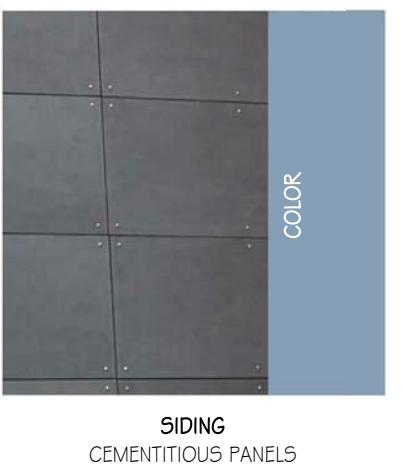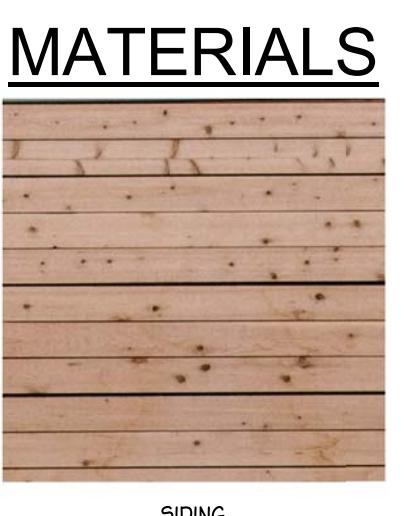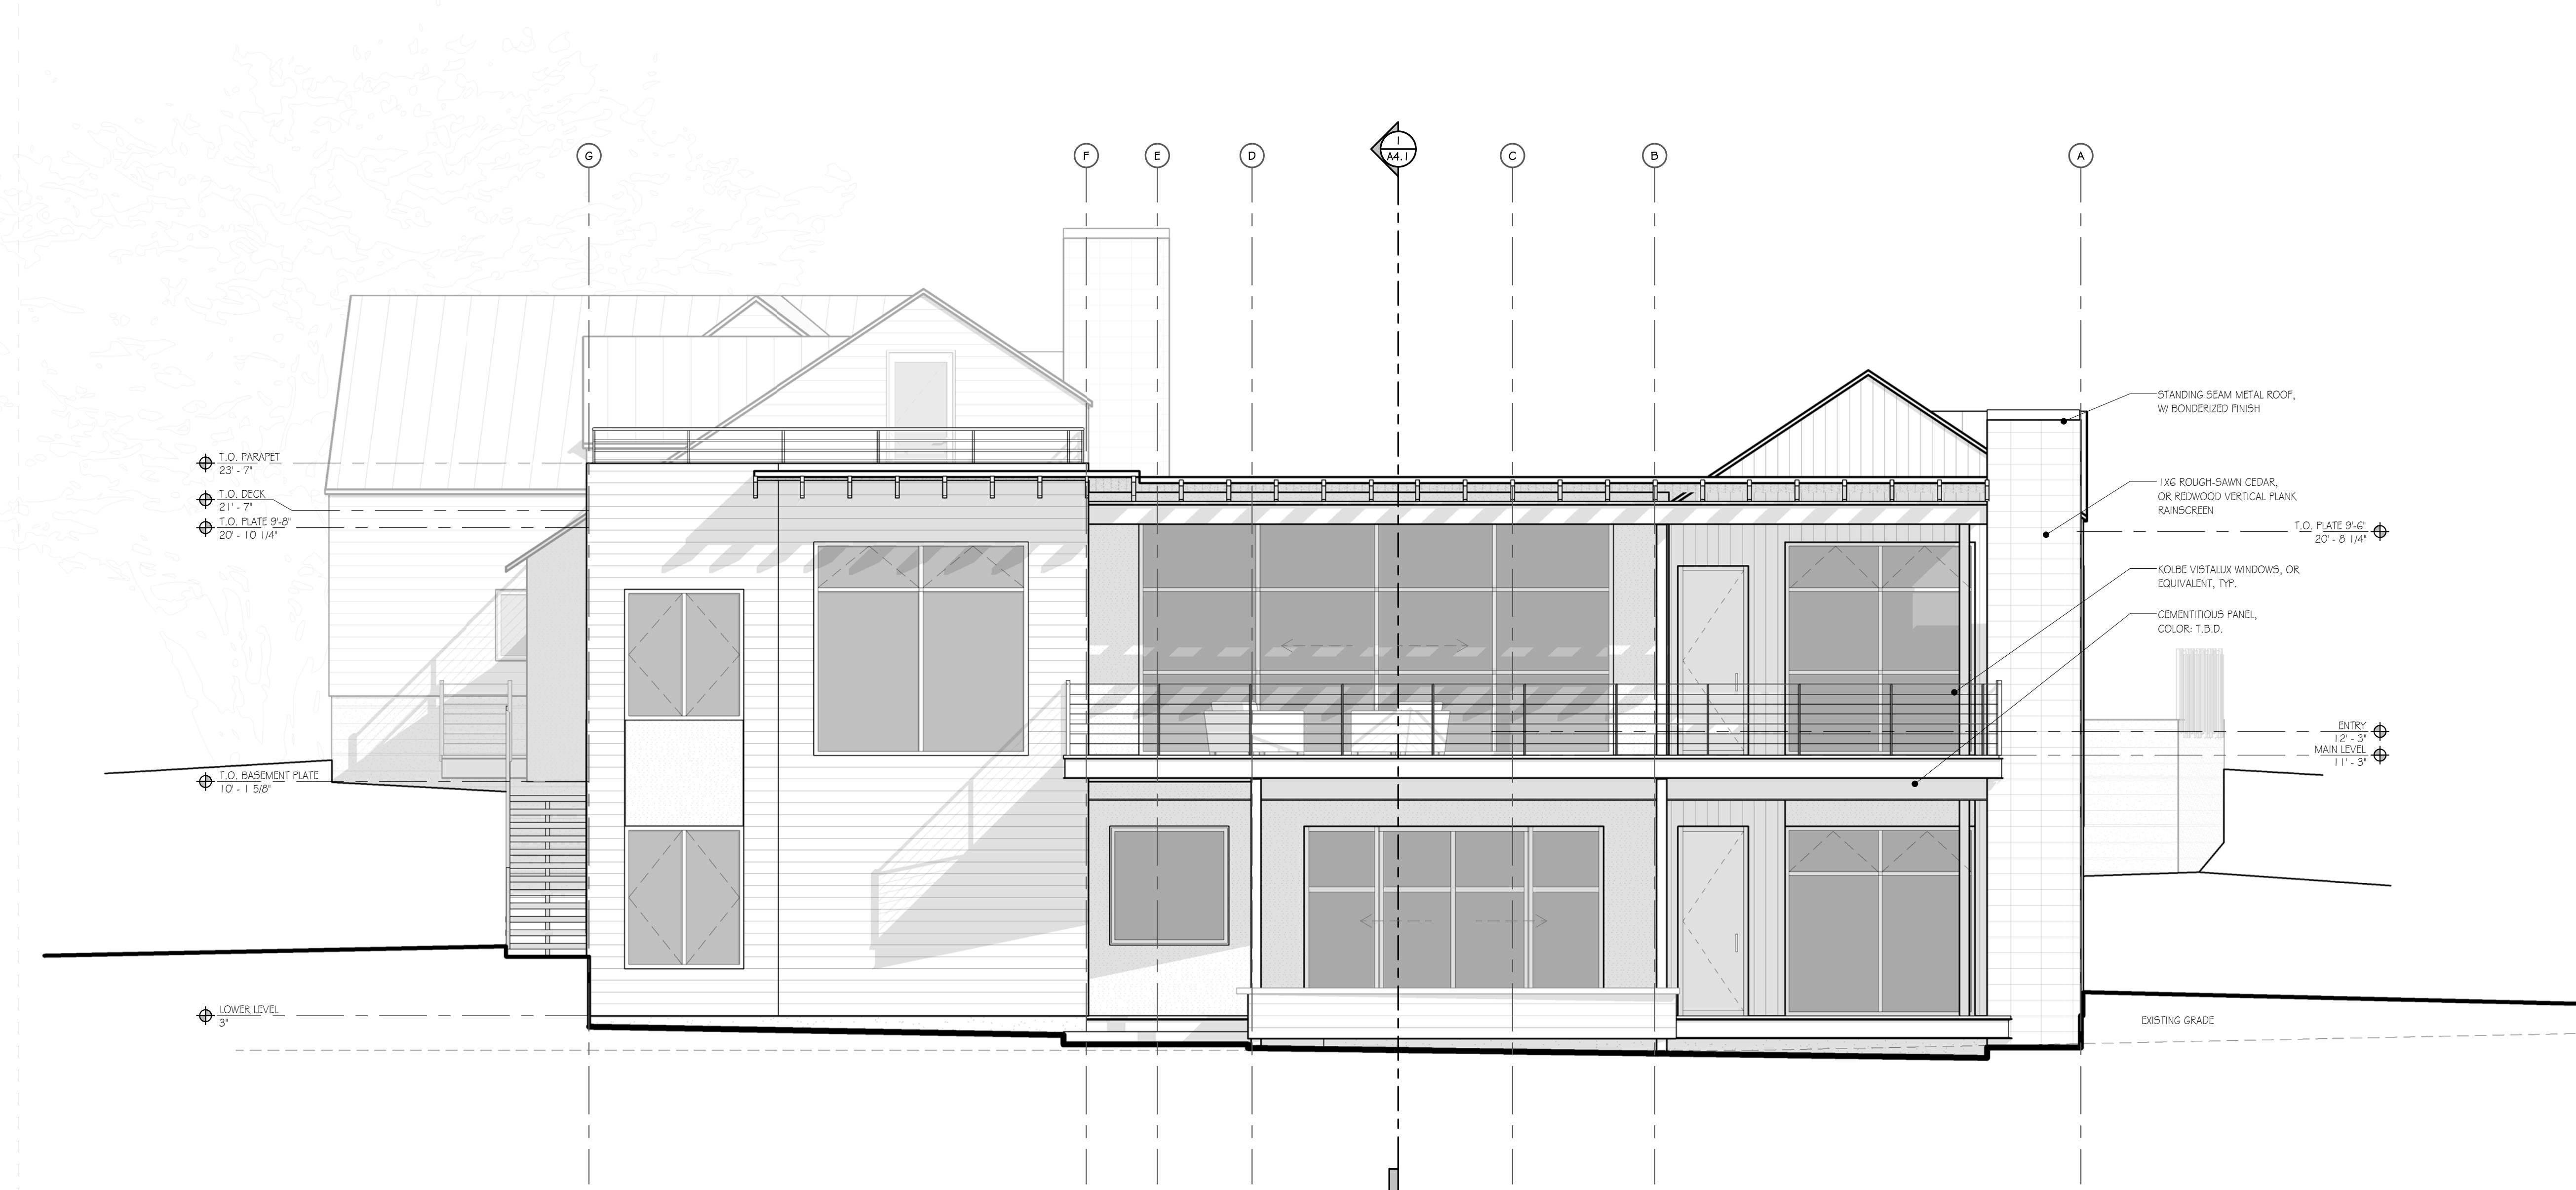

MOSS BEACH - LOT 1

VALLEMAR ST. & JULIANNA AVE.

PDC
PEARSON
DESIGN GROUP
102 N. BROADWAY AVE., BOZEMAN, MT 59715
OFFICE: 406.587.9991 FAX: 406.587.0291
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REVISION
NO. DATE


COASTSIDE DESIGN
REVIEW APPLICATION

DRAWING
ELEVATIONS

PROJECT NUMBER: 1507
DATE: JULY 24, 2017
REVISION 1 08.25.17
DESIGN REVIEW SET

SHEET NO.

A3.3

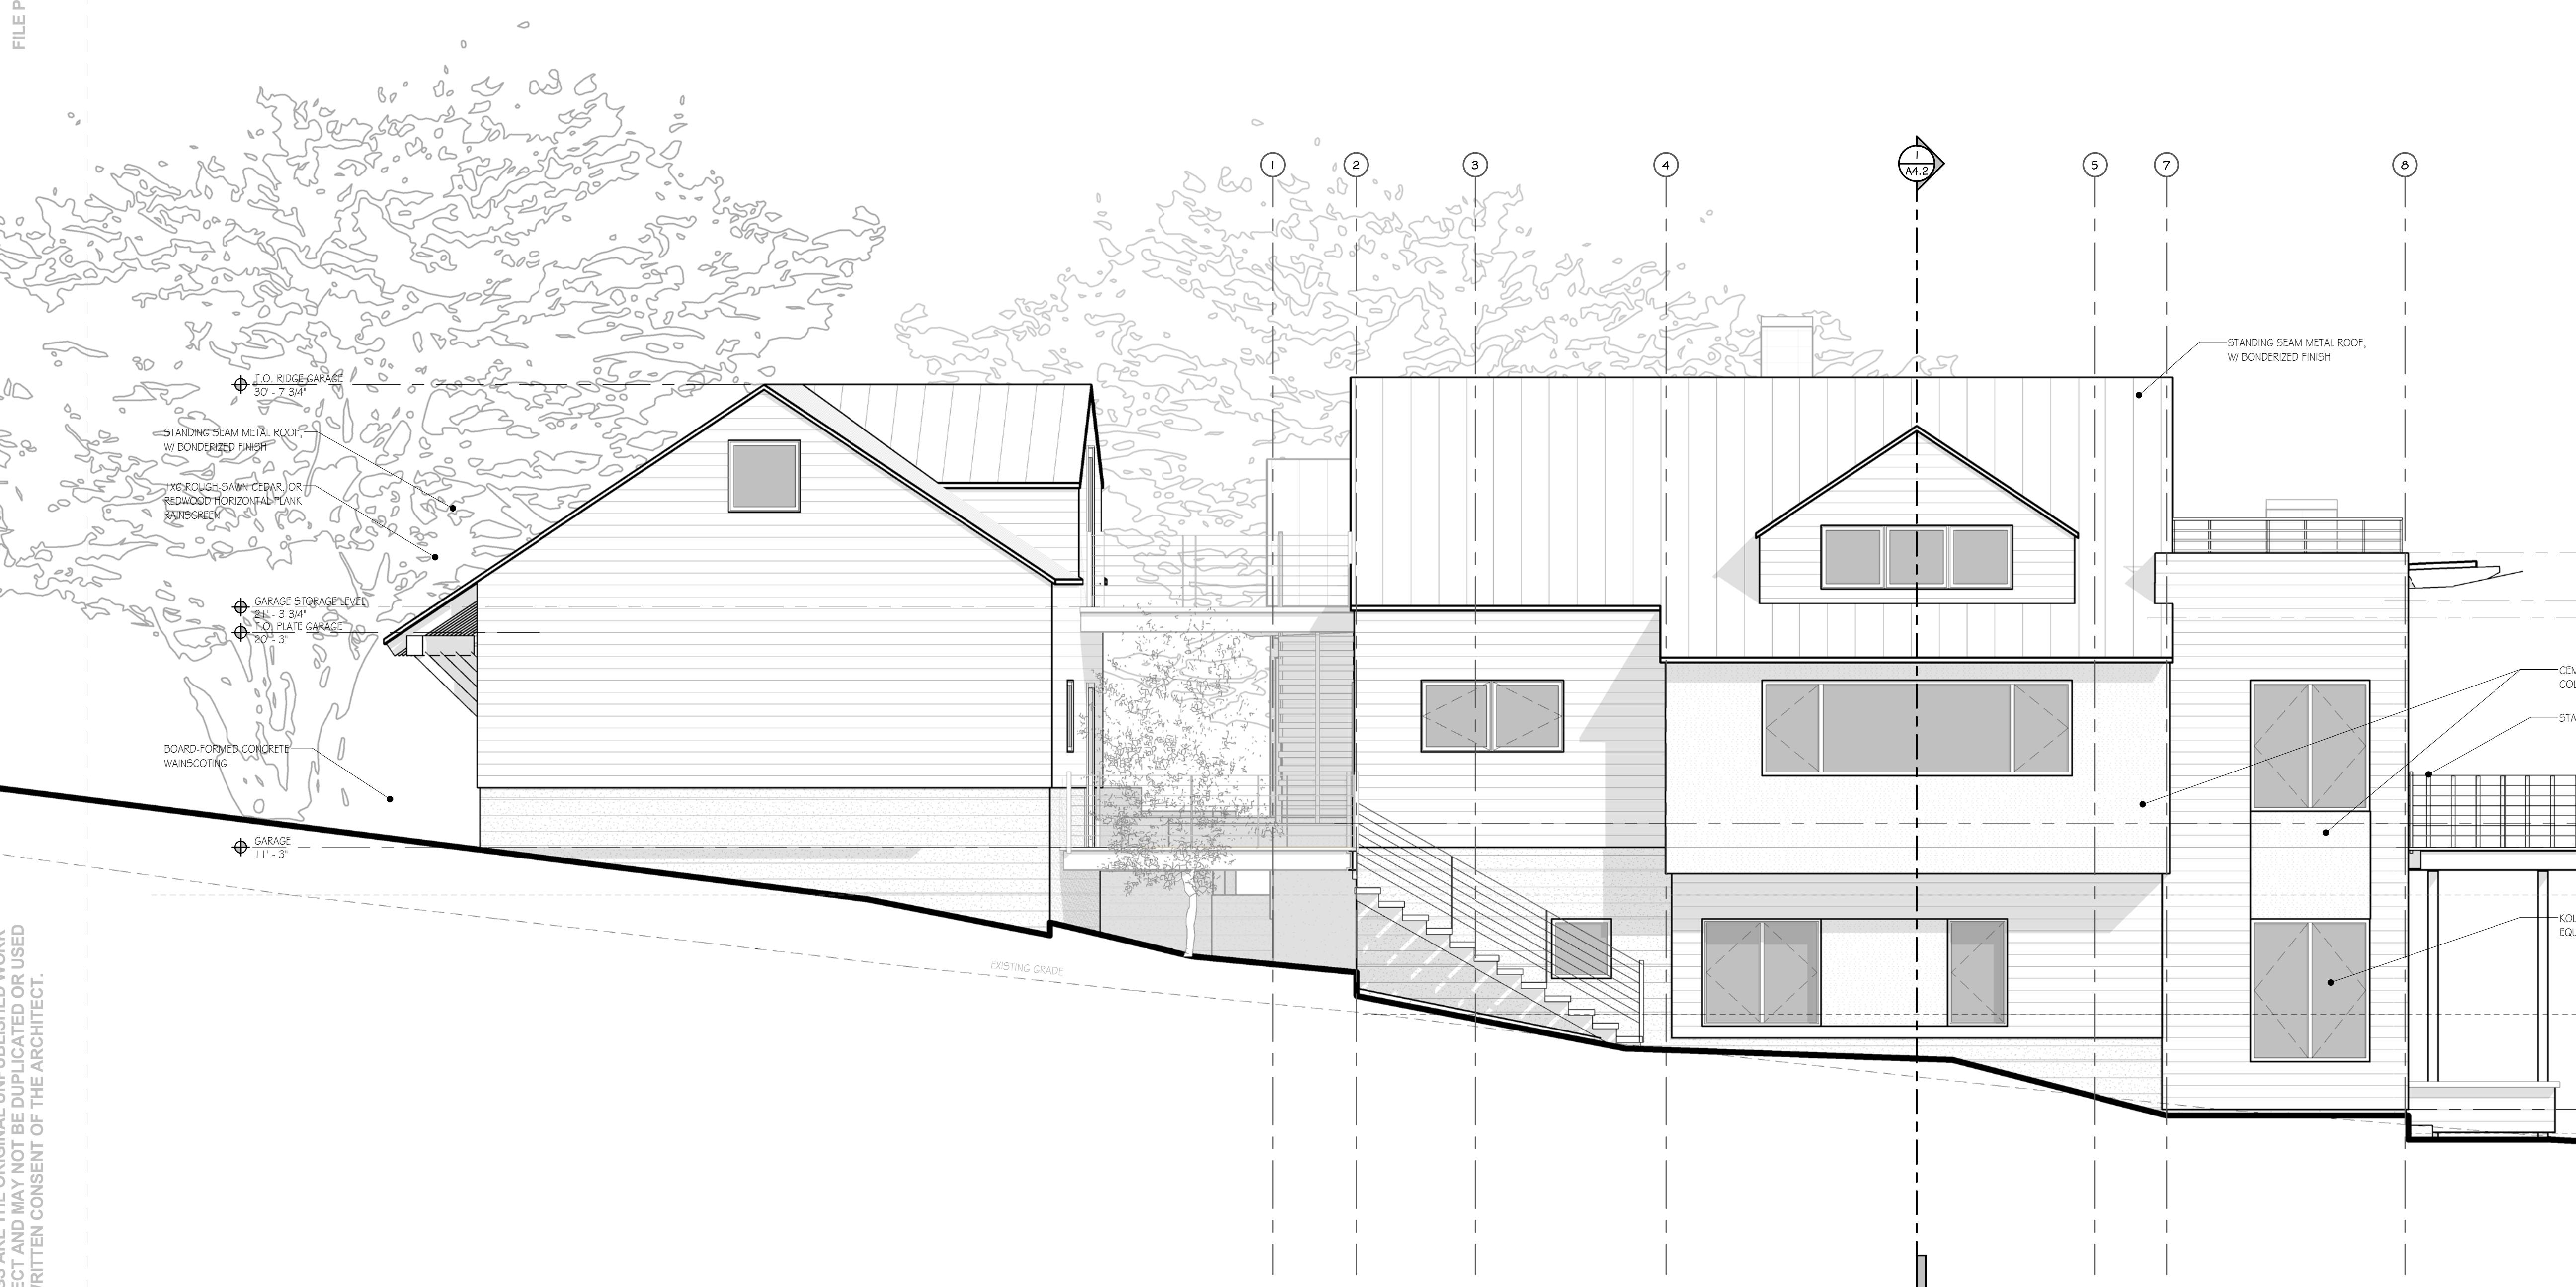

MATERIALS



SIDING
1x8 ROUGH-SAWN CEDAR, OR REDWOOD
HORIZONTAL PLANK W/ REVEAL EVERY THIRD
BOARD



SIDING
CEMENTITIOUS PANELS



WALLS
CMU VENEER,
(OR BOARD-FORMED CONCRETE)



ROOF
STANDING SEAM
METAL ROOF
W/ BONDERIZED FINISH



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SOFFITS
ROUGH-SAWN CEDAR
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RAILINGS & TRIM
STAINLESS STEEL CABLE RAILINGS
& STAINLESS STEEL TRIM



RAFTERS
ROUGH SAWN FIR

MOSS BEACH - LOT 1

VALLEMAR ST. & JULIANNA AVE.

COASTSIDE DESIGN
REVIEW APPLICATION

DRAWING
ELEVATIONS

PROJECT NUMBER: 1507
DATE: JULY 24, 2017
REVISION 1 08.25.17
DESIGN REVIEW SET

SHEET NO:

A3.4

PDC
PEARSON
DESIGN GROUP
102 N. BROADWAY AVE, BOZEMAN, MT 59715
OFFICE: 406.587.9991 FAX: 406.587.0391
WWW.PEARSONDESIGNGROUP.COM

MOSS BEACH - LOT 1



VALLEMAR ST. & JULIANNA AVE.



COASTSIDE DESIGN
REVIEW APPLICATIONDRAWING
SECTIONSPROJECT NUMBER: I507
DATE: JULY 24, 2017
REVISION I 08.25.17
DESIGN REVIEW SET

SHEET NO.


A4.1

MAXIMUM BUILDING HEIGHT CALCULATIONS

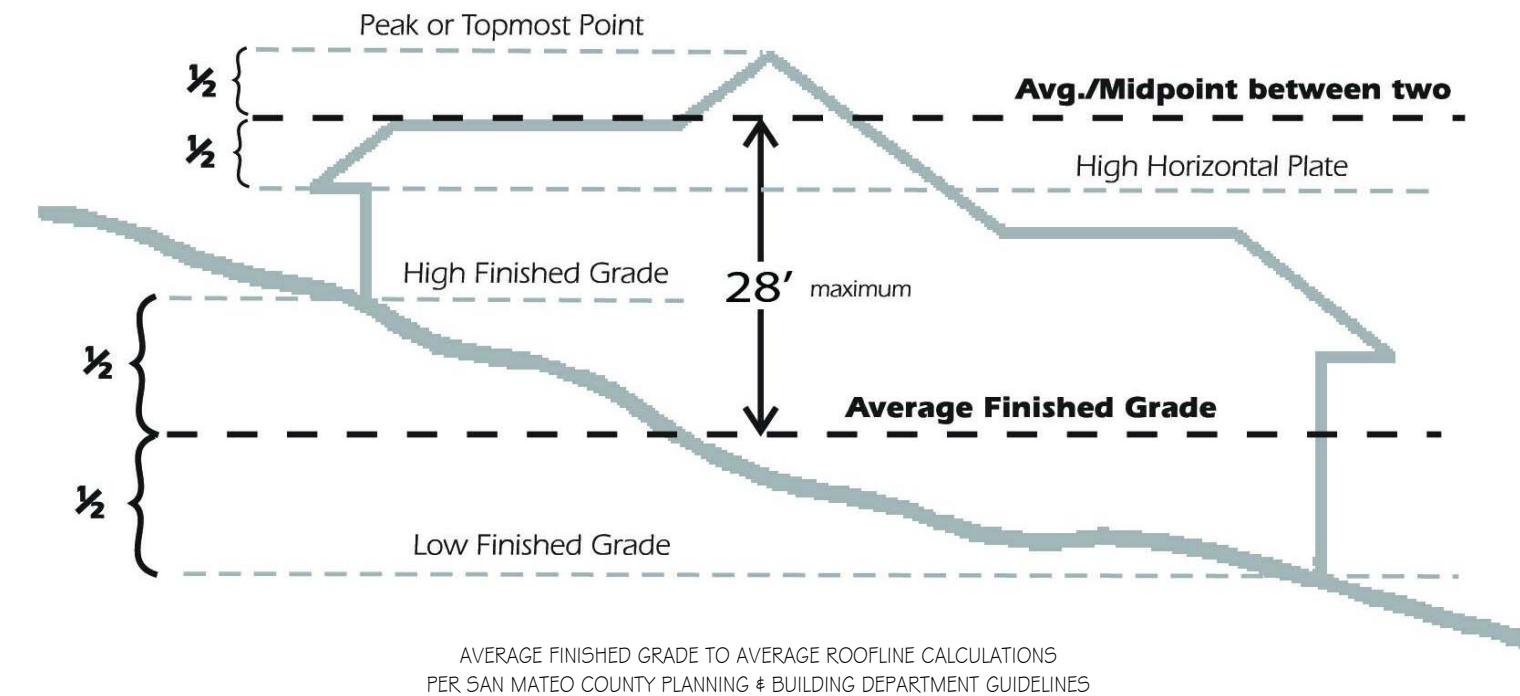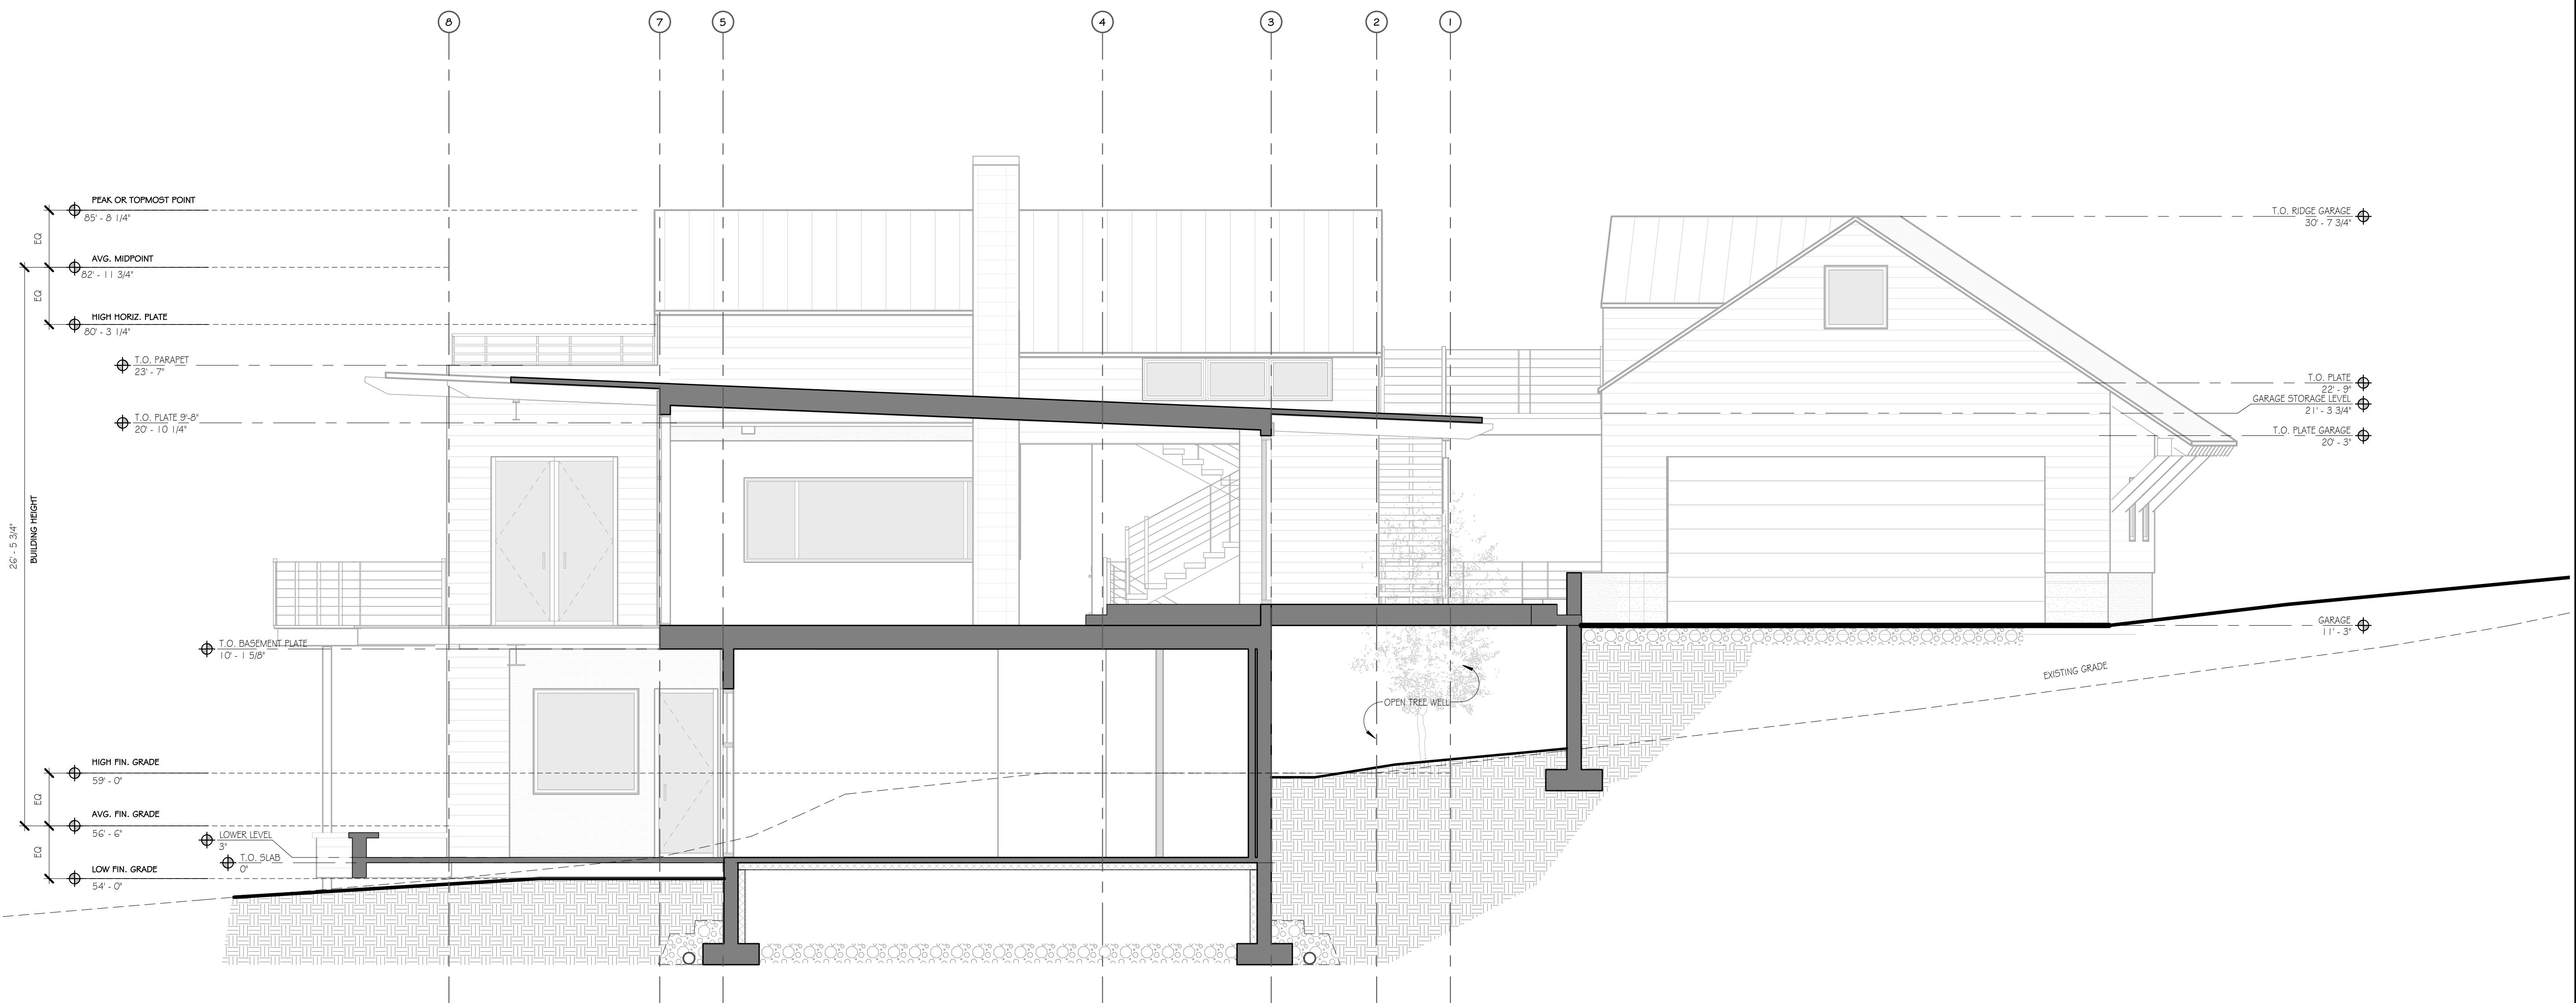FILE PATH: P:\CURRENT\I507 MOSS BEACH, SAN MATEO, CA\1.0 DRAWINGS_CURRENT
SET, REV\I501.LOT_NEW.mifTHESE DRAWINGS ARE THE ORIGINAL UNPUBLISHED WORK
OF THE ARCHITECT AND MAY NOT BE DUPLICATED OR USED
WITHOUT THE WRITTEN CONSENT OF THE ARCHITECT.

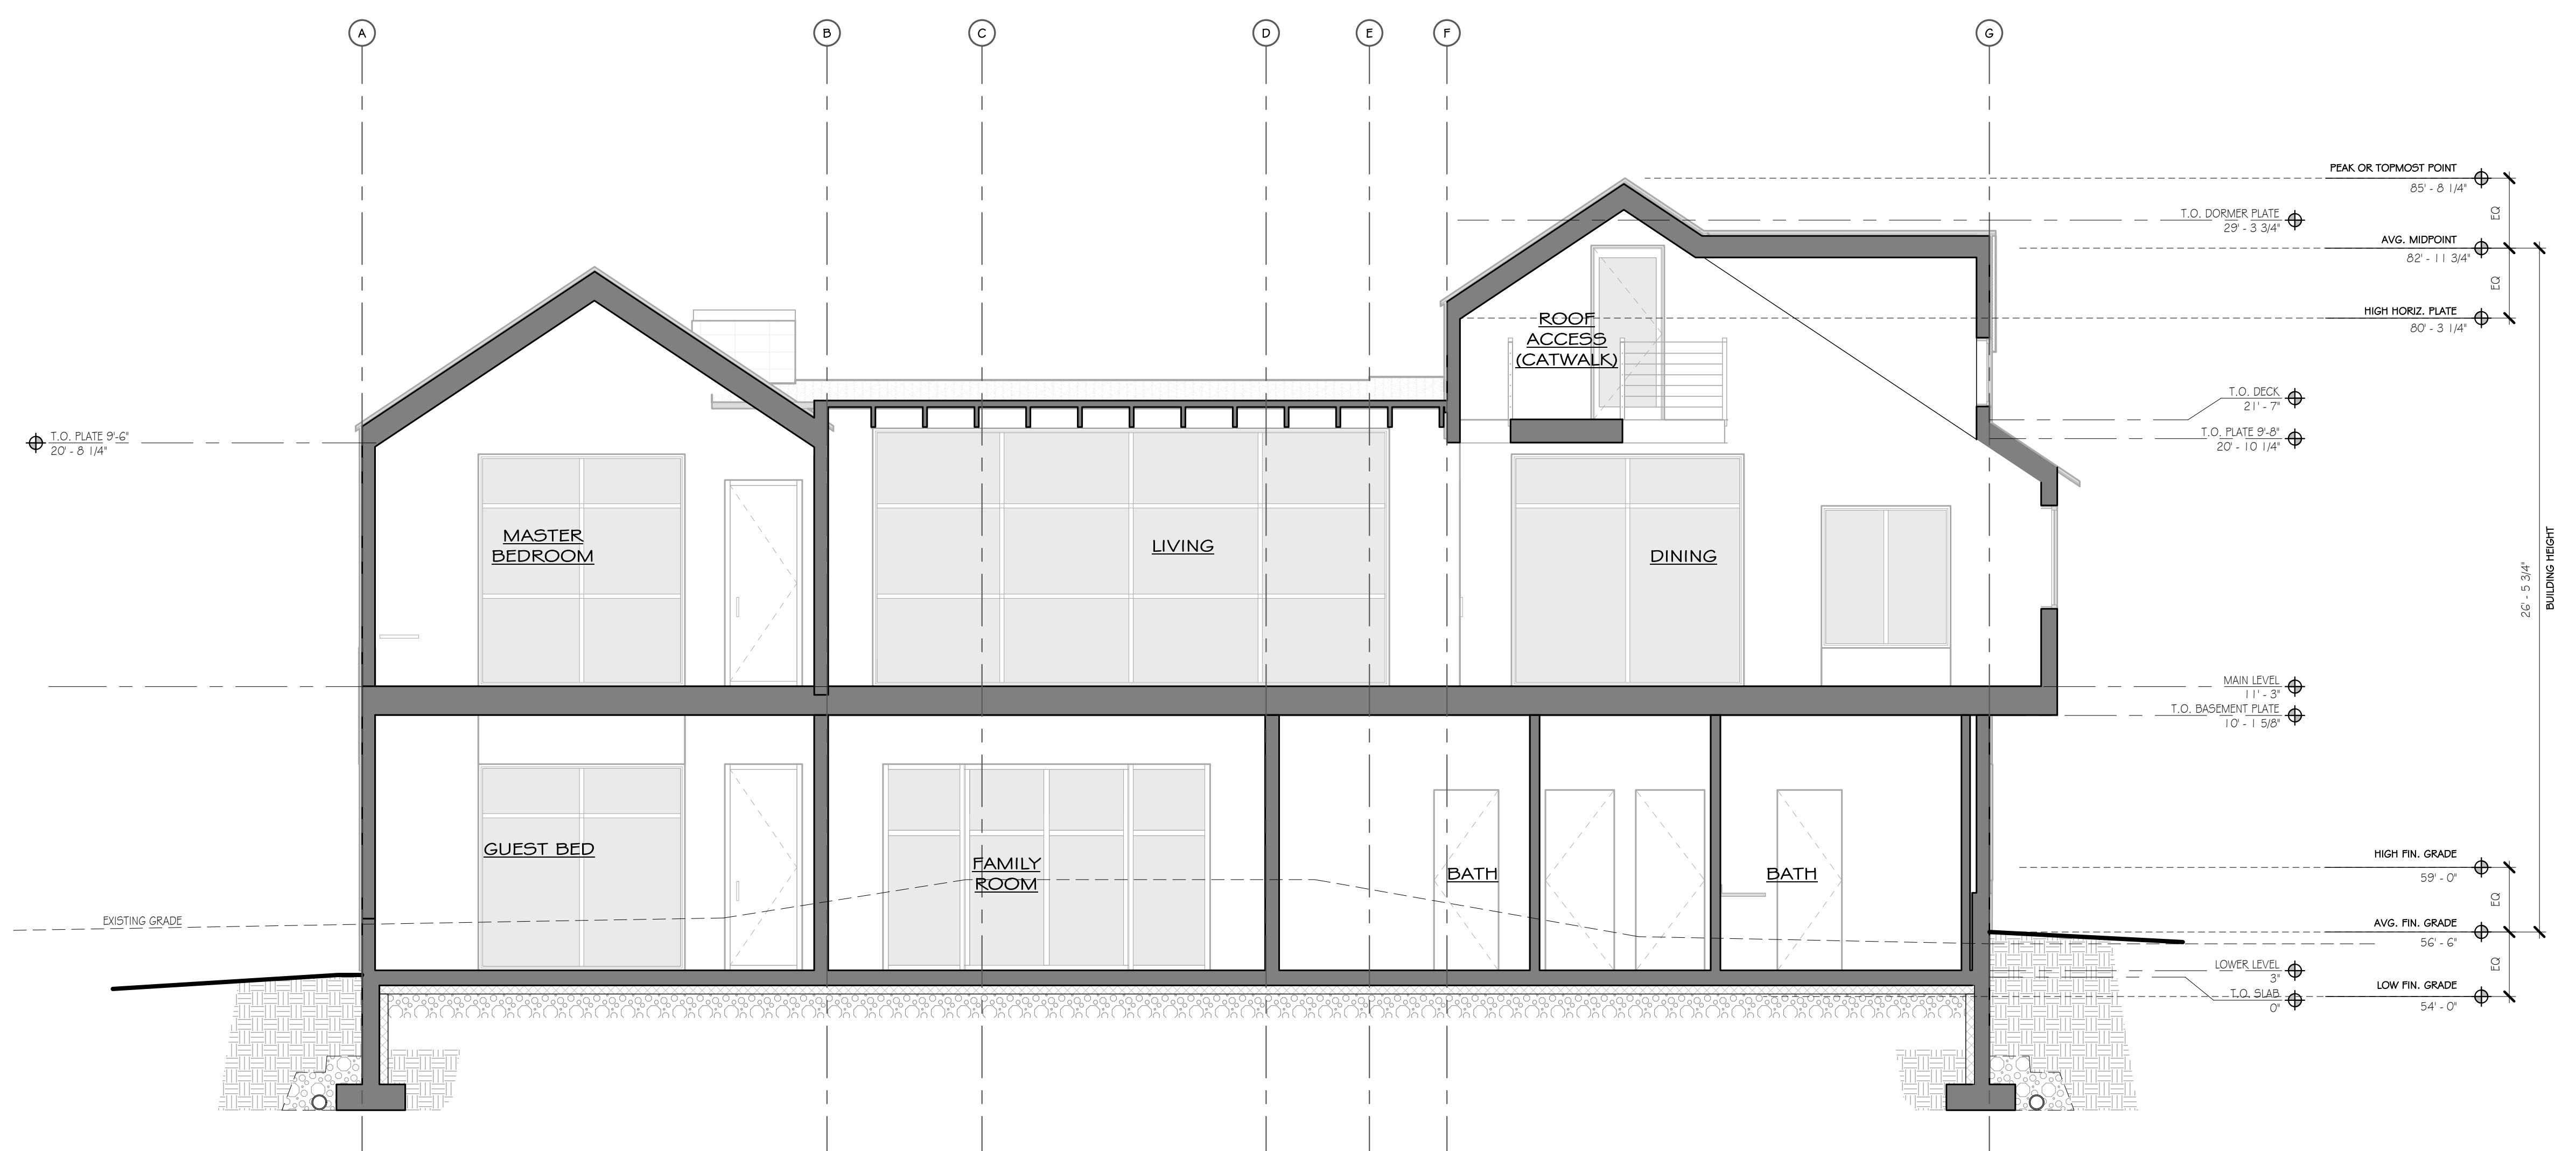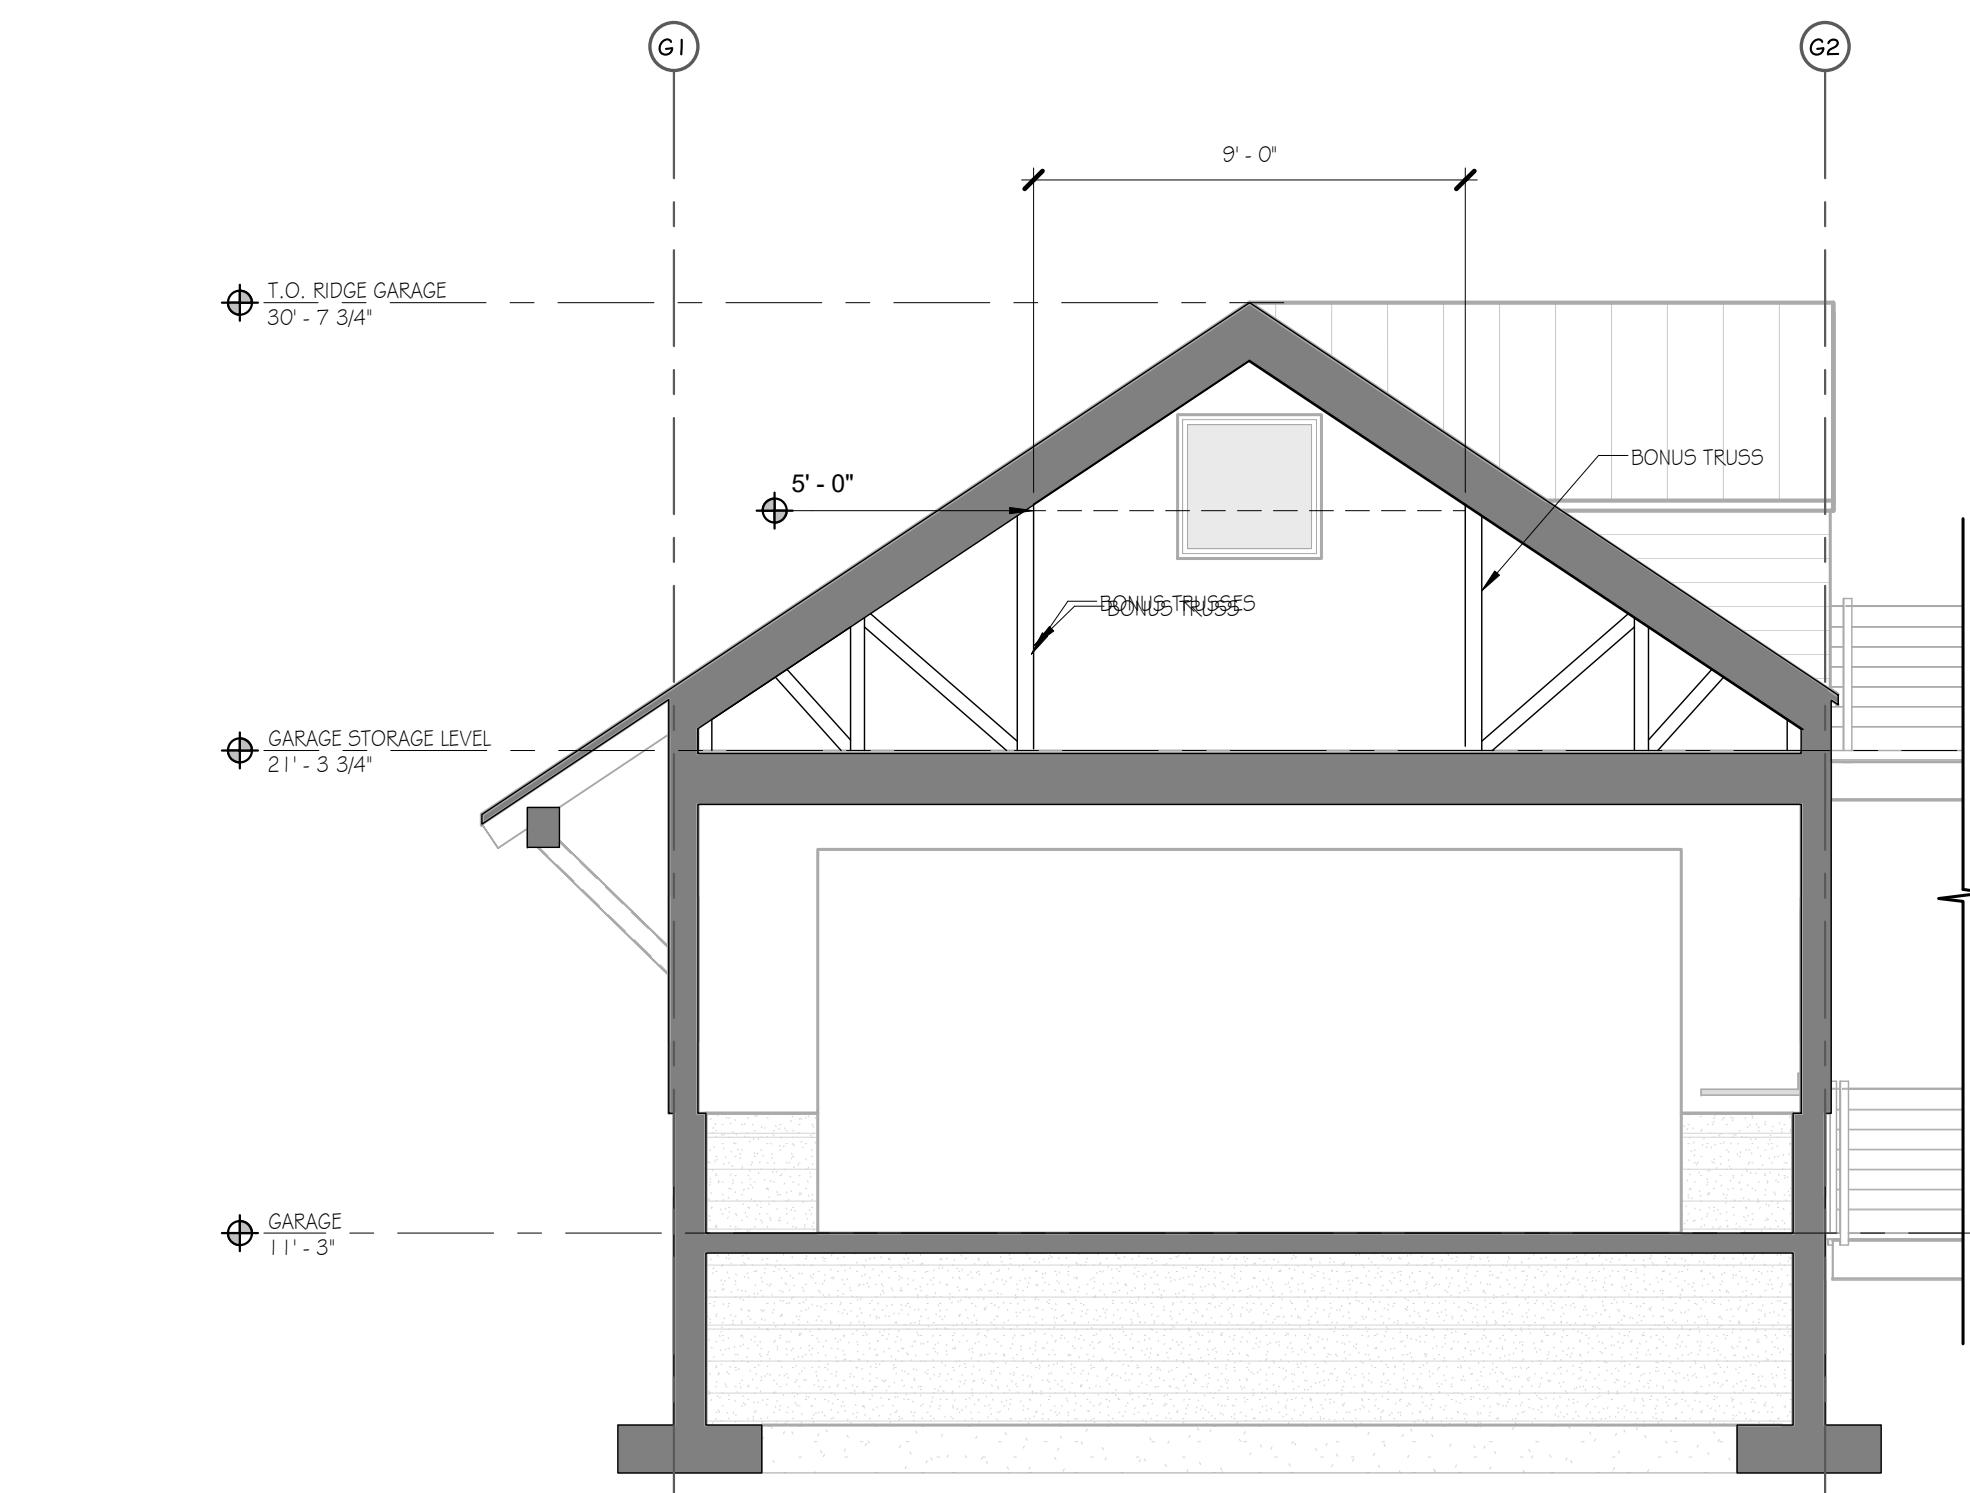

MAXIMUM BUILDING HEIGHT CALCULATIONS

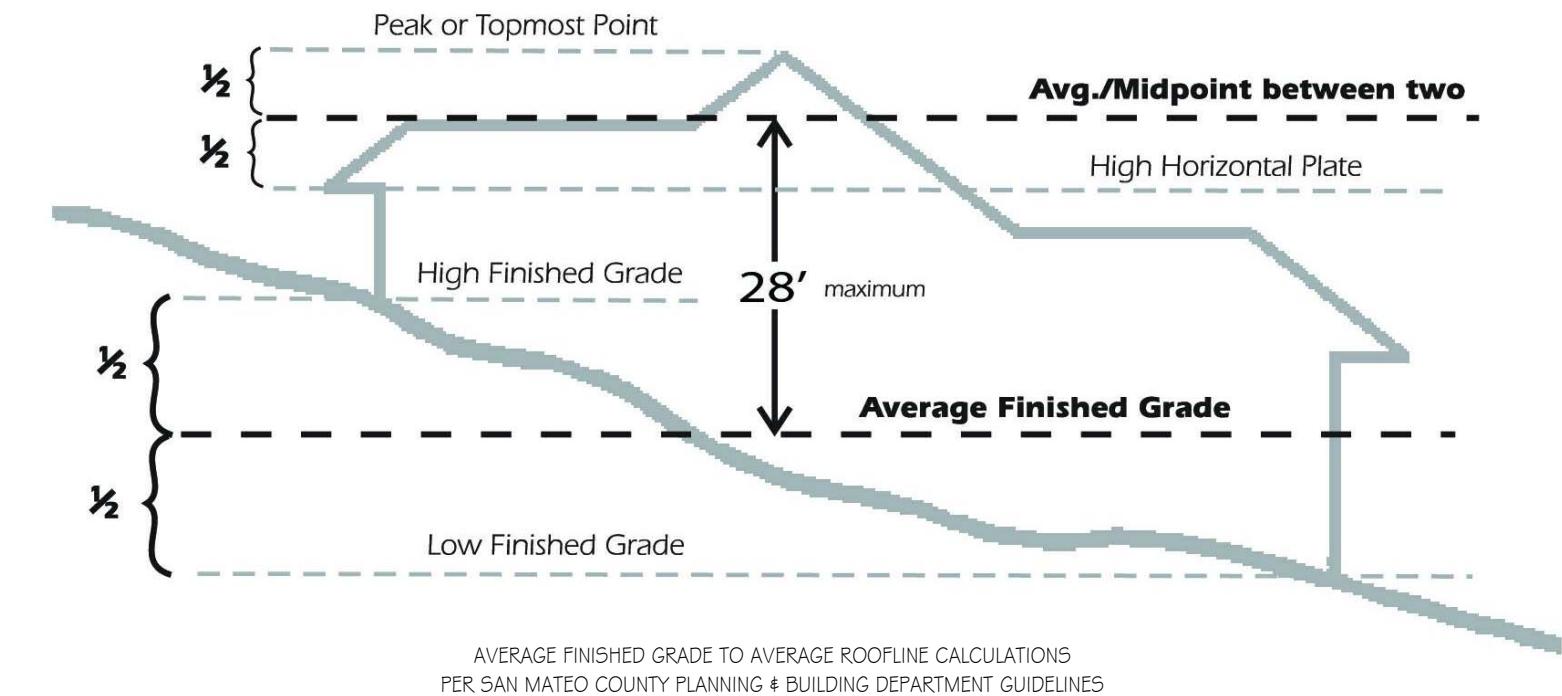

MOSS BEACH - LOT 1
VALLEMAR ST. & JULIANNA AVE.

COASTSIDE DESIGN
REVIEW APPLICATION

DRAWING
SECTIONS

PROJECT NUMBER: 1507
DATE: JULY 24, 2017
DESIGN REVIEW SET


SHEET NO.

A4.2

CABRILLO
HIGHWAY

VALLEMAR
STREET

JULIANA
AVENUE

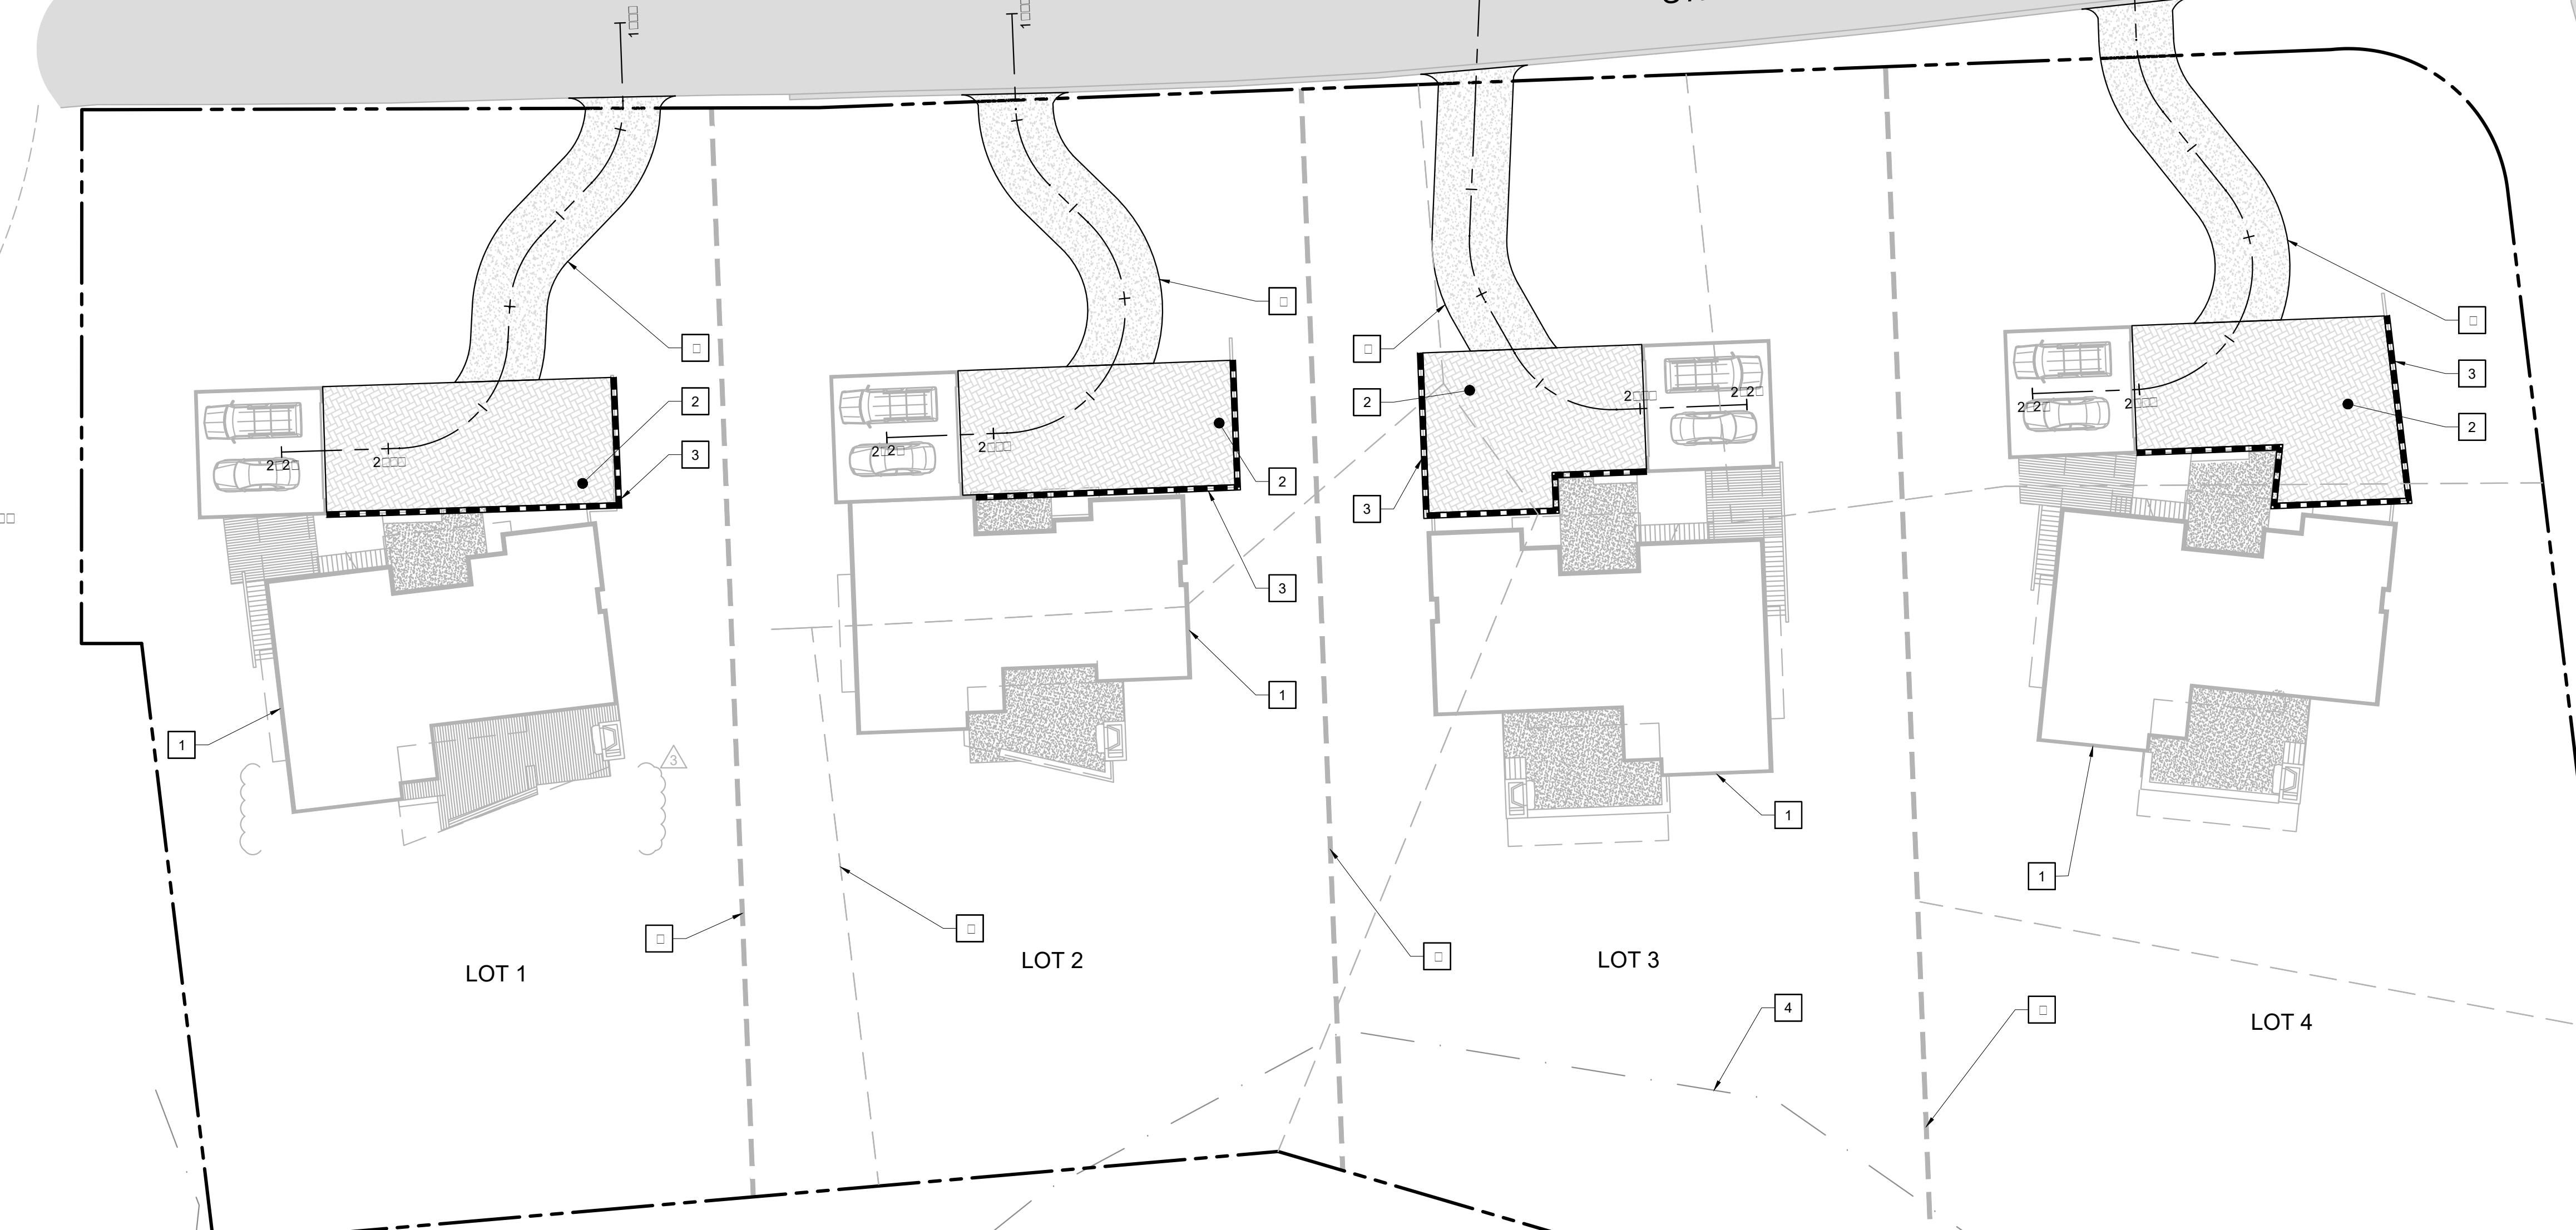

SHEET NOTES

- [] 1. HOUSE SEE ARCHITECTURAL PLANS
- [] 2. CONCRETE CURB & GAVERS SEE LANDSCAPE ARCHITECT PLANS
- [] 3. RETAINING WALLS SEE LANDSCAPE ARCHITECT PLANS
- [] 4. COASTAL SETBACK SEE COASTAL REPORT
- [] APPROXIMATE LOCATION OF DESTINATION NEAR THE HOUSE AND DRIVE AS ESTIMATED FROM ELOCATION MAPS
- [] EXISTING PROPERTY LINE TO COORDINATE SURVEY MAP
- [] EXISTING EASEMENT SEE COORDINATE SURVEY MAP
- [] PROPOSED PROPERTY LINE TO COORDINATE SURVEY MAP
- [] CONCRETE DRIVE AIDS SEE LANDSCAPE ARCHITECT PLANS


CIVIL SHEET INDEX

- [] 1. SITE PLAN
- [] 2. RADIALS PLAN
- [] 3. UTILITIES & DRAINAGE PLAN
- [] 4. DRIVEWAY LOCATIONS
- [] SEWER LOCATIONS
- [] EROSION CONTROL PLAN
- [] CONSTRUCTION MTS
- [] DETAILS

PACIFIC OCEAN

SITE PLAN


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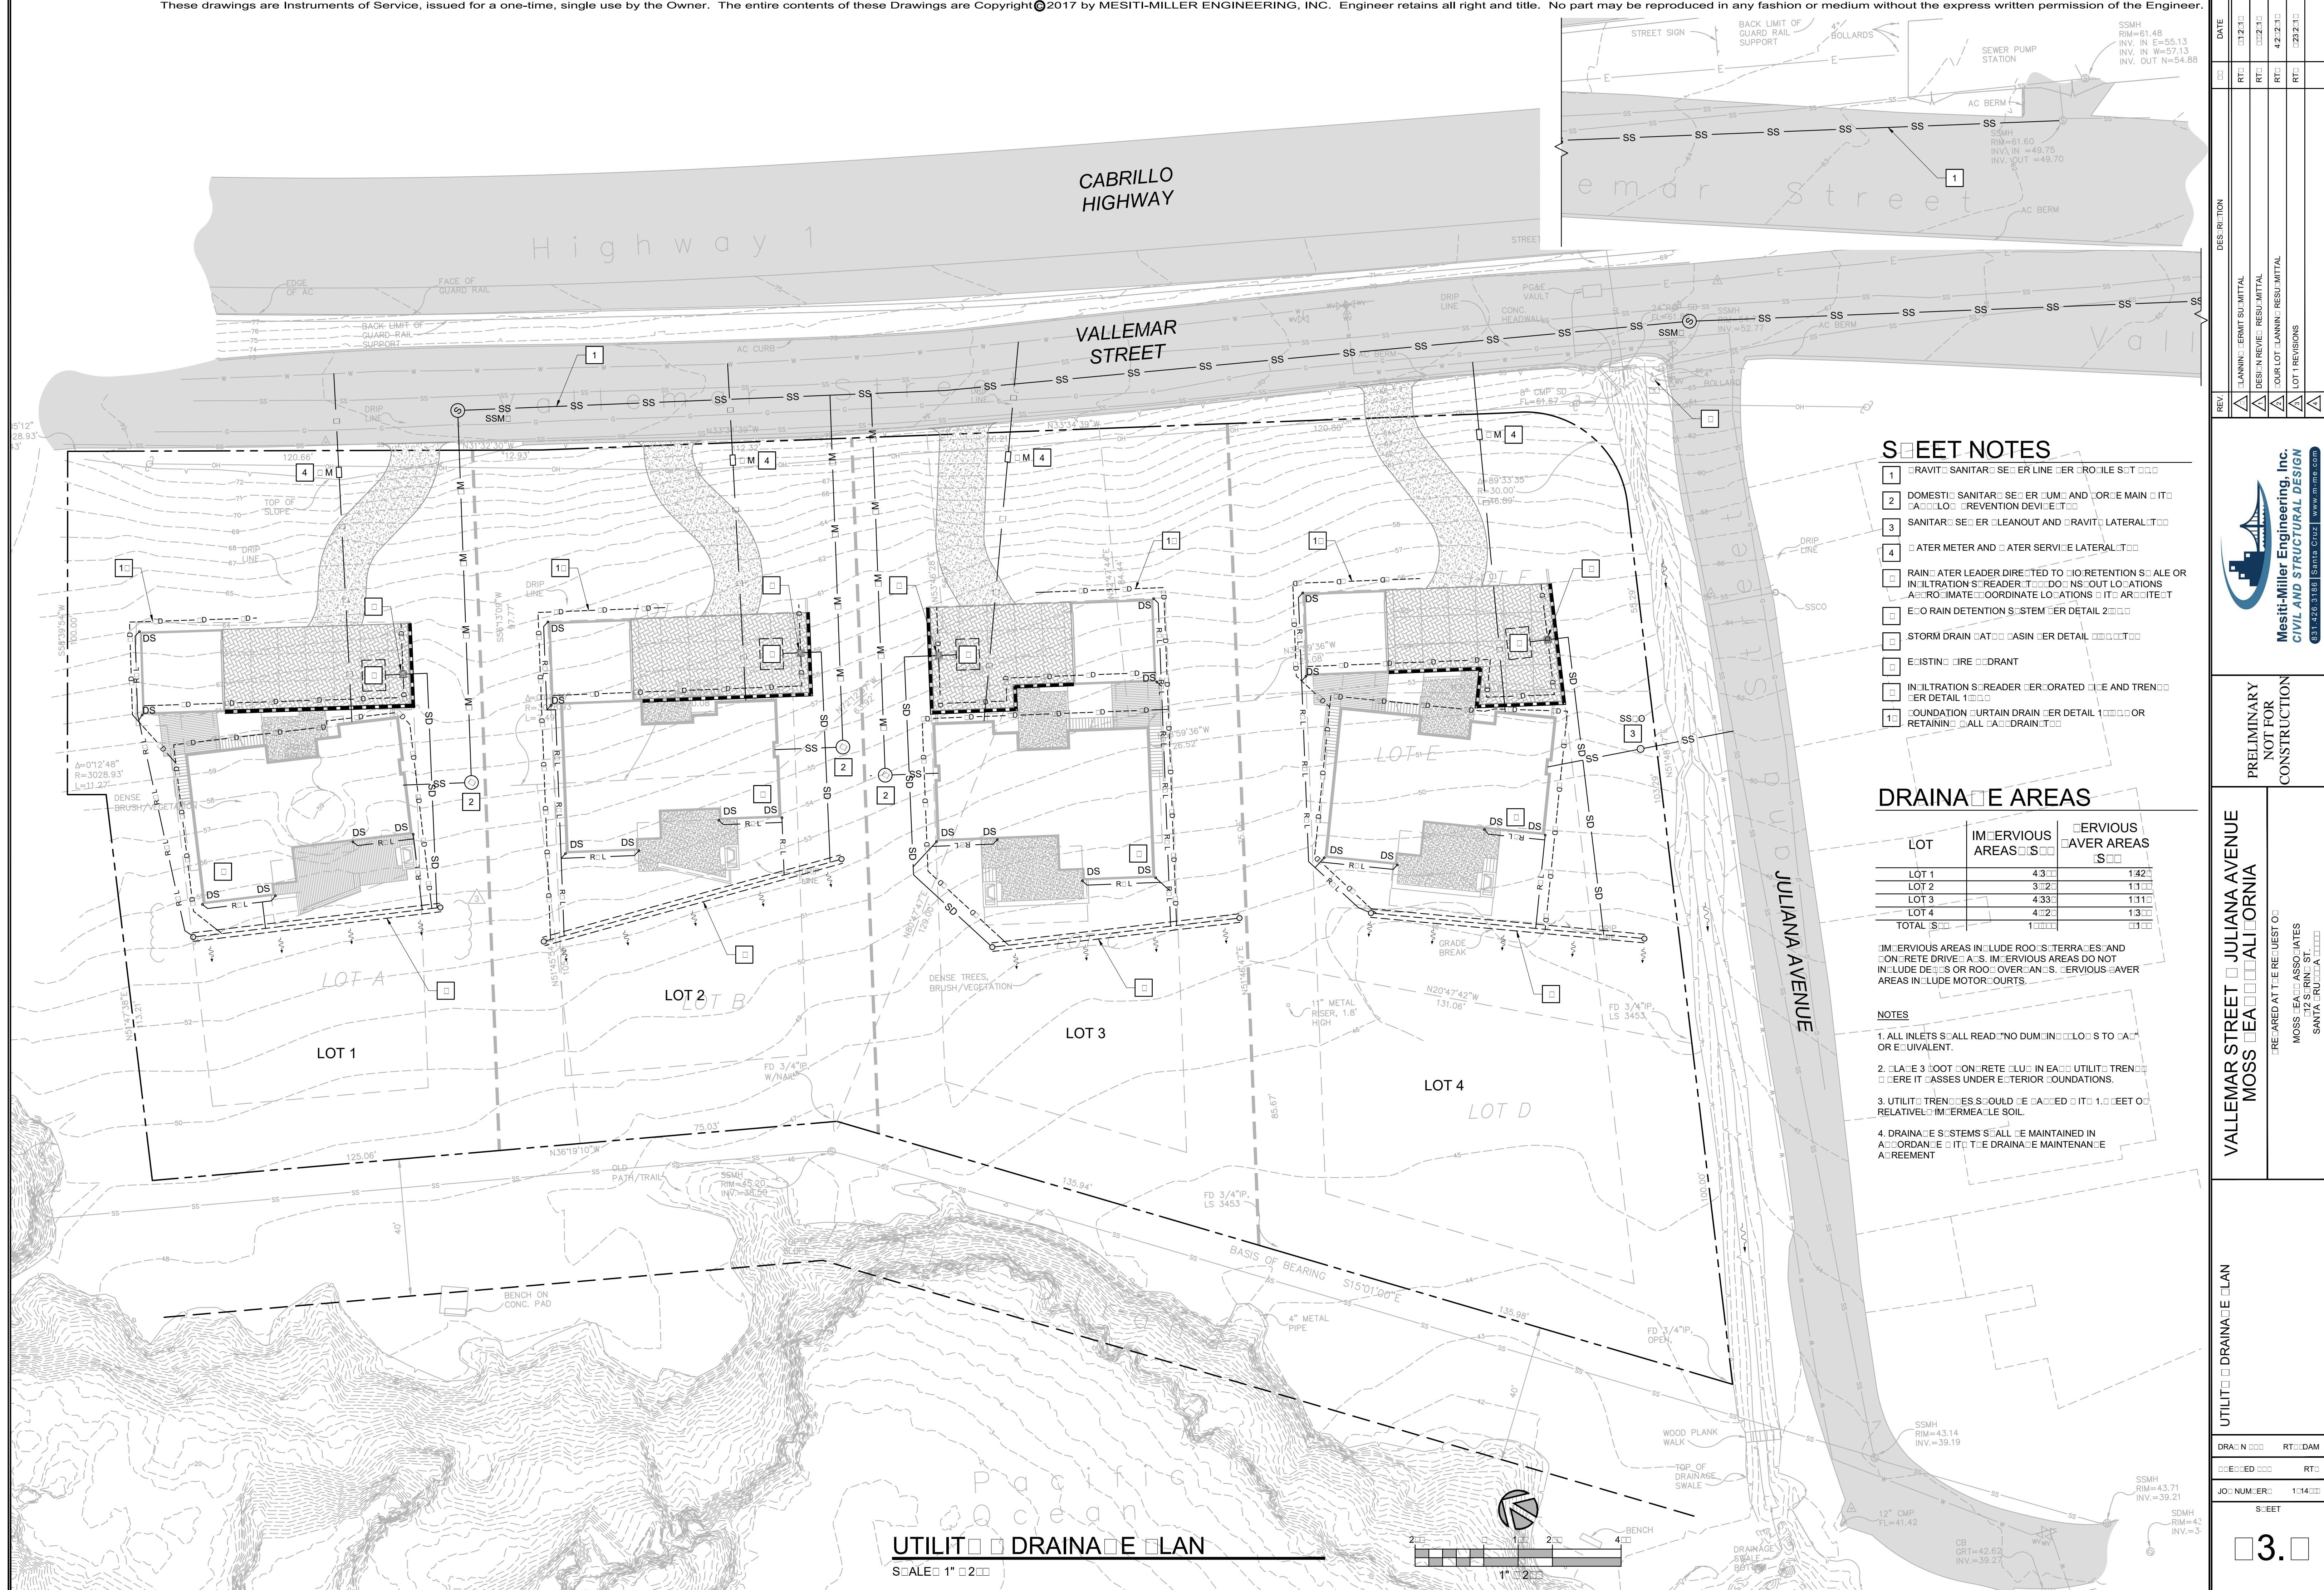


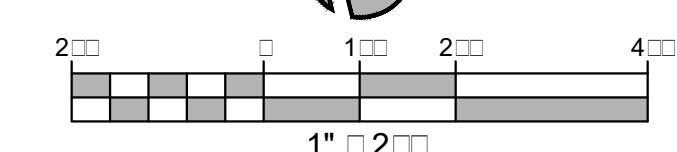
DESIGNATION	REV.	DATE	
		RT-1	RT-2
LAND-TRIM SUBMITTAL	△	1-2-11	RT-1
DESIGN REVIEW SUBMITTAL	△	2-2-11	RT-2
OUR LOT PLANNING SUBMITTAL	△	4-2-11	RT-2
LOT 1 REVISIONS	△	2-2-11	RT-2
Mesiti-Miller Engineering, Inc. CIVIL AND STRUCTURAL DESIGN	△	831-426-1186	Santa Cruz www.m-m-e.com

SITE PLAN
VALLEMAR STREET
MOSS BEACH, CALIFORNIA
PREPARED AT THE REQUEST OF
MOSS BEACH ASSOCIATES
12 SIRNE ST
SANTA CRUZ, CA

SITE PLAN
DRAWDN ALDAM
CLOSED RT
JO NUMBER 1043
SHEET
1.0




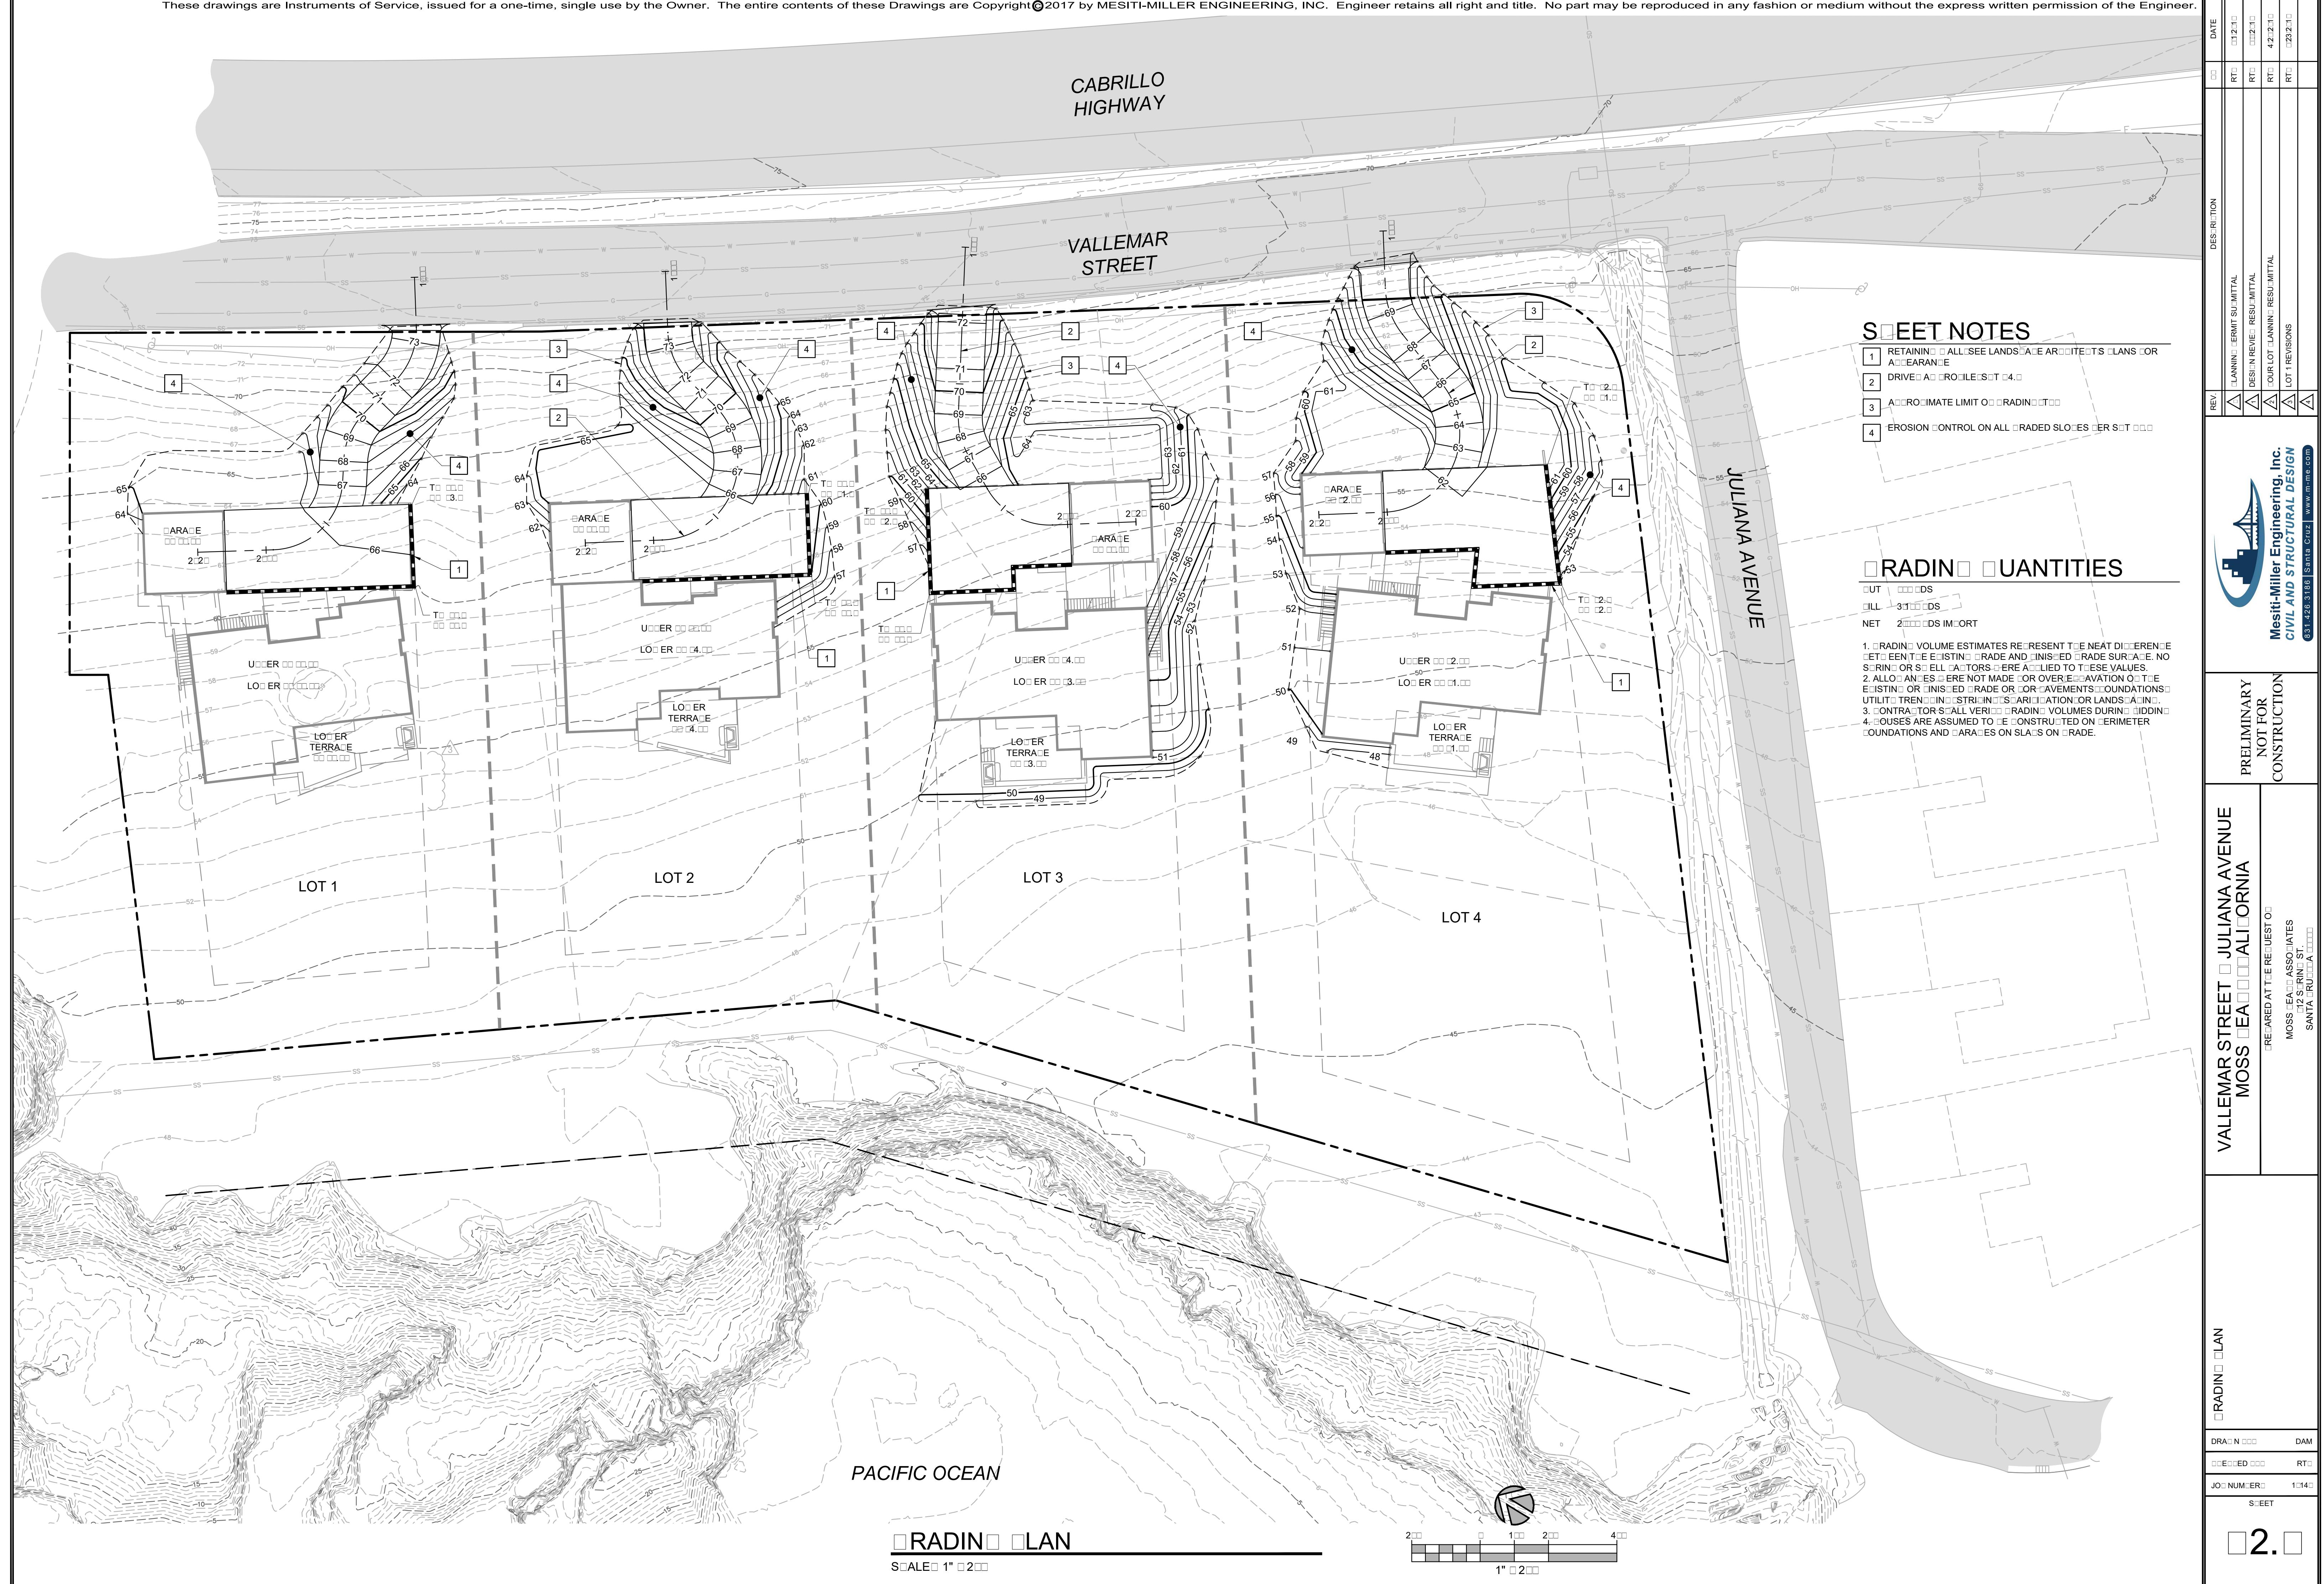

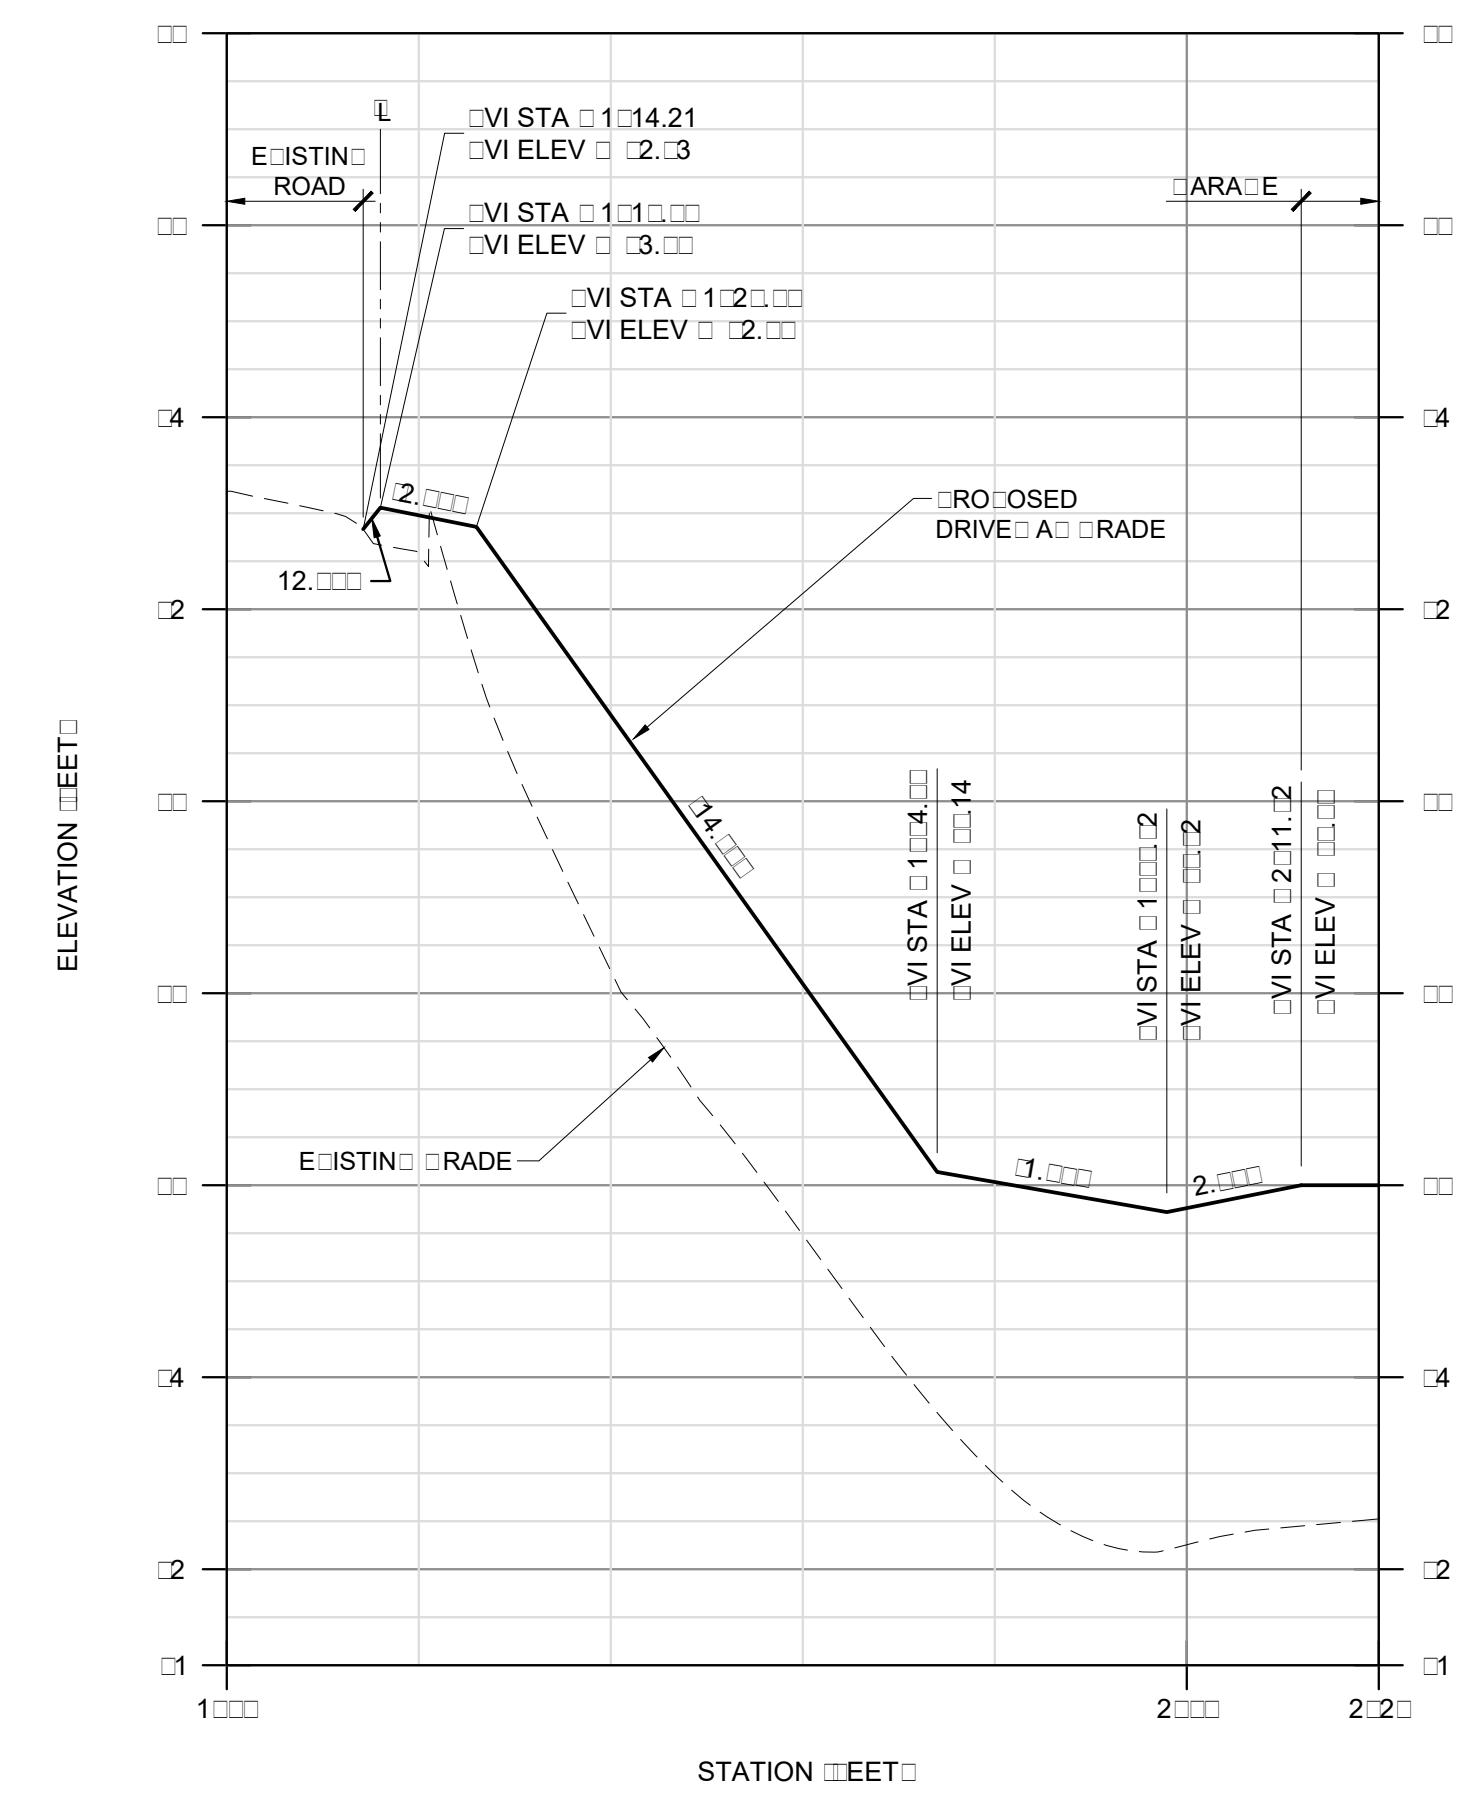

DRIVE A PROFILE


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DRIVE A PROFILE

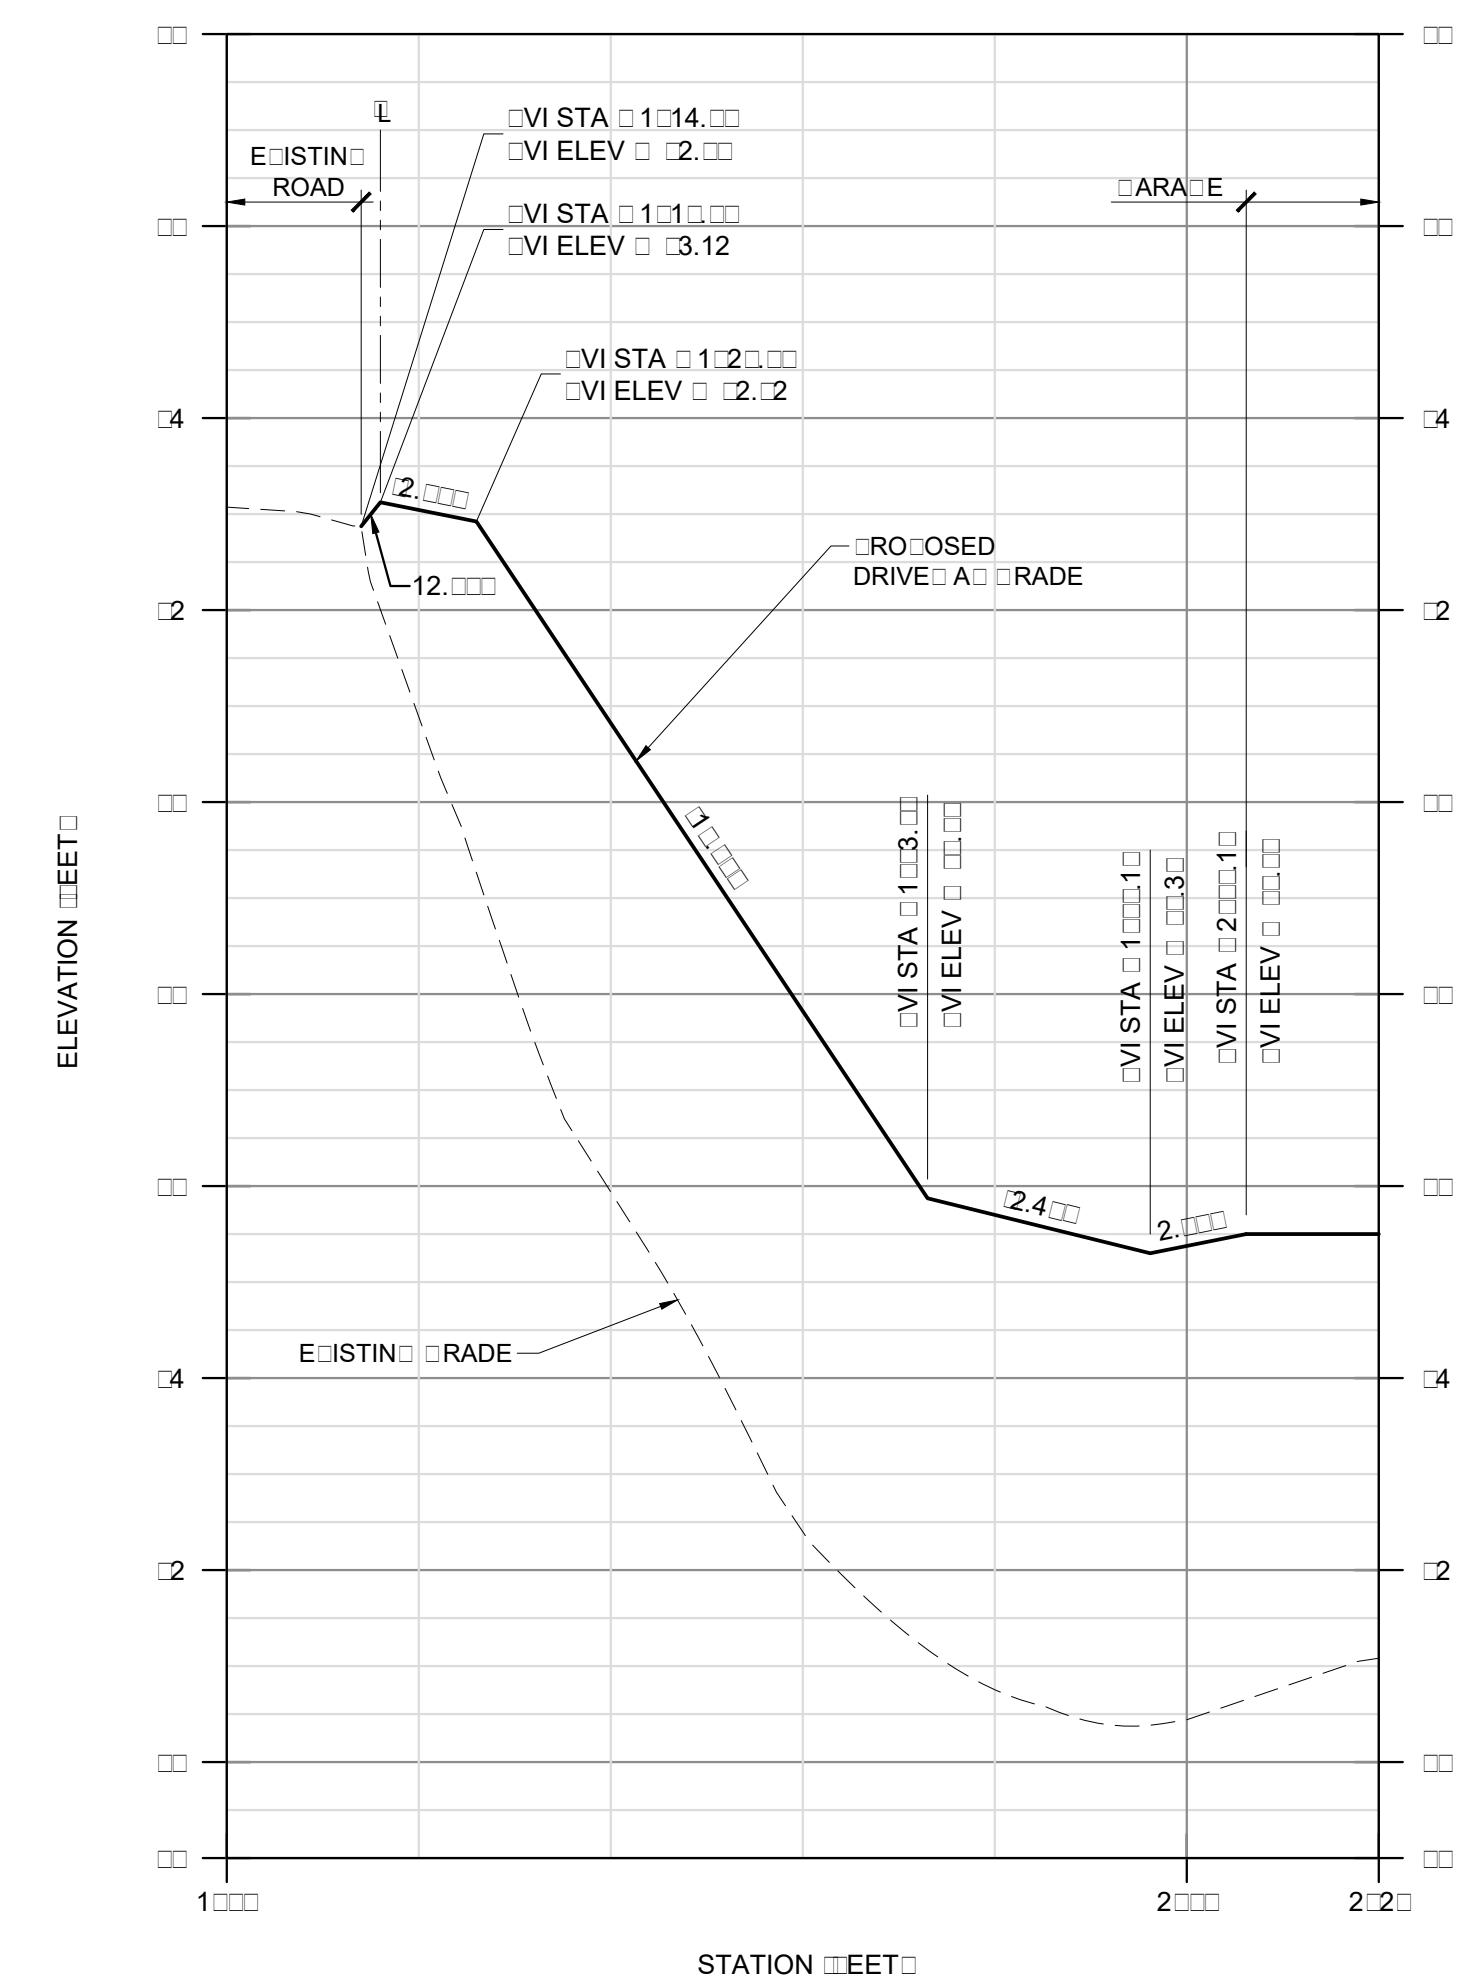
SCALE 1" 2" V1" 2"

NOTES:
1. VERTICAL CURVES NOT SHOWN ON PRELIMINARY PROFILES.



DRIVE A PROFILE

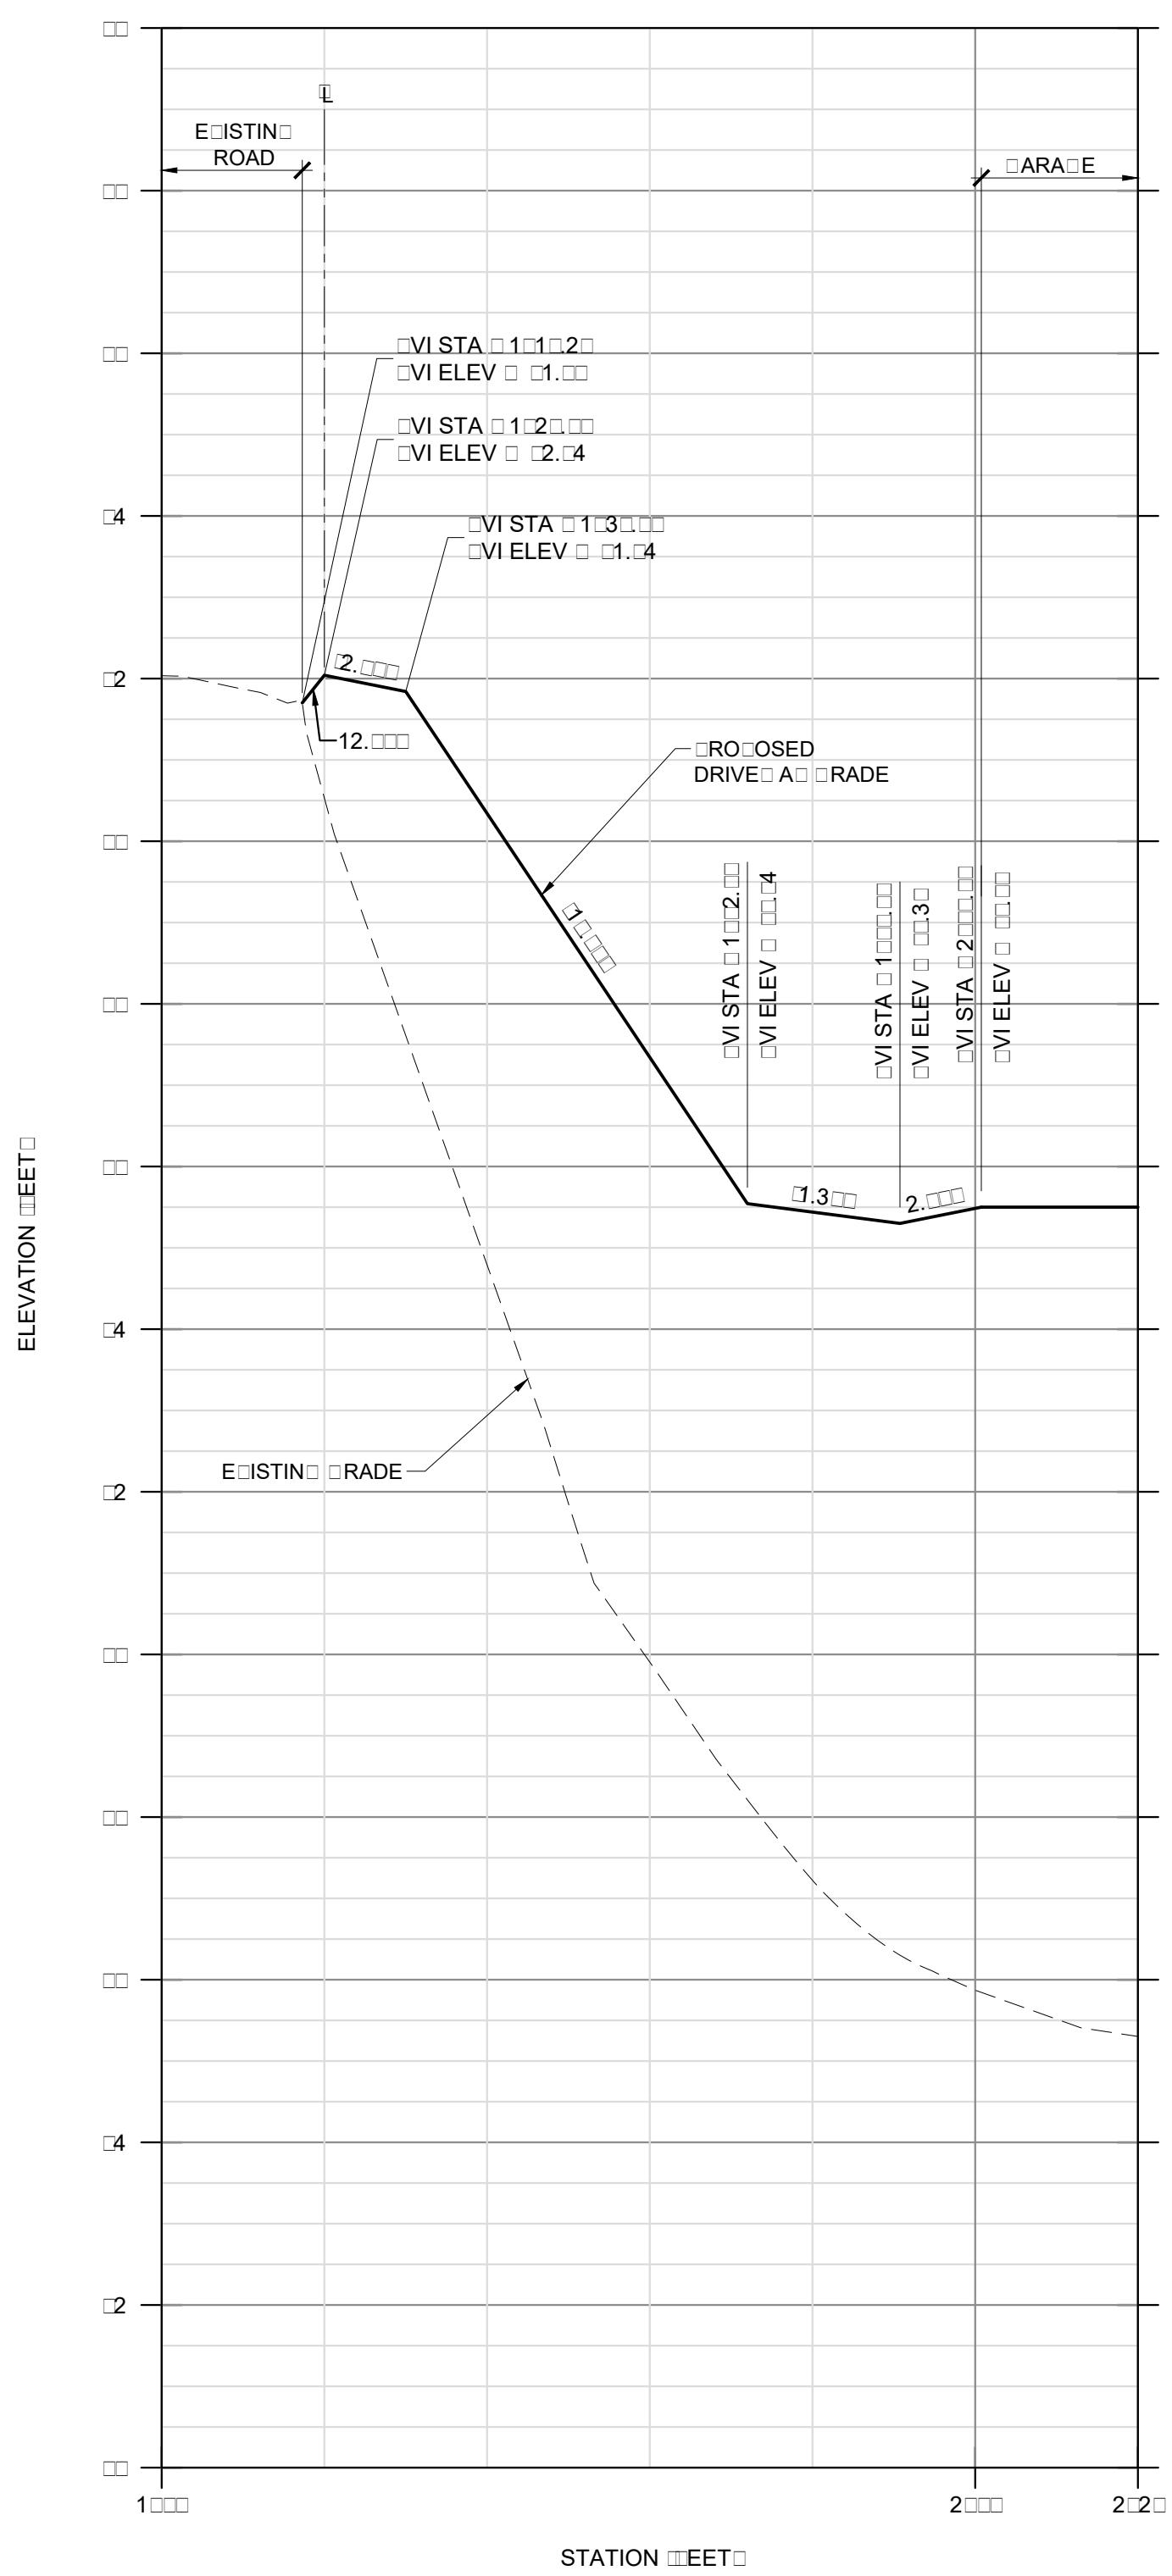SCALE 1" 2" V1" 2"

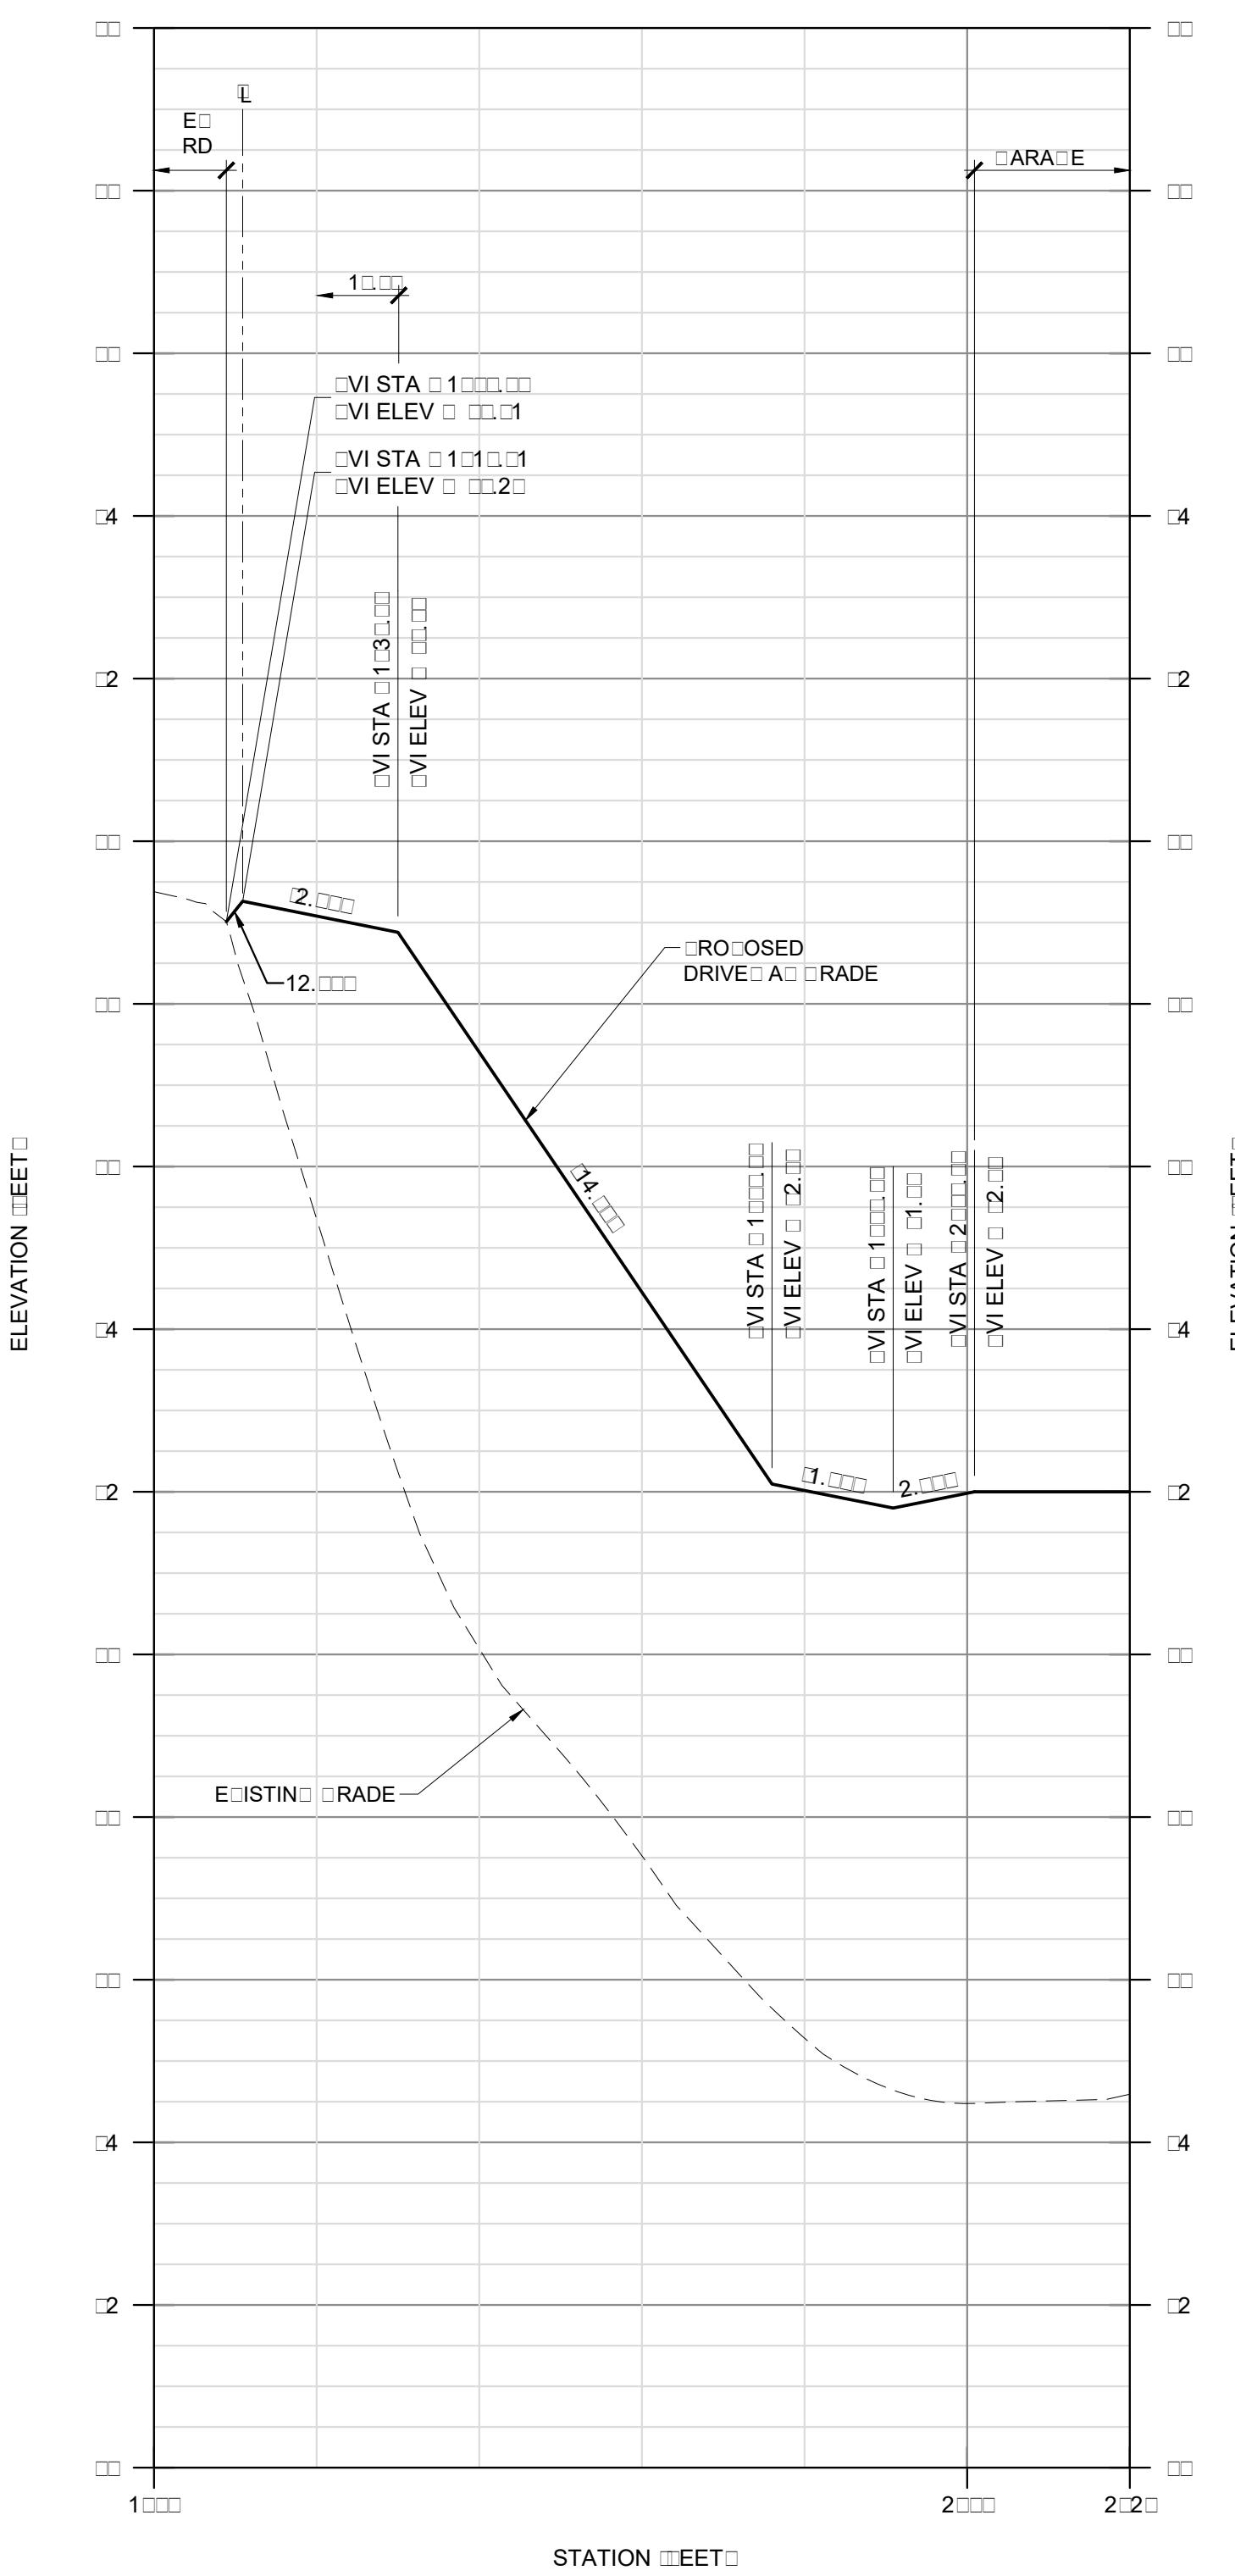


DRIVE A PROFILE

SCALE 1" 2" V1" 2"

DRIVE A PROFILES	VALLEMAR STREET JULIANA AVENUE MOSS EA JULIA ORNIA	PRELIMINARY NOT FOR CONSTRUCTION	MesitiMiller Engineering, Inc. CIVIL AND STRUCTURAL DESIGN 831.426.1186 Santa Cruz www.mmes.com	REV. RD LANNIN ERIN SU MITTAL DES IN REVIE RESUMMITAL OUR LOT LANNIN RESUMMITAL LOT 1 REVISIONS DATE RT-12/11 RT-12/11 RT-4/2/15 RT-12/11
DRAWN BY DRAFTED BY JO. NUMBER 1043 SHEET 4.4	REARED AT THE REQUEST OF MOSS LEAD ASSOCIATES 12 SIRNE ST SANTA CRUZ CA			

4.4

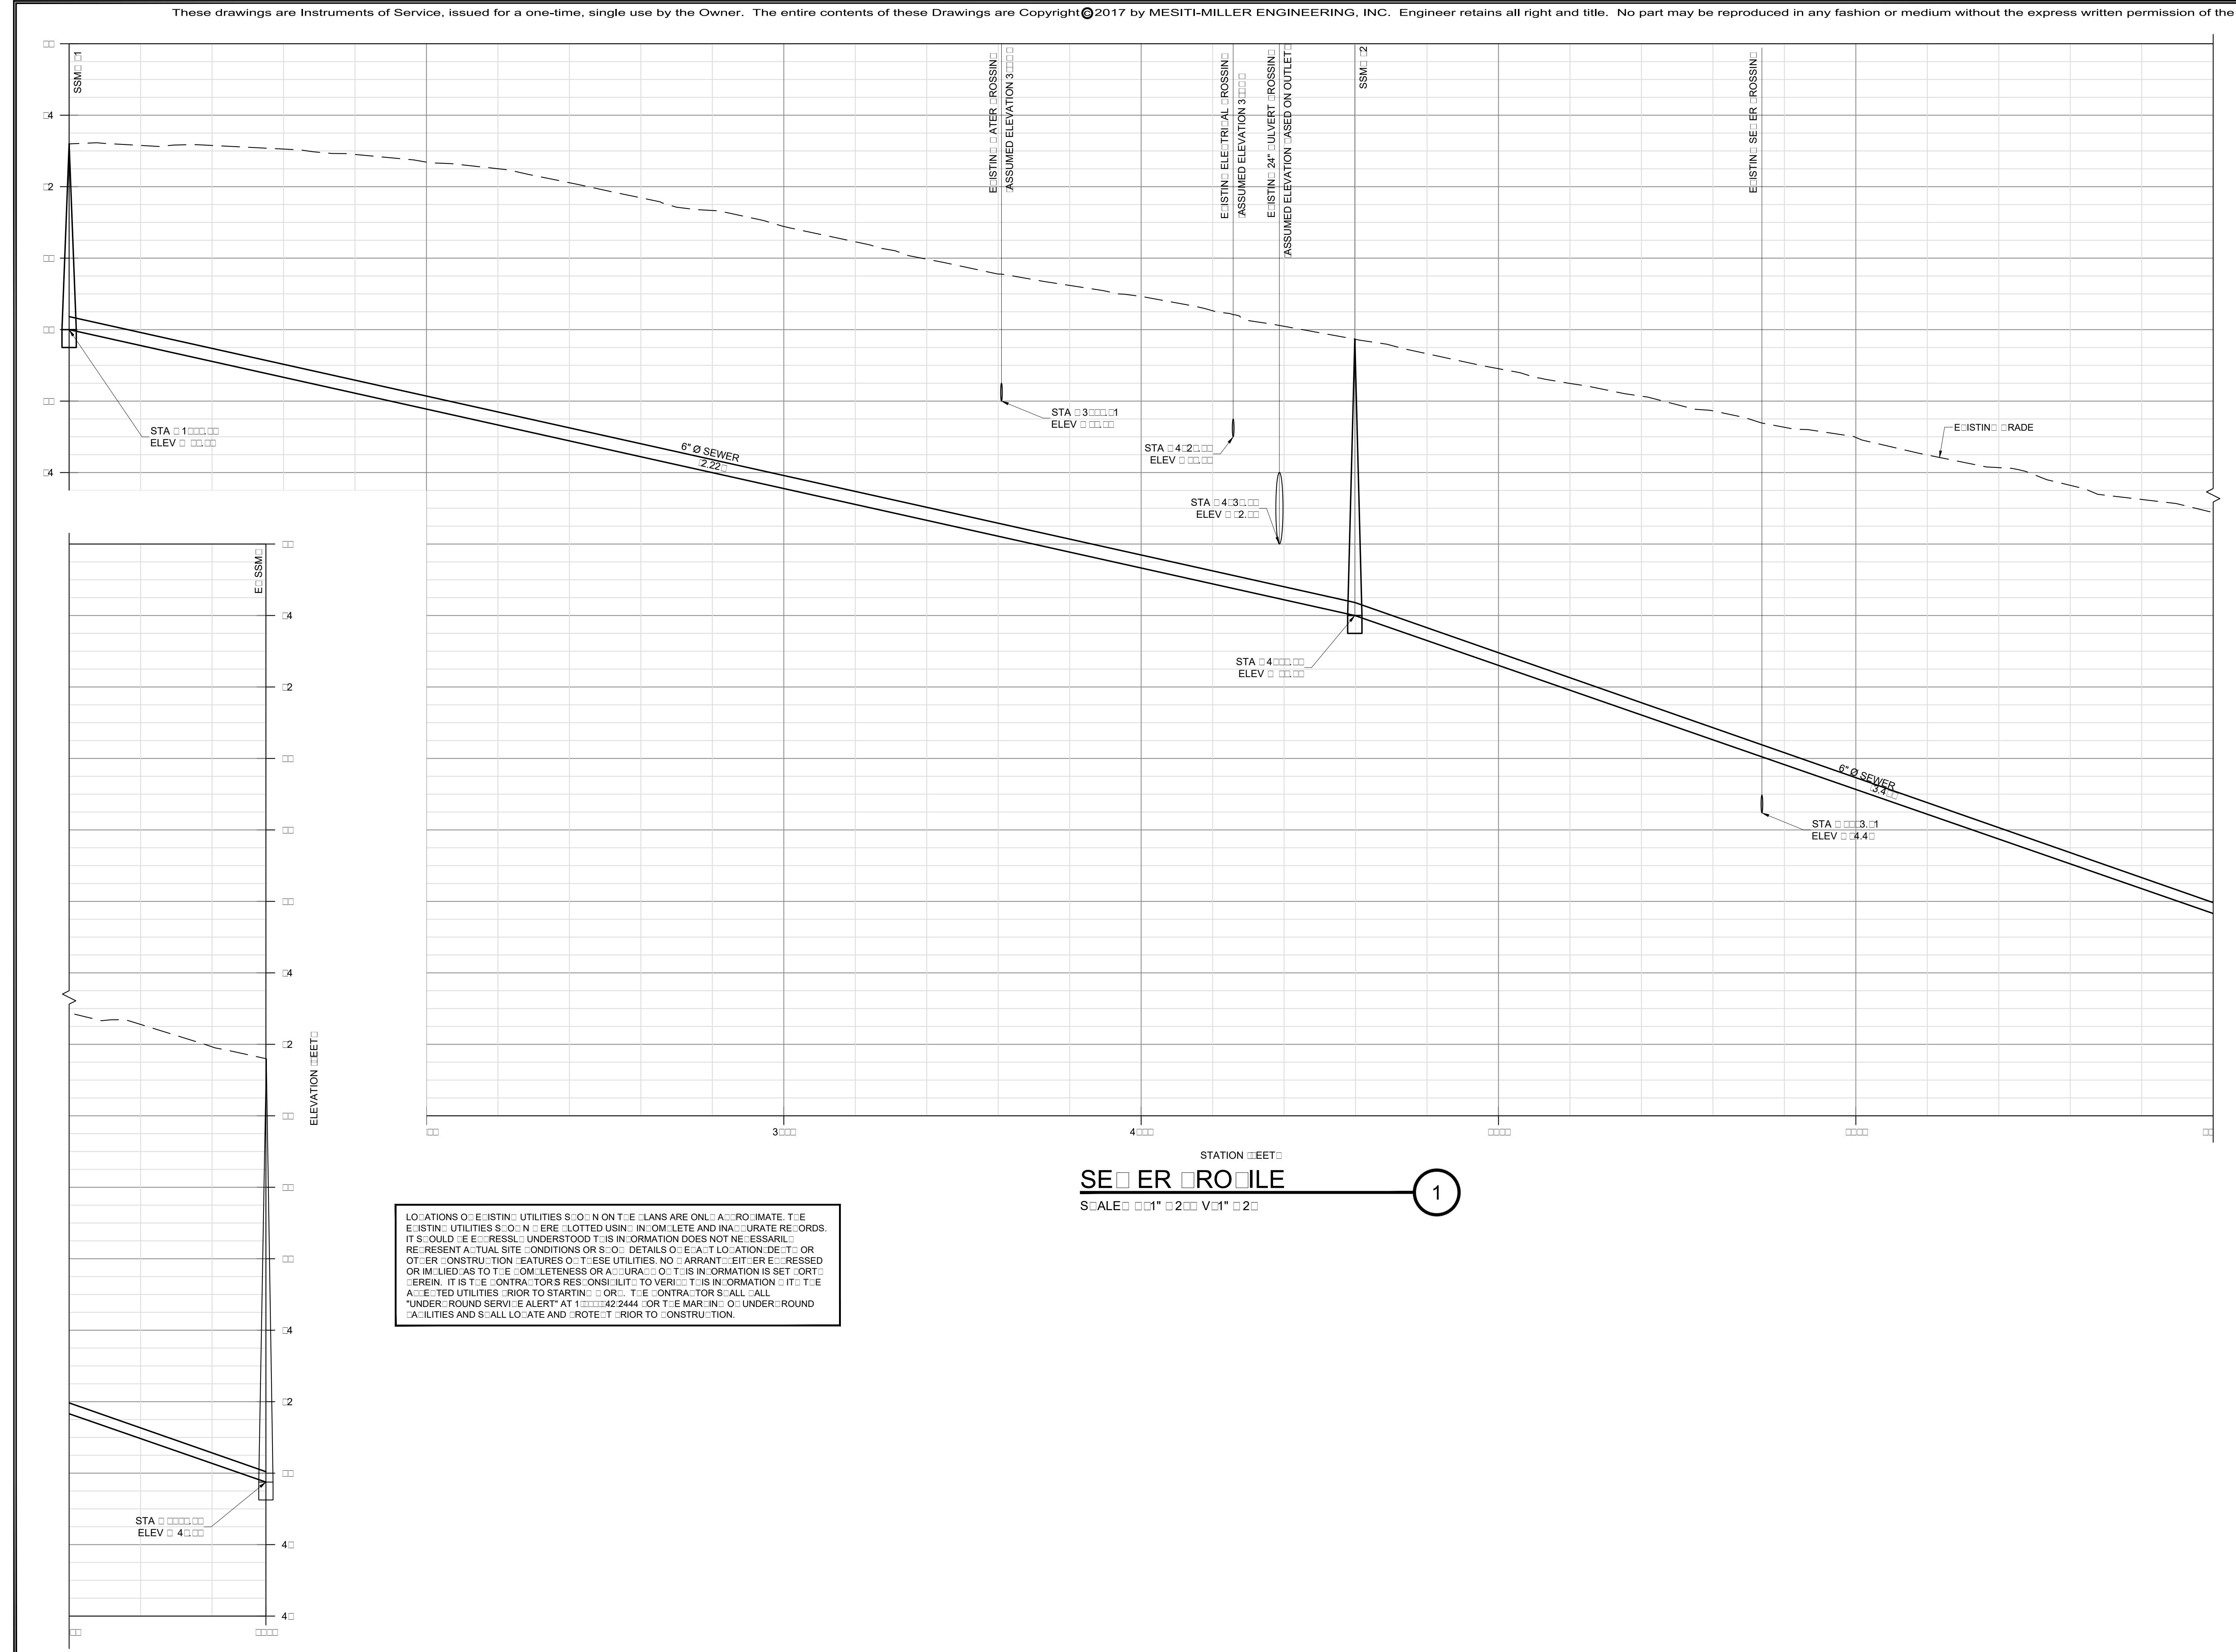

SEWER PROFILE	VALLEMAR STREET JULIANA AVENUE MOSS EA CALIFORNIA	PRELIMINARY NOT FOR CONSTRUCTION	Mesiti-Miller Engineering, Inc. CIVIL AND STRUCTURAL DESIGN 831-426-1186 Santa Cruz www.m-m-e.com
DRAFTER _____ RT _____ CODED _____ RT _____ JOB NUMBER 1040 SHEET _____	STATION EET ELEVATION FEET VALLEMAR STREET JULIANA AVENUE MOSS EA CALIFORNIA	RECEIVED AT THE REQUEST OF Moss Beach Associates 12 Spring St Santa Cruz, CA	REV. LANNAN - ERNST SUBMITTAL DES/NREV/E - RESUMMITAL OUR LOT - LANNAN RESUMMITAL LOT 1 REVISIONS

CABRILLO HIGHWAY

VALLEMAR STREET

SHEET NOTES

- [1] PROTECT ALL CUT AND DILT SLOPES WITH EROSION CONTROL CARRIERS AND OR MULCH
- [2] PROTECT ALL STORM DRAIN SYSTEMS AND DRAWS FROM SEDIMENT DURING CONSTRUCTION WITH DIRT TRAP INLET COVERS AND OR GRAVEL CARRIERS TO
- [3] PROTECT DITCHES FROM SEDIMENT DURING CONSTRUCTION WITH SILT ENDS AND/OR DIRT ROLLS
- [4] PREVENT CONCENTRATED RUNOFF FROM LOGGING OVER SLOPE
- [5] TEMPORARY SILT ENDS
- [6] TREE PROTECTION: TEMPORARY END TIE EASIER ALTRANS STANDARD PLAN TO REMOVE DENSE LOGGING ADOPT ORIGINAL STABILIZATION

Mesiti-Miller Engineering, Inc.
CIVIL AND STRUCTURAL DESIGN
831.426.4186 Santa Cruz, www.m-m-e.com

REV: 1 DATE: 12/11
RTD: 11/21
RTD: 11/21
RTD: 4/2/15
RTD: 2/21/15

PRELIMINARY

NOT FOR

CONSTRUCTION

MADE AT THE REQUEST OF
MOSS LEAD ASSOCIATES
12 S. RINCON ST.
SANTA CRUZ, CA

RECEIVED AT THE REQUEST OF
MOSS LEAD ASSOCIATES
12 S. RINCON ST.
SANTA CRUZ, CA



MAP/MATERIALS

GENERAL

- CONTROL AND PREVENT THE DISCHARGE OF ALL POTENTIAL POLLUTANTS (INCLUDING AVENEMENT CUTTING, ASTES, PAINTS, OIL, RETROFETEUM, RODENTS, CHEMICALS, ASH, TATER OR SEDIMENTS, RINSE WATER FROM ARCHAETURAL, MOISTER, AND NONSTORMATER DISCHARGES TO STORM DRAINS AND WATER COURSES).
- STORE, HANDLE AND DISPOSE OF CONSTRUCTION MATERIALS (ASTES, ROOFING) TO PREVENT CONTACT WITH STORMWATER.
- DO NOT CLEAN EQUIPMENT OR MAINTAIN VEHICLES ON SITE, EXCEPT IN A DESIGNATED AREA WHERE ASHATER IS CONTAINED AND TREATED.
- TRAIN AND PROVIDE INSTRUCTION TO ALL EMPLOYEES AND CONTRACTORS REGARDING CONSTRUCTION CMS.
- PROTECT ALL STORM DRAIN INLETS IN VICINITY OF SITE USING SEDIMENT CONTROLS SUCH AS FILTER ROLLS OR FILTERS. LIMIT CONSTRUCTION ACCESS ROUTES AND STAY OUT OF NATURAL ACCESS POINTS.
- FORGE LEARNER AND EXAMINER ACTIVITIES ONLY DURING THE DAY.
- USE SEDIMENT CONTROLS OR FILTERS TO REMOVE SEDIMENT AND DECONTAMINATE AND OBTAIN ALL NECESSARY PERMITS.
- TRANSPORT SEDIMENT ON SITE USING CMS SUCH AS SEDIMENT BASINS OR TRANSPORT ENCLUSES OR ERMS, SILT ENCLUSES, DAMS, SOIL LANETS OR MATS COVERS OR SOIL STOCKPILES.
- DIVERT ON-SITE RUNOFF AROUND EXPOSED AREAS DIVERT ON-SITE RUNOFF AROUND THE SITE INTO DRAWS AND DITCHES.

- PROTECT ADJACENT PROPERTIES AND UNDISTURBED AREAS FROM CONSTRUCTION IMPACTS USING VEGETATIVE COVER STRIPS, SEDIMENT CARRIERS OR FILTERS, DITCHES, MULCHING AND OTHER MEASURES AS APPROPRIATE.
- NO LAND CLEARING OPERATIONS OR GRADING OPERATIONS MAY TAKE PLACE BEFORE OCTOBER 1 AND APRIL 1, UNLESS A SEPARATE INTER EROSION CONTROL PLAN IS APPROVED PRIOR TO BEGINNING SUCH CONSTRUCTION.
- EROSION IS TO BE CONTROLLED AT ALL TIMES. THESE MEASURES SHOULD BE IMPLEMENTED AT ALL TIMES. ADDITIONAL MEASURES WILL BE REQUIRED FOR CONSTRUCTION BETWEEN OCTOBER 1 AND APRIL 1.
- EROSION CONTROL MEASURES SHALL BE MONITORED, MAINTAINED AND RECALLED AS NEEDED TO PREVENT EROSION OF SEDIMENT FROM THE SITE. NO TURBID RUNOFF SHALL BE ALLOWED TO LEAVE THE CONSTRUCTION SITE.

RESPONSIBILITY

- IT IS THE RESPONSIBILITY OF THE CONTRACTOR TO REGULARLY INSPECT THE EROSION AND SEDIMENT CONTROL MEASURES AND SUBMIT A REPORT TO THE OWNER AT THE TIME FUNCTIONING AS DESIGNED AND AT THE END OF THE PROJECT. THIS REPORT SHALL BE PROVIDED TO THE CONTRACTOR.
- IT IS THE CONTRACTOR'S RESPONSIBILITY TO SEE THAT ADDITIONAL MEASURES ARE NECESSARY TO CONTROL SITE EROSION AND PREVENT SEDIMENT TRANSPORT OFF-SITE ARE IMPLEMENTED.
- THE CONTRACTOR SHALL REMAIN ON-SITE DURING THE COURSE OF CONSTRUCTION. CONTRACTOR SHALL USE STRATEGIES SUCH AS DAMS AND/OR EROSION CONTROL PROTECTION DURING THE RAIN SEASON AS NECESSARY.
- BETWEEN OCTOBER 1 AND APRIL 1, STRATEGIC STOCKPILE SITES SHALL REMAIN ON-SITE DURING THE COURSE OF CONSTRUCTION. CONTRACTOR SHALL USE STRATEGIES SUCH AS DAMS AND/OR EROSION CONTROL PROTECTION DURING THE RAIN SEASON AS NECESSARY.
- EXCAVATED MATERIALS SHALL BE REMOVED TO AN APPROVED DISPOSAL SITE OR DISPOSED ON-SITE IN A MANNER THAT WILL NOT CAUSE EROSION.

GENERATED DRADING AND RELATED ACTIVITIES OUTSIDE THE DISTURBED AREA

- EROSION CONTROL MEASURES SHALL BE IMPLEMENTED AT ALL TIMES. ADDITIONAL MEASURES MAY TAKE PLACE PRIOR TO ESTABLISHMENT OF THE PROJECT AND ERODED SOIL OR DISRUDED SLOPES SHALL BE PERMANENTLY PROTECTED FROM EROSION.
- ALL DISTURBED AREAS SHALL BE DROSEEDED USING A NATIVE SEED MIXTURE AND MULCHED SO THAT THE DISTURBED AREAS ARE ROTOTILLED PRIOR TO OCTOBER 1. IN THE EVENT THAT IT IS NOT POSSIBLE TO ESTABLISH MATURE GRASS PRIOR TO OCTOBER 1, IN THE EVENT THAT IT IS NOT POSSIBLE TO ESTABLISH MATURE GRASS PRIOR TO OCTOBER 1, ALL DISTURBED AREAS SHALL BE DROSEEDED, MULCHED AND PROTECTED FROM EROSION. CONTROL PLANS SHALL BE INSTALLED IN ACCORDANCE WITH THE MANUFACTURERS INSTRUCTIONS.

EROSION CONTROL PLAN

EROSION CONTROL PLAN

- EROSION CONTROL MEASURES SHALL NOT BE REMOVED OR DESTROYED OR CONSTRUCTION ACTIVITIES MORE THAN 1 DAY DURING THIS PERIOD. EROSION AND SEDIMENT CONTROL MEASURES SHALL BE MAINTAINED AT ALL TIMES.
- ONCE THE PROJECT AND ALL DISTURBED AREAS ARE ROTOTILLED, THE PROJECT AND ALL DISTURBED AREAS SHALL BE PERMANENTLY PROTECTED FROM EROSION.
- CONTRACTOR SHALL IDENTIFY AND MARK ALL EXISTING VEGETATION TO BE PROTECTED IN THE DISTURBED AREA.

RUNOFF

RUNOFF

- NO TURBID RUNOFF SHALL BE ALLOWED TO LEAVE THE SITE.
- RUNOFF MUST BE PREVENTED FROM LOGGING OVER UNPROTECTED SLOPES.
- EE RUNOFF AREA DISTURBED AREAS DURING DRADING AND RELATED ACTIVITIES.
- SILT CARRIERS SHALL BE CONSTRUCTED ALONG THE BOTTOM OF ALL GRADED SLOPES.

SEEDING

SEEDING

- TEMPORARY SEED MIXTURES SHALL CONSIST OF NATIVE SEEDS AND SHALL BE APPLIED AT RATE OF 14 POUNDS PER ACRE. SEED SHALL BE SUBMITTED BY LANDSCAPE ARCHITECT OR REVIEWER FOR APPROVAL.
- PRIOR TO REMOVING DODGE, ROCKS AND DEBRIS FROM THE DISTURBED AREA, RAKE OUT SURFACE TO PROVIDE A SMOOTH TRANSITION FROM EROSION CONTROL PLANTS.
- CONTRACTOR SHALL IDENTIFY AND MARK ALL EXISTING VEGETATION TO BE PROTECTED IN THE DISTURBED AREA.

IRRIGATION

IRRIGATION

- IRRIGATION SHALL BE USED SO THAT EROSION CONTROL PLANTING IS ESTABLISHED AS SOON AS POSSIBLE. THE SOIL SHOULD BE KEPT CONTINUALLY MOIST UNTIL THE SEED GERMINATES. 23 FEET OF GRASS IS THREE INCHES 3' X 1'. THEN CONTINUE TO WATER A LOT ON THE EED OR AS REQUIRED UNTIL THE RAINY SEASON BEGINS. IRRIGATION SHALL BE CLOSELY MONITORED SO THAT IT WILL NOT CAUSE AN EROSION PROBLEM.

- Maintaining the contractor shall commence after the covered areas are in place after seedling. The area will continue until the ground cover is fully developed and as required, the owner shall monitor, maintain and repair all erosion control measures as required.

SOILS


SOILS

- SOILS MUST BE REMOVED FROM THE STOCKPILE OR MATERIALS MUST BE AVOIDED DURING RAIN. LOGGING DURING RAIN TREATMENTS STOCKPILE SOILS AND OTHER MATERIALS SHALL BE COVERED WITH A TAR OR OTHER WATERPROOF MATERIAL.

- EXCAVATED MATERIALS SHALL BE REMOVED TO AN APPROVED DISPOSAL SITE OR DISPOSED ON-SITE IN A MANNER THAT WILL NOT CAUSE EROSION.

EROSION CONTROL PLAN

SCALE: 1" = 200'

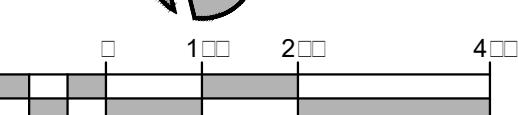

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DRAG

DAM

DAM

DEEDED

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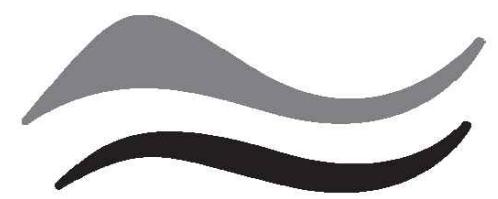
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DRAG




**SAN MATEO COUNTYWIDE
Water Pollution
Prevention Program**

Clean Water. Healthy Community.

Construction Best Management Practices (BMPs)

Construction projects are required to implement the stormwater best management practices (BMP) on this page, as they apply to your project, all year long.

Materials & Waste Management

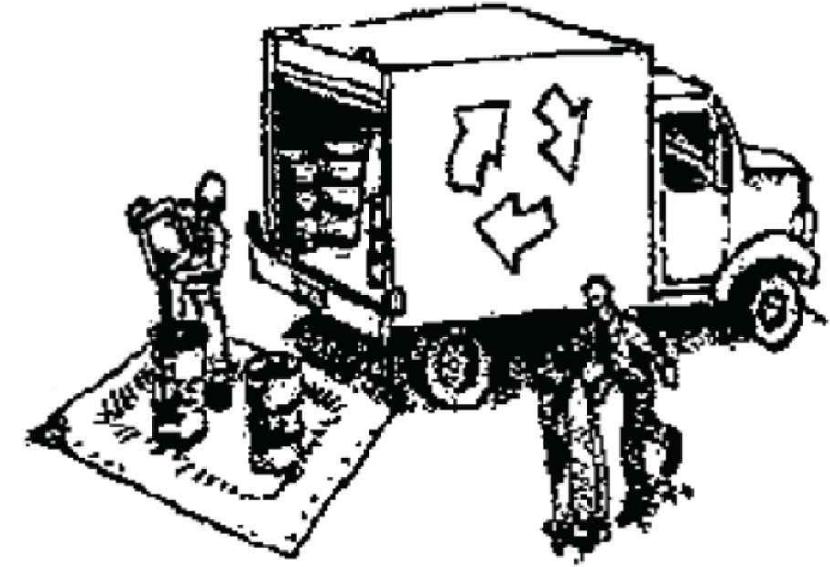

Non-Hazardous Materials

- Berm and cover stockpiles of sand, dirt or other construction material with tarps when rain is forecast or if not actively being used within 14 days.
- Use (but don't overuse) reclaimed water for dust control.

Hazardous Materials

- Label all hazardous materials and hazardous wastes (such as pesticides, paints, thinners, solvents, fuel, oil, and antifreeze) in accordance with city, county, state and federal regulations.
- Store hazardous materials and wastes in water tight containers, store in appropriate secondary containment, and cover them at the end of every work day or during wet weather or when rain is forecast.
- Follow manufacturer's application instructions for hazardous materials and be careful not to use more than necessary. Do not apply chemicals outdoors when rain is forecast within 24 hours.
- Arrange for appropriate disposal of all hazardous wastes.

Waste Management

- Cover waste disposal containers securely with tarps at the end of every work day and during wet weather.
- Check waste disposal containers frequently for leaks and to make sure they are not overfilled. Never hose down a dumpster on the construction site.
- Clean or replace portable toilets, and inspect them frequently for leaks and spills.
- Dispose of all wastes and debris properly. Recycle materials and wastes that can be recycled (such as asphalt, concrete, aggregate base materials, wood, gyp board, pipe, etc.)
- Dispose of liquid residues from paints, thinners, solvents, glues, and cleaning fluids as hazardous waste.

Construction Entrances and Perimeter

- Establish and maintain effective perimeter controls and stabilize all construction entrances and exits to sufficiently control erosion and sediment discharges from site and tracking off site.
- Sweep or vacuum any street tracking immediately and secure sediment source to prevent further tracking. Never hose down streets to clean up tracking.

Equipment Management & Spill Control




Maintenance and Parking

- Designate an area, fitted with appropriate BMPs, for vehicle and equipment parking and storage.
- Perform major maintenance, repair jobs, and vehicle and equipment washing off site.
- If refueling or vehicle maintenance must be done onsite, work in a bermed area away from storm drains and over a drip pan or drop cloth big enough to collect fluids. Recycle or dispose of fluids as hazardous waste.
- If vehicle or equipment cleaning must be done onsite, clean with water only in a bermed area that will not allow rinse water to run into gutters, streets, storm drains, or surface waters.
- Do not clean vehicle or equipment onsite using soaps, solvents, degreasers, or steam cleaning equipment.


Spill Prevention and Control

- Keep spill cleanup materials (e.g., rags, absorbents and cat litter) available at the construction site at all times.
- Inspect vehicles and equipment frequently for and repair leaks promptly. Use drip pans to catch leaks until repairs are made.
- Clean up spills or leaks immediately and dispose of cleanup materials properly.
- Do not hose down surfaces where fluids have spilled. Use dry cleanup methods (absorbent materials, cat litter, and/or rags).
- Sweep up spilled dry materials immediately. Do not try to wash them away with water, or bury them.
- Clean up spills on dirt areas by digging up and properly disposing of contaminated soil.
- Report significant spills immediately. You are required by law to report all significant releases of hazardous materials, including oil. To report a spill: 1) Dial 911 or your local emergency response number, 2) Call the Governor's Office of Emergency Services Warning Center, (800) 852-7550 (24 hours).

Earthmoving

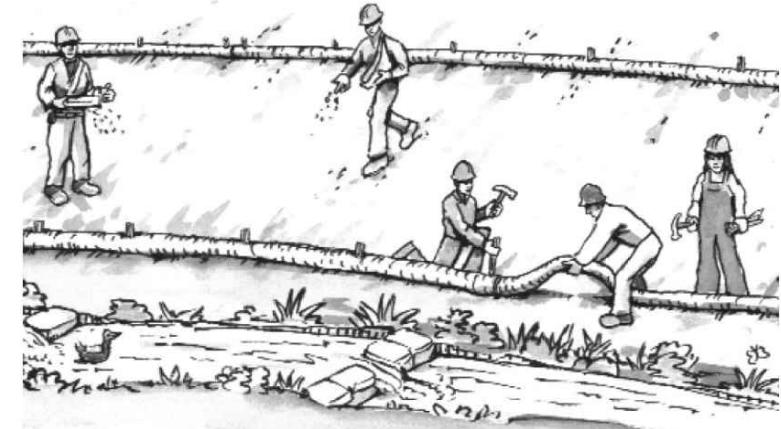

Paving/Asphalt Work

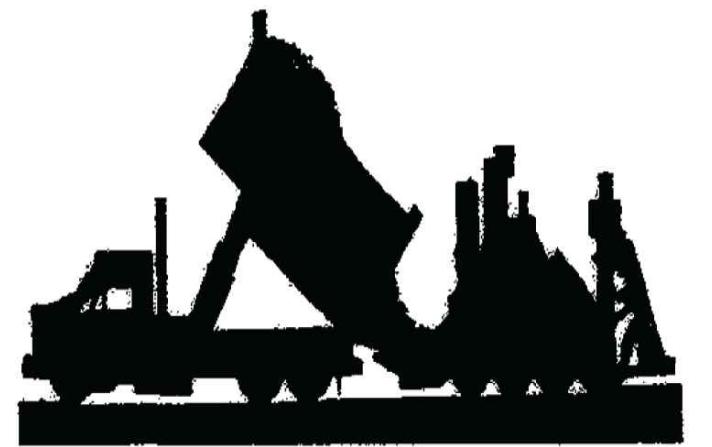

- Avoid paving and seal coating in wet weather or when rain is forecast, to prevent materials that have not cured from contacting stormwater runoff.
- Schedule grading and excavation work during dry weather.
- Stabilize all denuded areas, install and maintain temporary erosion controls (such as erosion control fabric or bonded fiber matrix) until vegetation is established.
- Remove existing vegetation only when absolutely necessary, and seed or plant vegetation for erosion control on slopes or where construction is not immediately planned.
- Prevent sediment from migrating offsite and protect storm drain inlets, gutters, ditches, and drainage courses by installing and maintaining appropriate BMPs, such as fiber rolls, silt fences, sediment basins, gravel bags, berms, etc.
- Wash out concrete equipment/trucks offsite or in a designated washout area, where the water will flow into a temporary waste pit, and in a manner that will prevent leaching into the underlying soil or onto surrounding areas. Let concrete harden and dispose of as garbage.
- Do not use water to wash down fresh asphalt concrete pavement.

Sawcutting & Asphalt/Concrete Removal

- Protect nearby storm drain inlets when saw cutting. Use filter fabric, catch basin inlet filters, or gravel bags to keep slurry out of the storm drain system.
- Shovel, absorb, or vacuum saw-cut slurry and dispose of all waste as soon as you are finished in one location or at the end of each work day (whichever is sooner!).
- If sawcut slurry enters a catch basin, clean it up immediately.

Contaminated Soils

- If any of the following conditions are observed, test for contamination and contact the Regional Water Quality Control Board:
 - Unusual soil conditions, discoloration, or odor.
 - Abandoned underground tanks.
 - Abandoned wells
 - Buried barrels, debris, or trash.

Concrete, Grout & Mortar Application




- Store concrete, grout, and mortar away from storm drains or waterways, and on pallets under cover to protect them from rain, runoff, and wind.
- Wash out concrete equipment/trucks offsite or in a designated washout area, where the water will flow into a temporary waste pit, and in a manner that will prevent leaching into the underlying soil or onto surrounding areas. Let concrete harden and dispose of as garbage.
- When washing exposed aggregate, prevent washwater from entering storm drains. Block any inlets and vacuum gutters, hose washwater onto dirt areas, or drain onto a bermed surface to be pumped and disposed of properly.

Landscaping



- Protect stockpiled landscaping materials from wind and rain by storing them under tarps all year-round.
- Stack bagged material on pallets and under cover.
- Discontinue application of any erodible landscape material within 2 days before a forecast rain event or during wet weather.


Painting & Paint Removal

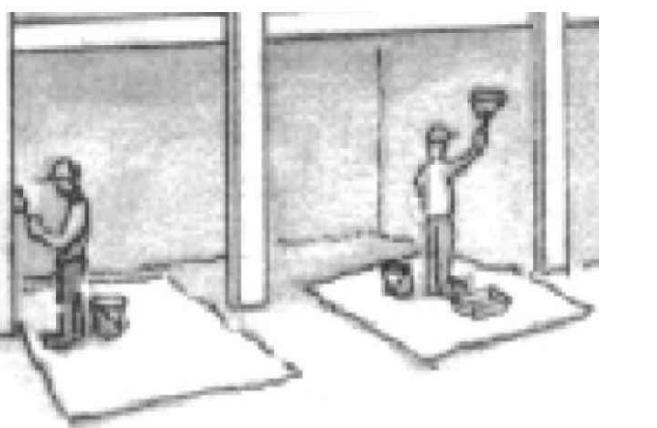

Painting Cleanup and Removal

- Never clean brushes or rinse paint containers into a street, gutter, storm drain, or stream.
- For water-based paints, paint out brushes to the extent possible, and rinse into a drain that goes to the sanitary sewer. Never pour paint down a storm drain.
- For oil-based paints, paint out brushes to the extent possible and clean with thinner or solvent in a proper container. Filter and reuse thinners and solvents. Dispose of excess liquids as hazardous waste.
- Paint chips and dust from non-hazardous dry stripping and sand blasting may be swept up or collected in plastic drop cloths and disposed of as trash.
- Chemical paint stripping residue and chips and dust from marine paints or paints containing lead, mercury, or tributyltin must be disposed of as hazardous waste. Lead based paint removal requires a state-certified contractor.

Dewatering

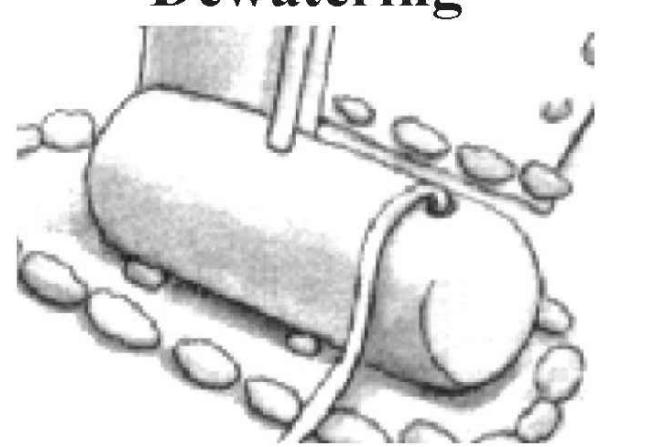

- Discharges of groundwater or captured runoff from dewatering operations must be properly managed and disposed. When possible send dewatering discharge to landscaped area or sanitary sewer. If discharging to the sanitary sewer call your local wastewater treatment plant.
- Divert run-on water from offsite away from all disturbed areas.
- When dewatering, notify and obtain approval from the local municipality before discharging water to a street gutter or storm drain. Filtration or diversion through a basin, tank, or sediment trap may be required.
- In areas of known or suspected contamination, call your local agency to determine whether the ground water must be tested. Pumped groundwater may need to be collected and hauled off-site for treatment and proper disposal.

Storm drain polluters may be liable for fines of up to \$10,000 per day!

CONSTRUCTION MILE	VALLEMAR STREET	JULIANA AVENUE	MOSS	PREPARED AT THE REQUEST OF	NOSEY LEAD ASSOCIATES	NOSEY LEAD ASSOCIATES
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831-426-1186 Santa Cruz www.m-m-e.com



Mesiti-Miller Engineering, Inc.
CIVIL AND STRUCTURAL DESIGN

