## Planning Permit Application Form

San Mateo County Planning and Building Department

455 County Center, 2nd Floor • Redwood City CA 94063 Mail Drop: PLN 122 • TEL [650] 363-4161 • FAX [650] 363-4849 www.co.sanmateo.ca.us/planning

PLN: 2016-00317

Applicant/OwnerInformation	
Applicant: MARK REILLY, MARK I	RELUCY APCHITECTURE,
Malling Address: 163 PARK ST	STOCK ACCINITION OF
SAN FRANCISCO, CA	Zip: 94110
Phone, W: 415-309-0107	H: ~
E-mail Address: MARKE MARKPEILU (ARCHITECTURE	COM FAX:
- T Stor (B) - ON (NO TON)	21001
Name of Owner (1): JULIA PAIGE & DAN SPANGUER	Name of Owner (2):
Malling Address: 146 LA GRANDE AVE	Mailing Address:
MOSS BEACH, CA	Market Market Market Company
zip: 94038	
Phone,W: ~	Phone,W: San Mateo County
H: 323-496-9669	H: Planning and Building Department
E-mail Address: JPAIGE @ GOOGLE, COM	E-mail Address:
(Mojequinomiation)	
Project Location (address): 146 LA GRANDE AVE	Assessor's Parcel Numbers: 037 - 258 - 1990 260
MOSS BEACH, CA	
94038	
zoning: R-1/5-17/DR/GH/CD	Parcel/lot size: (6,548 SF (Square Feet)
List all elements of proposed project: [e.g. access, size and local	ation, primary and accessory structures, well, septic, tank)
SHE IS A 10,548 SOFT CORNER LOT,	ACCESSED BY LA GRANDE AVE AND
SAN KAMON AVE IN MOSS BEACH,	THE PROPOSED PROJECT WILL DEMOUSE
THE EXISTING STRUCTURE AND BUILD A	NEW THO STORY SINGLE FAMILY
HOME WITH A FRONT PORCH, SIDE AN THE EXISTING PLAY STRUCTURES WILL	DE PELOCATED ON THE COOP DECE.
Describe Existing Site Conditions/Features (e.g. topography, v	vater bodies, vegetation):
	D CONTAINS SEVERAL CYPRUS TREES,
THE CYPRUS TREES WILL BE PRES	»EPVEIZ»
Describe Existing Structures and/or Development: THE EXISTING STRUCTURE 15 A TW	D STORY SINGLE FAMILY HOME WITH
MULTIPLE DECKS, A PARKING PAD, AND	
•	VIEED SETBACK AND THE GARAGE
DOES NOT MEET CODE, SIZE PEQUI	REMIENTS, THERE IS ALSO A
PLAY STRUCTURE/SHED, DOG RUN, AND	FENCE ON THE PROPERTY.
Signatures	
We hereby certify that the information stated above and on for	orms, plans and other materials submitted berewith in support
of the application is true and correct to the best of our knowle	dge. It is our responsibility to inform the County of San Mateo
through our assigned project planner of any changes to infon	nation represented in these submitalls.
Owner's signature:	
Owner's signature:	• •
Applicant's signature: MOLAL, MANA	
- AND STAND	L-lweb stufAPBSite\pdRForm\22054 09-06-12

### Application for Design Review by the **County Coastside Design Review Committee**

HOME WITH PARTIAL ROOF DECK.

Design Review by the County Coastside Design Review Committee	County Government Center = 455 County Center = Redwood City CA 94063  Mail Drop PLN 122 = 650 - 363 - 4161 = FAX 650 - 363 - 4849  Permit #: PLN 20/6-00 3/7
	Other Permit #:
Applicant:	Owner (if different from Applicant):
Name: MARK REIUT	Name: JULIA PAIGE & DAN SPANGUER
Address: 163 PARK ST	Address: 146 LA GRANDE AVE
SF, CA Zip: 94110	MOGS BEACH, CA Zip: 94038
Phone, W: 415-309-0107 H: -	Phone,W: - H: 323-496-9669
Email: MARKEMARKPEILL; ARCHITECTURE, COM	
<b>Architect or Designer</b> (if different from Applicant): Name:	,
Address:	Zip:
Phone,W: H:	Email:
Project location:	Site Description:
APN: 037-258-000 Z60	☐ Vacant Parcel
Address: 146 LA GRANDE DVE	
MOSS BEACH, CA Zip: 94038	SINGLE FAMILY, TWO STORY RESIDENCE
Zoning: R-1/5-17/DR/GH/CD	W/NON CODE COMPLIANT SETBACKS,
Parcel/lot size: 10,548 sq. ft.	GARAGE SIZE, AND SECONDARY UNIT
Project:	Additional Permits Required:
Mew Single Family Residence: 5,393 sq. ft	Certificate of Compliance Type A or Type B
☐ Addition to Residence: sq. ft	☑ Coastal Development Permit
Other:	☐ Fence Height Exception (not permitted on coast)
	☐ Grading Permit or Exemption
Describe Project:	☐ Home Improvement Exception
DEMOUSH EXISTING, TWO STORY HOME	□ Non-Conforming Use Permit
AND CONSTRUCT A NEW TWO STORY	Off-Street Parking Exception

San Mateo County Planning and Building Department

AUG 0 1 2016

□ Variance

Pares San Parassa	HAR-A	Color/Finish	Check if matches
Fill in Blanks:	Waterial		existing
		(If different from existing, attach sample)	
a, Exterior walls	CEDAR SHINGUES	NATURAL/CLEAR STAIN	
b. Trim	HOOD	BLACK	
c. Windows	DOOM DAN MUMIMULA	BLACK	
d. Doors	GOOM DAJS MUNIMULA	BLACK	
e, Roof	STANDING SEAM METAL	GRAY	
. Chimneys	CEDAR SHINGLES	NATURAL/CLEAR STAIN	
g. Decks & railings	WOOD DECKS/ PAILINGS	NATURAL DECK/BLACK STEET	
h. Stairs	MOOD	NATURAL TREADS & BLACK STRINGERS	
. Retaining walls	BOARD FORMED CONCRETE	NATURAL	
. Fences	CEDAR OF REDWOOD BOARDS	MATURAL	
k. Accessory buildings			
Garage/Carport	CEDAR SHINGLES	NATURAL/CLEAR STAIN	
o approve this applicat	ion, the County must determine that this pro indings that the project does conform to the	standards and guidelines for design revi	
o approve this applicat ncluding the required f pplicable to the locatio	cion, the County must determine that this pro indings that the project does conform to the on of the project pursuant to Section 6565.10	standards and guidelines for design revi I.	ew
To approve this applicat ncluding the required f applicable to the locatio	ion, the County must determine that this pro indings that the project does conform to the	standards and guidelines for design revi I.	ew
o approve this applicat neluding the required f applicable to the location (aptional) Applic	cion, the County must determine that this proindings that the project does conform to the on of the project pursuant to Section 6565.10 ant's Statement of project compliance with st	standards and guidelines for design revi I. andards and guidelines (check if attache	ew Langu
To approve this applicate not adding the required for applicable to the location (optional). Application the application appli	cion, the County must determine that this pro indings that the project does conform to the on of the project pursuant to Section 6565.10	standards and guidelines for design revi andards and guidelines (check if attache s, and other materials submitted herewi ledge. It is my responsibility to inform the	th in e County of
To approve this applicate not adding the required for applicable to the location (optional). Application the application appli	cion, the County must determine that this proindings that the project does conform to the on of the project pursuant to Section 6565.10 ant's Statement of project compliance with stant's Statement and project compliance with stantian stated above and on forms, plant on is true and correct to the best of my know assigned project planner of any changes to in	standards and guidelines for design reviol.  andards and guidelines (check if attache and other materials submitted herewilledge. It is my responsibility to inform the information represented in these submitt	th in e County of
To approve this applicate not adding the required for applicable to the location (optional). Application the application appli	cion, the County must determine that this proindings that the project does conform to the on of the project pursuant to Section 6565.10 ant's Statement of project compliance with stant's Statement and project compliance with stantian stated above and on forms, plant on is true and correct to the best of my know assigned project planner of any changes to in	standards and guidelines for design reviol.  andards and guidelines (check if attache and other materials submitted herewilledge. It is my responsibility to inform the information represented in these submitt	th in e County of
To approve this applicate including the required fapplicable to the location (optional) Application (optional) App	cion, the County must determine that this proindings that the project does conform to the on of the project pursuant to Section 6565.10 ant's Statement of project compliance with stant's Statement and project compliance with stantian stated above and on forms, plant on is true and correct to the best of my know assigned project planner of any changes to in	standards and guidelines for design revi andards and guidelines (check if attache s, and other materials submitted herewi ledge. It is my responsibility to inform the	th in e County of
o approve this applicate including the required fapplicable to the location (aptional) Application (aptional) Application (application) Application	cion, the County must determine that this proindings that the project does conform to the on of the project pursuant to Section 6565.10 ant's Statement of project compliance with stant's Statement and project compliance with stantian stated above and on forms, plant on is true and correct to the best of my know assigned project planner of any changes to in	standards and guidelines for design reviol.  andards and guidelines (check if attache and other materials submitted herewilledge. It is my responsibility to inform the information represented in these submitt	th in e County of
To approve this applicate including the required fapplicable to the location (optional) Application (optional) App	cion, the County must determine that this proindings that the project does conform to the on of the project pursuant to Section 6565.10 ant's Statement of project compliance with stant's Statement and project compliance with stantian stated above and on forms, plant on is true and correct to the best of my know assigned project planner of any changes to in	standards and guidelines for design reviol.  andards and guidelines (check if attache and other materials submitted herewilledge. It is my responsibility to inform the information represented in these submitt	th in e County of
o approve this applicate actuding the required find pplicable to the location (optional) Application (optional) Ap	ion, the County must determine that this proindings that the project does conform to the on of the project pursuant to Section 6565.10 ant's Statement of project compliance with standard and the conformation stated above and on forms, plant is true and correct to the best of my know assigned project planner of any changes to incompliance.	standards and guidelines for design reviol.  andards and guidelines (check if attache and other materials submitted herewilledge. It is my responsibility to inform the information represented in these submitt	th in e County of

### 

# Application for a Coastal Development Permit

455 County Center , 2nd Floor · Redwood City, CA 94063 Mail Drop: PLN 122 · TEL (650) 363-4161 · FAX (650) 363-4849

**Companion Page** 

Applicant's Name: MARK REILLY

Primary Permit #: PLN 2016-003/7

#### **直程115112(中)**(01)5章

g. Retaining Walls

i. Storage Tanks

h. Fences

Please fill out the general Planning Permit Application Form and this form when applying for a Coastal Development Permit. You must also submit all items indicated on the checklist found on the reverse side of the Planning Permit Application Form.

	The transfer of the creeking found	or the reverse side of the rialling remit App	DICATION FORM.
	madon		
listed?	licant own any adjacent property not Yes 👿 No	Have you or anyone else previously applied County of San Mateo or the California Coasta for a Coastal Development Permit for this or at this location?    Yes  No	al Commission
If yes, list Assessor's Parc		If yes, explain (include date and application f	file numbers).
	AUG 0 1 2016		
	San Mateo County Planning and Building Department		
		Hinderd Studings -	
Fill in Blanks:	section you do not need to file a sepai Material	. r	Check if matches existing
a. Exterior Walls	CEDAR SHINGLES	NATURAL/CLEAR STAIN	
o. Trim	MOOD	BLACK	
c. Roof	STANDING SEAM MET	•	
d. Chimneys	CEDAR SHINGLES	MATURAL/CLEAR STAIN	
e. Accessory Buildings	~	DECT	
. Decks/Stairs	MOOD	NATURAL TREADS & BRINGERS BLACK POSTS & STRINGERS	

NATURAL

CEDAR OR REDWOOD ECARDS NATURAL/CLEAR STAIN

BOARD FORMED CONCRETE

related automotion										
Does this project, the parcel on which it is lo immediate vicinity involve or include:	ocated or	r the	p. Between the sea and the nearest public road?		ď					
a. Demolition of existing housing units?.	Yes	No	q. Existing or proposed provisions for public access to the shoreline?		ď					
(If yes, give value of owner-occupied	☑		r. Public or commercial recreation facilities?		ď					
units or current monthly rent of rental units in explanation below.)			s. Visitor-serving facilities?		<u> </u>					
b. Creeks, streams, lakes or ponds?		Q	t. Existing or proposed public trail		,					
c. Wetlands (marshes, swamps, mudflats)?		回	easements?		$\square$					
d. Beaches?		Ø	Explain all Yes answers below. Indicate							
e. Sand Dunes?		IX	item applies to the project itself, the parcel on							
f. Sea cliff, coastal bluffs or blufftops?		$\square$	located, or the immediate vicinity (attach addinecessary):	uonai sr	neets if					
g. Ridgetops?		IX	A. DEMOLISHING EXISTING SING	GUE I	FAMIL					
h. Pampas Grass, invasive brooms or		囡	HOME AND CONSTRUCTING A I	VE M						
Weedy Thistle?	,	•	SINGLE FAMILY HOME.							
i. Removal of trees or vegetation?	<b>∑</b>		I REMOVING SMALLER, NO	 N-11	ATIVE					
j. Grading or alteration of landforms?	<u> </u>		UNPROTECTED TREES PER							
k. Landscaping?		☑ /	CYPRUS TREES ON SITE.		V 11412					
I. Signs?		☑ 	1 PERFORMING SUGAT C	, D VD						
<ul> <li>m. Phone or utility line extensions or connections, either above or below</li> </ul>		区	1							
ground (explain which)?		,	WORK TO ACCOMMODATE		△					
n. Areas subject to flooding?		₫,	HOME AND IMPROVE SIT							
o. Development on slopes 30% or steeper?		☑	DRAINAGE.							
是是一行工具。1717年										
California Coastal Commission Juri	isdictic	on	Commission; a public hearing is always require	≞d.						
A. Does the Proposed Project Involve:  1. A subdivision, Certificate of Compliance Type B, Use Permit, or Planned Agricultural District Permit?  Yes  No		<b>B.</b> Does the proposed project involve lands below the mean high tide line and lands where the public trust may exist? (See "Post CCP Certification Permit and Appeal Jurisdiction Map).								
					Construction or grading within 100 feet of wetland?	a stream	ı or	☐ Yes        Mo		
					□ Yes ☑ No			Var to above means that the California County	<i>-</i> .	
3. A parcel located between the sea and the fi through road paralleling the sea; 300 feet fr extent of any beach or mean high tide line i beach; or within 300 feet of the top of the s	om the i f there is	inland s no	Yes to above means that the California Coastal retains permit jurisdiction over all or part of the project. A Coastal Development Permit from th required.	propos	sed					
a coastal bluff?  ☐ Yes ☐ No		i	Reviewed by:							
_ 163 140		į								
Yes to any one of the above means that the Coastal  Development Permit is appealable to the Coastal										

# **Environmental Information Disclosure Form**

PLN 2016-003/7
BLD\_\_\_\_\_\_\_\_

Project Address: 146 LA GRANDE AVE	Name of Owner: JULIA PAIGE & DAN SPONGLER
MOSS BEACH, CA 94038	Address: 146 LA GRANDE AVE
	MOSS BEACH, CA Phone: 323-496-9669
Assessor's Parcel No.: 037 — 258 — GMO 260	Name of Applicant: MARK REIUT
	Address: 163 PARK ST, SF, CA 94110
Zoning District: Palacation Icalian	Phone: 415-309-0107
Zoning District: R-1/5-17/DR/GH/CD	
Existing Site Conditions	
Parcel size: 10,548 < FT	
Describe the extent and type of all existing development and u	
purpose of any easements on the parcel, and a description of creeks, vegetation). AN EXISTING, TWO STORY	any natural features on the project parcel (i.e. steep terrain,  SINGUE FAMILY HOME WITH TWO
LARGE DECKS & CONCRETE PATIO ON	
WITH CYPRUS TREES.	A FORDORINANILI FLAT SITE
VIIIV CIPEUS INTES	
Environmental Review Checklist	
1. California Environmental Quality Act (CEQA)	Beview
Yes No Will this project involve:	
a. Addition to an existing structure > 50% of	of the existing area OR > 2.500 cg. ft2
b. Construction of a new multi-family reside	· · · · · · · · · · · · · · · · · · ·
c. Construction of a commercial structure >	
d. Removal of mature tree(s) ( ≥ 6" d.b.h. ir	n Emerald Lake Hills area or ≥ 12" d.b.h. in any
residential zoning district)?	, in the second
If yes, how many trees to be removed? e. Land clearing or grading?	
If yes, please state amount in cubic yard	ds (c.y.):
Excavation: ZZO c.y.	Fill: <u>ZO</u> c.y.
f. Subdivision of land into 5 or more parcel	
g. Construction within a State or County sce	enic corridor?  AUG 0 1 2016
h. Construction within a sensitive habitat?	
i. Construction within a hazard area (i.e. se	eismic fault, landslide, flood)?  San Mateo County
	(check with Co. Env. Health Division) lanning and Building Departmen
Please explain all "Yes" answers:	
BUILDING A NEW TWO STORY,	· · · · · · · · · · · · · · · · · · ·
THE SITE OF THE EXISTING H	OME. TO IMPROVE SITE
DRAINAGE, MINOR GRADING W	
SITE IS WITHIN A SEISMIC	FAULT ZONE

2. Na	tional N	larine Fisheries Rule 4(d) Review
Yes	No	Will the project involve:
V		a. Construction outside of the footprint of an existing, legal structure?
	[V]	b. Exterior construction within 100-feet of a stream?
		c. Construction, maintenance or use of a road, bridge, or trail on a stream bank or unstable hill slope?
		d. Land-use within a riparian area?
	V	e. Timber harvesting, mining, grazing or grading?
		f. Any work inside of a stream, riparian corridor, or shoreline?
		g. Release or capture of fish or commerce dealing with fish?
Please	explain	any "Yes" answers:
CON	ISTE	ICTION OF THE NEW HOME WILL EXTEND BEYOND
		OTPRINT OF THE EXISTING HOME.
n) in the same same		
3, Nat	ional P	ollutant Discharge Elimination System (NPDES) Review
Yes	No	Will the project involve;
	_,	a. A subdivision or Commercial / Industrial Development that will result in the addition or replacement of 10,000 sq. ft. or more of impervious surface?
		If yes, Property Owner may be required to implement appropriate source control and site design measures and to design and implement stormwater treatment measures, to reduce the discharge of stormwater pollutants. Please consult the Current Planning Section for necessary forms and both construction and post-construction requirements.
		b. Land disturbance of 1 acre or more of area?
		If yes, Property Owner must file a Notice of Intent (NOI) to be covered under the statewide General Construction Activities Storm Water Permit (General Permit) <u>prior</u> to the commencement of construction activity. Proof of coverage under State permit must be demonstrated prior to the issuance of a building permit.
	i i i i i i i i i i i i i i i i i i i	ion
The state of the s		that the statements furnished above and in the attached exhibits present the data and
nforma nforma	ition red ition pre	rular the statements furnished above and fir the attached exhibits present the data and pulified for this initial evaluation to the best of my ability, and the facts, statements and esented are true and correct to the best of my knowledge and belief. If any of the nated here change, it is my responsibility to inform the County.
acts re	shi esei	the state of the s
acts re	shi esei	
acts re Signed:	. A	Date: 7/20/16

PUNZU16-00317

#### MARK REILLY ARCHITECTURE

163 Park Street · San Francisco · California · 94110 415.309.0107

#### 146 La Grande Avenue – Property Information and Narrative

Owner:

Julia Paige and Dan Spangler

Address:

146 La Grande Avenue

Moss Beach, CA 94038

APN:

037-258-**0000 Z 60** 

Zoning:

Lot Size:

R-1/S-17/DR/GH/CD

10,548 sq ft

Maximum Area:

5,590 sq ft (53%)

Setbacks:

Front 20'\*, Rear 20', Street Side 10', Side 5' (min)

(\* Front is side with shorter street frontage - San Ramon Avenue)

**Existing Area:** 

1st Floor - Living: 1,168 sq ft 1st Floor - Garage: 312 sa ft\*\* 2<sup>nd</sup> Floor - Living: 1,289 sq ft Total - Living: 2,457 sq ft

Total - All:

2,769 sq ft

RECEIVED

AUG 0 1 2016

San Mateo County Planning and Building Department

(\*\* Existing garage space does not meet code. 342 sq ft min req'd)

**Proposed Area:** 

1st Floor – Living: 1,361 sq ft

1st Floor - Garage/Storage:

651 sq ft

1st Floor - Covered Porch:

138 sq ft

1st Floor – Covered Outdoor Lounge: 472 sq ft\*\*\*

2<sup>nd</sup> Floor – Living:

2,455 sq ft 316 sa ft\*\*\*

Roof Deck - Glass Enclosure Total – Living:

3,816 sq ft

Total - All:

5.393 sq ft

(\*\*\* Unconditioned space)

#### **Existing Site:**

Type: Corner lot

Site Grade: Relatively flat site with a slight southwest slope from San

Ramon Ave

Structures: A dilapidated two story, single family home -- with multiple decks, a concrete parking pad, and non-code compliant renovations/setbacks – and a play house/shed.

Natural Features: Mature Cyprus trees along the southwest property line, ocean views to the southwest and west, and hill views to the northeast

Adjacent Structures: The single family home to the southwest is setback further from the street than the existing structure, and is shielded from the property by Cyprus trees. The single family home to the southeast is located up-slope from the existing structure, and is over 65 feet away

146 La Grande Avenue – Conformation to Midcoast/Moss Beach Design Review Standards and Guidelines (Section 6565.20(A-D))

Neighborhood Definition and Character (Section 6565.20(B)):

- 1. Neighborhood Definition:
  - a. Neighborhood Context:
    - 1. Immediate Context: Single family homes. Relation of buildings to one another varies.
    - 2. Neighborhood Context: Visual character of the neighborhood varies greatly. Most homes are 2-3 stories tall, and sit flat on their site.
  - b. Neighborhood Limits:
    - 1. Topography: Ranges from flat to sloping
    - 2. Land Use: Primarily single family residential

- 3. Proximity to Open Space: Neighborhood is adjacent to coastal open space
- 4. Subdivision Pattern: A grid of streets, interrupted by topographical changes
- 5. Street Width and Natural Features: Streets are a standard width, edge of neighborhood is coastal open space
- 6. Noticeable Changes in Building Types: There are many changes in building styles, materials, and heights, with most homes 2-3 stories
- 7. Visibility from Off-Site Vantage Points: The site is not visible from nearby vantage points.

#### 2. Neighborhood Character:

- a. Siting: Homes are primarily sited near the street, with 10'-20' setbacks.
- b. Blending with Surrounding Scenic and Natural Environments: Homes primarily sit flat on their lot, some are nestled next to pre-existing trees.
- c. Architectural Style: Varies greatly with much contrast -- from simple, older homes, to boxy, to a mishmash, to contemporary.
- d. Scale: Homes are primarily two to three stories tall.
- e. Arrangement/Placement/Massing: Most homes are placed near the street with 10'-20' setbacks and predominantly boxy massings.
- f. Parking and Garage Patterns: Many predominant garage doors located at the front of the house, next to the entry.
- g. Location of Entries: Many entries are adjacent to garage doors, hidden, or under a deck or entry porch.
- h. Roof Forms: Predominately gable or shed roof forms.
- i. Exterior Materials and Colors: Materials vary greatly -- from wood boards, to wood shingles, to painted horizontal siding, to T-11, to

board and batten, to stucco. Colors vary greatly from natural wood, to yellow, to green, to blue, to brown.

- j. Window Type and Placement: Type varies greatly from large plate glass rectangles, to sloped top, to aluminum sliders, to fake mullions, to double hung. Placement varies greatly too.
- k. Landscaping: More natural, less manicured landscaping. Numerous large Cyprus trees.
- I. Older Buildings or Features Having Historic Character: Nearby older/historic buildings have simple forms, shingled siding, double hung windows with muntons, tall gabled roofs, prominent entry, and less prominent garages.

#### **Site Planning and Structure Placement** (Section 6565.20(C):

- 1. Integrate Structures with the Natural Setting:
  - a. Trees and Vegetation: The proposed home will retain and preserve the existing Cyprus trees on the property
  - b. Grading:
    - 1. Minimize Fill: The proposed home will be located on the building pad of the existing home, but within the required setbacks. The new home will be placed at the building pad elevation height of the existing home to minimize fill.
    - 2. Limited Excavation: Minimal excavation (< 250 cu yds) at the front (San Ramon Ave) and side of the property will reduce the visual impact of the home on San Ramon Avenue, allow the driveway to conform to County design standards, blend the home into the site, and improve site drainage per the recommendations of the geotechnical engineer.
    - 3. Limit Grading: Grading is limited (< 250 cu yd) and will extend slightly beyond the footprint of the structure to improve site drainage per the recommendations of the geotechnical engineer.
    - 4. Finished Grade Similar to Existing Grade: The finished grade beyond the structure will be similar to that of the existing grade, except where modified by the geotechnical engineer for improved drainage.

- 5. Retaining Walls: The board formed concrete retaining/ foundation wall at the side/rear of the proposed home will be incorporated into the building structure and kept to a minimum height. It will not be visible from the street.
- c. Streams and Other Drainage Features:
  - 1-4. NA: There are no streams or natural drainage features on the property. The site will not be altered to cause significant drainage problems, erosion, or flooding.
- d. Ridgelines, Skylines, and View Corridors:
  - 1-2. NA The development is not proposed on a ridgeline, skyline or view corridor. In addition, the proposed grading/excavation will help minimize the impact the new home has on San Ramon Avenue.
- e. Relationship to Open Spaces: NA The property is not visible from a designated open space.
- 2. Compliment Other Structures in the Neighborhood:
  - a. Privacy:
    - 1. Minimize Direct Views into Neighboring Houses and Decks: The retained Cyprus trees will reduce the privacy impact between the new home and the adjacent property. The proposed home will be set back further from the adjacent property than the existing home to improve privacy. The new side balcony will be substantially smaller than the existing deck that faces the adjacent property.
    - Locate High Activity Areas Away from Low Activity Areas of Adjacent Properties: The highest activity spaces – the Great Room and Outdoor Lounge – are located away from the adjacent property.
    - 3. Rooftop Decks:
      - a. The proposed rooftop deck is designed to avoid direct views into neighboring homes. The gabled roofs on either side of the roof deck and the half gable roof at the rear of the roof deck will block views into adjacent properties. The street width, building setback, neighbor's street plantings, and

- height of the roof deck will prevent views into homes across the street.
- b. The proposed roof deck will be accessed by an interior stair.
- c. The proposed rooftop deck is integrated into the roof design. It is nestled between the two front gables of the house and the rear half gable.
- 4. Landscaping and Architectural Solutions: The retained Cyprus trees will reduce the privacy impact between the new home and the adjacent property.
- b. Views: The effect on views from neighboring houses was minimized by maintaining the existing side/La Grande Avenue set back, keeping the existing building pad height, and excavating at the San Ramon Avenue side of the property to nestle the home into the site.

#### **Elements of Design** (Section 6565.20(D):

- 1. Building Mass, Shape, and Scale:
  - a. Relationship to Existing Topography: The proposed new home relates to the primarily flat site by maintaining the building pad elevation of the existing home. Slight grading work and a minimal retaining/foundation wall at the rear of the property improve site drainage, nestle the home into the rear of the site, and reduce the visual impact of the home along San Ramon Avenue.
  - b. Neighborhood Scale: The neighborhood scale varies greatly. The proposed home respects and follows the scale of the older and more historic homes in the neighborhood (particularly 1040 Park Way) with its shape, form, façade articulation, and details. This includes having a full two story height, classic full gable roof, simple building articulation, punched window/door openings, front porch, and side/rear balconies.

#### c. Second Stories:

 Second Story Location: Homes in the neighborhood are two and three stories tall. Almost all second stories are located above the entire first story. This is also true for the older and historic homes in the neighborhood. The proposed home respects this existing neighborhood context by locating the second story above the full first story. 2. Lowering the Eave Line: None of the two story homes in the neighborhood have lowered eave lines. This is also true for the older and historic homes in the neighborhood. The proposed home respects this existing neighborhood context by not lowering the eave line.

#### d. Daylight Plane/Façade Articulation:

1. Daylight Plane: NA

- 2. Façade Articulation: The facades of the proposed home are broken up with stepped building massings, multiple gabled roof forms, projected eaves, a front porch, a side roof overhang, recessed door and window openings, balconies, railings, stairs, a covered outdoor lounge, an enclosed roof deck, and exposed chimney boxes/flues. The façade articulation follows that of the historic and older homes in the neighborhood.
- e. Wall Articulation: Building walls are articulated with stepped walls, a recessed front porch, a side roof overhang, recessed door and window openings, projected eaves, balconies, railings, stairs, a covered outdoor lounge, an enclosed roof deck, exposed chimneys, and contrasting natural wood shingles and painted wood trim.

#### 2. Architectural Styles and Features:

- a. Architectural Style: There isn't a predominant architectural style in the neighborhood. The proposed home follows the style of the historic and older homes in the neighborhood (particularly 1040 Park Way), but with more façade articulation to meet the Design Standards. The elements that define the historic/older homes and the proposed home include a simple building shape, full gabled roof forms, roof eaves, double hung windows with divided lights, recessed door and window openings, carriage type garage doors, natural wood shingles, and painted trim.
- b. Openings: The proposed double-hung, aluminum clad, wood windows and doors with divided lights compliment the double hung windows and doors of the historic/older homes in the neighborhood. The repeating style, size, and proportion of the windows and doors create a simple architectural rhythm along the façade.

- c. Entries: The proposed front door entry is scaled to relate to the windows and doors of the home and is residential in appearance. The proposed front porch helps to further emphasize the entry.
- d. Garages: Despite a neighborhood pattern of prominent garage doors, the proposed garage doors have been located on the side of the home (away from the entry) to lessen their prominence and better follow the Design Standards. Carriage style garage doors relate to the style of the home and to older/historic homes in the neighborhood.

#### 3. Roof Design:

- a. Massing and Design of Roof Forms: The proposed gabled roof form reflects those of older and historic homes in the neighborhood. Multiple intersecting gables, porch and side awning roofs, articulated chimney stacks, a roof deck enclosure, and railings all work to break down the apparent mass of the home and provide visual interest. The proposed standing seamed metal roof material is durable, energy efficient (with "cool roof" technology), nonreflective, and references the agricultural history of the area. Solar panels are located at the back of the house, out of view from neighbors, and will follow the roof slope. The proposed roof color is a neutral, matte gray.
- b. Design Compatibility: The proposed gabled roof form compliments the prominent full height gabled roof forms of the neighborhood, and of older/historic homes in the area.
- 4. Exterior Materials and Colors: The proposed exterior materials include natural cedar shingle siding, black painted wood trim, black aluminum clad wood windows and doors, black painted railings and posts, and matte grey standing seam metal roofing. (Please see the 8 ½ x 11 Primary Building Elevation Material Board)
  - a. Compatibility: The material palette relates to that of the historic older/historic homes in the neighborhood. The natural shingles blend with the natural setting of the adjacent Cyprus trees and compliment the natural wood siding of the adjacent home. The black trim, windows, doors, railings, and posts help to reduce the apparent mass of the home. The metal roof is a neutral warm grey, non-reflective, and recalls the area's agrarian past.

- b. Quality: All materials are of a high quality and consistent with the style of the house.
- Quantity: The number of materials and colors is consistent with those in the neighborhood and the style of the home. The texture of the cedar shingle siding, and the contrast between the natural siding, black trim, and grey porch/awning roofs will help reduce the appearance of bulk.
- d. Ornamentation: The use and application of simple window, door, and eave trim is consistent with the style and size of the house.

#### Additional Site Planning and Design Considerations (Section 6565.20(E):

- 1. Multiple Contiguous or Nearby Projects: Not applicable.
- 2. Minimize Blocking of Sunlight: The proposed home was located on the exiting home's building pad and placed further away from the neighboring home to minimize further impact on the adjacent home. Existing Cyprus trees between the properties were maintained to screen the properties.

# Landscaping, Paved Areas, Fences, Lighting, and Noise (Section 6565.20(F):

- 1. Landscaping: No new landscaping is proposed, except for the planting of native grasses where the soil is disturbed during construction.
- 2. Paved Areas: The only paved area will be the County required asphalt transition zone between the street and the proposed permeable driveway.
- 3. Fencing: The proposed horizontal, natural cedar or redwood board fence complements the design of the cedar shingled home, and follows the height limits specified in the Zoning Regulations.
- 4. Lighting: The proposed lighting fixtures and their placement complements the home's design and casts low-level light downward to meet "night sky" requirements.
- 5. Noise: Higher activity areas of the home (the kitchen, great room, and lounge) are located away from the adjacent home to minimize their

impact. In addition, new fencing and the existing Cyprus trees with buffer sound between properties.


#### **Utilities and Ancillary Structures** (Section 6565.20(G):

All utilities will be screened from view in a manner compatible with the building and site design. There are no ancillary structures, although an existing playhouse will be relocated on the property.

#### Second Units (Section 6565.20(H):

There are no second units proposed for the site.


ph2016-00317

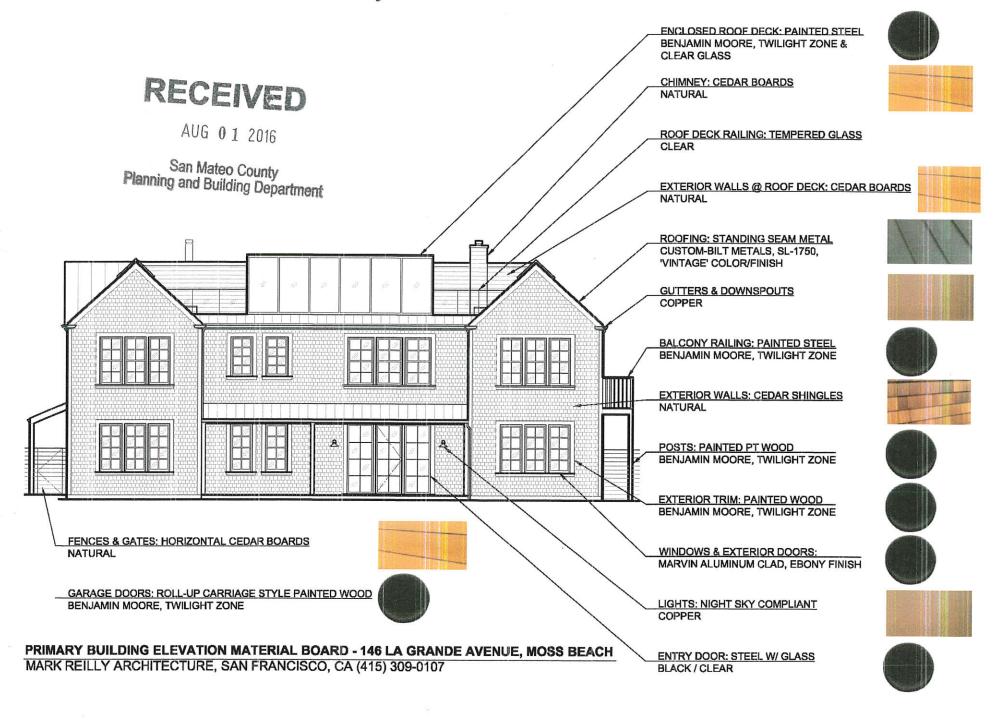


## louis poulsen

#### NYHAVN

#### WALL

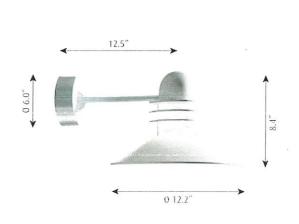

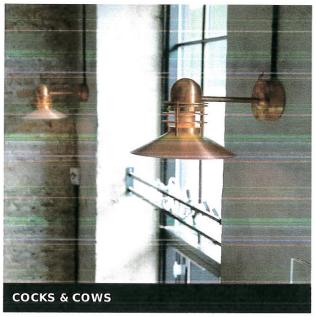

#### Design:

Alfred Homann & Ole V. Kjær

#### Concept:

The conical shade ensures comfortable light that is directed downwards in a wide beam. The shade interior has a white matte painted surface, ensuring uniform light distribution. The rings ensure that a stray light is controlled, and direct a small amount of light onto the top side of the shade for self-illumination.

#### Finish:

Copper, brushed or white, wet painted.

#### Material:

Shades: Spun aluminum or spun copper. Diffuser: Clear glass. Top: Spun aluminum or spun copper. Mounting box: Die cast aluminum. Mounting box

#### Weight:

Min: 7 lbs. Max: 11 lbs.

#### Compliance:

cULus, Wet location.

#### **SPAREPART**

PRODUCT NAME:

NYHAVN WALL, GLASS CLEAR

NYHAVN WALL, GLASS PARTLY FROSTED

ORDERING NUMBER:

5743590513

5743590526



#### Angled Plane Downlight Outdoor LED Wall Sconce



Item Code: SON-ANGLED-PLANE-DNLT-OTDR-LED-WALL-SCE

Description:

Design by Robert Sonneman, 2016. Made By SONNEMAN - A Way of Light.

The Angled Plane Downlight Outdoor LED Wall Sconce is a clean and minimal modern fixture, casting direct accent light. Perfect for modern outdoors, the Angled Plane is also ideal for hallways and anywhere compact accent illumination is needed.

Offered in three textured finishes: gray, bronze and white, the Angled Plane Narrow is a minimal and stylish addition to modern indoor and outdoor spaces. Dimmable with an electronic low voltage or standard TRIAC dimmer (sold separately). LED driver located in outlet box. ADA compliant. Shown in bronze.

#### **Dimensions**

Overall: 7"W X 7.75"H X 2.25" extension

Backplate: 5.5"W X 5.25"H

Material(s)

Metal

Lamp Type

LED

Bulbs

1 X 13W 120V LED array, 90 CRI, 3000K, 840

lumens (included)

Listing

ADA, WET-LOCATION

Instructions

Click to download instructions.

Item Number

SON-ANGLED-PLANE-DNLT-OTDR-LED-WALL-SCE

Model(s)

2363.72-WL 2363.74-WL 2363.98-WL

Price:

\$350.00

+ Free Shipping

Options:

Model:

2363 - Angled Plane Downlight Outdoor LED Wall Sconce

Finish:

.72-WL - Bronze


.74-WL - Gray

.98-WL - White

Design by Robert Sonneman, 2016. Made By SONNEMAN - A Way of Light.

The Angled Plane Downlight Outdoor LED Wall Sconce is a clean and minimal modern fixture, casting direct accent light. Perfect for modern outdoors, the Angled Plane is also ideal for hallways and anywhere compact accent illumination is needed.

Offered in three textured finishes: gray, bronze and white, the Angled Plane Narrow is a minimal and stylish addition to modern indoor and outdoor spaces. Dimmable with an electronic low voltage or standard TRIAC dimmer (sold separately). LED driver located in outlet box. ADA compliant. Shown in bronze.

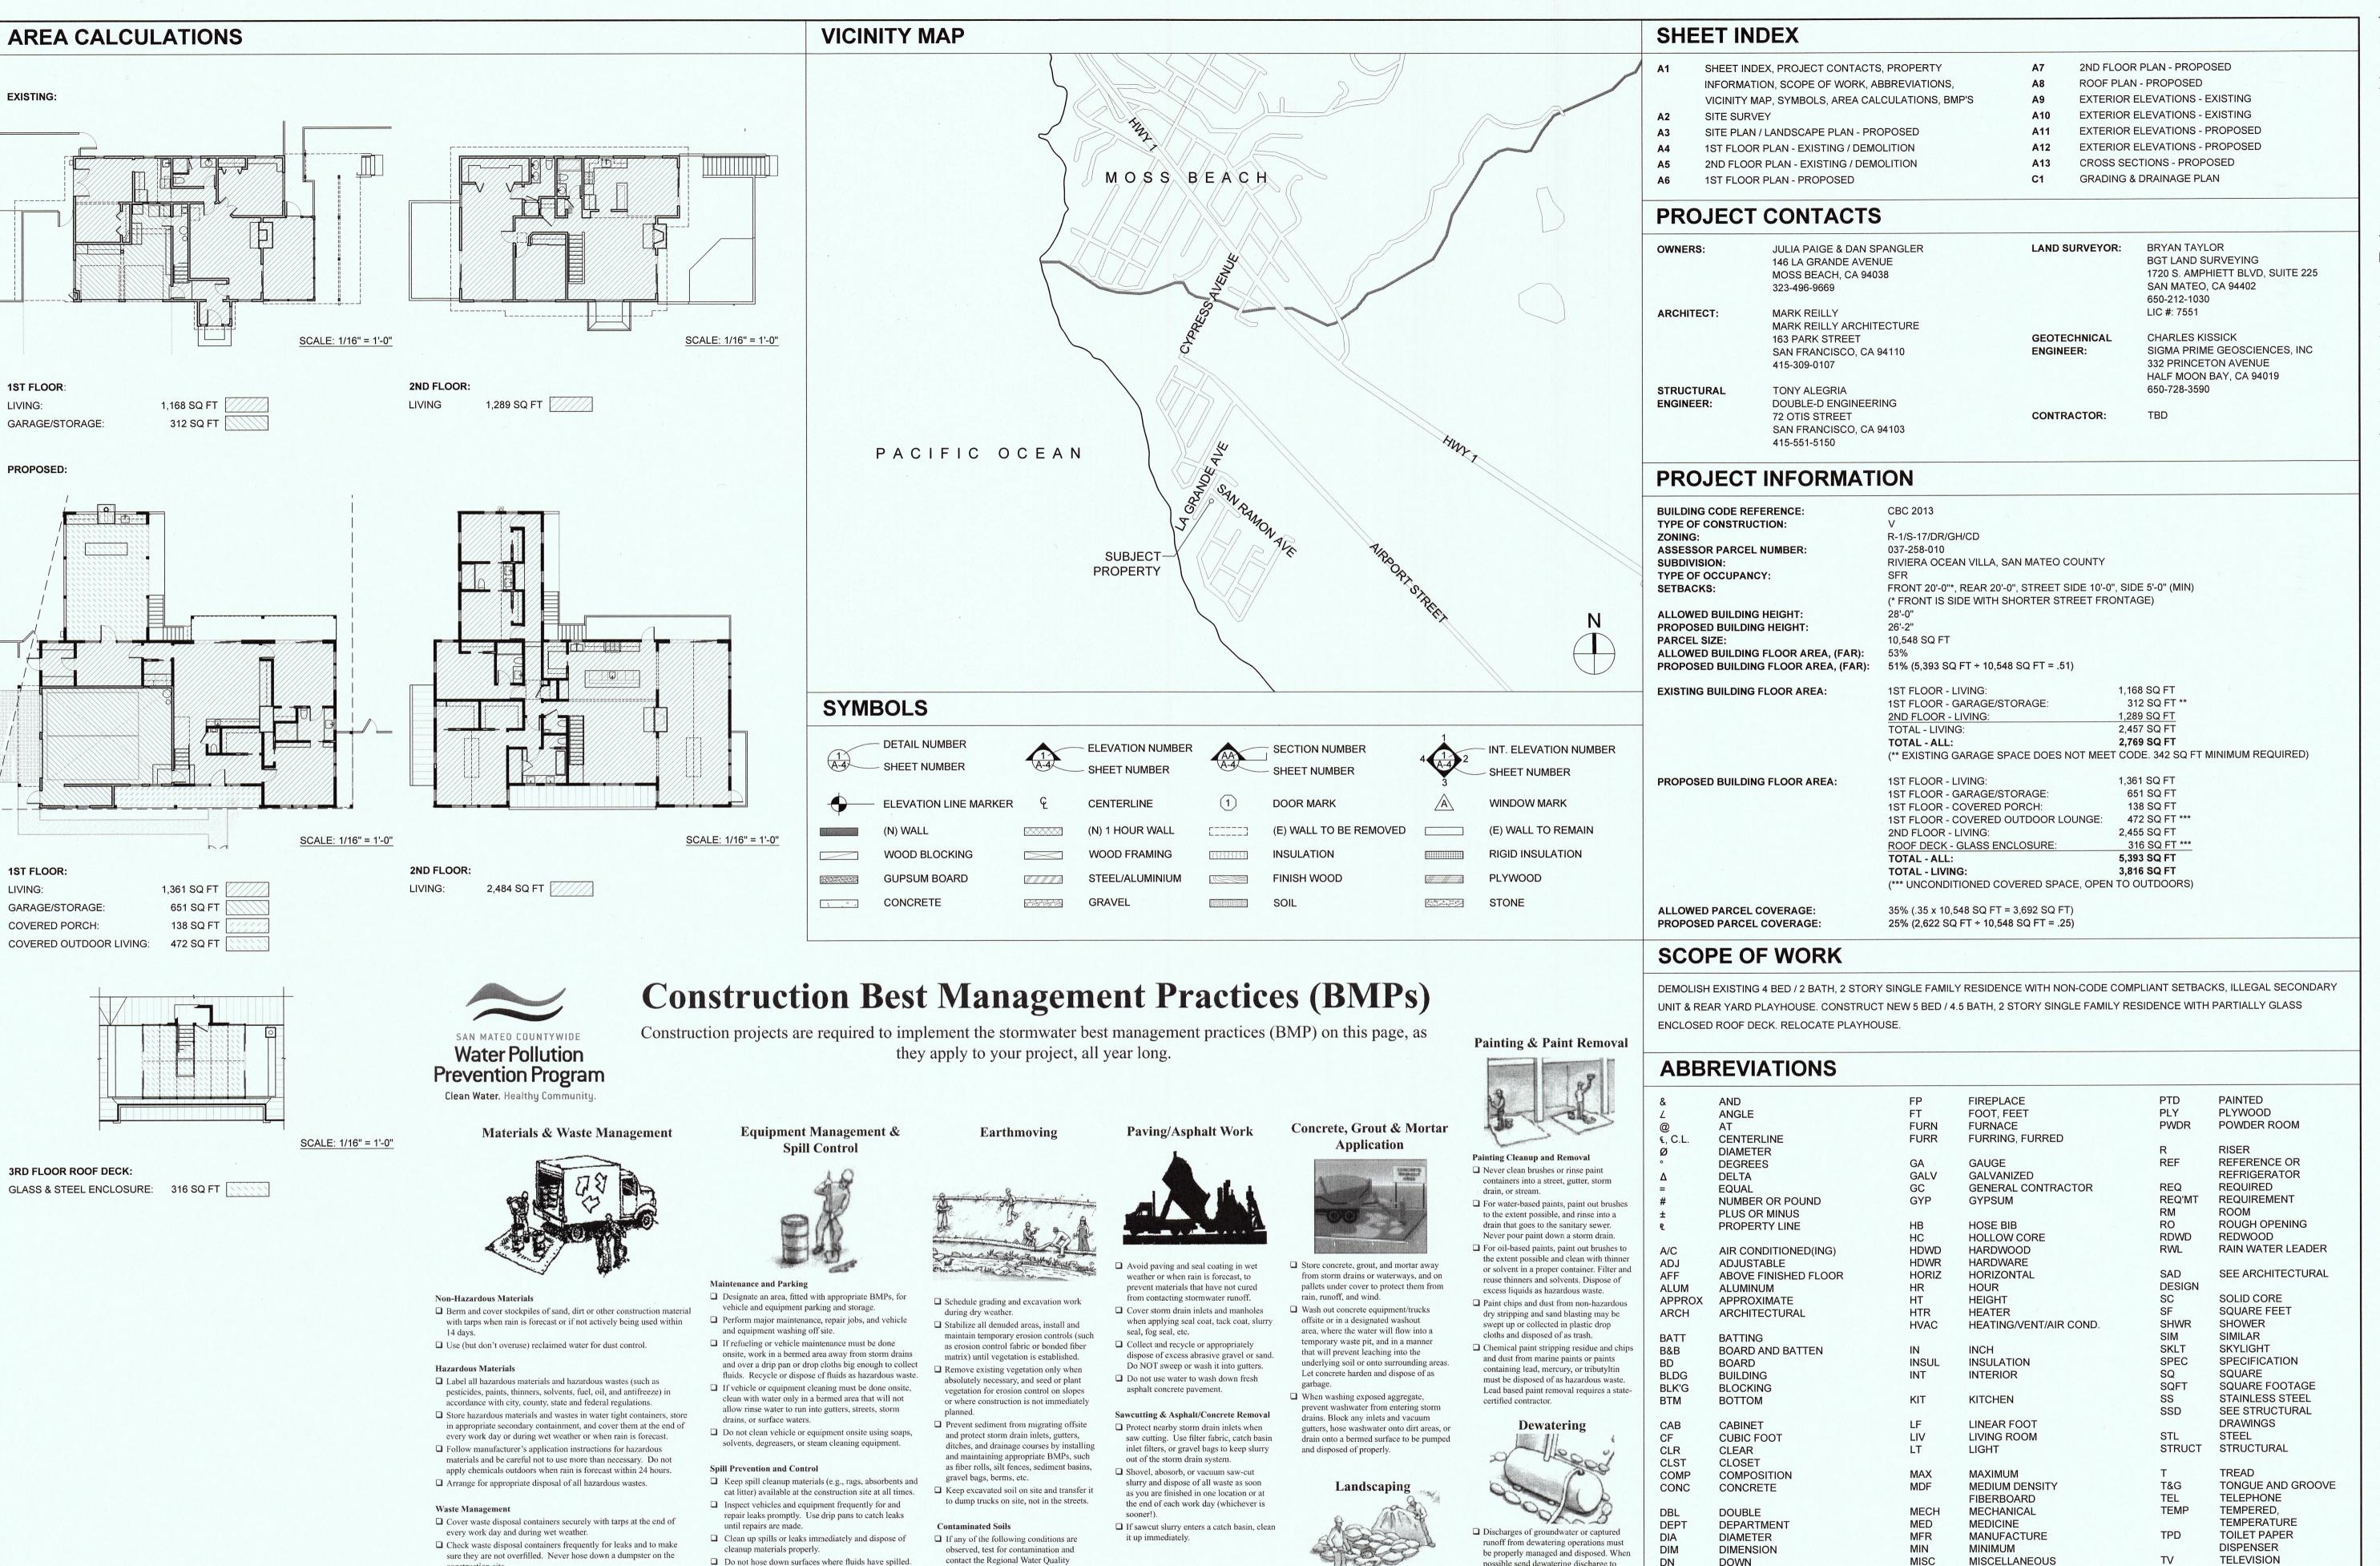

DN

DW

DWG

**DWR** 

**ELEC** 

**ELEV** 

EQ

EXT

FIN

FIR

FLR

**FLUOR** 

**EQPT** 

possible send dewatering discharge to

discharging to the sanitary sewer call your

landscaped area or sanitary sewer. If

local wastewater treatment plant.

☐ Divert run-on water from offsite away

☐ When dewatering, notify and obtain

☐ In areas of known or suspected

approval from the local municipality

before discharging water to a street gutter

or storm drain. Filtration or diversion

through a basin, tank, or sediment trap

contamination, call your local agency to

determine whether the ground water must

be tested. Pumped groundwater may need

to be collected and hauled off-site for

treatment and proper disposal.

from all disturbed areas.

may be required.

Protect stockpiled landscaping materials

☐ Stack bagged material on pallets and

☐ Discontinue application of any erodible

landscape material within 2 days before a

forecast rain event or during wet weather.

tarps all year-round.

under cover.

from wind and rain by storing them under

DOWN

DISHWASHER

DRAWING

DRAWER

**EXISTING** 

ELECTRICAL

**ELEVATION** 

**EQUIPMENT** 

FINISH FLOOR

**FLUORESCENT** 

DOUGLAS FIR WOOD

**EXTERIOR** 

EACH

**EQUAL** 

FINISH

FLOOR

MTL

NIC

NOM

NTS

OD

**PCS** 

PERF

PANT

PR

**PSF** 

PSI

INCH

METAL

NOMINAL

PIECE(S)

PANTRY

PAIR

NOT IN CONTRACT

**OUTSIDE DIAMETER** 

POUNDS PER SQUARE FT

POUNDS PER SQUARE

NOT TO SCALE

PERFORATED

Do not hose down surfaces where fluids have spilled.

☐ Sweep up spilled dry materials immediately. Do not

☐ Clean up spills on dirt areas by digging up and

properly disposing of contaminated soil.

Center, (800) 852-7550 (24 hours).

try to wash them away with water, or bury them.

Report significant spills immediately. You are required

by law to report all significant releases of hazardous

materials, including oil. To report a spill: 1) Dial 911

Governor's Office of Emergency Services Warning

or your local emergency response number, 2) Call the

Use dry cleanup methods (absorbent materials, cat

Control Board:

Abandoned wells

or odor.

Unusual soil conditions, discoloration,

Storm drain polluters may be liable for fines of up to \$10,000 per day!

Abandoned underground tanks.

Buried barrels, debris, or trash.

construction site.

leaks and spills.

to clean up tracking.

Clean or replace portable toilets, and inspect them frequently for

☐ Dispose of all wastes and debris properly. Recycle materials and

materials, wood, gyp board, pipe, etc.)

cleaning fluids as hazardous waste.

**Construction Entrances and Perimeter** 

wastes that can be recycled (such as asphalt, concrete, aggregate base

Dispose of liquid residues from paints, thinners, solvents, glues, and

☐ Establish and maintain effective perimeter controls and stabilize all

construction entrances and exits to sufficiently control erosion and

sediment source to prevent further tracking. Never hose down streets

sediment discharges from site and tracking off site.

☐ Sweep or vacuum any street tracking immediately and secure

Mark Reilly Architecture

> 163 Park Street San Francisco, CA 94110 415-309-0107

markreillyarchitecture.com

REVISION HISTORY (THIS SHEET)

San Mateo County Planning and Building Department

RESIDENCE PLICATION



SHEET TITLE

SHEET INDEX, PROJECT **CONTACTS, PROJECT** INFO, SCOPE OF WORK, **ABBREVIATIONS** VICINITY MAP, SYMBOLS, AREA CALCS, BMP'S

**DATE /** JULY 21, 2016 SCALE / AS NOTED

TYP

**UBC** 

UON

**VENT** 

**VERT** 

VIF

W/

WD

WH

W/O

WP

WT

NOTED

**TYPICAL** 

UNIFORM BUILDING CODE

UNLESS OTHERWISE

VENTILATION

**VERIFY IN FIELD** 

WATER HEATER

WATERPROOF(ING)


**VERTICAL** 


WITH

WOOD

WITHOUT

WEIGHT

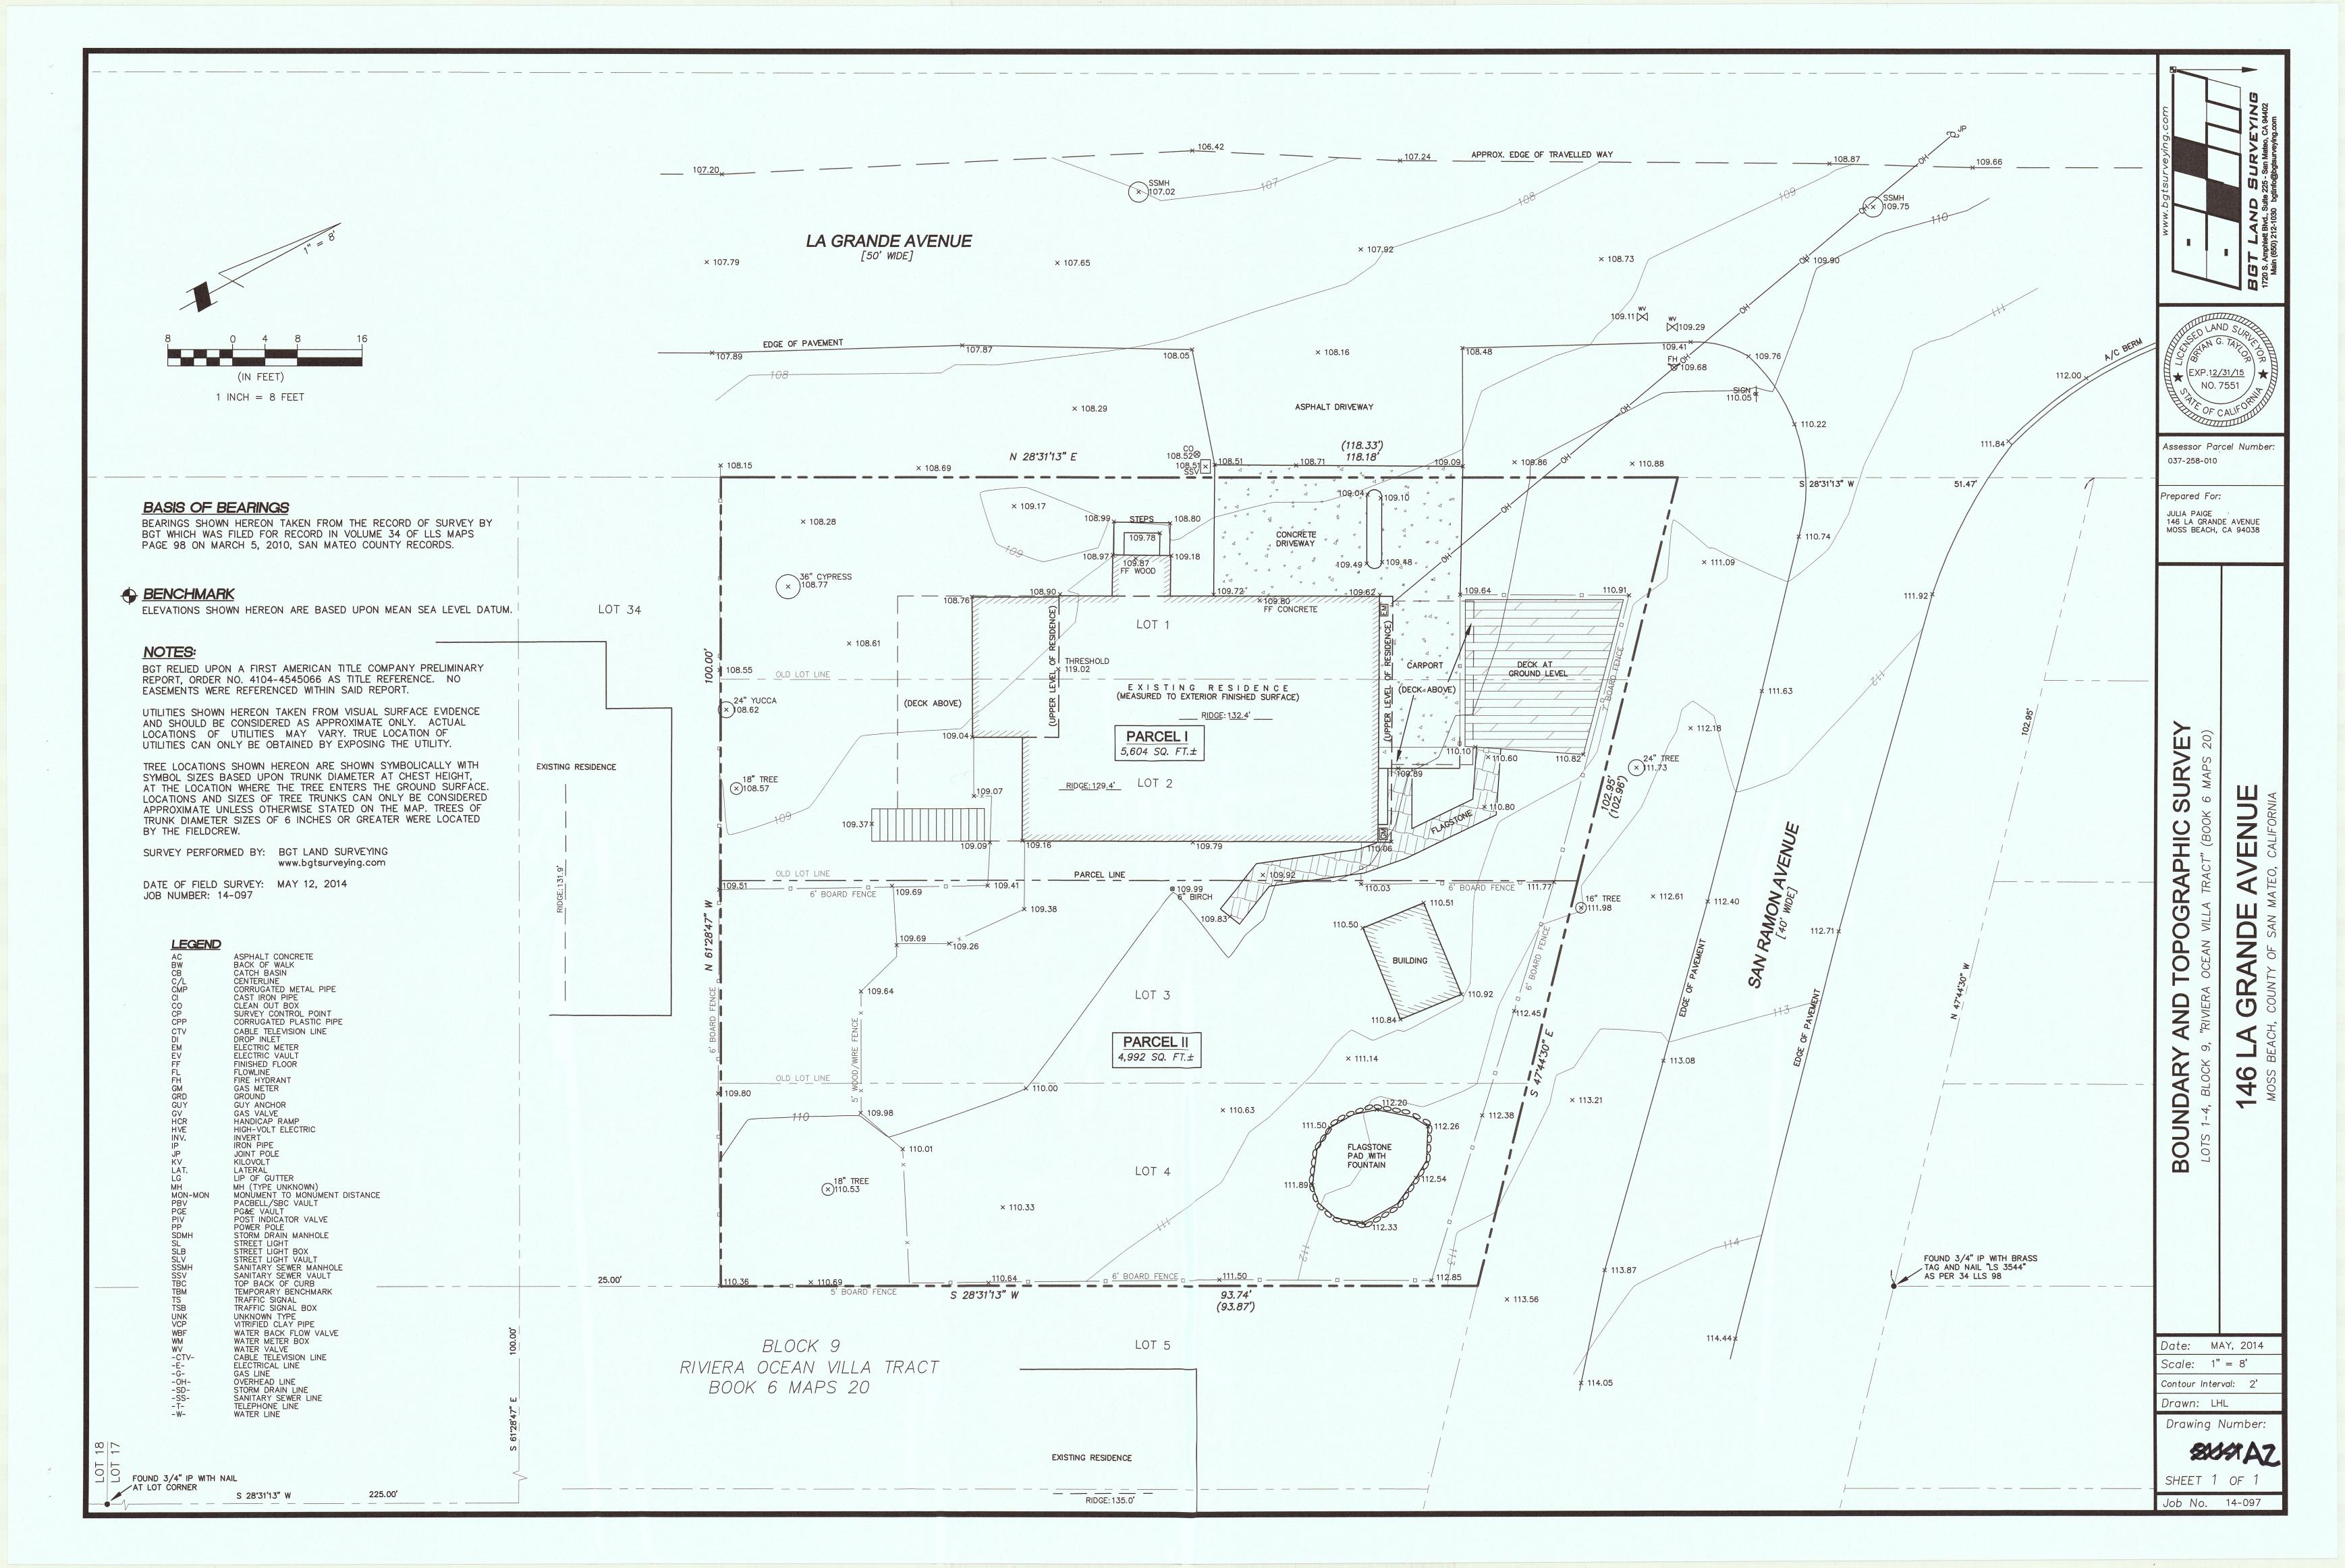

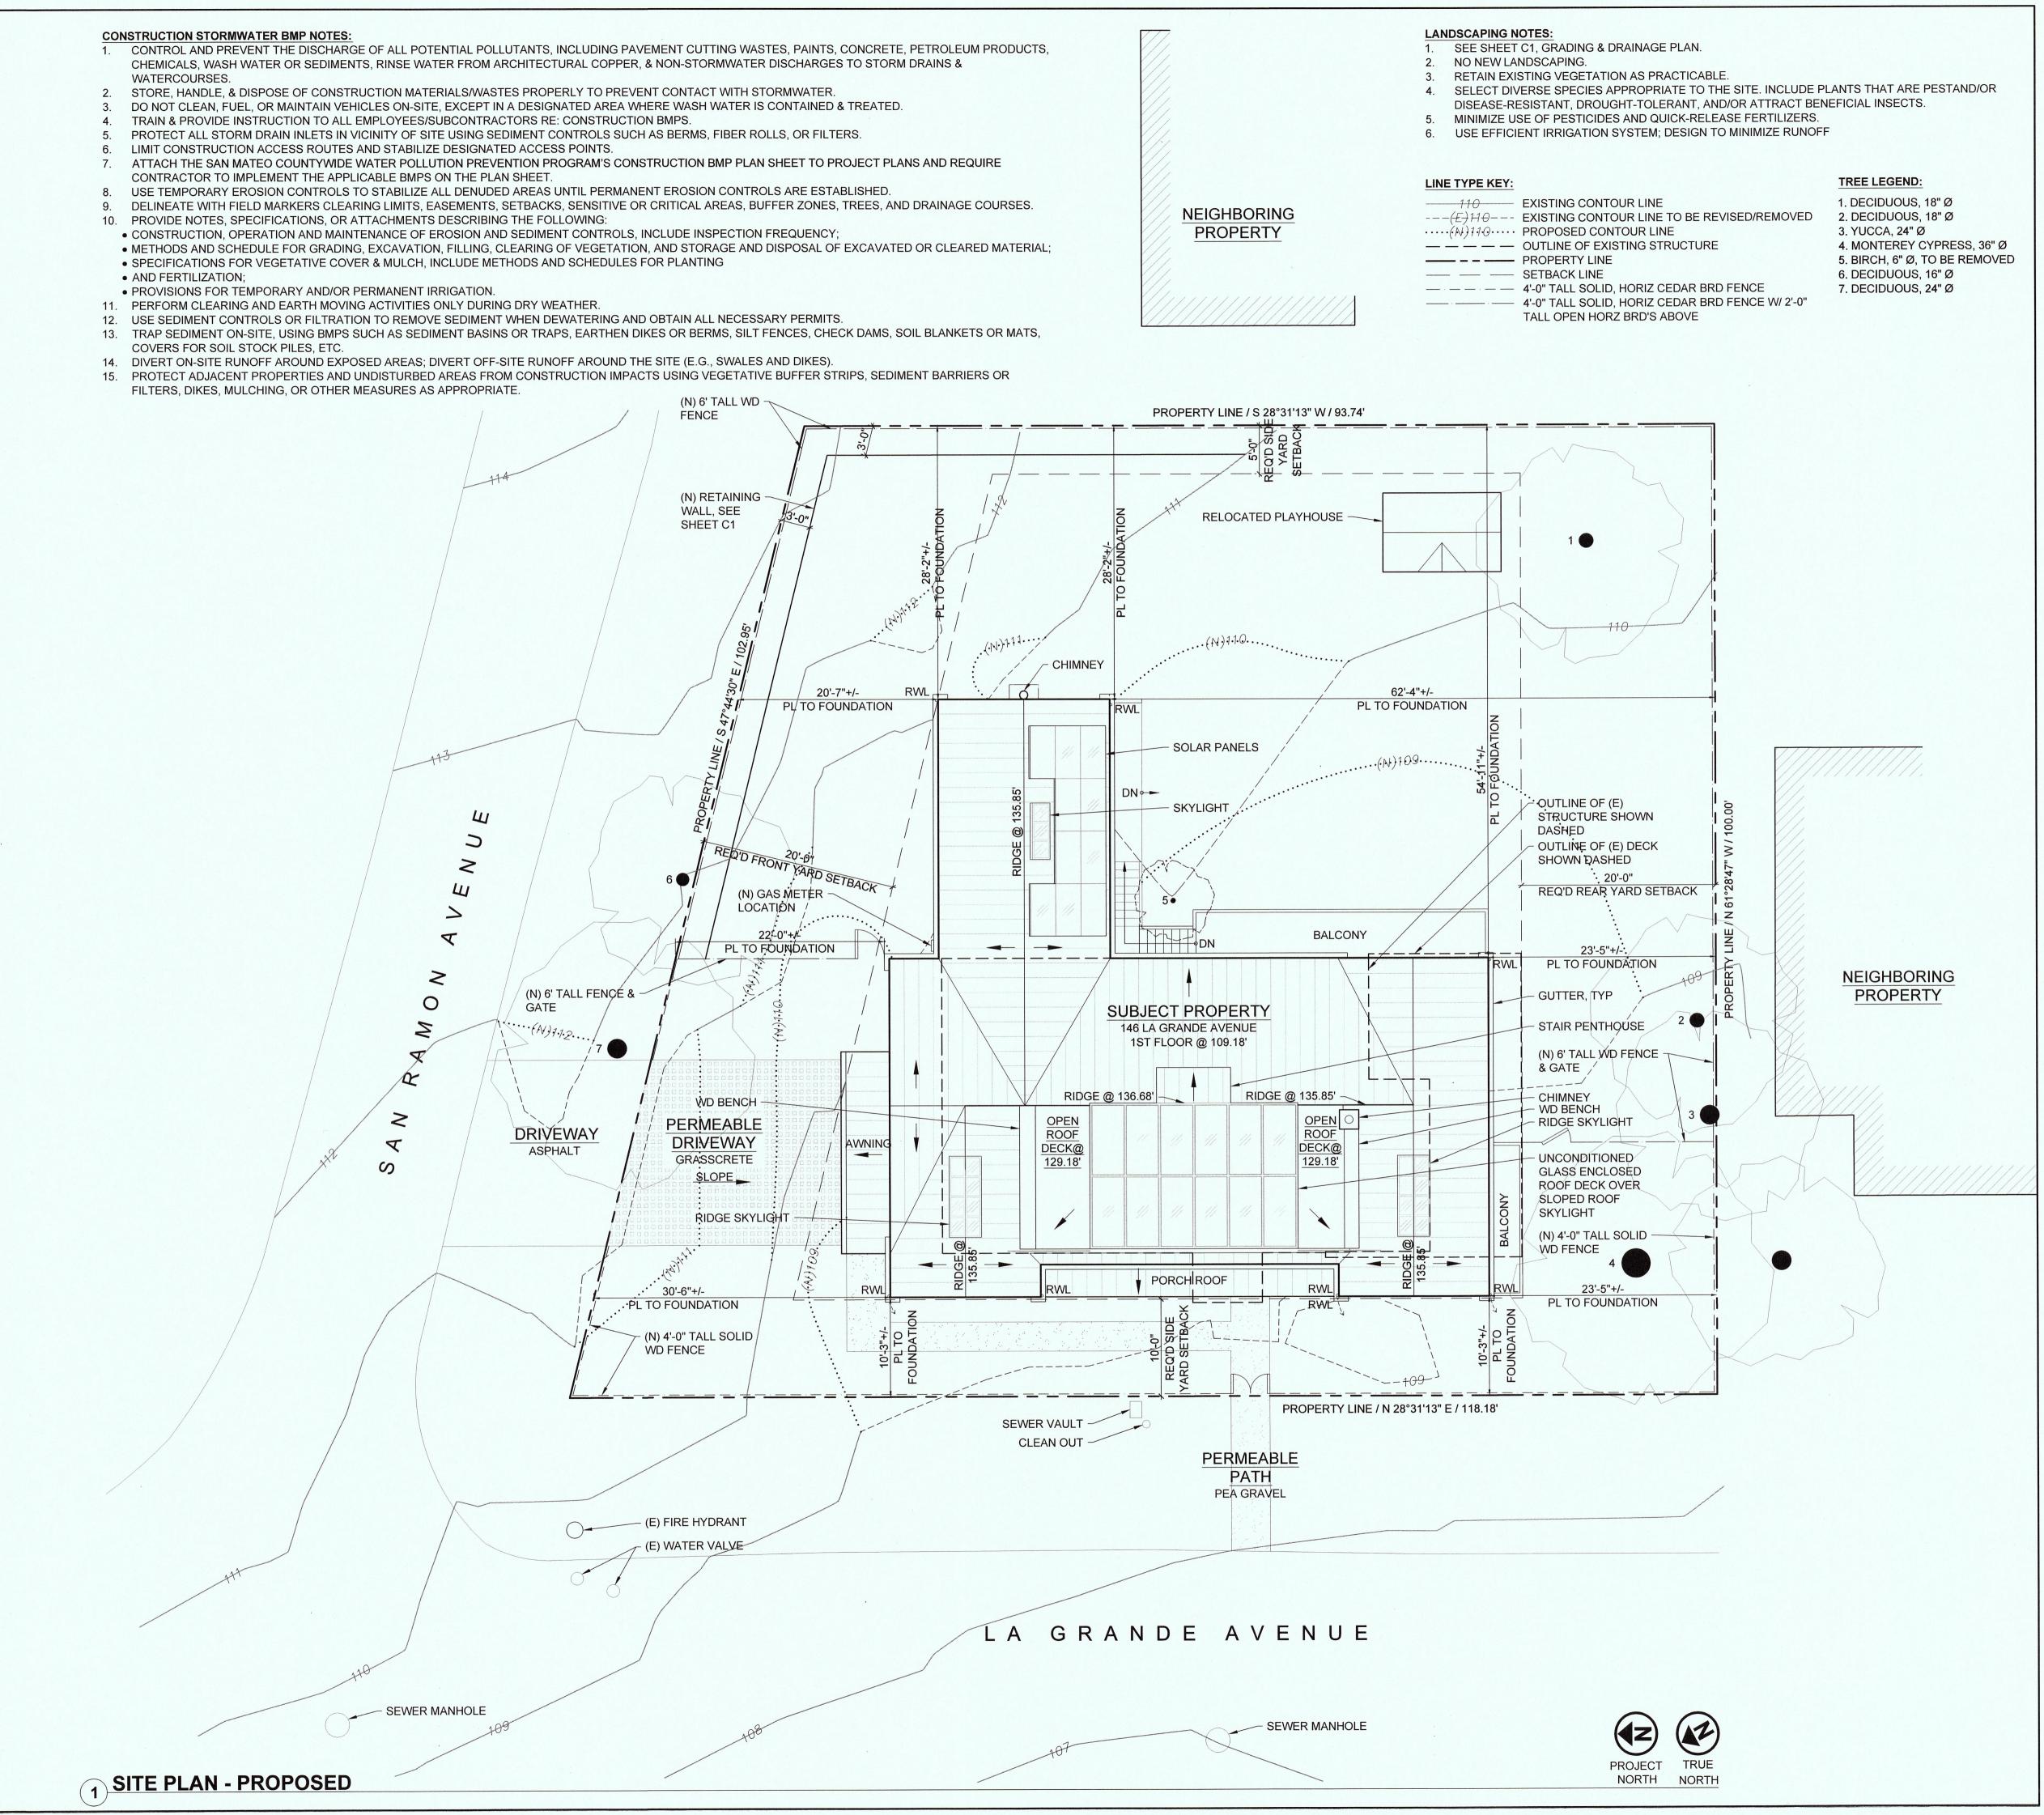

# Mark Reilly

Architecture

163 Park Street San Francisco, CA 94110

415-309-0107

markreillyarchitecture.com

REVISION HISTORY (THIS SHEET)

MAY 02 2017

San Mateo County


Planning and Building Department RESIDENCE

**M** <u>U</u> NGLEI TEW A SP RE

PAIGE + DESIGN REN. 04/30/2019

SHEET TITLE SITE PLAN

**DATE / JULY 21, 2016 SCALE /** 1/8" = 1'-0"

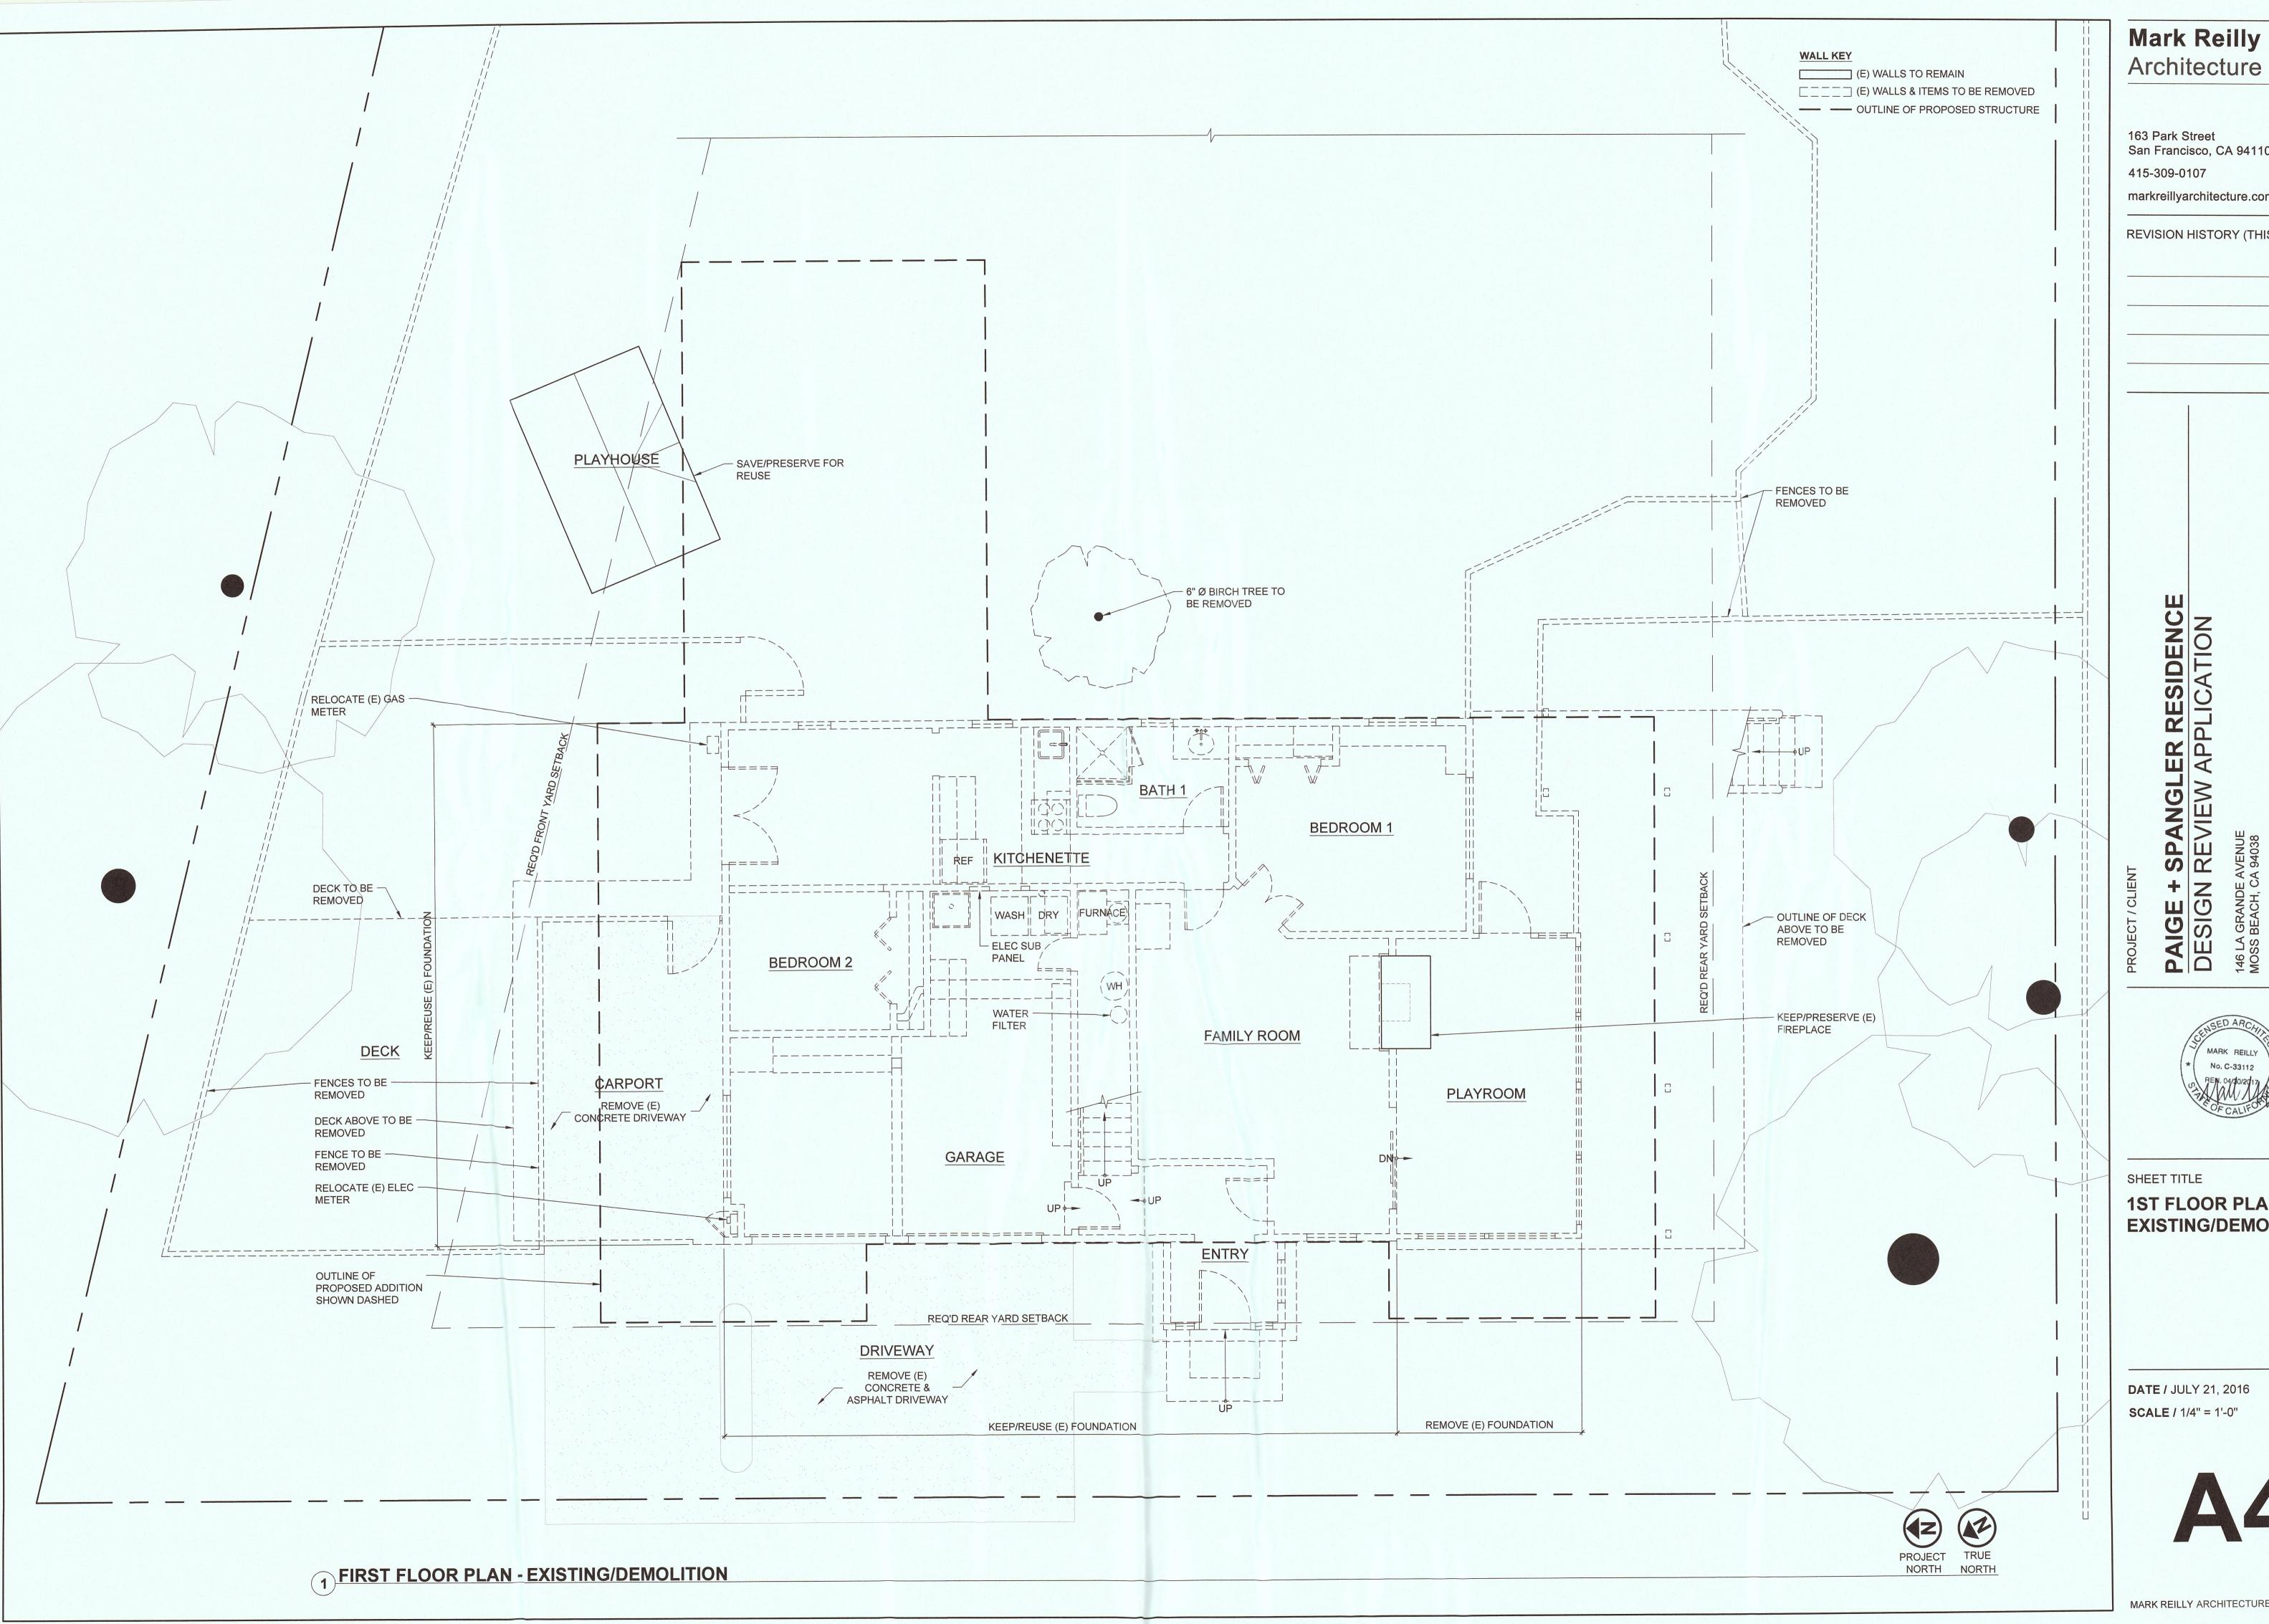

Mark Reilly

163 Park Street San Francisco, CA 94110


markreillyarchitecture.com

REVISION HISTORY (THIS SHEET)



**1ST FLOOR PLAN -EXISTING/DEMOLITION** 

**DATE /** JULY 21, 2016 **SCALE /** 1/4" = 1'-0"

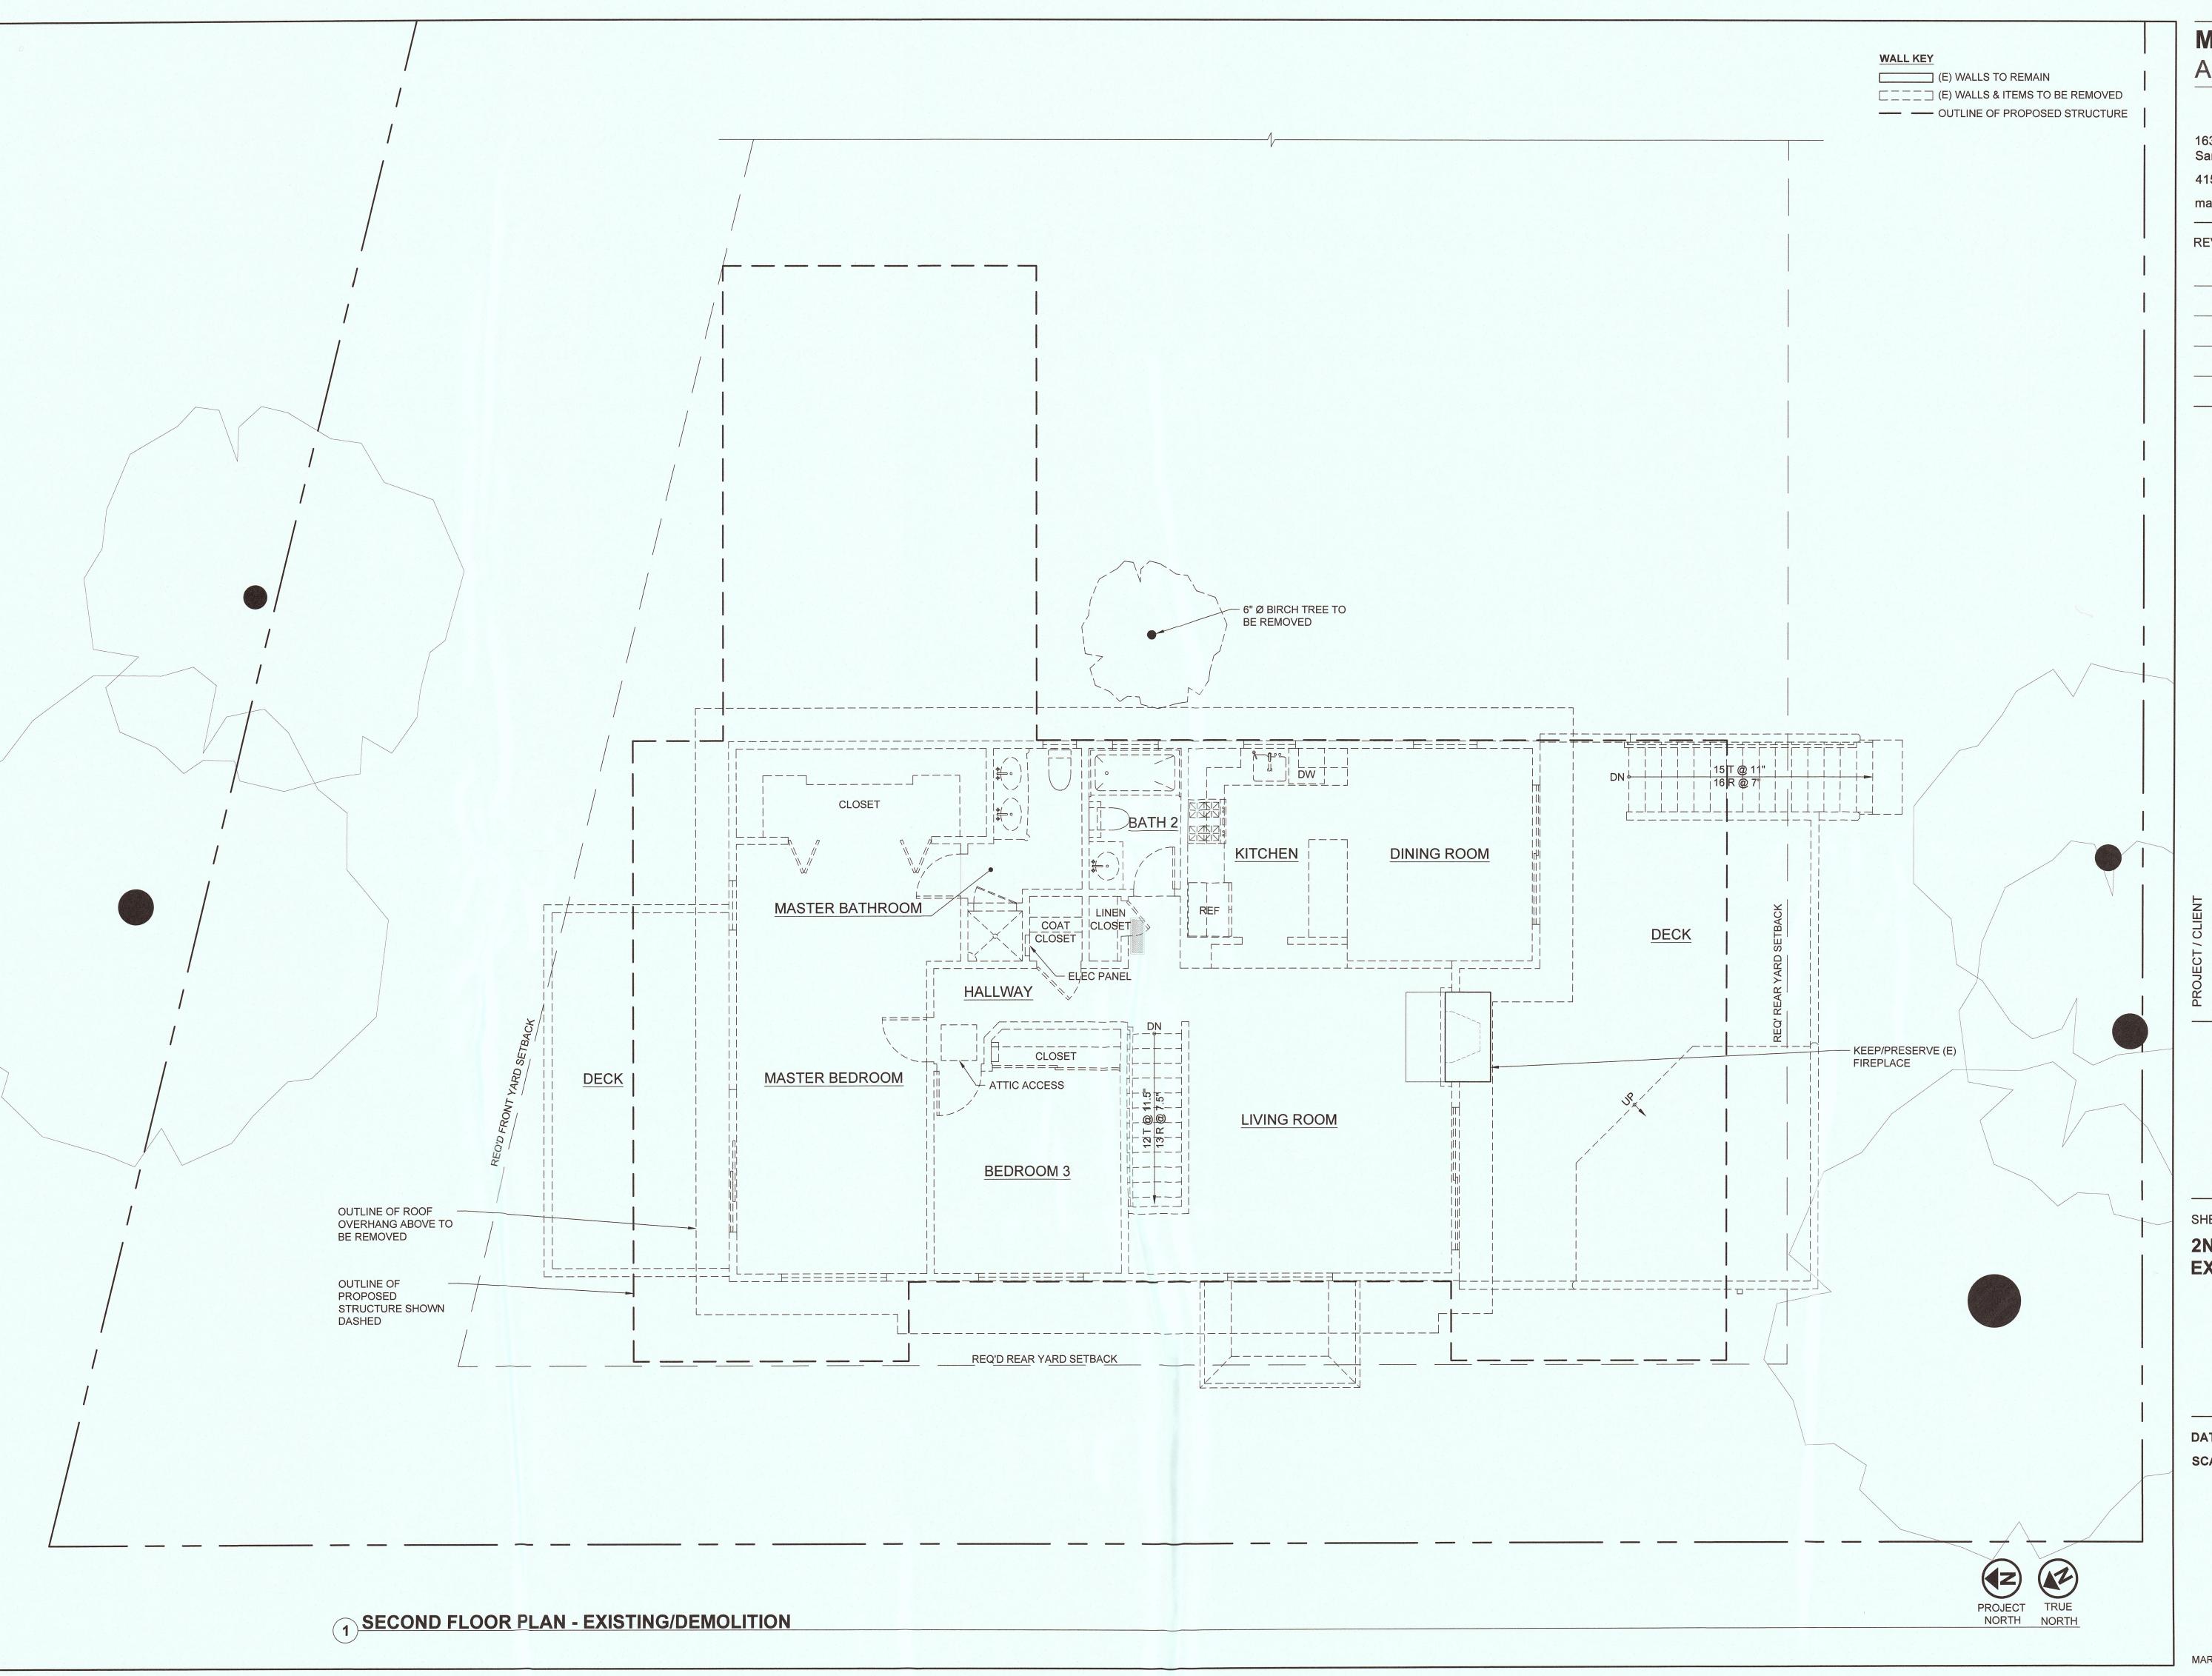

Mark Reilly Architecture

> 163 Park Street San Francisco, CA 94110 415-309-0107

markreillyarchitecture.com

REVISION HISTORY (THIS SHEET)

+ SPANGLER RESIDENCE
N REVIEW APPLICATION
DE AVENUE
1, CA 94038

MARK REILLY
No. C-33112


REN. 04/30/2017

SHEET TITLE

2ND FLOOR PLAN EXISTING/DEMOLITION

DATE / JULY 21, 2016 SCALE / 1/4" = 1'-0"

A5

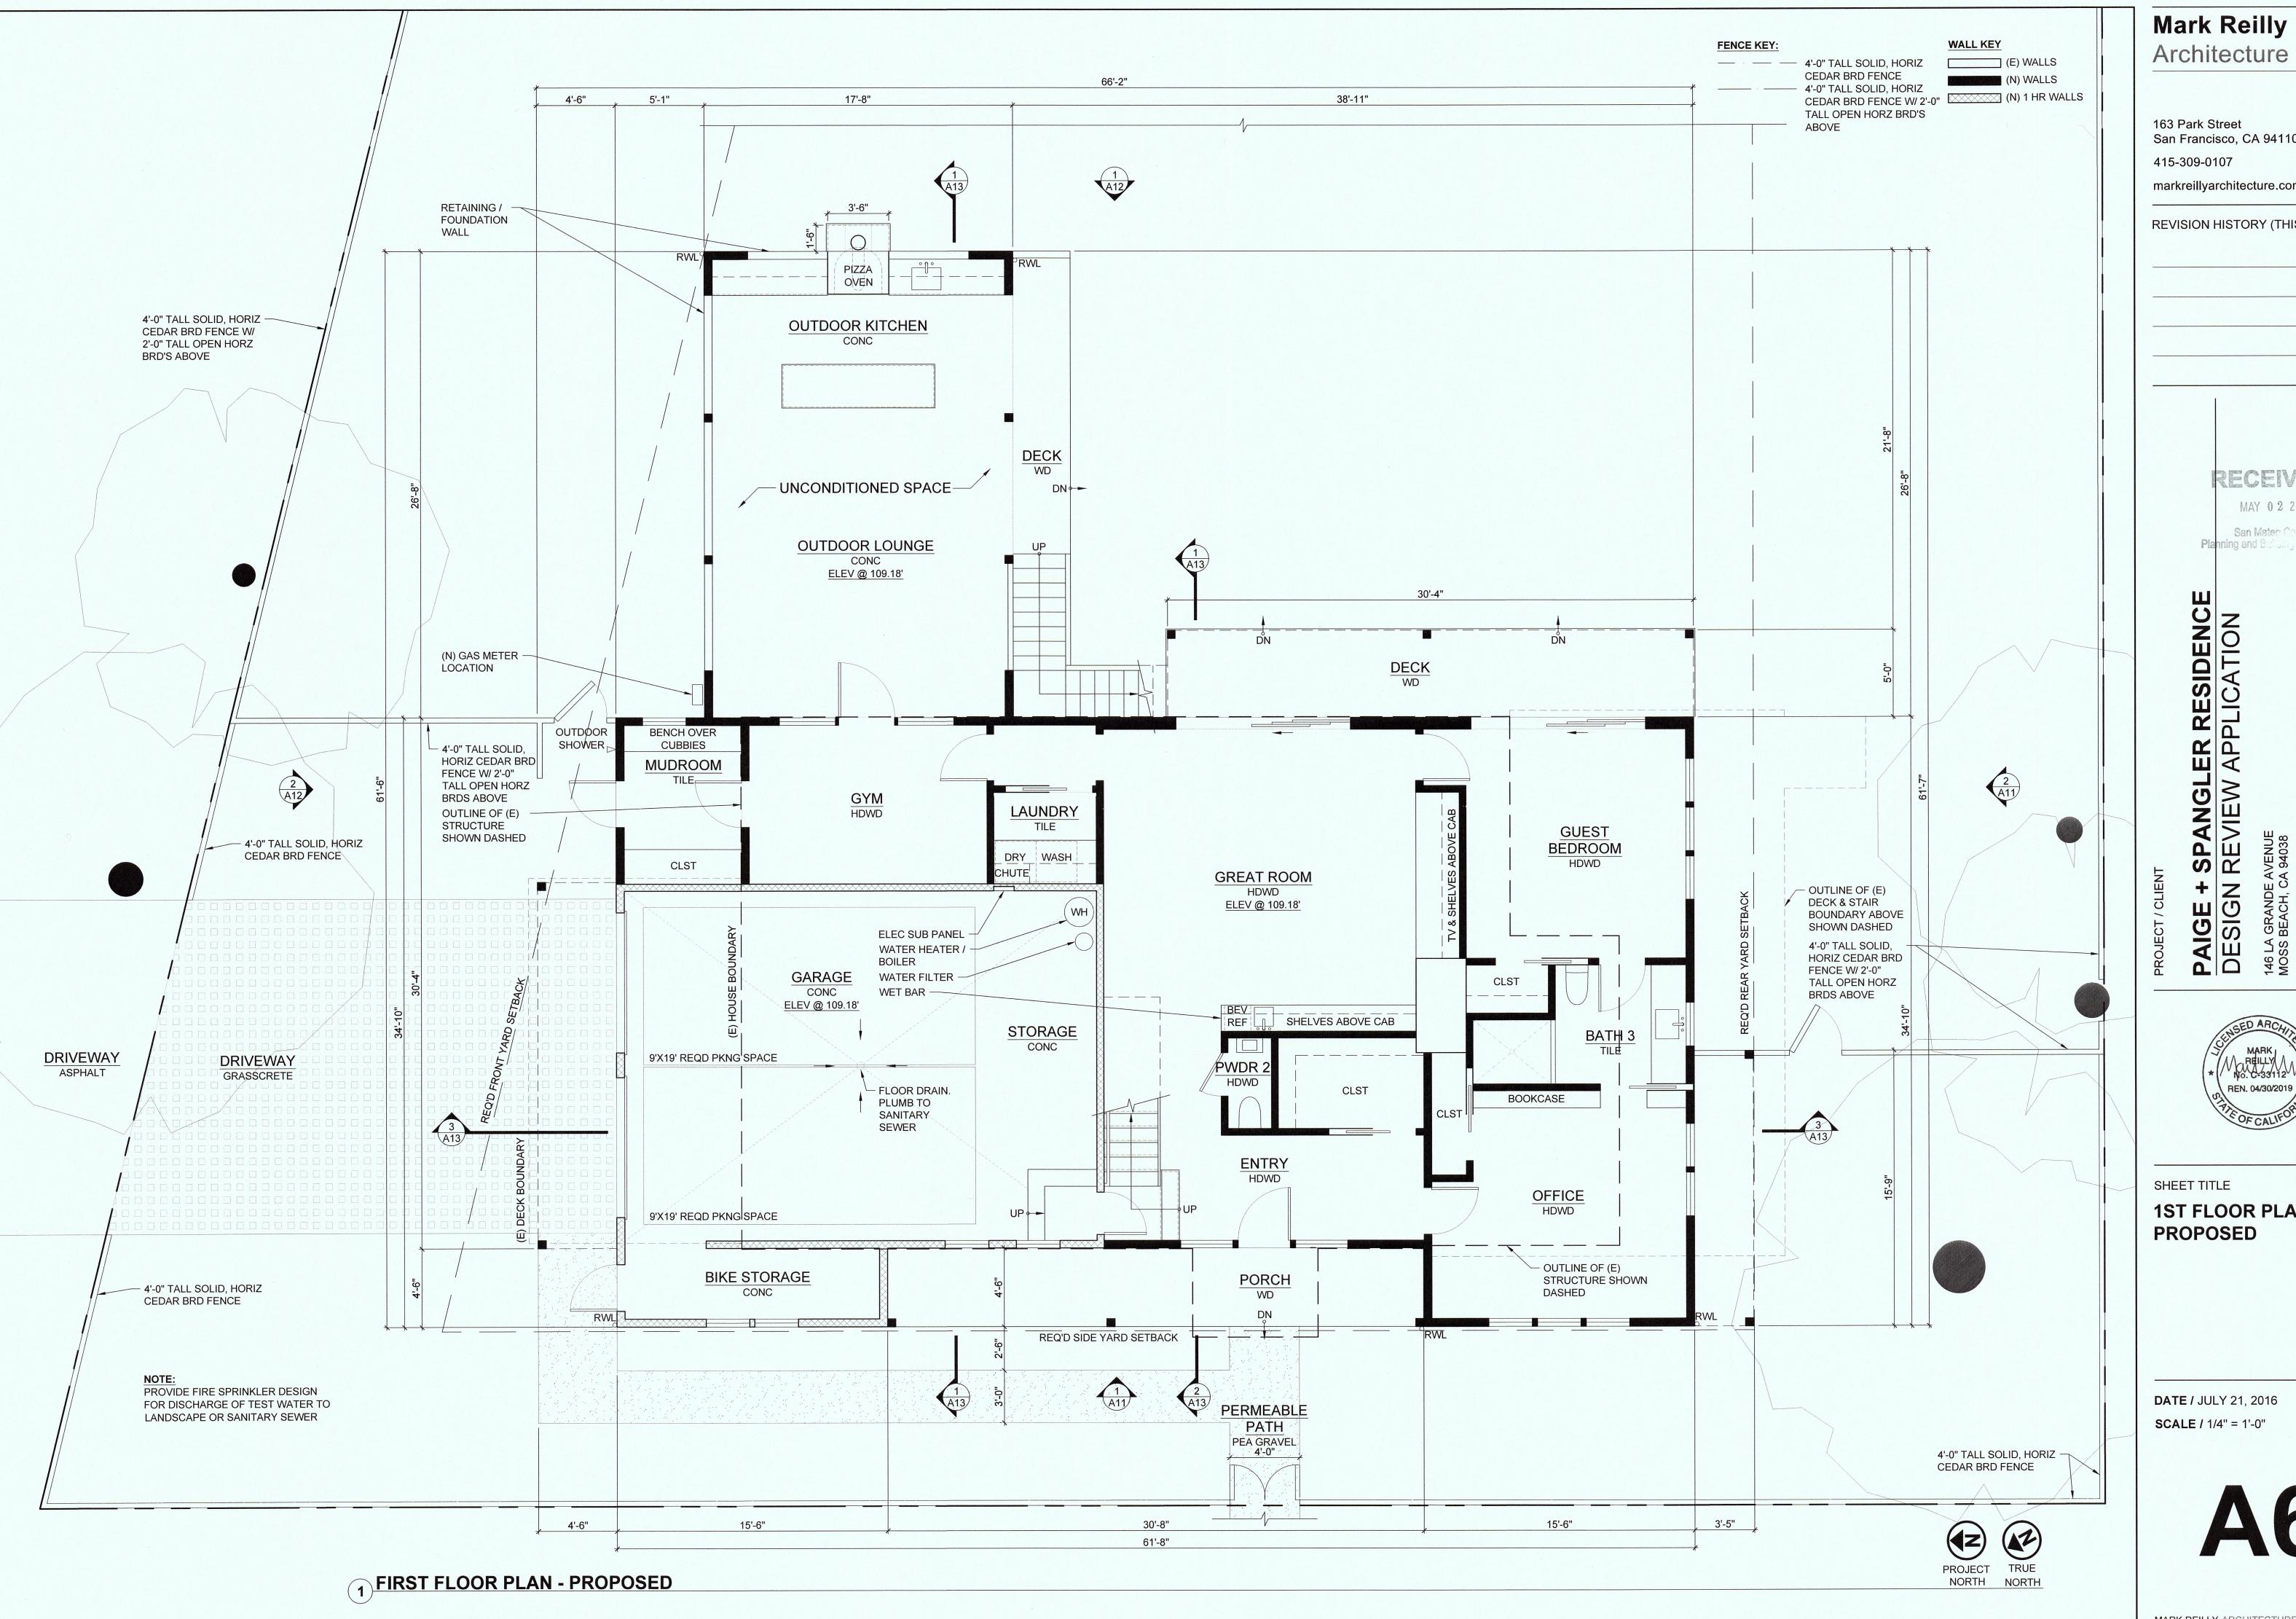

Mark Reilly

163 Park Street San Francisco, CA 94110

415-309-0107 markreillyarchitecture.com

REVISION HISTORY (THIS SHEET)

RECEIVED

MAY 0 2 2017

San Mateo County Planning and Bulluing Department


RESIDENCE PPLICATION

PAIGE + SP/ DESIGN REV



1ST FLOOR PLAN -**PROPOSED** 

**DATE /** JULY 21, 2016 **SCALE /** 1/4" = 1'-0"

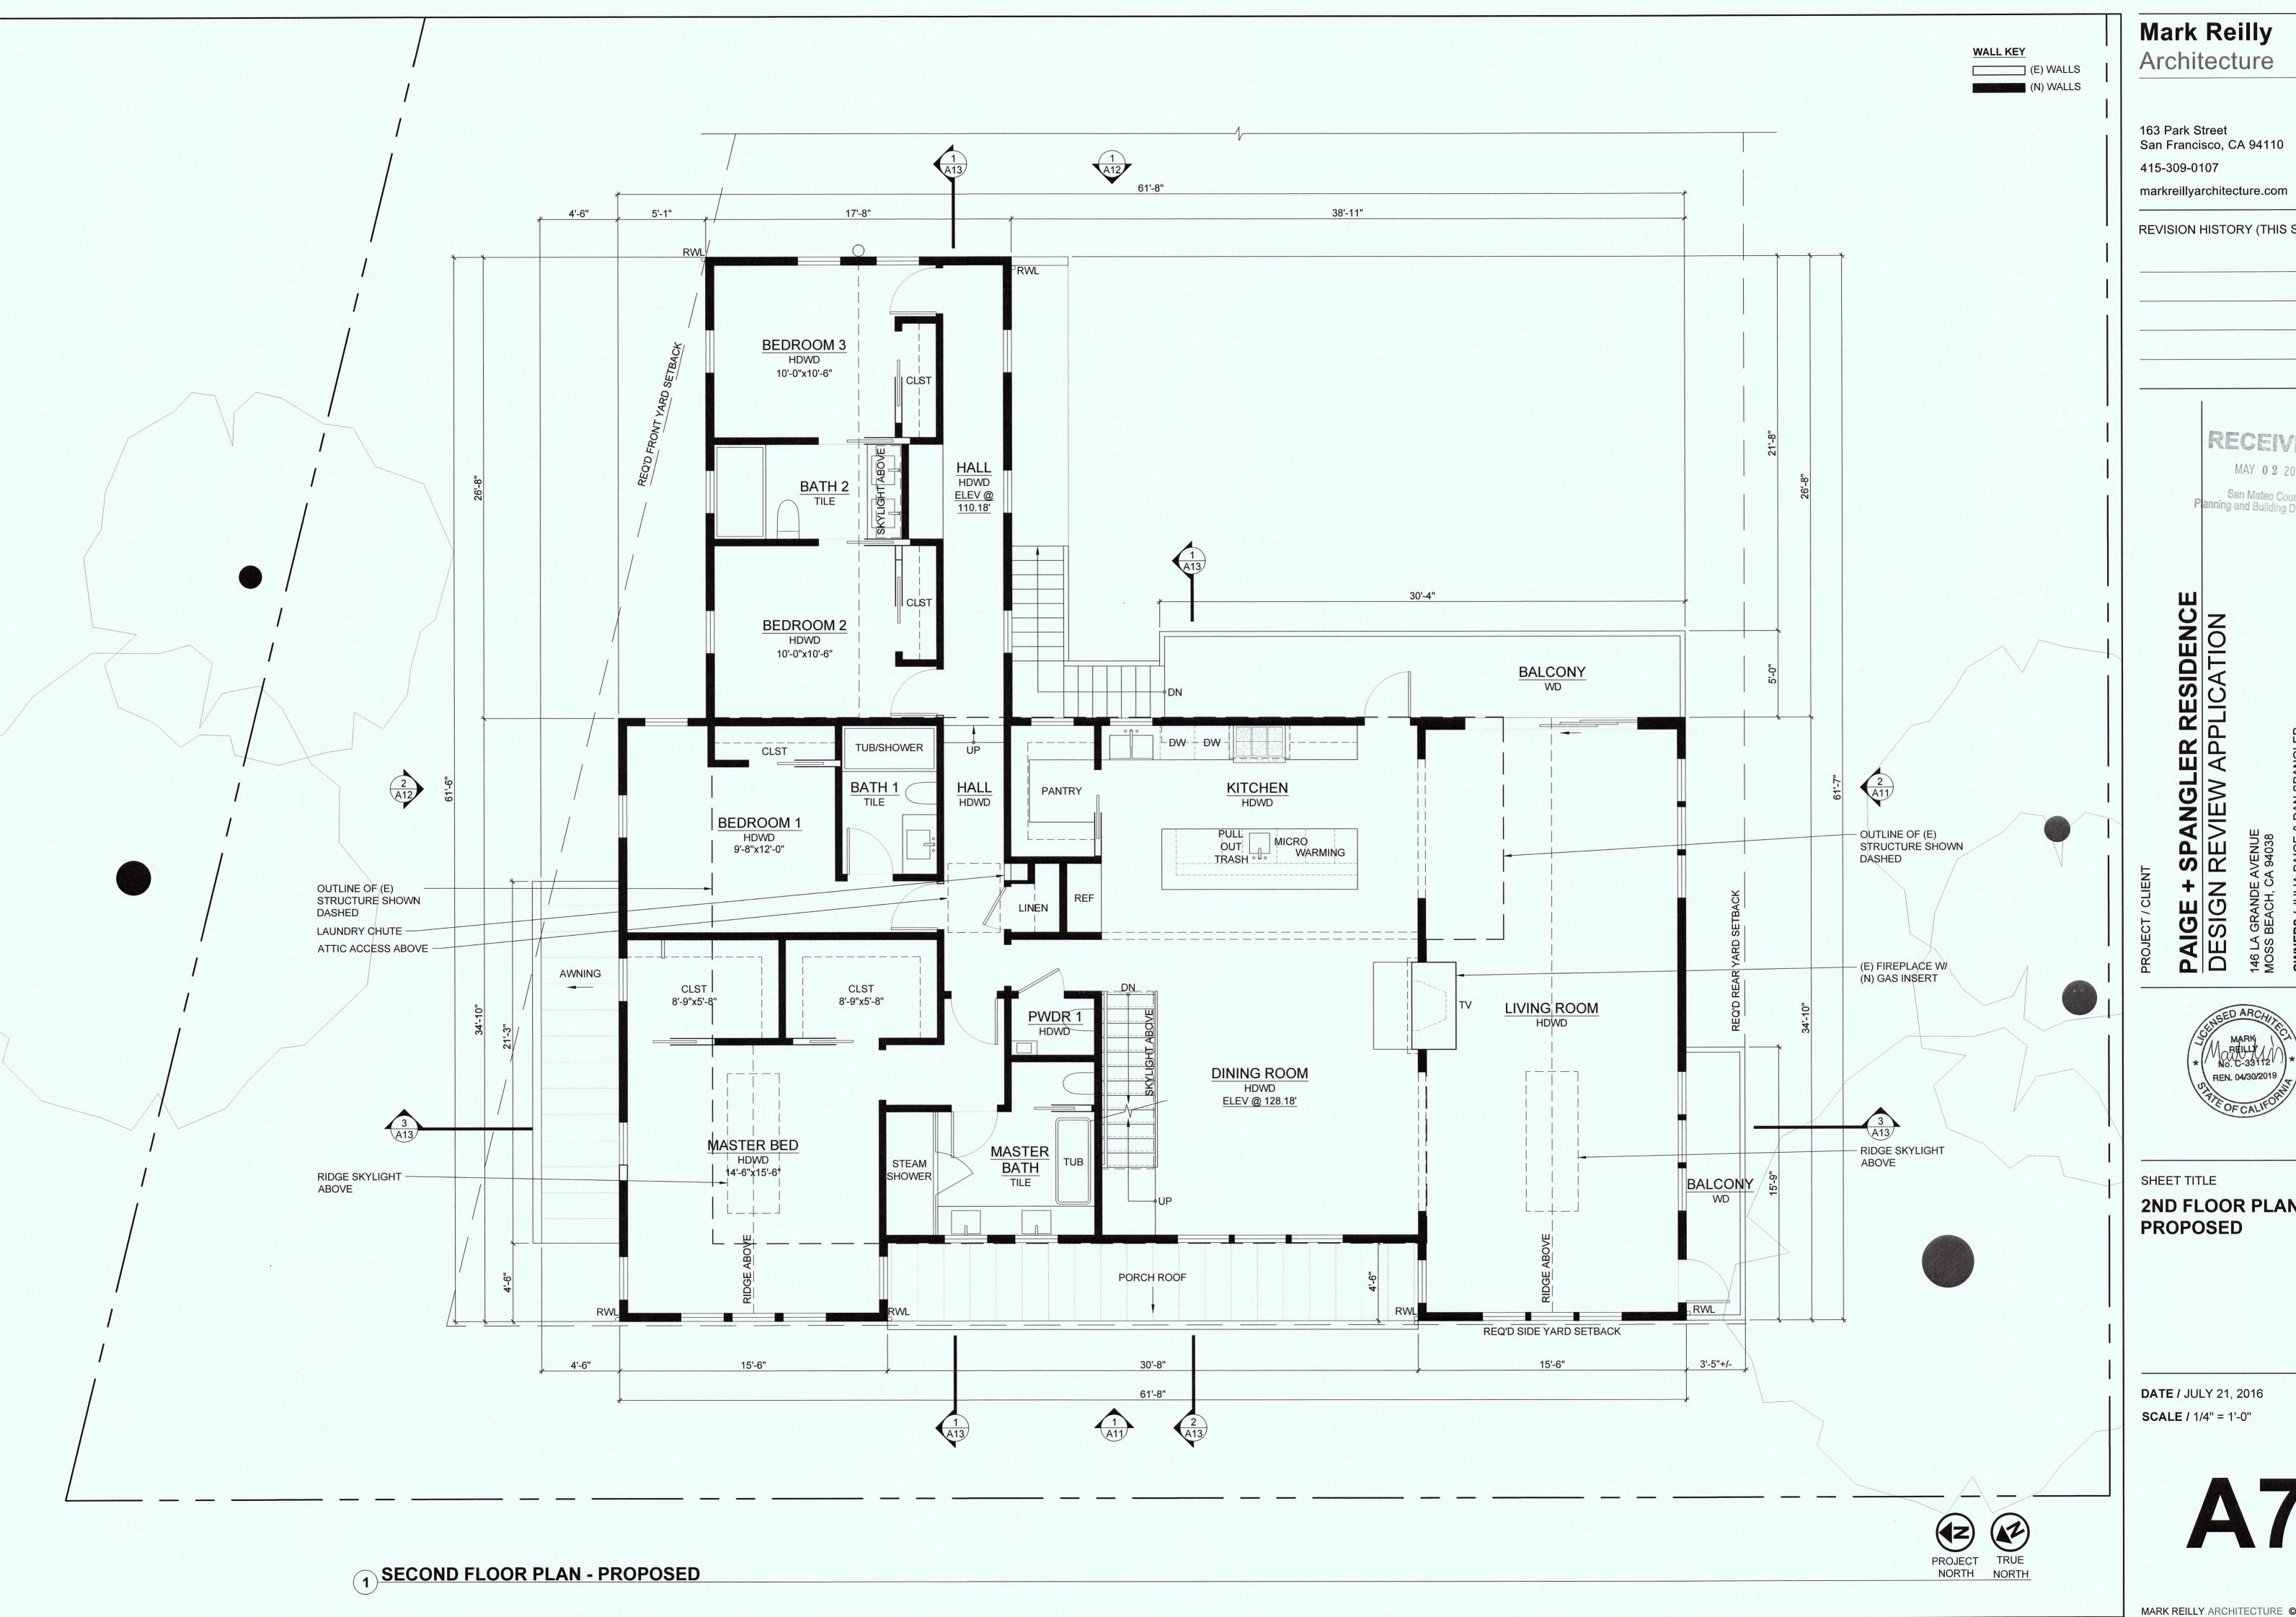

Mark Reilly Architecture

> 163 Park Street San Francisco, CA 94110 415-309-0107

REVISION HISTORY (THIS SHEET)

RECEIVED


MAY 02 2017 San Mateo County
Planning and Building Department

ANGLER RESIDENCE VIEW APPLICATION

PAIGE + SP/ DESIGN RE\

2ND FLOOR PLAN -**PROPOSED** 

**DATE /** JULY 21, 2016 **SCALE / 1/4" = 1'-0"** 

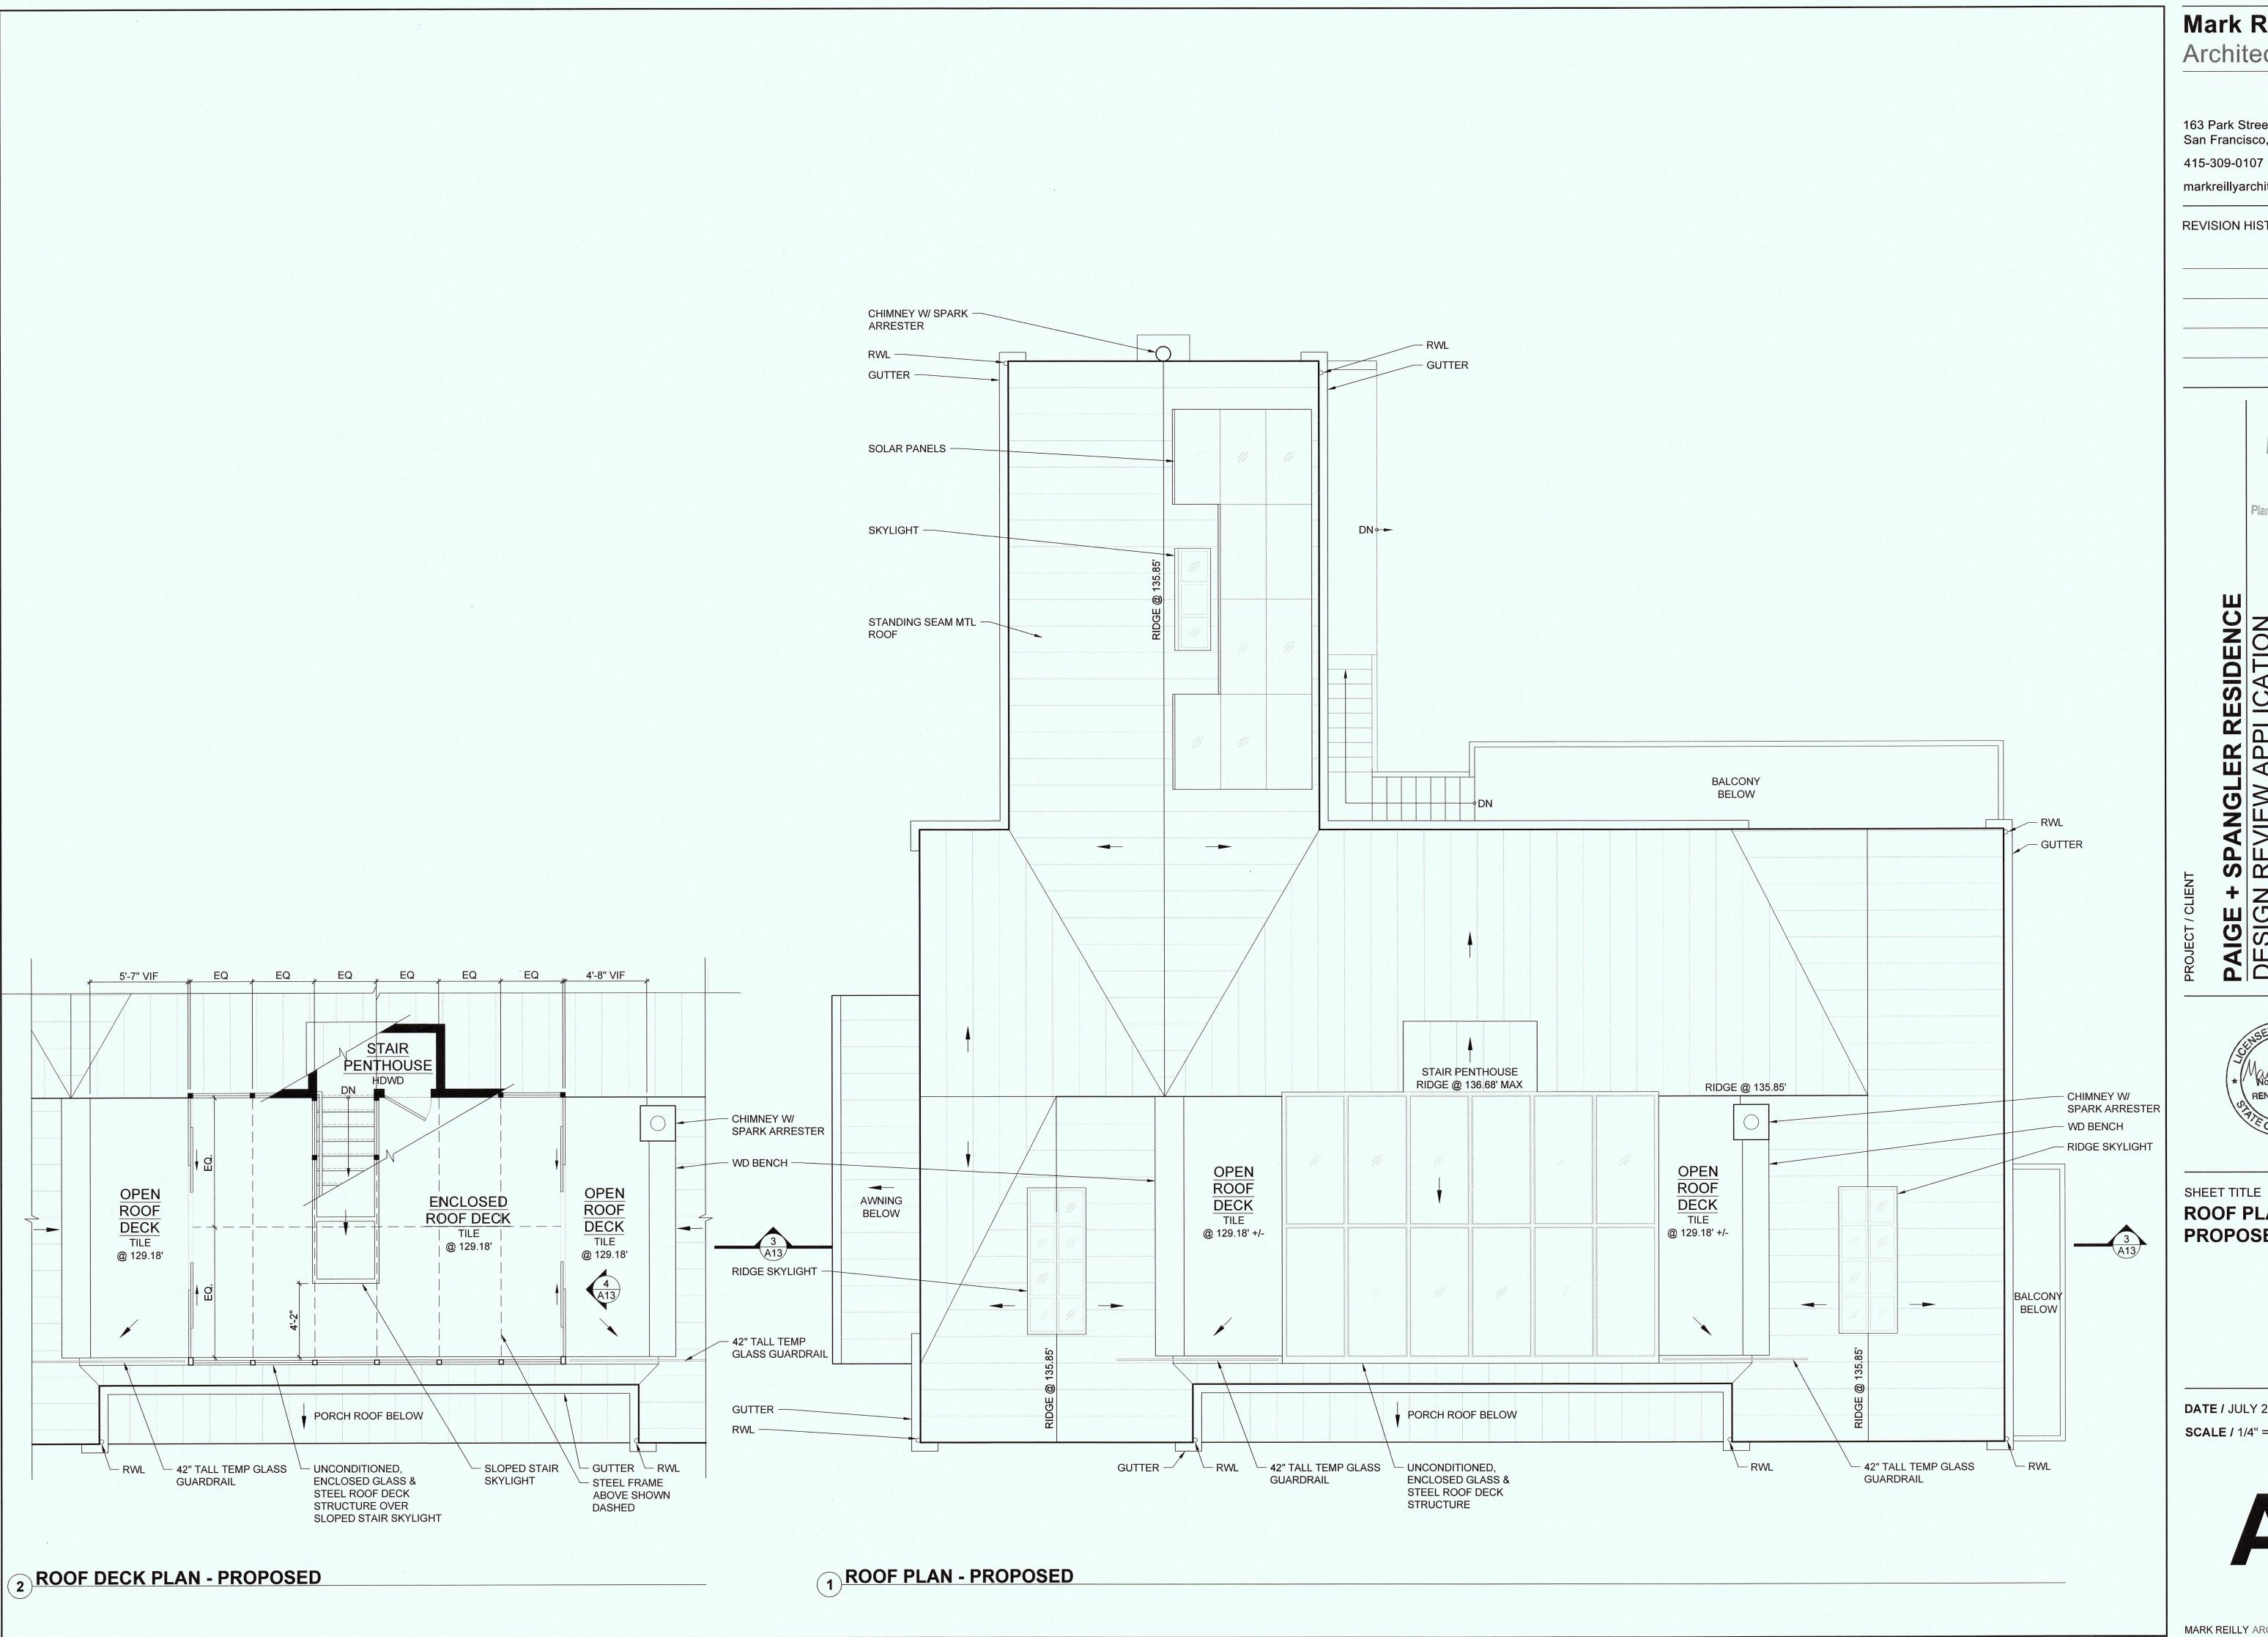

Mark Reilly Architecture

163 Park Street San Francisco, CA 94110

markreillyarchitecture.com

REVISION HISTORY (THIS SHEET)

MAY 02 2017 San Mateo County
Planning and Building Department

ANGLER RESIDENCE VIEW APPLICATION


PAIGE + SPA

REN. 04/30/2019

SHEET TITLE **ROOF PLAN -PROPOSED** 

**DATE /** JULY 21, 2016 **SCALE /** 1/4" = 1'-0"



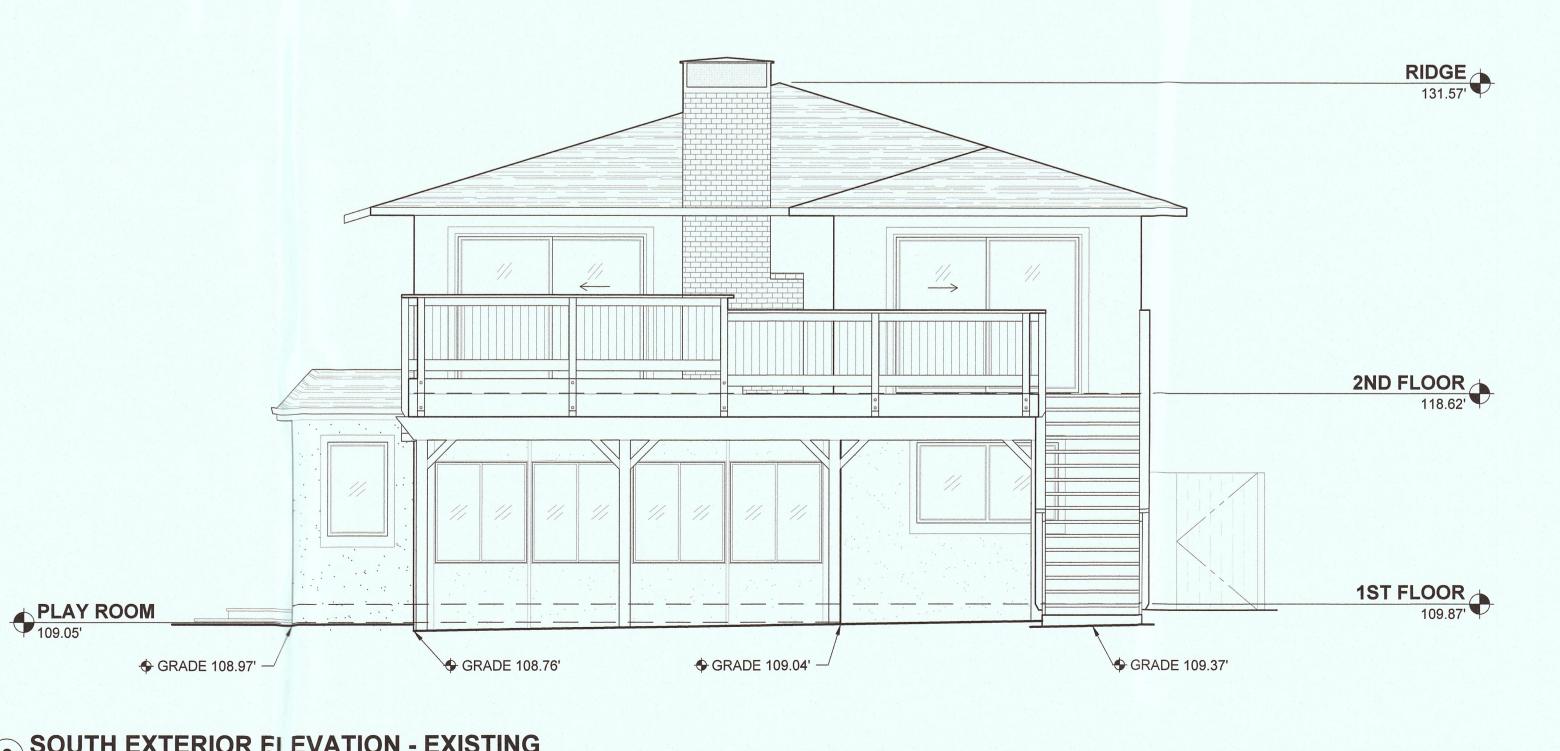

SOUTH EXTERIOR ELEVATION - EXISTING

# Mark Reilly Architecture

163 Park Street San Francisco, CA 94110 415-309-0107 markreillyarchitecture.com

REVISION HISTORY (THIS SHEET)

SHEET TITLE

**EXTERIOR ELEVATIONS -EXISTING** 

**DATE /** JULY 21, 2016 **SCALE /** 1/4" = 1'-0"



GRADE 110.06'

NORTH EXTERIOR ELEVATION - EXISTING

# Mark Reilly Architecture

163 Park Street San Francisco, CA 94110 415-309-0107

markreillyarchitecture.com

REVISION HISTORY (THIS SHEET)

W APPLICATION

AIGE + SPAI

MARK REILLY

\* No. C-33112

REN. 04/30/2017

OF CALIFORNIA


SHEET TITLE

EXTERIOR ELEVATIONS - EXISTING

DATE / JULY 21, 2016 SCALE / 1/4" = 1'-0"

♦ GRADE 109.64' — ♦ GRADE 109.18' —

A10

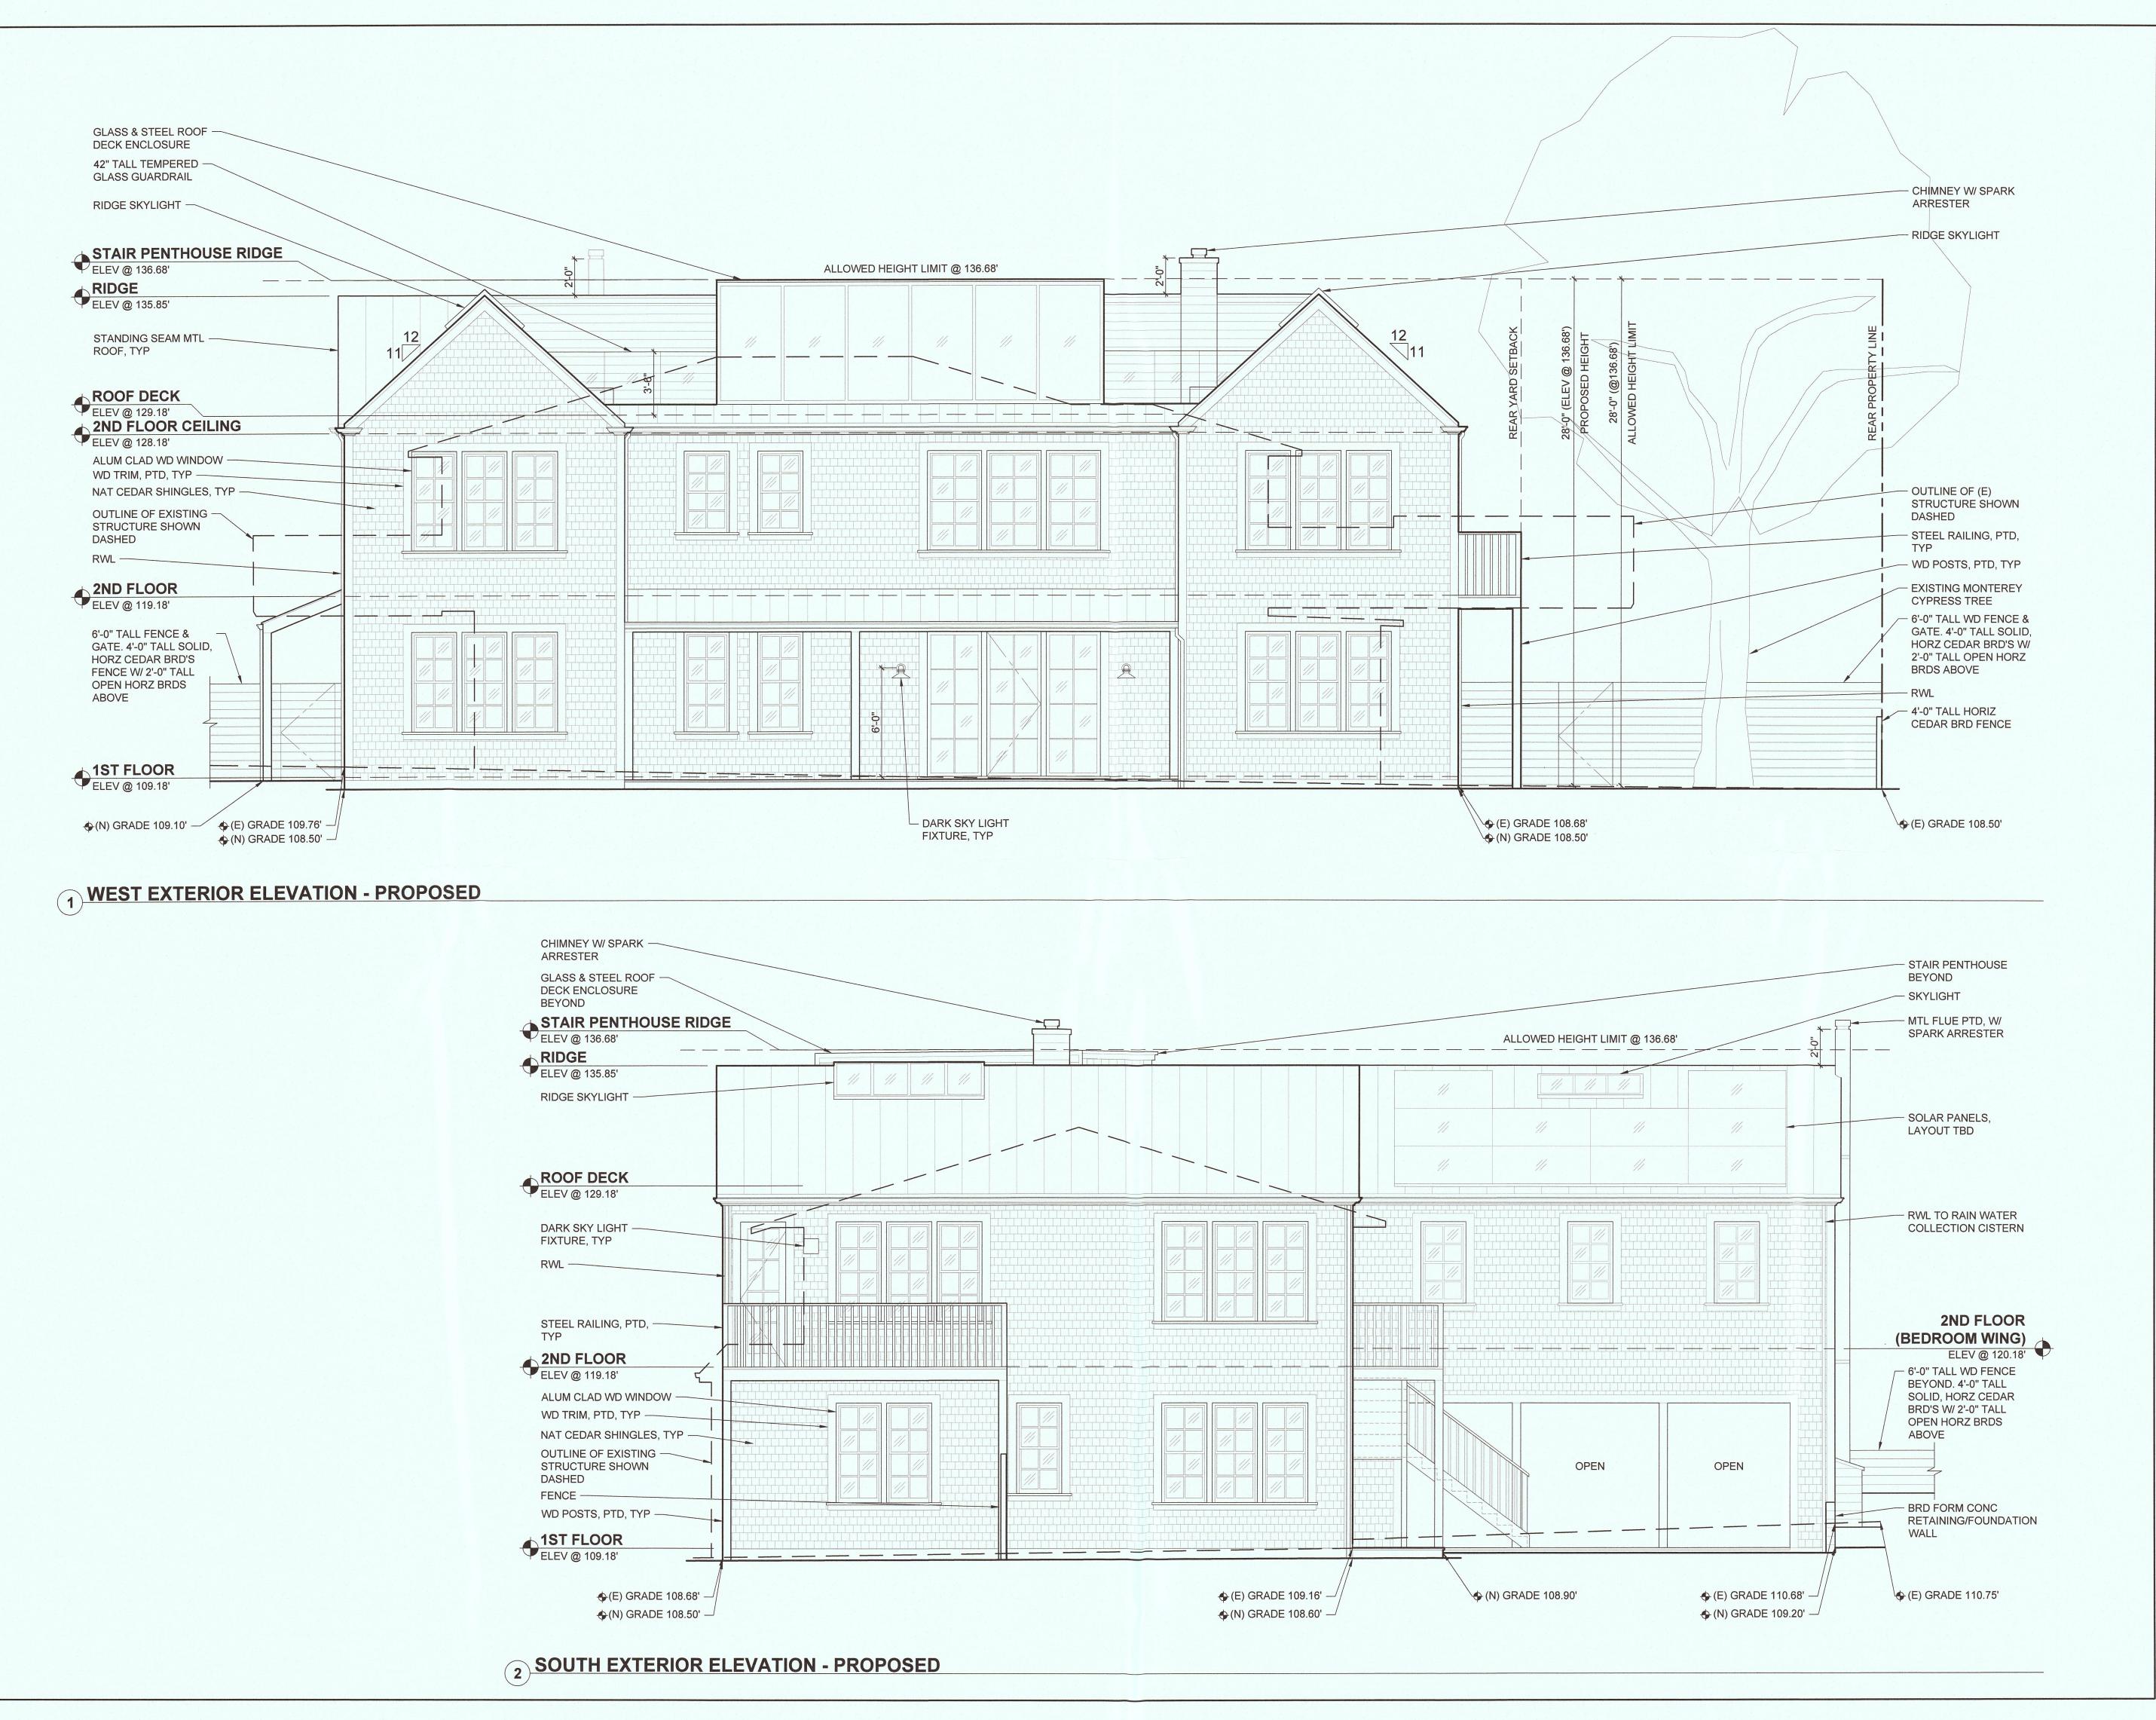

# Mark Reilly Architecture

163 Park Street San Francisco, CA 94110 415-309-0107 markreillyarchitecture.com

REVISION HISTORY (THIS SHEET)

ANGLER RESIDENCE

EVIEW APPLICATION

PAIGE + SPAN DESIGN REVIE

DESIGN REPORT OF THE LA GRANDE AVENUMOSS BEACH, CA 9403


OWNERS / JULIA PAIGI

SHEET TITLE

EXTERIOR ELEVATIONS - PROPOSED

DATE / JULY 21, 2016 SCALE / 1/4" = 1'-0"

A11

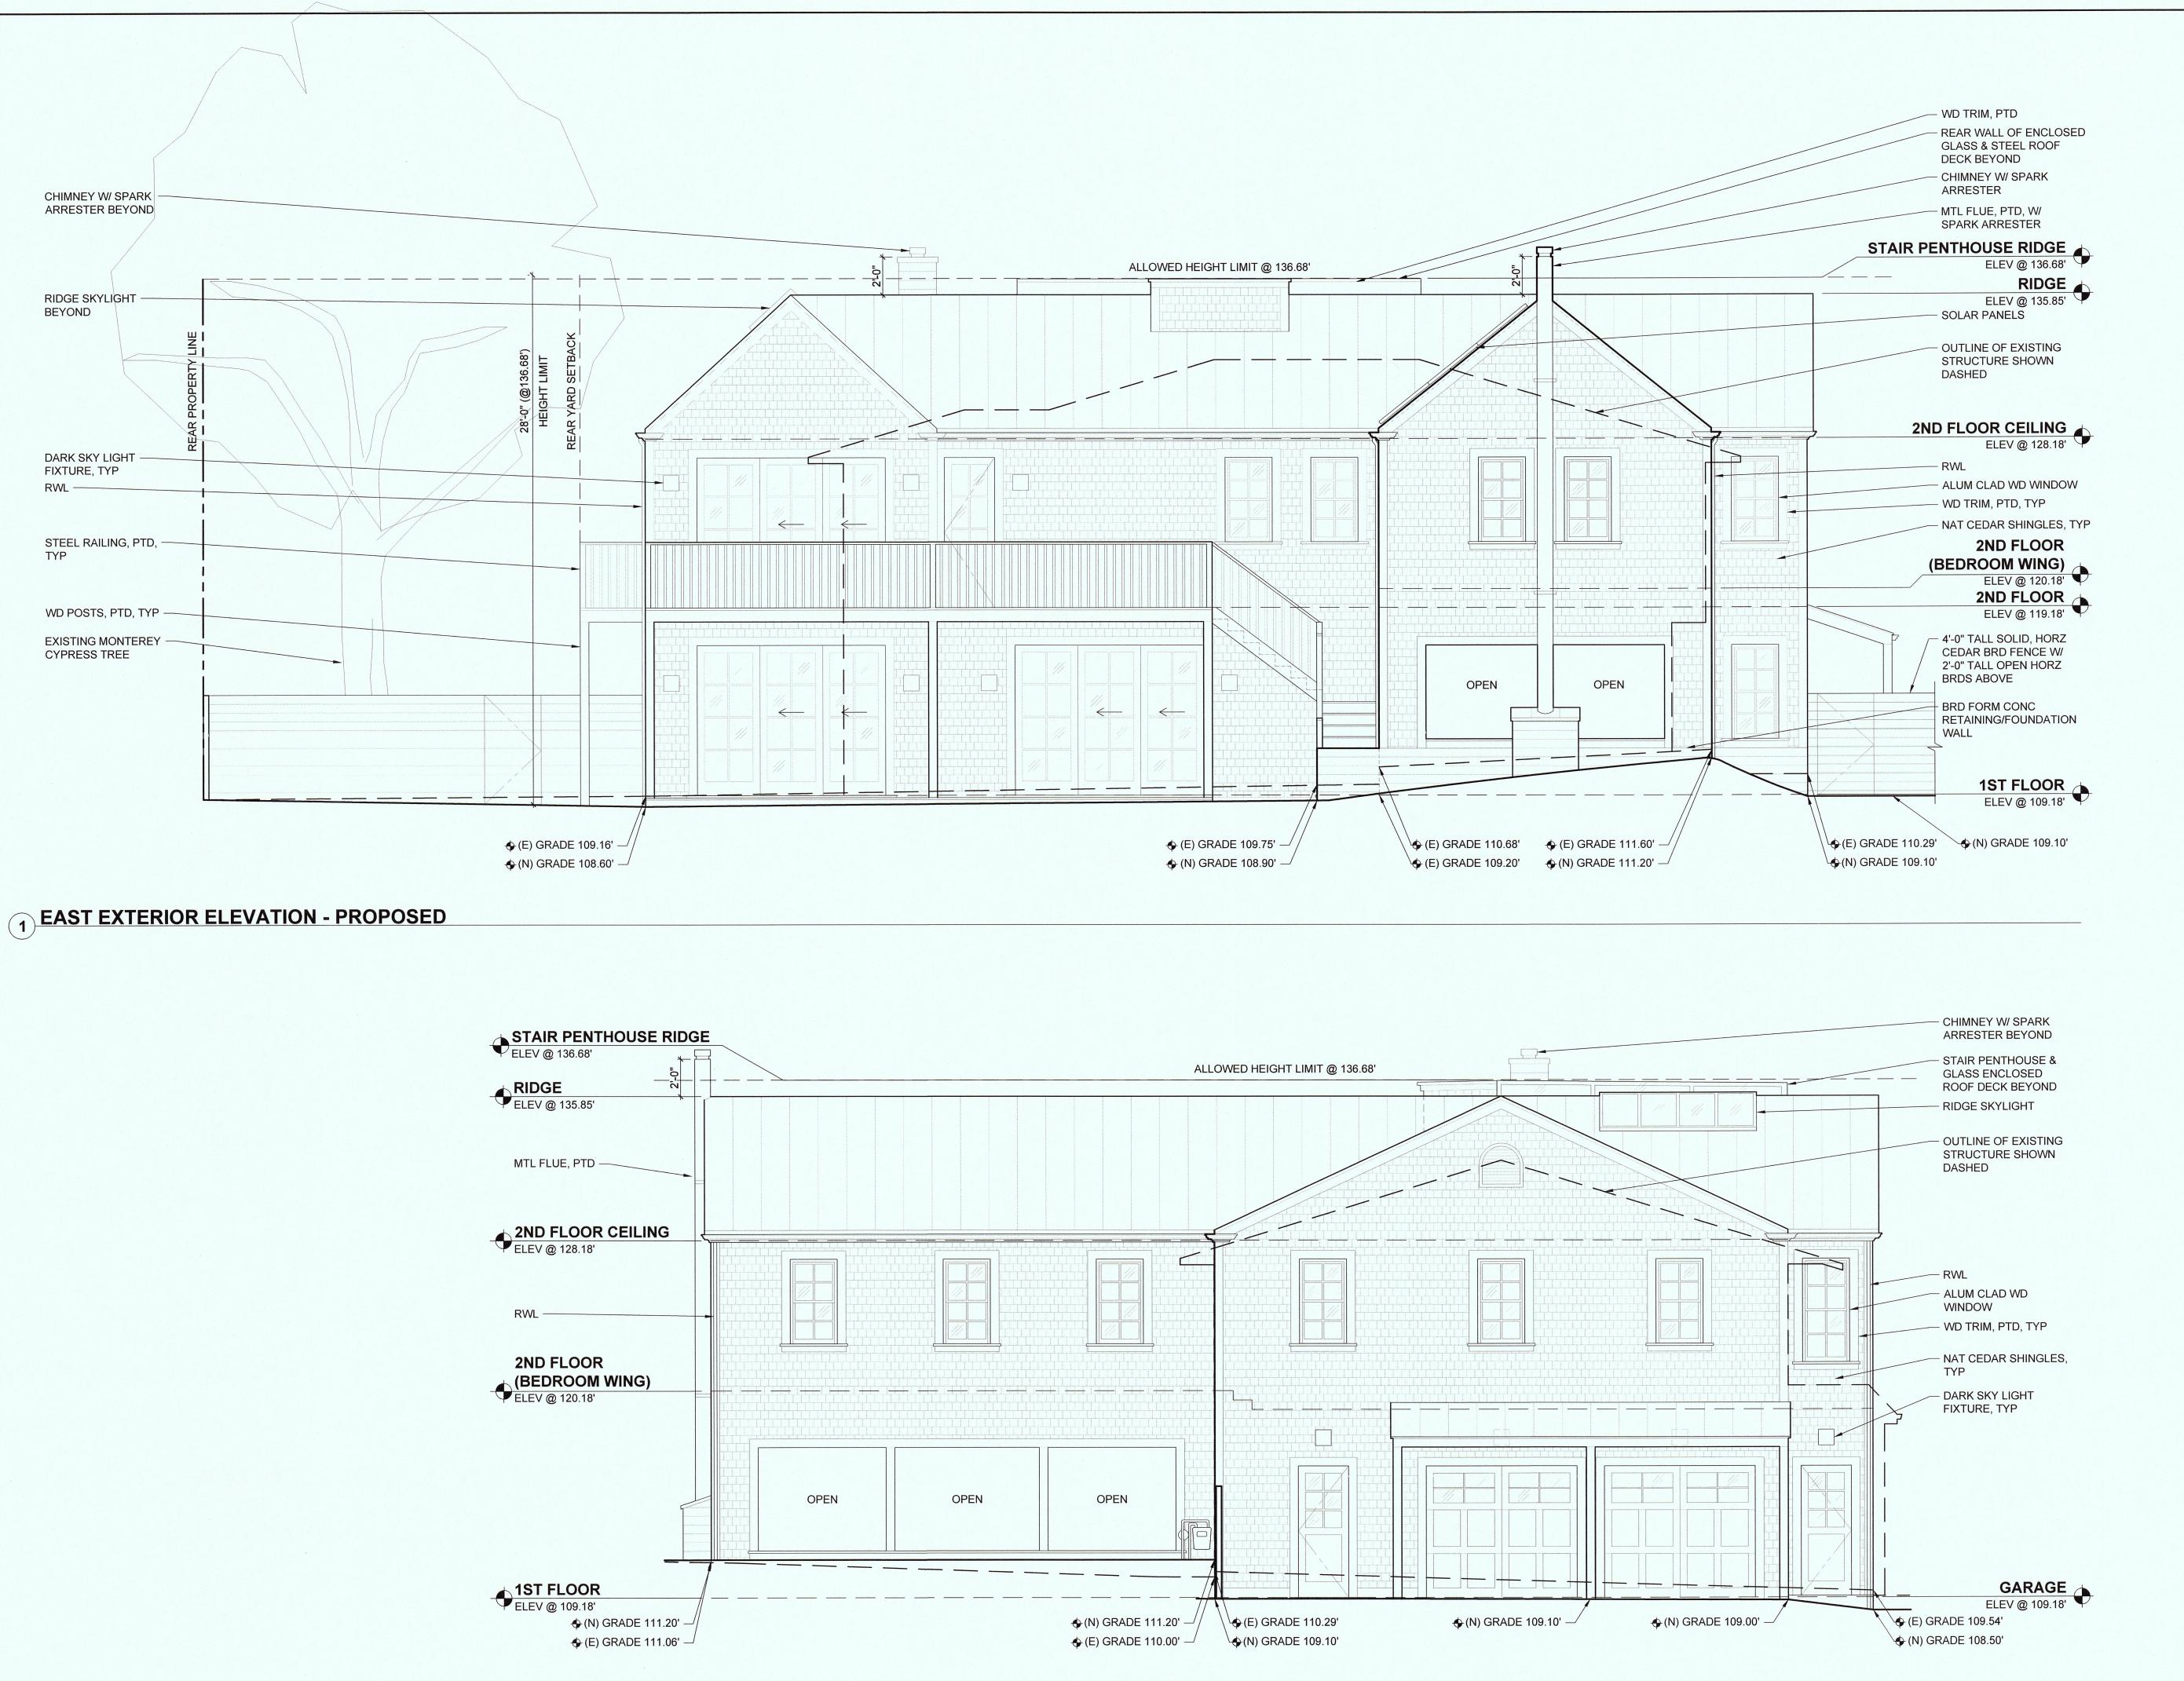

NORTH EXTERIOR ELEVATION - PROPOSED

Mark Reilly Architecture

> 163 Park Street San Francisco, CA 94110 415-309-0107

markreillyarchitecture.com

REVISION HISTORY (THIS SHEET)

MAY 02 2017

San Mateo County
anning and Building Department

ANGLER RESIDENCE VIEW APPLICATION


PAIGE + SPA



SHEET TITLE

**EXTERIOR ELEVATIONS -PROPOSED** 

**DATE /** JULY 21, 2016 **SCALE /** 1/4" = 1'-0"

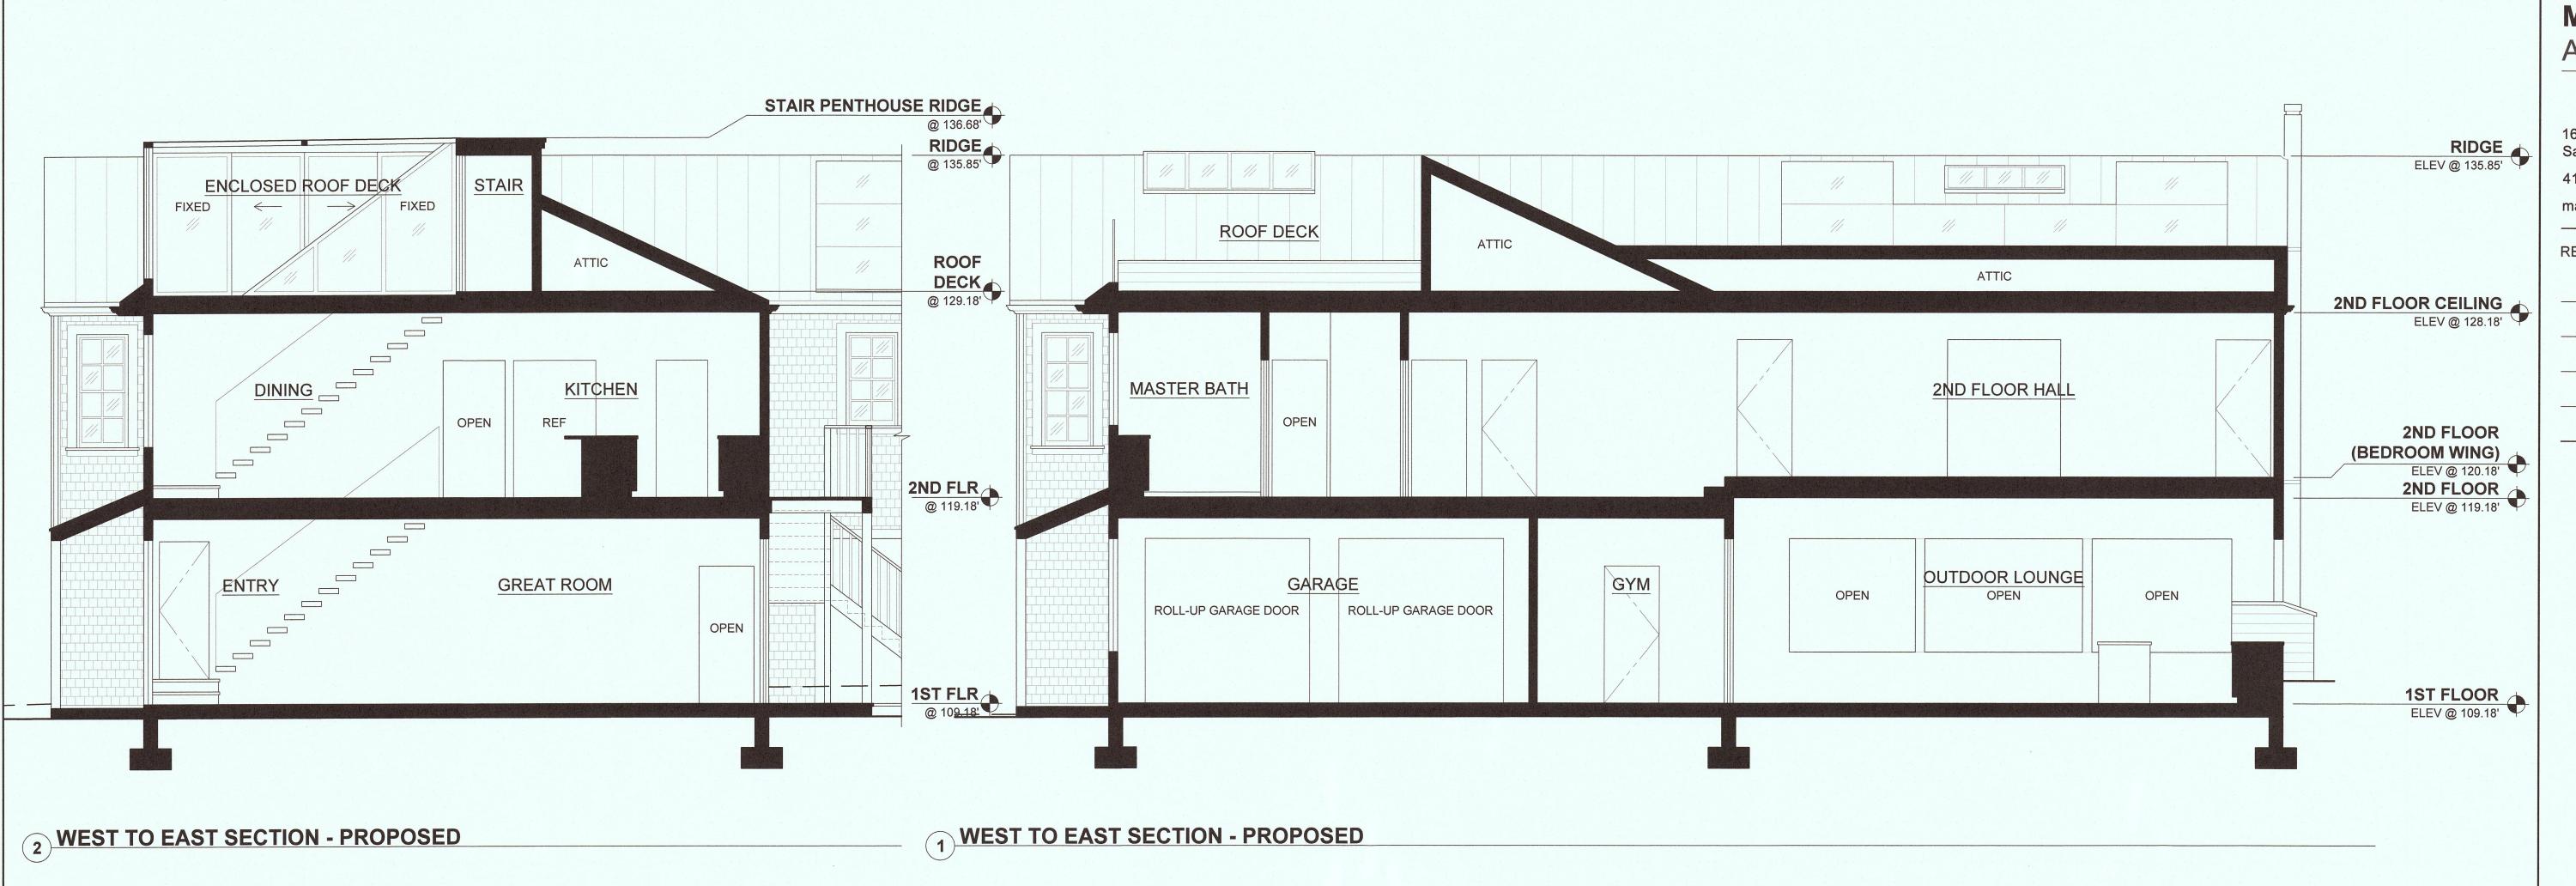

STAIR PENTHOUSE RIDGE
ELEV @ 136.68' RIDGE ELEV @ 135.85' ENCLOSED ROOF DECK OPEN ROOF DECK OPEN ROOF DECK ROOF DECK
ELEV @ 129.18' 2ND FLOOR CEILING ELEV @ 128.18' MASTER BATH MASTER BED **DINING ROOM** LIVING ROOM 2ND FLOOR ELEV @ 119.18' GARAGE OFFICE **ENTRY** 1ST FLOOR ELEV @ 109.18'

(SOUTH ELEVATION, NORTH SIMILAR)

SLOPE

SLOPE

FIXED

3 NORTH TO SOUTH SECTION - PROPOSED

Mark Reilly Architecture

> 163 Park Street San Francisco, CA 94110 415-309-0107

markreillyarchitecture.com

REVISION HISTORY (THIS SHEET)

+ SPANGLER RESIDENCE
SN REVIEW APPLICATION
H, CA 94038


MARK REILLY
No. C-33112
REN CARROLLE


SHEET TITLE

CROSS SECTIONS - PROPOSED

DATE / JULY 21, 2016 SCALE / 1/4" = 1'-0"

A13

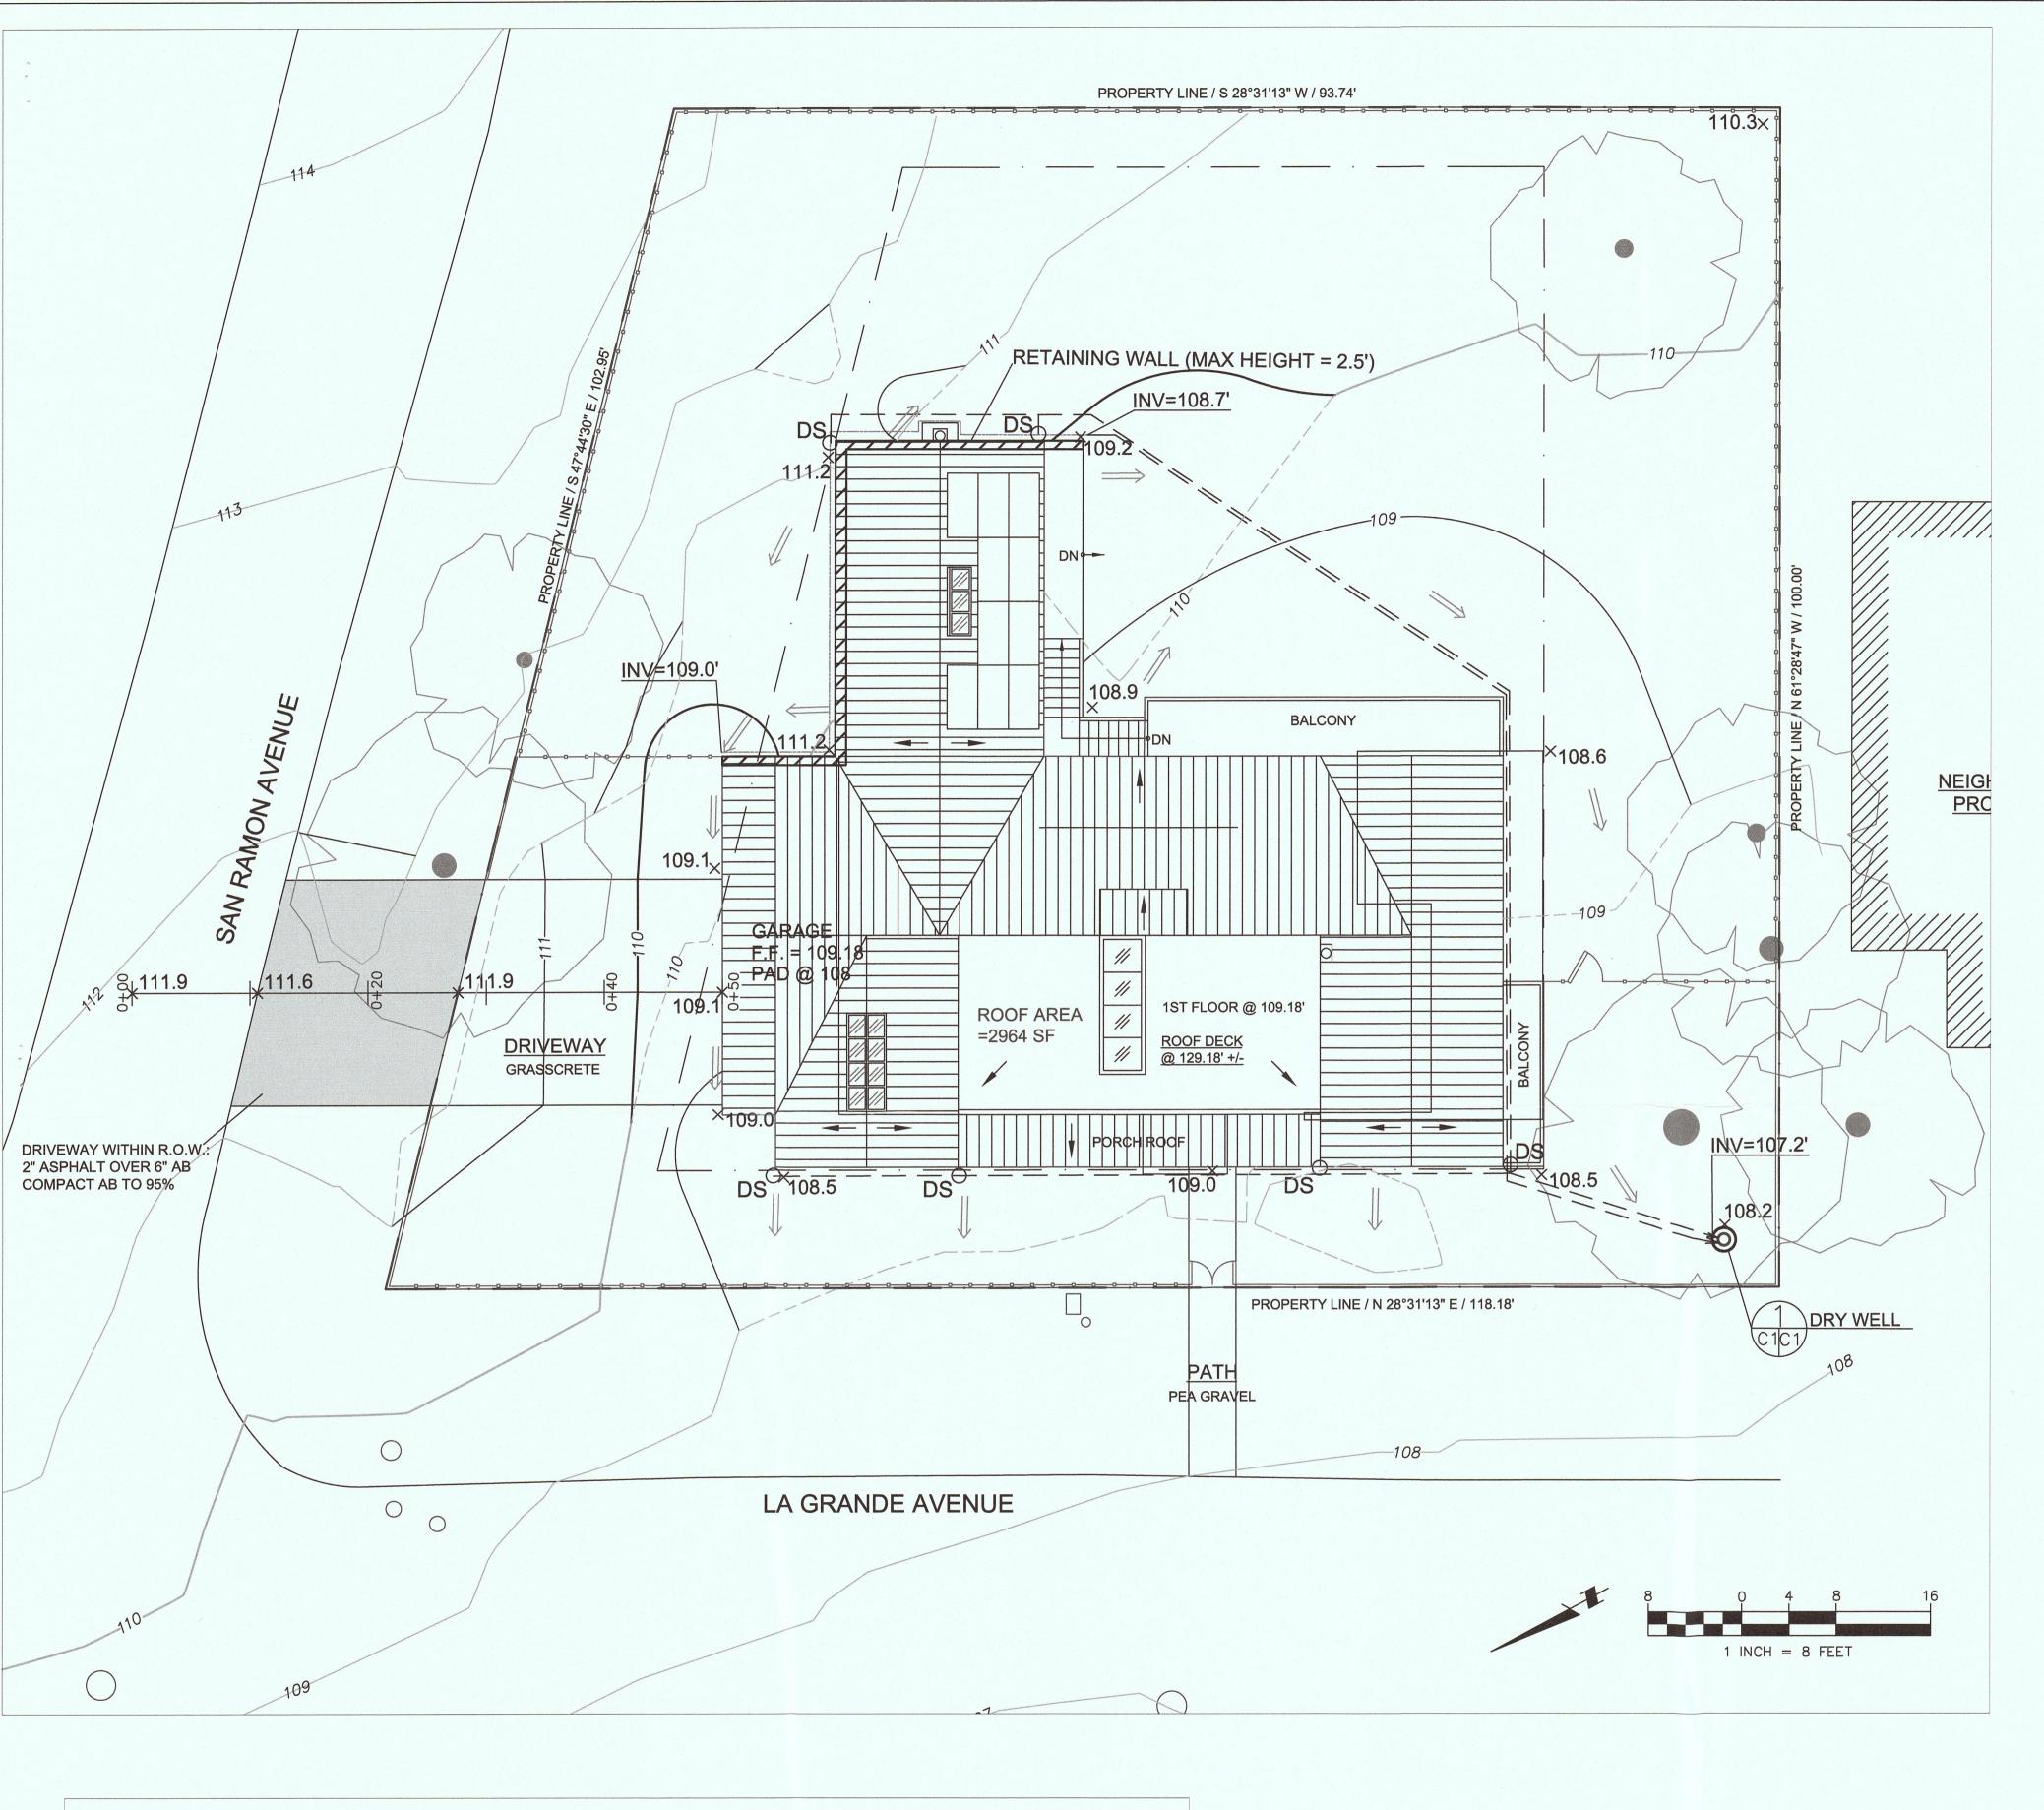

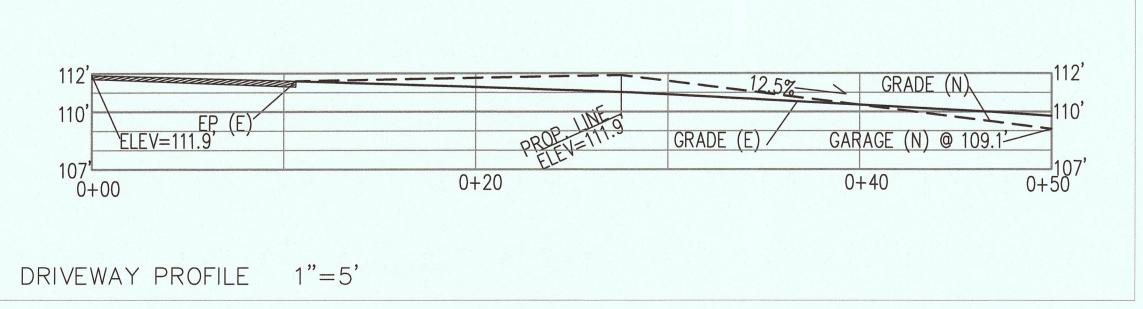

## LEGEND

EXISTING CONTOUR

PROPOSED CONTOUR

EXISTING CONTOUR, REMOVED

× 109.1 PROPOSED SPOT ELEVATION

PROPOSED (NEW) DOWNSPOUT

DIRECTION OF SURFACE DRAINAGE FLOW

3" SOLID PLASTIC DRAIN PIPE, SDR 35 @ 1% MINIMUM

3" PERFORATED PLASTIC DRAIN PIPE, SDR 35 @ 0.5% MINIMUM SLOPE.

## GENERAL NOTES

- 1. PLANS PREPARED AT THE REQUEST OF:
- JULIA PAIGE, OWNER 2. SURVEY AND TOPOGRAPHY BY OTHERS.
- 3. ELEVATION DATUM ASSUMED.
- 4. THIS IS NOT A BOUNDARY SURVEY.

## GRADING NOTES

CUT VOLUME: 220 CY (FOR FOUNDATION AND GRADING IN BACK YARD) FILL VOLUME: 20 CY TOTAL CUT+FILL = 240 CY

1. ABOVE VOLUMES ARE APPROXIMATE. 2. ALL GRADING SHALL CONFORM TO LOCAL CODES AND ORDINANCES.

## DRAINAGE NOTES

1. DRAINAGE INTENT: IT IS THE INTENT OF THE DRAINAGE SYSTEM TO CONVEY ROOF

RUNOFF FROM THE ADDITION TO A SAFE LOCATION.

2. THERE IS A NET DECREASE IN IMPERVIOUS SURFACES OF -268 SF.

3. ALL EXISTING DOWNSPOUTS SHALL BE RETAINED. 4. THE PROPOSED DRAIN PIPE SHALL BE 3" DIAMETER SOLID PIPE, SLOPED AT 1% MINIMUM.

5. IT IS THE RESPONSIBILITY OF THE OWNER TO MAINTAIN THE DRAINAGE SYSTEM. THE DRY WELL SHALL BE CHECKED EVERY FALL AND CLEARED OF DEBRIS.

## TRAFFIC CONTROL NOTES

1. CONTRACTOR AND WORKERS SHALL PARK ALONG LA GRANDE AVENUE. 2. WHEN TRUCKS PARK IN STREET FOR DELIVERY OF SUPPLIES AND CONCRETE, EVERY EFFORT SHALL BE MADE TO PROVIDE ROOM FOR VEHICLES TO PASS. WORKERS SHALL PROVIDE TRAFFIC CONTROL AT ALL

TIMES WHEN ROAD IS PARTIALLY BLOCKED. 3. IF ROAD IS BLOCKED, WORKERS SHALL PROVIDE WRITTEN DIRECTIONS

FOR A DETOUR, IF REQUESTED BY A MOTORIST.

SECTION AND DETAIL CONVENTION

SECTION OR DETAIL IDENTIFICATION REFERENCE SHEET No. FROM WHICH SECTION OR DETAIL IS TAKEN REFERENCE SHEET No. ON



GRADING AND DRAINAGE PLAN

SHEET

 $\bigcup$  —

