COUNTY OF SAN MATEO PLANNING AND BUILDING

March 17, 2017

County Government Center 455 County Center, 2nd Floor Redwood City, CA 94063 650-363-4161 T 650-363-4849 F www.planning.smcgov.org

Erica Adams 1181 Kedith Street Belmont, CA 94002

Dear Ms. Adams:

SUBJECT: Coastside Design Review Recommendation

Columbus Street, El Granada

APN 047-275-060; County File No. PLN 2017-00002

At its meeting of March 9, 2017, the San Mateo County Coastside Design Review Committee (CDRC) considered your application for a design review recommendation to allow construction of a new 1,432 sq. ft. 3-story single-family residence, including a 210 sq. ft. attached 1-car garage, located on a 2,984 sq. ft. parcel, as a part of a Coastal Development Permit (CDP); a Non-Conforming Use Permit due to non-conforming parcel size, setbacks, and parking; and a Certificate of Compliance (COC) Type B to legalize the parcel. The project includes the removal of three significant trees and involves minor earthwork. The CDP is appealable to the California Coastal Commission.

The CDRC was unable to make the findings for a design review recommendation of approval based on certain design deficiencies. In order to resolve these deficiencies in the project's design, a more thorough review of the "Standards for Design for One-Family and Two-Family Residential Development in the Midcoast" manual is required. As such, requirements from the CDRC for further project redesign are as follows:

- a. Section 6565.20(F). LANDSCAPING, PAVED AREAS, FENCES, LIGHTING AND NOISE; 1. Landscaping; Standard g.: Provide planting sizes for all trees, shrubs, ground covers, etc. Provide a full landscape plan that addresses the downhill section of the property and the at-grade deck.
- b. Section 6565.20(D). ELEMENTS OF DESIGN; 4. Exterior Materials and Colors; Standards a.(2): Provide an additional paint color for increased contrast.
- c. Section 6565.20(D). ELEMENTS OF DESIGN; 1. Building Mass, Shape and Scale; a. Relationship to Existing Topography; Standards (2) and (3): Increase the terracing of balconies with regard to their relationship to the topography of the site. Minimize the unused space under the lower level and middle level of the house.
- d. Section 6565.20(D). ELEMENTS OF DESIGN; 2. Architectural Styles and Features; d. Garages; Standard (1): Modify the garage design to minimize the prominence of the garage as viewed from the street, and articulate the front entry elevation.

As such, you were presented with the following available options at the end of the CDRC's deliberation of the project: (i) request for a decision from the CDRC on the plans presented or (ii) request that the project be considered at the next meeting to provide you with ample time to consider and incorporate the elements recommended for project redesign. You chose the second option, and the CDRC directed staff to schedule your project for consideration at a later date.

Please contact Camille Leung, Senior Planner, at 650/363-1826, if you have any questions.

To provide feedback, please visit the Department's Customer Survey at the following link: http://planning.smcgov.org/survey.

Sincerely,

Dennis P. Aguirre, Design Review Officer

CML:jlh - CMLBB012 WJN.DOCX

cc: Dianne Whitaker, Member Architect Stuart Grunow, Member Architect

Chris Johnson, El Granada Community Representative Ed and Alexis Abell, Interested Members of the Public

Major Gates, Interested Member of the Public Edward Stanley, Interested Member of the Public



COLUMBUS AVE. HALF MOON BAY

EXTERIOR MATERIALS/COLORS

Redwood City, CA 94063

t (650) 344-1244 f (650) 344-1241


hrh@hrharchitecture.com

www.hrharchitecture.com



COLUMBUS AVENUE, HALF MOON BAY, CA **EXTERIOR MATERIALS** ROOF: SIDING ASPHALT SHINGLES COLOR: BROWN WOOD FIELD - MOUNTAIN SAGE TRIM - SWEET TEA BY:GLIDDEN PAINT WINDOWS: DOORS: STUCCO SMOOTH FINISH/ INTERGRAL COLOR WHISPERING WILLOW GLIDDEN PAINT ENTRY DOOR: SOLID WOOD GUTTER: **GARAGE** DOOR: SHEET METAL, PAINTED ALUM/GLASS



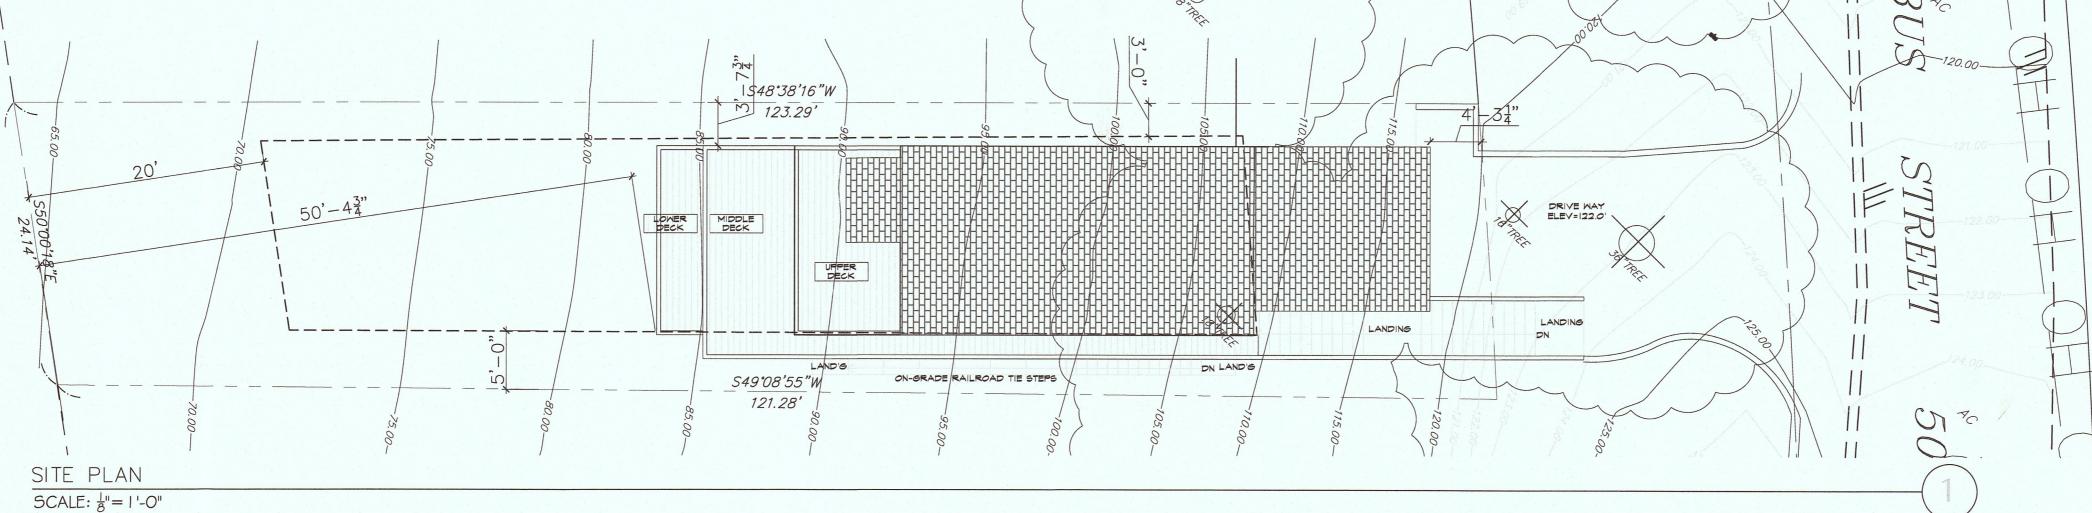

		PROJECT DATA	
	MANUFACTURER		
	JAMES HARDIE	ZONE:	R-1/S-17/DR/CD
	GLIDDEN PAINT	APN:	047-275-060
-	GLIDDEN PAINT	LOT AREA:	2,984 SF
	JELDWEN	PROPOSED LOT COVERAGE:	1,042 SF
	GARAGA	MAX. LOT COVERAGE:	1,044 SF
	OWENS CORNING "Supreme Shingles"	PROPOSED FLOOR AREA:	1,431 SF
1	GLIDDEN PAINT	MAX. FLOOR AREA ALLOWED	1,432 SF

NOTE: ESCAPE OR RESCUE WINDOWS SHALL HAVE A MIN. NET CLEAR OPENABLE AREA OF 5.7 SQUARE FEET, 5.0 SQ. FT. ALLOWED AT GRADE. THE MIN. NET CLEAR OPENABLE HEIGHT DIM. SHALL BE 24" THE CLEAR OPENABLE WIDTH DIM. SHALL BE 20 INCHES. FINISHED SILL HEIGHT SHALL BE NOT MORE THAN 44 INCHES ABOVE THE FINISHED FLOOR.

FINISH COLOR

- MOUNTAIN SAGE

BROWNWOOD

- UNIVERSAL BROWN GARAGA

- WHISPERING WILLOW GLIDDEN PAINT

- SWEET TEA

- SWEET TEA

- MESSA RED

MATERIAL PALETTE FOR COLUMBUS AVENUE, HALF MOON BAY, CA

MATERIAL

HARDIPLANK

WOOD/PAINTED

WOOD/PAINTED

ASPHALT SHINGLES

CEMENT PLASTER

SIDING

FRONT DOOR


WINDOWS/DOORS VINYL

GARAGE DOOR ALUMINUM

TRIM

ROOF

STUCCO

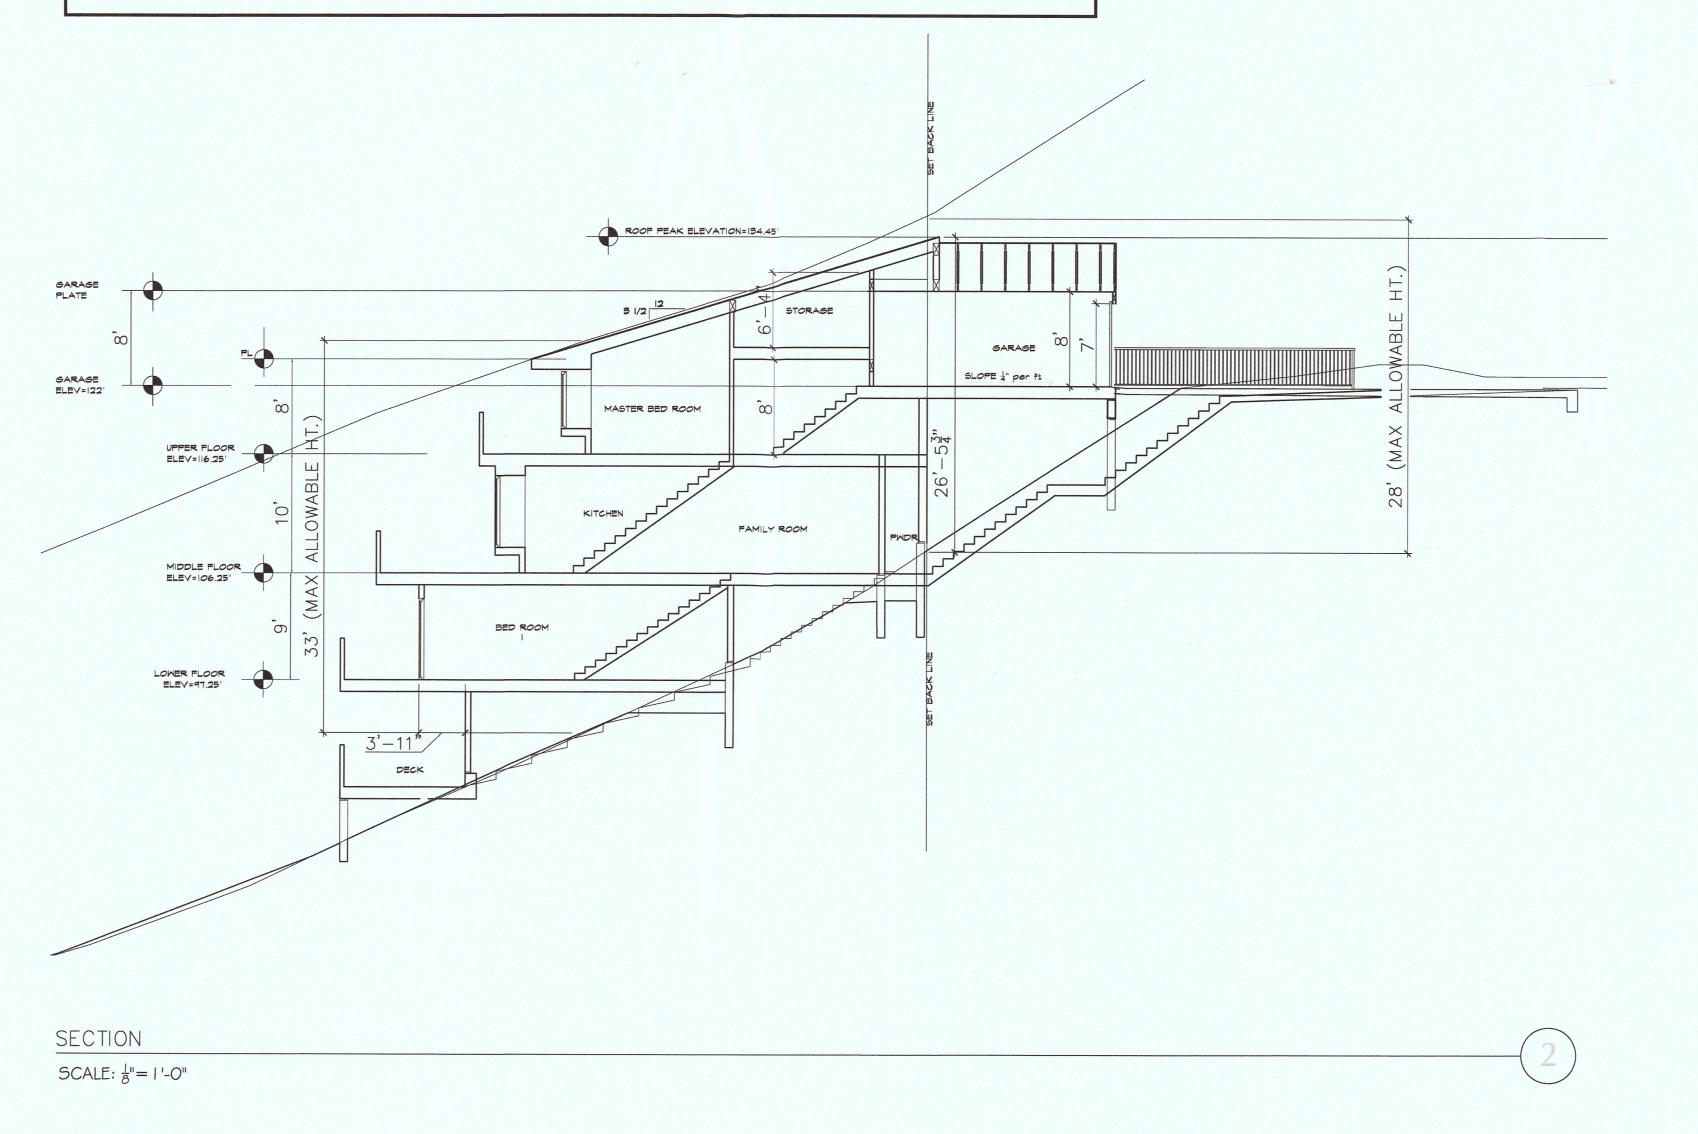

PLN2017-00002

APR 1 2 2017 San Mateo County
Planning and Building Department



Hamid Hekmat, AIA LEED AP

611 Veterans Blvd., #212 Redwood City, CA 94063

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Project

COLUMBUS AVE. HALF MOON BAY

APN: 0470275-060

OWNER:

MS. ERICA ADAMS

Sheet Title

SITE PLAN SECTION

Drawn Date 2-5-2017 Revisions


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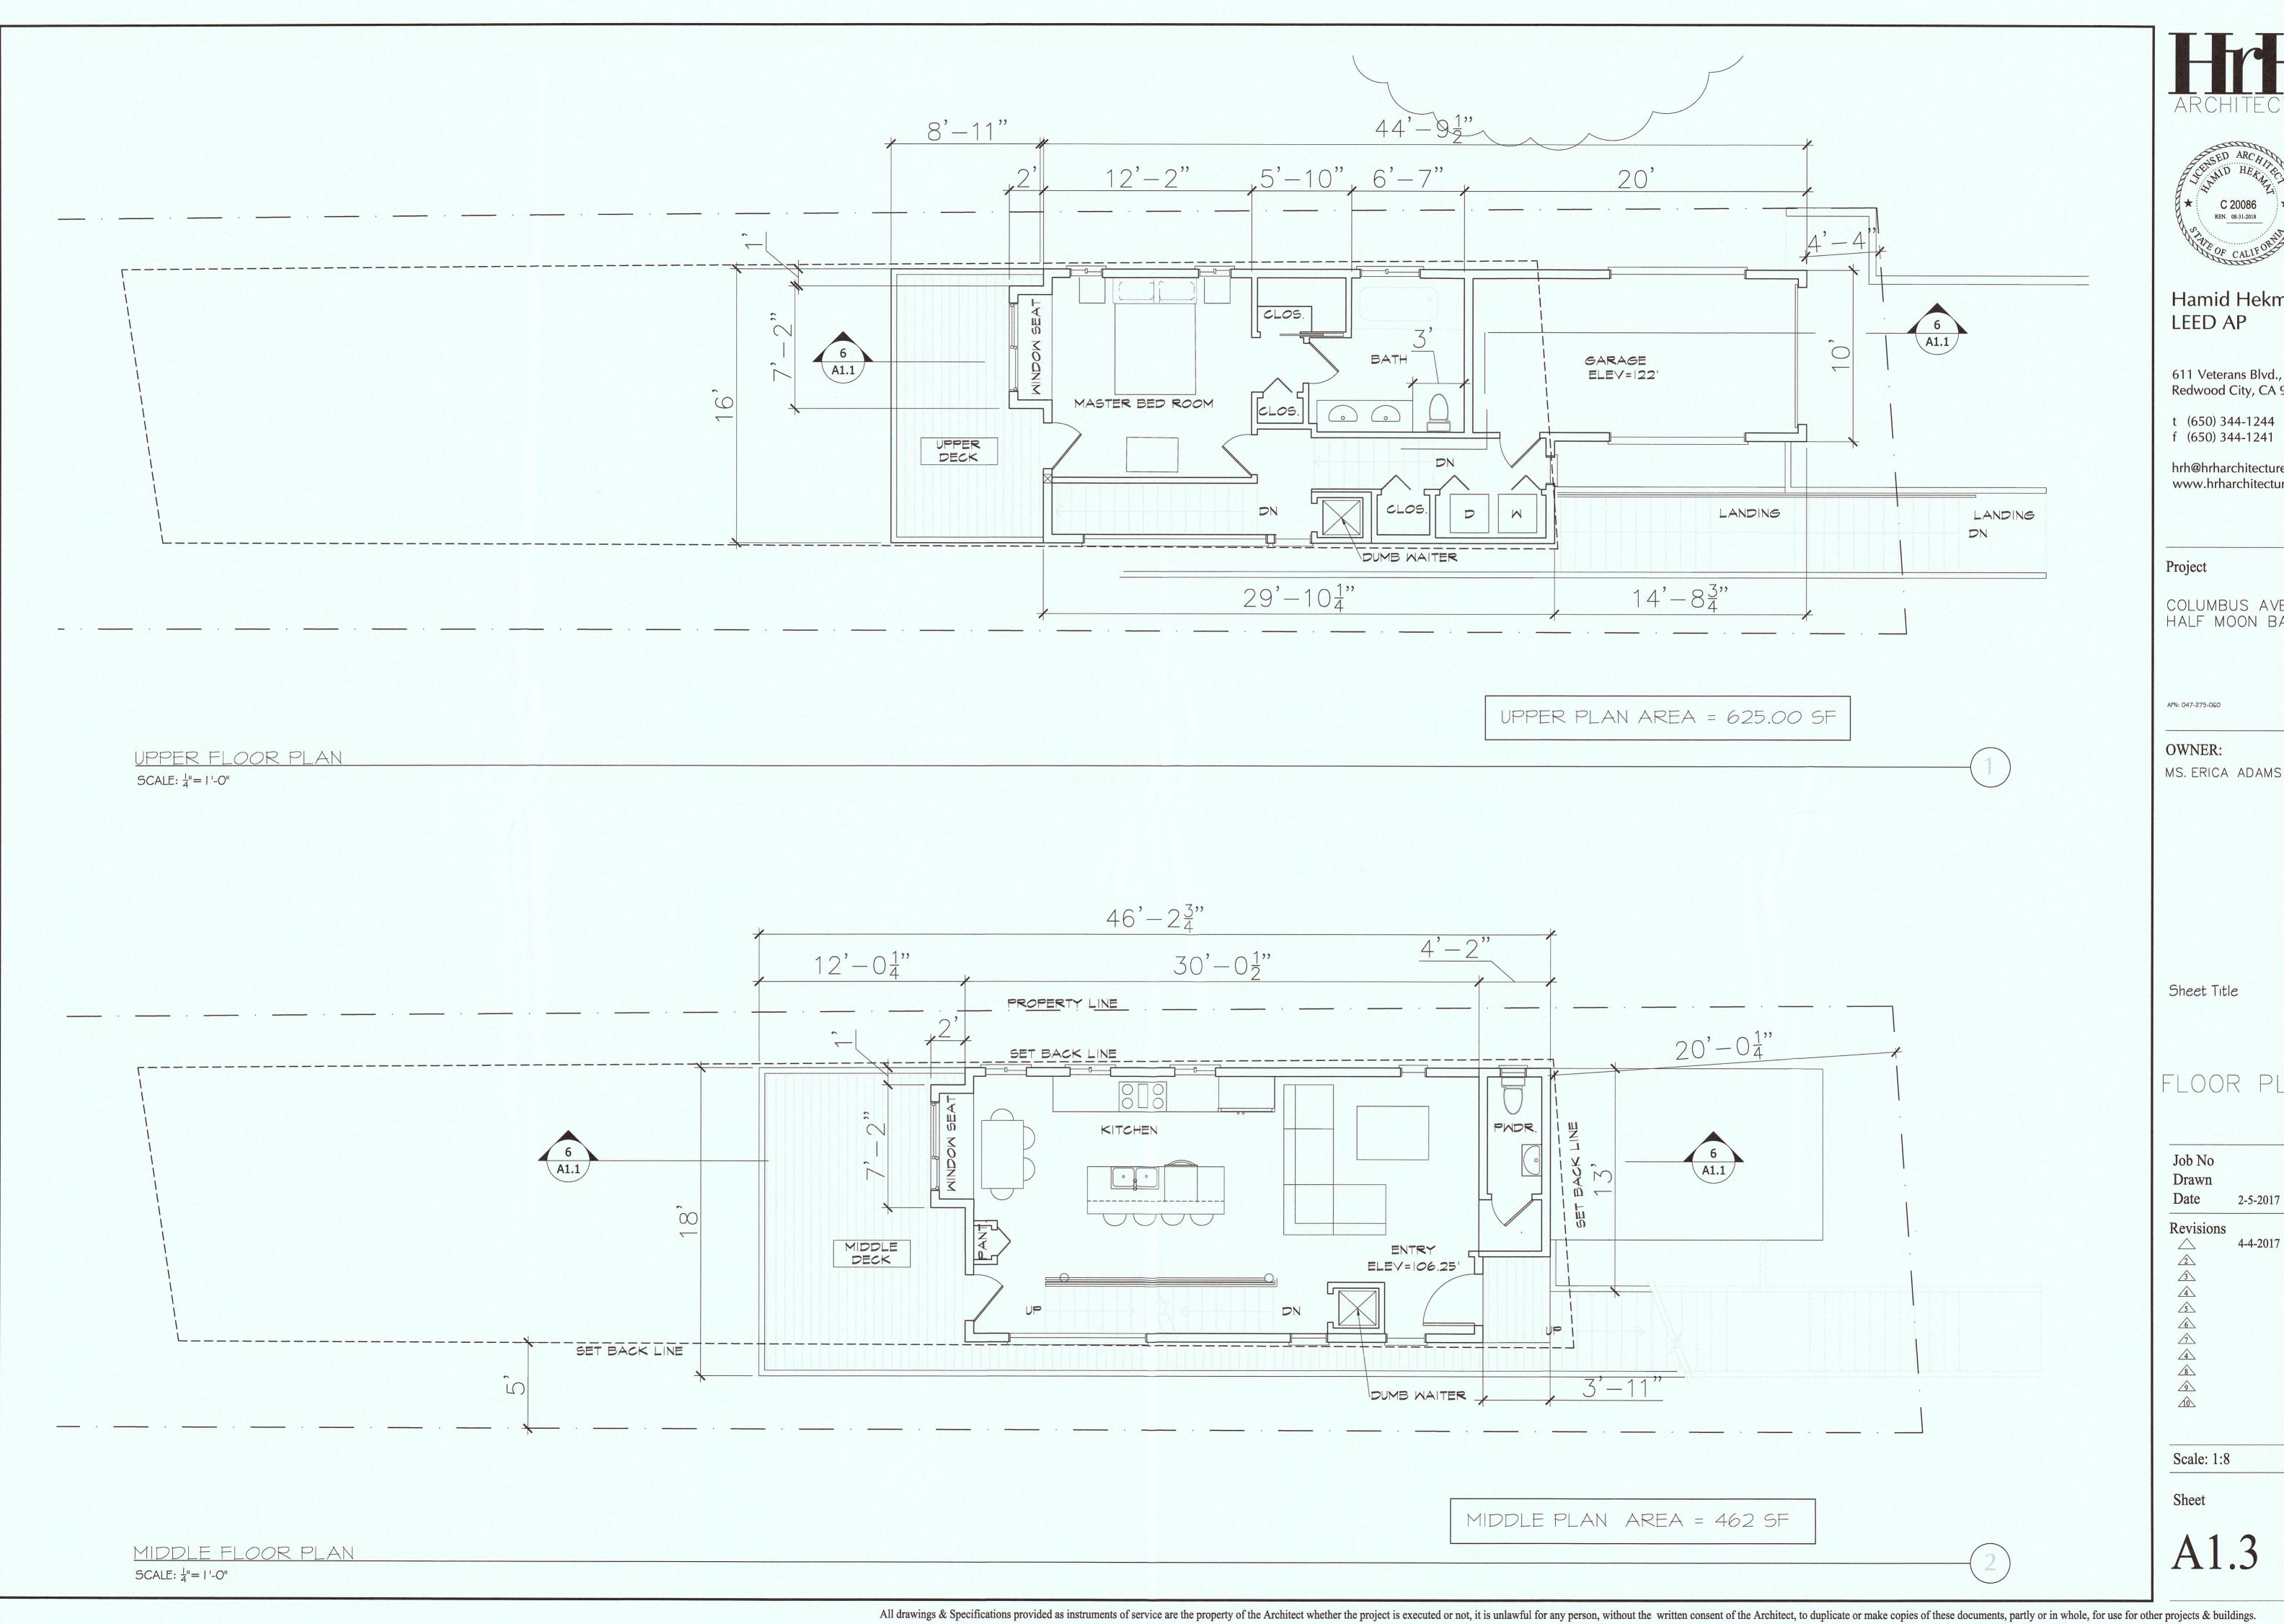
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Sheet







Hamid Hekmat, AIA

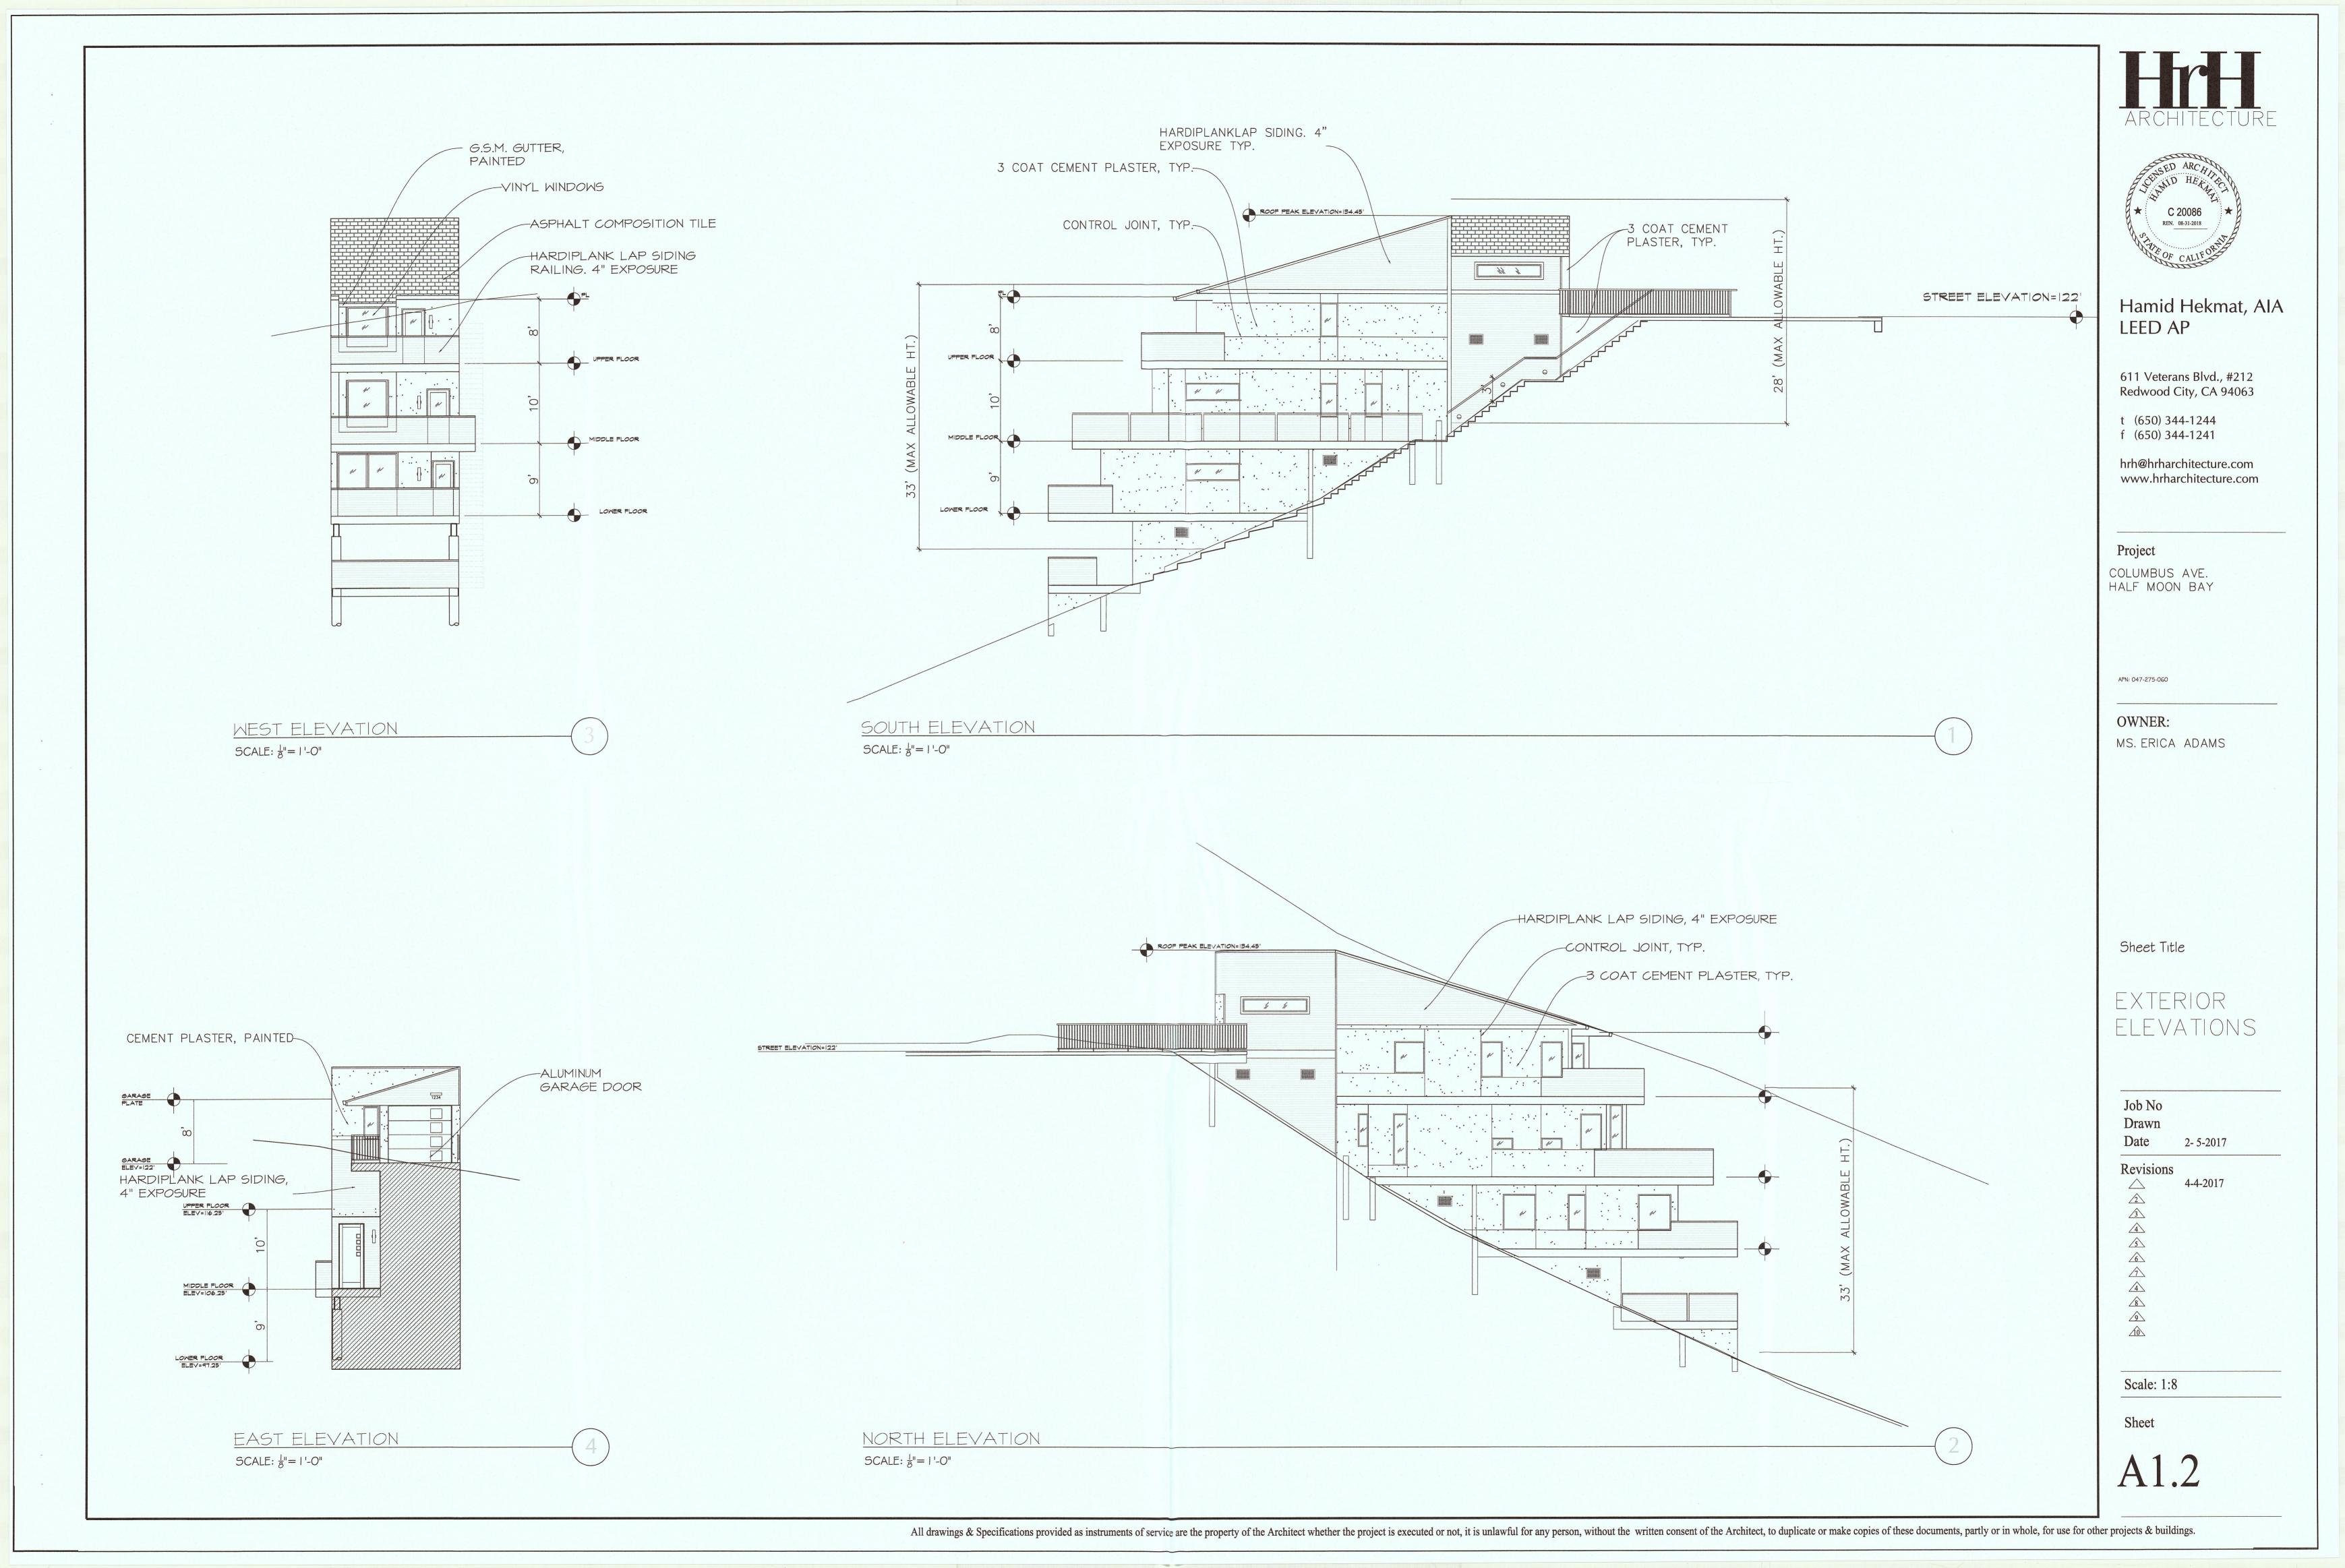
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COLUMBUS AVE. HALF MOON BAY

MS. ERICA ADAMS

FLOOR PLANS



LOWER PLAN AREA = 344 SF

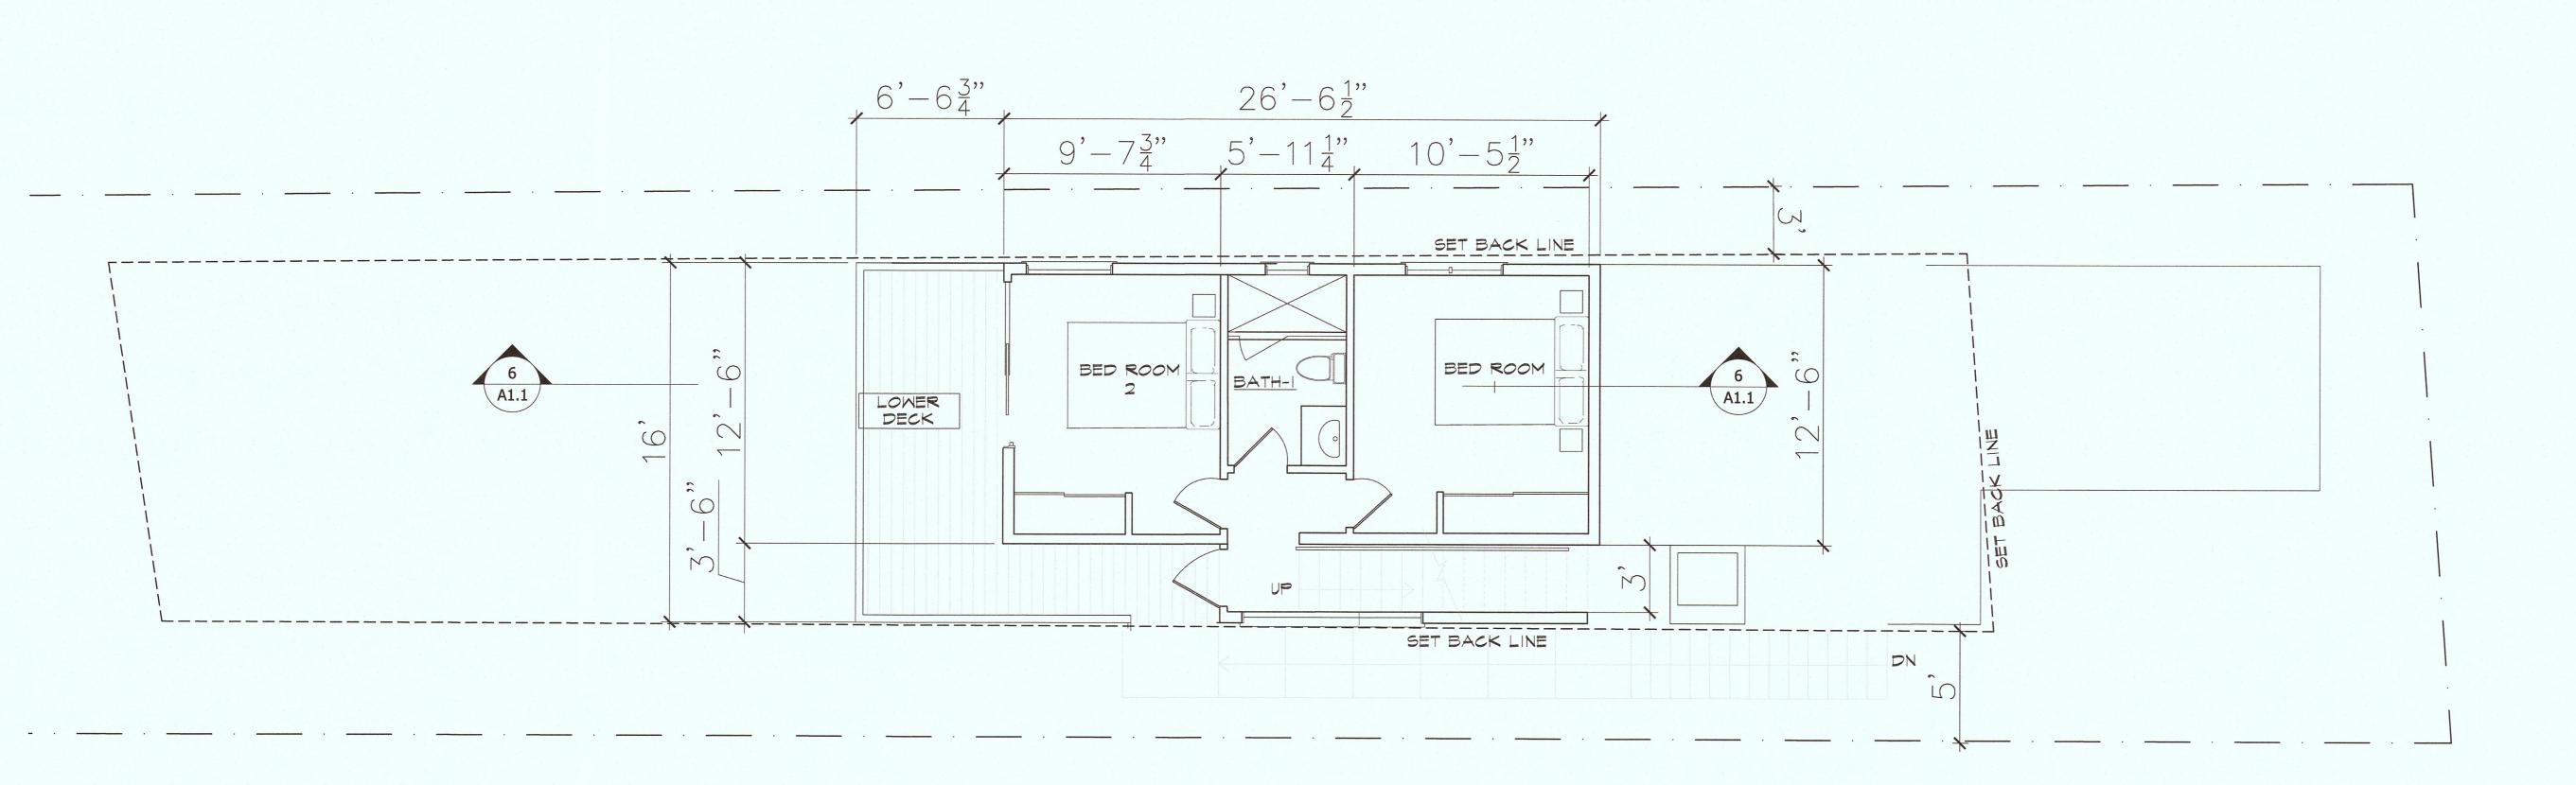LOWER FLOOR PLAN

SCALE: 1'-0"

ARCHITECTURE



Hamid Hekmat, AIA LEED AP

611 Veterans Blvd., #212 Redwood City, CA 94063

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Project

COLUMBUS AVE. HALF MOON BAY

APN: 047-275-060

OWNER:

MS. ERICA ADAMS

Sheet Title

FLOOR PLANS

Job No Drawn Date

te 2-5-2017


Revisions
4-4-2017

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Sheet

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triod/holmes assoc, civil engineering land surveying

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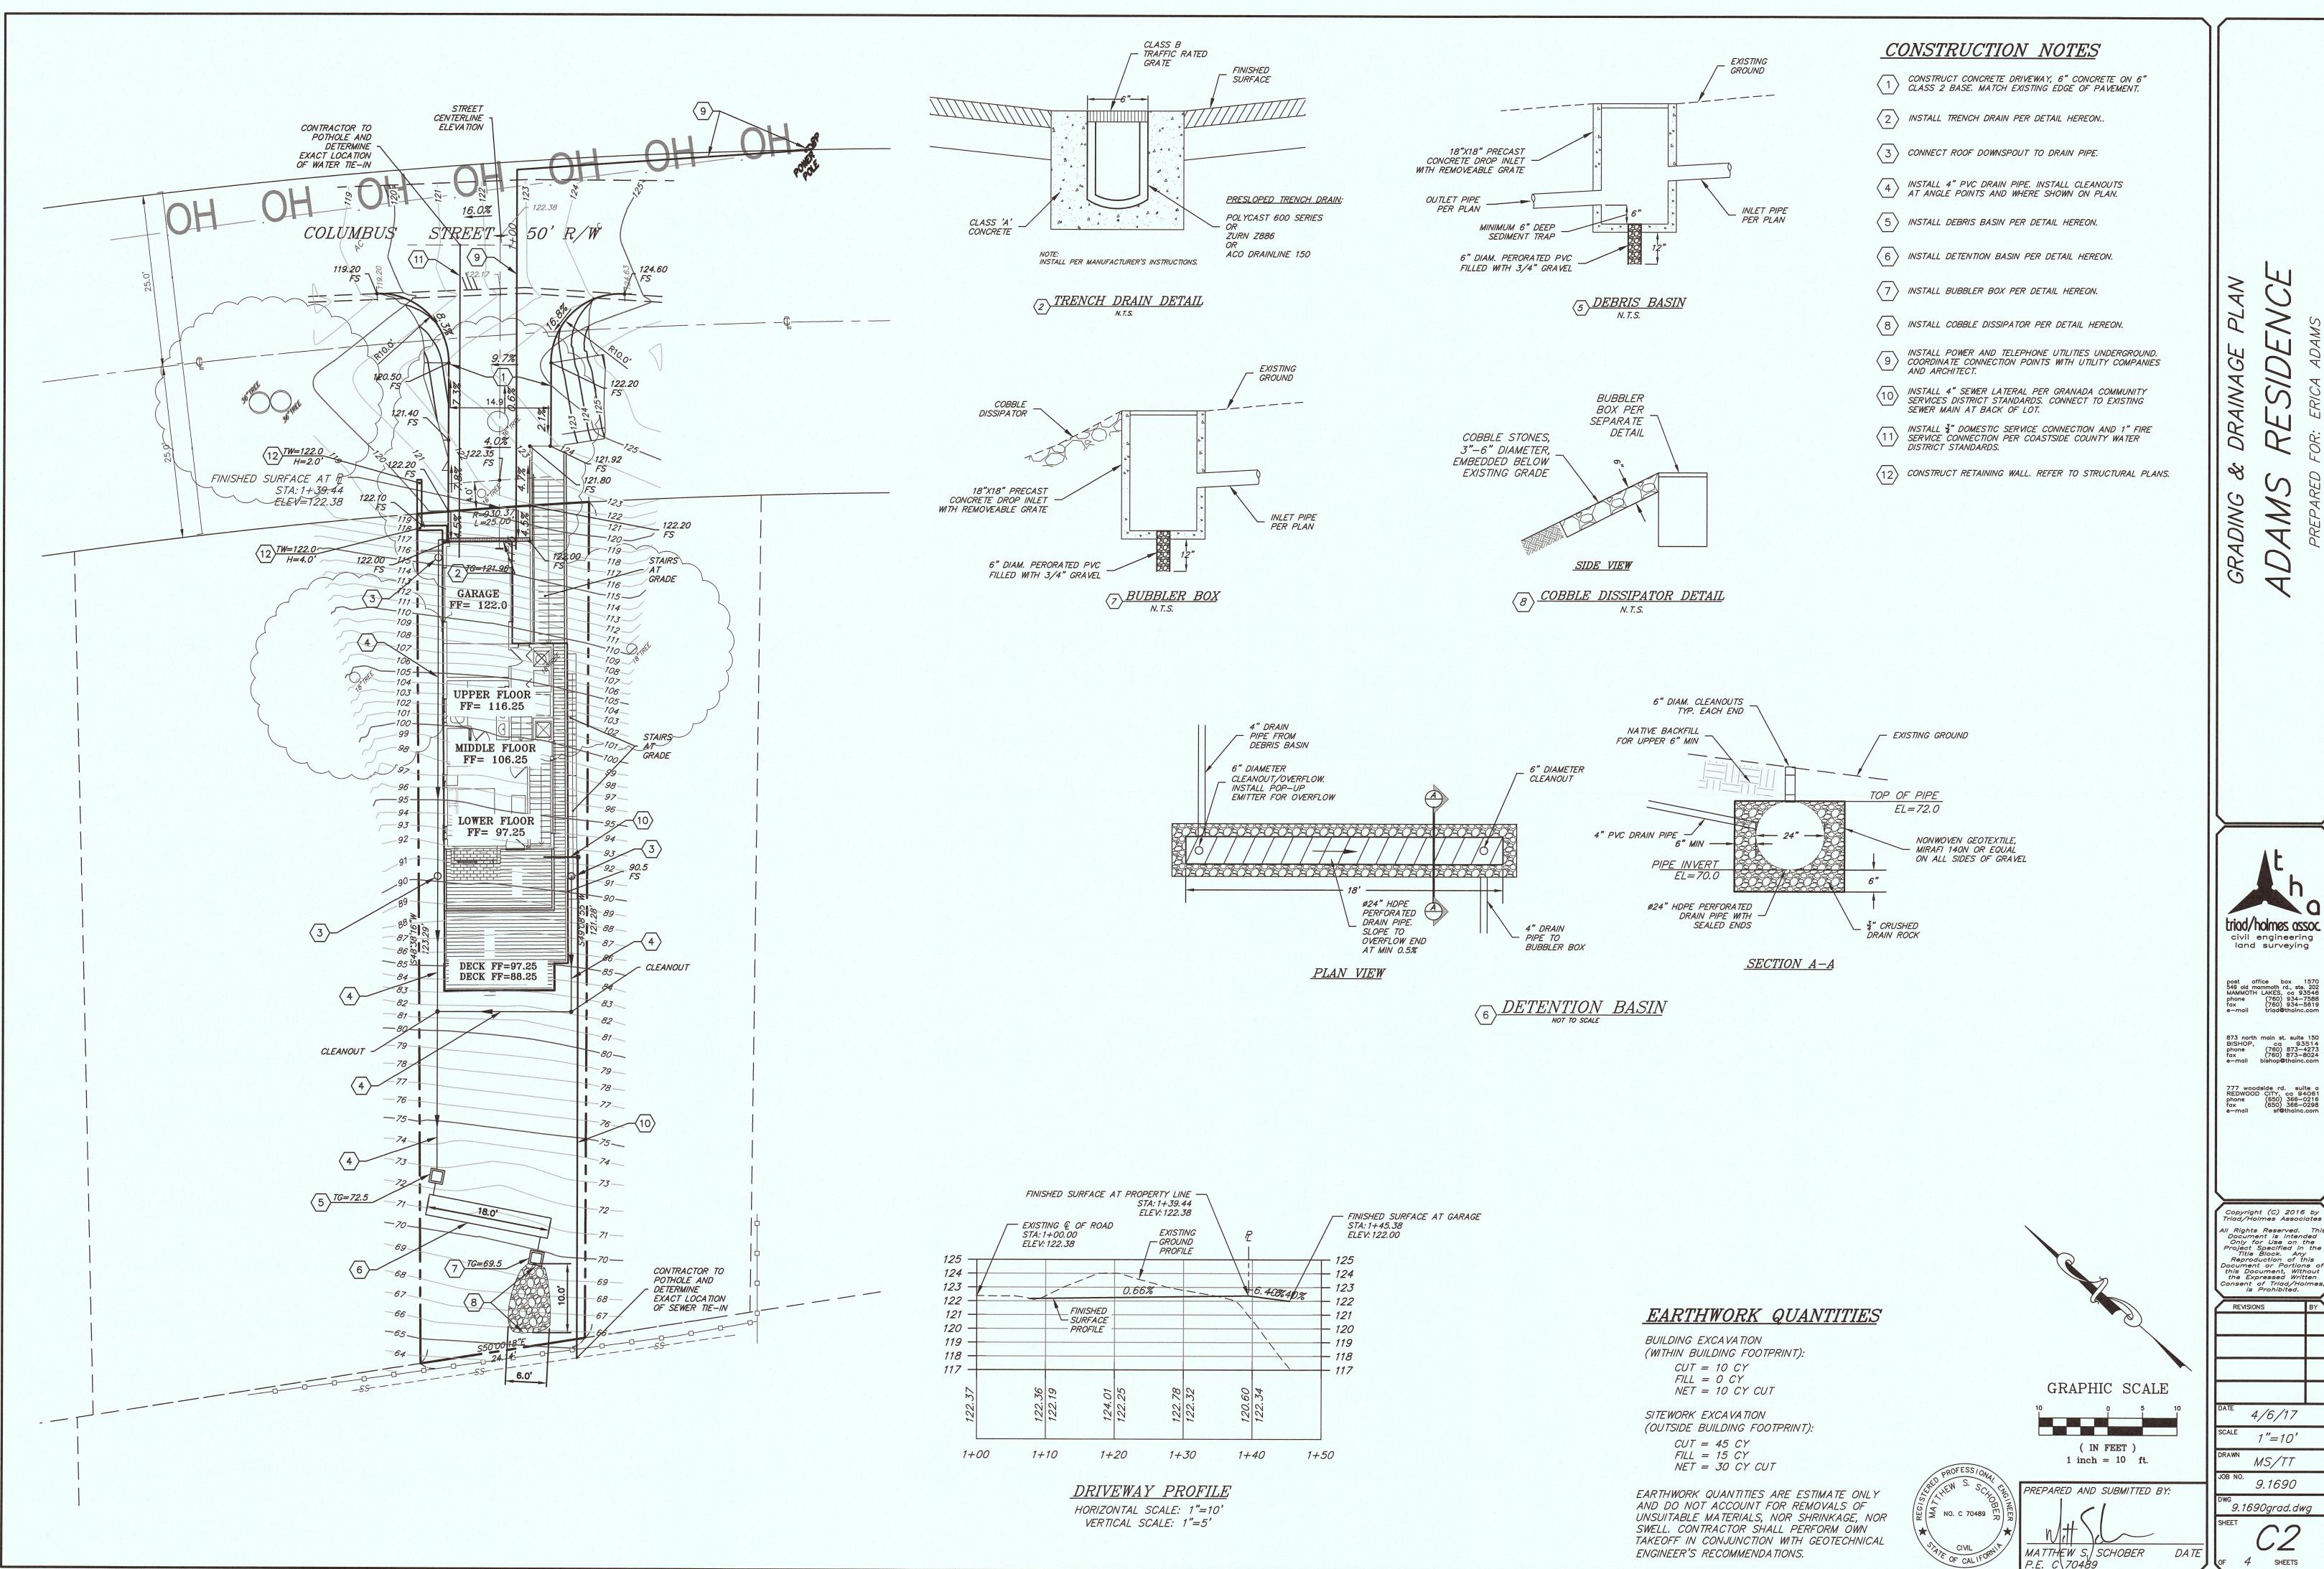
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REVISIONS 7/30/15

1"=10" MN

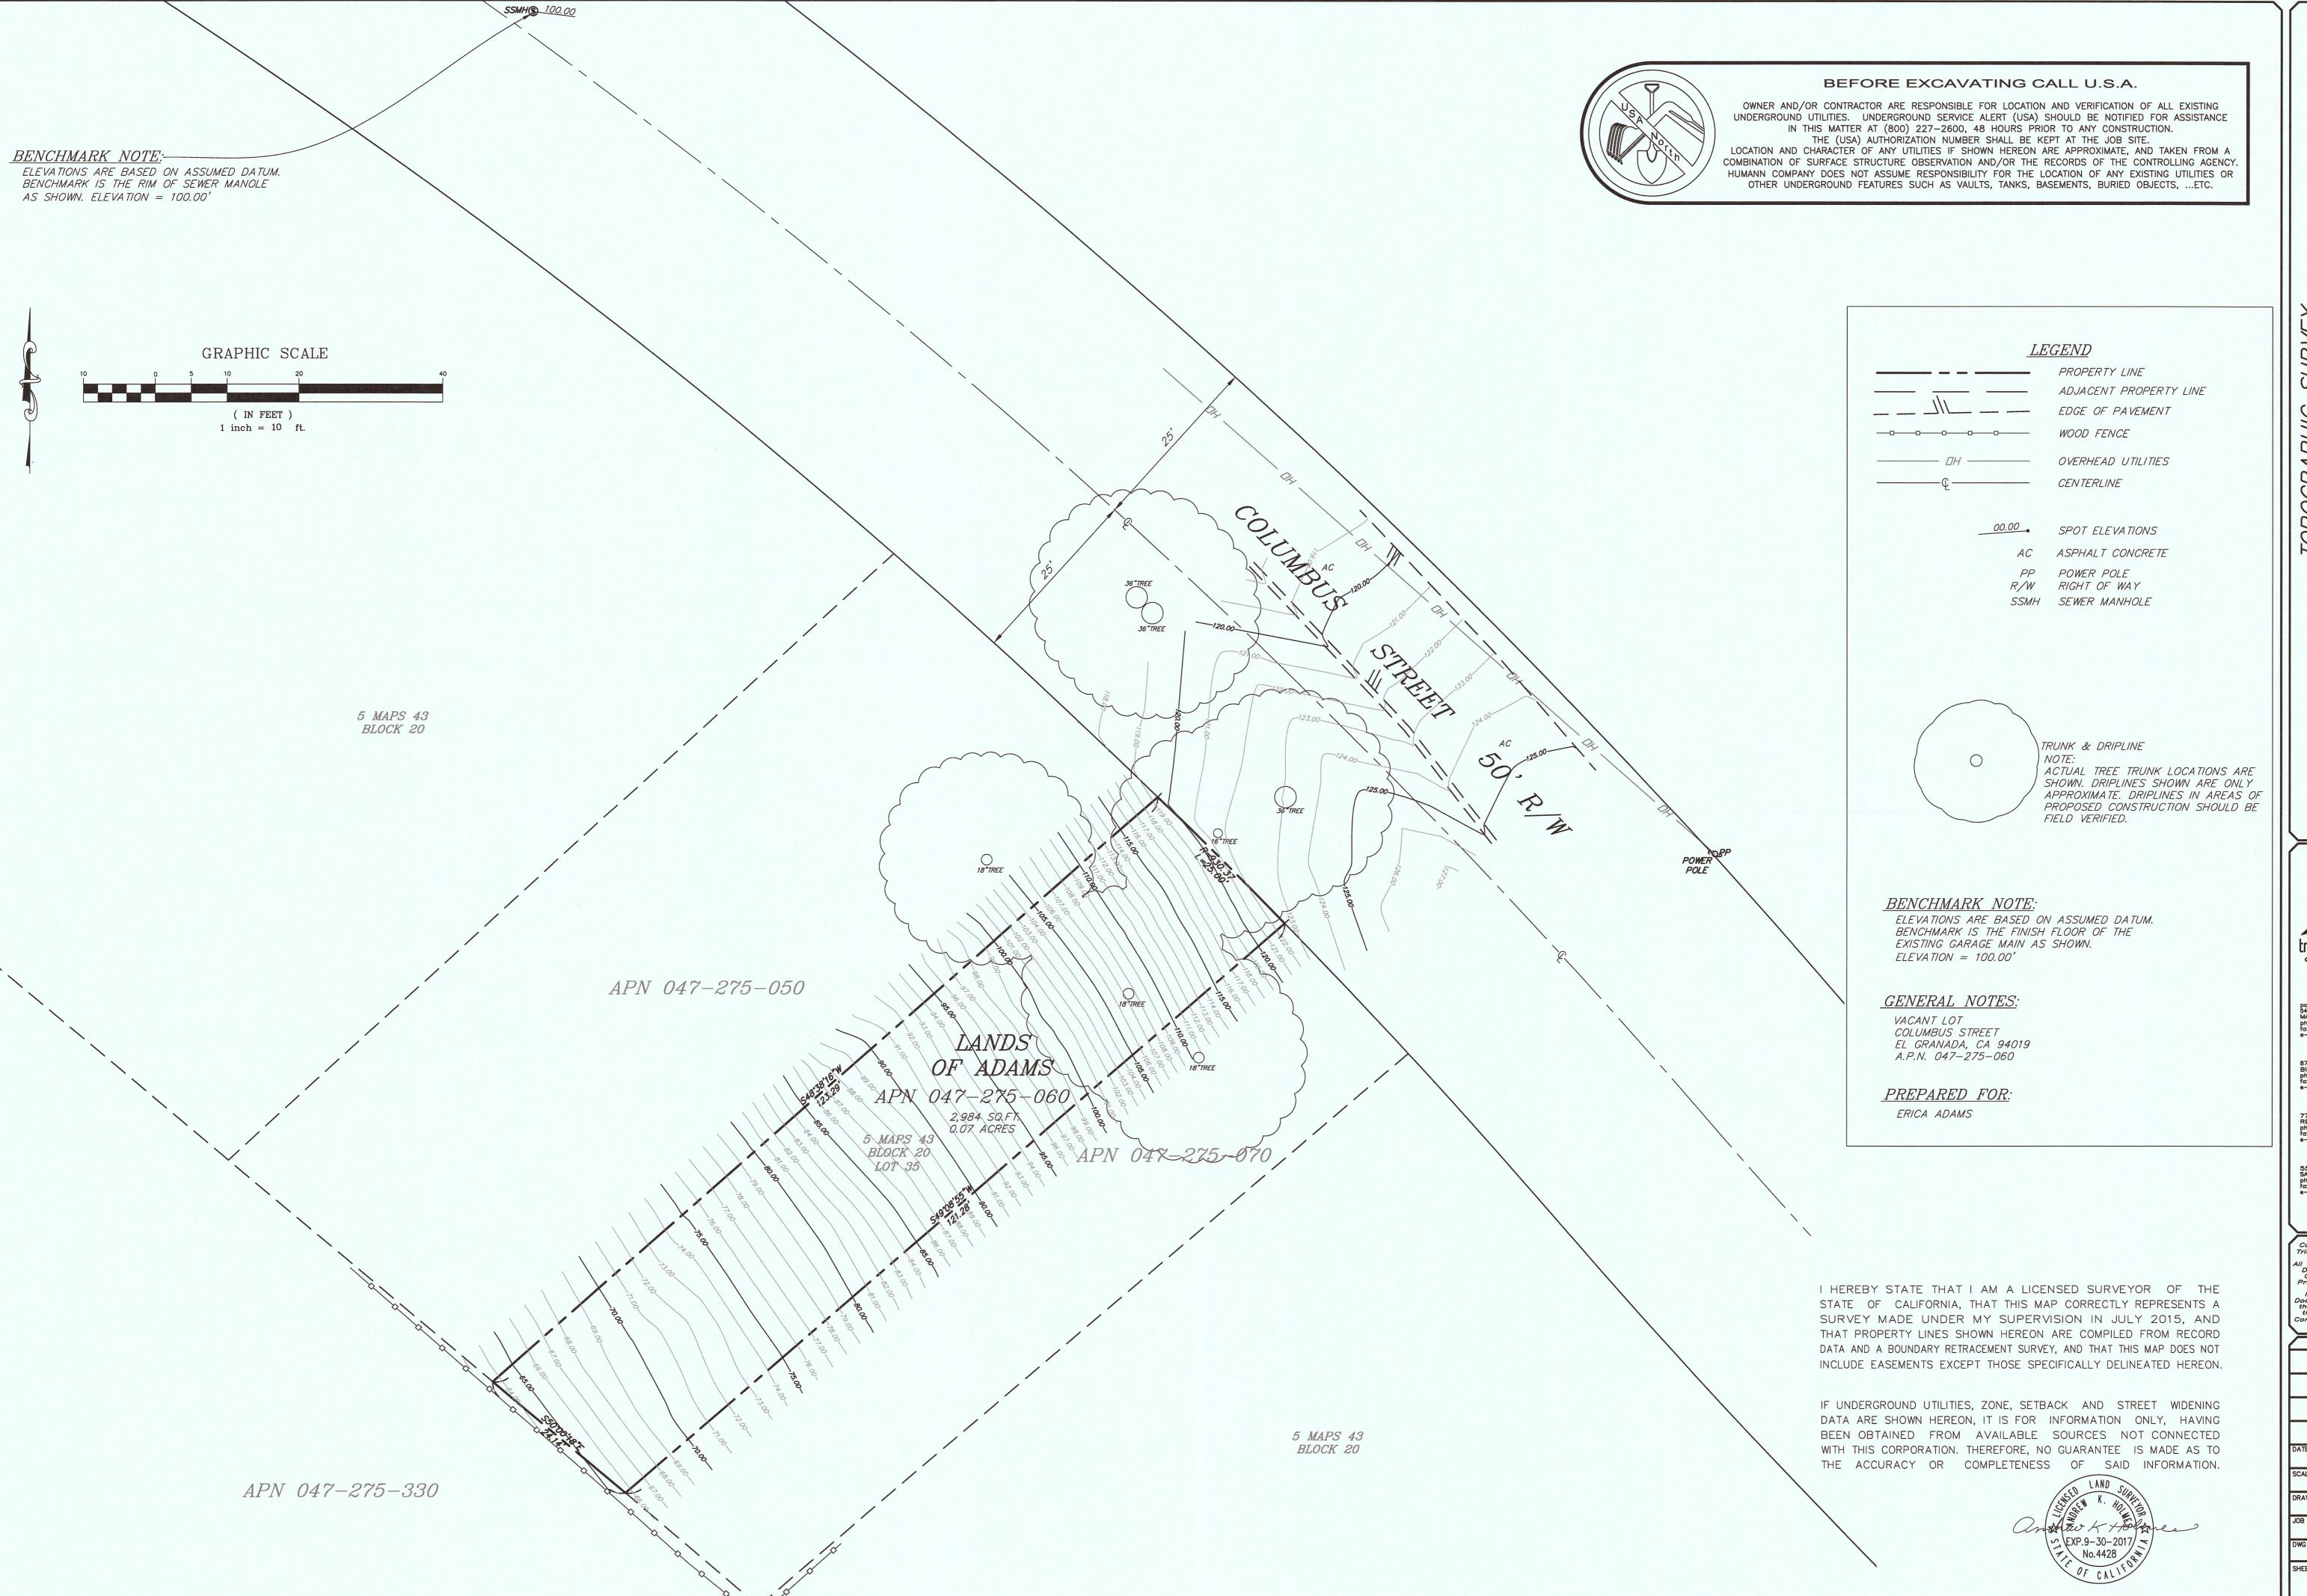09-1690

09-1690TOPO




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4/6/17

1"=10'

MS/TT

9.1690

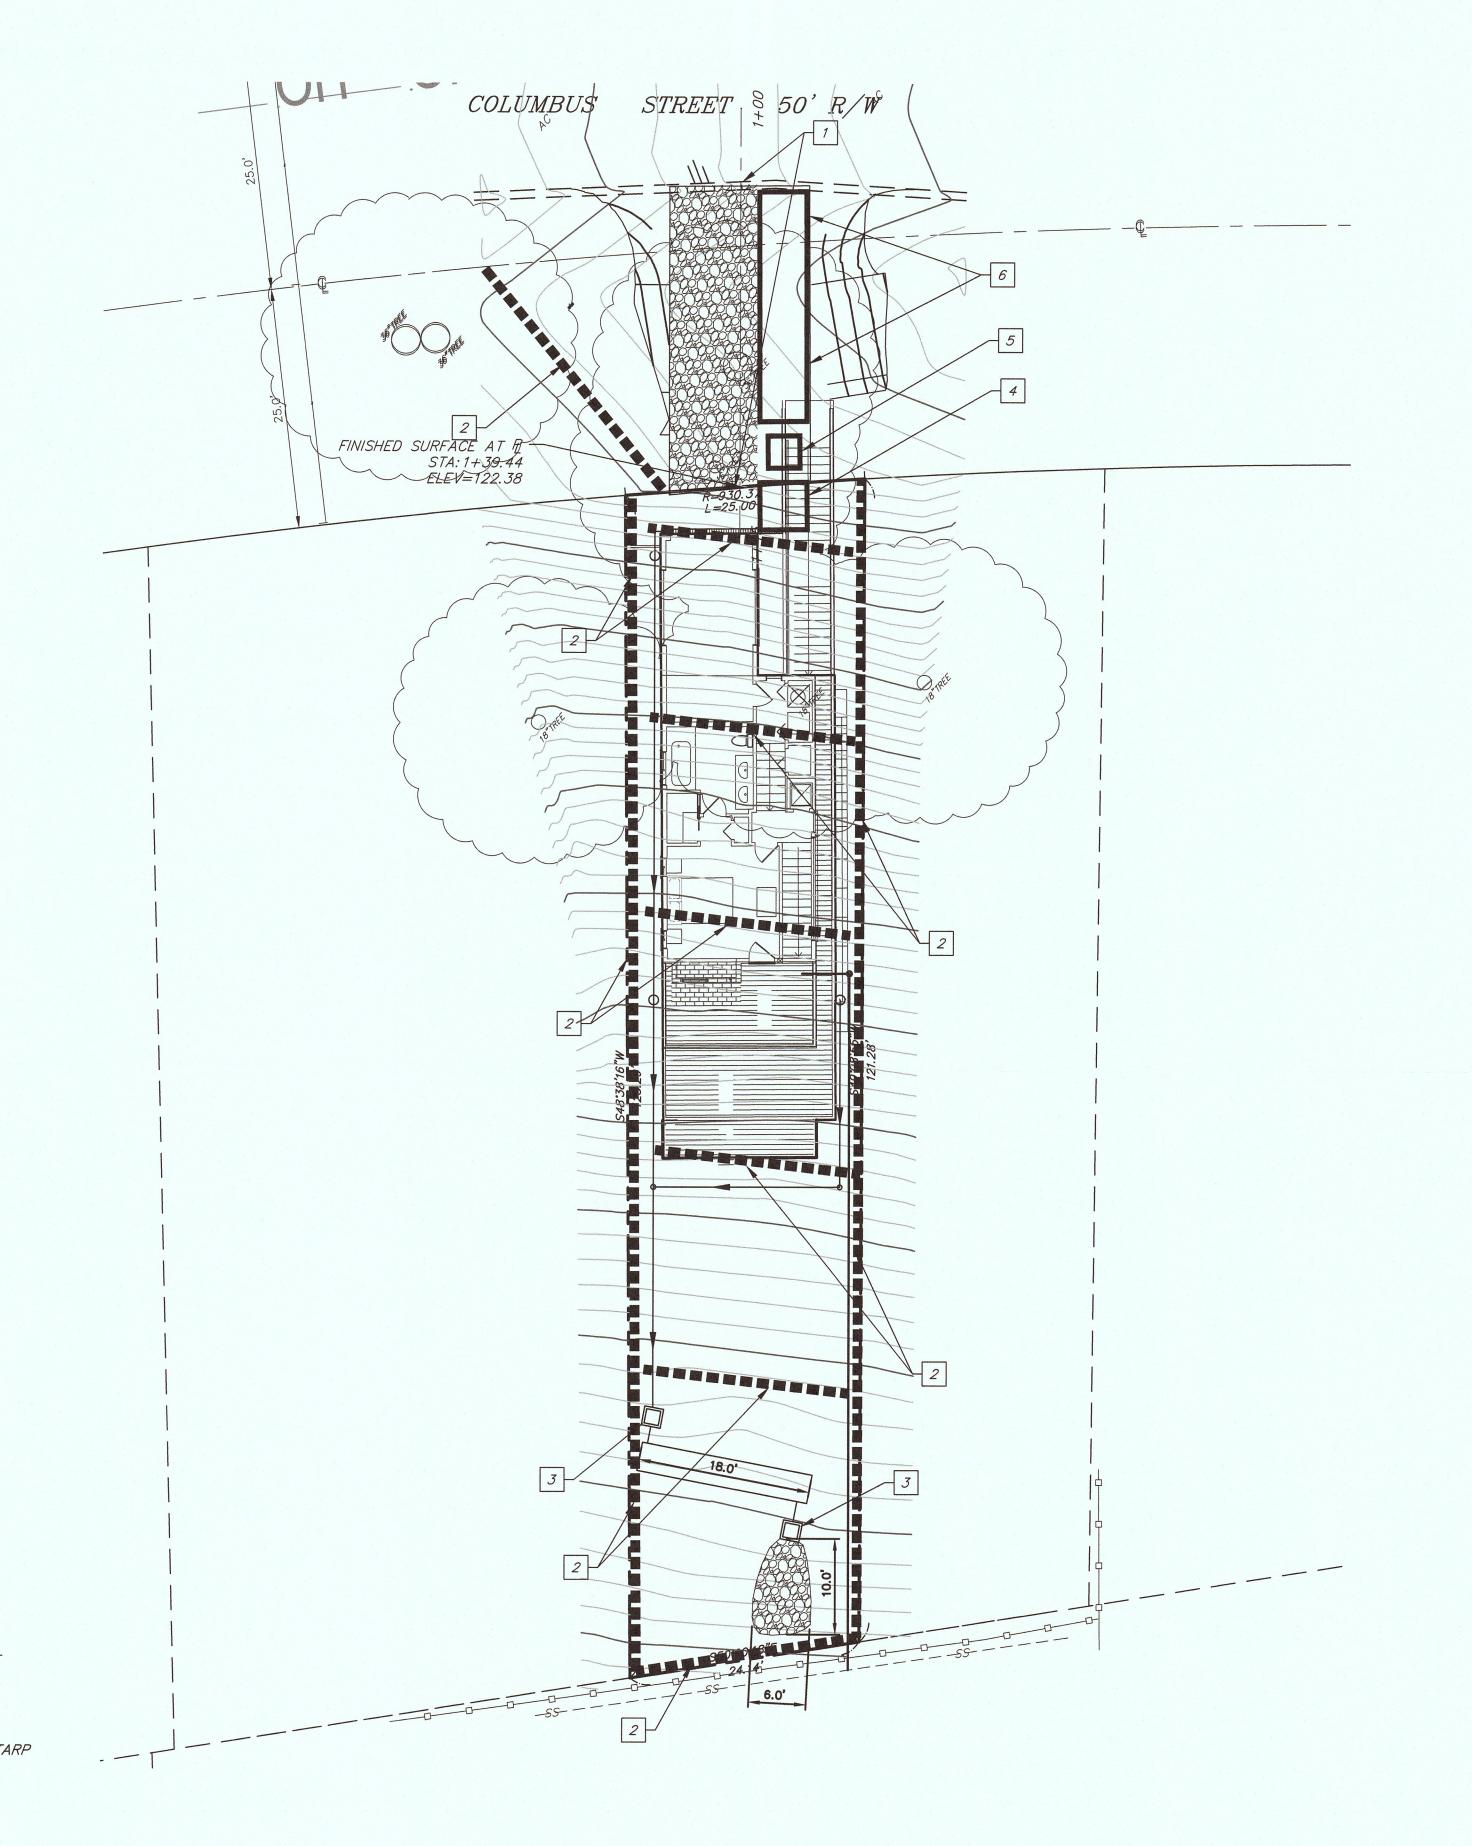

CONSTRUCTION NOTES

1 INSTALL STABILIZED CONSTRUCTION ENTRANCE PER DETAIL HEREON.

2 INSTALL FIBER ROLL PER DETAIL HEREON.

3 INSTALL DROP INLET PROTECTION PER DETAIL HEREON.

4 INSTALL CONCRETE WASHOUT PIT PER DETAIL HEREON.

5 INSTALL PORTABLE TOILET.

6 CONSTRUCTION MATERIAL AND STOCKPILE AREA.

EROSION CONTROL NOTES

1. TEMPORARY EROSION CONTROL FACILITIES SHALL BE IN PLACE PRIOR TO COMMENCING ANY GRADING OPERATIONS.

2. DURING CONSTRUCTION, TEMPORARY EROSION CONTROL MEASURES SUCH AS BERMS, SILT FENCES, FIBER ROLLS, EROSION CONTROL BLANKETS, OR OTHER METHODS SHALL BE INSTALLED AS NECESSARY TO PREVENT DISCHARGE OF EARTHEN MATERIALS FROM THE SITE DURING PERIODS OF PRECIPITATION OR RUNOFF. SIMILAR MEASURES SHALL BE INSTALLED ON OR AROUND ANY SOIL STOCKPILE LOCATED ADJACENT TO PUBLIC ROADWAYS, RESIDENCES, OR BUSINESSES, IN THE VICINITY OF BODIES OF WATER, OR WHEN REMAINING ON-SITE FOR AN EXTENDED PERIOD.

3. CONTRACTOR SHALL TAKE ALL SUCH MEASURES NECESSARY TO RETAIN SOIL AND SEDIMENT ON—SITE AND TO PREVENT TRACKING OF MUD AND DIRT ONTO PUBLIC ROADWAYS.

4. BMP'S SHALL BE MAINTAINED AND OPERATED SUCH THAT THEY REDUCE OR ELIMINATE POLLUTANTS FROM EXITING THE SITE TO THE GREATEST EXTENT POSSIBLE. IF SELECTED BMP'S ARE NOT WORKING AS REQUIRED, THE BMP INSTALLATION MUST BE IMPROVED, OR NEW BMP'S SHALL BE SELECTED.


5. EROSION CONTROL MEASURES SHALL BE IN PLACE THROUGHOUT THE RAINY SEASON BETWEEN OCTOBER 1 AND APRIL 30, AND SHALL BE AVAILABLE ON—SITE IN THE EVENT OF FORECASTED WET WEATHER.

6. THE CONTRACTOR SHALL BE RESPONSIBLE FOR CHECKING AND REPAIRING EROSION CONTROL SYSTEMS AFTER EACH STORM.

> GRAPHIC SCALE

> > (IN FEET)

1 inch = 10 ft.

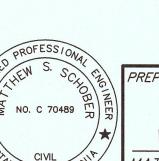

PREPARED AND SUBMITTED BY: MATTHEW S. SCHOBER DATE P.E. C\70489

triad/holmes assoc civil engineering land surveying

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4/6/17

1"=10' MS

9.1690

9.1690grad.dwg

GRAVEL BAGS 3 DROP INLET PROTECTION DETAIL NTS

PLACE LATHE AND SECURE PLASTIC LINING FLAGGING AROUND 3 - WITH SANDBAGS PLACED SIDES OF PERIMETER TO AROUND PERIMETER DELINEATE THE PIT - 5' SQUARE - 10 MIL MIN PLASTIC TARP BOTTOM OF EXCAVATED HOLE SHALL BE FREE OF ROCKS OR DEBRIS THAT MAY DAMAGE LINER

NOTE: ABOVE GRADE WASHOUT MAY BE CONSTRUCTED WITH ENGINEER'S APPROVAL

COARSE AGGREGATE (3/4" TO 2" DIAMETER)

20' = 4:1 OR FLATTER 15' = 4:1 - 2:1

PLACE ROLL OF SLOPE.

10' = 2:1 - STEEPER

FIBER ROLL PLACEMENT

IN SLOPE AREA

- PLACE OVERSIZED PIECE OF

FILTER FABRIC BETWEEN FRAME AND GRATE

INSTALL A FIBER ROLL
NEAR GRADE BREAK
WHERE IT TRANSITIONS
TO A STEEPER SLOPE

PLACE FIBER ROLLS

ON A LEVEL CONTOUR

STABILIZED CONSTRUCTION ENTRANCE

__WOOD_STAKE 1"x2"x23" 3' MAX

SPACING

ENTRENCHMENT DETAIL IN SLOPE AREA

2 FIBER ROLL DETAIL
N.T.S.


GRATE

FIBER ROLL

CONTOUR

KEY TRENCH
2" MIN. TO
4" MAX.

STRAW WATTLE

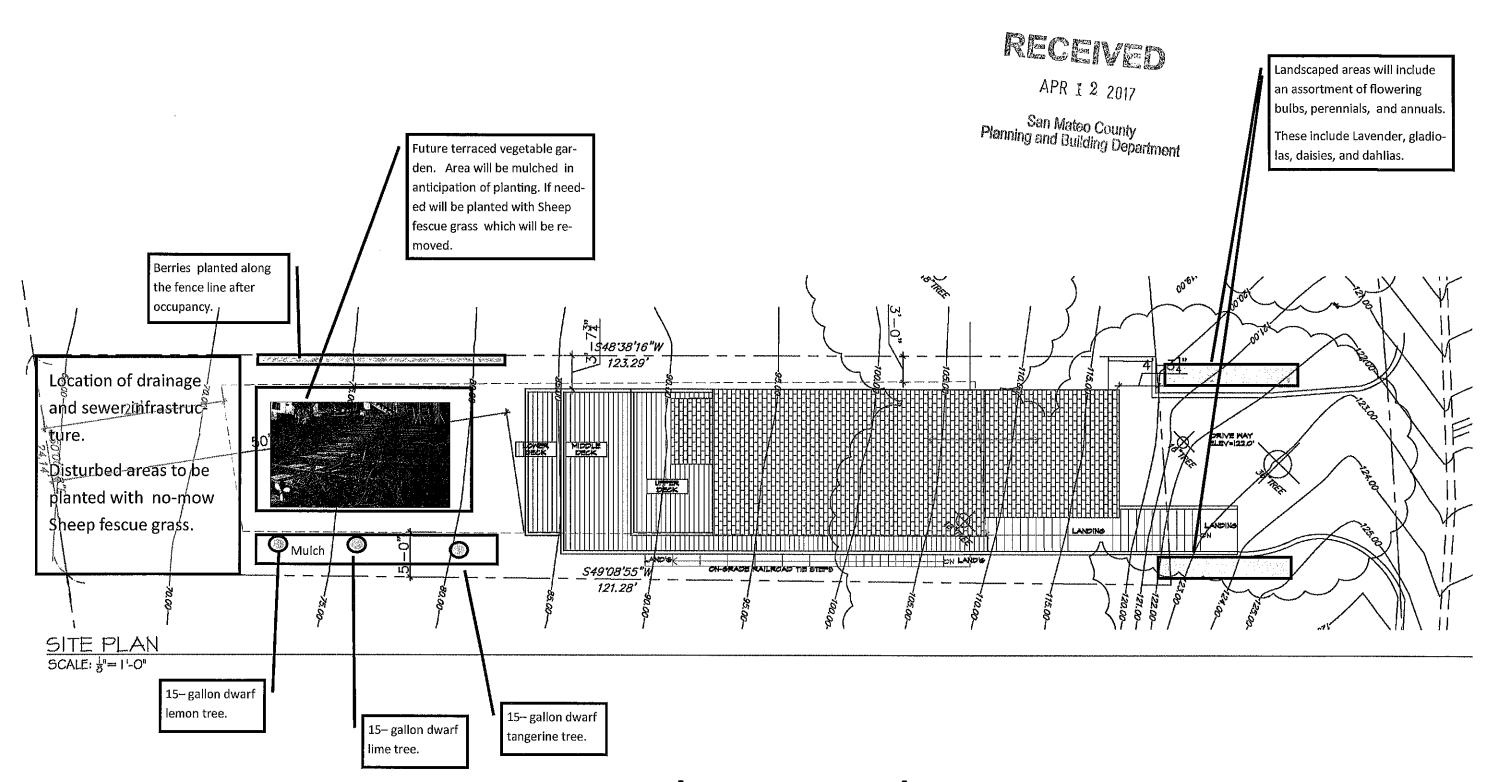

Landscape Plan