Planning Permit Application Form

455 County Center, 2nd Floor • Redwood City CA 94063 Mail Drop: PEN 122 • TEL (650) 363-4161 • FAX (650) 363-4849 www.co.savmateo.caus/planning

PLN: 2016 - 00467 BLD:

Applicant Rocks & SON CONSTRUCTION	(61E6 ROCHA)
Mailing Address: PO Box 1202	(0) The land of the
EL GRANADA, CA 94018	5 Zip: 94018
Phone,# (650) 743 - 080 B	#Office-650-712-8181
E-mail Address: GREG @ ROCHASON, COM	FAX:
Name of Owner (1): EUGENE ! LISA MARSH	Name of Owner (2):
Mailing Address: 147 SOPORA AVENUE	Mailing Address:
ELGRANADA, CA	
zip: 94019	Zip:
Phone,W:	Phone,W:
14:	H
Email Address: EPMARSH59 @ GMAIL - COM	E-mail Address:
Project Location (address):	Assessor's Parcel Numbers:
147 SOMORA AVENUE	047-121-070:
ELGERMAN CA 94019	No. of the contract of the con
Zoning: 4-17	Parcel/lot size: 6,250 SF (Square Feet)
PARTIAL 2ND STORY ADDITION TO IN	Cation, primary and accessory structures, well septic, tank! SCLUDE (N) FAMILY ROOM, & MASTER EPRODM & LAUNDILY. NO SITE WORK
PARTIAL 21-D STORY ADDITION TO 10 SUITE, AND PRINCE APPOPULATION OF (e) BI	OCLUDE (N) FAMILY ROOM, EMASTER
PARTIAL 21-D STORY APPITION TO IT SUITE, AND PELOCATION OF (e) BI 13 PROPOSED.	EPRODY & LAUNDRY NO SITE WORK
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Application for Design Review by the **County Coastside Design Review Committee**

FAMILY HOME

□ Variance

	Application for			
	Design Review by the	County Government Center # 455 County Center # Redwood City CA 94063 Mail Drop PLN 122 # 650 - 363 - 4161 # FAX 650 - 363 - 4849		
	County Coastside Design	Permit #: PLN 2016 - 00467		
	Review Committee	Other Permit #:		
	Applicant:	Owner (if different from Applicant):		
	Name: BOCKA SON CONSTRUCTION			
	Address: PO BOX 1202	Address: 147 901-024 AUGNUE		
	ELGRAPADA, CA Zip: 94018	EL GRANADA, CA ZID: 94019		
Cell	Phone, # (650) 743-0808 N. office 650-712-81811	Phone,W: H:		
	Email: GREG @ POCHASON. COM	Email: EPMAPSH 59 @ GMAIL. COM		
	Architect or Designer (if different from Applicant):			
	Name: BRINKMAN			
	Address: 648 NAVARRE DRIVE PACIFICA	, CA Zip: 94044		
		EMAIL: BRINKMAN DESIGNE GMAIL. COM		
	Project location:	Site Description:		
	APN: 047-121-070	☐ Vacant Parcel		
	Address: 147 SONORA AVENUE	र्छः Existing Development (Please describe):		
	Zip: 94019	EXISTING 1,224 SF SINGLE STORY HOME		
	Zoning: \(\frac{15-17}{D} \) Parcel/lot size: \(\frac{15-17}{D} \) sq. ft.	W/ 2-CAR ATTACHED GARACE		
	Project:	Additional Permits Required:		
	New Single Family Residence: sq. ft	☐ Certificate of Compliance Type A or Type B		
	Addition to Residence: 98° sq. ft	☐ Coastal Development Permit		
	Other:	 Fence Height Exception (not permitted on coast) 		
		☐ Grading Permit or Exemption		
	Describe Project:	☐ Home Improvement Exception ☐ Nori-Conforming Use Permit		
	PARTIAL 2ND STORY APPITION TO EXISTING SINGLE STORY, SINGLE			
	EXISTING SINGLE STORY, SINGLE	☐ Off-Street Parking Exception 1 2016		

San Mateo County Planning and Building Department

Fill in Blanks:	Material	Color/Finish	Check if matches existing
		(If different from existing, attach sample)	
a. Exterior walls	HARDIEPLANK LAR/HARDIESHINGLE	BERT. MOGRE (W-665 POWELLGE	26410
b. Trim	REDWOOD	BENT MOORE OC 123 BANGHAN C	TEAM []
c. Windows	MILGARD VINYL	WHITE	П
d. Doors	FIBERALASS	BENT- MOORE AF 295 POINTE GRANT	τ ε " 🖸
e, Roof	ASPHALT COMP. SHINGLES	GLATE (FRONT BOOK	<i>-</i>)
f. Chlmneys	HARRIE PLANT LAP	BENT- HUBBLE CU GIS POWELL GRE	۲' p
g. Decks & railings	بالم		
h. Stairs	r/rx		
I. Retaining walls	v/n		
J. Fences	TED WOOD		\B
k. Accessory buildings	N/A		Ō
I. Garage/Carport	GAME AS HOUSE	-	a
including the required fir applicable to the location	on, the County must determine that this projectings that the project does conform to the of the project pursuant to Section 6565.10	standards and guidelines for design re	view
	nt's Statement of project compliance with st	andards and guidelines (check if attach	ied).
		White the control of	of the second se
support of the application	aformation stated above and on forms, plans in is true and correct to the best of my knowl assigned project planner of any changes to in	edge. It is my responsibility to inform t	he County of
Owner:	Applicant	211	***************************************
(0/6/2016 Date:	Date:	10-25-16	***************************************

Date:

COL			

Environme	ntal	Information
Disclosure	Fori	m

PLN 2016-00467	er .
BLD _{econd-lander-to-lander}	

		E	RLD
^o roject ,	Address	S: 147 SONORA AVENUE	Name of Owner: EUGENE & LISA MARSH
		ELGRANDA, CA 94019	Address: 149 SONORA AUENUE
			Phone:
\ssessc	or's Parc	sel No.: 047 - 121 - 670	Name of Applicant: POCHA & SON CONSTRUCTION (GHE PO
			Address: PO BEX 1202 EL GRAVADA, CA 94
⁷ onina I	District:	6.17	(50-712-818) Phone: (656) 743 - 0808
	(Calabata Statement Ver State		\$60 114 6147
- 71F	ille	Site Conditions	
		6,250 SF	
urpose	of any e	easements on the parcel, and a description of	uses on the project parcel, including the existence and any natural features on the project parcel (i.e. steep terrain, באד (אףף בסא י בייס סטפואטב בעניט ארניט איניט א
WITH	QUA	EXISTING 1,224 SF HOME AND A	TTACHED 393 SF GAPAGE OCCUPYING IT.
		APE USE WELL SITS APPROX	
13177		ental Review Checklist	
1. Cal	ifornia	Environmental Quality Act (CEQA)	Review RCCENTED
Yes	No	Will this project involve:	NOV
X	envan	a. Addition to an existing structure > 50% of	of the existing area OR > 2,500 sq. ft 2016
	b. Construction of a new multi-family residential structure beging 50 mm/m units?		
		c. Construction of a commercial structure :	> 2,500 sq.ft? County > Emerald Lake Hills area or ≥ 12° d.b.h. in any
	No.	 d. Removal of mature tree(s) (≥ 6" d.b.h. in residential zoning district)? If yes, how many trees to be removed? 	n Emerald Lake Hills area or ≥ 12° d.b.h. in any 11€
	X	e. Land clearing or grading? If yes, please state amount in cubic yard Excavation: c.y.	ds (c.y.): Fill: c.y.
	_🔟	t. Subdivision of land into 5 or more parcel	· · · · · · · · · · · · · · · · · · ·
	<u> </u>	g. Construction within a State or County so	enic corridor?
- Chancelor		h. Construction within a sensitive habitat?	
	X	i. Construction within a hazard area (i.e. se	· · · · · · · · · · · · · · · · · · ·
	_12	j. Construction on a hazardous waste site	(check with Co. Env. Health Division)?
	-	all "Yes" answers:	
THE	- P120	POSED 2ND STORY IS APPRO	X. 80% OF THE FLOOR AREA
OF	THE	EXISTING HOME	
******** Advisor West amount			

95	No	Marine Fisheries Rule 4(d) Review Will the project involve:
1	18	a. Construction outside of the footprint of an existing, legal structure?
	N N	b. Exterior construction within 100-feet of a stream?
- Amazonti	15	c. Construction, maintenance or use of a road, bridge, or trail on a stream bank or unstable hill stope?
-	17	d. Land-use within a riparian area?
- Aller	R	e. Timber harvesting, mining, grazing or grading?
		f. Any work inside of a stream, riparian corridor, or shoreline?
1		g. Release or capture of fish or commerce dealing with fish?
	e explain	any "Yes" answers:

S	No	Will the project involve:
·, ···· •· , ,		
		a. A subdivision or Commercial / Industrial Development that will result in the addition or replacement
The state of		A subdivision or Commercial / Industrial Development that will result in the addition or replacement 10,600 sq. ft. or more of impervious surface? If we Property Owner may be required to implement appropriate source control and site design.
The same of the sa		A subdivision or Commercial / Industrial Development that will result in the addition or replacement 10,000 sq. ft, or more of impervious surface? If yes, Property Owner may be required to implement appropriate source control and site design measures and to design and implement stormwater treatment measures, to reduce the discharge stormwater pollutants. Please consult the Current Planning Section for necessary forms and both construction and post-construction requirements.
The state of the s		10,000 sq. ft. or more of impervious surface? If yes, Property Owner may be required to implement appropriate source control and site design measures and to design and implement stormwater treatment measures, to reduce the discharge stormwater pollutants. Please consult the Current Planning Section for necessary forms and both
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reb rma rma	y certify ation red	If yes, Property Owner may be required to implement appropriate source control and site design measures and to design and implement stormwater treatment measures, to reduce the discharge stormwater pollutants. Please consult the Current Planning Section for necessary forms and both construction and post-construction requirements. b. Land disturbance of 1 acre or more of area? If yes, Property Owner must file a Notice of Intent (NOI) to be covered under the statewide General Construction Activities Storm Water Permit (General Permit) prior to the commencement of construction activity. Proof of coverage under State permit must be demonstrated prior to the issuance of a building permit. That the statements furnished above and in the attached exhibits present the data acquired for this initial evaluation to the best of my ability, and the facts, statements and esented are true and correct to the best of my knowledge and belief. If any of the
ereb erma	y certify ation red	If yes, Property Owner may be required to implement appropriate source control and site design measures and to design and implement stormwater treatment measures, to reduce the discharge stormwater pollutants. Please consult the Current Planning Section for necessary forms and both construction and post-construction requirements. b. Land disturbance of 1 acre or more of area? If yes, Property Owner must file a Notice of Intent (NOI) to be covered under the statewide General Construction Activities Storm Water Permit (General Permit) prior to the commencement of construction activity. Proof of coverage under State permit must be demonstrated prior to the issuance of a building permit. If that the statements furnished above and in the attached exhibits present the data acquired for this initial evaluation to the best of my ability, and the facts, statements and
reb rma rma	y certify tion red tion pre e prese	If yes, Property Owner may be required to implement appropriate source control and site design measures and to design and implement stormwater treatment measures, to reduce the discharge stormwater pollutants. Please consult the Current Planning Section for necessary forms and both construction and post-construction requirements. b. Land disturbance of 1 acre or more of area? If yes, Property Owner must file a Notice of Intent (NOI) to be covered under the statewide General Construction Activities Storm Water Permit (General Permit) prior to the commencement of construction activity. Proof of coverage under State permit must be demonstrated prior to the issuance of a building permit. (a) (b) (c) (c) (d) (d) (d) (e) (e) (e) (e) (f) (f) (f) (f

(Applicant may sign)

San Mateo County

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Certificate of Exemption or Exclusion from a Coastal Development Permit

455 County Center, 2nd Floor • Redwood City, CA • 94063 Mail Drop: PLN 122 • TEL (650) 363-4161 • FAX (650) 363-4849

Permit #: PLN 2016 - 00467

Permanent Record Microfilming Required

· CIMIC W. DLD	Twicromining Required
a a septembrane for	
Owner Name: EUGENE? USA MARSH Address: 147 SONDRA AVENUE EL GRANADA, CA Zip: 94019 Phone (12) 208-891-6393 H: 3 Email Address: EPMARSH 59 @ GMAIL. COM	Applicant Name: ROCHA & SON CONSTRUCTION Address: PO BOX 1202 EL GRANADA, CA Zip: 94018 Phone, W: (650) 743-0808 DFFile-650-712-8181 Email Address: GREG@ ROCHASON. COM
Project Description: PARTIAL ZPD STORY ADDITION TO EXISTING SINGLE STORY, SINGLE FAMILY HOME Assessor's Parcel Number(s): 047 - 121 - 070	Existing water source: Utility connection Well Proposed water source: Litility connection Well Staking of well location and property lines are required. Provide site plan depicting Cationand lifes Will this require anylgrading or vegetation/tree removal? Yes Nov 1 2016 If Yes, additional permits may be required. Such as: Tree Removal Permit, Grading Permit, Land Clearing Remay Coastal Development Permit.
ESTOTETURA ESTA ESTA ESTA ESTA ESTA ESTA ESTA EST	Coastal Development Permit. San Mateu-Obstition Planning and Building Department
We have reviewed this form as completed above and the basis for basis for exemption or exclusion are true and correct to the best of in accordance with the terms of the exemption/exclusion category exemption or exclusion issued for a water well and/or storage tank event the future house, the well, and/or storage tank requires a value of the well of the following the well of the following tank requires a value of the well o	selected on reverse. We also understand and agree that any

(Both Owner and Applicant must sign unless this Application for Exemption or Exclusion accompanies a Building Permit Application for which the Applicant is an agent for the Owner acceptable to the Building Inspection Section.)

NOV 01 2016

October 21, 2016

County of San Mateo Planning Department

San Mateo County
Planning and Building Department

RE:

Statement regarding conformance with Design Review Guidelines for

147 Sonora Avenue El Granada, CA 94019

The existing home at 147 Sonora Avenue in El Granada is a single story home with an open kitchen/dining/living room area, and 3 smaller bedrooms / 2 smaller bathrooms. The goal of the proposed project is to add a 2nd story with a second common living area (i.e. a family room) that captures ocean views around the building to the rear of the home, adds a larger master suite, results in an addition of 1 bedroom overall, and relocates the existing laundry out of the kitchen. The project we have submitted achieves these desires, while conforming to the guidelines set forth in Section 6565.20 ("Standards for Design for One-Family and Two-Family Residential Development in the MidCoast").

Conformity to each of the guidelines found within the said "Standards" is as follows:

Item 1 refers to Site Planning and location, privacy aspects, and views. As this is an addition to an existing home with no proposed footprint expansion, the location aspect is not applicable to the proposed project. The only adjacent property with potential privacy issues lies to the south (next door on Sonora Avenue). Few windows have been placed on this side of the proposed addition to maintain privacy between the two homes. Additionally, the 2nd story addition on the adjacent home is to the front of the property (over the garage), while the addition we have proposed sets the addition back from the garage, which provides an additional measure to ensure privacy.

item 2 refers to massing, articulation, architectural style, and facades. The existing home has very little articulation. There is a single gable roof over the home, with a single gable over the garage and front walkway projecting from it. The proposed 2nd story addition integrates the same roof types, while adding variation and additional aesthetic interest to the façade of the home. As described in the "Standards", existing window styles / shapes, roof pitches, eaves, etc. have been incorporated into the addition, to maintain a cohesive architectural style. There are various 2-story homes in the immediate neighborhood; some smaller additions and some that are 2 full stories for most or the home's entire footprint. The proposed home falls well within similar massing/scale factors found within the


PLN2016-004-67

immediate neighborhood. Additionally, the proposed new color scheme fits the neighborhood, and is similar (but not an exact replication) to nearby homes.

In all, the proposed home addition is in general conformance with existing development in the area, and meets the standards as set forth in the Design Guidelines.

Sincerely,

Brian Brinkman

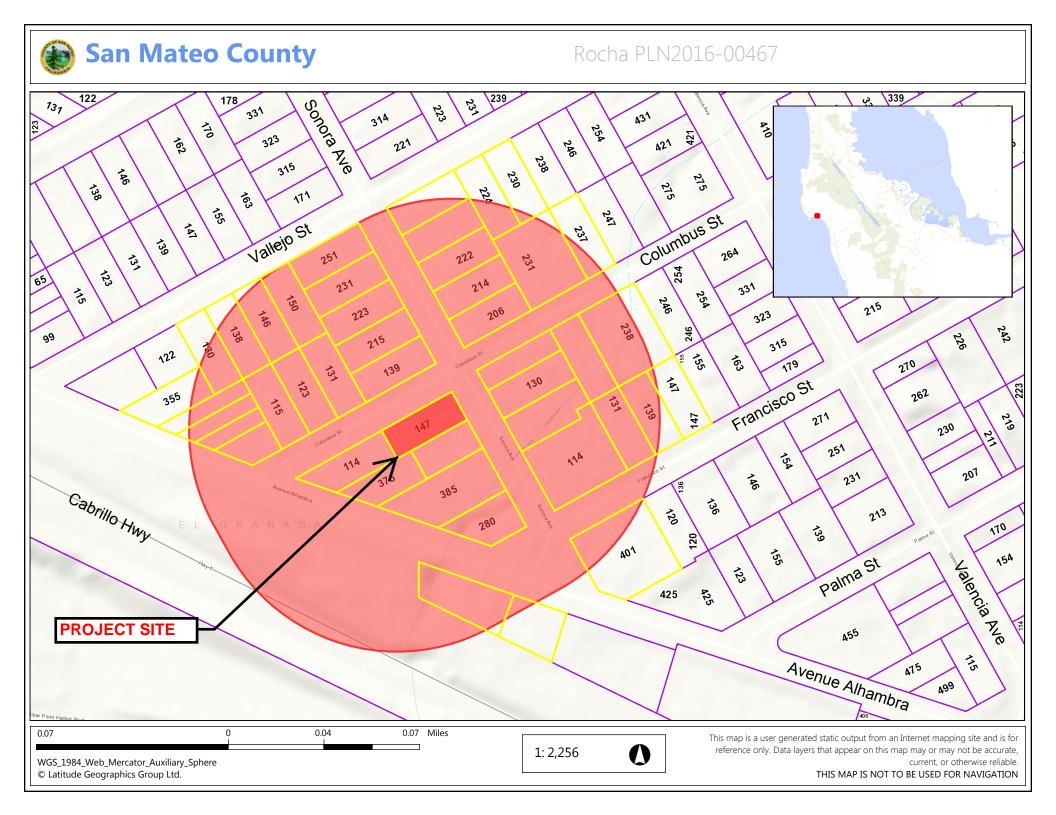

County of San Mateo Planning Department

RE: Exterior Materials List for 147 Sonora Avenue El Granada, CA 94019

ROOF -

GAF Timberline HD 'Slate' Asphalt Composition Shingles



RECEIVED

NOV 0 1 2016

San Mateo County
Planning and Building Department

SIDING MATERIAL (Walls)-

HardiePlank Lap Siding Select Cedarmill



PLN2016-00467

EXTERIOR TRIM / FASCIA -

Painted Redwood

GUTTERS -

Painted Galvanized Steel


EXTERIOR TRIM/FASCIA/GUTTERS/GARAGE DOOR COLOR -

Benjamin Moore OC-123 'Bavarian Cream'




FRONT DOOR COLOR -

Benjamin Moore AF-295 'Pomegranate'

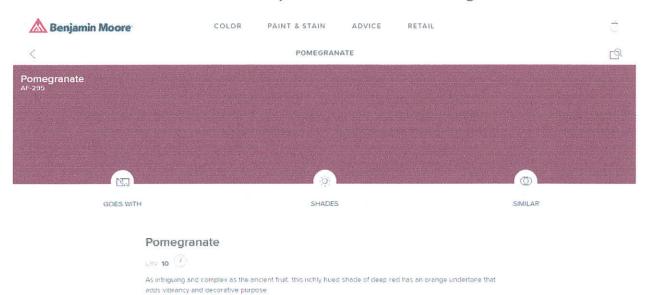

WINDOWS - Milgard Styleline Series Vinyl Windows with Standard White color sash

Milgard® Vinyl Window Frame Colors

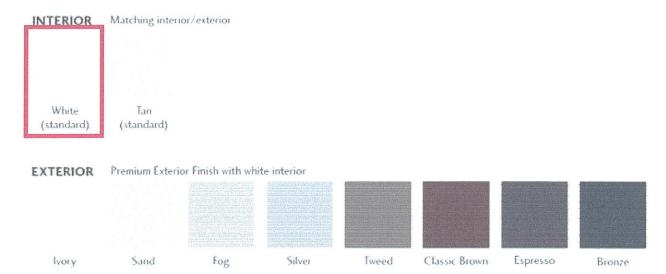



147 SONORA AVENUE, EL GRANADA

Shop by Room/Trends Store Locations Rate Us 800-782-1967

Lamps Plus | Outdoor Lighting | Kichler | Kichler Elba 12 1/4"H LED Bronze Outdoor Up/Down Wall Light

< Go Back



San Mateo County Planning and Building Department

VIEW IN YOUR ROOM

Kichler Elba 12 1/4"H LED Bronze Outdoor Up/Down Wall Light - Style # 4N184

SALE Save \$16

\$148.50

Reg. \$165,00 | Ends 11/15/16 | Low Price Guarantee

Qty

ADD TO WISH LIST

In Stock - Ships in 1 to 2 Days | Check Store Availability

FREE SHIPPING + FREE RETURNS*



Write a Review

Architectural Bronze finish gives this outdoor LED wall light a warm and inviting contemporary look.

This stylish modern outdoor wall light is illuminated with energy-saving LEDs. The chic metal cylindrical housing of this Dark Sky compliant up and down light features a warm and inviting Architectural Bronze finish that will complement

LN2016-00467

many home styles with its graceful contemporary look. An invigorating design from Kichler outdoor lighting.

- · Modern LED outdoor wall light.
- · Textured architectural bronze finish.
- · Down light design with no glass.
- · Metal housing construction.
- · A Kichler outdoor wall light design,
- · Dark Sky compliant.
- · Not dimmable.
- Integrated 9.78 watt LED array.
- Light output 450 lumens, comparable to a 40 watt incandescent bulb.
- · 3000K color temperature; CRI is 80.
- Measures 12 1/4" high, 5" wide.
- Extends 6 1/2" from the wall.







Shop all Kichler

REMODEL AND ADDITION: MARSH RESIDENCE 147 SONORA AVENUE, EL GRANADA, CA

SYMBOLS

ABBREVIATIONS AT NORTH NUMBER (N) NEW N/A NOT APPLICABLE **ANCHOR BOLT** NA **NOT AVAILABLE** A/C AIR CONDITIONER NIC NOT IN CONTRACT ABOVE FINISHED FLOOR NOM NOMINAL **APPROX** APPROXIMATE **NON-RATED** ABOVE SUBFLOOR NET SQUARE FEET ABOVE SLAB NTS NOT TO SCALE **BLDG** BUILDING 0 OVEN BLK **BLOCK** OA **OVERALL BLOCKING** BLKG OC ON CENTER BM OD OUTSIDE DIAMETER OR BOT **BOTTOM OVERFLOW DRAIN** CAB OFF CABINET OFFICE **OPNG** CB **CATCH BASIN OPENING** CL OHCENTERLINE **OVERHANG** CLG O/H CEILING **OVERHEAD** CLST CLOSET OPP **OPPOSITE** CMU CONCRETE MASONRY UNIT PLATE OR PROPERTY LINE CO **CLEAN OUT PLYWD PLYWOOD** COL COLUMN CONCRETE PT POINT OR PRESSURE TREATED CONT CONTINUOUS RADIUS DRYER RAG RETURN AIR GRILLE DBL DOUBLE RD **ROOF DRAIN** DEPT DEPARTMENT REF REFRIGERATOR DEG **DEGREES** REINF REINFORCED OR REINFORCEMENT DIA DIAMETER REQ'D REQUIRED DIM DIMENSION **REV** REVISION DN DOWN RHB RADIANT HEATING BOILER DR DOOR RM DS DOWNSPOUT RO ROUGH OPENING DW DISHWASHER ROW RIGHT-OF-WAY DWG DRAWING SOUTH **EXISTING** SB SETBACK EΑ EACH SCHED SCHEDULE ELECTRICAL SD SMOKE DETECTOR OR STORM DRAIN **ELEV** ELEVATION SF SQUARE FEET OR SQUARE FOOT ENG **ENGINEER** SH SHOWER HEAD **EQPT EQUIPMENT** SHT SHEET EXT EXTERIOR SHWR SHOWER FAU FORCED AIR UNIT SHTG SHEATHING FLOOR AREA RATIO SIMILAR SLIDING FLOOR DRAIN FF **SPEC SPECIFICATION** FINISHED FLOOR FIN SQ SS SQUARE FINISH SANITARY SEWER **FLOOR FLUORESCENT** STL STEEL **FOUNDATION** STOR STORAGE FOUND STRUCT **FIREPLACE** STRUCTURAL FT FOOT OR FEET **SUBCONTRACTOR** SUB FTG **FOOTING SUBFLR SUBFLOOR FURN FURNACE** SW SHEAR WALL SYM SYMMETRICAL GAS GΑ **GAUGE** TILE, TREAD, TOP, OR **GALV** GALVANIZED **TRANSFORMER** GC GENERAL CONTRACTOR T&G TONGUE AND GROOVE GD GARBAGE DISPOSAL TO BE DETERMINED GL TEL **GLASS** TELEPHONE GR THK GRADE THICK GYP BD GYPSUM BOARD TO TOP OF TOC TOP OF CURB HC **HANDICAP** TOP TOP OF PLATE HDR **HEADER** TOS TOP OF SUBFLOOR **HDWD HARDWOOD** TOW TOP OF WALL HT HEIGHT TP TOP OF PAVEMENT HORIZ HORIZONTAL TV **TELEVISION** HR HOUR TYP TYPICAL INSUL INSULATION UNO UNLESS NOTED OTHERWISE INT INTERIOR **VERT VERTICAL** JOINT OR JOINT TRENCH W WEST, WASHER, OR WATER LINEN LINEN CLOSET W/ WITH LAM LAMINATE WC WATER CLOSET LAV LAVATORY WD WOOD LIGHT WH WATER HEATER MAX **MAXIMUM** $W \times H$ WIDTH BY HEIGHT **MECH MECHANICAL WNDW WINDOW** MFR MANUFACTURER W/O WITHOUT WP MH MANHOLE WATERPROOF WR MIN MINIMUM WATER RESISTANT WT **MISC** MISCELLANEOUS WEIGHT **MLDG** MOULDING MTD MOUNTED MTL **METAL**

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PROJECT SCOPE

PARTIAL SECOND STORY ADDITION AND MINOR REMODEL OF (E) HOUSE TO INCORPORATE (N) STAIRS, AT (E) SINGLE STORY, SINGLE FAMILY HOME

PLANNING DATA

PROJECT COMMON ADDRESS: 147 SONORA AVENUE EL GRANADA, CA 94019

ASSESSOR'S PARCEL NUMBER: 047-121-070 S-17 SINGLE FAMILY RESIDENTIAL COMBINING DISTRICT - COASTSIDE

BUILDING CODE DATA

TYPE OF OCCUPANCY: CONSTRUCTION TYPE: BEARING AND NON-BEARING WALLS (LESS THAN 5' FROM PROPERTY LINE): 1-HOUR OPENINGS NOT PERMITTED LESS THAN 3' FROM PROPERTY LINE NUMBER OF STORIES:

ALL WORK TO CONFORM TO 2013 CRC, CBC, CFC,

CPC, CMC, CEC, 2013 CALIFORNIA ENERGY CODE,

AND 2013 CGBC

	- SECTION CUT, DETAIL NUMBER - SHEET ON WHICH IT OCCURS
	- DETAIL NUMBER - SHEET ON WHICH IT OCCURS
	REVISION CLOUD
\triangle	REVISION NUMBER
1	GRIDLINE IDENTIFICATION
2% SLOPE	DOWNSLOPE INDICATION
\longrightarrow	SHOWER HEAD

	PROJECT DIREC	TORY	
SERVICE	COMPANY	CONTACT	TELEPHONE
OWNER	=	EUGENE & LISA MARSH	-
APPLICANT / DESIGN / BUILDER	ROCHA & SON CONSTRUCTION	GREG ROCHA	(650) 712-8181
SURVEYOR	SAVIOR P MICALLEF LAND SURVEYING	SAVIOR MICALLEF	(805) 709-2423
DRAFTING / DESIGN	<u>-</u>	BRIAN BRINKMAN	(650) 922-7993

PROJECT NOTES

CALGREEN CONSTRUCTION REQUIREMENTS

CONTRACTOR SHALL PROVIDE, AT THE TIME OF FINAL INSPECTION, AN OPERATION AND MAINTENANCE MANUAL TO THE OWNER OR OCCUPANT. ADDRESSING ITEMS 1 THROUGH 10 IN CALGREEN SECTION 4.410.1. PER CALGREEN SECTION 4.408.2, CONTRACTOR SHALL PROVIDE AND SUBMIT A CONSTRUCTION WASTE MANAGEMENT PLAN, DIVERTING A

MINIMUM OF 50% OF WASTE GENERATED AT THE SITE TO RECYCLE OR SALVAGE, TO THE BUILDING DEPARTMENT. THE FOLLOWING INFORMATION

- SHALL BE PROVIDED IN THE PLAN: IDENTIFY MATERIALS TO BE RECYCLED, REUSED, OR SALVAGED
- SPECIFY IF MATERIALS WILL BE SORTED ON SITE OR MIXED FOR TRANSPORTATION
- IDENTIFY THE DIVERSION FACILITY(IES) TO BE USED IDENTIFY CONSTRUCTION METHODS TO BE USED TO LIMIT WASTE GENERATION
- SPECIFY THAT THE AMOUNT OF MATERIALS DIVERTED ARE TO BE CALCULATED BY WEIGHT OR VOLUME
- AUTOMATIC IRRIGATION SYSTEMS CONTROLLERS INSTALLED AT THE TIME OF FINAL INSPECTION SHALL BE WEATHER-BASED PROTECT ANNULAR SPACES AROUND PIPES, ELECTRIC CABLES, AND CONDUITS AT EXTERIOR WALLS AGAINST THE PASSAGE OF RODENTS.
- COVER DUCT OPENINGS AND OTHER RELATED AIR DISTRIBUTION COMPONENT OPENINGS DURING CONSTRUCTION.
- ADHESIVES, SEALANTS, AND CAULKS SHALL BE COMPLIANT WITH VOC AND OTHER TOXIC COMPOUND LIMITS. PAINTS, STAINS, AND OTHER COATINGS SHALL BE COMPLIANT WITH VOC LIMITS.
- AEROSOL PAINTS AND COATINGS SHALL BE COMPLIANT WITH PRODUCT WEIGHTED MIR LIMITS FOR ROC AND OTHER TOXIC COMPOUNDS.
- VERIFICATION OF COMPLIANCE SHALL BE PROVIDED. CARPET AND CARPET SYSTEMS SHALL BE COMPLIANT WITH VOC LIMITS.
- MINIMUM OF 80% OF FLOOR AREA RECEIVING RESILIENT FLOORING SHALL COMPLY WITH SECTION 4.504.4.
- PARTICLEBOARD, MEDIUM DENSITY FIBERBOARD, AND HARDWOOD PLYWOOD USED IN INTERIOR FINISH SYSTEMS SHALL COMPLY WITH LOW FORMALDEHYDE EMISSION STANDARDS.
- INSTALL CAPILLARY BREAK AND VAPOR RETARDER AT SLAB ON GRADE FOUNDATIONS.
- CHECK MOISTURE CONTENT OF BUILDING MATERIALS USED IN WALL AND FLOOR FRAMING BEFORE ENCLOSURE EACH BATHROOM SHALL BE MECHANICALLY VENTILATED WITH AN ENERGY STAR EXHAUST FAN, AND FAN MUST BE CONTROLLED BY A HUMIDIT
- DUCT SYSTEMS SHALL BE SIZED, DESIGNED, AND EQUIPMENT SELECTED PER SECTION 4.507.2. HVAC SYSTEM INSTALLERS MUST BE TRAINED AND CERTIFIED AND SPECIAL INSPECTORS EMPLOYED BY THE ENFORCING AGENCY MUST BE QUALIFIED.

PROJECT INFORMATION		
LOT SIZE	6,250 SF	
EXISTING/NEW LOT COVERAGE	1,617 SF / 6,250 SF = 25.87%	
EXISTING/NEW TOTAL PAVED SURFACES	482 SF	
EXISTING/NEW TOTAL IMPERVIOUS SURFACES	2,099 SF / 6,250 SF = 33.58%	
EXISTING/NEW PAVER PATIO	229 SF	
EXISTING/NEW LANDSCAPED AREA	3,922 SF	
EXISTING/NEW LANDSCAPED / PERVIOUS SURFACE AREA	3,922 SF / 6,250 SF = 62.75%	
EXISTING LIVING AREA	1,224 SF (CONDITIONED)	
NEW 1ST FLOOR LIVING AREA	1,224 SF (CONDITIONED)	
NEW 2ND FLOOR LIVING AREA	984 SF (CONDITIONED)	
NEW TOTAL LIVING AREA	2,208 SF (CONDITIONED)	
ADDED LIVING AREA	2,208 - 1,224 = 984 SF	
EXISTING ATTACHED GARAGE AREA	393 SF (UN-CONDITIONED)	
NEW FLOOR AREA RATIO	1,224 + 984 + 393 = 2,601 SF 2,601 / 6,250 = 0.416 (0.53 MAX)	

		2	
PROJECT I	NFORMATION		DRAWING INDEX
SIZE	6,250 SF	ARCHITE	CTURAL/CIVIL TITLE SHEET / PROJECT INFO
STING/NEW LOT COVERAGE	1,617 SF / 6,250 SF = 25.87%	1 of 1 A1.1	TOPOGRAPHIC SURVEY SITE PLAN
STING/NEW TOTAL ED SURFACES	482 SF	A2.1 A2.2 A2.3	EXISTING AND NEW 1ST FLOOR PLANS EXISTING ROOF PLAN AND NEW 2ND FLOOR PLAN NEW UPPER ROOF PLAN
STING/NEW TOTAL ERVIOUS SURFACES	2,099 SF / 6,250 SF = 33.58%	A2.3 A3.1 A3.2	EXISTING AND NEW FRONT ELEVATIONS EXISTING AND NEW LEFT ELEVATIONS
STING/NEW PAVER PATIO	229 SF	A3.3 A3.4	EXISTING AND NEW REAR ELEVATIONS EXISTING AND NEW RIGHT ELEVATIONS
STING/NEW IDSCAPED AREA	3,922 SF	A3.5	NEW SECTION
STING/NEW LANDSCAPED / RVIOUS SURFACE AREA	3,922 SF / 6,250 SF = 62.75%		
STING LIVING AREA	1,224 SF (CONDITIONED)		
EW 1ST FLOOR LIVING AREA	1,224 SF (CONDITIONED)		
EW 2ND FLOOR LIVING AREA	984 SF (CONDITIONED)		
EW TOTAL LIVING AREA	2,208 SF (CONDITIONED)		
DDED LIVING AREA	2,208 - 1,224 = 984 SF		
STING ACHED GARAGE AREA	393 SF (UN-CONDITIONED)		
V FLOOR AREA RATIO	1,224 + 984 + 393 = 2,601 SF 2,601 / 6,250 = 0.416 (0.53 MAX)		



147 Sonora Avenue - Proposed Perspective with Materials and Colors

- 1 Roofing: GAF Timberline HD 'Slate' Asphalt Composition Shingles
- 2 Exterior Wall Siding: HardiePlank Lap Siding Select Cedarmill, painted Benjamin Moore CW-665 'Powell Grey' Gable Wall Siding: HardieShingle Siding Straight Edge Panel, painted Benjamin Moore CW-665 - 'Powell Grey'
- Exterior Trim, Fascia, Gutters, Garage Door: Redwood, painted Benjamin Moore OC-123 'Bavarian Cream' 5 Front Door: Existing Door, painted Benjamin Moore AF-295 - 'Pomegranate'
- 6 Windows: Milgard Styleline Series Vinyl Windows with Standard White color frame

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"Ma	king you			ıms a re	
PO	Gregor 650.74 Box 120 @rochas	02 - El	O: 65 Granad	0.712 .8 a, CA 9	818 401
DESCRIPTION	PRE-APPLICATION MEETING	DESIGN REVIEW SUBMITTAL			
DATE	09/28/16	10/19/16			
>=					


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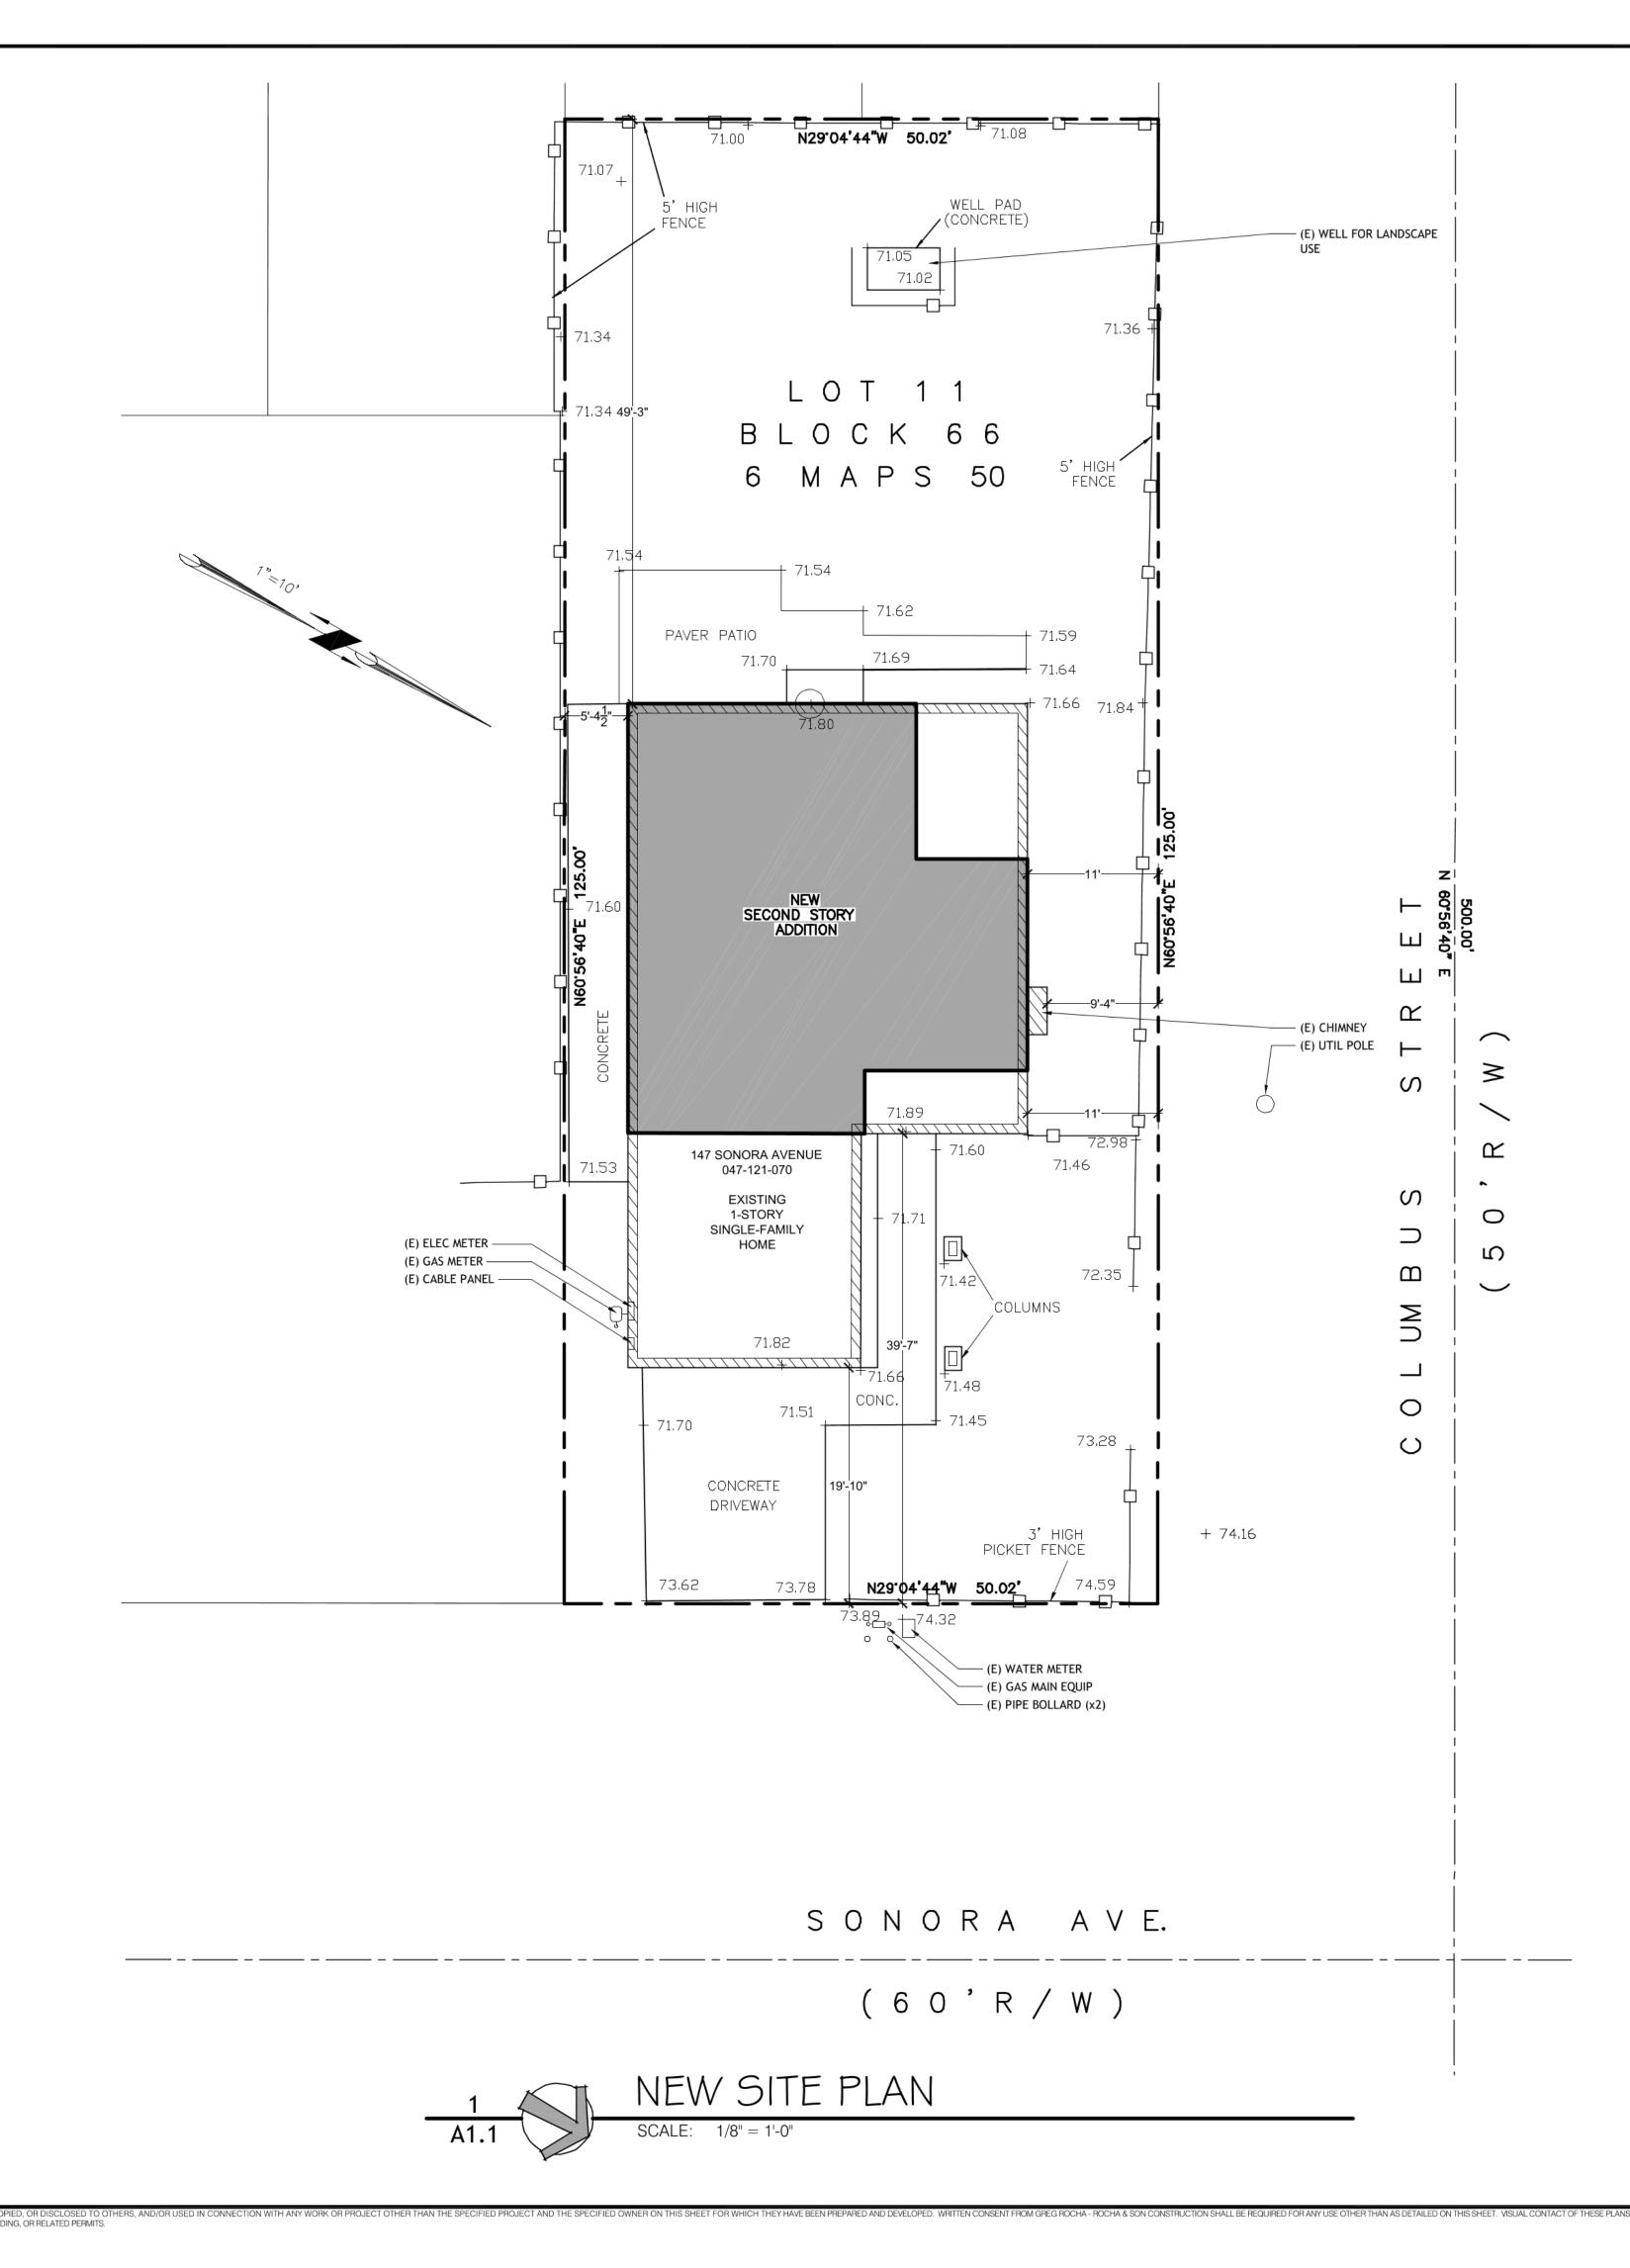
2ND NCE AVENUE , CA 94019 AND SIDE


SHEET TITLE:

TITLE SHEET **PROJECT** INFO

SHEET:



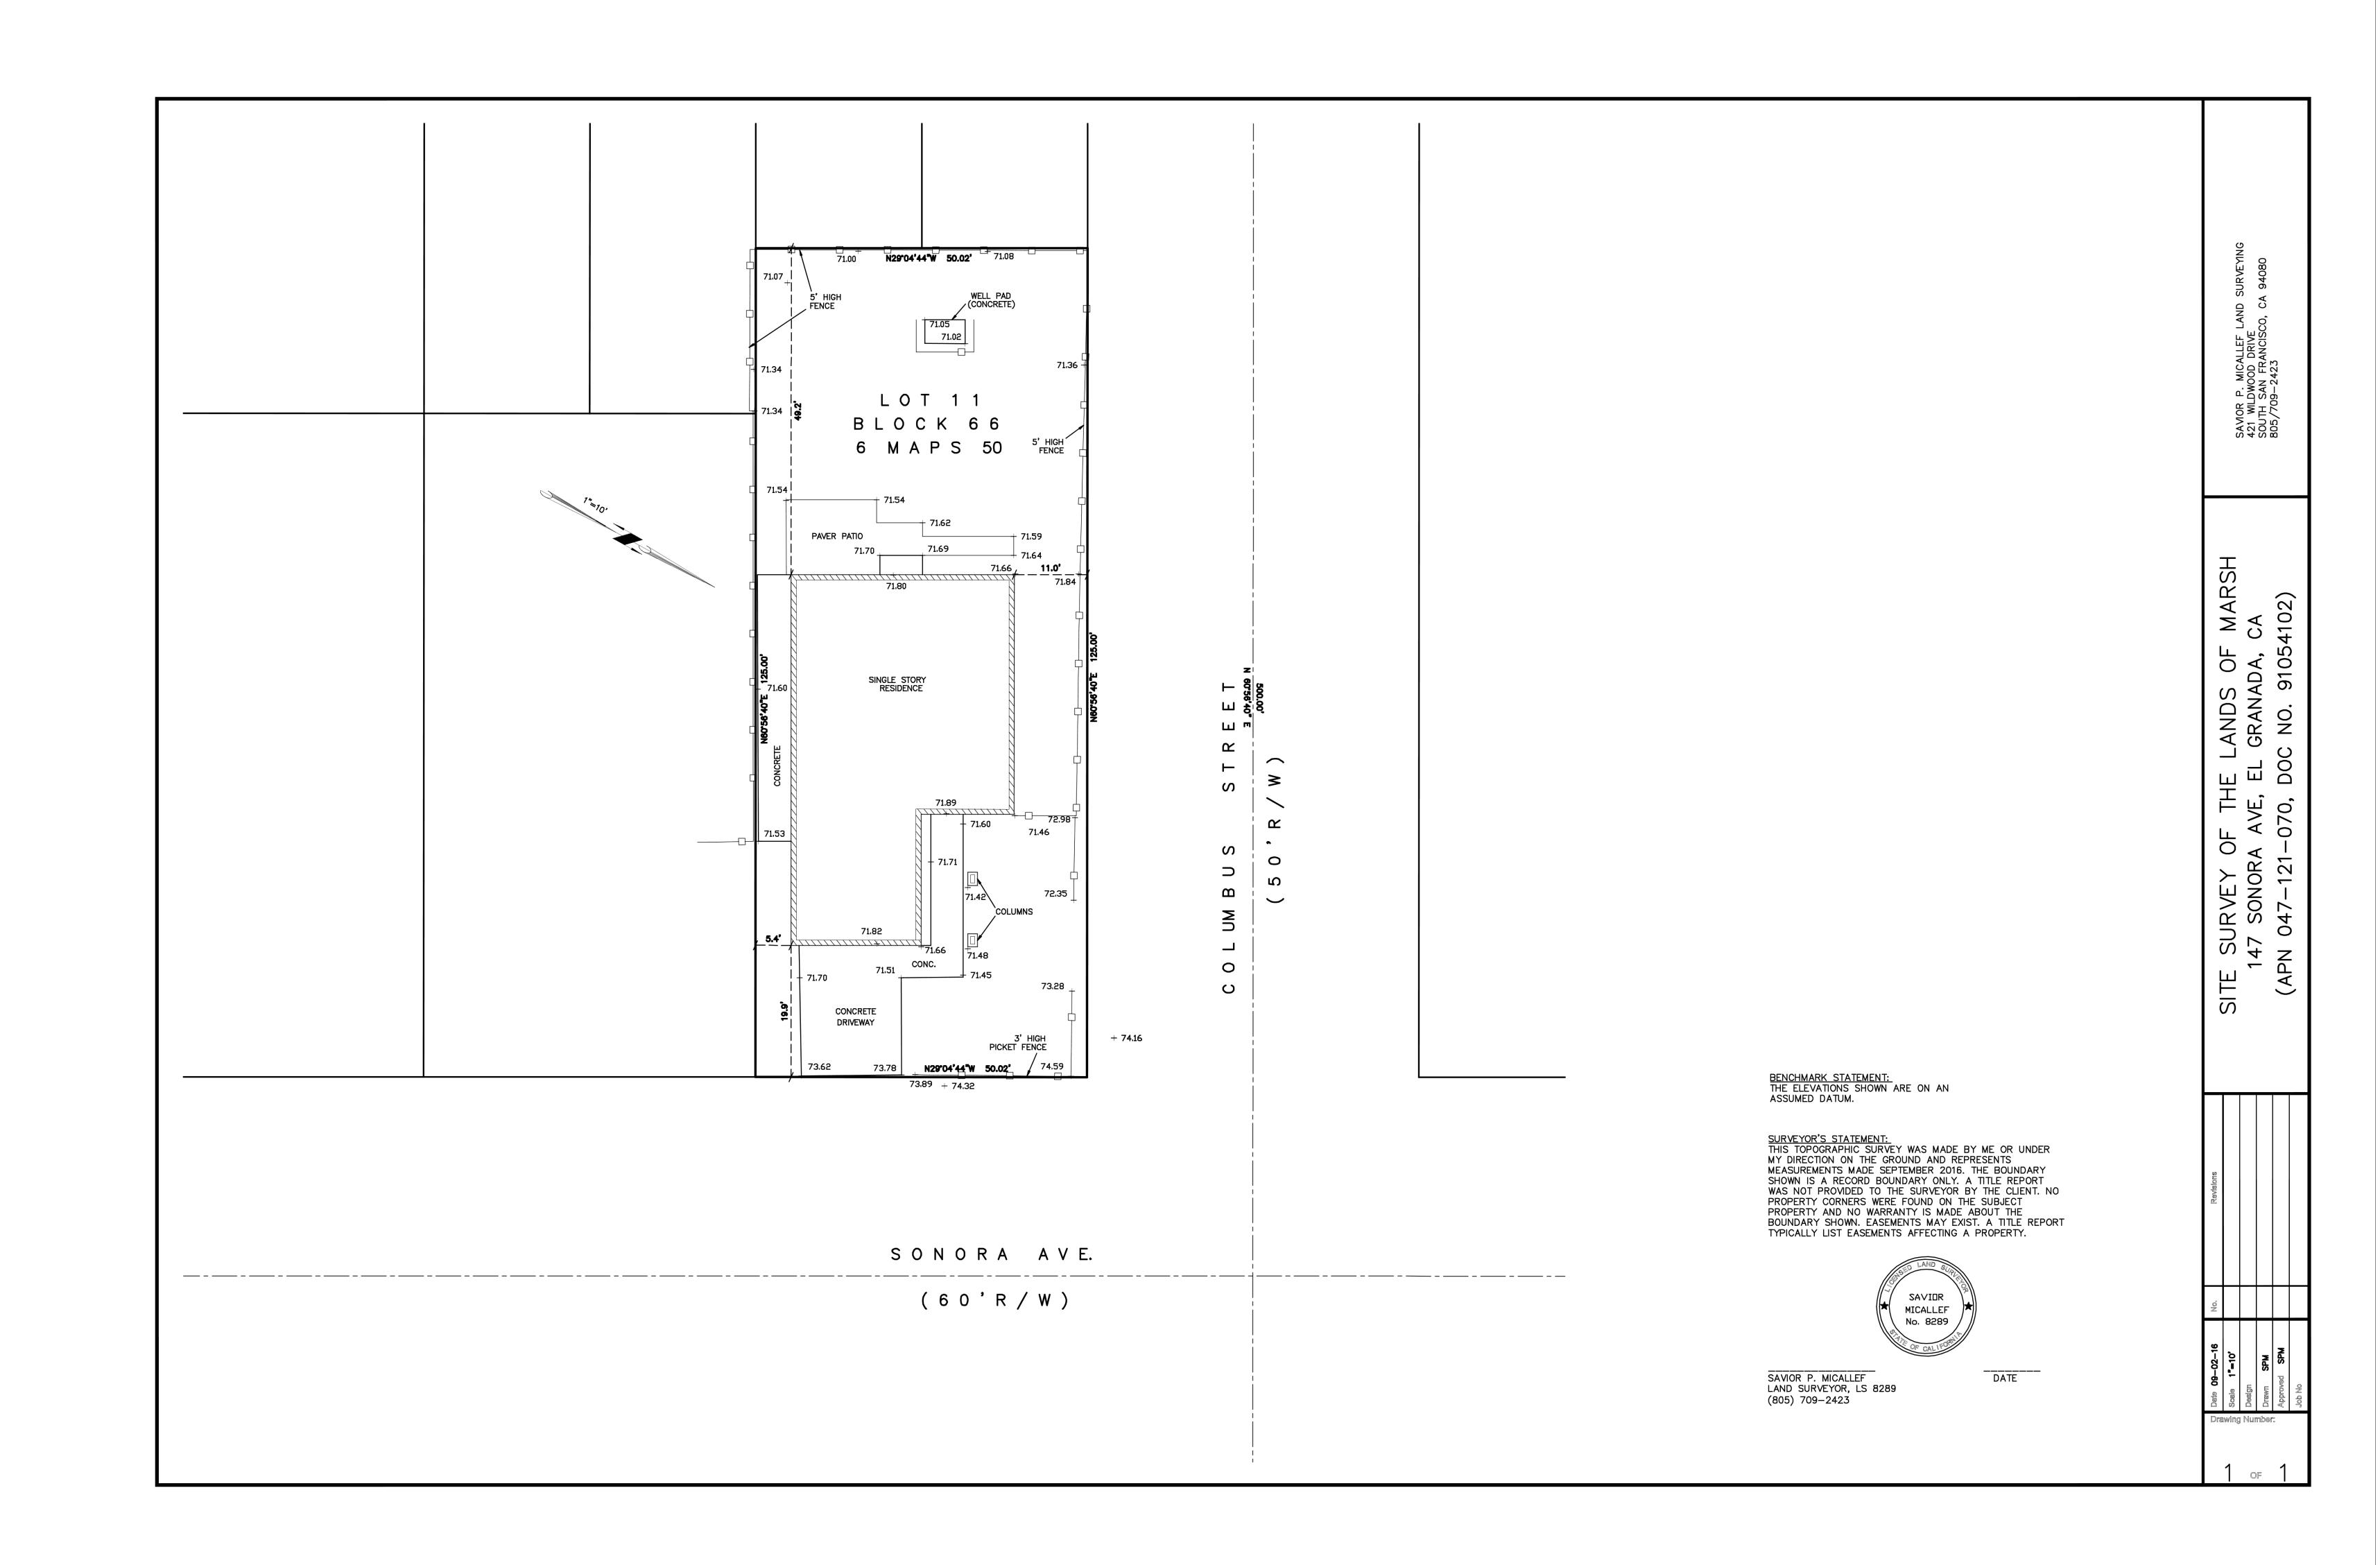

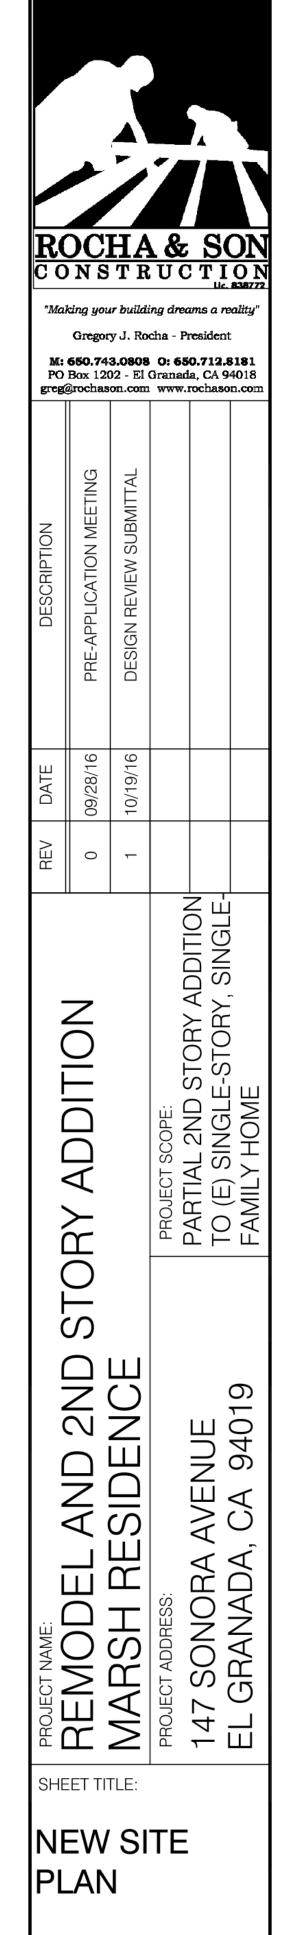

SHEET:

A1.1

PLUMBING FIXTURE NOTES:

- MAX FLOW RATE OF SHOWERHEADS SHALL BE 2.0 GPM
- MAX FLOW RATE OF LAVATORY FAUCETS SHALL BE 1.5 GPM
- MAX FLOW RATE OF KITCHEN FAUCETS SHALL BE 1.8 GPM
- ALL TOILETS SHALL BE MAX 1.28 GPF

EXISTING PLUMBING FIXTURES WITHIN THE HOUSE THAT DO NOT MEET THE COMPLIANT FLOW RATES SHALL BE REPLACED, PER THE FOLLOWING:

•• WATER CLOSETS WITH A FLOW RATE IN EXCESS OF 1.6 GPF SHALL BE REPLACED WITH WATER CLOSETS WITH A MAX FLOW RATE OF 1.28 GPF.

EGRESS NOTE: AT LEAST ONE WINDOW IN EACH BEDROOM SHALL MEET THE FOLLOWING REQUIREMENTS:

MIN. 5.7 SF IN OVERALL SIZE

WALL LEGEND

= = = = = EXISTING WALL TO BE REMOVED

☐ EXISTING WALL OR DECK RAILING TO REMAIN

PROPOSED 42" HIGH STUD WALL

EXISTING / PROPOSED CONCRET

CONSTRUCTION

"Making your building dreams a reality"

Gregory J. Rocha - President M: 650.743.0808 O: 650.712.8181 PO Box 1202 - El Granada, CA 94018 greg@rochason.com www.rochason.com

ADDITION

STORY

REMODEL AND 2ND MARSH RESIDENCE

SHEET TITLE:


NEW 1ST


EXISTING AND

FLOOR PLANS


STORY ADDITION-LE-STORY, SINGLE-


AVENUE V, CA 94019

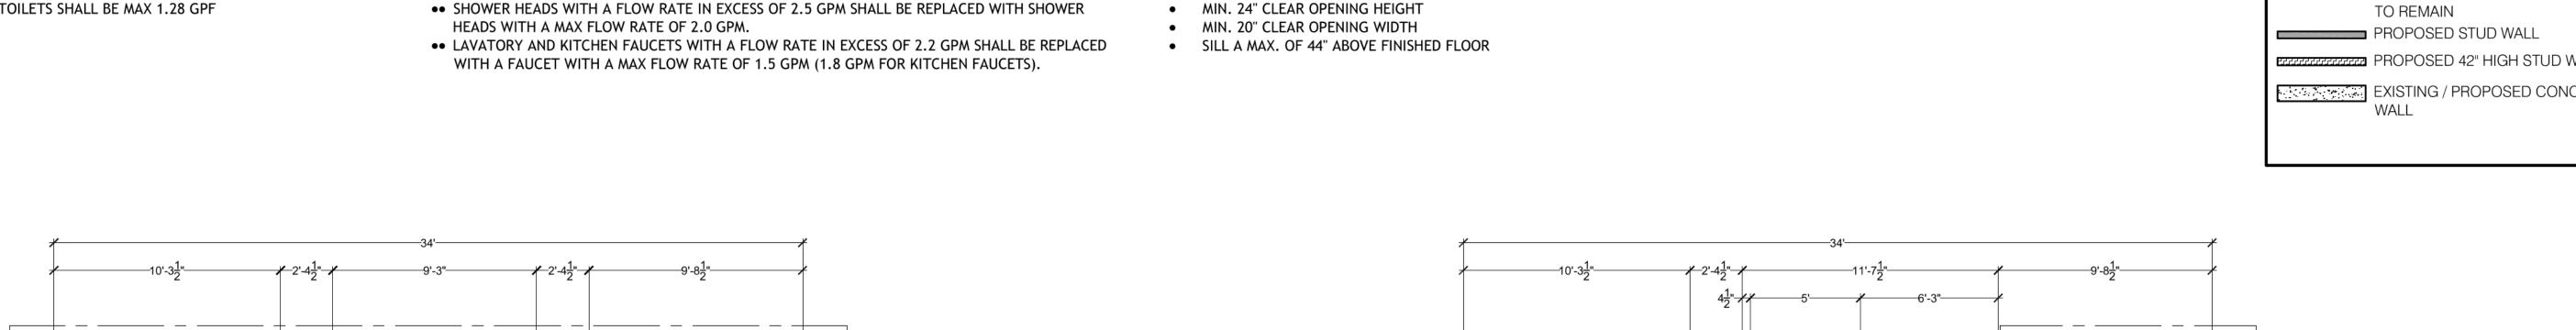

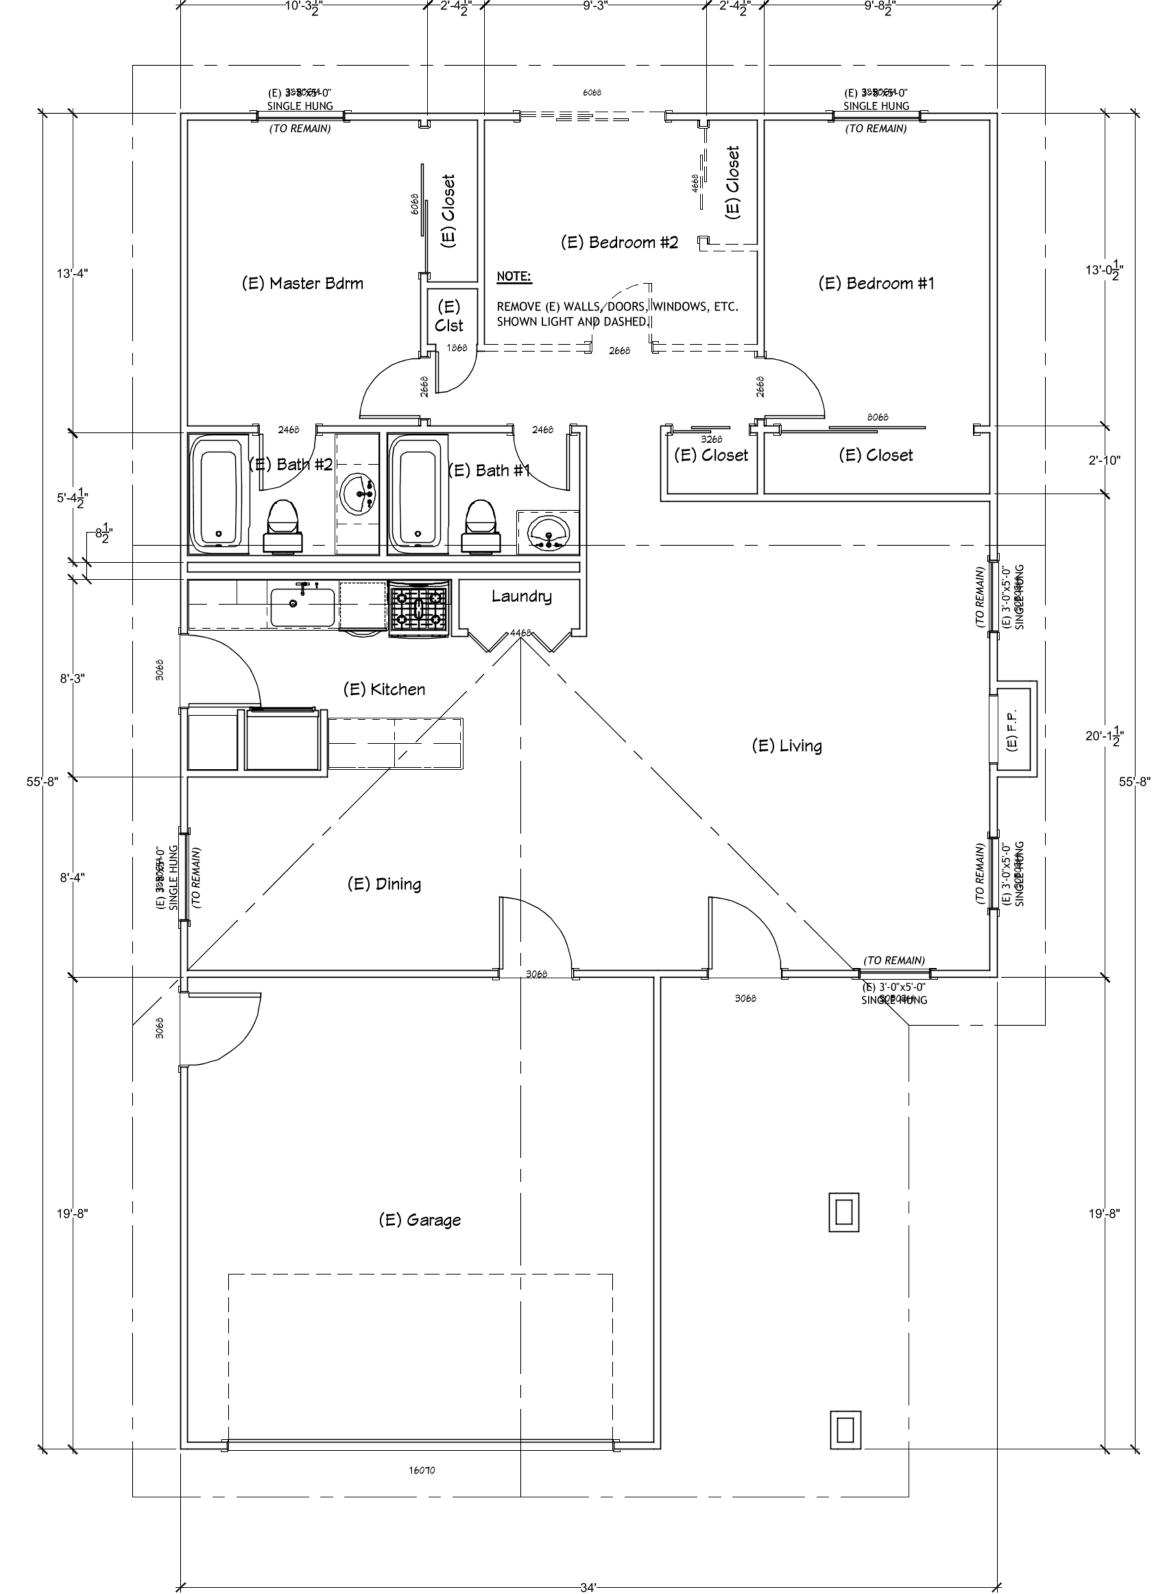

NEW 1ST FLOOR PLAN

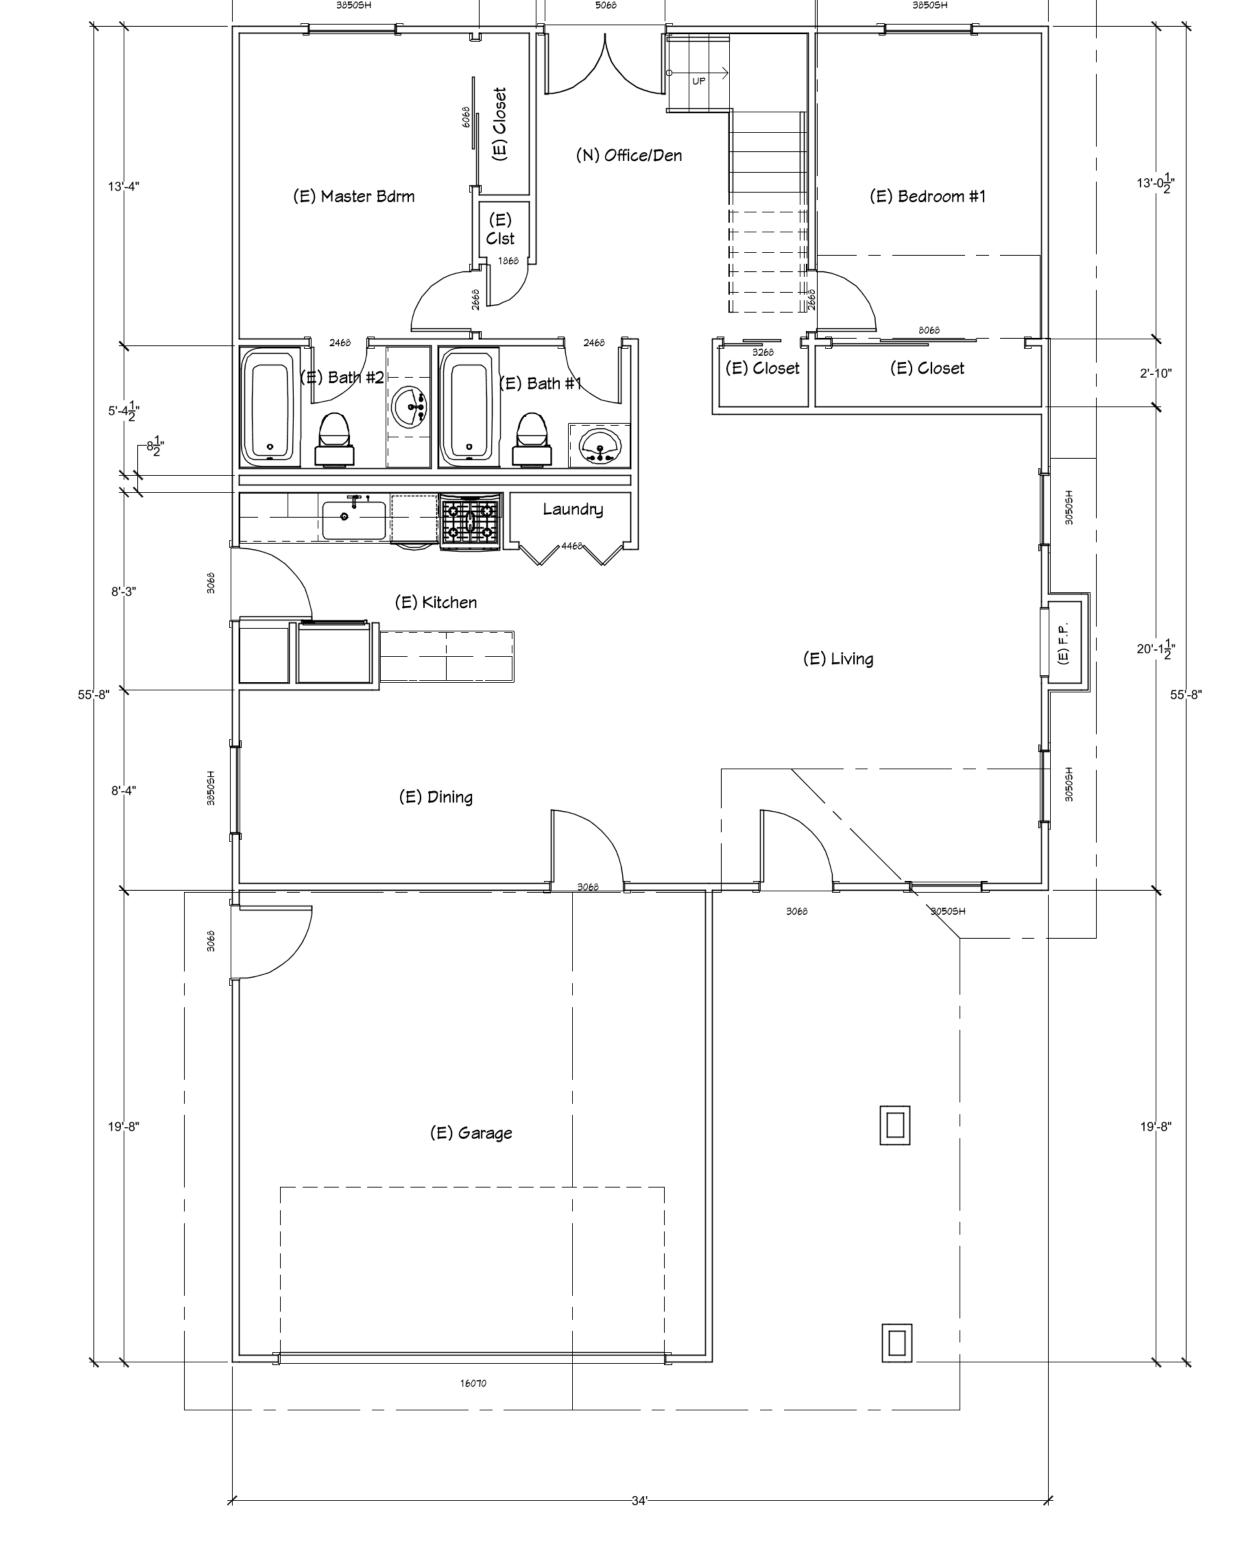

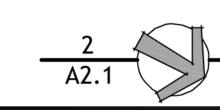

NEW 1ST FLOOR PLAN SCALE: 1/4'' = 1'-0''

A2.1

PLUMBING FIXTURE NOTES:

- MAX FLOW RATE OF SHOWERHEADS SHALL BE 2.0 GPM
- MAX FLOW RATE OF LAVATORY FAUCETS SHALL BE 1.5 GPM
- MAX FLOW RATE OF KITCHEN FAUCETS SHALL BE 1.8 GPM
- ALL TOILETS SHALL BE MAX 1.28 GPF

EXISTING PLUMBING FIXTURES WITHIN THE HOUSE THAT DO NOT MEET THE COMPLIANT FLOW RATES SHALL BE REPLACED, PER THE FOLLOWING:

- •• WATER CLOSETS WITH A FLOW RATE IN EXCESS OF 1.6 GPF SHALL BE REPLACED WITH WATER CLOSETS WITH A MAX FLOW RATE OF 1.28 GPF.
- •• SHOWER HEADS WITH A FLOW RATE IN EXCESS OF 2.5 GPM SHALL BE REPLACED WITH SHOWER HEADS WITH A MAX FLOW RATE OF 2.0 GPM.
- •• LAVATORY AND KITCHEN FAUCETS WITH A FLOW RATE IN EXCESS OF 2.2 GPM SHALL BE REPLACED WITH A FAUCET WITH A MAX FLOW RATE OF 1.5 GPM (1.8 GPM FOR KITCHEN FAUCETS).

EGRESS NOTE: AT LEAST ONE WINDOW IN EACH BEDROOM SHALL MEET THE FOLLOWING REQUIREMENTS:

- MIN. 5.7 SF IN OVERALL SIZE
- MIN. 24" CLEAR OPENING HEIGHT MIN. 20" CLEAR OPENING WIDTH
- SILL A MAX. OF 44" ABOVE FINISHED FLOOR

WALL LEGEND


===== EXISTING WALL TO BE REMOVED


EXISTING WALL OR DECK RAILING TO REMAIN

PROPOSED STUD WALL


PROPOSED 42" HIGH STUD WALL

EXISTING / PROPOSED CONCRET WALL

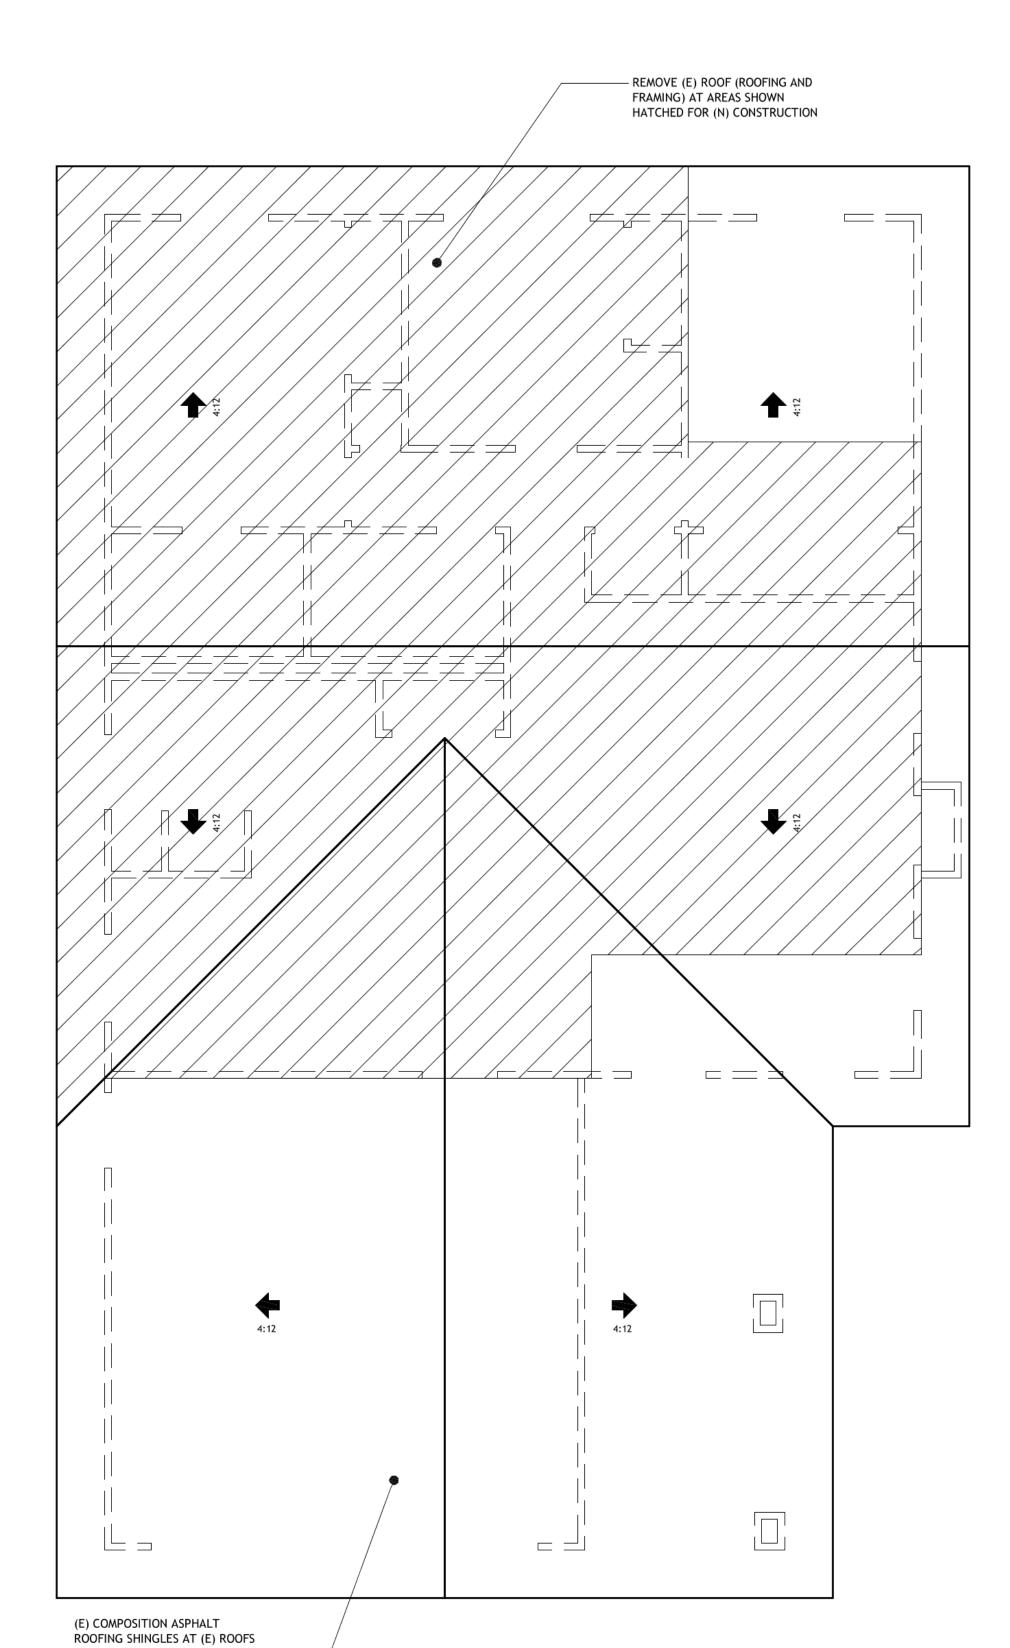

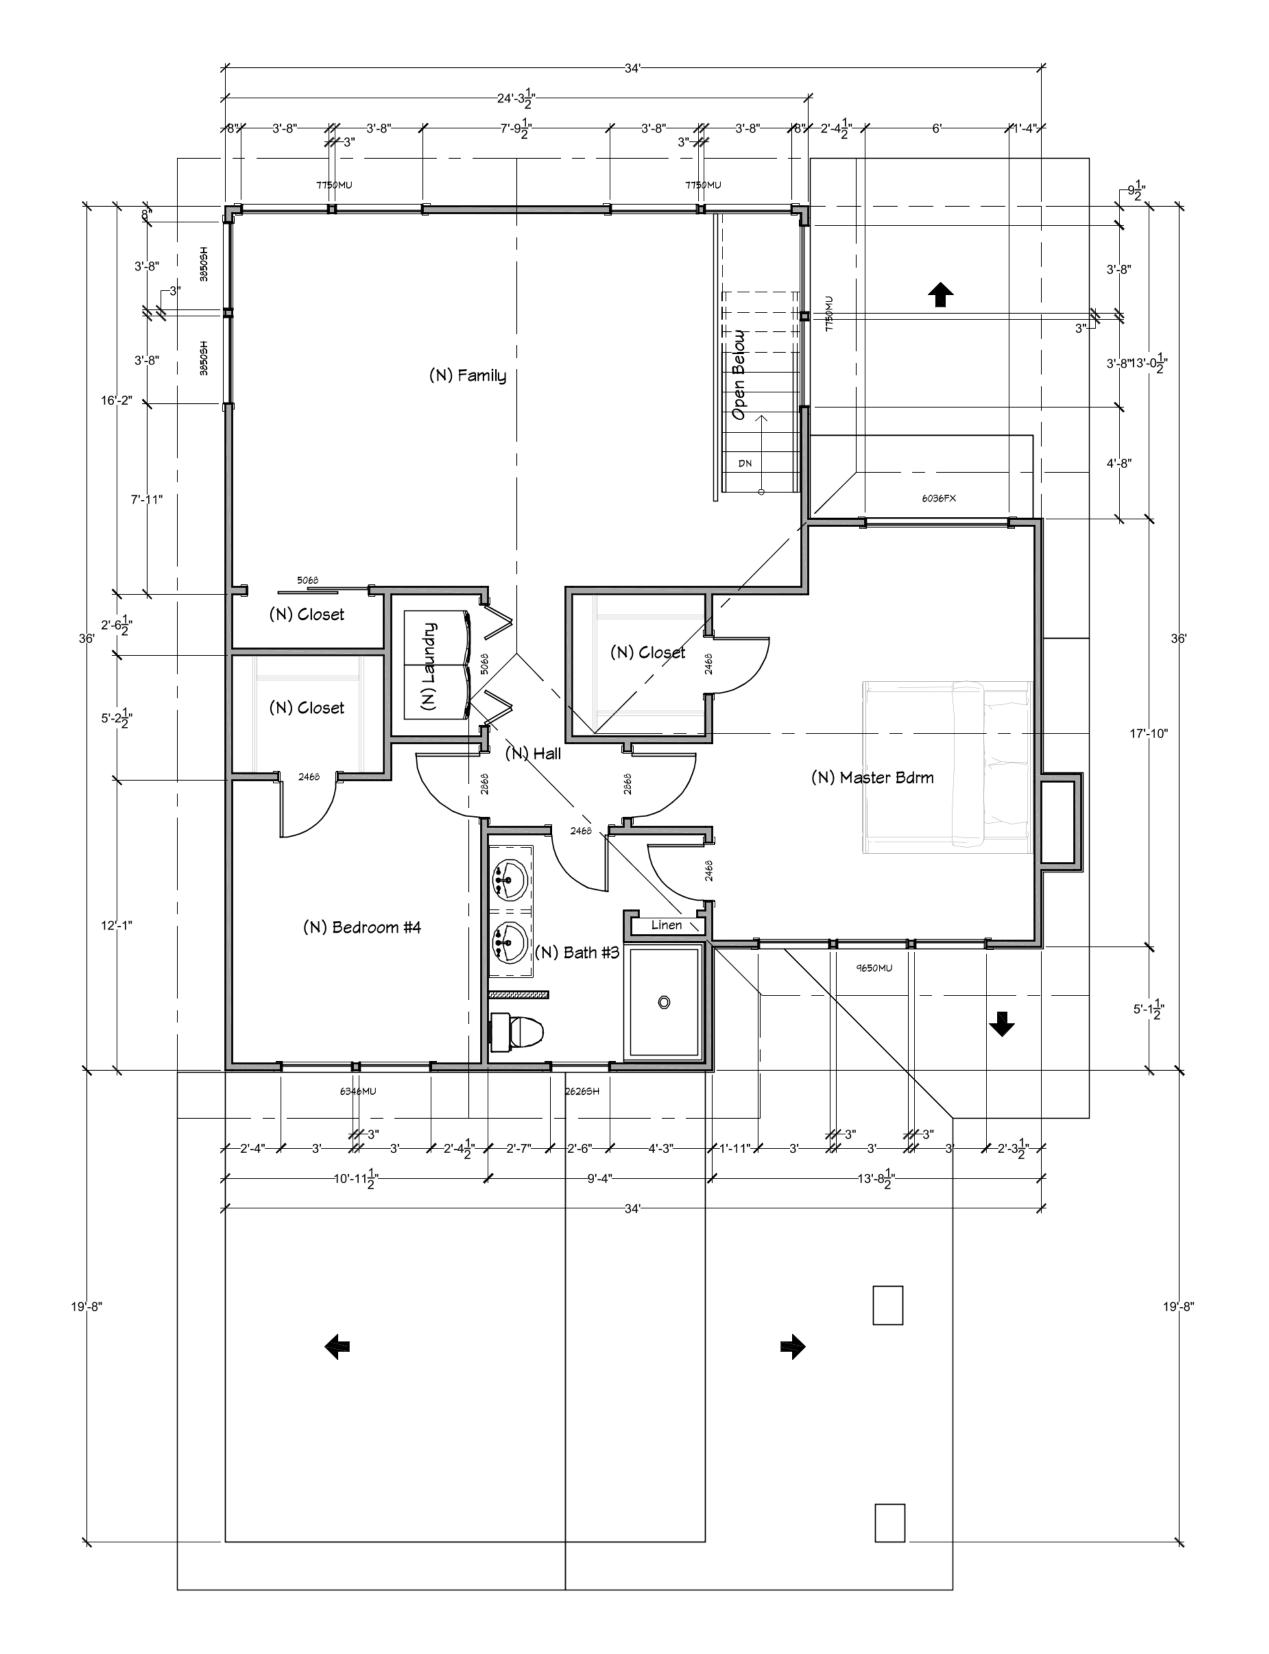



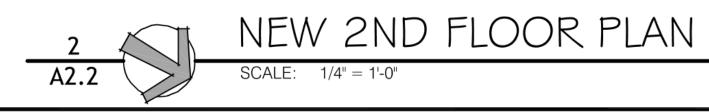





EXISTING ROOF PLAN AND NEW 2ND FLOOR PLAN

A2.2

PLUMBING FIXTURE NOTES:

- MAX FLOW RATE OF SHOWERHEADS SHALL BE 2.0 GPM
- MAX FLOW RATE OF LAVATORY FAUCETS SHALL BE 1.5 GPM
- MAX FLOW RATE OF KITCHEN FAUCETS SHALL BE 1.8 GPM
- ALL TOILETS SHALL BE MAX 1.28 GPF

EXISTING PLUMBING FIXTURES WITHIN THE HOUSE THAT DO NOT MEET THE COMPLIANT FLOW RATES SHALL BE REPLACED, PER THE FOLLOWING:

- •• WATER CLOSETS WITH A FLOW RATE IN EXCESS OF 1.6 GPF SHALL BE REPLACED WITH WATER CLOSETS WITH A MAX FLOW RATE OF 1.28 GPF.
- •• SHOWER HEADS WITH A FLOW RATE IN EXCESS OF 2.5 GPM SHALL BE REPLACED WITH SHOWER HEADS WITH A MAX FLOW RATE OF 2.0 GPM.
- •• LAVATORY AND KITCHEN FAUCETS WITH A FLOW RATE IN EXCESS OF 2.2 GPM SHALL BE REPLACED WITH A FAUCET WITH A MAX FLOW RATE OF 1.5 GPM (1.8 GPM FOR KITCHEN FAUCETS).


EGRESS NOTE: AT LEAST ONE WINDOW IN EACH BEDROOM SHALL MEET THE


FOLLOWING REQUIREMENTS:

- MIN. 5.7 SF IN OVERALL SIZE
- MIN. 24" CLEAR OPENING HEIGHT MIN. 20" CLEAR OPENING WIDTH
- SILL A MAX. OF 44" ABOVE FINISHED FLOOR


WALL LEGEND



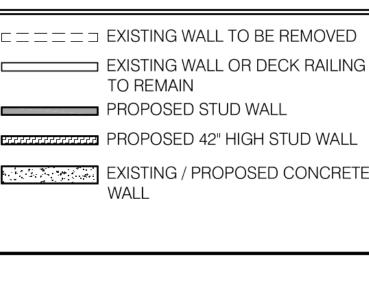

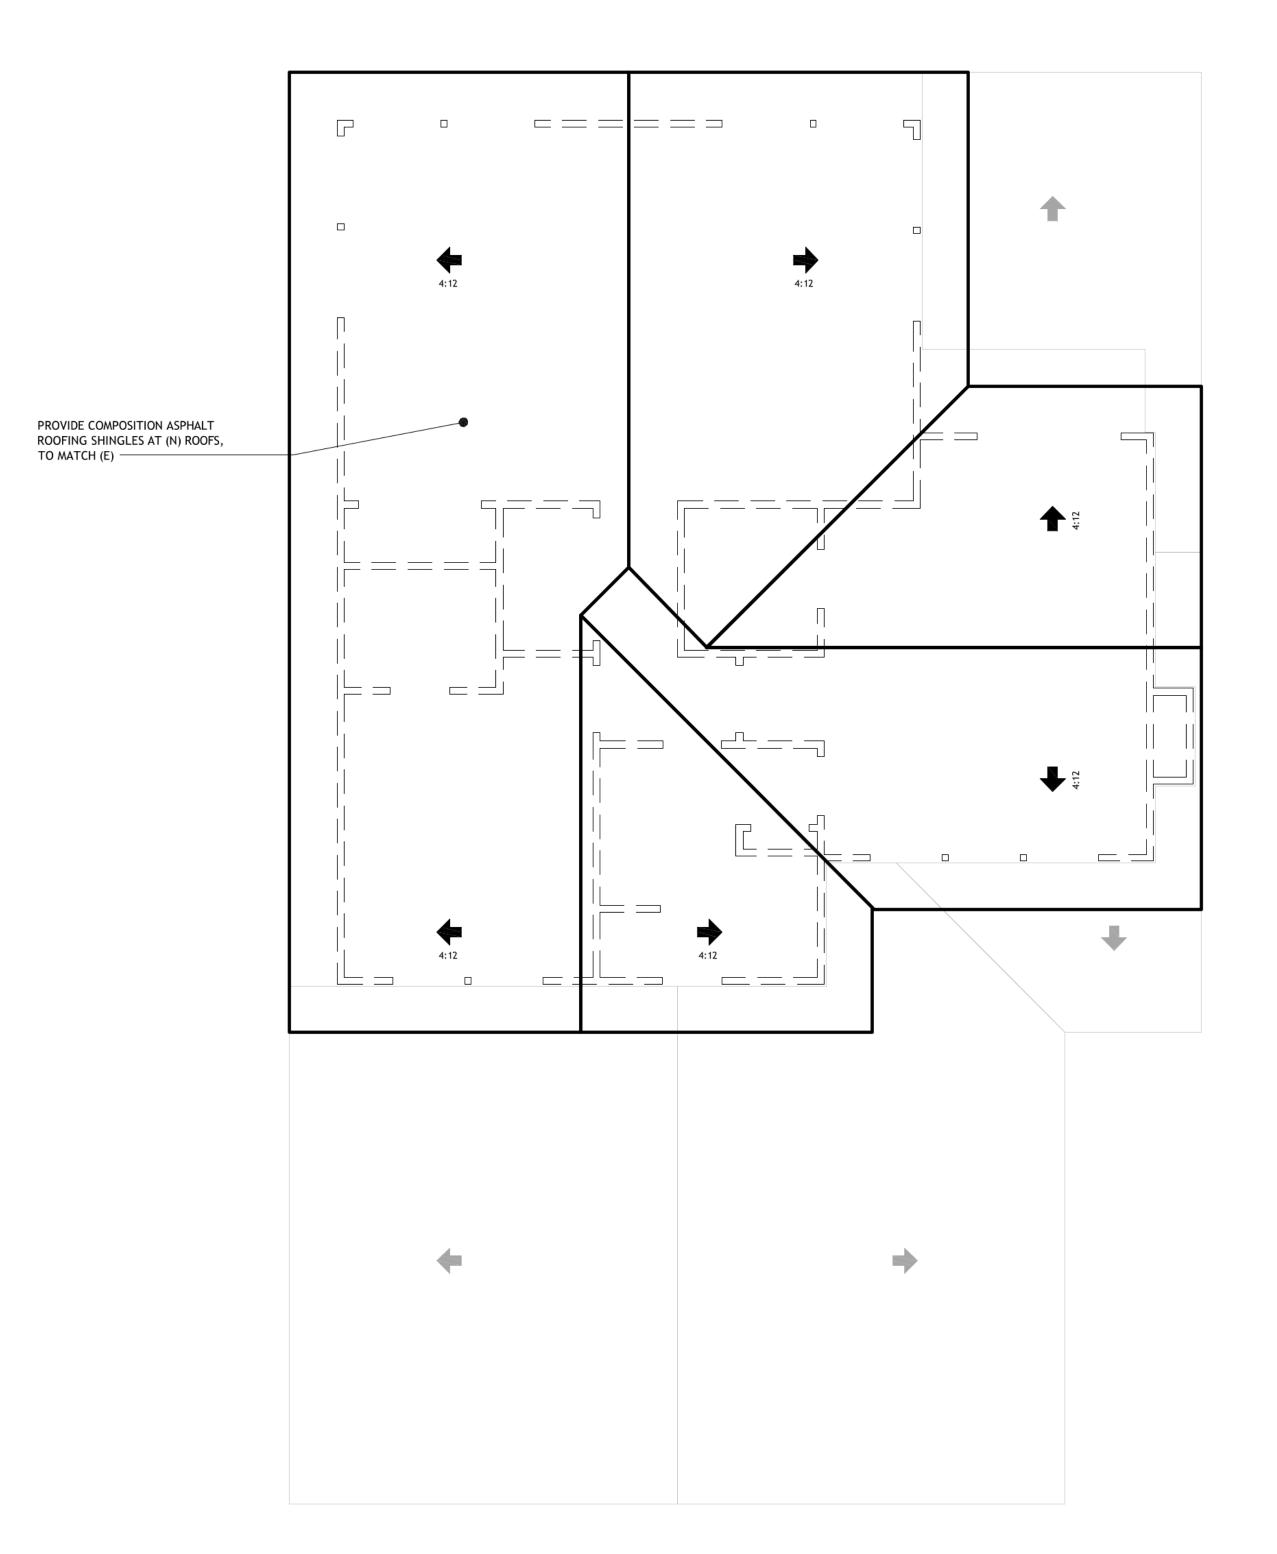




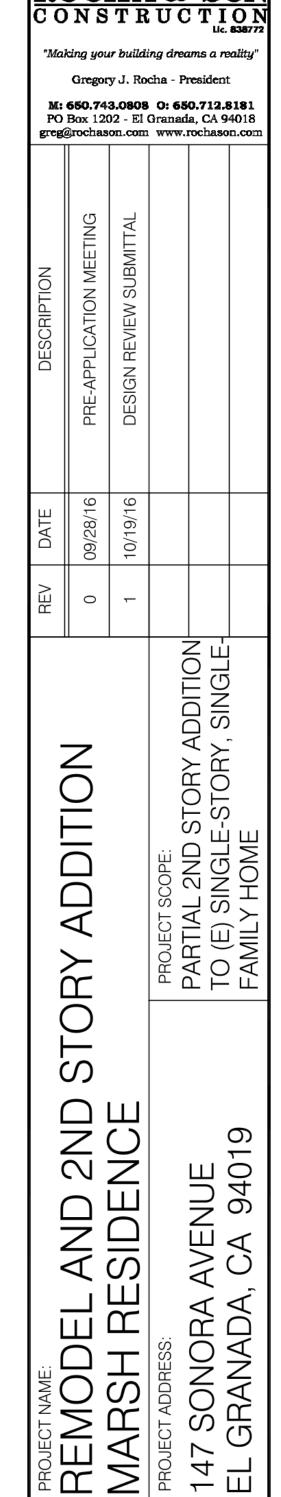


SHEET TITLE:

NEW UPPER ROOF PLAN

A2.3

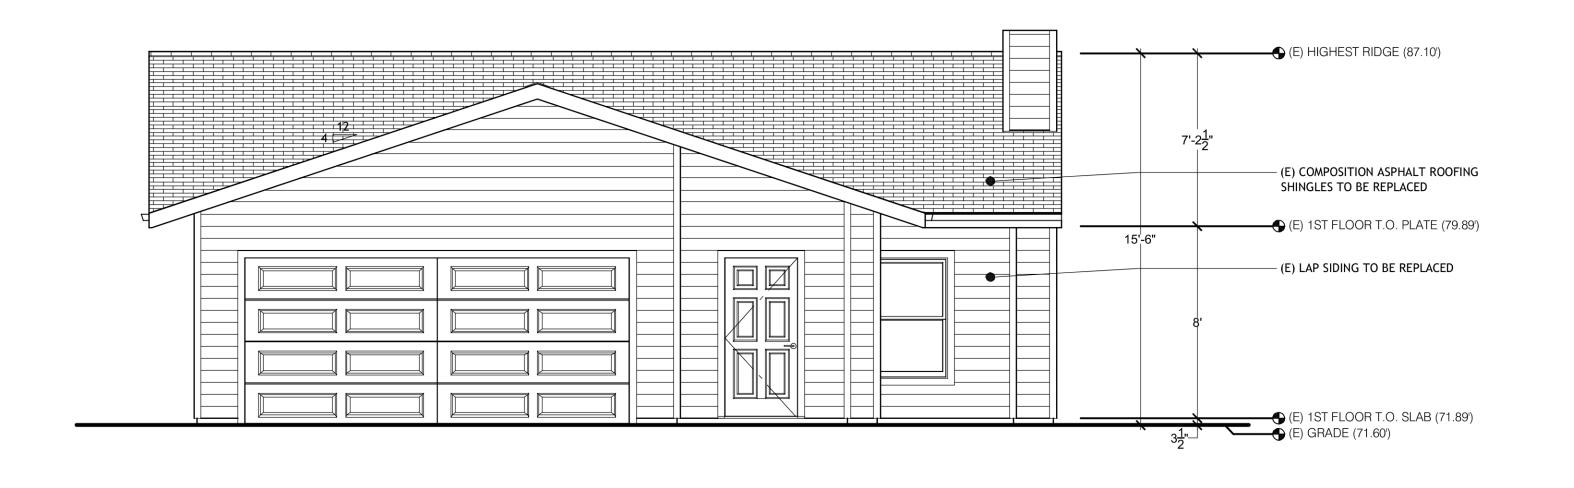

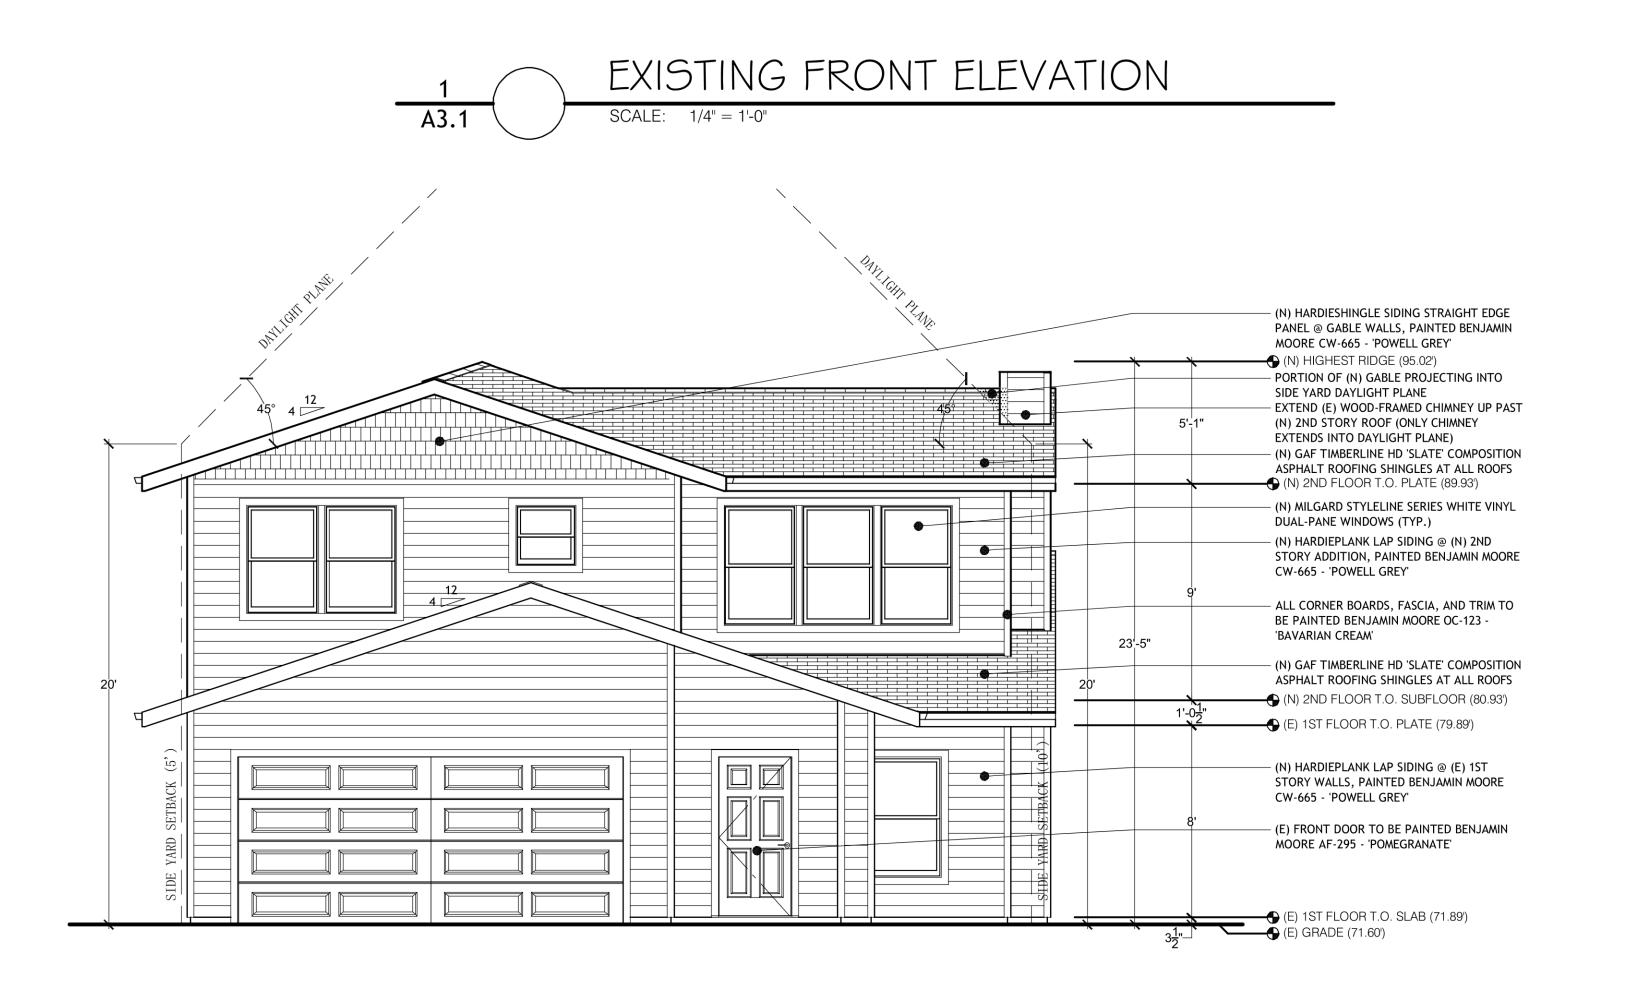

2	NEW FRONT ELEVATION
A3.1	SCALE: 1/4" = 1'-0"

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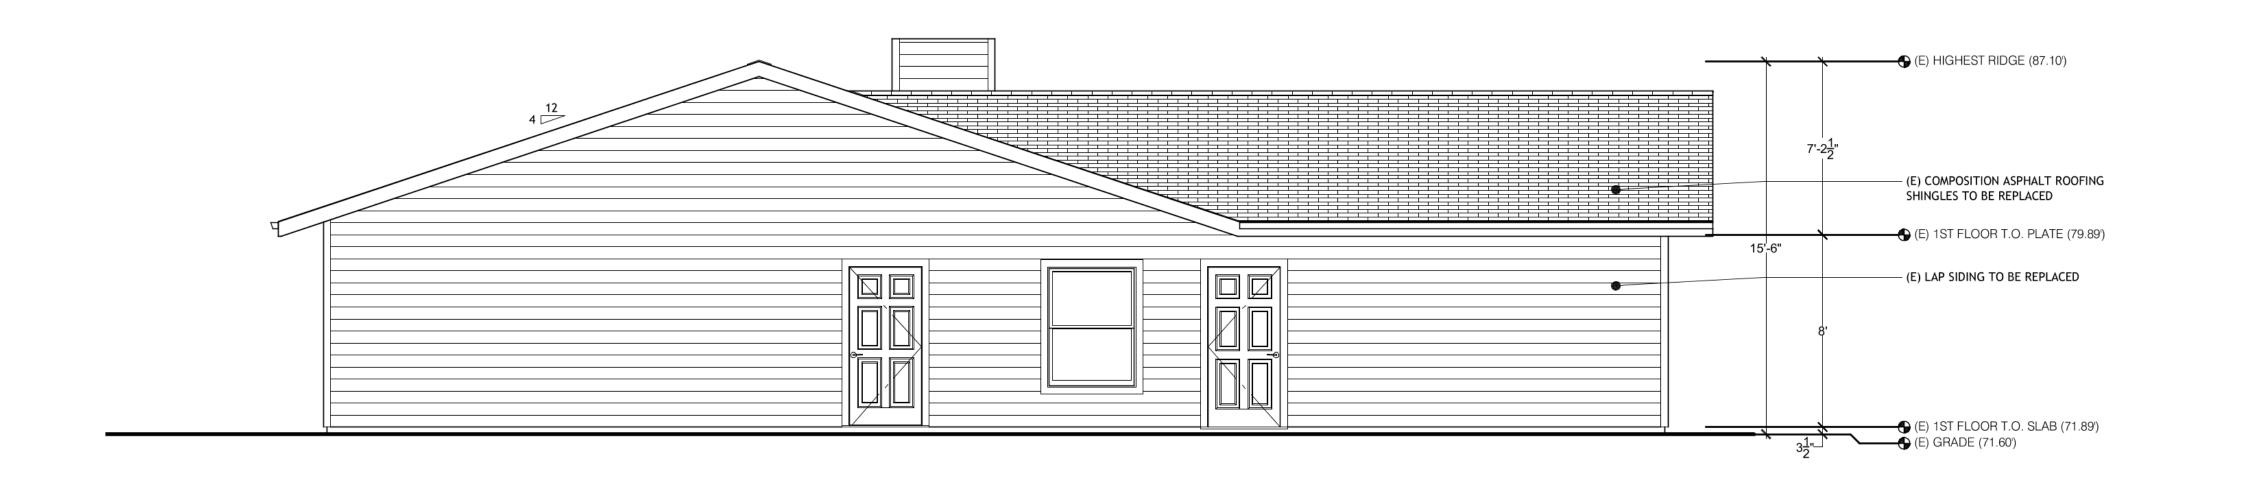
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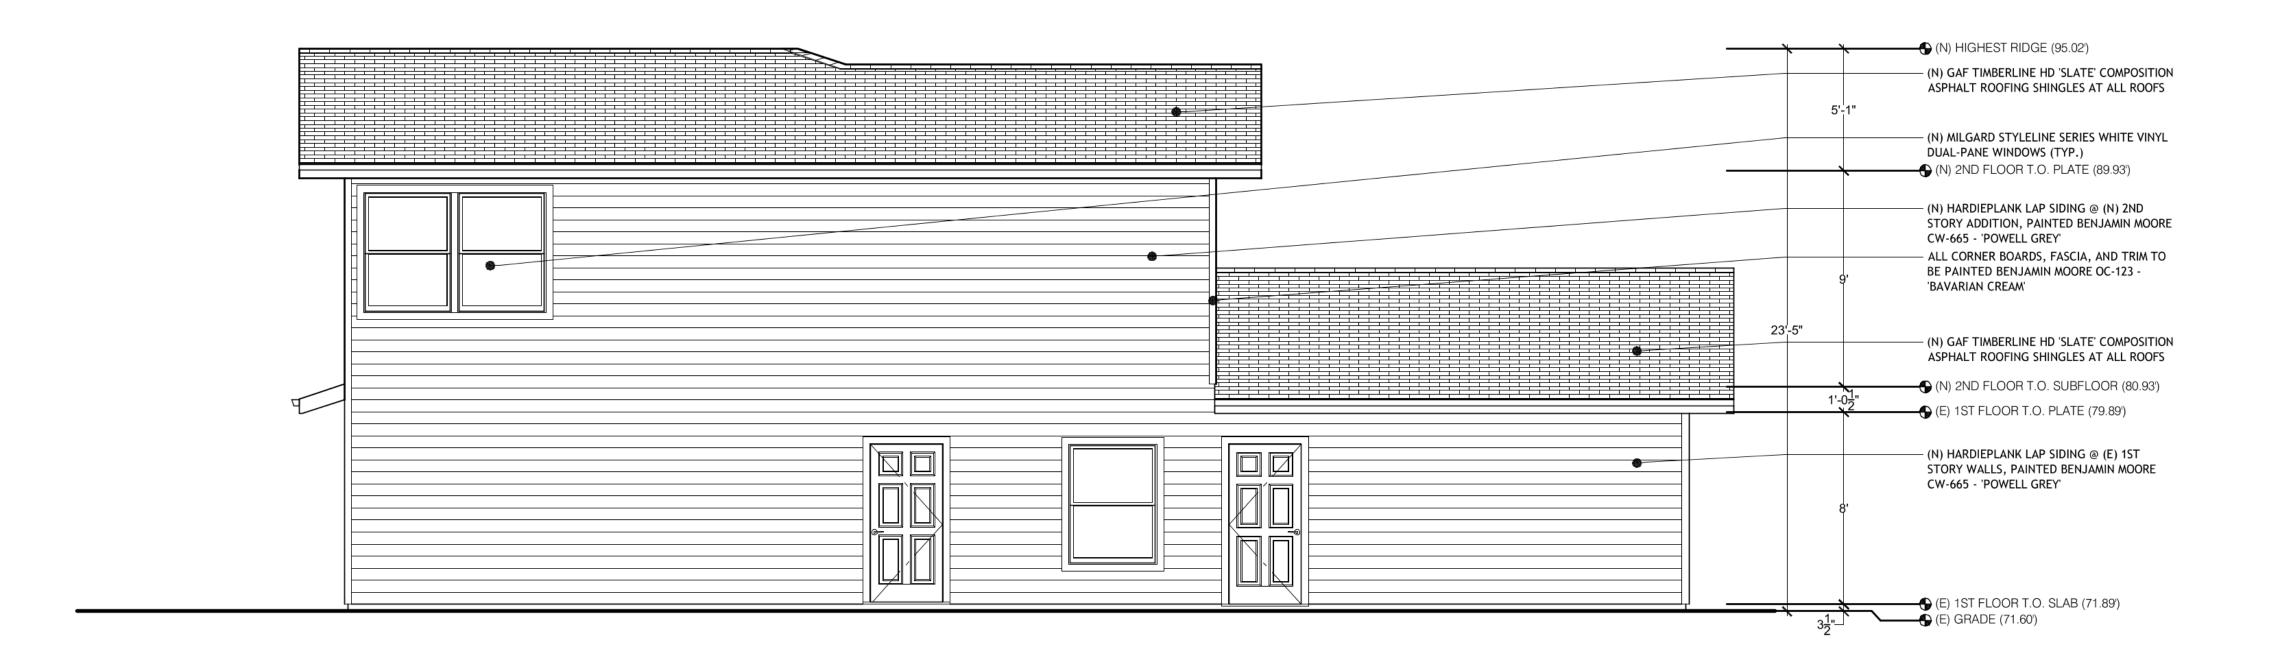
Gregory J. Rocha - President M: 650.743.0808 O: 650.712.8181 PO Box 1202 - El Granada, CA 94018 greg@rochason.com www.rochason.com STORY ADDITION STORY SINGLE -STORY, SINGLE -STORY, SINGLE -STORY, SINGLE -STORY SINGLE -STORY SINGLE -STORY SINGLE		OCI NS	HATR			
HOUSET NAME: REMODEL AND 2ND STORY ADDITION MARSH RESIDENCE PROJECT SCOPE: PROJECT SCOPE:	M: (Gregor 6 50.74 Box 120	ur buildi y J. Ro 3.0808 02 - El (ing dre cha - F O: 68 Granac	ams a re President 50.712.4 da, CA 9	eality" t B181 94018
REMODEL AND STORY ADDITION HARSH RESIDENCE PROJECT ADDRESS: 147 SONORA AVENUE EL GRANADA, CA 94019 PROJECT NAME TO (E) SINGLE-STORY, SINGLE-TOWN FAMILY HOME						
REMODEL AND 2ND STORY ADDITION HARSH RESIDENCE PROJECT ADDRESS: 147 SONORA AVENUE EL GRANADA, CA 94019 FROJECT NAME TO (E) SINGLE-STORY, SINGLE-TOWN FAMILY HOME	DATE	09/28/16	10/19/16			
A SI PROJECT NAME: REMODEL AND 2ND STOF MARSH RESIDENCE PROJECT ADDRESS: 147 SONORA AVENUE EL GRANADA, CA 94019	REV	0	-			
EXISTING AND NEW FRONT				PROJECT SCOPE:	PARTIAL 2ND STORY / TO (F) SINGLE-STORY	FAMILY HOME
NEW FRONT	PROJECT NAME:	KEMODEL AND ZND (MARSH RESIDENCE	PROJECT ADDRESS:	147 SONORA AVENUE	EL GRANADA, CA 94019
	NE	ΞW	FF	RO	NT	•

A3.

SHEET:







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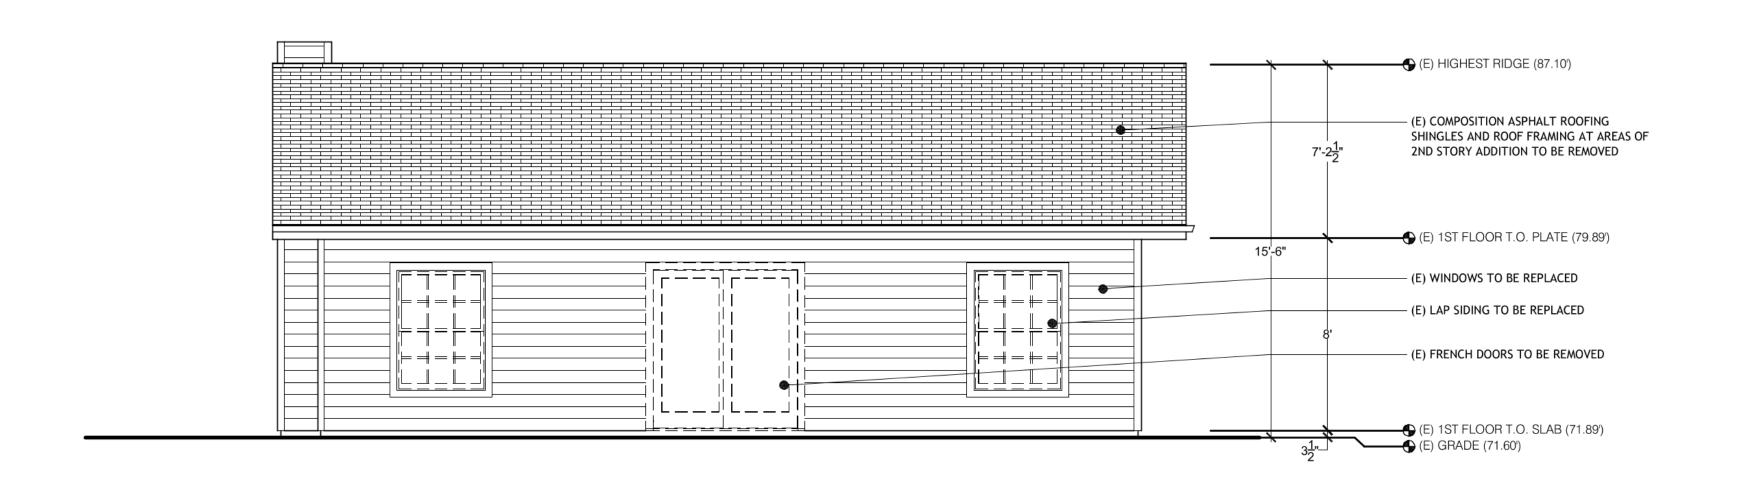
NEW LEFT ELEVATION


SCALE: 1/4" = 1'-0"

CONSTRUCTION "Making your building dreams a reality" Gregory J. Rocha - President M: 650.743.0808 O: 650.712.8181 PO Box 1202 - El Granada, CA 94018 greg@rochason.com www.rochason.com SCOPE: 2ND STORY ADDITION— SINGLE-STORY, SINGLE-HOME ADDITION STORY REMODEL AND 2ND MARSH RESIDENCE PROJECT ADDRESS:
147 SONORA AVENUE
EL GRANADA, CA 94019 SHEET TITLE: EXISTING AND NEW LEFT ELEVATIONS

SHEET:

A3.2



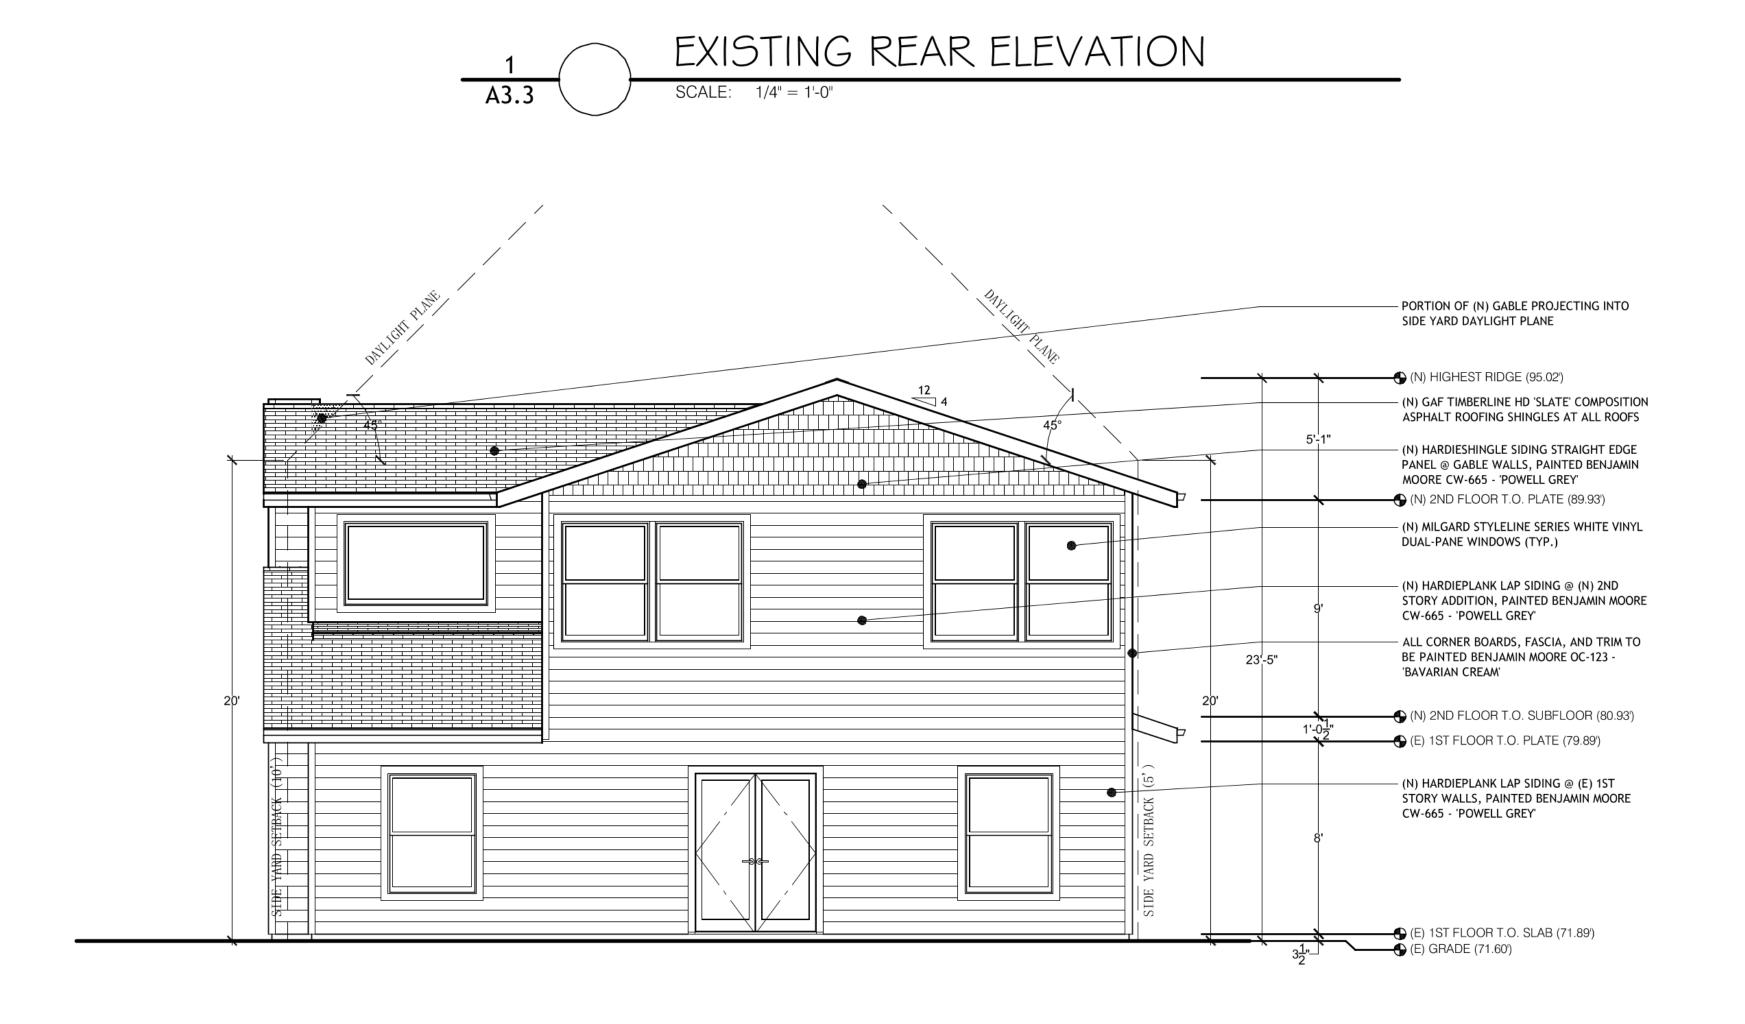




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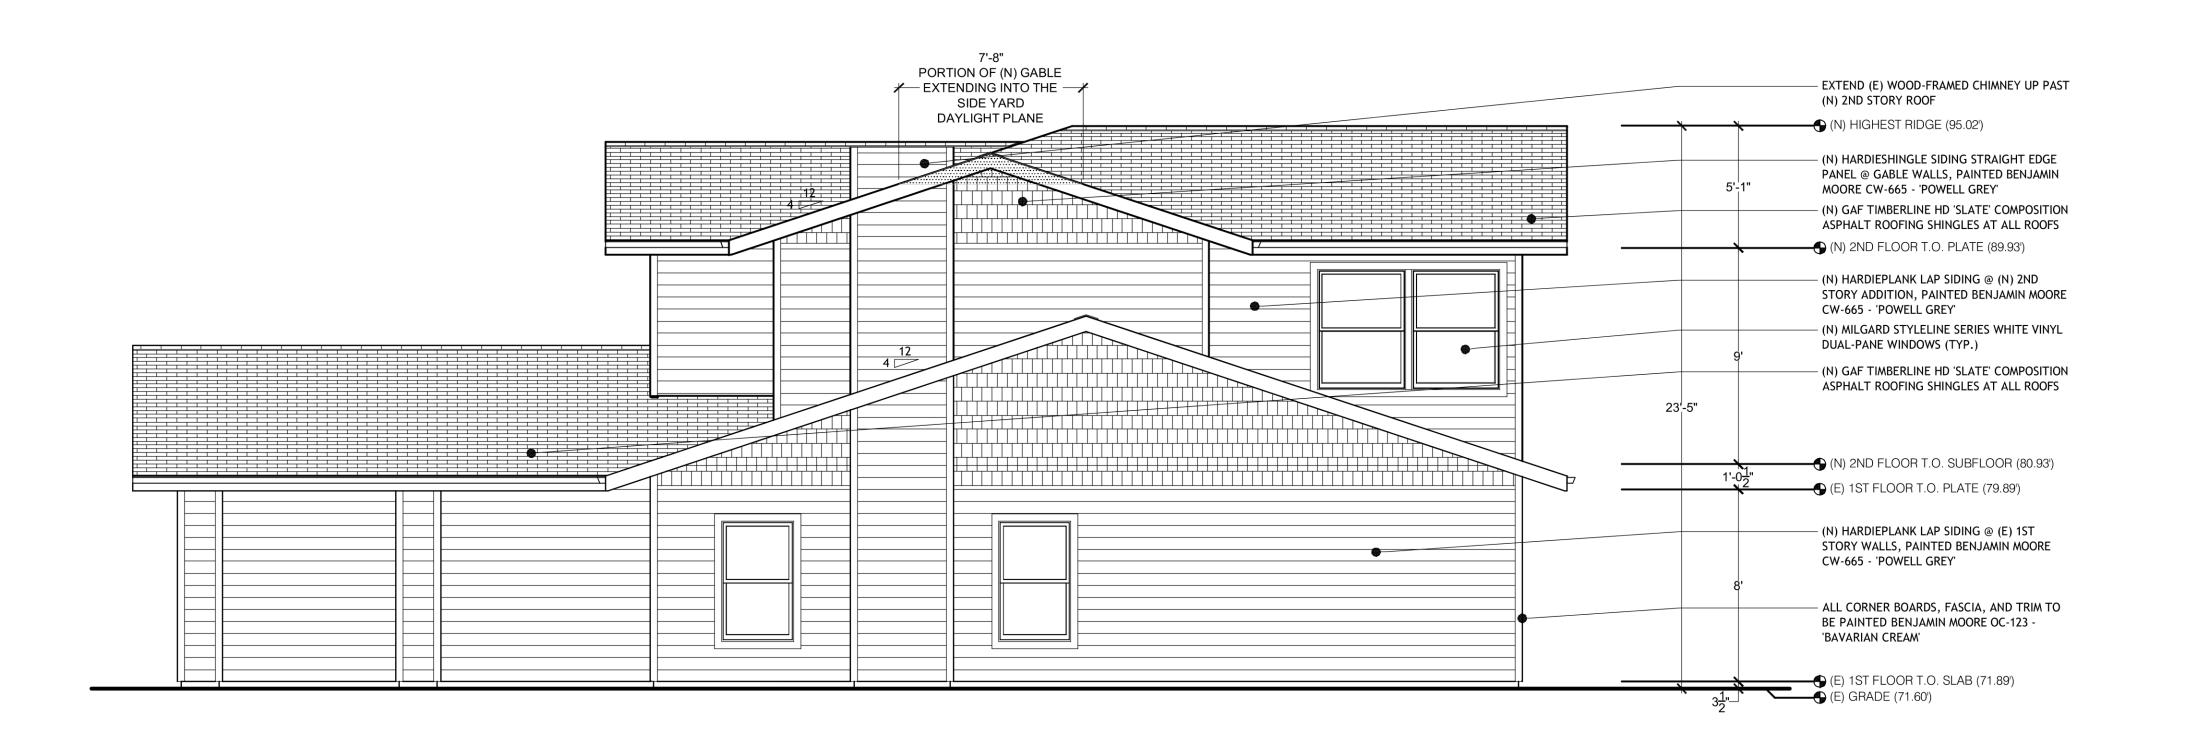
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147 SONORA AVENUE
EL GRANADA, CA 94019 SHEET TITLE: EXISTING AND NEW REAR ELEVATIONS


SHEET:

A3.3



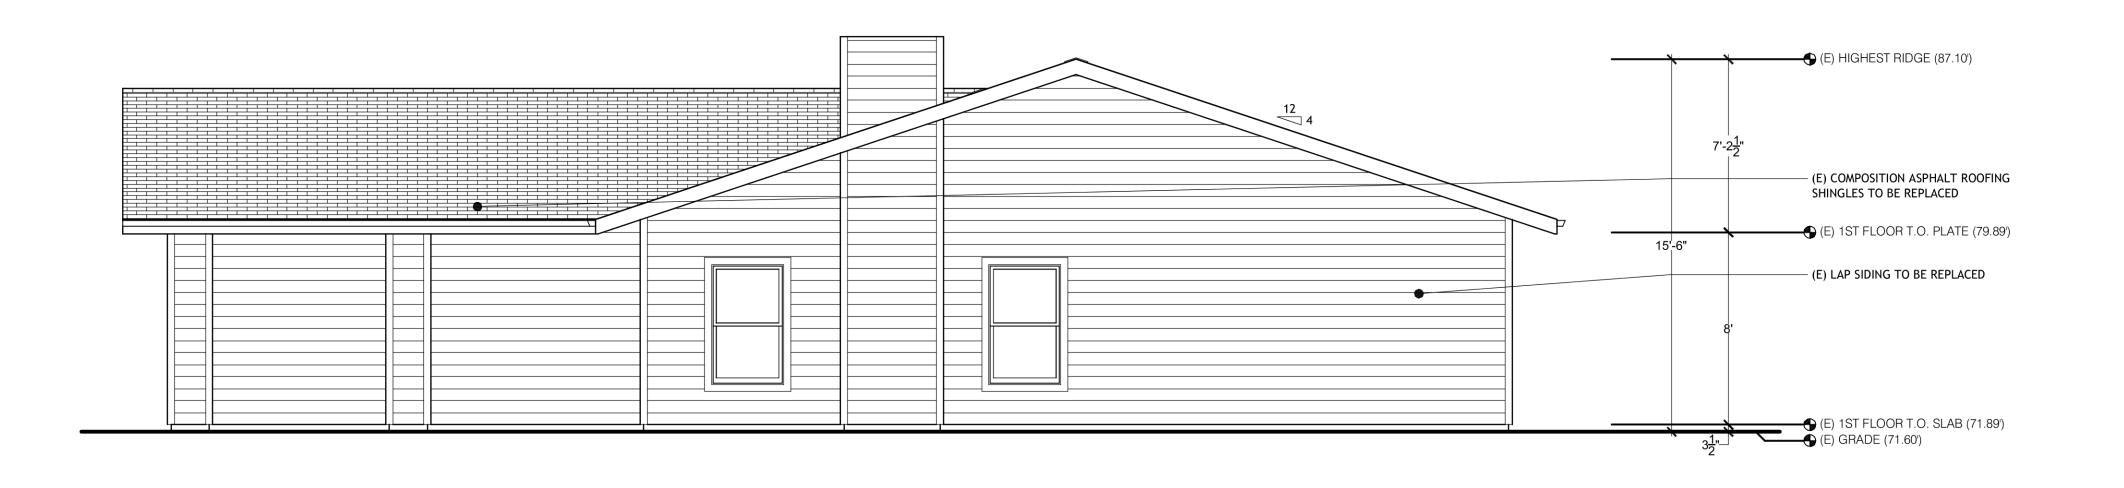



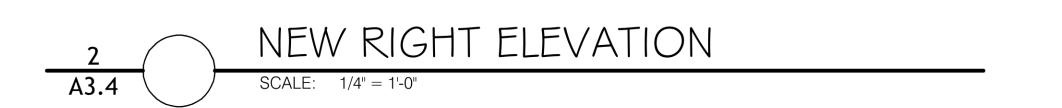


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M: PO	Gregor 650.74 Box 12	y J. Roo 3.0808 02 - El (cha - F O: 6 l Granae	ams a n Presiden 50.712. da, CA 9	t 8181 94018
DESCRIPTION	PRE-APPLICATION MEETING	DESIGN REVIEW SUBMITTAL			
DATE	0 09/28/16	10/19/16			
REV	0				
	SIORY ADDIIION		PROJECT SCOPE:	PARTIAL 2ND STORY ADDITION TO (F) SINGI F-STORY SINGI F-	FAMILY HOME
PROJECT NAME:	REMODEL AND ZND STORY	MARSH RESIDENCE	PROJECT ADDRESS:	147 SONORA AVENUE	EL GRANADA, CA 94019
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CONSTRUCTION
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		REV	REV DATE	
ر ا	ORY ADDITION	0	0 09/28/16	
ESIDENCE		-	10/19/16	
AVENUE	PROJECT SCOPE: PARTIAL 2ND STORY ADDITION TO (E) SINGLE-STORY, SINGLE-			
いっつけのこう	FAMILY HOME			

SHEET TITLE:

NEW SECTION

SHEET:

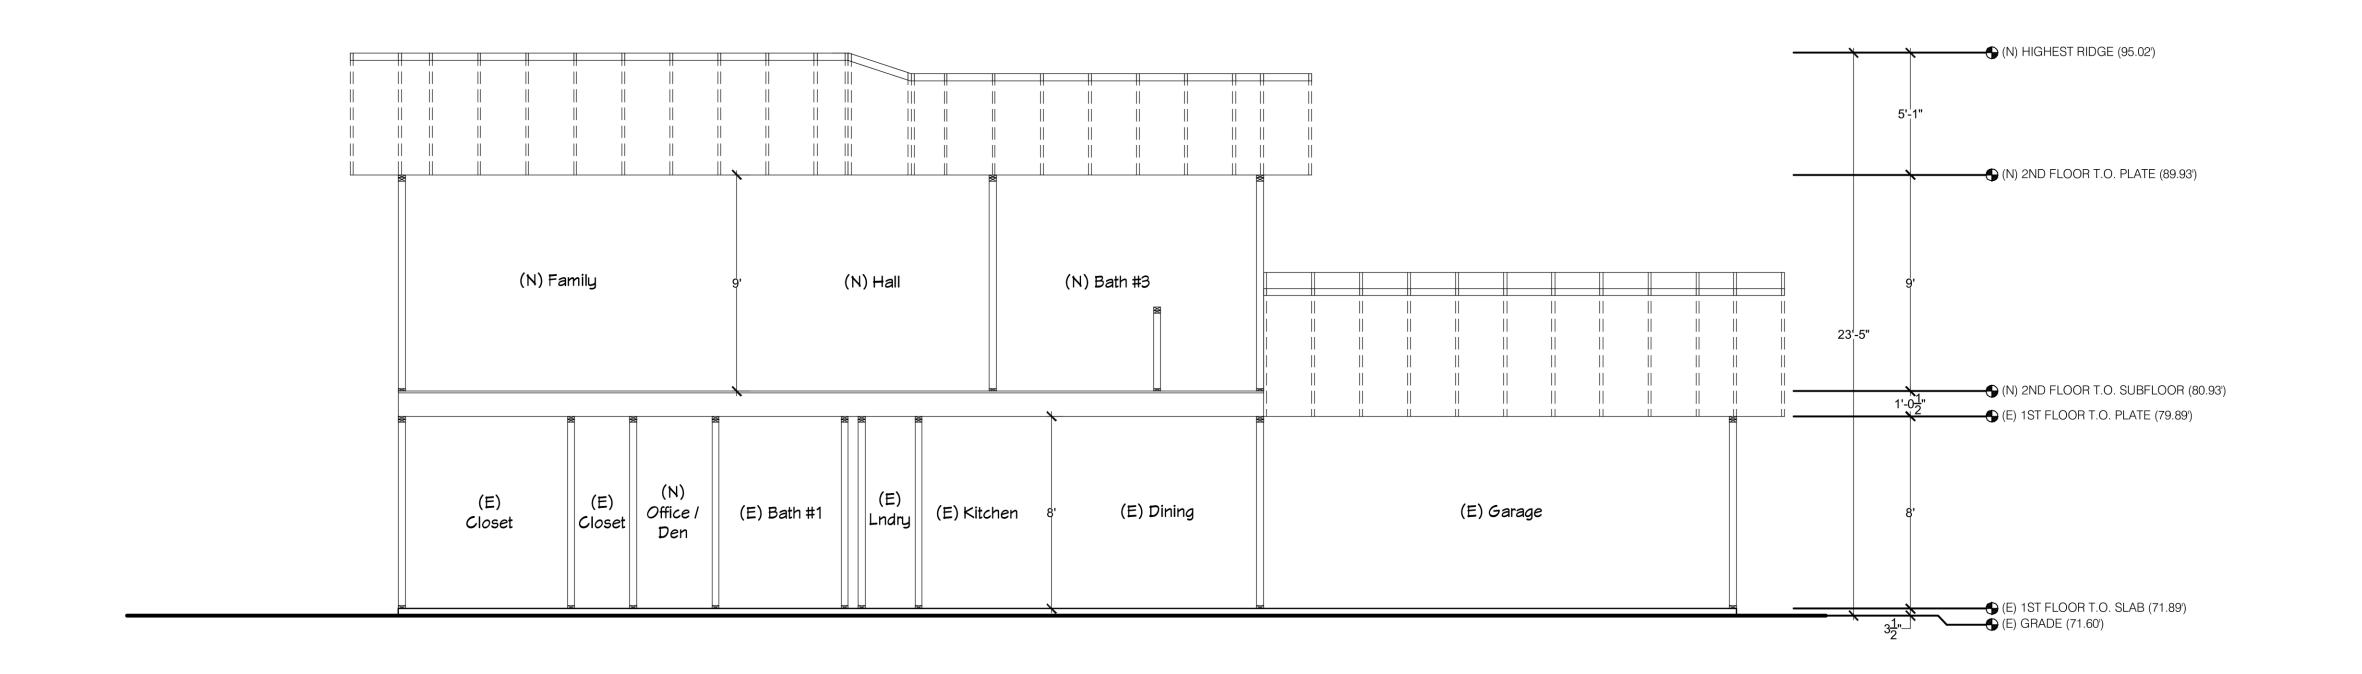A3.5