
SELECTED PROPERTY

Situs: 1455 Audubon Avenue, Montara

Owner: Bewley Sirje M Tr, P O Box 370453, Montara, CA, 94037-

APN: 036310180

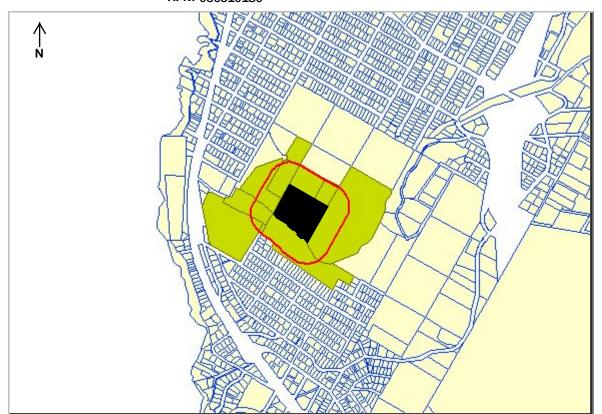

San Mateo County Environmental Services Agency 5.你不过过他来的对话里的**为**你还在他还有这个人,我们就是这种,我们就是这个人,我们就是这个人,我们就是这个人,我们就是这个人,我们就是这个人,我们就是这个人,

Panking zing Benfoling Division

Planning Permit

455 County Center • Redwood City CA 94063 (650) 363-4161 • FAX (650) 363-4849

| Application Form | Permit Numbers Primary: PLN 6 | 2010-00079 |
|--|---|------------------------------------|
| Application Form | BLD | , |
| Applicant/owner Information. | | |
| Applicant: Sirje Bewley Henri Manni | K | |
| | ee Altached | Zip; 94037 |
| Phone, W: H: 650-728-3 | | Zip, 94001 |
| Name of Owner (1): Sirje Bewley | Name of Owner (2): | |
| Mailing Address: P.O. BOX 370453, Montara, CA | Mailing Address: | |
| Zip: 94037 | | Zip: |
| Phone,W: | Phone,W: | |
| H: 650-728-3188 | H: | |
| Project Information | | |
| Project Location (address): | Assessor's Parcel Number | |
| Audubon Ave. | 036 — 310 — 180 | · |
| Montara, CA 94037 | | |
| Zoning: P.A.D C.D. | Parcel/lot size: 8.199 acres | |
| List all elements of proposed project: Please see attached s | supplement. | |
| | | |
| | | |
| ist any other permits or approvals already obtained for this None. | project (include date, agency and ap | plication/permit numbers): |
| | | N-187-1 |
| Normania de la compania de la compa | | |
| We hereby certify that the information stated above and on | forms, plans and other materials subn | nitted herewith in support |
| f the application is true and correct to the best of our known trough our assigned project planner of any changes to info | vieage. It is our responsibility to inform ormation represented in these submitt | o the County of San Mateo rais. |
| wner's signature: Du Bulley | | ch 15-2010 |
| wner's signature; | | 0~15,0010 |
| | ~ ~ ~ ~ ~ ~ ~ ~ ~ ~ ~ ~ ~ ~ ~ ~ ~ ~ ~ | |
| oplicant's signature: | **************** | |

San Mateo County Environmental Services Agency

Application for a **Planned Agricultural** District Permit

Companion Page

Planning and Building Division

San Mateo County Planning and Building Division 455 County Center - Second Floor - Redwood City CA 94063 Mail Drop PLN 122 - 650 - 363 - 4161 - FAX - 650 - 363 - 4849

Applicant's Name: Sirje Bewley Manni K

Primary Permit #:

PW2010-00079

Instructions

Please fill out the general Planning Permit Application Form and this form when applying for a Planned Agricultural District Permit.

You must also submit:

- All items indicated on the checklist found on the reverse side of the Planning Permit Application Form.
- A brief written statement presenting evidence which demonstrates that the project will comply with the
- Substantive Criteria for Issuance of a Planned Agricultural Permit.
- Agricultural Land management Plan for parcels 20 acres or more (See Zoning Regulations 6361C).
- Master Land Division Plan (for land divisions only; see Zoning Regulations Section 6361A). The plan should show how the parcel will be divided and which parcels will be used for agricultural and non-agricultural uses.

| Parcel/Lot Size: 8.199 acres | Current land use and existing structures: |
|---|--|
| Density analysis credits: 1 | Vacant lot with no existing structures |
| Density anaylsis file number: | |
| Application for: | |
| ☐ land division ☐ land conversion ☐ lot line adjustment Prime soils: None | Water consumption data associated with proposed land use: Standard domestic use with water conserving fixtures and appliance: Assume 60 gallons per bedroom maximum per day: 240 gal.per day Actual daily domestic use may be 60 to 180 gallons per day. acres |

Approval Considerations

To approve this application, the County must find that this project complies with all provisions of the Planned Agricultural District and other applicable regulations. You are strongly encouraged to familiarize yourself with the Planned Agricultural District regulations which are available from the

zoning counter. Of particular importance are the Substantive Criteria for Issuance of a Planned Agricultural Permit, set forth in Section 6355 of the Planned Agricultural District regulations.

San Mateo County Environmental Services Agency

Application for a Grading Permit Land Clearing Companion Page

Easic Information - Land Glearing

Planning and Building Division

County Government Center • 455 County Center • Redwood City CA 94063 Mail Drop PLN 122 • 650 • 363 • 4161 • FAX 650 • 363 • 4849

 $f f egin{array}{c} f egin$

Applicant's Name: Sirje Bewley Mannik

Primary Permit #: PUN 2010-00079

Lustractions

Land Clearing Operator

Please fill out the general Planning Permit Application Form and this form when applying for a Grading Permit. You must also submit all items indicated on the checklist found on the reverse side of the Planning Permit Application Form.

Disposal Site:

| Name: | |
|---|--|
| Address | |
| Zip: | Purpose of removal: |
| Phone: | , dipose di terriover. |
| License #: | |
| • Area to be cleared: so | η, ft. |
| Average slope of area to be cleared: | |
| Type of vegetation to be removed: | |
| | |
| • | |
| | |
| The land clearing Plan Requirem The land clearing plans must show: (1) Property lines. (2) Location of area to be cleared | (3) Existing structures |
| he land clearing plans must show: | |
| The land clearing plans must show: (1) Property lines. (2) Location of area to be cleared. AFEASIC Information - Grading | (3) Existing structures (4) Erosion control measures. |
| The land clearing plans must show: (1) Property lines. (2) Location of area to be cleared. 4. Easic Information - Grading Frading Operator | (3) Existing structures |
| The land clearing plans must show: (1) Property lines. (2) Location of area to be cleared. 4. Basic Information - Grading Finading Operator Jame: | (3) Existing structures (4) Eroslon control measures. Geotechnical Consultant |
| The land clearing plans must show: (1) Property lines. (2) Location of area to be cleared. 44 Easic Information - Grading Grading Operator Jame: | (3) Existing structures (4) Eroslon control measures. Geotechnical Consultant Name: Joel Baldwin, Earth Investigations |
| The land clearing plans must show: (1) Property lines. (2) Location of area to be cleared. 4. Basic Information - Grading Finading Operator Jame: | (3) Existing structures (4) Erosion control measures. Geotechnical Consultant Name: Joel Baldwin, Earth Investigations Address: P.O. Box 795 Pacifica, CA |
| The land clearing plans must show: (1) Property lines. (2) Location of area to be cleared. A Basic Information - Graeling Grading Operator Jame: ddress: | (3) Existing structures (4) Eroslon control measures. Geotechnical Consultant Name: Joel Baldwin, Earth Investigations Address: P.O. Box 795 |

| Name: Sherwood Design E | ngineers | Haul site: | |
|---|---------------------------|------------------------|-------------------------------------|
| Address: One Union Street | | Purpose of grading: | 7 |
| San Francisco, CA | | Road and patio grading | |
| Phone: 415-677-7300 | Zip: 94111 | | Septiment of the page of the second |
| License #: | | | |
| • Engineer's estimate of the qui moved: | antity of materials to be | | |
| cut: | 917 cubic yards | | bers of any adjacent property |
| fill: | 1189 cubic yards | | applicant, now or in the past: |
| Depth of cut: | Varies 4 ft. | | |
| Depth of fill: | Varies 8 ft. | | A The second of the second |
| | | | |

5. Grading Plan Requirements

The grading plans, 24"x36", prepared and signed by a civil engineer shall contain the following:

- (1) All of the proposed uses for which the proposed grading is necessary.
- (2) Boundary lines of the site.
- (3) If there is a proposed subdivision, each lot or parcel of land into which the site is proposed to be divided.
- (4) The location of any existing buildings, structures, easements or underground utilities on the property where the work is to be performed and the location of any buildings or structures on adjacent land within 50 feet of the proposed work.
- (5) Accurate contours showing the topography of the existing ground extending at least 10 feet outside all boundary lines of the project site.
- (6) Elevations, locations, extent and slope of all proposed final grading shown by contours. Location of any rock disposal areas, buttress fills, subdrains, or other special features to be included in the work.
- (7) A statement of the quantities of material to be excavated and/or filled and the amount of such material to be imported to, or exported from, the site.

- (8) Location and nature of known or suspected soil or geologic hazard areas.
- (9) Specifications, cross-sections, profiles, elevations, dimensions and construction details based on accurate field data.
- [10] Construction details for roads, watercourses, culverts, bridges and drainage devices, retaining walls, gabion walls, cribbing, dams, and other improvements existing or to be constructed, together with supporting calculations and maps.
- (11) Approximate boundaries of any areas with a history of flooding.
- [12] Location, width, direction or flow and approximate location of top and toes of banks or any watercourse.
- (13) General location and character of vegetation covering the site, including all trees proposed to be removed and all trees 12" dbh within 20 feet of the area to be disturbed.
- (14) Name and registration number of the registered California civil engineer under whose direction the grading plan is prepared.

San Mateo County Environmental Services Agency

Application for a Coastal Development Permit

Companion Page

Planning and Building Division

County Government Center • 455 County Center • Redwood City CA 94063 Mail Drop PLN 122 • 650-363-4161 • FAX 650-363-4849

| Primary Permit #: | Applicant's Name: | Sirje Bewley | | | |
|-------------------|-------------------|--------------|--|--|--|
| | Primary Permit #: | | | | |

1. Instructions

Please fill out the general Planning Permit Application Form and this form when applying for a Certificate of Exemption or Exclusion from Requirement for Coastal Development Permit. You must also submit all items indicated on the checklist found on the reverse side of the Planning Permit Application Form.

| 2. Basic Information | |
|--|--|
| Does the owner or applicant own any adjacent property not listed? Yes No | Have you or anyone else previously applied to either the County of San Mateo or the California Coastal Commission for a Coastal Development Permit for this or a similar project at this location? |
| | ☐ Yes ☐ No |
| If yes, list Assessor's Parcel Number(s): | If yes, explain (include date and application file numbers). |
| | |
| | |
| | • |
| | |

3. Materials and Finish of Proposed Buildings or Structures

Note: By completing this section you do not need to file a separate application for Design Review Approval.

| | | | matches |
|------------------------|---|------------------------------|----------|
| Fill in Blanks: | Material | Color/Finish | existing |
| a. Exterior Walls | Lime Plaster | Off-white: Bone | |
| b. Trim | Redwood trim and siding | Dark Brown Stain | |
| c. Roof | Composition Shingle | Black, Architectural | |
| d. Chlmneys | Lime Plaster | Off-white: Bone | |
| e. Accessory Buildings | Lime Plaster and Vertical Redwood | To match main building | |
| f. Decks/Stairs | Stucco over concrete masonry | Off-white: Bone | |
| g. Retaining Walls | Stucco & Stone over concrete masonry | Off-white stucco. | |
| h. Fences | Wire Mesh or Stucco over concrete masonry | Off-white: Bone | |
| i. Storage Tanks | Steel with earth berms | Berms with living vegetation | |

| 4. Project Information | | | |
|--|-------------------|----------------|--|
| Does this project, the parcel on which it is lo immediate vicinity involve or include: | cated t | or the | p. Between the sea and the nearest public road? |
| , | Yes | No | q. Existing or proposed provisions for public 🔲 🔯 |
| a. Demolition of existing housing units? (If yes, give value of owner-occupied units or current monthly rent of rental | " i 🗖 , | X | access to the shoreline? r. Public or commercial recreation facilities? |
| units in explanation below.) | - N | | s. Visitor-serving facilities? |
| b. Creeks, streams, lakes or ponds? | ∇ | | t. Existing or proposed public trail |
| c. Wetlands (marshes, swamps, mudflats)? | | <u>×</u> | easements? |
| d. Beaches? | | X | Explain all Yes answers below. Indicate whether the |
| e. Sand Dunes? | | lacktriangle | item applies to the project itself, the parcel on which it is located, or the immediate vicinity (attach additional sheets if |
| f. Sea cliff, coastal bluffs or blufftops? g. Ridgetops? | | X | necessary): |
| h. Pampas Grass, invasive brooms or | ⊠ | IX.) | Please see attached supplement for explanations. |
| Weedy Thistle? | Т | L,i | |
| i. Removal of trees or vegetation? | | | 1. 1. 1. 1. 1. 1. 1. 1. 1. 1. 1. 1. 1. 1 |
| j. Grading or alteration of landforms? | \boxtimes | | |
| k. Landscaping? | ⊠ | | |
| I. Signs? | | ☑ | |
| m. Phone or utility line extensions or connections, either above or below ground (explain which)? | | | |
| n. Areas subject to flooding? | | | |
| o. Development on slopes 30% or steeper? | | | |
| | | | |
| 5. Staff Use Only | | | |
| California Coastal Commission Juri: | sdicti | on | Commission; a public hearing is always required. |
| A. Does the Proposed Project Involve: | | | B. Does the proposed project involve lands below the mean |
| I. A subdivision, Certificate of Compliance Type Permit, or Planned Agricultural District Permit | | e | high tide line and lands where the public trust may exist? (See "Post CCP Certification Permit and Appeal Jurisdiction Map). |
| ☑ Yes ☐ No | | | ☐ Yes ☑ No |
| Construction or grading within 100 feet of a wetland? | a strean | n or | |
| ☐ Yes ☐ No | • | | Yes to above means that the California Coastal Commission |
| 3. A parcel located between the sea and the fir through road paralleling the sea; 300 feet fro extent of any beach or mean high tide line if beach; or within 300 feet of the top of the se | om the there I | inland s no | retains permit jurisdiction over all or part of the proposed project. A Coastal Development Permit from that agency is required. |
| a coastal bluff? ☐ Yes ☐ No | | | Reviewed by: |
| · | | | |
| Yes to any one of the above means that the Co Development Permit is appealable to the Coasta | | | engendungstein gehalt der besteht in der besteht dage. |

Environmental Information Disclosure Form

Planning and Spilding Department

BLD___

| Α | ct Addres | the state of the s | Name of Owner: Sirje Bewley | | |
|---------------------------------------|---------------------|--|---|--|--|
| Audubon Ave | | | Address: P.O. BOX 370453, Montara, CA, 94037 | | |
| Montara, CA 94037 | | N 94037 | Phone: 650-728-3188 | | |
| Asses | sor's Pai | cel No.: 036 — 310 — 180 | Name of Applicant: Sirje Bewley Mahni K | | |
| | · | <u></u> | Address: | | |
| Zoning | g District | : P.A.D C.D. | Phone: 650-728-3188 | | |
| Ev | ictina | Site Conditions | | | |
| | size: <u>8.</u> | | | | |
| creeks | , vegetati | easements on the parcel, and a description | d uses on the project parcel, including the existence and of any natural features on the project parcel (i.e. steep terrain, | | |
| The | site consi | | e of the lot with a rayine on the South side along Montara Creek | | |
| | | | pastal Chaparral | | |
| · All Parties and the | | nental Review Checklist | | | |
| ike: | | Paylennestal anany Art (epse) | | | |
| Yes | No | Will this project involve: | | | |
| | - X | a. Addition to an existing structure > 50% | 6 of the existing area OR > 2,500 sq. ft? | | |
| | | | | | |
| | X | D. Construction of a new mutti-tamily rest | dential structure having 5 or more units? | | |
| · · · · · · · · · · · · · · · · · · · | X | | dential structure having 5 or more units? >> 2,500 sq.ft? | | |
| | | c. Construction of a commercial structure d. Removal of mature tree(s) (≥ 6" d.b.h residential zoning district)? | e > 2,500 sq.ft? In Emeraid Lake Hills area or ≥ 12" d.b.h. in any | | |
| X | Х | c. Construction of a commercial structure d. Removal of mature tree(s) (≥ 6" d.b.h. | rds (c.y.): | | |
| X | Х | c. Construction of a commercial structure d. Removal of mature tree(s) (≥ 6" d.b.h residential zoning district)? If yes, how many trees to be removed? e. Land clearing or grading? If yes, please state amount in cubic ya Excavation : 917 c.y | e > 2,500 sq.ft? In Emerald Lake Hills area or ≥ 12" d.b.h. in any rds (c.y.): 1,189 c.y. To tall | | |
| X | x | c. Construction of a commercial structure d. Removal of mature tree(s) (≥ 6" d.b.h residential zoning district)? If yes, how many trees to be removed? e. Land clearing or grading? If yes, please state amount in cubic ya Excavation: 917 c.y f. Subdivision of land into 5 or more parc | e > 2,500 sq.ft? In Emerald Lake Hills area or ≥ 12" d.b.h. in any rds (c.y.): 7. Fill: | | |
| X | X | c. Construction of a commercial structure d. Removal of mature tree(s) (≥ 6" d.b.h residential zoning district)? If yes, how many trees to be removed? e. Land clearing or grading? If yes, please state amount in cubic yate. Excavation: 917 c.y f. Subdivision of land into 5 or more parce. | e > 2,500 sq.ft? In Emerald Lake Hills area or ≥ 12" d.b.h. in any rds (c.y.): Fill: 1,189 c.y. cenic corridor? | | |
| X | X X X X | c. Construction of a commercial structure d. Removal of mature tree(s) (≥ 6" d.b.h residential zoning district)? If yes, how many trees to be removed? e. Land clearing or grading? If yes, please state amount in cubic yatex excavation: 917 c.y f. Subdivision of land into 5 or more parce g. Construction within a State or County state. h. Construction within a sensitive habitat? | e > 2,500 sq.ft? In Emerald Lake Hills area or ≥ 12" d.b.h. in any rds (c.y.): // Fill: | | |
| X | X X X X | c. Construction of a commercial structure d. Removal of mature tree(s) (≥ 6" d.b.h residential zoning district)? If yes, how many trees to be removed? e. Land clearing or grading? If yes, please state amount in cubic ya Excavation: 917 c.y f. Subdivision of land into 5 or more parc g. Construction within a State or County s h. Construction within a sensitive habitat? i. Construction within a hazard area (i.e. | e > 2,500 sq.ft? In Emerald Lake Hills area or ≥ 12" d.b.h. in any Inds (c.y.): Fill: 1,189 c.y. Cenic corridor? selsmic fault, landslide, flood)? | | |
| | X X X X X X explain | c. Construction of a commercial structure d. Removal of mature tree(s) (≥ 6" d.b.h residential zoning district)? If yes, how many trees to be removed? e. Land clearing or grading? If yes, please state amount in cubic yatex excavation: 917 c.y f. Subdivision of land into 5 or more parce g. Construction within a State or County state. h. Construction within a sensitive habitat? | e > 2,500 sq.ft? In Emerald Lake Hills area or ≥ 12" d.b.h. in any Inds (c.y.): Fill: 1,189 c.y. Cenic corridor? Selsmic fault, landslide, flood)? (check with Co. Env. Health Division)? | | |
| | X X X X X X explain | c. Construction of a commercial structure d. Removal of mature tree(s) (≥ 6" d.b.h residential zoning district)? If yes, how many trees to be removed? e. Land clearing or grading? If yes, please state amount in cubic ya Excavation: 917 c.y f. Subdivision of land into 5 or more parce g. Construction within a State or County sh. Construction within a sensitive habitat? i. Construction within a hazard area (i.e. sh. Construction on a hazardous waste site all "Yes" answers: | e > 2,500 sq.ft? In Emerald Lake Hills area or ≥ 12" d.b.h. in any Inds (c.y.): Inds (c.y.): Fill: Cenic corridor? Selsmic fault, landslide, flood)? Check with Co. Env. Health Division)? | | |

| Yes | No | Marine Fisheries Rule 4(a) Review Will the project involve: |
|-------|---------|--|
| | X | a. Construction outside of the footprint of an existing, legal structure? |
| | X | b. Exterior construction within 100-feet of a stream? |
| -T | X | c. Construction, maintenance or use of a road, bridge, or trail on a stream bank or unstable hill slope? |
| | Х | d. Land-use within a riparian area? |
| Х | | e. Timber harvesting, mining, grazing or grading? |
| | Х | f. Any work inside of a stream, riparian corridor, or shoreline? |
| | X | g. Release or capture of fish or commerce dealing with fish? |
| lease | explain | any "Yes" answers: |
| • | | There will be grading for the construction of the residence, approach road and site drainage. |

| 8) N | Hortal I | Collumnt Discharge Ellinination System (Nights) Review |
|---------------------------------|----------|---|
| Yes | No | Will the project Involve: |
| | X | A subdivision or Commercial / Industrial Development that will result in the addition or replacement of 10,000 sq. ft. or more of impervious surface? If yes, Property Owner may be required to implement appropriate source control and site design measures and to design and implement stormwater treatment measures, to reduce the discharge of stormwater pollutants. Please consult the Current Planning Section for necessary forms and both construction and post-construction requirements. |
| Yes. 1.20 acre approx. | | b. Land disturbance of 1 acre or more of area? If yes, Property Owner must file a Notice of Intent (NOI) to be covered under the statewide General Construction Activities Storm Water Permit (General Permit) prior to the commencement of construction activity. Proof of coverage under State permit must be demonstrated prior to the issuance of a building permit. |

Certification

I hereby certify that the statements furnished above and in the attached exhibits present the data and information required for this initial evaluation to the best of my ability, and the facts, statements and information presented are true and correct to the best of my knowledge and belief. If any of the facts represented here change, it is my responsibility to inform the County.


Signed:


Date:

2010

Bewley Residence

Audubon

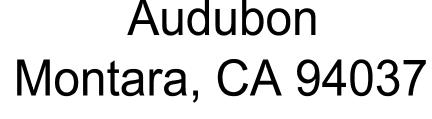

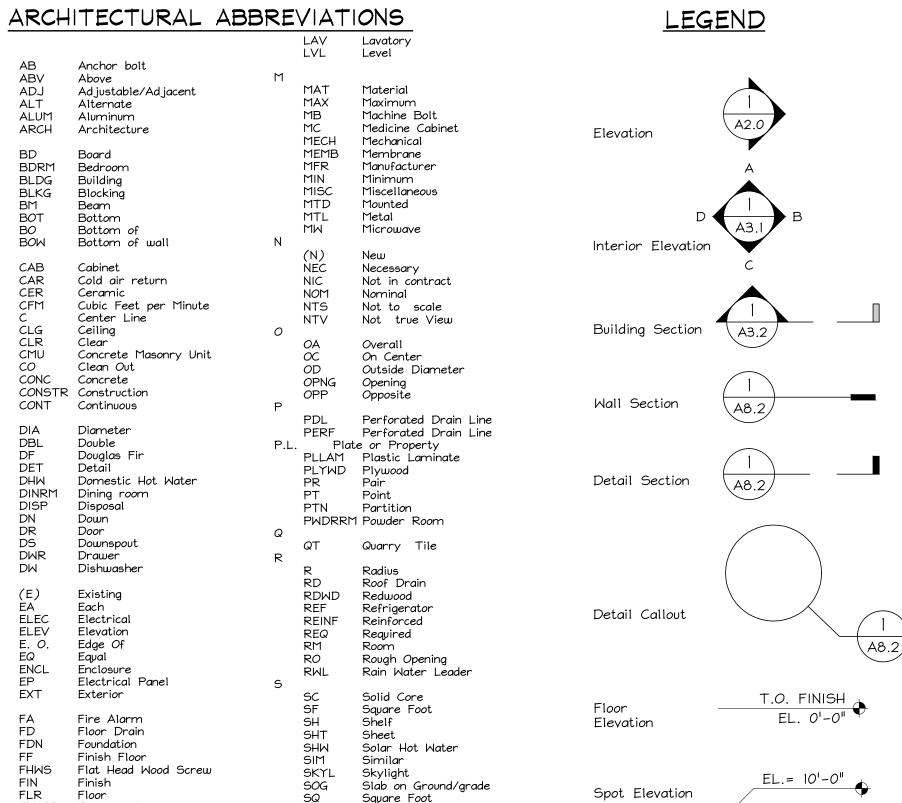

SOG SQ STD STOR See Civil Drawings See Landscape Drawings See Mechanical Drawings See Structural Drawinas Symmetrical 22-56 Key Note Towel Bar CSI # - Note # Tight Drain Line (Category#) - (Project Telephone Note #) Tongue and Groove

Threaded Top of Concrete Door Mark or Top of Wall Window Mark Typical D = DoorUnless Otherwise Noted W = Window M-1 = Level-Unit#Vertical e.g. = Main LVL-Window#1 Vertical Grain Doug Fir Warm Air Register

F-01 Finish Mark (P-01) Plumbing Mark

Appliance Mark

A-01

Number or Pounds Property Line or Plate

With

Water closet

Water heater

Water-Resistant

Welded Wire Mesh

Window

Wit.hout.

Waterproof

SMD SSD

TEL T#G

THRD

TOC

TOW TYP

UON

VERT

VGDF

MIND

MWM

LAM Laminate PROJECT DATA SEE AI.2 FOR ZONING DATA

FLUOR

FURR

GLB

HDR

HHM

HDMD

HDWR

Face of Stud

Footing

Galvanized

Glazing

GLULAM Glue Laminated

GYPBD Gypsum Board

Ground Fault

Hollow Core

Header

Hardwood

Hardware

Horizontal

Insulation

Interior

Heiaht

Heating Hot Water

Inside Dimension

Insulated Concrete Forms

Garbage Disposal

Glue Laminated Beam

Galvanized sheet metal

Furring

Project Name Bewley Residence 1455 Audubon Ave. (South end) Project Addresss Montara, CA 94037 Project Owner Sirje Bewley P.O. Box 370453 Montara, CA 94037

A.P.N. 036-310-180 San Mateo County Planning Dept Permit # P.L.N. 2010-00079

Zone P.A.D.-C.D.; Planned Agricultural District Type of Construction Concrete Masonry, Cast Concrete, Light Framed Wood


Occupancy Type

2 Stories with a Crawlspace Number of Stories Fire Sprinklers Yes (County Requirement) Code 2013 California Building Code


Fire Marshal Half Moon Bay Fire Protection District Green Building Rating "Build It Green" New Home GreenPoints Checklist, 2006 Edition

San Mateo County Rating Standard

(Based on S.M.C. Green Building Ordinance #04411 admendment adding Chapter 14 to the County Ordinance Code.

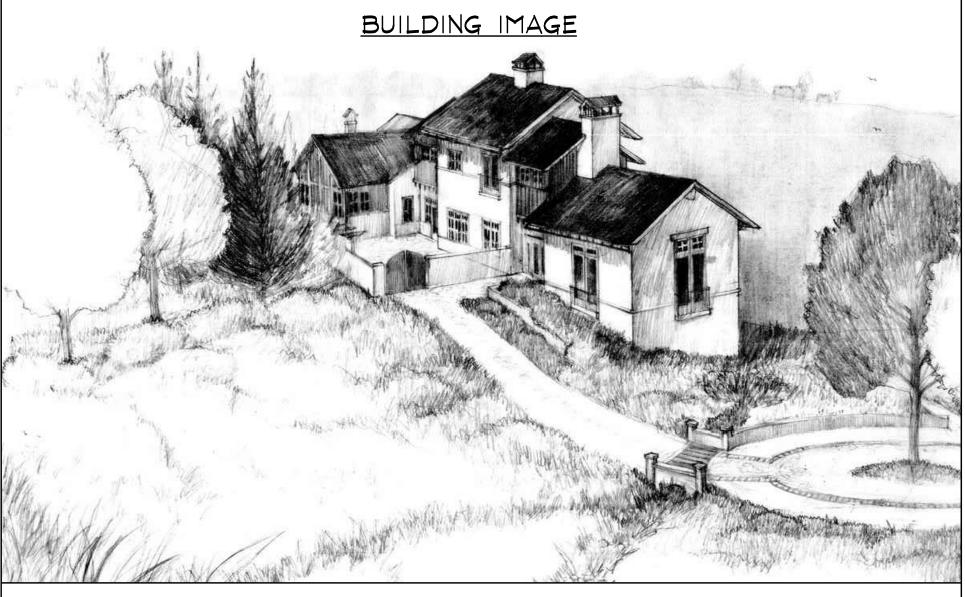

VICINITY MAP

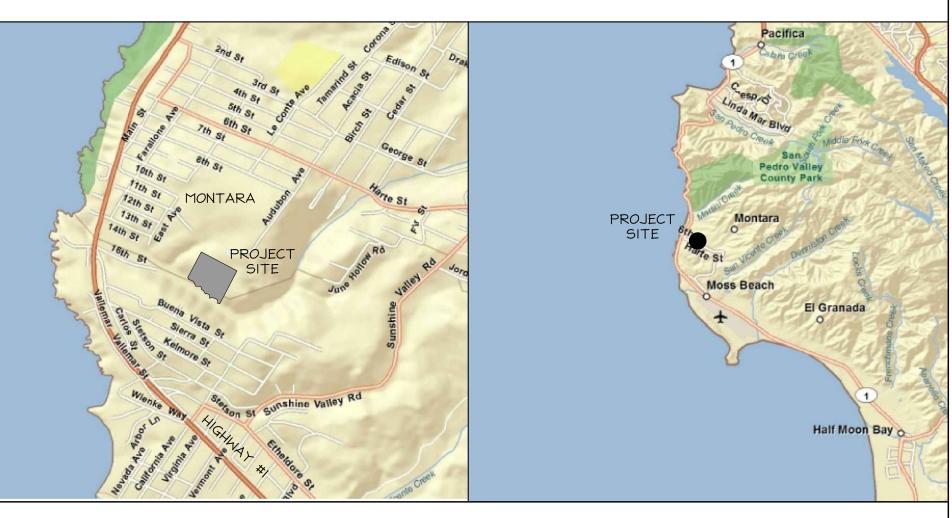

PROJECT DESCRIPTION

The project consists of a new single family residence located in the coastal town of Montara, California.

Development will be roughly limited to the North East quadrant of the property by the existing tree line and the existing horse stables on the adjacent property. There will be an access drive from Audubon Avenue and around an inner meadow area. The drive passes an studio/barn

The site design includes water storage features and stormwater management which encourages ground water absorption. A large portion of the site will be untouched.

The house will be a durable structure constructed of concrete/masonry with an insulated cavity and outer masonry veneer. The walls utilize insulated thermal mass to retain solar heat gain. The building shape and glazing enable interior spaces to have natural light from at least two sides.

Where possible, the building systems are accessible for repair and maintenance. Salvaged materials will be used where

possible. The structural detailing considers the

proximity to the San Gregorio fault.

DESIGN TEAM

Architect: Henri Mannik, a+e 5429 Telegraph Ave. Oakland, CA 94609 Γ. 510.652.1511 Contact: Henri Mannik, Architect h.mannik@ henrimannik-ae.com

Biologist:

Environmental

San Rafael, CA

7. 415.454.8868

smick@wra-ca.com

Geoff Smick, Principal

Consulting .

Contact:

W.R.Ă.

Structural Engineer: HM,a+e 5429 Telegraph Ave. Oakland, CA 94609 T. 510.652.1402 Contact: Henri Mannik, P.E. h.mannik@hmk-ae.com

Surveyor:

Contact:

Mike Turnrose

2169-G East Francisco Blvd. T. 209.599.5100

125 East Main St.

Ripon, CA 95366

mikels7454@verizon.net

Civil Engineer: Sherwood One Union St., 2nd Floor San Francisco, CA 94111 T. 415.677.7300 Contact: John Leys, P.E. jleys@sherwoodengineers

Geotech:

Contact:

Consultants

Joel Baldwin

P.O. Box 795

Pacifica, CA 94044

earthinvestigations4@comcast.net

T. 650.557.0262

Turnrose Land Surveying Earth Investigations

Landscape Architect: Blue Sky Design 495 Purisma Way Half Moon Bay, CA 94109 T. 650.726.5990 Contact: Ken Coverdale Bruce Atkinson info@blueskydesignsinc.com

> Contractor: Street Address City, CA Zip T. 510.000.0000 Contact:

> > email@email.com

Title-24 Consultant:

Street Address

T. 510.000.0000

email@email.com

City, CA Zip

Contact:

Name

 $|\times|\times|\times|\times|\times$ COVER, ABBREVIATIONS AND DRAWING INDEX ZONING DATA AND NOTES $\times | \times | \times | \times | \times | \times$ $\times |\times| \times |\times| \times |\times|$ PLOT PLAN $\times |\times| \times |\times| \times |\times$ SITE PLAN $|X| \times |X| \times |X|$ BUILDING SITE PLAN: MAIN HOUSE BUILDING SITE PLAN: STUDIO AND GARAGE $|\times|\times|\times|\times$ $|\times|\times|\times$ FIRE ACCESS AND FIRE SITE DETAILS $|\times|\times|\times$ SITE PLAN-EXTERIOR LIGHTING PLAN $|\times|\times|\times$ OVERALL LAYOUT SHEET $|\times|\times|\times$ ACCESS ROAD PLAN & PROFILE $|\times|\times|\times$ DRIVEWAY PLAN & PROFILE C3.0 $|\times|\times|\times$ GRADING & DRAINAGE PLAN C4.0 DETAILS $|\times|\times|\times$ EROSION CONTROL PLAN $|\times|\times|\times$ $|\times|\times|\times$ EROSION CONTROL DETAILS $|\times|\times|\times$ LANDSCAPE SITE PLAN A2.2 MAIN FLOOR PLAN $|\times|\times|\times$ $|\times|\times|\times$ A2.3 UPPER FLOOR PLAN ROOF PLAN $|\times|\times|\times$ WORKROOM AND BARN PLAN |X|XGARAGE PLAN $|\times|\times|\times|\times$ EAST ELEVATION $|\times|\times|\times$ SOUTH ELEVATION |X|X|X|X|X|XA3.3 WEST ELEVATION NORTH ELEVATION $|\times|\times|\times|$ A3.4 TRANSVERSE SECTIONS-LIVING ROOM $|\times|\times|\times$ TRANSVERSE SECTIONS-ENTRY HALL AND STAIRS |X|X|X|X|X|XA3.7 TRANSVERSE SECTIONS-ELEVATOR AND DINING ROOM TRANSVERSE SECTIONS-MASTER BEDROOM |X|X|X $|\times|\times|\times$ TRANSVERSE SECTIONS-FAMILY ROOM A3.9 LONGITUDINAL SECTION $|\times|\times|\times|\times$ BARN ELEVATIONS A3.11 |X|X|X|XA3.12 BARN ELEVATIONS A3.13 BARN SECTIONS $\times | \times | \times | \times$ GARAGE ELEVATIONS $|\times|$ GARAGE ELEVATIONS A3.15 WINDOW SCHEDULE DOOR SCHEDULE A4.3 FINISH SCHEDULE INTERIOR ELEVATIONS INTERIOR ELEVATIONS INTERIOR ELEVATIONS A6.1 REFLECTED CEILING PLAN REFLECTED CEILING PLAN REFLECTED CEILING PLAN VERTICAL CIRCULATION A8.I EXTERIOR DETAILS EXTERIOR DETAILS A8.3 EXTERIOR DETAILS EXTERIOR DETAILS INTERIOR DETAILS A9.1 INTERIOR DETAILS A9.2 INTERIOR DETAILS A9.3 A10.1 SPECIFICATIONS A10.2 SPECIFICATIONS TITLE 24 TITLE 24 MECHANICAL AND PLUMBING PLAN M.2 MECHANICAL AND PLUMBING PLAN E.1 ELECTRICAL PLAN E.2 ELECTRICAL PLAN STRUCTURAL DRAWINGS + = REVISED AND INCLUDED IN SET X = INCLUDED IN SET

DRAWING INDEX

Project

BEWLEY RESIDENCE

Audubon Ave. Montara, CA 94037 A.P.N. 036-310-180

Architect

HM,a+e

Henri Mannik Architecture and Engineering

> 5429 Telegraph Ave. Oakland, CA 94609 510 652 1511 p 510 601 7196 f

> > Consultant

Stamp

Printing Date

Planning Permit 03.18.2010 09.12.2011 Coordination 09.13.2011 Planning 10.05.2011 Coordination 10.11.2011 Coordination 07.19.2013 Coordination 08.08.2013 Coordination 10.07.2013 Coordination 10.21.2013 Coordination 11.05.2013 Coordination 11.07.2013 Constraints Map Constraints Map 11.25.2013 03.19.2014 Coordination D.R.Pre-app conf. 03.26.2014 Design Review 08.12.2014 Story Pole 11.14.2014 D.R. coord 06.08.2015 Design Review 07.10.2015

> HM,a+e Job Number 2005,01

Sheet Title **COVER**

Sheet Number

2.All work shall conform to the 2013 California Building Code, as modified by state and local jurisdiction. 3. Nothing in the Drawings or in these Specifications is to be construed as requiring or permitting work that is contrary to

these rules, regulations and codes. 4.All work and materials shall be in full accord with the latest rules and regulations of the Safety Orders of the Division of Industrial Safety, California Labor Code and all applicable federal, state and/or local health regulations. 5. Any reference to standards shall comply with requirements

of latest revision. 6. Construction shall comply with all State of California Title-24 energy code requirements and mandatory measures per Compliance certification herein.

DRAWING USE:

7. These architectural drawings are copyrighted instruments of service of Henri Mannik, Architecture and Engineering (HM, a+e), for the sole use for this project. If the contract has been terminated with HM, a+e, these Construction Documents in whole or part may not be used for any construction. Use of these drawings are not transferable without a new contract. Reproductions of these drawings in part or whole are not permitted without the permission of HM,a+e.

8. The Construction Documents include these Drawings and Notes, Specifications and all revisions, additions and addenda's

9. Unless otherwise shown or noted, all typical details shall be used where applicable. All details shall be considered typical at similar conditions. Drawings do not illustrate every detail but show only special requirements to assist contractor. 10.Do not scale drawinas.

11. Specifications take precedence over drawings. 12. Any existing building or site data is based on observation and/or existing information only. Destructive testing, removal of existing finishes, equipment disassembly, and

material testing was not preformed for the as-build condition, data, and code analysis. 13. The Contractor and Special Inspector shall contact the Architect regarding any questions of interpretation of these

specifications and drawings. 14. The Contractor shall thoroughly examine the drawings and specifications, and existing site conditions. By entering into the work, the Contractor states that the documents are sufficient to provide a complete installation of pertinent portions of the work. Report any questions or requests for clarification to HM, a+e immediately. If, in the opinion of any contractor, any construction details shown or otherwise specified are in conflict with accepted industry standards for quality construction or might interfere with his full guarantee of the work, he/she is to notify HM, a+e immediately for clarification. No omission or lack of detailed requirements in the drawinas or specifications is to be construed as allowing

any materials or workmanship below industry standards. 15.Confirm with HM, a+e that these contract documents are the most recent issue before layout and construction. 16. Verify all existing conditions and proposed dimensions at the job site. Compare architectural drawings with structural, mechanical, and electrical and plumbing drawings before commencing work. Notify Architect of any discrepancies and

do not proceed with affected work until they are resolved. 17. The Architect and the Architect's consultants have no responsibility for any modification, revisions, or substitutions of the work shown in the Construction Documents unless approved in writing by the Architect.

18.HM, a+e CAD files may only be used as backgrounds for shop drawings after HM, a+e receives a signed waiver from each party using the files, addressing the limitations and proper use of these CAD files.

GEOTECHNICAL REPORT

19.For geotechnical information, see the Geotechnical Investigation Report prepared by Earth Investigations Consultants (650-557-0262) and dated October 30, 2009. 20. Follow the recommendations of the report including but not limited to: site preparation, grading, compaction, trenches, foundations, slabs, driveways, drainage, and maintenance.

BIOLOGICAL MITIGATION MEASURES, PRECONSTRUCTION BIOLOGICAL SURVEY, & AREA OF DISTURBANCE

21.All work shall comply with local, City, County, State, and Federal environmental and biological regulations. The specific regulations listed are for coordination. Other regulations may apply.

22. See the Biological Report by W.R.A. Environmental Consultants of San Rafael dated biological information relvant to the project and for information, protection, and procedures on sensitive environmental habitants and

23. See Site Plans and W.R.A.'s Biological Report for identified Environmentally Sensitive Habitat Areas (E.S.H.A.) protected by the CA Coastal Commission's and San Mateo County's

Local Coastal Program (L.C.P.). 24. See Site Plans for the protected riparian corridor defined by San Mateo County regulations.

25. See Site Plans and W.R.A.'s Biological Report for required protection of the James V. Fitzgerald Area of Special Biological Significance (ASBS). Water Board Resolution No. 2012-0012 and San Mateo County's Fitzgerald ASBS Pollution Reduction Program.

26. The drawings and reports contain required measures and procedures to protect sensitive environmental areas. Install and maintain measures during construction.

27. Prior to the commencement of grading, excavation, vegetation removal, installation of utilities, and the construction of site improvements and structures, a biological survey is required to idendify any flora, fauna, or raptor nesting listed in the Biological Report by W.R.A. Environmental Consultants. The contractor shall allow time for the Biological Survey and any potential mitigation measures identified in the report.

28. See sheet A1.3 for area to be surveyed for flora, fauna, and raptor nesting. No work, site modifications or disturbances shall occur outiside of the indicated Area of Disturbance. During construction, field stakes shall identify the Area of Disturbance. Replace damaged or missing

29.No work or site modifications temporary or permanent are permitted within the Riparian Setback shown on the site

30. Any repair or maintenance of the existing well to ensure domestic capacity and quality shall be approved by the California Conservation Corp (C.C.C.).

REQUIREMENTS FOR ARCHITECTURAL COPPER 31.Copper from buildings may harm aquatic life. Water that comes into contact with architectural copper may contribute to impacts, especially during installation, cleaning, treating, or washing. Patination solutions typically contain acids. After treatment when the copper is rinsed to remove these acids, the rinse water is a source off pollutants. County prohibits discharges to the storm drain of water used in the installation, cleaning, treating and washing of architectural

32. The following Best Management Practices (BMPs) must be implemented to prevent prohibited discharges to storm

33. During installation use the following BMPs. If possible, purchase copper materials that do not have a pre-patina or have been pre-patinated at the factory with acid removed. 34.If patination is done on-site, implement one or more of the following BMPs:

34.1. Discharge the rinse water to landscaping. Ensure that the rinse water does not flow to the street or storm

drain. Block off storm drain inlet if needed. 34.2. Collect rinse water in a tank and pump to the sanitary sewer. Contact your local sanitary sewer agency before discharging to the sanitary sewer. 34.3. Collect the rinse water in a tank and haul off-site

for proper disposal. 35. Consider coating the copper materials with an impervious coating that prevents further corrosion and runoff. 36. During maintenance of architectural copper implement the following BMPs during routine maintenance activities, such as power washing the roof, re-patination or re-application of

37. Block storm drain inlets as needed to prevent runoff from entering storm drains. 38.Discharge the wash water to landscaping or to the sanitary

sewer (with permission from the local sanitary sewer agency). If this is not an option, haul the wash water off-site for proper disposal. 39.Contractor and owner are responsible for a discharge to the storm drain of non-stormwater generated by installing, cleaning, treating or washing copper architectural features,

you are in violation of the municipal stormwater ordinance

and may be subject to a fine. 40. See San Mateo Countywide Water Pollution Prevention Program for additional requirements or updates to standards. See County information on the James V. Fitzgerald Area of Special Biological Significance. The project is located within the protected watershed.

41. See biological report for additional measures. Stricter measures on the biological report govern.

FROSION CONTROL

impervious coatina.

42. See Civil drawings for storm water runoff control and construction erosion control

SITE GRADING

43. See Civil drawings for information on grading.

SITE DRAINAGE

44. See Civil drawings for information on site drainage. 45. See BUILDING DRAINAGE on AI.2 for additional information.

LANDSCAPE

46. See Landscape drawings for planting and site improvements.

TREE REMOVAL

28. See Site plans for trees to be removed. Do not remove trees unless specifically noted on drawings and permitted. 29. Trees with a trunk circumference of 55 inches measured 4'-6" above the average surface of the ground have a special county status.

30. Repair and upgrade the existing well for domestic capacity and quality.

31.SEE's report on water quality dated

DIMENSIONS:

32. Unless specifically noted on the drawings, all wall dimensions are to face of framing or face of structure, unless otherwise shown on masonry walls. See drawings for walls, columns, and other items dimensioned to center lines. Window dimensions are to centerline of window or door unless otherwise noted. Vertical dimensions are to finish floor unless noted otherwise.

33. Contractor shall verify and be responsible for all job site measurements and levels pertinent to their work. If they differ from Contract Drawings or reviewed Submittals, discrepancies shall be brought to HM, a+e's attention

34.It is the subcontractor's responsibility to establish sub floor elevations.

FINISHES:

35.HM,a+e shall observe and advise on work in order to produce harmony of matching finishes, textures, colors, etc. throughout various components of the project. 36.All interior wall and ceiling finishes shall comply with CBC

Chapter 8. 37. Stucco shall be three coat - 7/8 " min. thick exterior stucco application per CBC, unless otherwised noted on

drawings. See masonry details for additional info. 38. Doors and panels of shower and bath enclosures and adjacent wall openings within 60 inches above a standing surface and drain inlet shall be fully tempered, laminated safety glass or approved plastic and shall comply with CBC. 39. Shower area walls shall be finished water resistant board to a height of not less than 70" above drain outlet. See drawings for elevations.

MATERIALS AND PRODUCTS:

40. Unless otherwise shown or noted, follow Manufacturer's recommendations for all products used on this project. 41.All materials and equipment are to be installed in strict accordance with the latest edition of manufacturer's written installation instructions and specifications. Generic materials not specified by manufacturer are to be installed in accordance with recommendations of applicable trade associations (For example, Concrete Steel Institute, Gypsum Association, etc.)

42. Substitutions may only be considered if submitted in writing. The burden of proof of the proposed substitution is on the contractor.

43. Shop drawings, design/build items and product literature shall be submitted and reviewed by the General Contractor and Architect, before fabrication. All submittals shall have a clear 3.5"x7" space reserved for shop drawing stamps by the General Contractor, Architect, and Engineer. If the submitted sheets do not have sufficient room, a cover sheet with a table of contents and sufficient space for stamps may be submitted. Each shop drawing submittal to HM, a+e shall consist of one reproducible copy on bond, to be marked and returned by the Architect and one copy for each specific reviewer to keep including the architect and each applicable consultant. Additional copies for submission will be returned unmarked. Submit shop drawings well in advance of fabrication; allow at least three weeks for the Architect to review, and additional time for review by the consults and forwarding between the Architect and General Contractor. Allow time for revisions and re-submittal, if required. Shop drawings and submittals shall be dated, and each update shall be identified with a revision number. All items on the shop drawings that vary from the Drawings, alter details, or extrapolate from similar details, shall be circled by a cloud with the note "Architect Verify". Minor re-detailing due to clarification and coordination mark-ups on the shop drawings by the Architect and Engineer shall be expected;

submitted:

FIRE PROTECTION: 44. See sheet A1.7 for additional info.

included at no cost to the Owner. Added

45. The building shall be fully protected with a modified NFPA 13D residential fire sprinkler system as required by the

shop drawing re-detailing up to 5% of total effort shall be

re-detailing may be submitted. The following items shall be

46. Provide draft stops and fire blocking as required by CBC.

fabrication/installation costs or credits due to such

BUILDING AND STRUCTURE DRAINAGE: 47. Unless otherwise noted, provide perimeter drains, perforated drain pipe, drain rock, and drainage blanket around entire building foundation and at building and site retaining walls. Extend drains to daylight with a slope of

1/16-1/8" per foot, unless otherwise noted on the drawings. Drain to daylight and to well-drained, gently sloped areas, or drywells as required. Follow the recommendations and construction documents of the Geo-technical Engineer, Civil

Engineer, or requirements of local jurisdiction. 48. The Contractor shall provide all temporary erosion controls

during the work. See Civil drawings

EXTERIOR LIGHTING: 49. See Electric site plan and building elevations for agency approved lighting design. 50.All exterior lighting shall meet county and other agency

requirements. 51. San Mateo County zoning requirements: Design reviews section 6565.20(F).4.

52. The Contractor shall provide mock-ups where noted in the Construction Documents. 53. The Mock-ups shall consist of actual materials, colors, techniques, methods and assemblies used in the project. The level of skill in the mock-up shall match the level of

skill used in actual construction. 54. The mock-up shall be an example of all similar work in the project. Do not proceed with any work represented by the mockup until the mock-up has been approved by the Architect.

55.At the start of the work, the contractor shall provide to the architect a schedule for mock-up submittals.

56. Submit actual mock-ups well in advance of fabrication; allow at least one week for initial architectural review after notification that the mock-up is complete and accessible. Provide additional time for revisions and re-submittals, if 57.Re-detailing due to review of the mockup shall be

work represented by the mockup shall be included at no cost to the Owner. Added fabrication/installation costs or credits due to such re-detailing may be submitted. 58. Unless a specific mock-up size is noted, provide adequate size and scale to judge the nature of materials, material patterns, variations in material, relationships of parts, and the mock-up in context. The contractor shall submit the

expected. This re-detailing up to 10% of total effort of the

proposed size of the mock-up for approval by the Architect before fabrication of the mock-up. 59. Mock-ups shall remain accessible and protected during construction until the completion of all work which is represented by the mock-up. Provide on site a designated and identified location for mock-up storage. Do not destroy or alter mock-ups without the approval of the architect unless otherwise directed. At the completion of the work,

Description Dry stack sample of stone Garden Walls Paving Material Sample of any movable paving Review trees while in pots Tree Location Masonry Finish Stucco Finish

if requested, provide the mock-up to the Architect.

60. The Following items shall be mocked up:

Floor Finishes

Trim Stain/Paint

61.At all times, the Contractor shall be solely and completely responsible for the conditions of the job site. The responsibility includes the safety of people, property, and all necessary independent reviews of these conditions. The Architect's and the Architect's Consultant's job site visits are not intended to include review of the adequacy of the Contractor's safety measures. The Contractor shall take all precautions necessary to protect workers, and public from injury; protect from damage all existing utility lines, structures, and property, on and adjacent to the project site; and keep the job site and adjoining premises free from accumulations of waste and dangerous materials resulting from the Work. The Contractor shall not bury or bur rubbish on Owner's premises. Shoring and bracing of the soil, the existing structure, and the new structures shall be the responsibility of the contractor and the contractor's consulting structural engineer.

62. The Architect is not responsible for means and methods. 63. Contractors shall supervise and direct the pertinent work, inspect all work in progress and materials as they arrive for compliance with the Contract Documents, and reject defective work or materials immediately upon performance or delivery; The contractor shall deliver, store, and handle all materials and products in a manner which will prevent their damage and deterioration, and the contractor shall make all repairs or replacements necessary at no additional

cost to the Owner in the event of damage. 64. Prior to commencement of any portion of work, the Contractor shall carefully inspect and verify that work is complete to the point where new work may properly commence and all areas of discrepancy have been fully resolved. In event of failure to do so, the subcontractor shall be responsible for correction of any errors at no expense to the Owner.

65.It is the Contractor's responsibility to maintain a complete and organized set of construction documents pertinent to their work at the project site at all times when work is in progress. At the end of the project, provide to the client an As-Built set of drawings showing the actual built project including any revisions, alterations, modifications, and substitutions.

66. Contractor shall survey the existing building to locate all existing floor elevations, face of framing, column centerlines, and interior and exterior face of wall, in order to locate new alignments, centerlines, face of framing, face of finishes, and clearances.

67. Remove all abandoned plumbing, electrical, and mechanical items and equipment. 68. The contractor shall protect any occupied areas against dust and fumes during construction. The site shall be left broom

clean and tidy at the end of each day. 69. The contractor shall remove and dispose of any hazardous materials generated during the work. Follow standards, codes, and regulations on the safe handeling, removal, and disposal of these hazardous materials.

SUSTAINABLE MEASURES:

70. Contractor shall minimize construction waste. Salvage and recycle all construction and demolition materials. 71.Use Material with recycled content 72. Use Green Point or LEED for Homes. Follow measures and

requirments specified in the Construction Documents to meet the requirements. 73. Use FSC Certified wood for framing where noted. 74. Provide cement replacement with slag or fly ash where

75. Use low VOC interior paints and interior finishes. 76.Use materials with a 000 mile radius. 77. Provide __ air changes per hour. See mech drawings. 78.Ensure wall assembly remains breathable

END OF NOTES

ARCHITECTURAL SUBMITTALS

WATER SYSTEM PLAN SUBMITTAL. A plan showing all components of the fire protection water system shall be submitted to the Building Inspection Section of San Mateo County or City of Half Moon Bay for review and approval by the Coastside Fire Protection District and shall include the following:

1. Size, location and type of all water supply tanks showing vent and outlet locations and sizes. 2.A complete description and diagram showing the water piping layout. Include water source (e.g., supply lines, wells,

springs, community water system tap.) 3. Size, type, location and depth of cover for all piping including domestic/fire sprinkler supply and hydrant supply. 4. Size, type and location of all control valves, fittings, required pumps (with specifications), electrical service, and

5. Size, type, location and capability of fire hydrants. 6. Elevation of water tank, hydrant and sprinklered buildings. 5.REFERENCE: NFPA 1142, CFC Section 508, \$ Appendix B, BB. CA Code of Regulations, Title 14 Section 1275.00-1275.20. CFPD Ordinance 2009-01. Coastside Fire Protection District document "FPE-005, 9/11/09 Rev."

INSPECTIONS

1. Provide tests and inspections for all items as required by the 2013 California Building Code and all applicable local

ordinances. 2. The Owner shall retain an independent testing lab to

perform all required testing and inspection. 3. The Contractor is responsible for coordinating with the testing lab to schedule all required tests and inspections.

4. The following items shall be inspected 4.1. HYDRANT PRESSURE TEST & FLUSH. The installing contractor shall pressure test and flush the underground fire hydrant supply pipe as required. The flush and pressure test require verification by County Fire Marshal.

4.2. FIRE SPRINKLER PRESSURE TEST AND FLUSH. Prior to connecting the underground fire sprinkler supply pipe to the fire sprinkler riser, the pipe shall be pressure tested and flushed by the installing contractor, as required. If the underground piping is not to be connected to the riser immediately, the pipe shall be capped to prevent contamination.

5. See consultant drawings for observations not listed. 6. Architect does not provide inspection services.

ARCHITECTURAL OBSERVATIONS

1. The following completed items will be observed by the Architect on site. For all layouts, allow time and labor for reasonable modifications at no expense to owner. Observation is for review of intent and not a detailed inspection or observation of all items. The following is not a list of separate site visits. Multiple items will be observed per visit, and the contractor shall allow time in the construction schedule for the Architect to see multiple items per trip when reasonably possible. The Contractor shall notify the Architect at least five working days prior to concealing any architectural items. The Architect will then determine if a site visit is appropriate. Notification shall include the following items:

> Items marked for removal Items marked for demolition Items marked for reuse. Demolition Site layout Gradina Roadwork Site utility location and layout Septic layout and installation Site drainage Site underground drainage cleanouts Site equipment and electrical Site fire protection systems Site walls, fences, and structures Site finishes Foundation layout Foundation waterproofing

Foundation drainage and any concealed drainage Foundation insulation Concrete formwork Wall layout Partiti*o*ns Furring Blocking and supports within walls Wall, floor, ceiling, and roof penetrations 26. Chases, soffits, and raceways

Stair layout All Guardrail and handrail layout Doors

27. Windows and skylights Weather barriers Building wraps Rain screens Flashing and seals Deck waterproofing Roofing Siding and stucco

Veneers Rainwater leader location

Gutters Insulati*o*n 22. Plumbing sound attenuation

Cabinet layout Equipment layout Electric outlet, switch, and lighting layout Lighting units prior to installation Smoke and CO2 Alarms Sprinklers

Grab bars 25. HVAC and ducts/piping Gypsum Wall Board and GWB Finish Fire Rated Wall Board

1-Hour Fire Assemblies

Substrate installation

Fire blocking and barriers

Plumbing fixture locations

23. Plumbing clean-outs

Finishes Paneling Tiling Flooring pattern and joint layout Flooring Trim


39. Furnishings 40. Final Cleaning

Stains and sealers

Painting

2. See consultant drawings for observations not listed.

PROJECT KEY

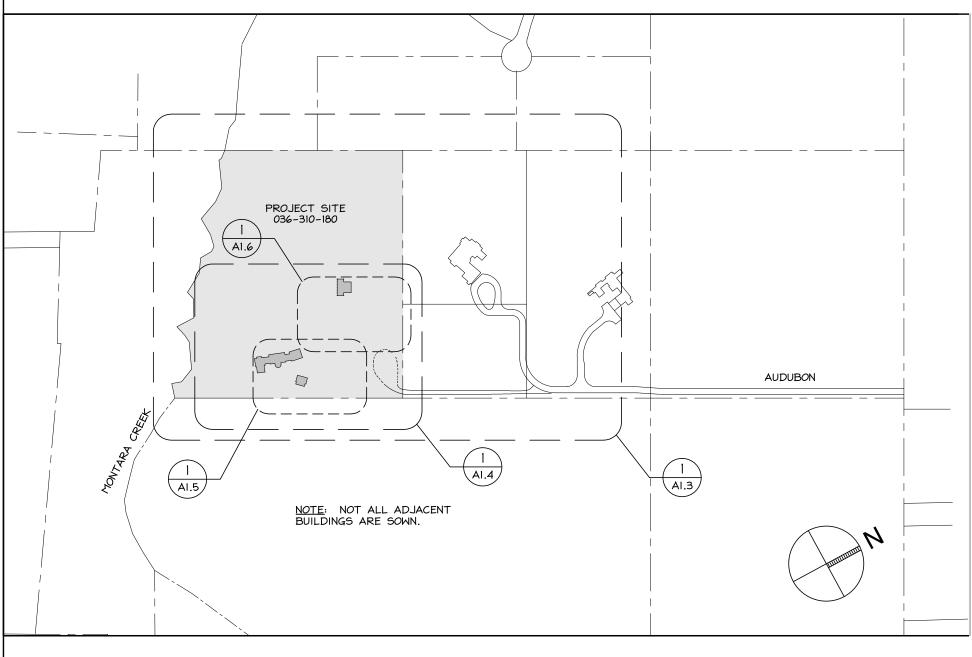

ZONING DATA

2,920. S.F.

<u>PROPOSED</u>

5.33 %

SITE

FILL

BLDG

FILL

1,659 FILL

326 FILL

TOTAL

(CU.YD.)

GENERAL NOTES ON ZONING DATA

I. SEE AI.3 FOR ADD'L INFO

HOUSE FLOOR AREA

1,580. S.F. UPPER LEVEL 2.920. S.F. MAIN LEVEL

TOTAL OF HABITABLE AREA 4,500. S.F.

HOUSE FOOTPRINT

BARN FLOOR AREA

PLANNING ITEM

STUDIO/BARN FLOOR AREA/FOOTPRINT 1,146. S.F.

554. S.F. GARAGE FLOOR AREA TOTAL FLOOR AREA 6,200. S.F.

SEE AI.3 FOR ADD'L INFO LOT SIZE 357,148 S.F. 8.199 ACRES LOT WIDTH 910 Ft. FRONT YARD 50 Ft. 254 Ft. REAR YARD Varies. Riparian 200 Ft. RIGHT SIDE (WEST) 566 Ft. 20 Ft. LEFT SIDE (EAST) 20 Ft. 62 Ft.

REQUIRED

COMBINED SIDE YARD 40 Ft. 628 Ft. **MAXIMUM** <u>PROPOSED</u> BUILDING HEIGHT 28 Ft. 28'-0" (SEE A3.7 FOR DETAILED INFO) (HEIGHT DETERMINED PER 2-STORIES 2-Levels SAN MATEO COUNTY DOCUMENT, " Maximum Building Heights in

1.29 % LOT COVERAGE F.A.R. 1.26 % HOUSE HOUSE, GARAGE, STUDIO, & BARN 1.74 % COVERED PARKING SPACES

IMPERVIOUS SURFACES: HOUSE, STUDIO, GARAGE ROOF AREA

HOUSE 3,788 S.F. BARN ROOF AREA 1,553 S.F. GARAGE ROOF AREA 772 S.F. SIDEWALKS, PATIOS, PATH HOUSE 678 S.F. BARN SIDEWALKS, PATIOS, PATH 1,387 S.F. DRIVEWAY 10,855 S.F. TOTAL 19,033 S.F.

IMPERVIOUS PAVED AREA AS % OF LOT

Unincorporated San Mateo County",

Dated 12/5/01)

GRADING. SEE C-1.0. (CU.YD.) SITE(CIVIL) BLDG TOTAL 917 + 416 = 1,333 CUT 1,189 + 470 = 272 + 54 = |

Henri Mannik, Architecture and Engineering 5429 Telegraph Ave.

Project

BEWLEY

RESIDENCE

Audubon Ave.

Montara, CA 94037

A.P.N. 036-310-180

Architect

HM.a+e

Oakland, CA 94609 510 652 1511 p 510 601 7196 f

Consultant

Stamp

Printing Date

Planning Permit 03.18.2010 09.12.2011 Coordination 09.13.2011 Planning 10.05.2011 Coordination 10.11.2011 Coordination 07.19.2013 Coordination 08.08.2013 Coordination 10.07.2013 Coordination 10.21.2013 Coordination 11.05.2013 Coordination 11.07.2013 Constraints Map Constraints Map 11.25.2013 03.19.2014 Coordination D.R.Pre-app conf. 03.26.2014 Design Review 08.12.2014 Story Pole 11.14.2014

D.R. coord

Design Review

06.08.2015

07.10.2015


HM,a+e Job Number


Sheet Title


2005,01


PROJECT DATA

Sheet Number

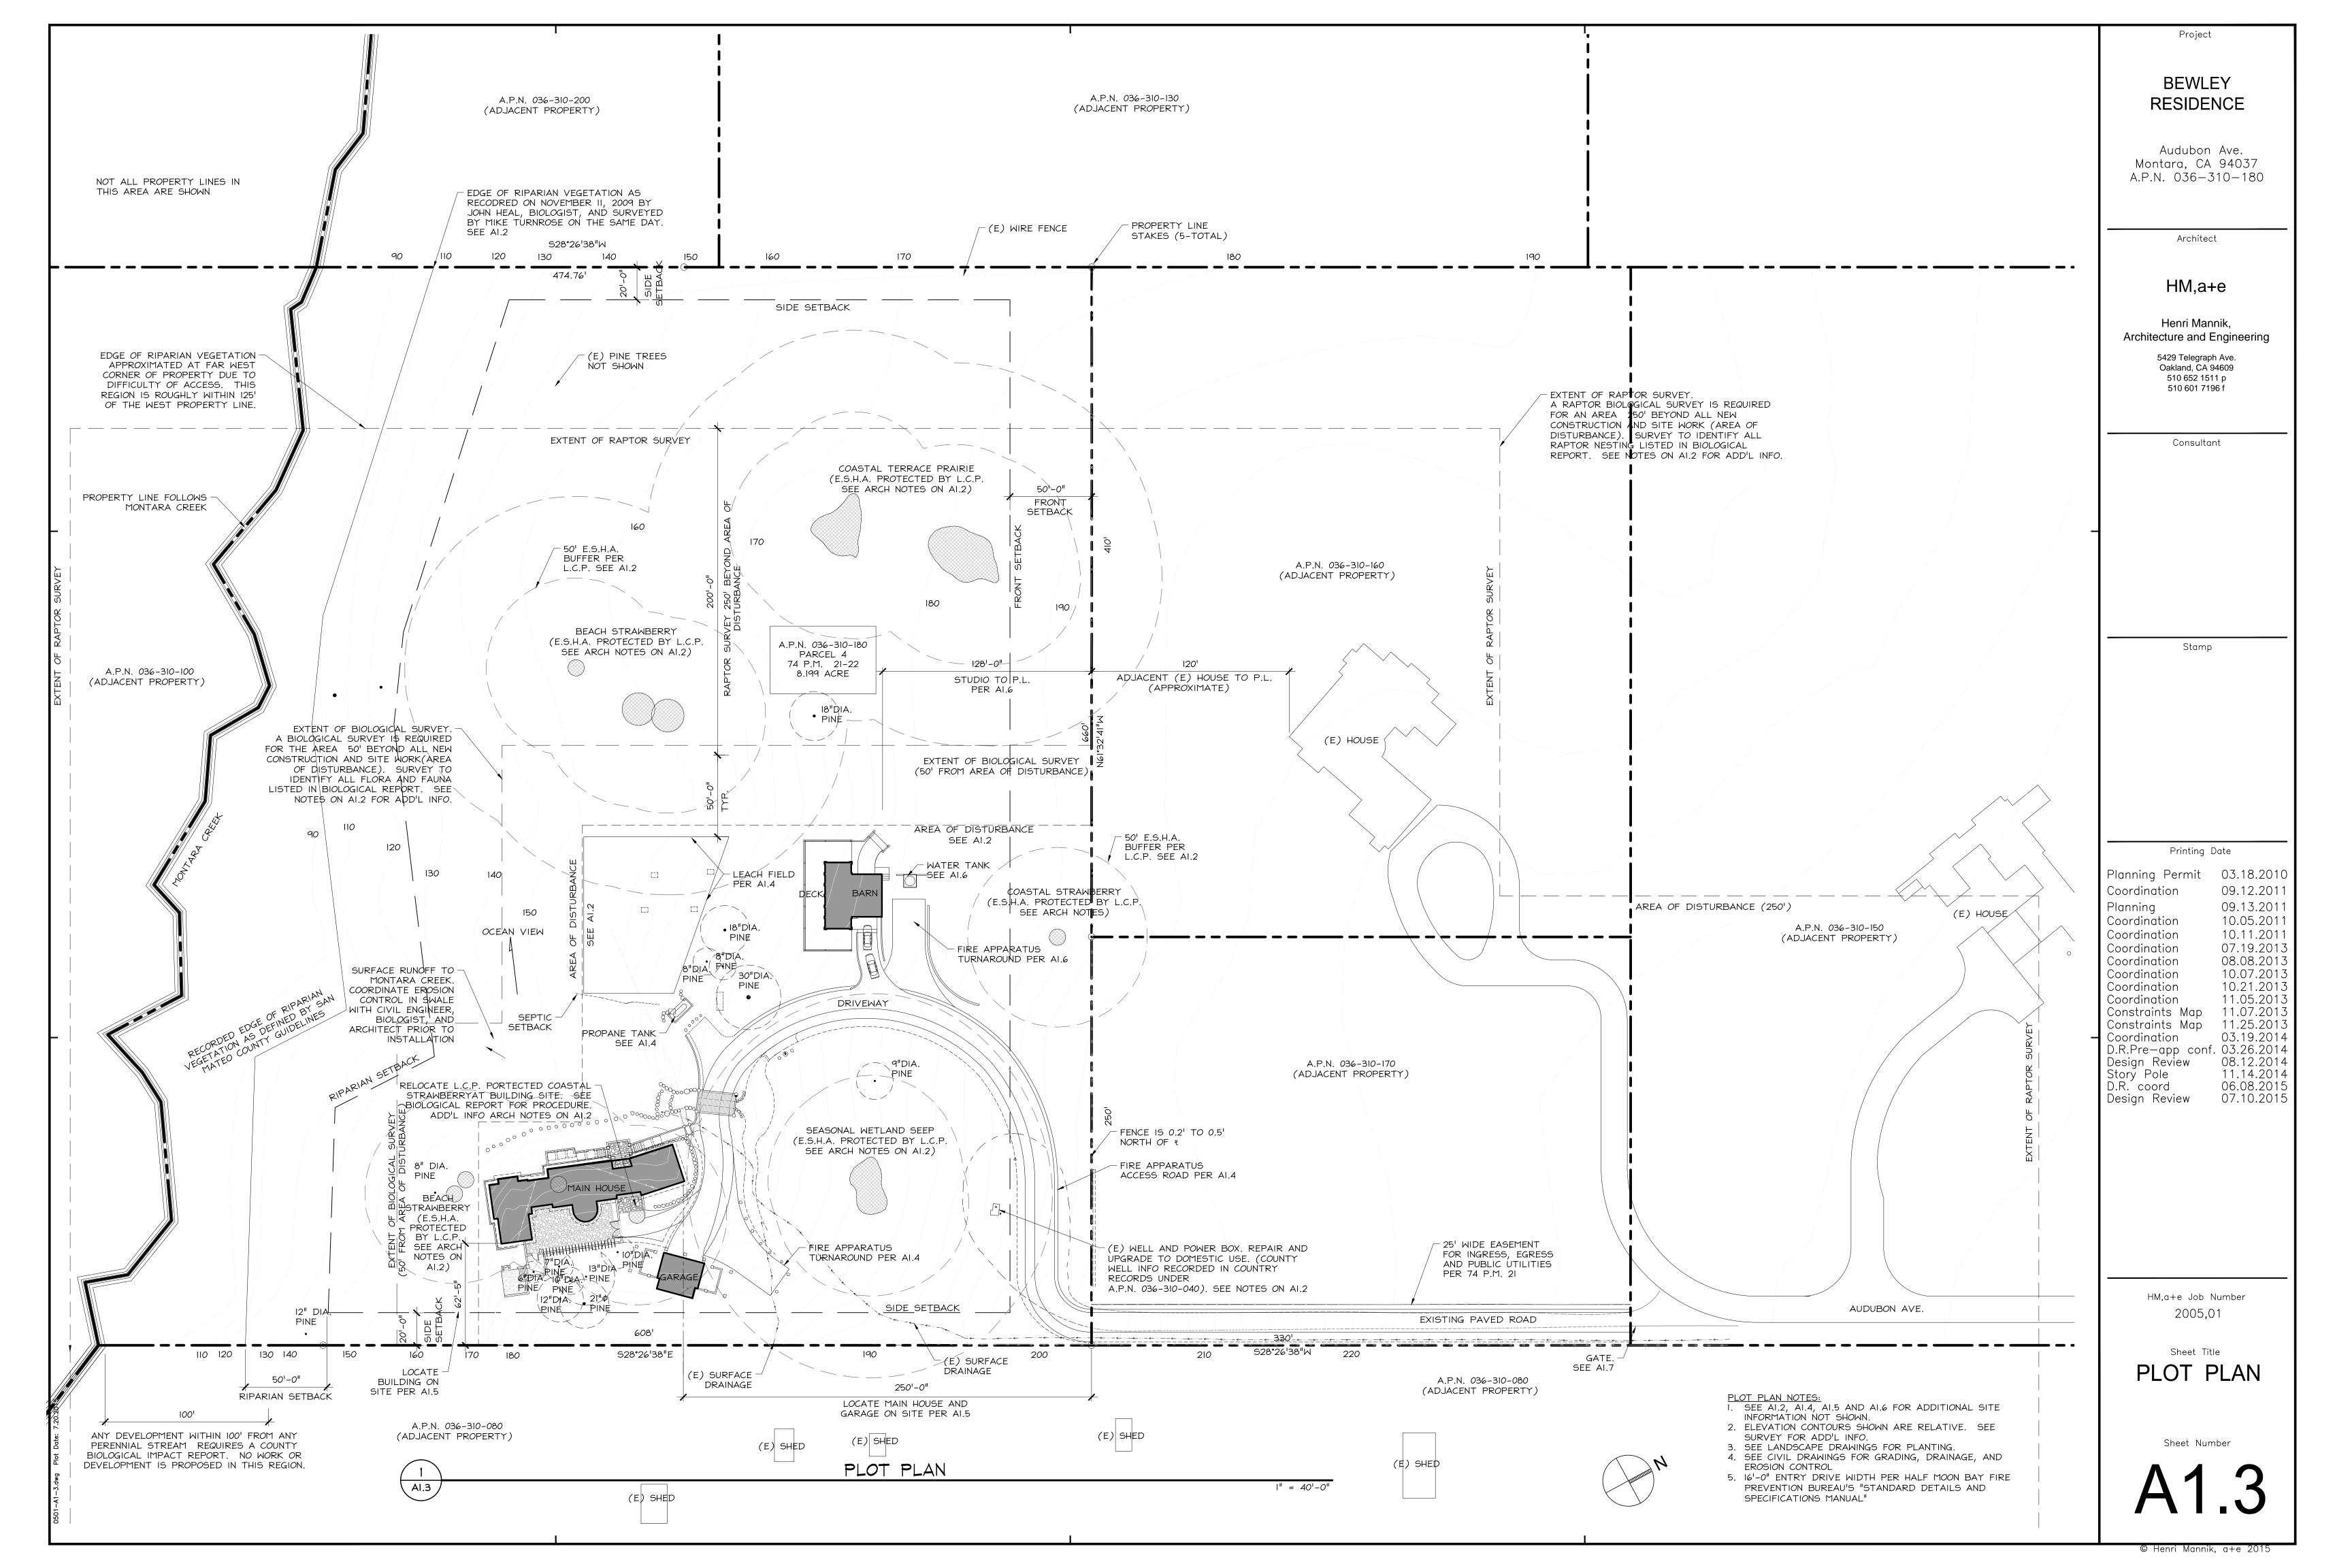

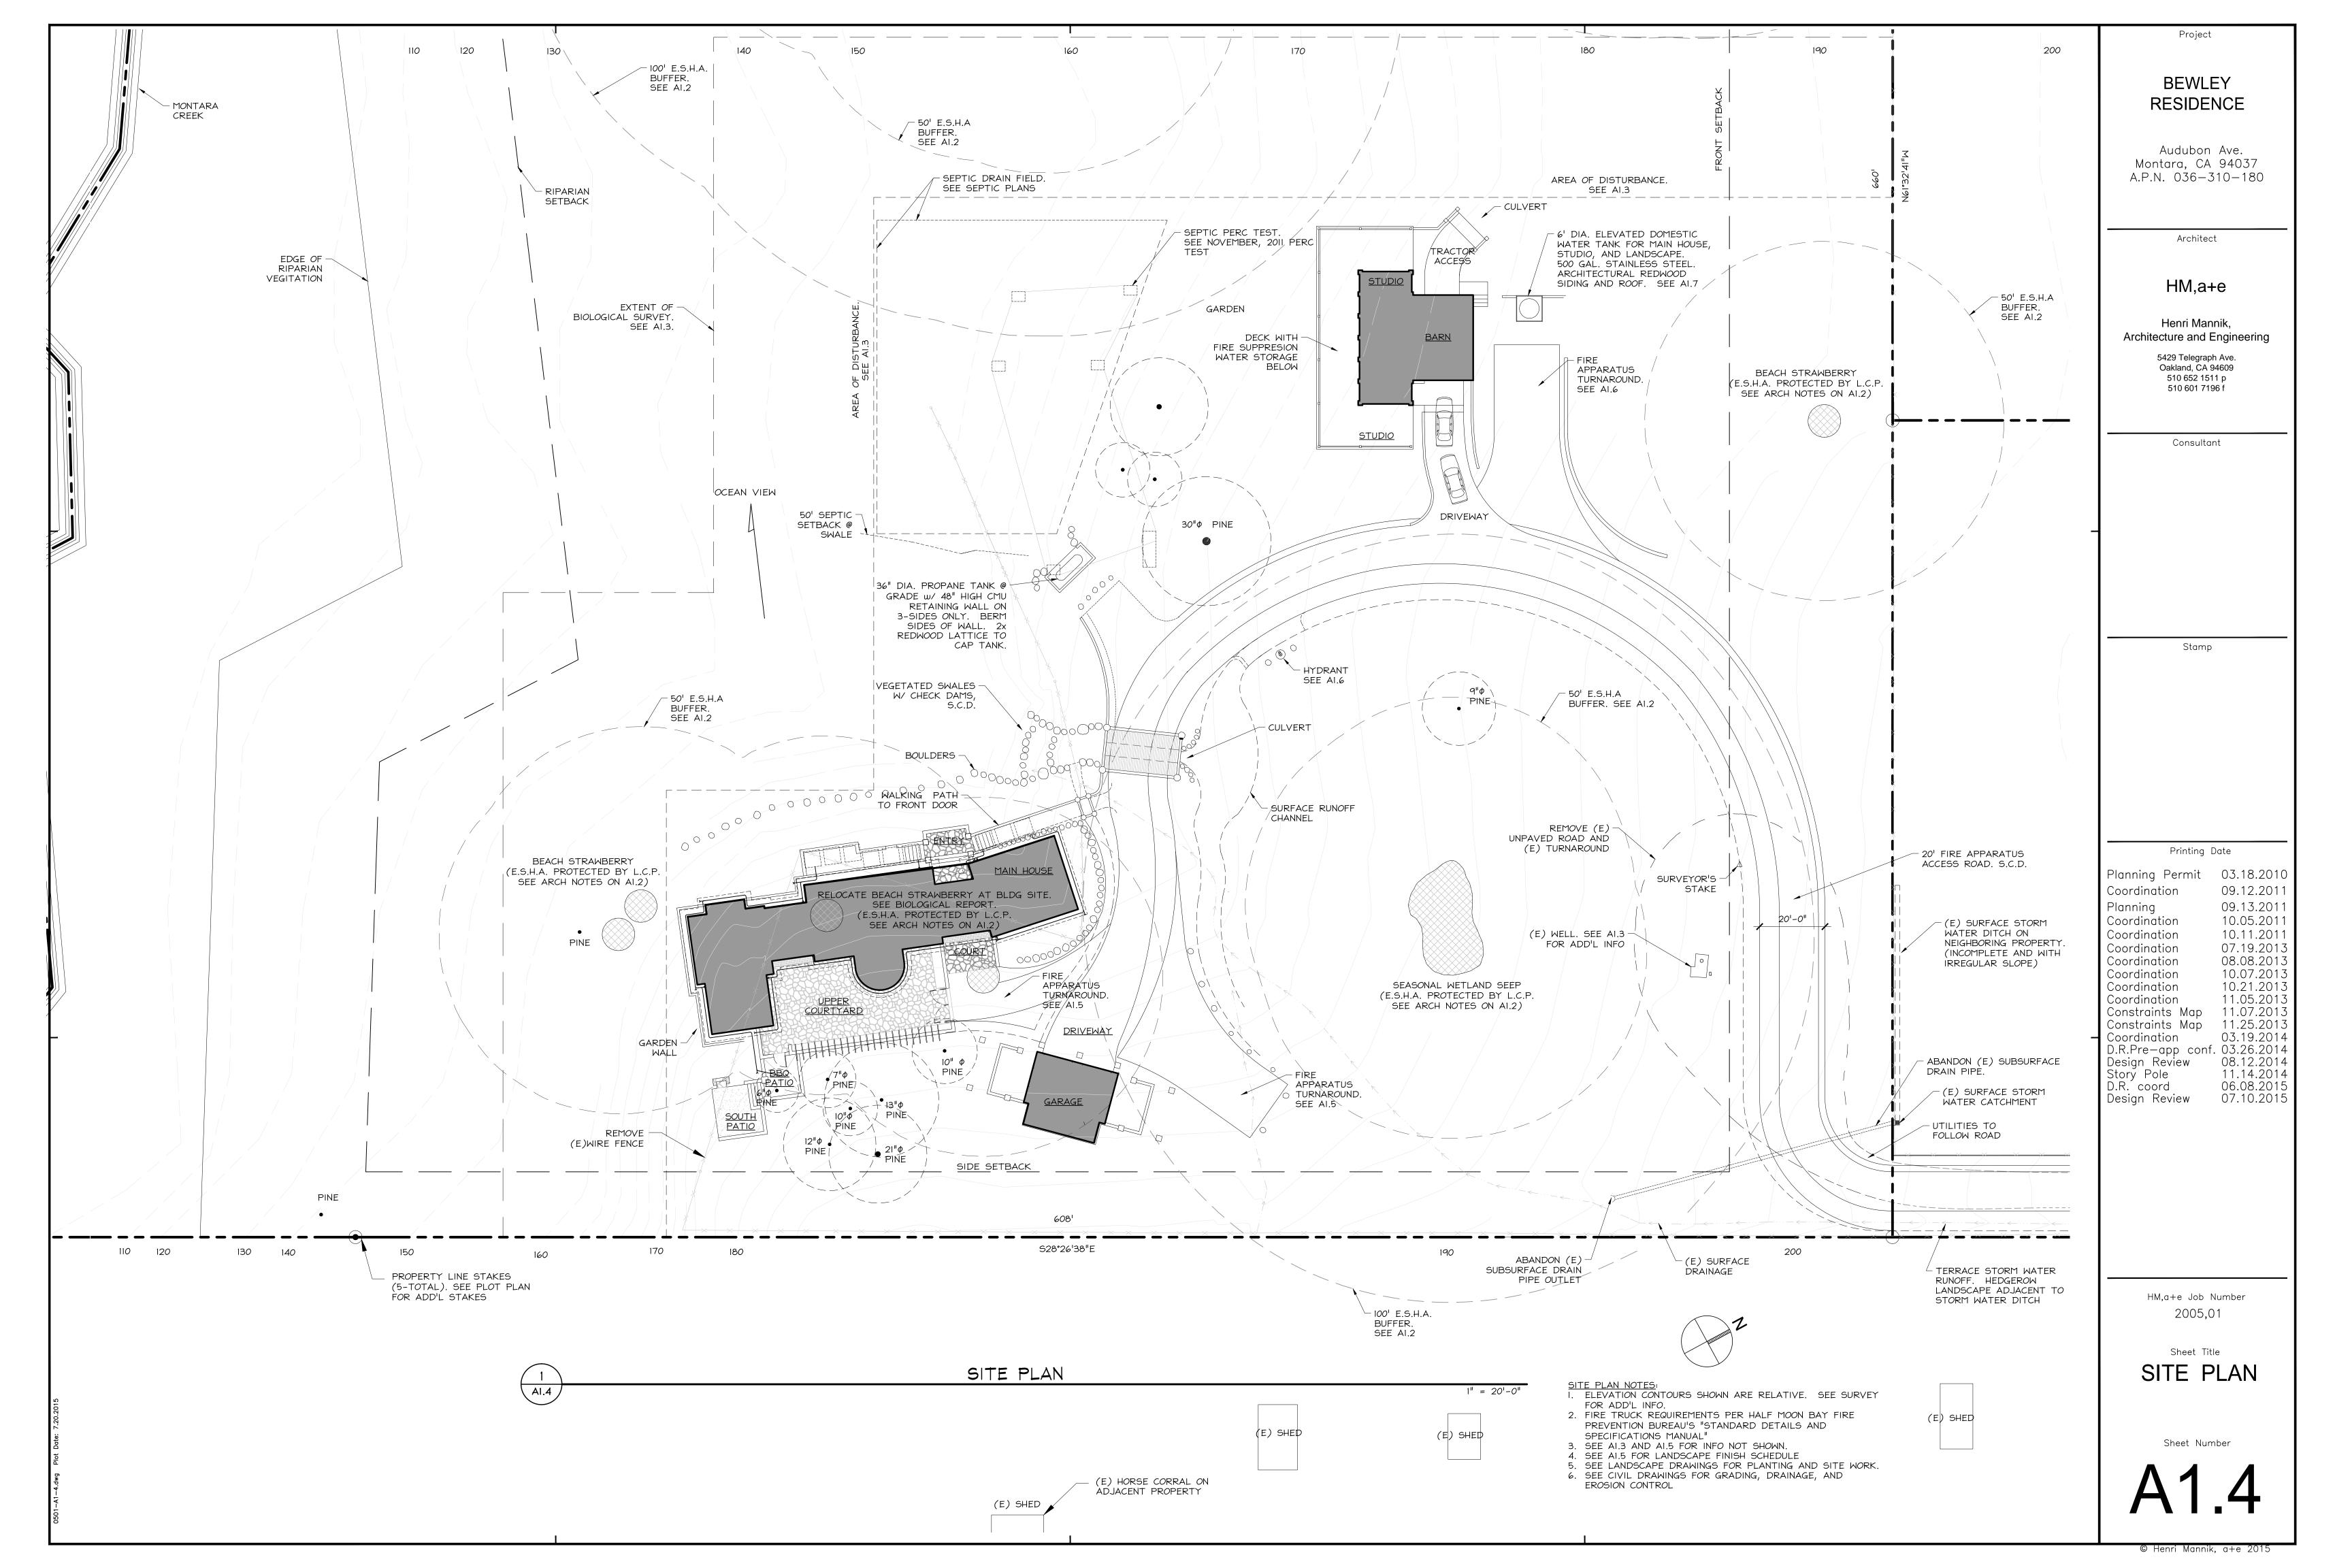

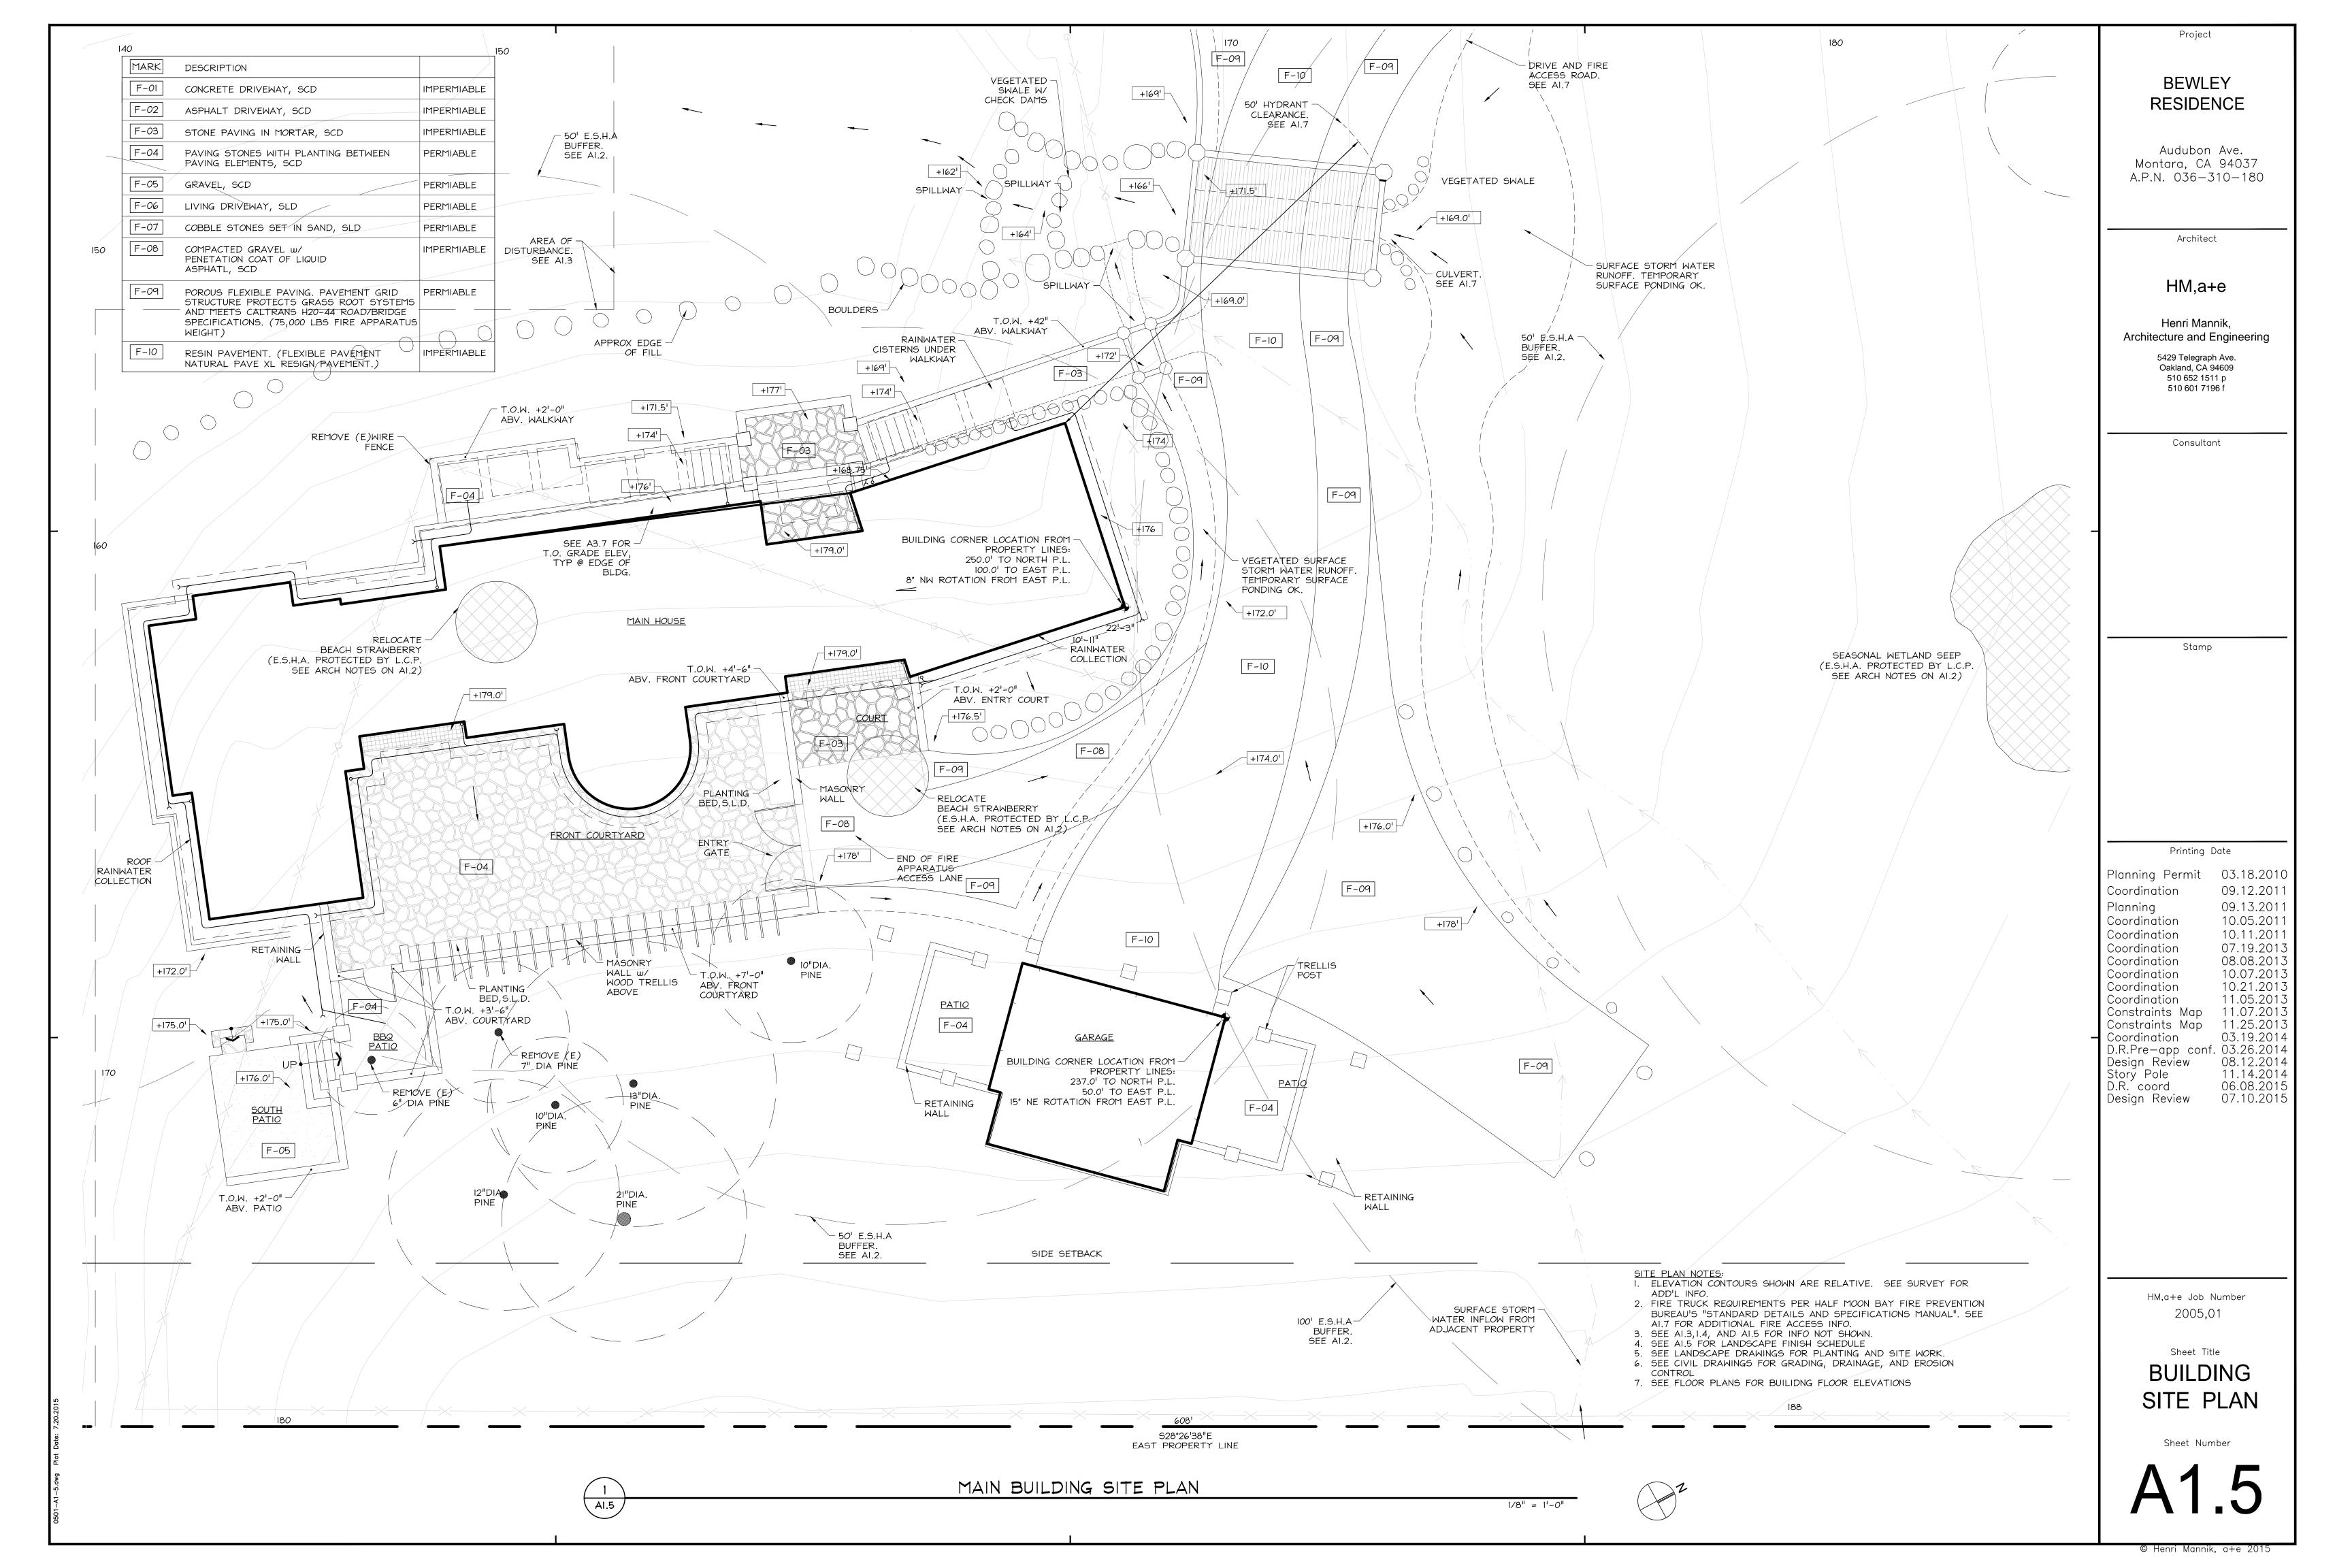

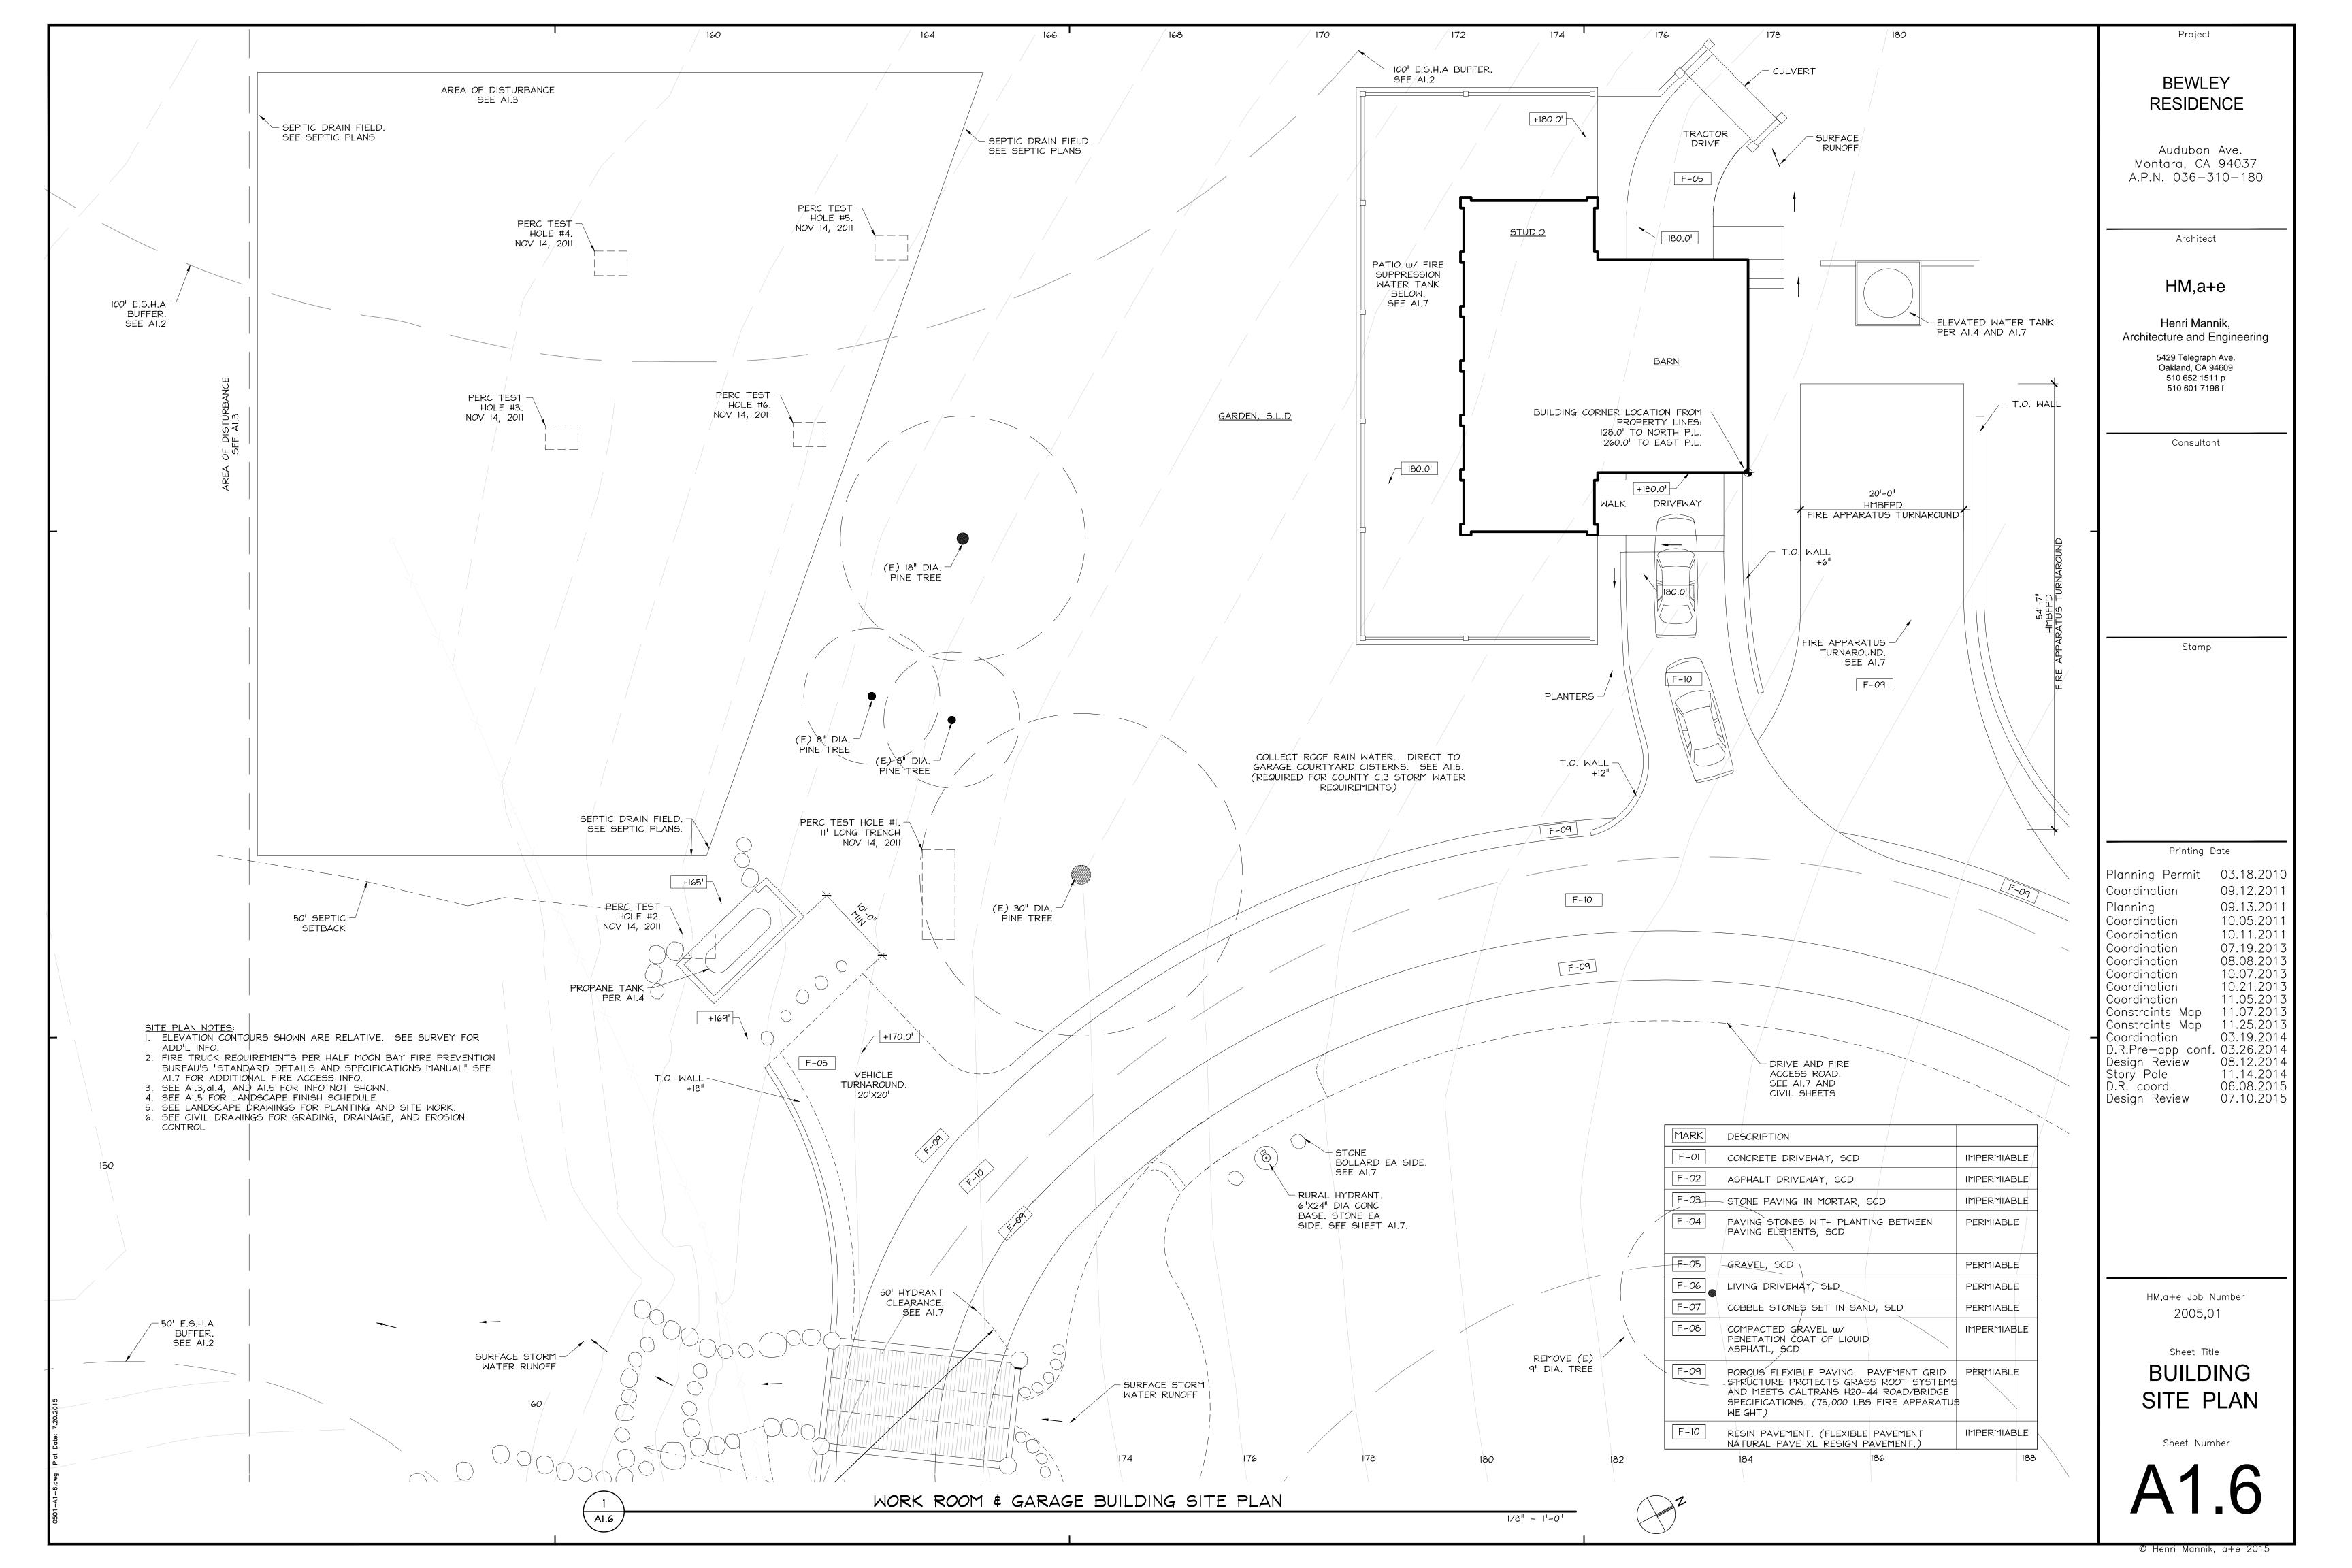

\ AI.7

1/4" = 1'-0"

A1.7

WATER TANKS

I. A SCREENED VENT 1.5 TIMES THE THE DIAMETER OF THE OUTLET IS REQUIRED. (e.g. 4" OUTLET=6" VENT).

- 2. WATER TANK(S) SUPPLYING HYDRANTS SHALL BE LOCATED AT AN ELEVATION WHICH PROVIDES ADEQUATE POSITIVE PRESSURE.
- 3. WATER TANKS SHALL BE INTERCONNECTED BY USING A MINIMUM PIPE SIZE OF 4 INCH, INTERCONNECTION PIPING AND VALVES MUST BE OF A MATERIAL NOT DAMAGED BY UV EXPOSURE. THE CROSS CONNECTION SHALL ALSO HAVE AN APPROPRIATELY SIZED CONTROL VALVE LOCATED AT
- 4. LANDSCAPING WATER SUPPLY SHALL NOT BE STORED IN TANKS PROVIDING WATER FOR FIRE HYDRANTS. THE LANDSCAPING WATER IS IN ADDITION TO THAT REQUIRED FOR FIRE PROTECTION AND A AUTOMATIC ACTIVATED SOLENOID VALVE SHALL BE REQUIRED TO AVOID PRESSURE LOSS IN FIRE PROTECTION WATER SUPPLY DUE TO LARGE DEMAND FROM THE SAME
- WATER SUPPLY (LANDSCAPING OR AGRICULTURAL IRRIGATION). 5. WATER TANKS USED FOR FIRE PROTECTION SHALL REMAIN FULL AT ALL TIMES, AND SHALL BE FILLED AUTOMATICALLY FROM A RELIABLE WATER SOURCE (e.g. WELL, YEAR ROUND SPRING OR CREEK).
- 6. WHERE WATER TANKS PROVIDE BOTH DOMESTIC AND FIRE PROTECTION SUPPLY, THE WATER TANK SHALL BE FITTED WITH A FLOAT SWITCH WIRED TO THE DOMESTIC WATER SHUT OFF SOLENOID. 7. CONTROL VALVES SHALL BE PROVIDED FOR ALL HYDRANT INSTALLATIONS
- AND BE LOCATED AT THE TANK OR IN A LOCATION APPROVED BY THE
- 8. ALL ABOVE GROUND FIRE SPRINKLER OR FIRE HYDRANT WATER PIPING SHALL BE METALLIC. 9. LABEL ALL TANKS, PIPES, \$ VALVES FOR FUNCTION: "FIRE", "DOMESTIC",
- 10. SEE WATER SYSTEM PLAN FOR DETAILED DESIGN OF FIRE PROTECTION SYSTEM. THE DETAIL SHOWN IS A SCHEMATIC DRAWING FOR PLANNING APPROVAL. IF THESE DETAILS CONFLICT WITH THE WATER SYSTEM PLAN, THE WATER SYSTEM PLAN SHALL GOVERN.
- II. DOMESTIC & FIRE WATER SUPPLY SHALL NOT BE IN SEPARATE TANKS. 12. WATER SUPPLY SHALL BE IN MINIMUM TWO TANKS. ALL FITTINGS SHALL OPERATE IN A MANNER ALLOWING ONE TANK TO REMAIN OPERATING WHILE THE OTHER TANK IS REPAIRED.
- 13. WATER TANKS SHALL BE CONSTRUCTED OF NON-COMBUSTABLE MATERIALS. 14. DOMESTIC WATER SHALL BE STORED IN STAINLESS STEEL.

RURAL HYDRANTS:

OR "LANDSCAPE."

ELEVATED

DOMESTIC TANK.

I. HYDRANTS SHALL BE LOCATED NO CLOSER THAN 50' TO ANY BUILDING, NO FURTHER AWAY THAN 150' OF THE PROTECTED STRUCTURE, AND BE LOCATED ON THE FIRE DEPARTMENT ACCESS SIDE OF THE BUILDING.

- 2. HYDRANT SUPPLY PIPE SHALL BE LISTED AND APPROVED FOR FIRE PROTECTION SERVICE FOR UNDERGROUND PIPE, SUCH AS AWWA C900. 3. PIPES SUPPLYING RURAL HYDRANTS SHALL HAVE A MINIMUM DIAMETER OF
- NO LESS THAN 4" STANDARD. 4. RURAL HYDRANTS SHALL HAVE AT LEAST ONE 41 OUTLET WITH "NATIONAL
- HOSE" THREAD STANDARD AND SHALL HAVE A REMOVABLE METALLIC CAP. 5. THE HYDRANT RISER AND ELBOW SHALL BE STEEL. ALL ABOVE GROUND PIPING USED FOR FIRE HYDRANT WATER SUPPLY SHALL BE METALLIC.
- 6. HYDRANTS SHALL HAVE A CONCRETE PAD. SEE DETAIL 7. ALL HYDRANTS SHALL BE POSITIVE PRESSURE AND MEET THE REQUIRED FIRE FLOW ON DEMAND. (HYDRANTS REQUIRING PRIMING, SHALL NOT BE CONSIDERED AS A PRIMARY WATER SOURCE.
- 8. CONCRETE THRUST BLOCKS (WHEN REQUIRED) SHALL BE SIZED IN ACCORDANCE WITH NATIONAL STANDARDS AND SHALL BE PROVIDED AT ALL CHANGES IN PIPE DIRECTION. SEE DETAIL
- 9. ALL HYDRANTS SHALL HAVE A 3' DIAMETER MINIMUM PHYSICAL CLEARANCE FROM RETAINING WALLS GUARDPOSTS, ROCKS etc.
- 10. FLAMMABLE VEGETATION SHALL BE CLEARED FOR A MINIMUM 8' RADIUS AROUND ALL HYDRANTS REGARDLESS OF TYPE.
- II. PERMANENT GUARD POSTS OR BOLLARDS SHALL BE INSTALLED TO PROTECT EXPOSED FIRE HYDRANTS FROM VEHICULAR DAMAGE. 12. HYDRANTS SHALL NOT BE OBSTRUCTED BY PARKING OR IN ANY OTHER
- MANNER. "NO PARKING" SIGNS MAY BE REQUIRED. 13. HYDRANT LOCATION SHALL BE IDENTIFIED BY THE INSTALLATION OF BLUE
- REFLECTIVE MARKERS. 14. RURAL HYDRANTS SHALL HAVE A PERMANENT SIGN AFFIXED, RED IN COLOR WITH WHITE I INCH LETTERS STATING "WET DRAFT HYDRANT___GALLONS", WITH THE GALLONS OF WATER AVAILABLE TO THE
- HYDRANT PROVIDED, SHALL BE PAINTED RED AND HAVE A MINIMUM 2" BLUE REFLECTIVE BAND AROUND THE TOP OF THE PIPE JUST BELOW THE

CULVERT:

SEE GARAGE COURTYARD ON ALS

I. WHEN A CULVERT IS USED AS A PART OF EMERGENCY ACCESS, IT SHALL BE CONSTRUCTED AND MAINTAINED IN ACCORDANCE WITH AASHTO HB-I7. THE CULVERT SHALL BE DESIGNED FOR A LIVE LOAD SUFFICIENT TO CARRY THE IMPOSED LOADS OF FIRE APPARATUS AS STATED HEREIN:

- 2. WEIGHT: EVERY PRIVATE CULVERT (BRIDGE) HEREAFTER CONSTRUCTED OR RE-CONSTRUCTED DUE TO DAMAGE, DETERIORATION, OR OBSOLESCENCE SHALL BE DESIGNED TO SUPPORT AN IMPOSED LOAD OF FIRE APPARATUS WEIGHING AT LEAST 75,000 lbs. <u>VEHICLE LOADS SHALL BE POSTED AND</u> DATED AT BOTH ENTRANCES TO BRIDGES. (HS20-44 HIGHWAY LOADING)
- 3. WIDTH: ALL CULVERTS (BRIDGES) MUST BE A MINIMUM OF 20 FEET CLEAR WIDTH. ONE-WAY CULVERTS (BRIDGES), AND CULVERTS (BRIDGES) WITH LESS THAN 20' OF CLEAR WIDTH, REQUIRE A TURNOUT AT BOTH ENDS TO

1/4'' = 1'-0''

I. GATES SHALL BE A MINIMUM OF 2 FEET WIDER THAN THE ROADWAY THEY

- 2. OVERHEAD GATE STRUCTURES SHALL HAVE A MINIMUM OF 131 FEET OF
- VERTICAL CLEARANCE. 3. LOCKED GATES SHALL BE PROVIDED WITH A KNOX BOX OR KNOX PADLOCK FOR THE FIRE DEPARTMENT ACCESS.
- 4. ELECTRIC GATES SHALL BE PROVIDED WITH A KNOX GATE SWITCH AND AUTOMATICALLY OPEN DURING POWER FAILURES UNLESS EQUIPPED WITH MANUAL OVERRIDE CAPABILITY (WHEN AUTHORIZED BY COASTSIDE FIRE
- 5. GATES PROVIDING FIRE ACCESS TO A DRIVEWAY OR OTHER ROADWAY SHALL BE LOCATED AT LEAST 35 FEET FROM THE PRIMARY ROAD OR STREET AND SHALL OPEN TO ALLOW A VEHICLE TO STOP WITHOUT OBSTRUCTING TRAFFIC ON THE ADJOINING ROADWAY. 6. CONTACT COASTSIDE FIRE DISTRICT FOR KNOX BOX APPLICATION.

EMERGENCY ACESS ROADS SEE Al.4, Al.6, AND CIVIL DRAWINGS

I. EMERGENCY ACCESS ROADS SHALL HAVE AN UNOBSTRUCTED MINIMUM

- WIDTH OF 20'-0". 2. WHERE HYDRANTS ARE LOCATED, THE ROAD SHALL BE A MINIMUM OF 26 FEET WIDE FOR A LENGTH OF 20 FEET ON EACH SIDE OF THE HYDRANT
- (40 FEET TOTAL LENGTH). 3. EMERGENCY ACCESS ROADS SHALL HAVE 13'-6" FEET OF VERTICAL
- CLEARANCE. 4. EMERGENCY ACCESS ROADS SHALL BE DESIGNED AND MAINTAINED TO SUPPORT THE IMPOSED LOAD OF A FIRE APPARATUS WEIGHING AT LEAST 75,000 lbs AND SHALL HAVE A MINIMUM OF 2" ASPHALT SURFACE PROVIDING ALL-WEATHR DRIVING CAPABILITIES. SEE CIVIL DETAILS.
- 5. GRADES OF LESS THAN 15% SHALL BE SURFACED WITH A MINIMUM CLASS 2 AGGREGATE BASE WITH 95% COMPACTION AND AN ASPHALT SURFACE. U.O.N.
- 6. GRADES OF 15% TO 20% SHALL REQUIRE A NON-SKID ASPHALT OR CONCRETE SURFACE, OR EQUIVALENT. U.O.N.
- GRADES 15% TO 20% SHALL BE LIMITED TO 150 FT. IN LENGTH. 8. THE CENTERLINE TURNING RADIUS FOR EMERGENCY APPARATUS ACCESS ROADS SHALL BE 35 FEET.
- 9. DEAD-END EMERGENCY ACCESS EXCEEDING 150 FT SHALL BE PROVIDED WITH WIDTH AND TURNAROUND PROVISIONS MEETING CALIFORNIA FIRE CODE
- 10. TURNAROUNDS SHALL HAVE A MAXIMUM LONGITUDINAL SLOPE NO GREATER THAN EIGHT PERCENT (8%). THE LONGITUDINAL SLOPE IS DEFINED AS THE SLOPE CORRESPONDING TO THE LONG AXIS OF A VEHICLE AS IT TRAVELS INTO, OUT OF, AND THROUGH A TURNAROUND. THIS SLOPE SHALL BE MAINTAINED BEGINNING AT AND ENDING AT THE POINT OF TANGENCY OF
- THE EDGE OF THE PAVEMENT CURVES FOR THE TURNAROUND. II. THE CROSS SLOPE PERPENDICULAR TO THE LONGITUDINAL SLOPE SHALL
- NOT EXCEED FIVE PERCENT (5%).
- 12. ROAD GRADES SHALL NOT EXCEED 20%. 13. GRADES 15% TO 20% SHALL BE LIMITED TO 150 FT. IN LENGTH. 14. 20-26 FEET ROAD WIDTH-NO PARKING ON EITHER SIDE OF THE ROADWAY.
- 15. 26-35 FEET ROAD WITH-PARKING IS ALLOWED ON ONLY ONE SIDE OF ROADWAY.
- 16. 36 FEET ROAD WITH-PARKING IS NOT RESTRICTED. 17. POLES, FENCES, STONES, OR VISIBLE MARKERS SHALL INDICATE THE EDGE
- OF FIRE LANES. 18. PROVIDE ALLOWANCE FOR ALL SIGNS AND MARKERS

BRIDGE:

NO BRIDGES USED. CULVERTS ONLY USED.

- I. BRIDGES SHALL MEET ALL CULVERT REQUIREMENTS. 2. CERTIFICATION: EVERY PRIVATE BRIDGE PROVIDING FIRE APPARATUS ACCESS HEREINAFTER CONSTRUCTED OR RE-CONSTRUCTED SHALL BE ENGINEERED BY A LICENSED CIVIL OR STRUCTURAL ENGINEER AND APPROVED BY THE FIRE MARSHAL. CERTIFICATION THAT THE BRIDGE COMPLIES WITH STRUCTURAL DESIGN STANDARDS MUST BE PROVIDED TO
- THE FIRE CHIEF. 3. RE-CERTIFICATION: EVERY PRIVATE BRIDGE SHALL BE RE-CERTIFIED EVERY TEN (10) YEARS OR WHENEVER DEEMED NECESSARY BY THE FIRE MARSHALL

BUILDING FIRE PROTECTION:

SEE PLANS AND DETAILS

- 1. THE BUILDING SHALL BE FULLY PROTECTED WITH A MODIFIED NFPA 13D RESIDENTIAL FIRE SPRINKLER SYSTEM AS REQUIRED BY THE CODE.
- 2. PROVIDE DRAFT STOPS AND FIRE BLOCKING AS REQUIRED BY CBC. 3. SMOKE AND CARBON MONOXIDE ALARMS SHOWN ARE CONNECTED TO THE BUILDING'S ELECTRICAL SYSTEM. ALARMS SHALL HAVE BATTERY BACKUP.
- 4. PROVIDE SMOKE ALARMS IN EACH BEDROOM. NOTIFY ARCH IF ANY BEDROOMS DO NOT HAVE AN ALARM.
- 5. INTERCONNECT SMOKE ALARMS IN NEW CONSTRUCTION AND IN REMODELS. WITH REMODELS, INTERCONNECTION TO EXISTING BEDROOM ALARMS IS NOT REQUIRED IF FINISHES NEED TO BE REMOVED, U.O.N.
- 6. FIRE BLOCKS SHALL BE 2X NOMINAL LUMBER, 3/4" PLYWOOD, 5/8 GYPSUM WALL BOARD. BATT INSULATION OR MINERAL WOOL INSULATION MAY BE USED AS NOTED
- 7. FIRE BLOCK ALL STUD BAYS AND VERTICAL WALL CAVITIES WITHIN STRUCTURAL WALLS, PARTITION WALLS, STAIR STRINGERS, AND FURRED WALLS. PROVIDE BLOCKING AT THE FLOOR AND CEILING.
- 8. FIRE BLOCK IF WALLS EXCEED IO' IN HEIGHT, ADD BLOCKING AT IO'O.C. VERTICAL. BLOCK AT 10'O.C. HORIZONTAL. 9. FIRE BLOCK AT ALL INTERSECTIONS BETWEEN VERTICAL AND HORIZONTAL
- CAVITIES SUCH AS, CRAWL SPACE TO WALL, WALL TO CEILING, SOFFITS AND DROPPED CEILINGS. 10. FIRE BLOCK AT VENT, PIPE, DUCT, CHIMNEY, AND FIREPLACE OPENINGS.
- II. FIRE BLOCK AT CONCEALED OPENINGS BETWEEN FLOORS. 12. PROVIDE DRAFTSTOPS AT ALL OPEN CONCEALLED SPACES OR CAVITIES BETWEEN USABLE STACKED HABITABLE SPACES. IN THESE AREAS SUCH
- AS, OPEN WEB FLOOR JOIST OR TRUSSES, INSTALL DRAFTSTOPS AT THE FOLLOWING CONDITIONS:
- a.AREAS GREATER THAN 1000 SQUARE FEET b.AT EACH JOIST 30'O.C., AT EDGES OF KITCHEN
- c.AT GARAGE WALLS d.AT UTILITY ROOMS WITH EQUIPMENT USING COMBUSTIBLE FUELS. e.PROVIDE DRAFTSTOPS IN SOFFIT AREAS GREATER THAN 500 SQUARE
- 13. DRAFTSTOPS SHALL BE 2X LUMBER, SHEET METAL, 3/" PLYWOOD, OR 5/8"GYPSUM WALL BOARD.

WATER TANK CAPACITIES: SEE A2.5 FOR LOCATION.

SEE A3.11, A3.12, A3.13. SEE AI.4

10,000 GALLONS FOR FIRE SUPPRESSION.

4 - 2,500 GALLON TANKS. PLASTIC, ABV GRADE, "TUNA CAN". LOCATED UNDER STUDIO DECK. GRID 1-4/ LINES-B, D, F, H

2,000 GALLONS FOR SPRINKLER 2 - 1,000 GALLON TANKS. PLASTIC, ABV GRADE, "TUNA CAN". LOCATED UNDER STUDIO DECK. GRID LINE-L, APPROX

500 GALLONS FOR DOMESTIC AND LANDSCAPE I-ELEVATED TANK NORTH OF BARN, GRID LINE-D STAINLESS STEEL (300 GALLONS FOR DOMESTIC PER DAY PER PLANING PERMIT)

BEWLEY **RESIDENCE**

Project

Audubon Ave. Montara, CA 94037 A.P.N. 036-310-180

Architect

HM,a+e

Henri Mannik, Architecture and Engineering

> 5429 Telegraph Ave. Oakland, CA 94609 510 652 1511 p 510 601 7196 f

> > Consultant

Stamp

Printing Date


Planning Permit 03.18.2010 09.12.201 Coordination 09.13.201 Planning 10.05.201 Coordination 10.11.201 Coordination 07.19.2013 Coordination 08.08.201 Coordination 10.07.201 Coordination Coordination 10.21.2013 11.05.2013 Coordination Constraints Map 11.07.201 Constraints Map 11.25.2013 03.19.2014 Coordination D.R.Pre-app conf. 03.26.2014 Design Review 08.12.2014 Story Pole 11.14.2014 D.R. coord 06.08.2015 07.10.2015 Design Review


> HM,a+e Job Number 2005,01


> > Sheet Title


FIRE ACCESS & SITE DETAILS


Sheet Number

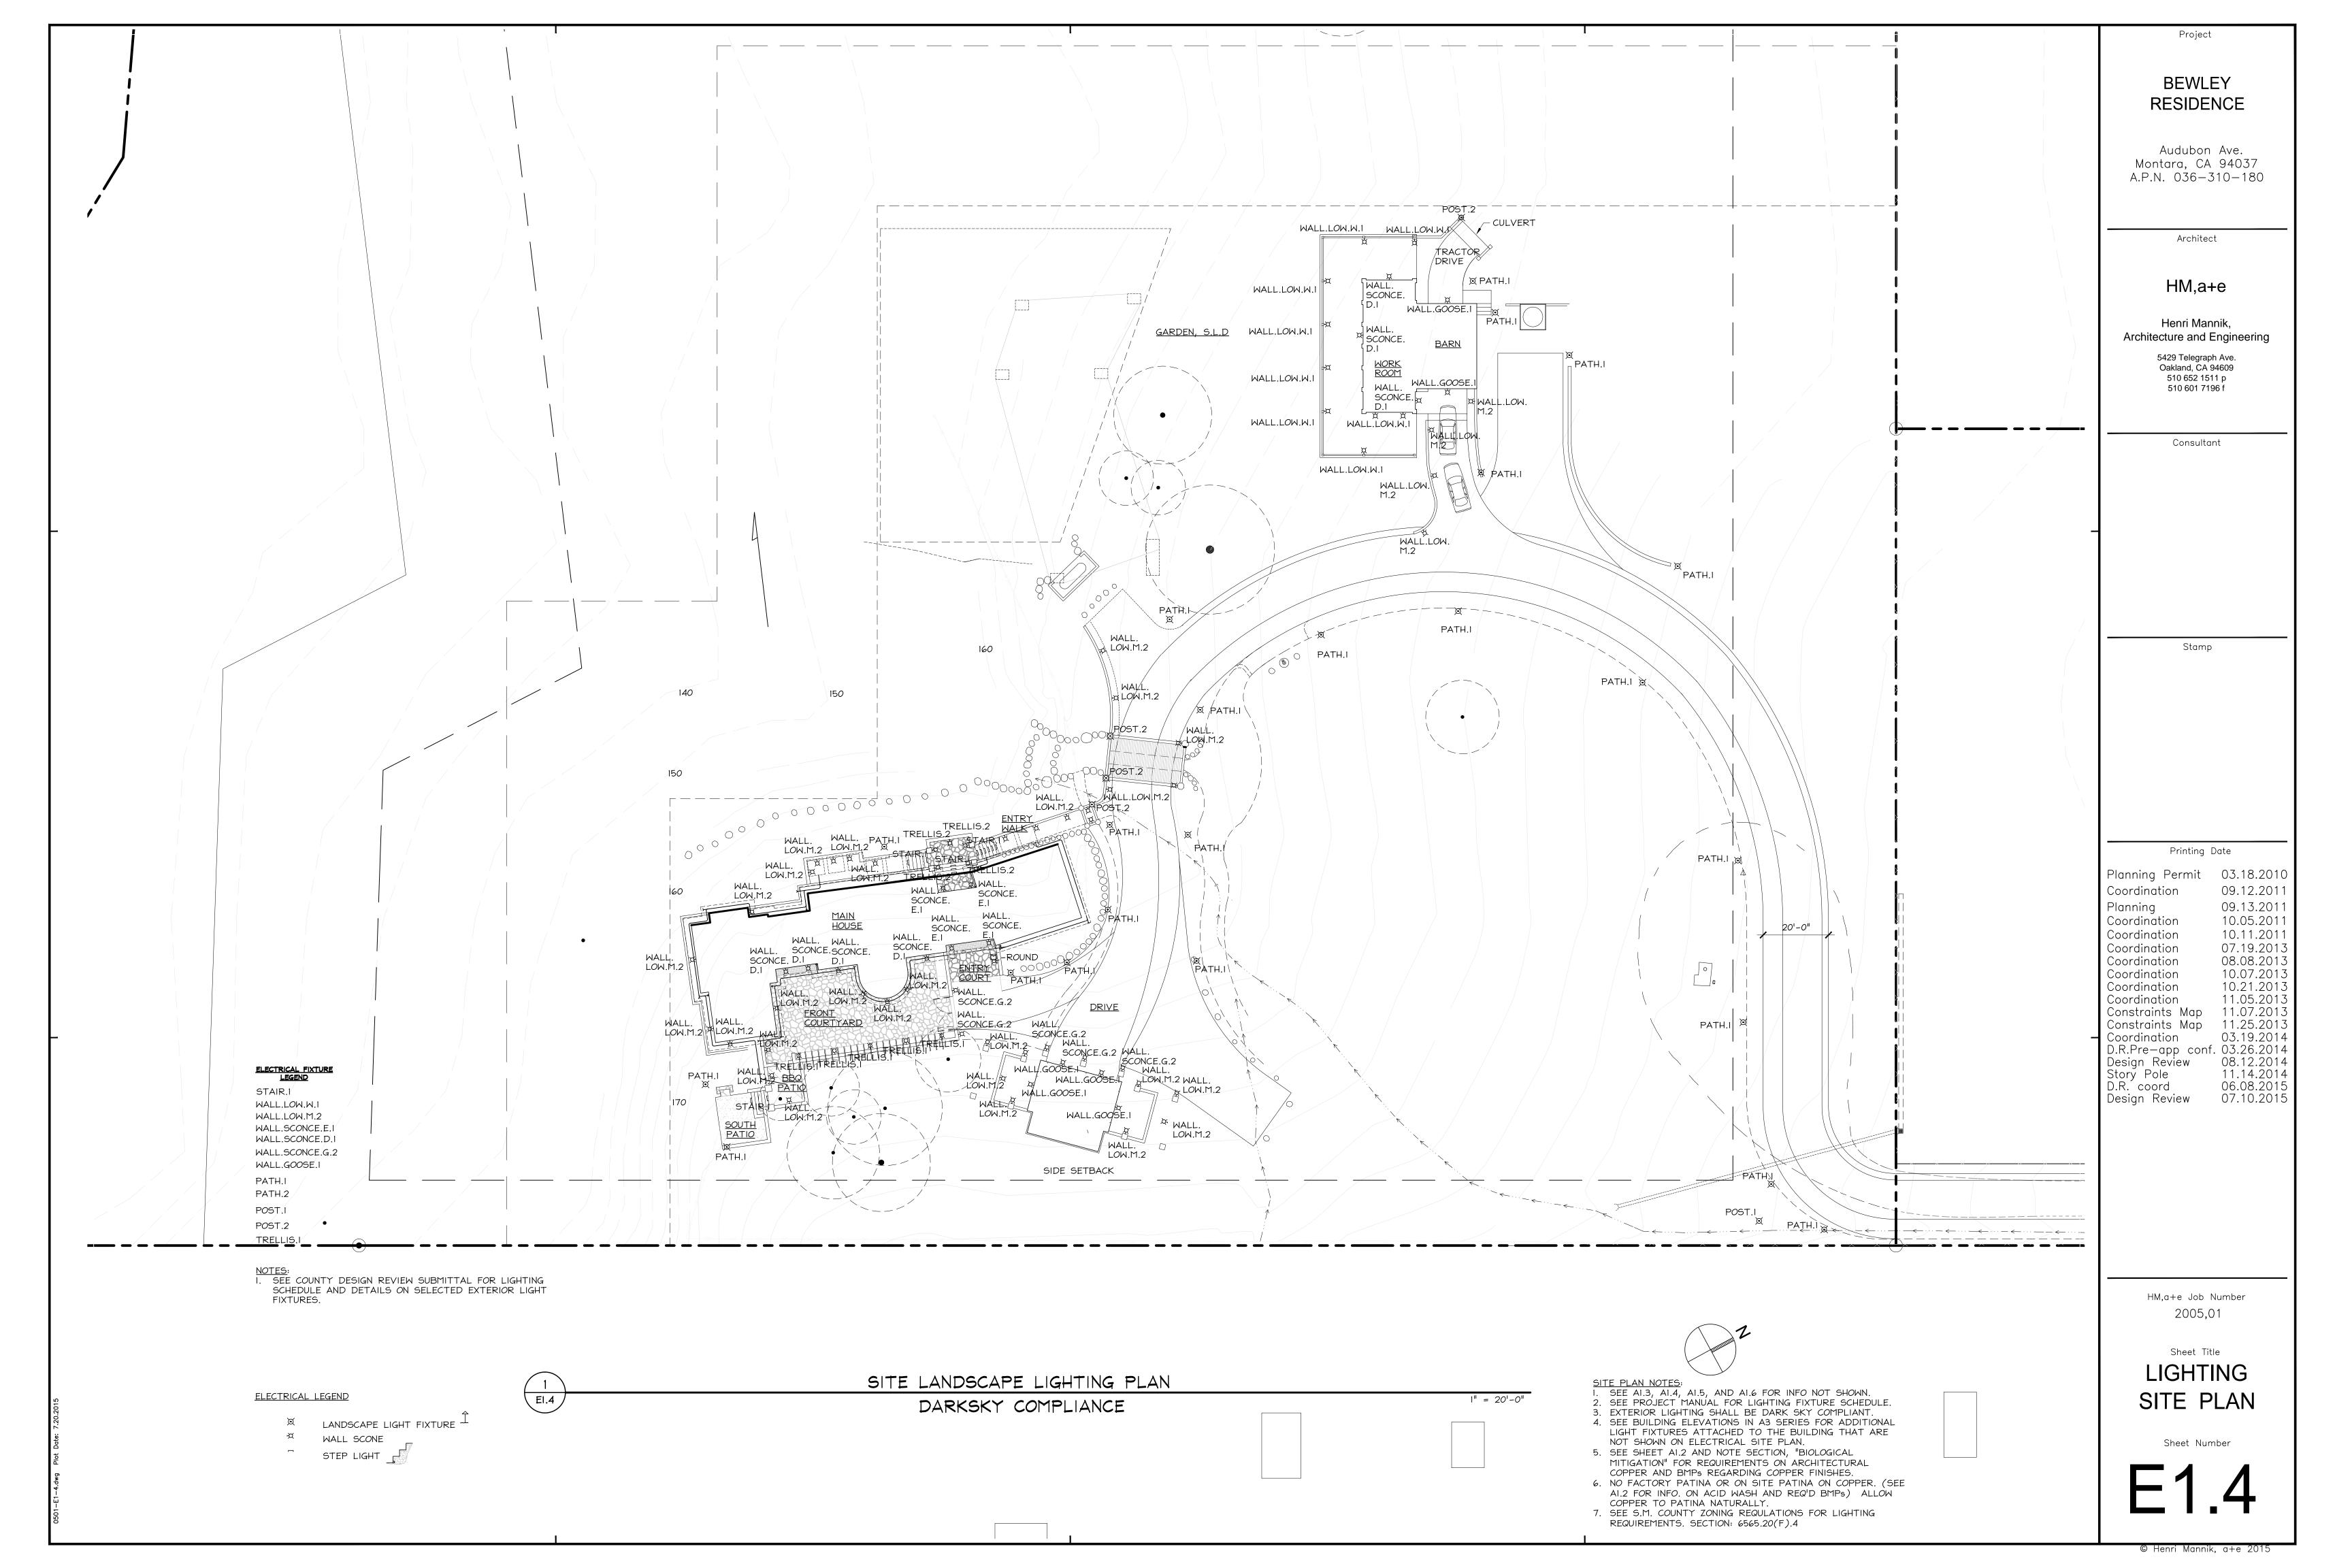


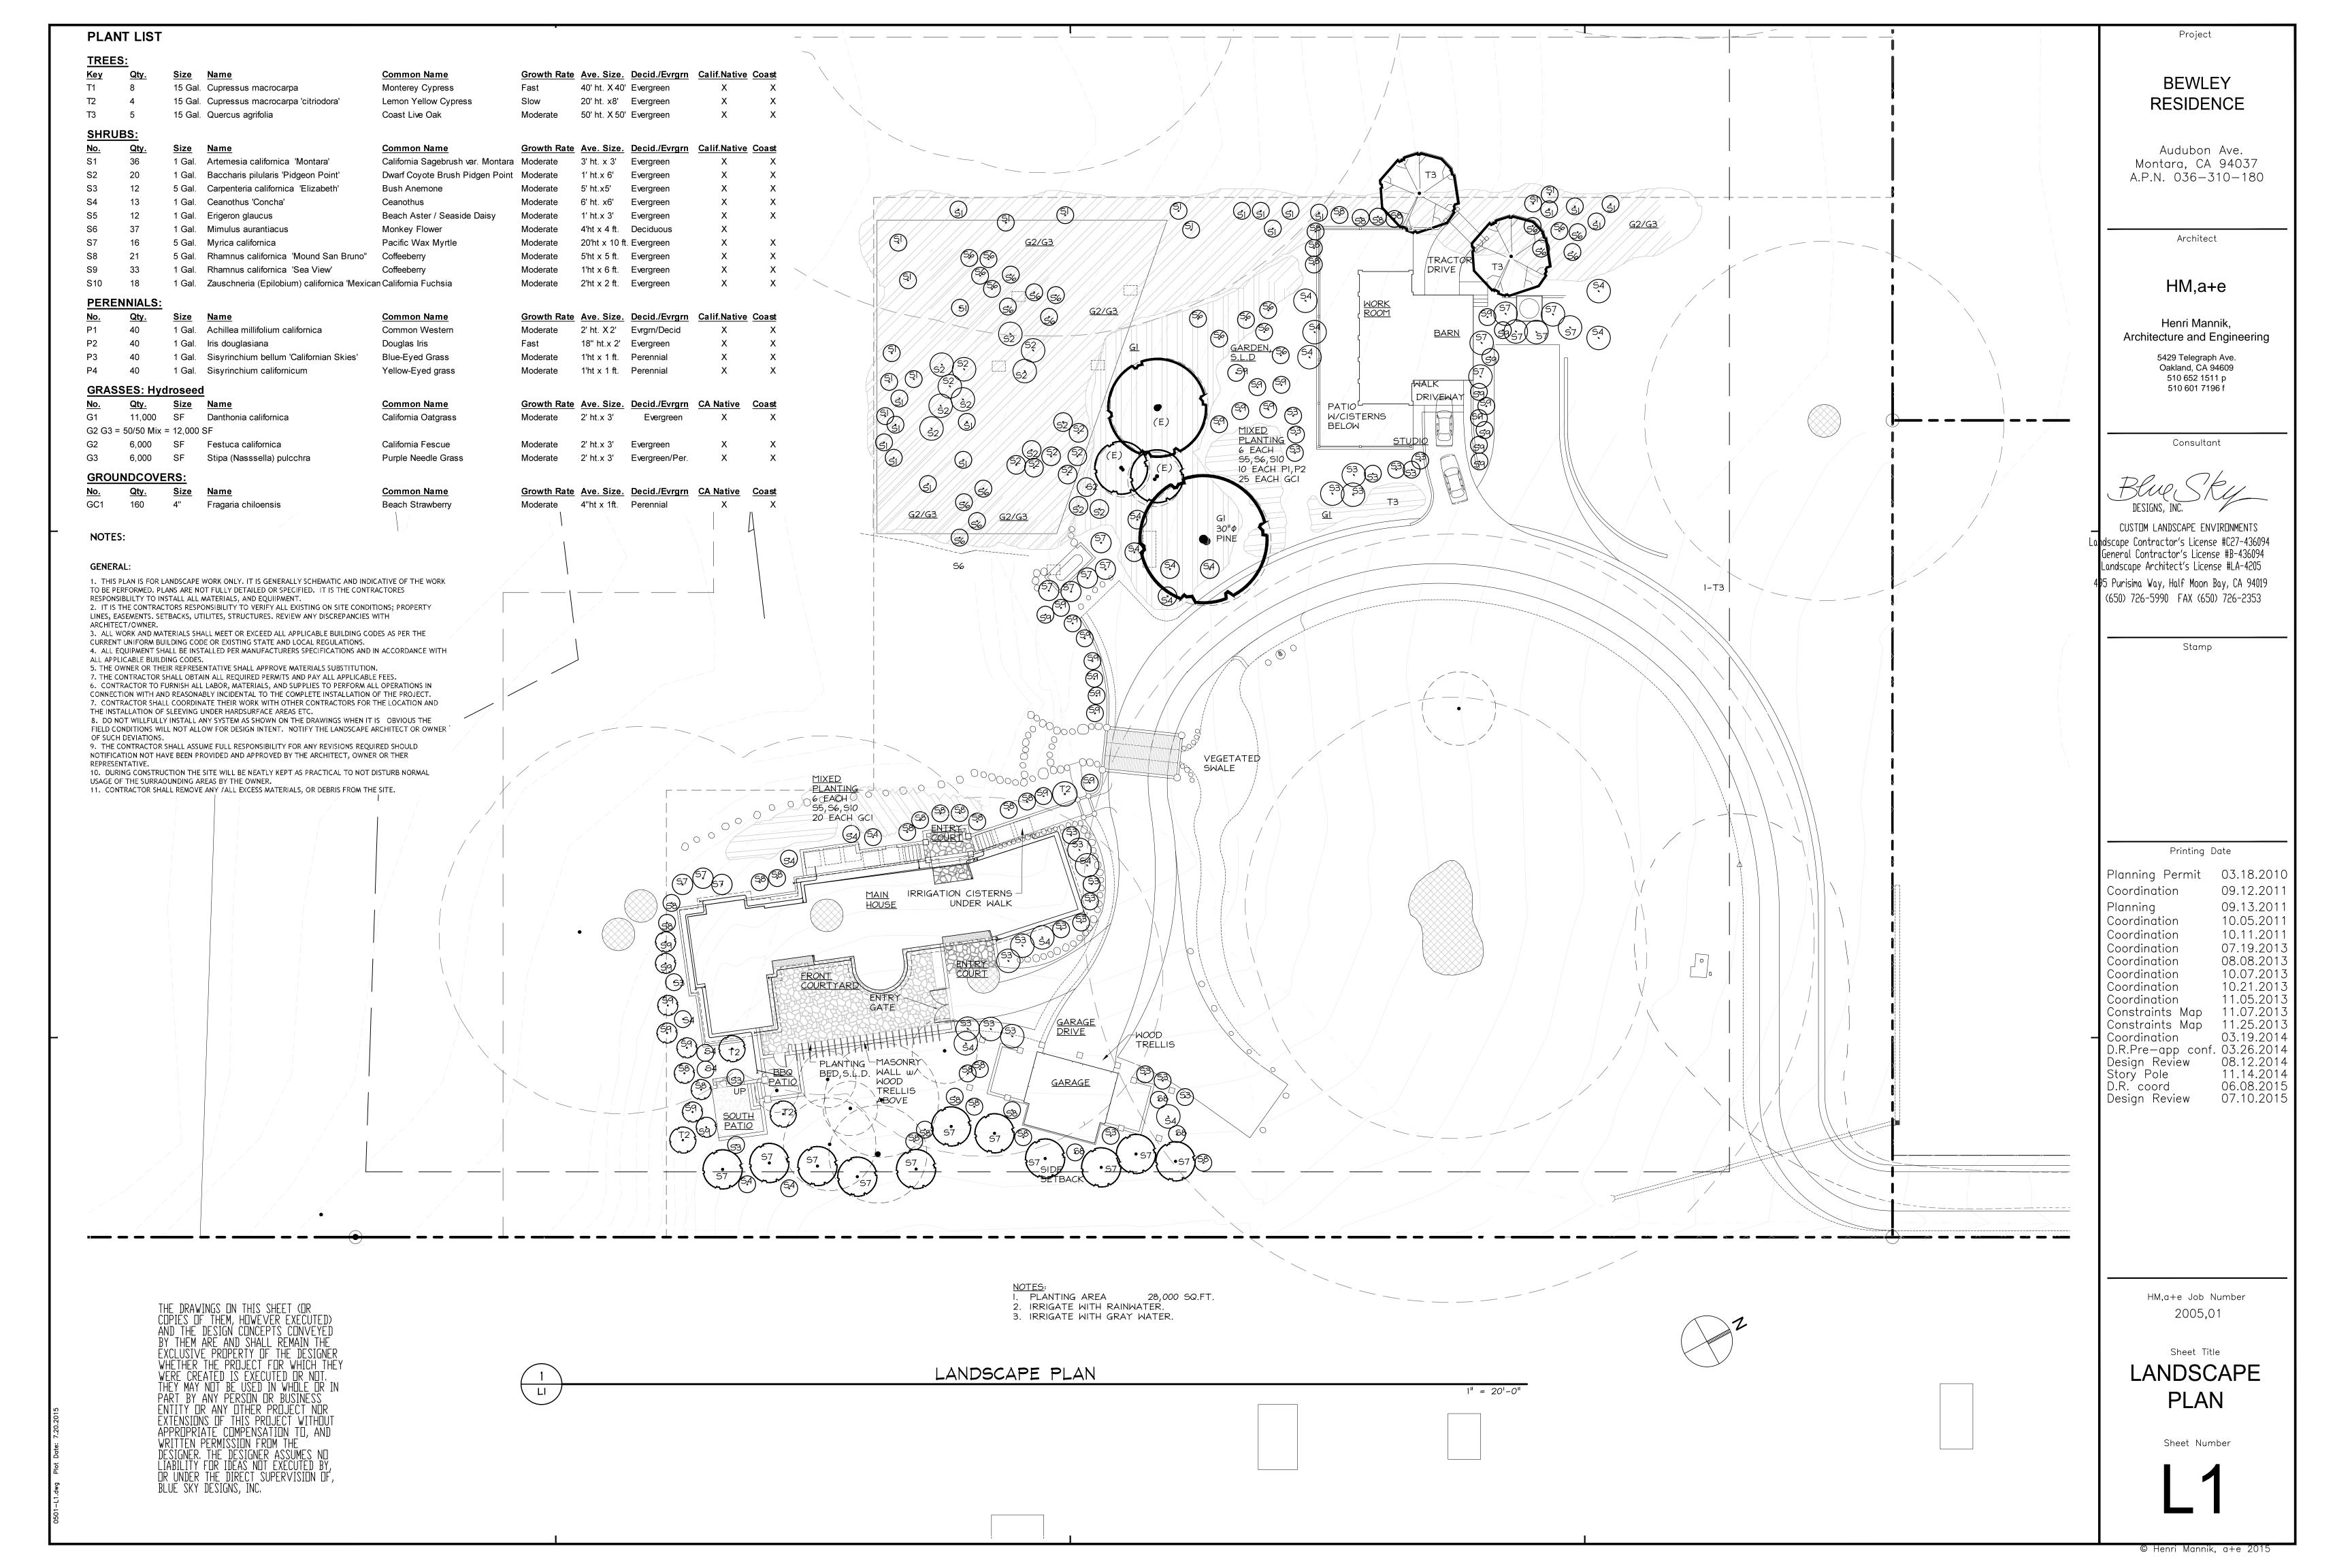


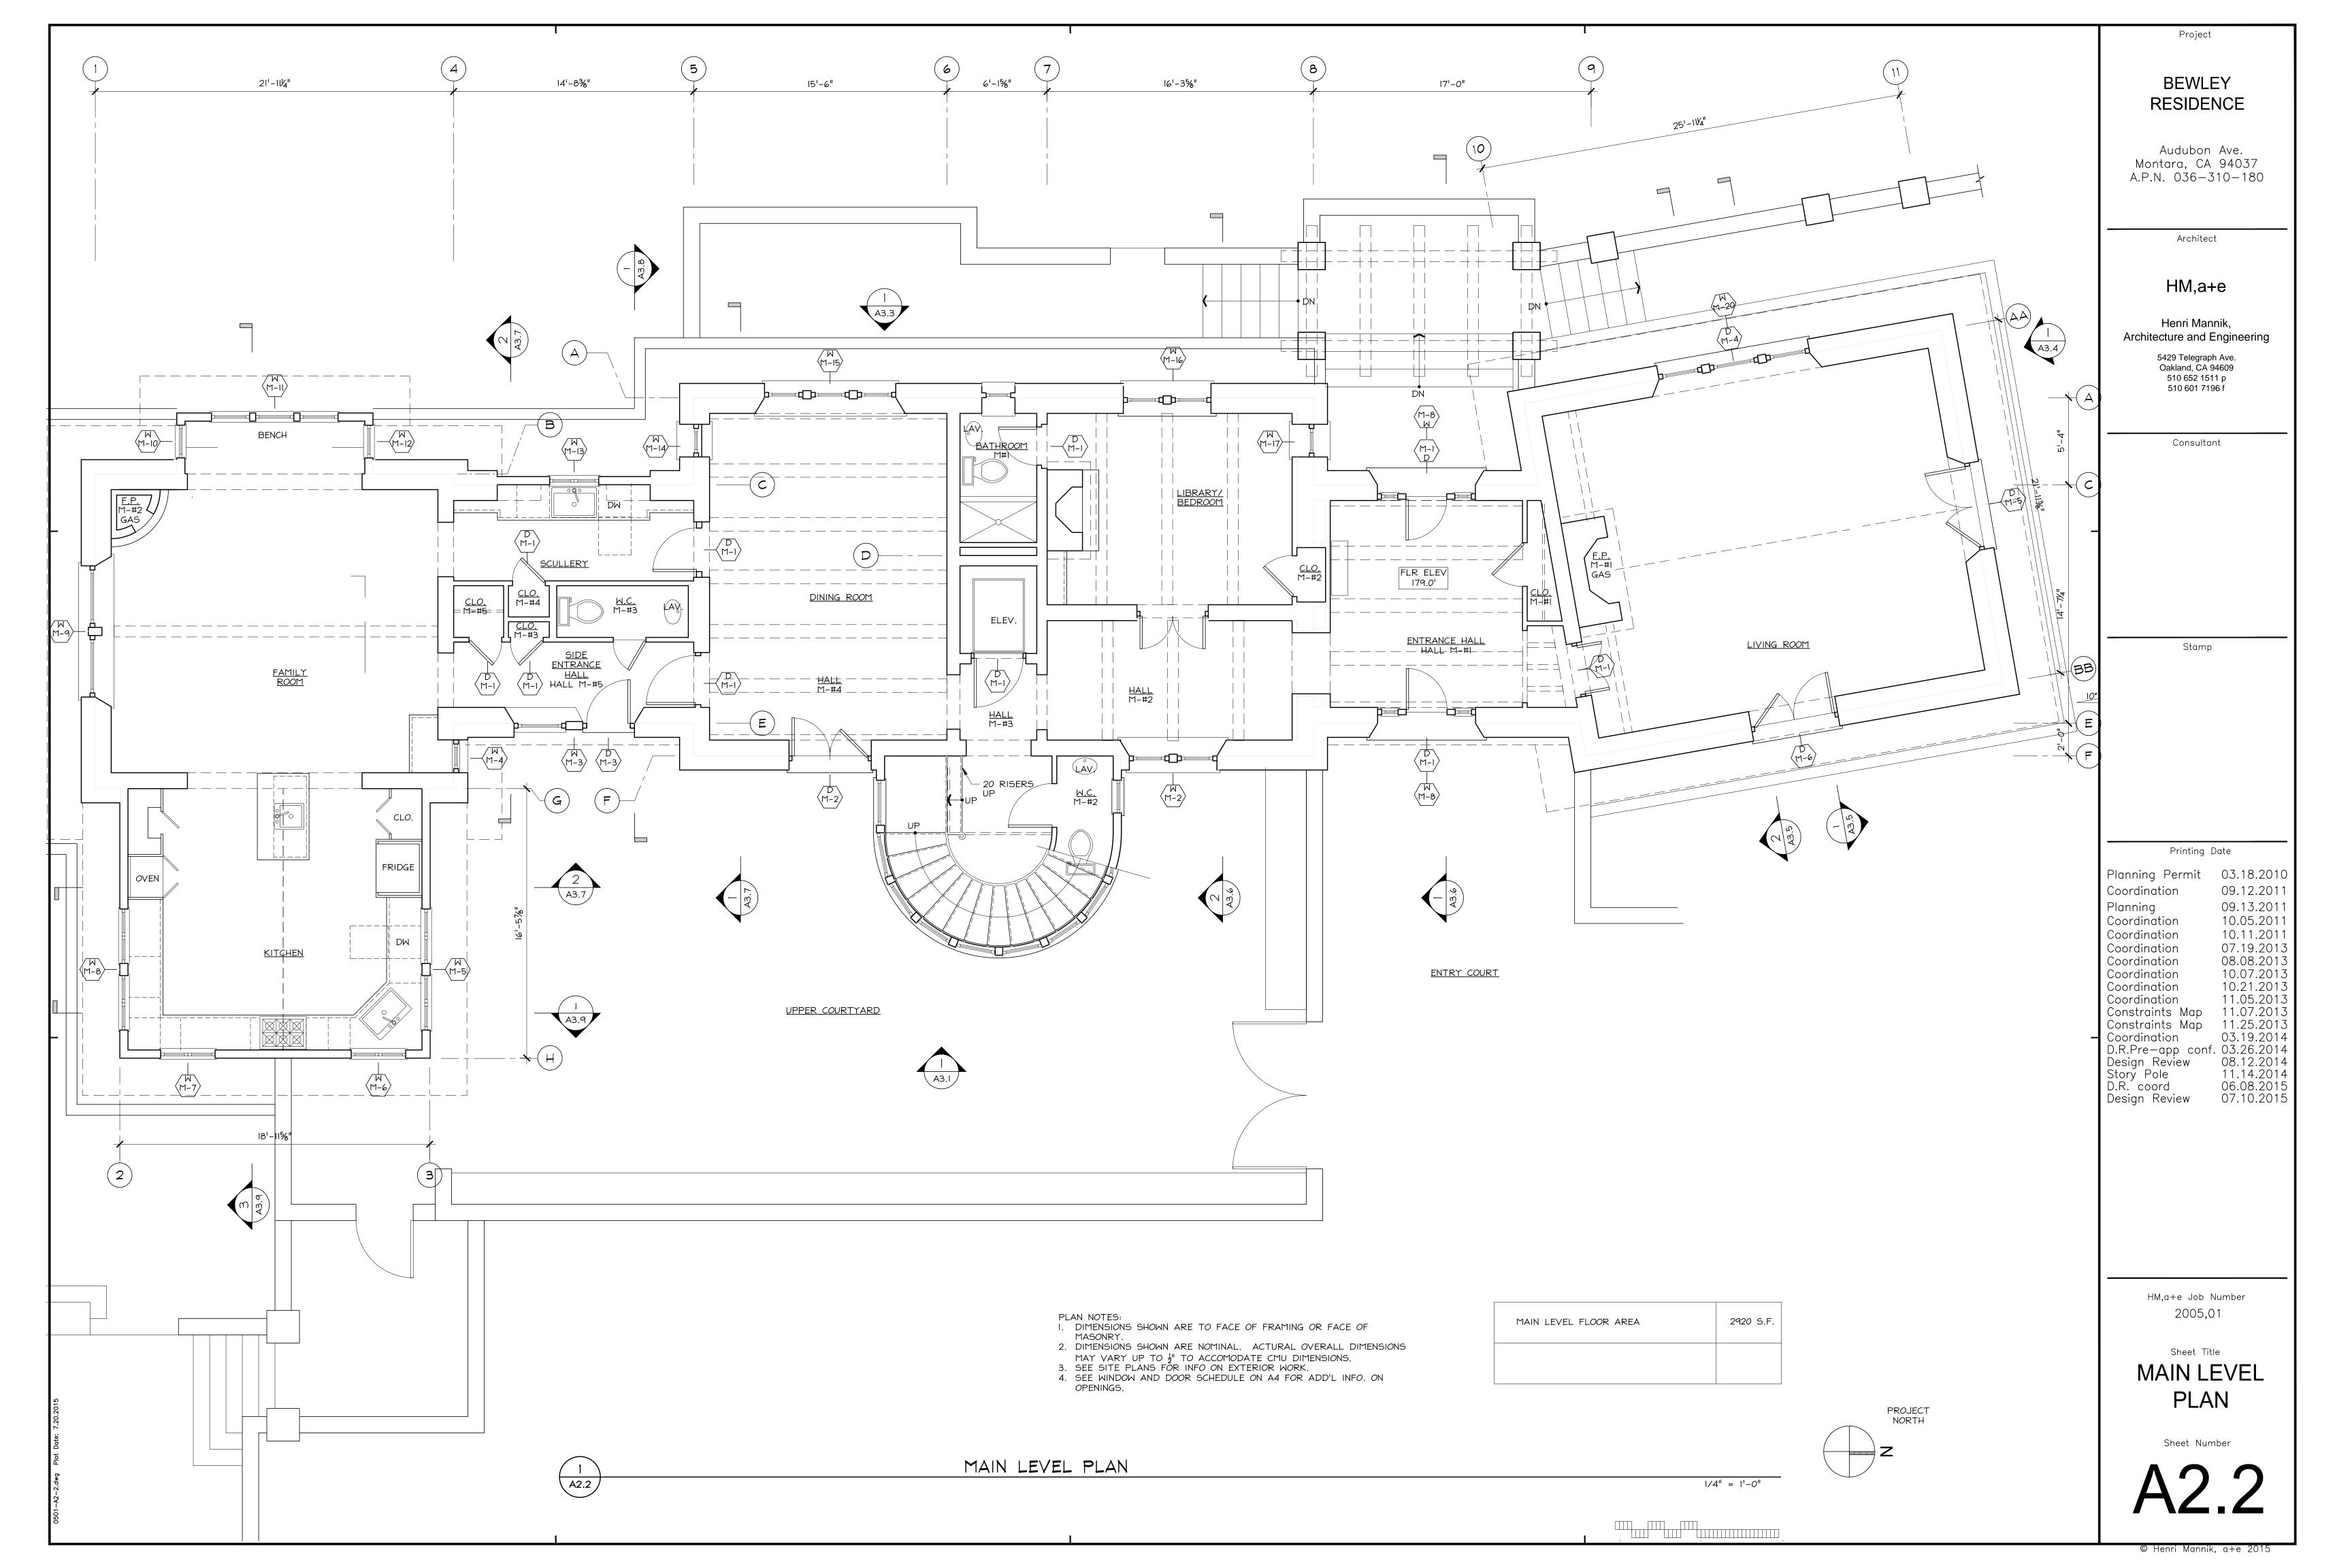


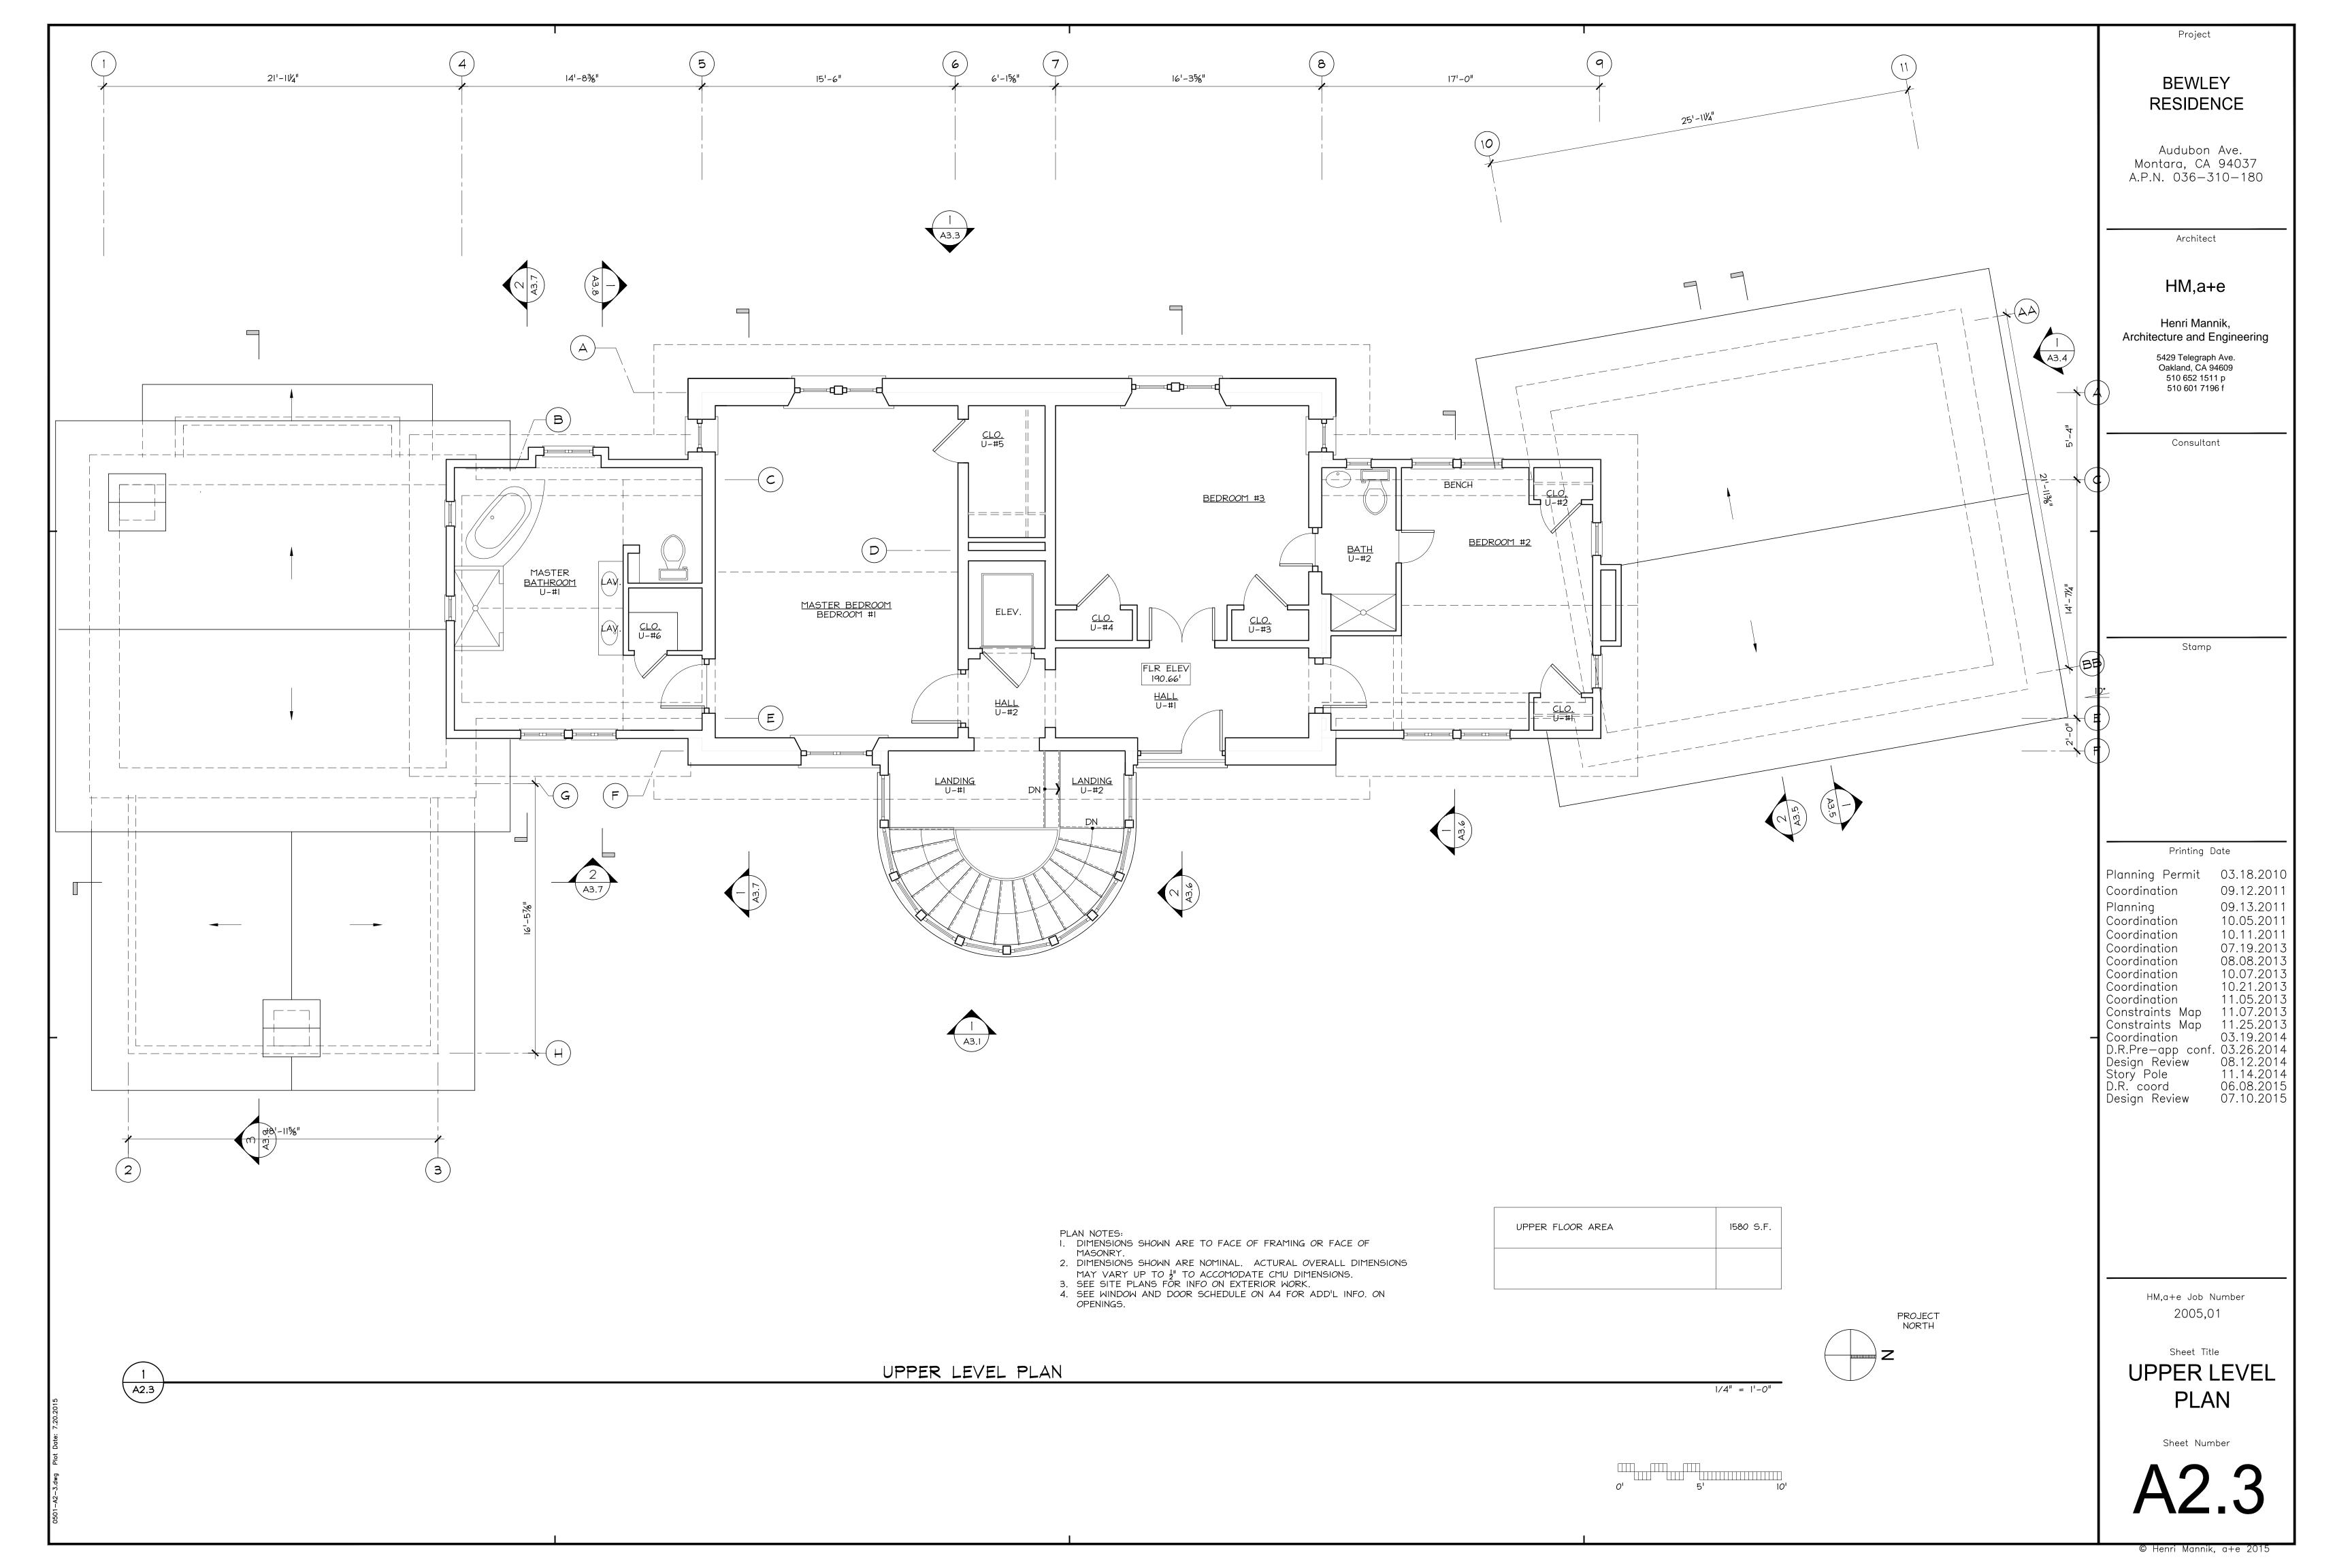

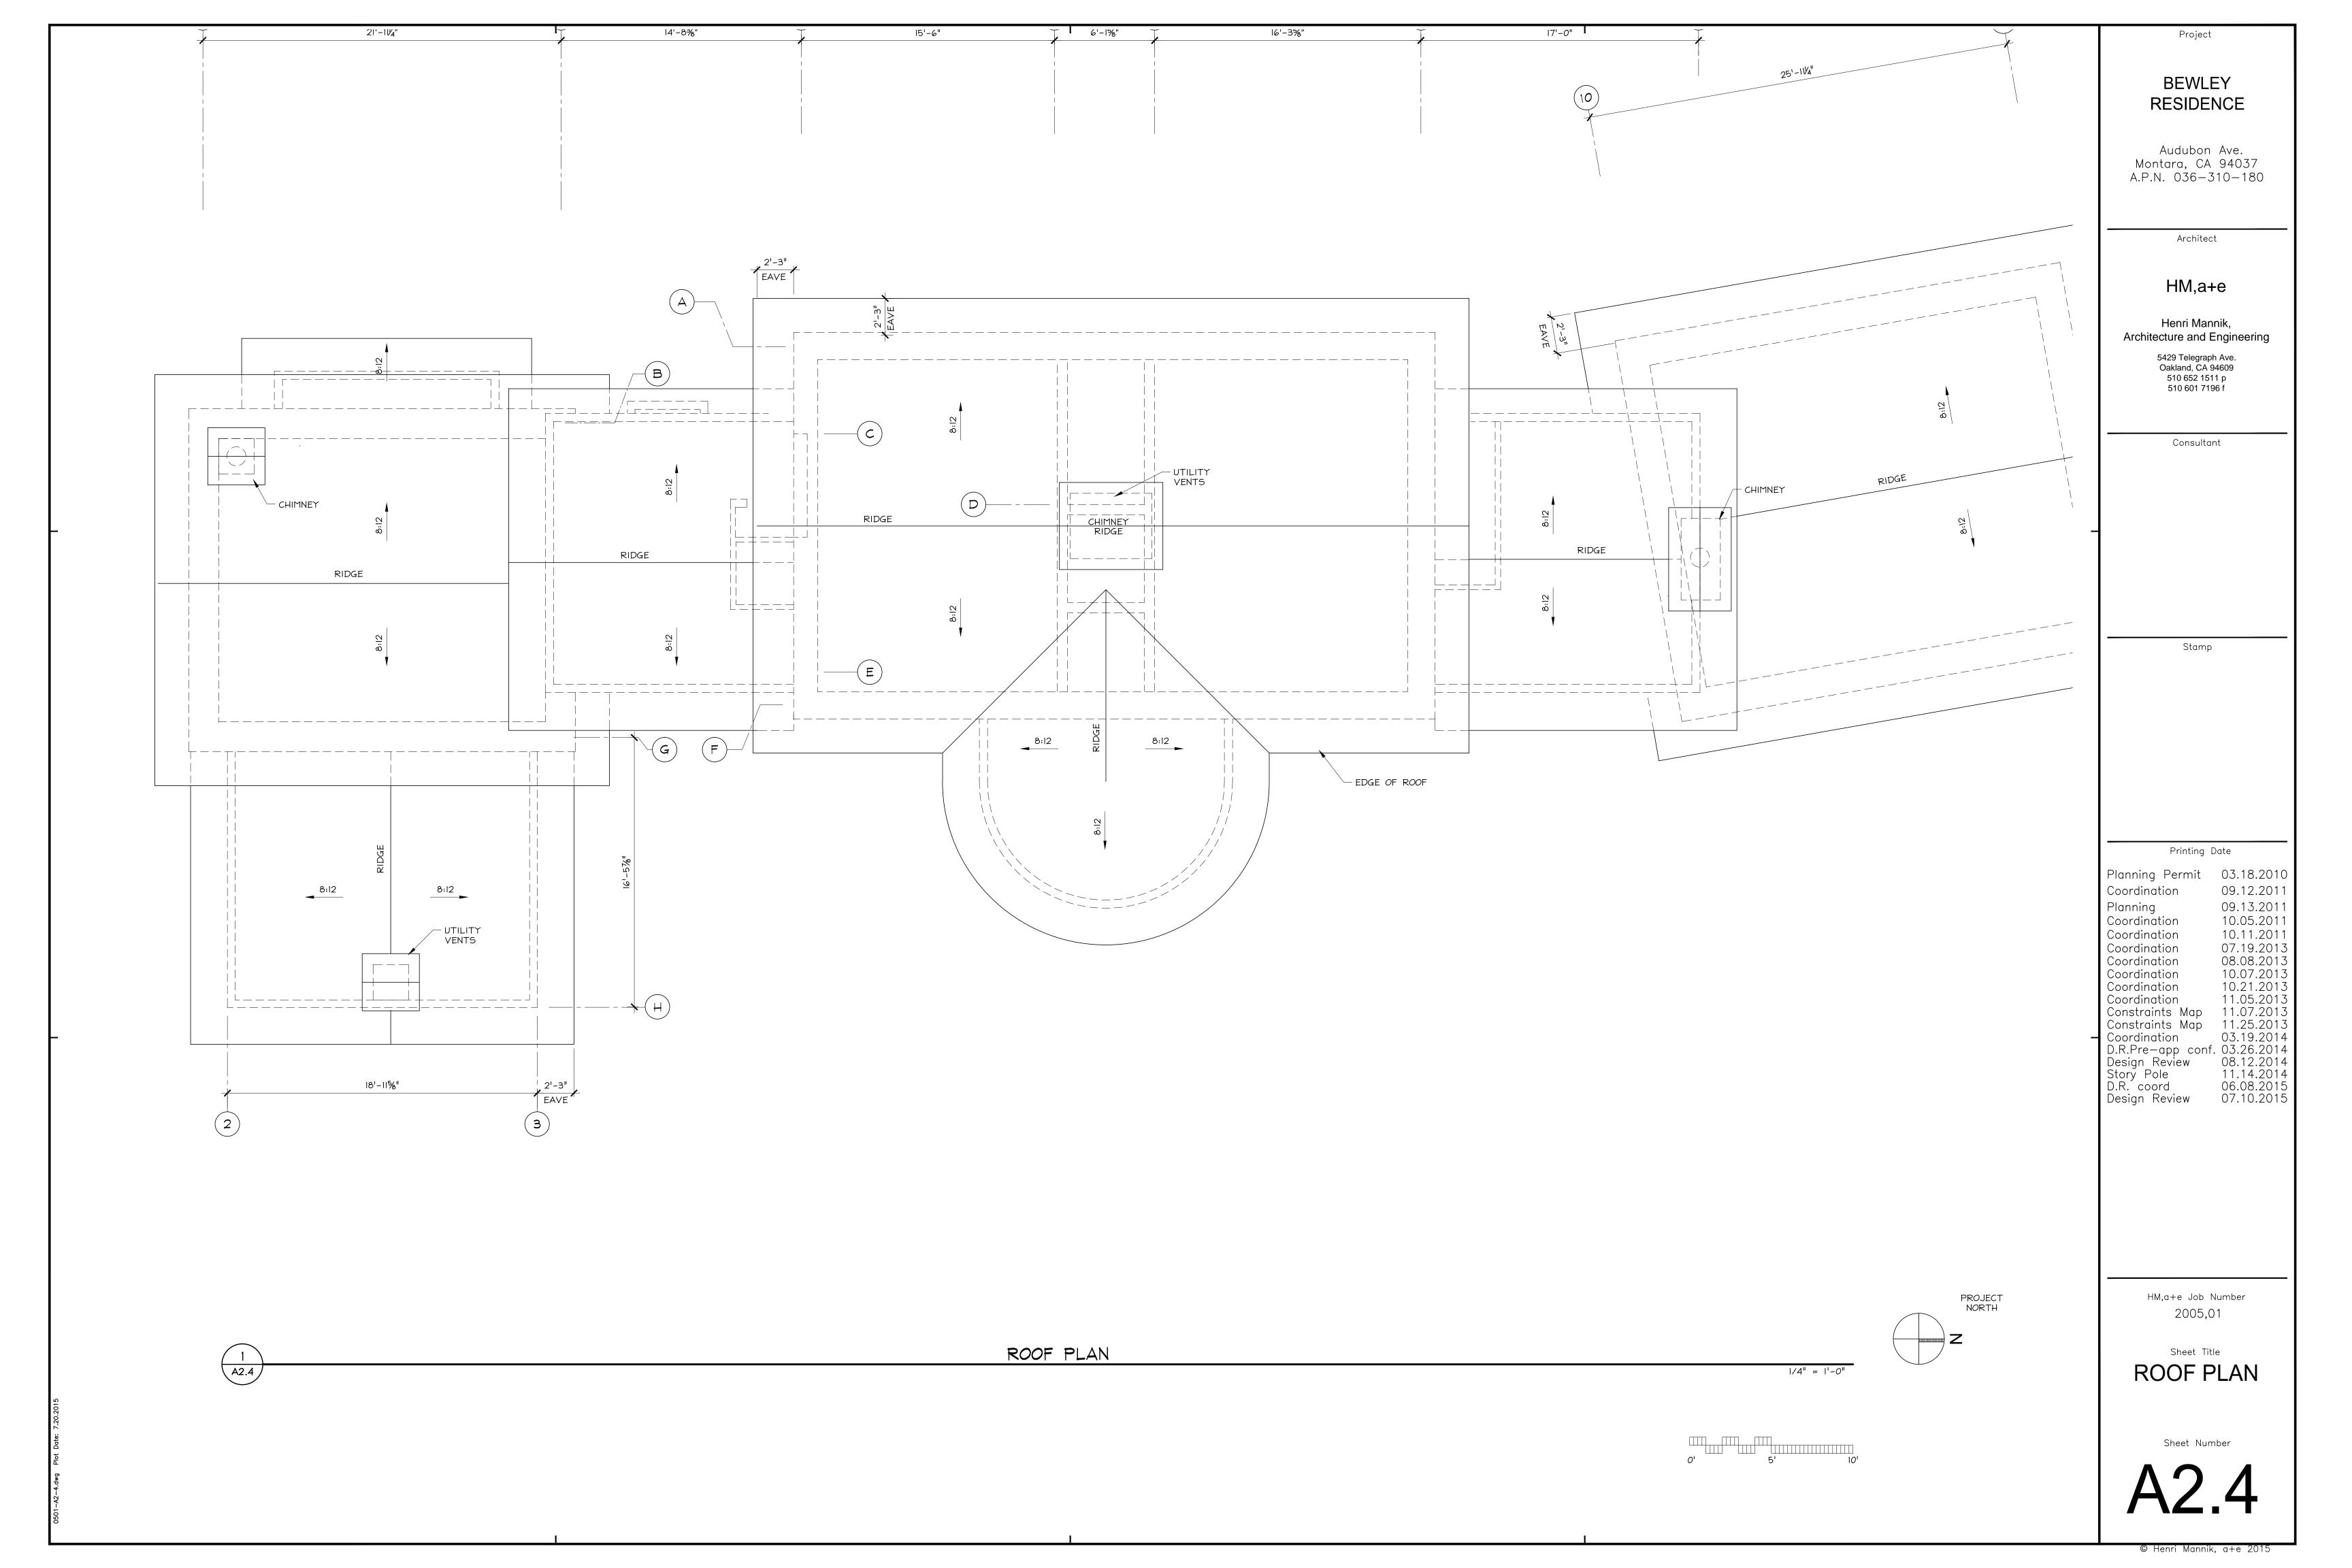

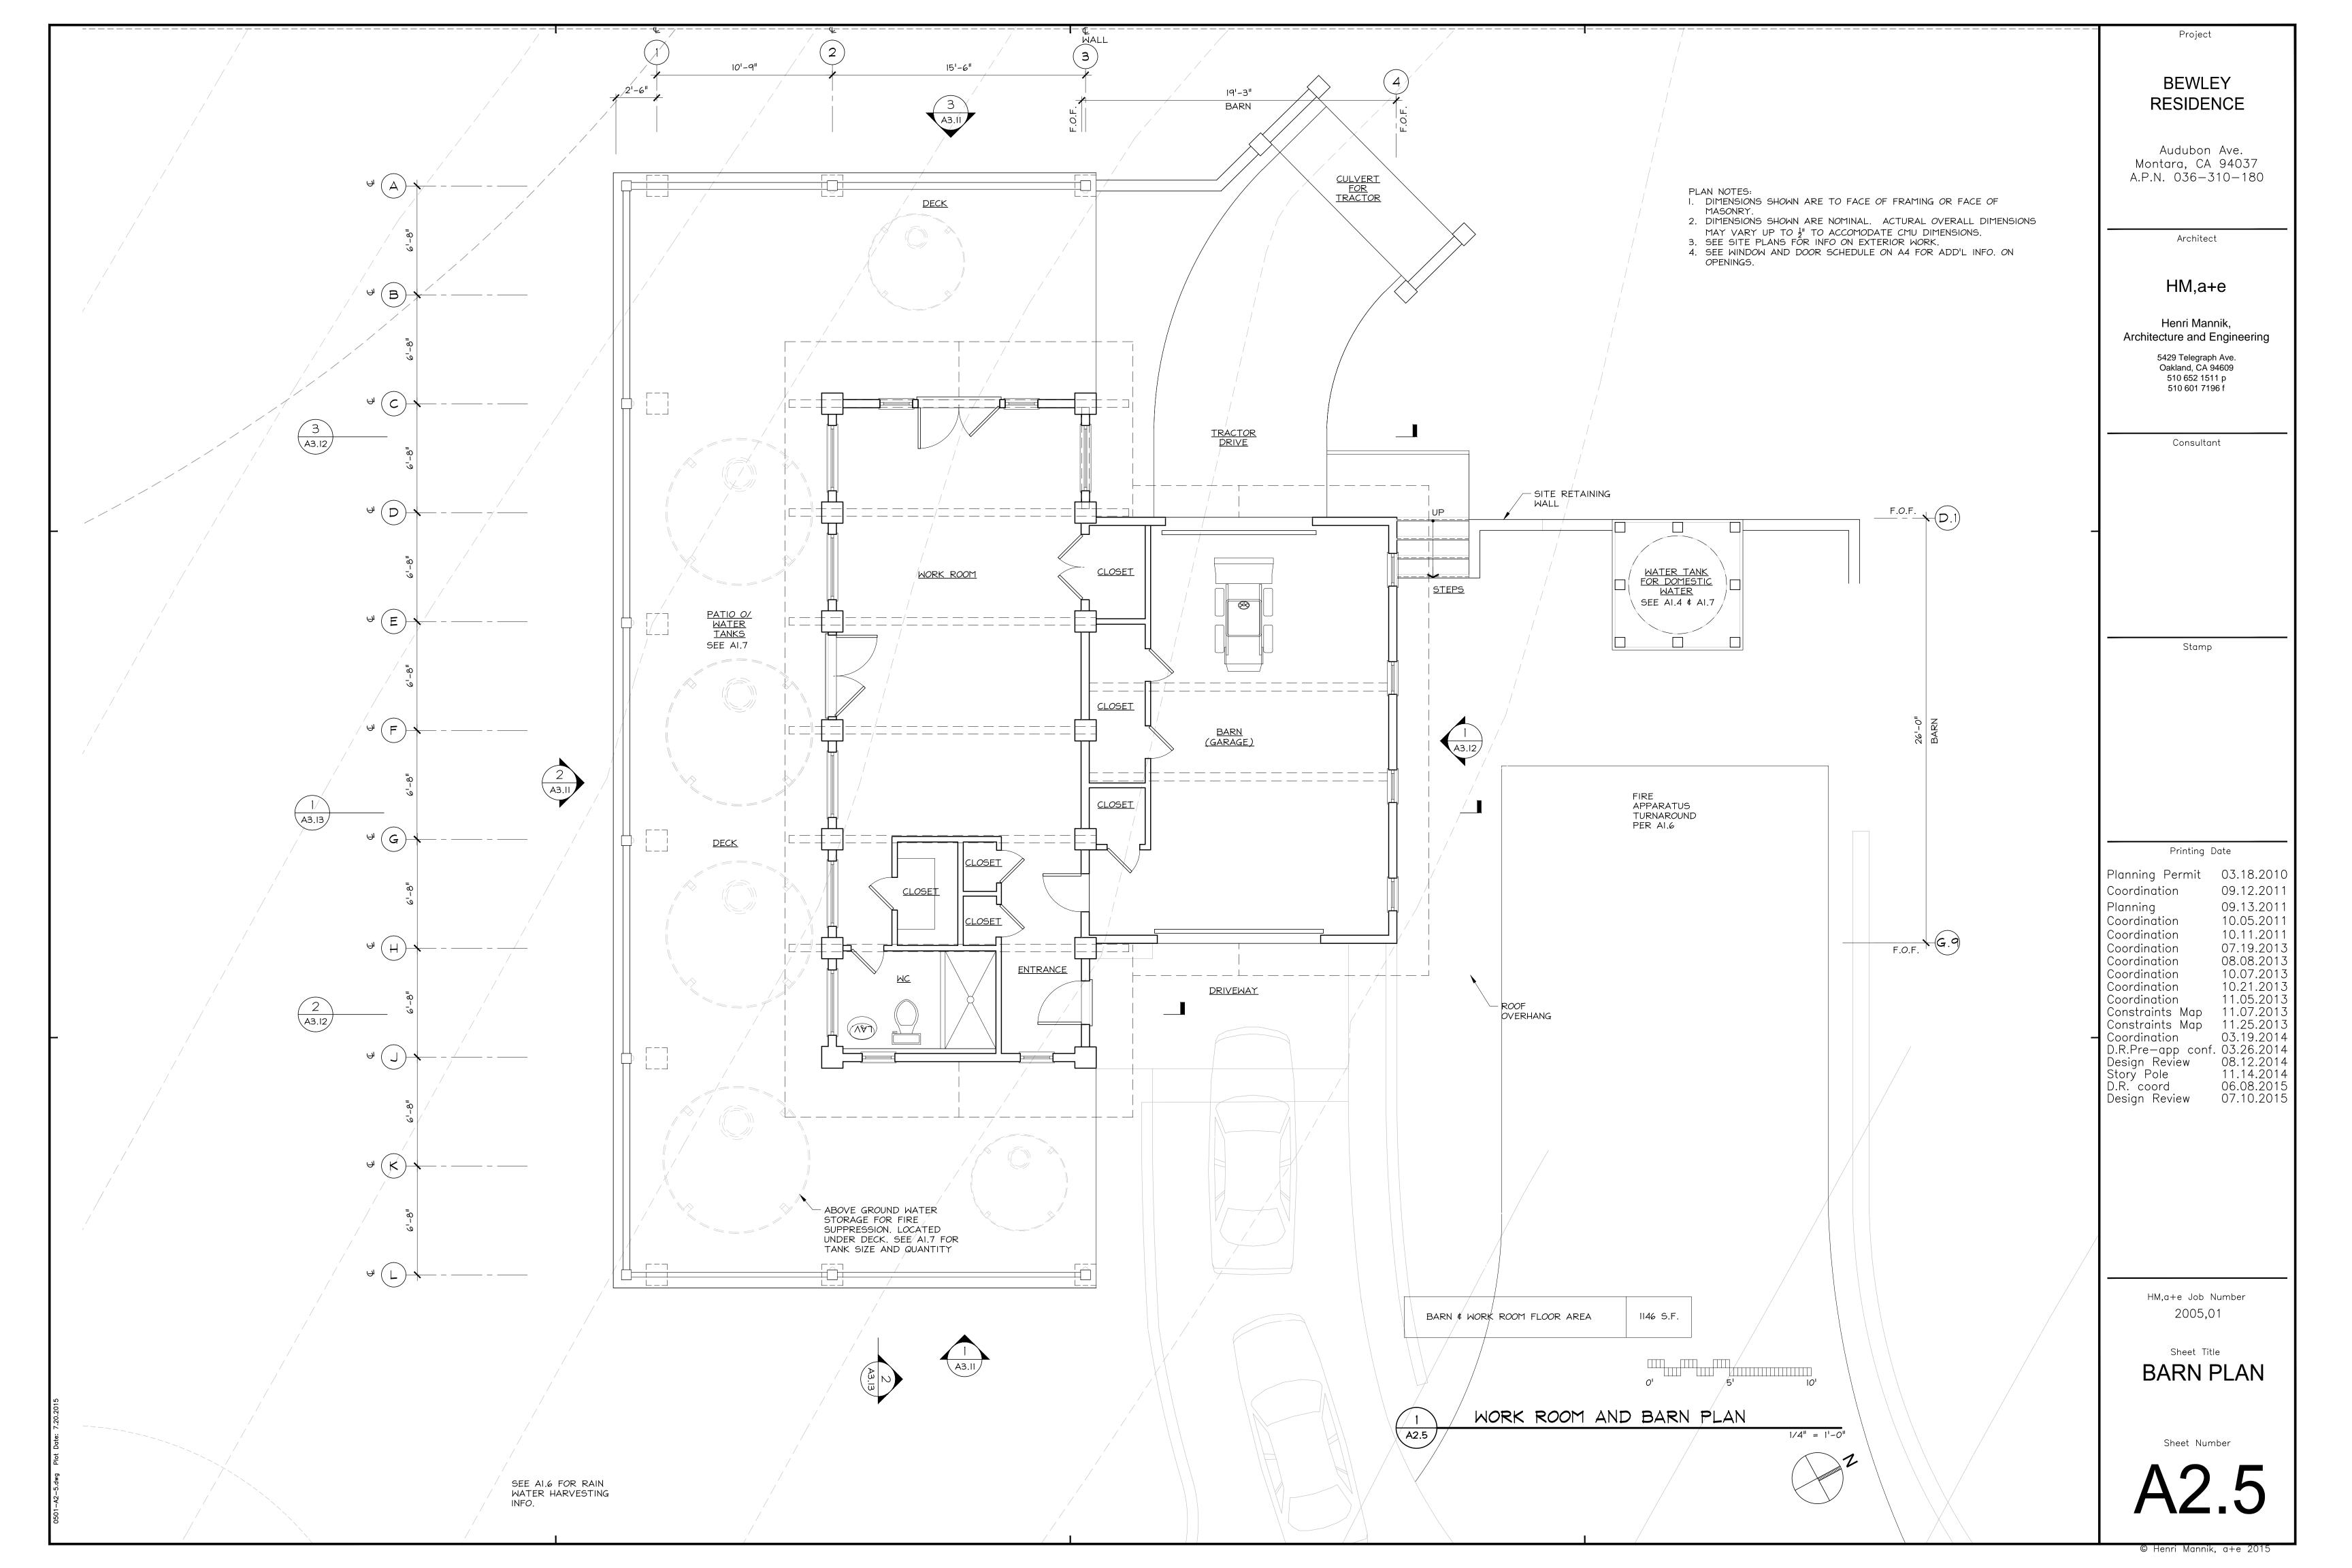

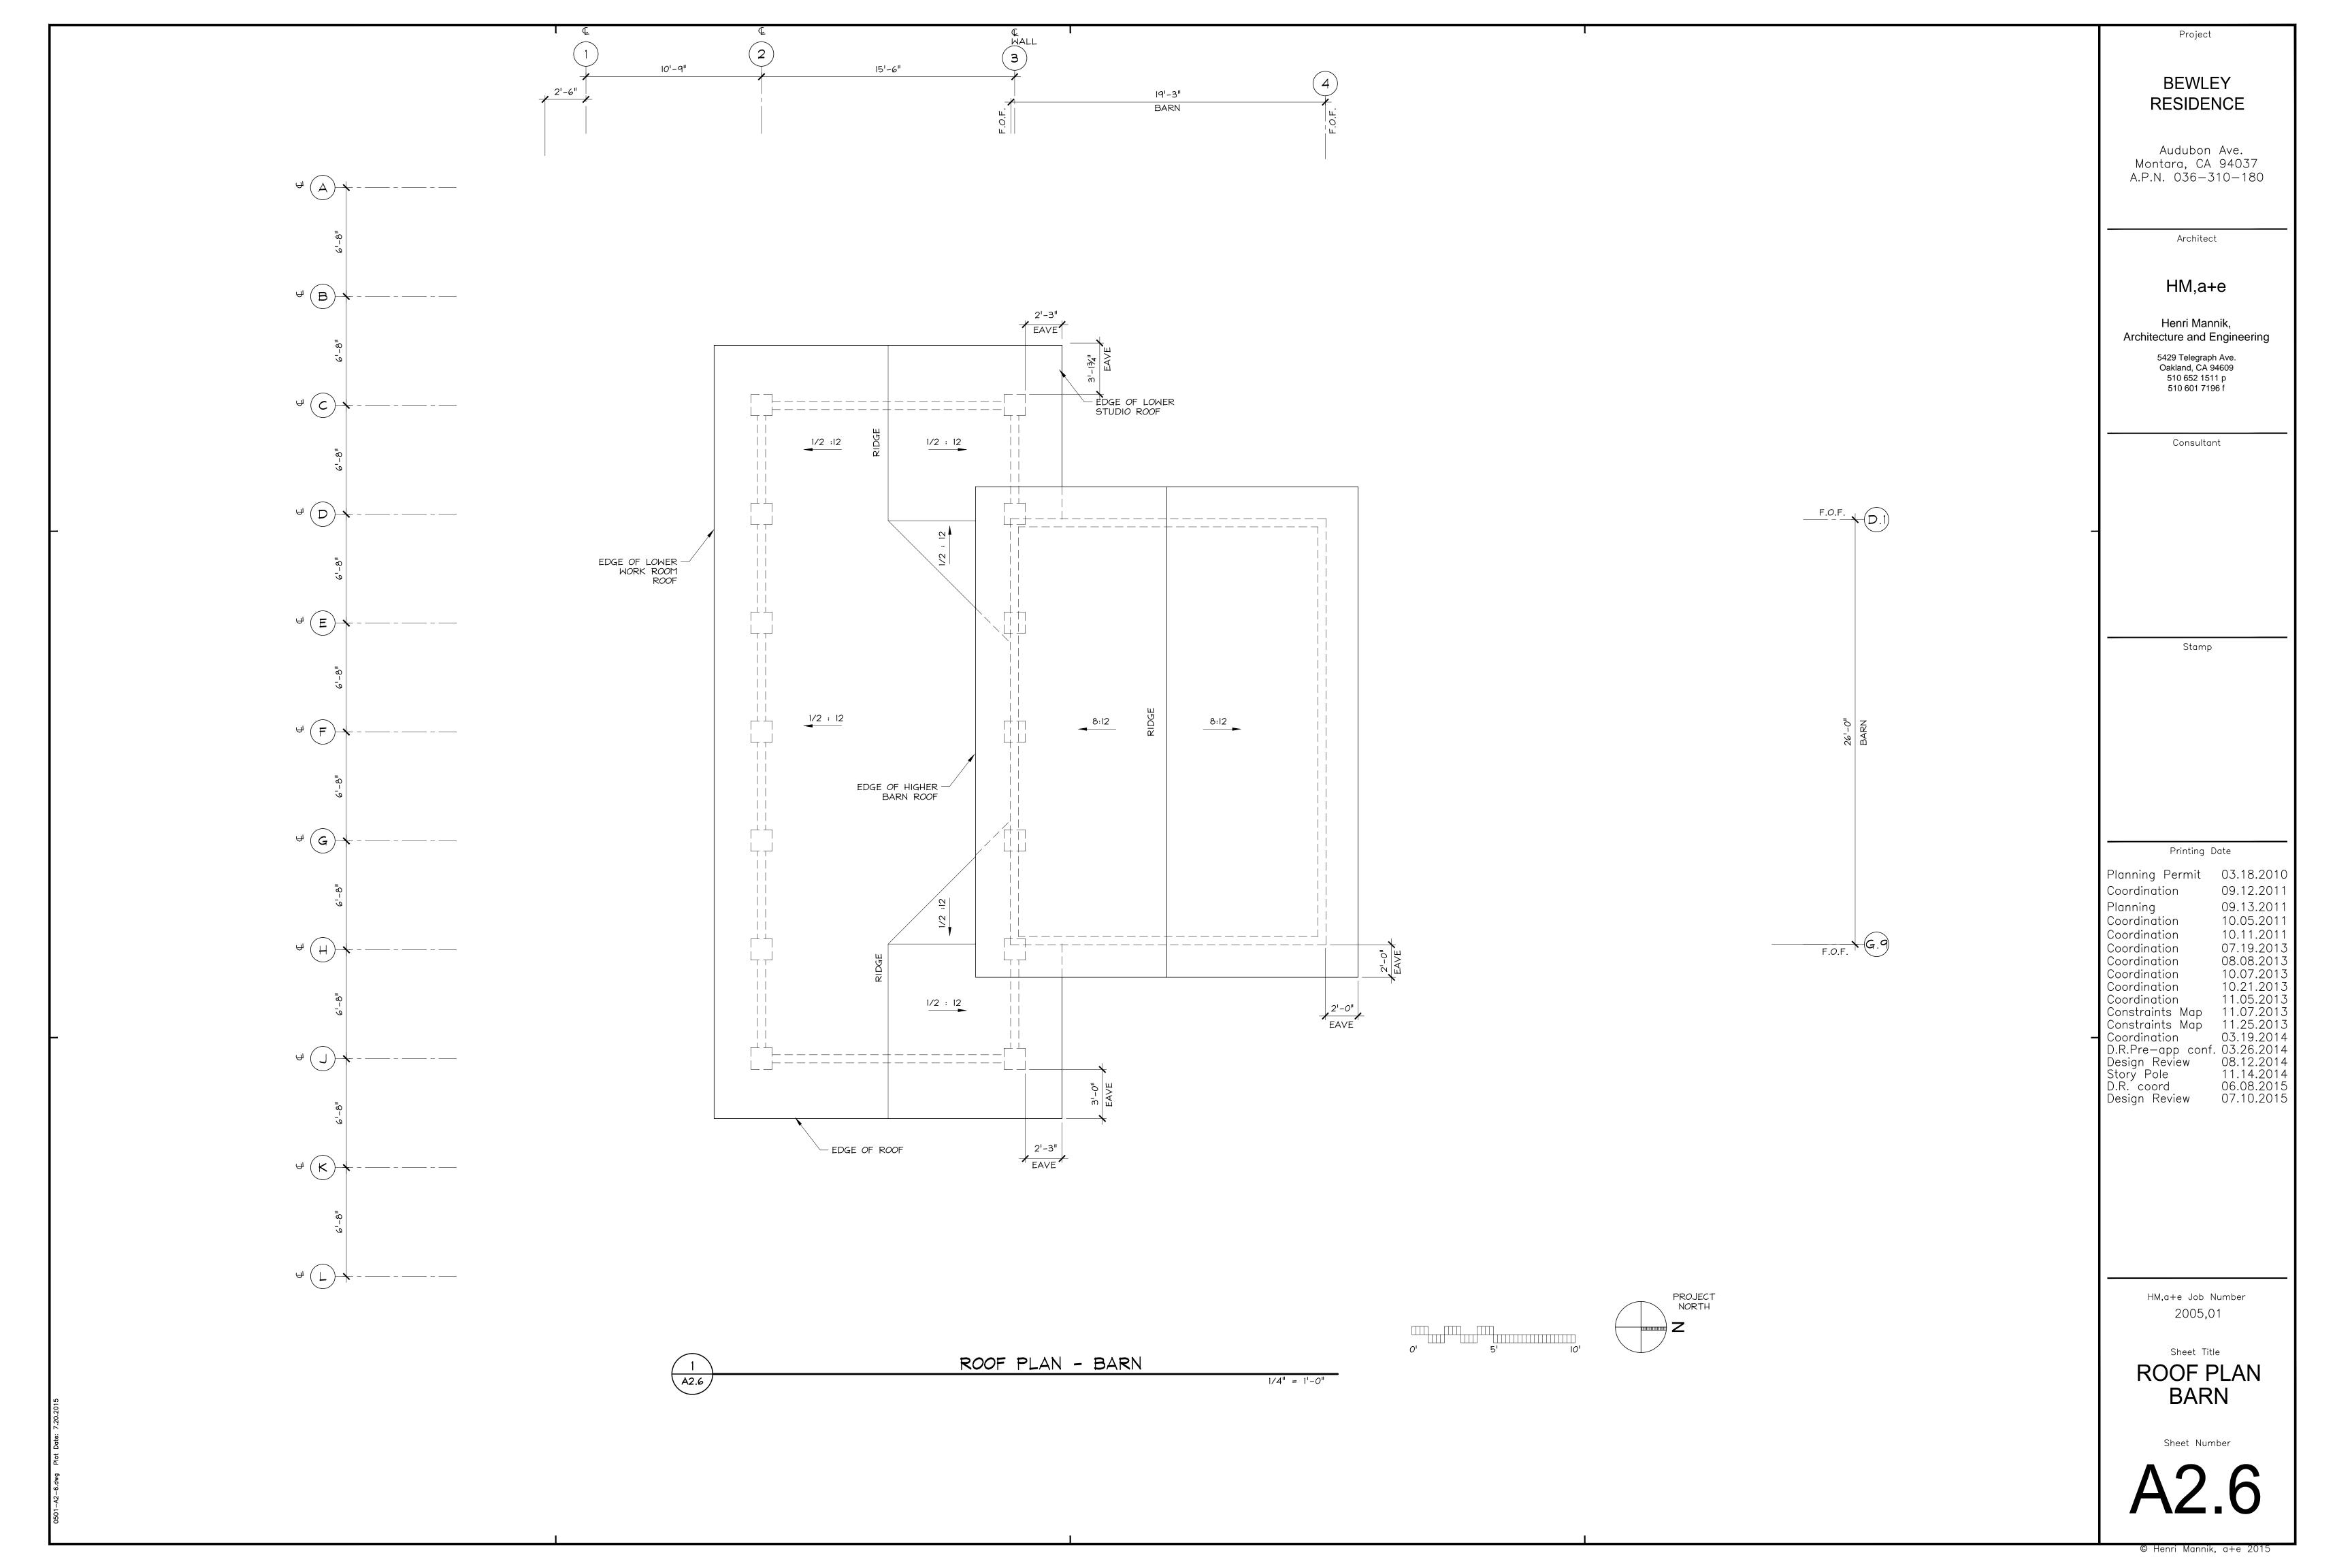

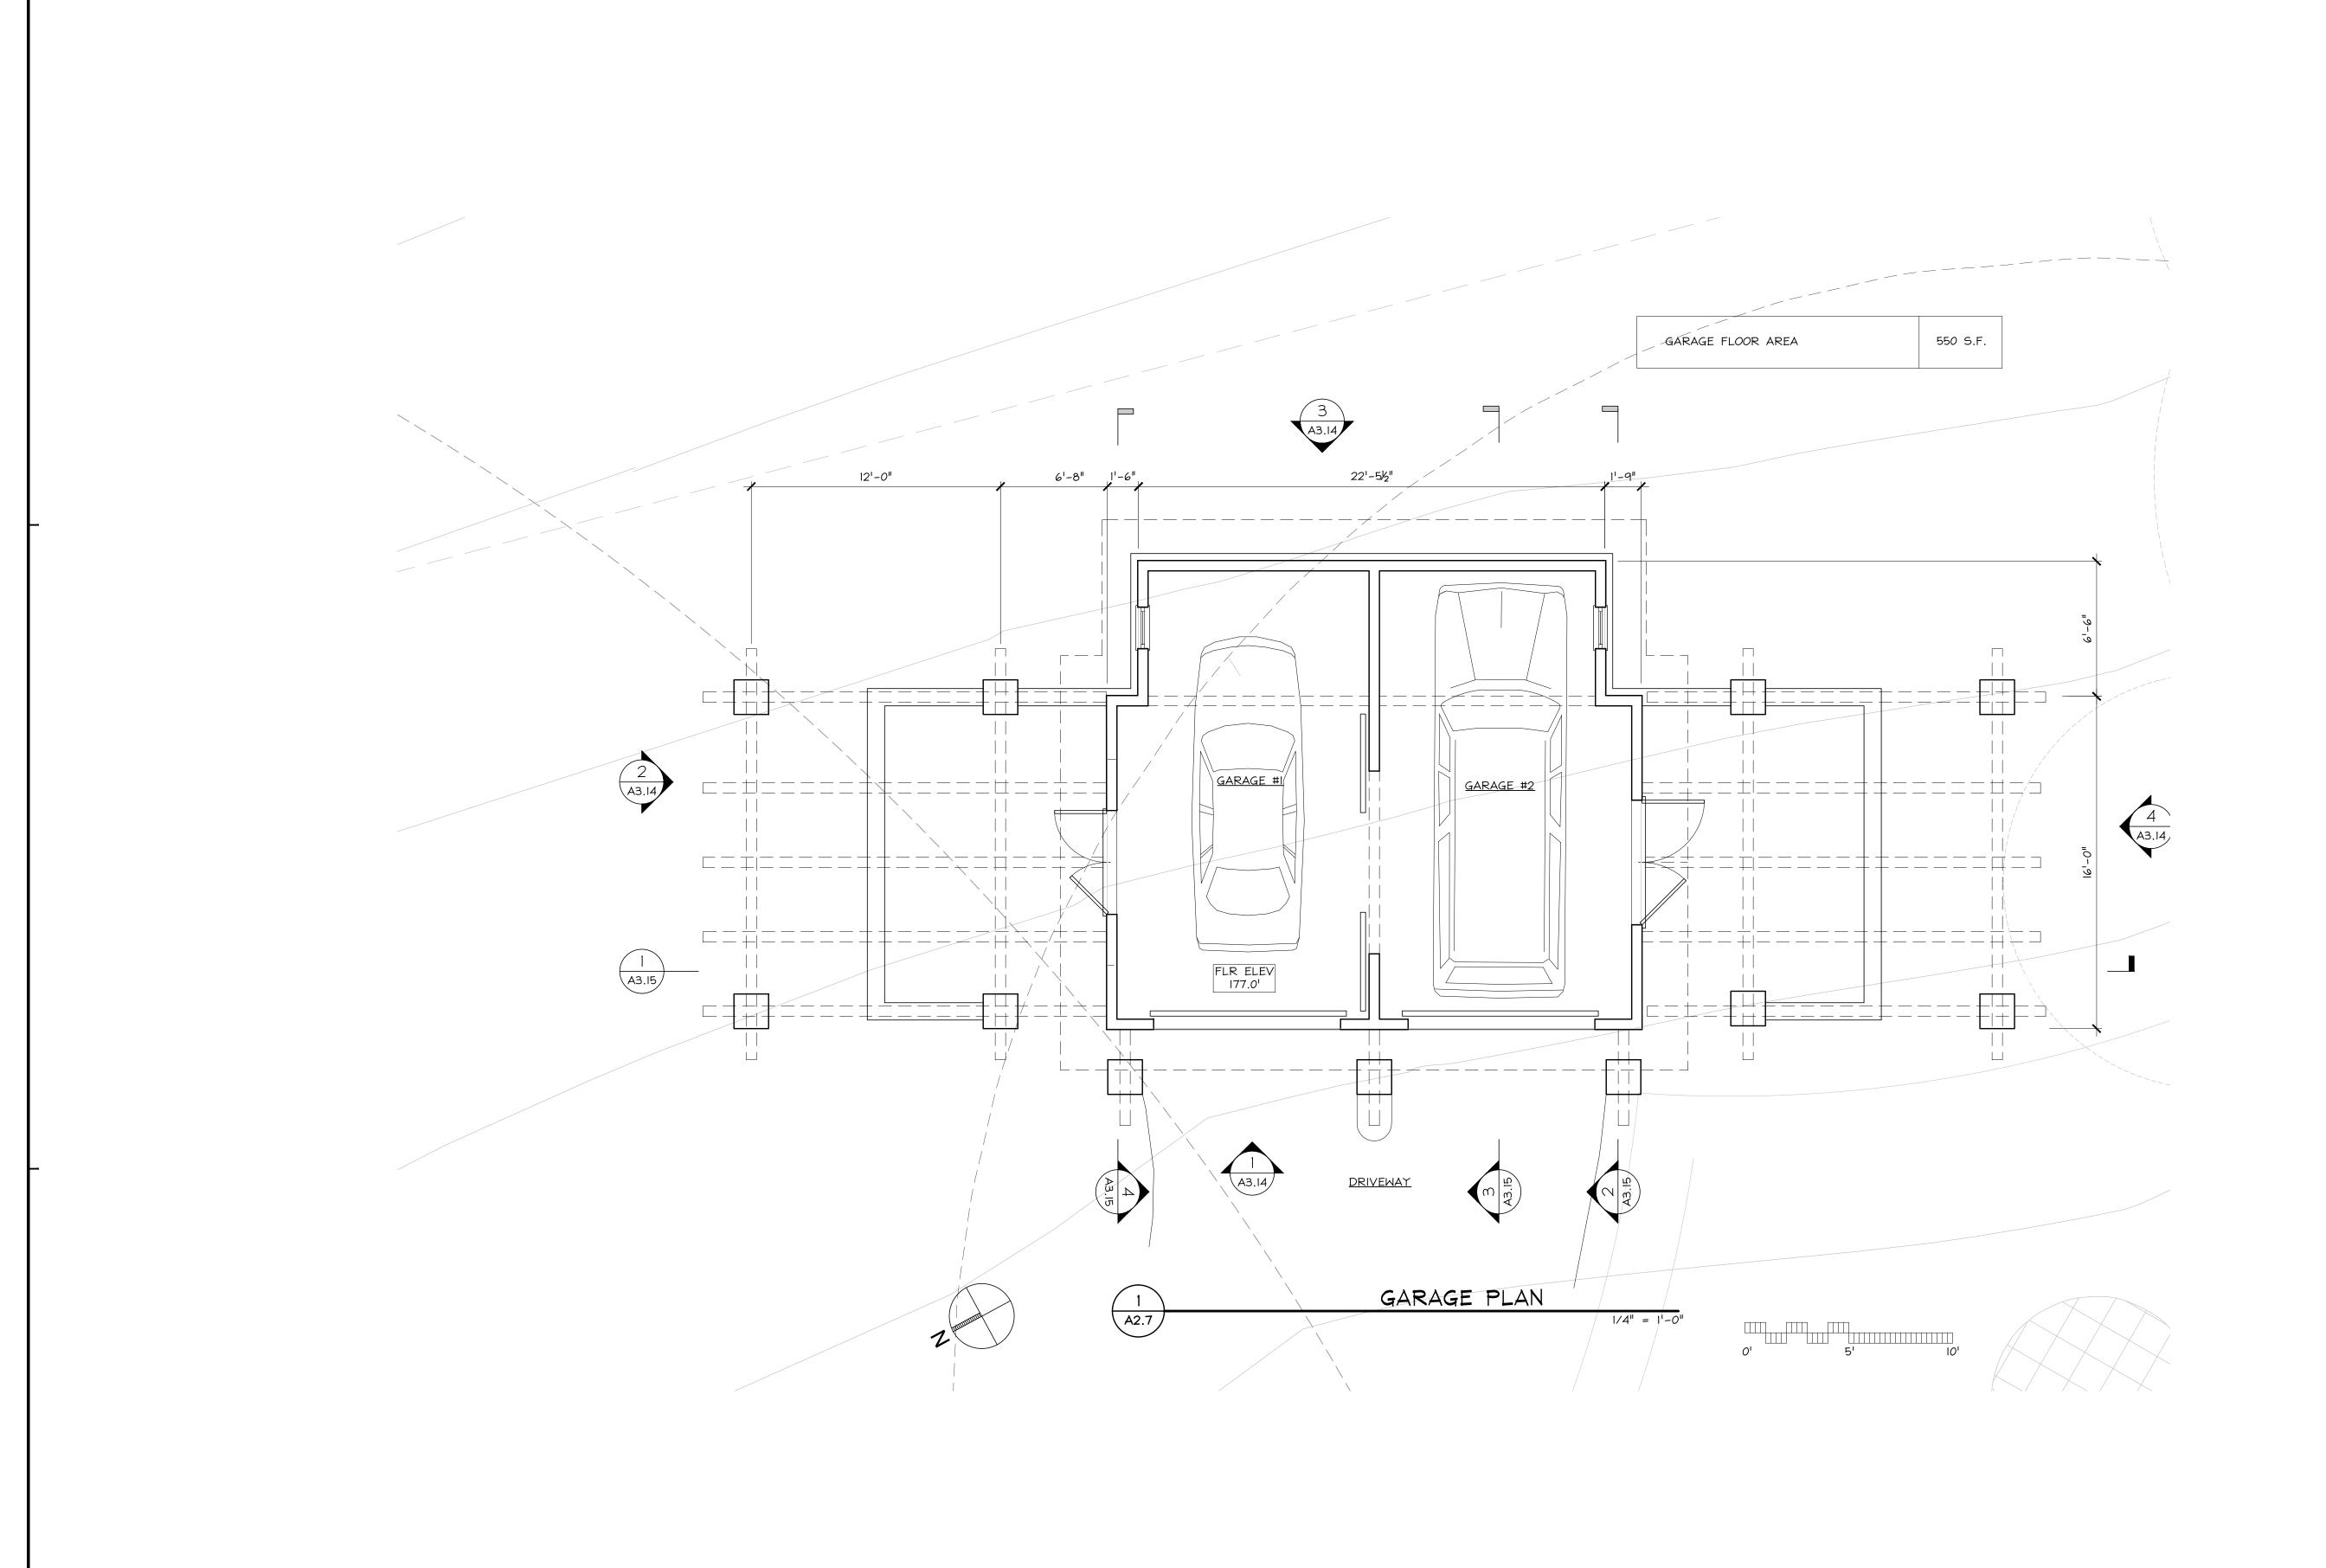

BEWLEY RESIDENCE

Audubon Ave. Montara, CA 94037 A.P.N. 036-310-180

Architect

HM,a+e

Henri Mannik, Architecture and Engineering

> 5429 Telegraph Ave. Oakland, CA 94609 510 652 1511 p 510 601 7196 f

> > Consultant

Stamp

Printing Date

 Planning Permit
 03.18.2010

 Coordination
 09.12.2011

 Planning
 09.13.2011

 Coordination
 10.05.2011

 Coordination
 07.19.2013

 Coordination
 08.08.2013

 Coordination
 10.07.2013

 Coordination
 11.05.2013

 Constraints Map
 11.07.2013

 Constraints Map
 11.25.2013

 Coordination
 03.19.2014

 D.R.Pre-app conf.
 03.26.2014

 Design Review
 08.12.2014

 D.R. coord
 06.08.2015

 Design Review
 07.10.2015


HM,a+e Job Number 2005,01

Sheet Title

GARAGE PLAN

Sheet Number

A2.7

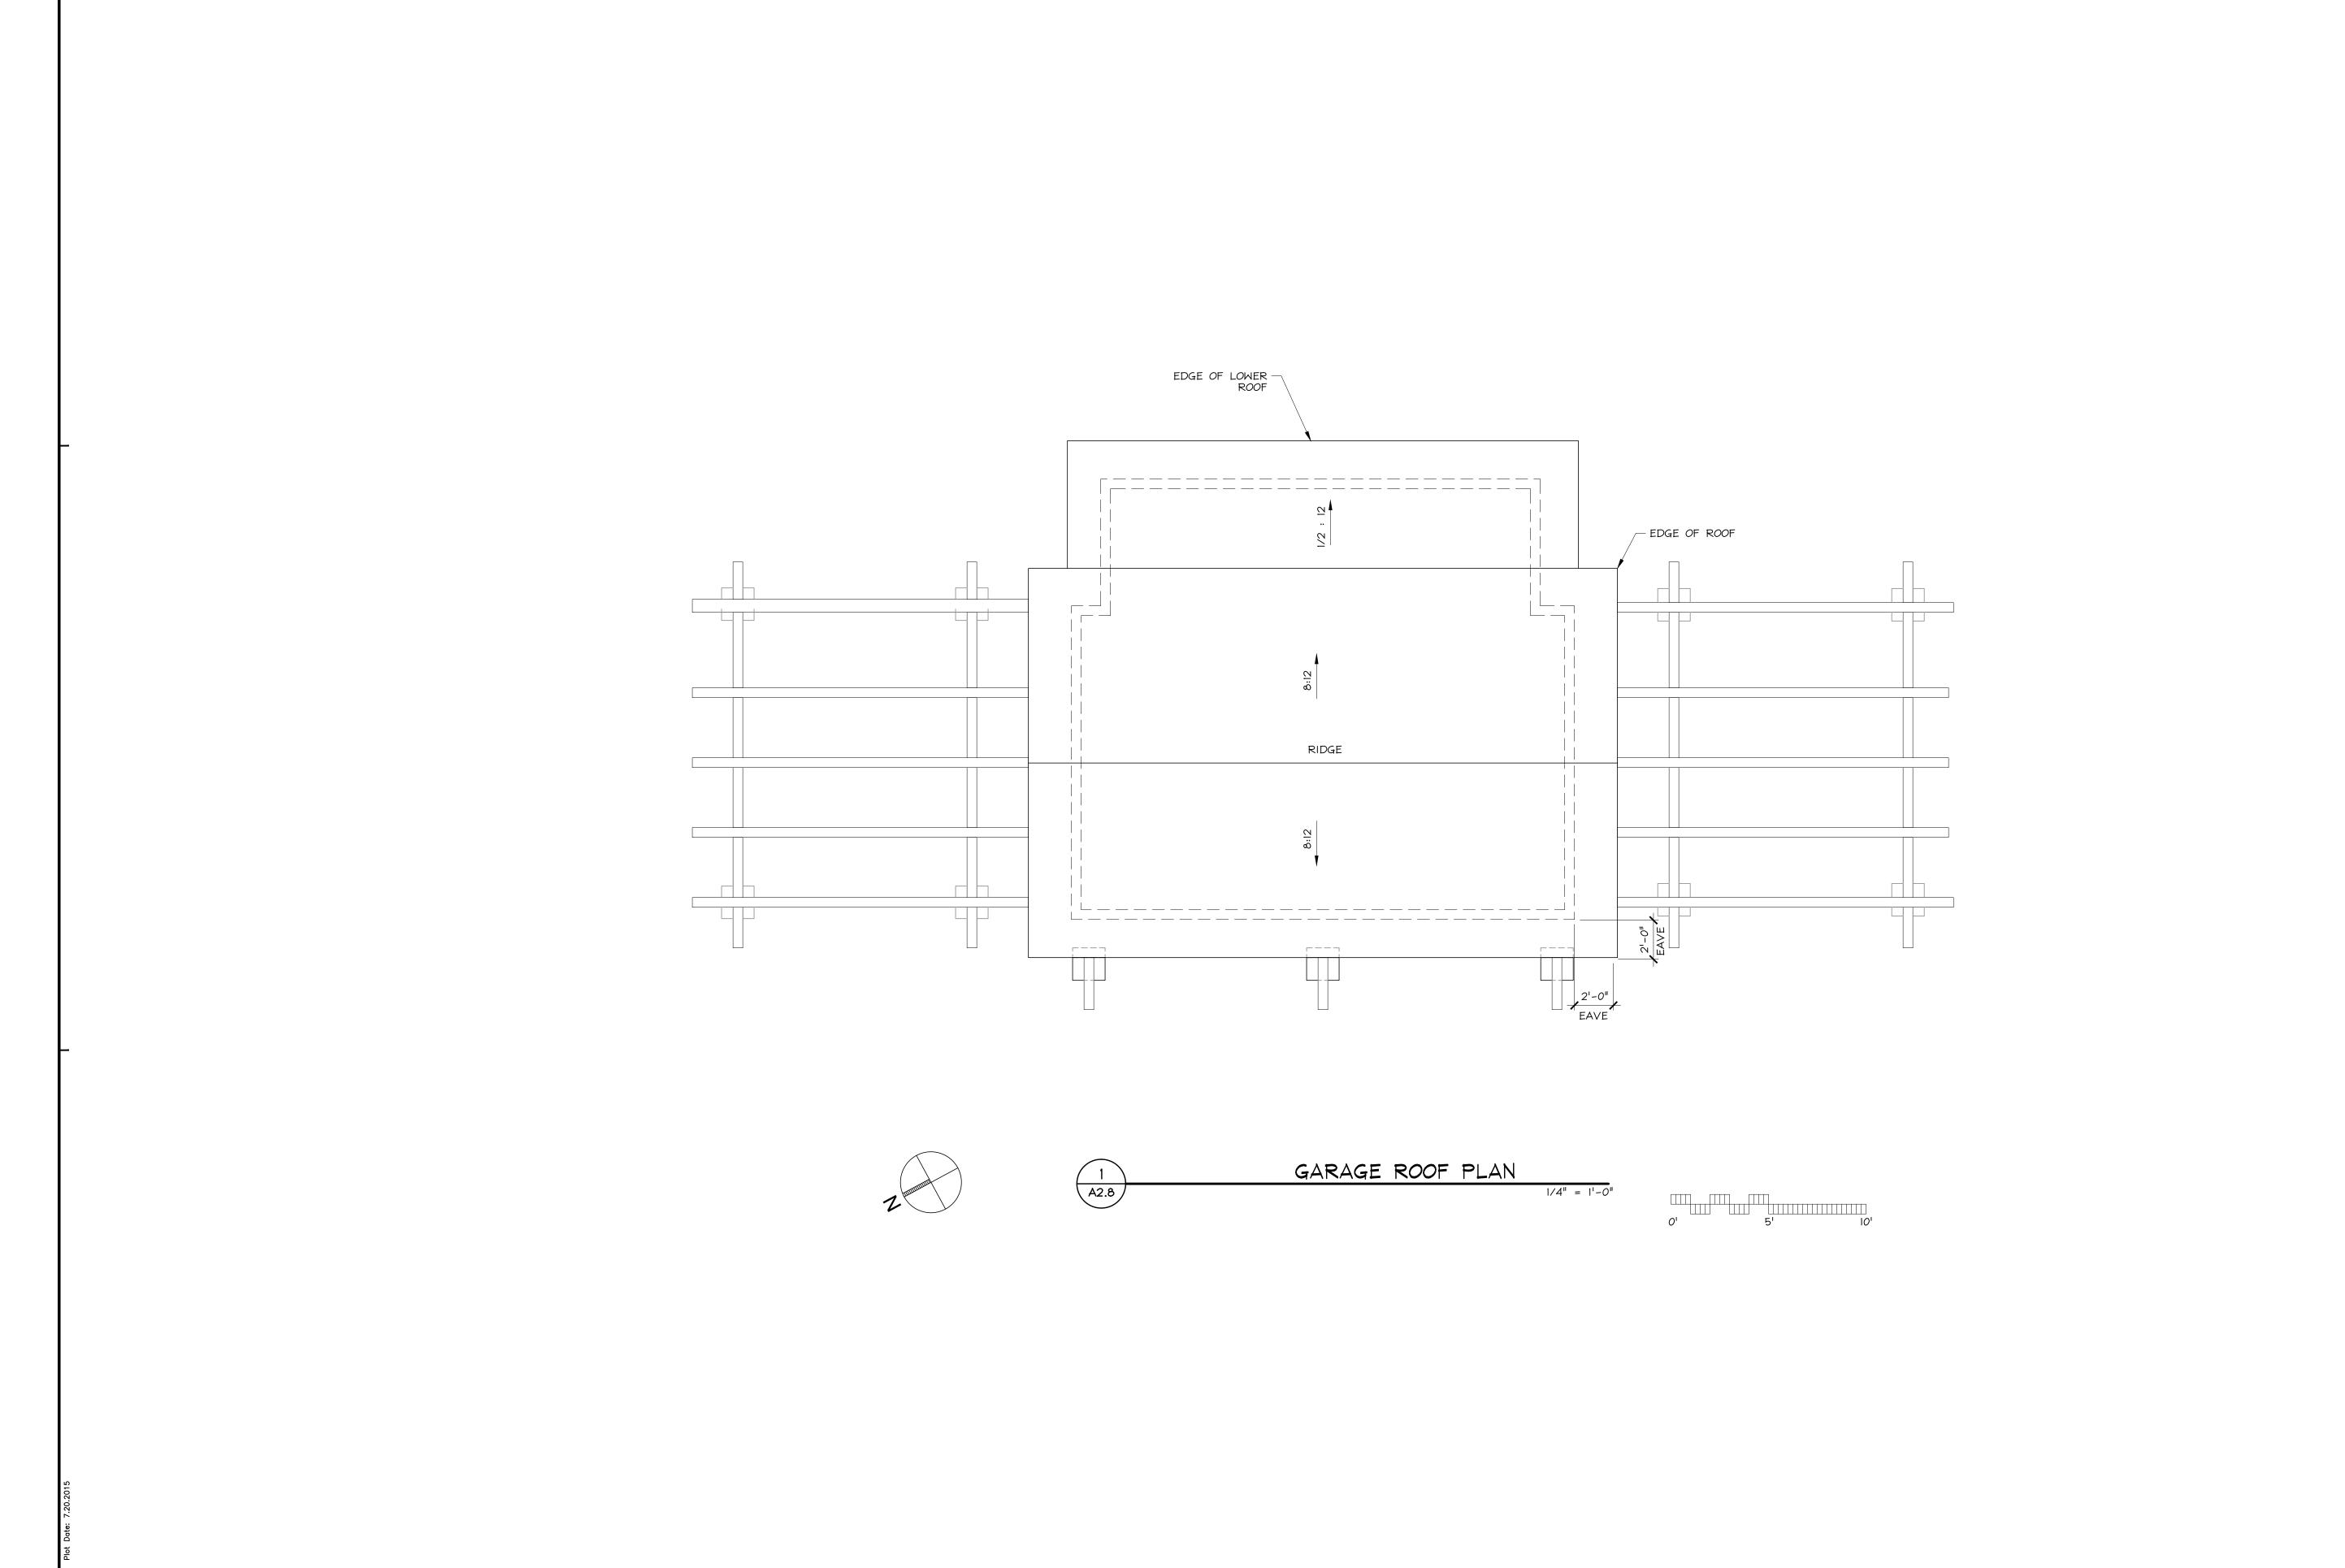

BEWLEY RESIDENCE

Audubon Ave. Montara, CA 94037 A.P.N. 036—310—180

Architect

HM,a+e

Henri Mannik, Architecture and Engineering

> 5429 Telegraph Ave. Oakland, CA 94609 510 652 1511 p 510 601 7196 f

> > Consultant

Stamp

Printing Date

 Planning Permit
 03.18.2010

 Coordination
 09.12.2011

 Planning
 09.13.2011

 Coordination
 10.05.2011

 Coordination
 07.19.2013

 Coordination
 08.08.2013

 Coordination
 10.07.2013

 Coordination
 11.05.2013

 Constraints Map
 11.07.2013

 Constraints Map
 11.25.2013

 Coordination
 03.19.2014

 D.R.Pre-app conf.
 03.26.2014

 Design Review
 08.12.2014

 Story Pole
 11.14.2014

 D.R. coord
 06.08.2015

 Design Review
 07.10.2015


HM,a+e Job Number 2005,01


Sheet Title

GARAGE ROOF PLAN

Sheet Number

A2.8

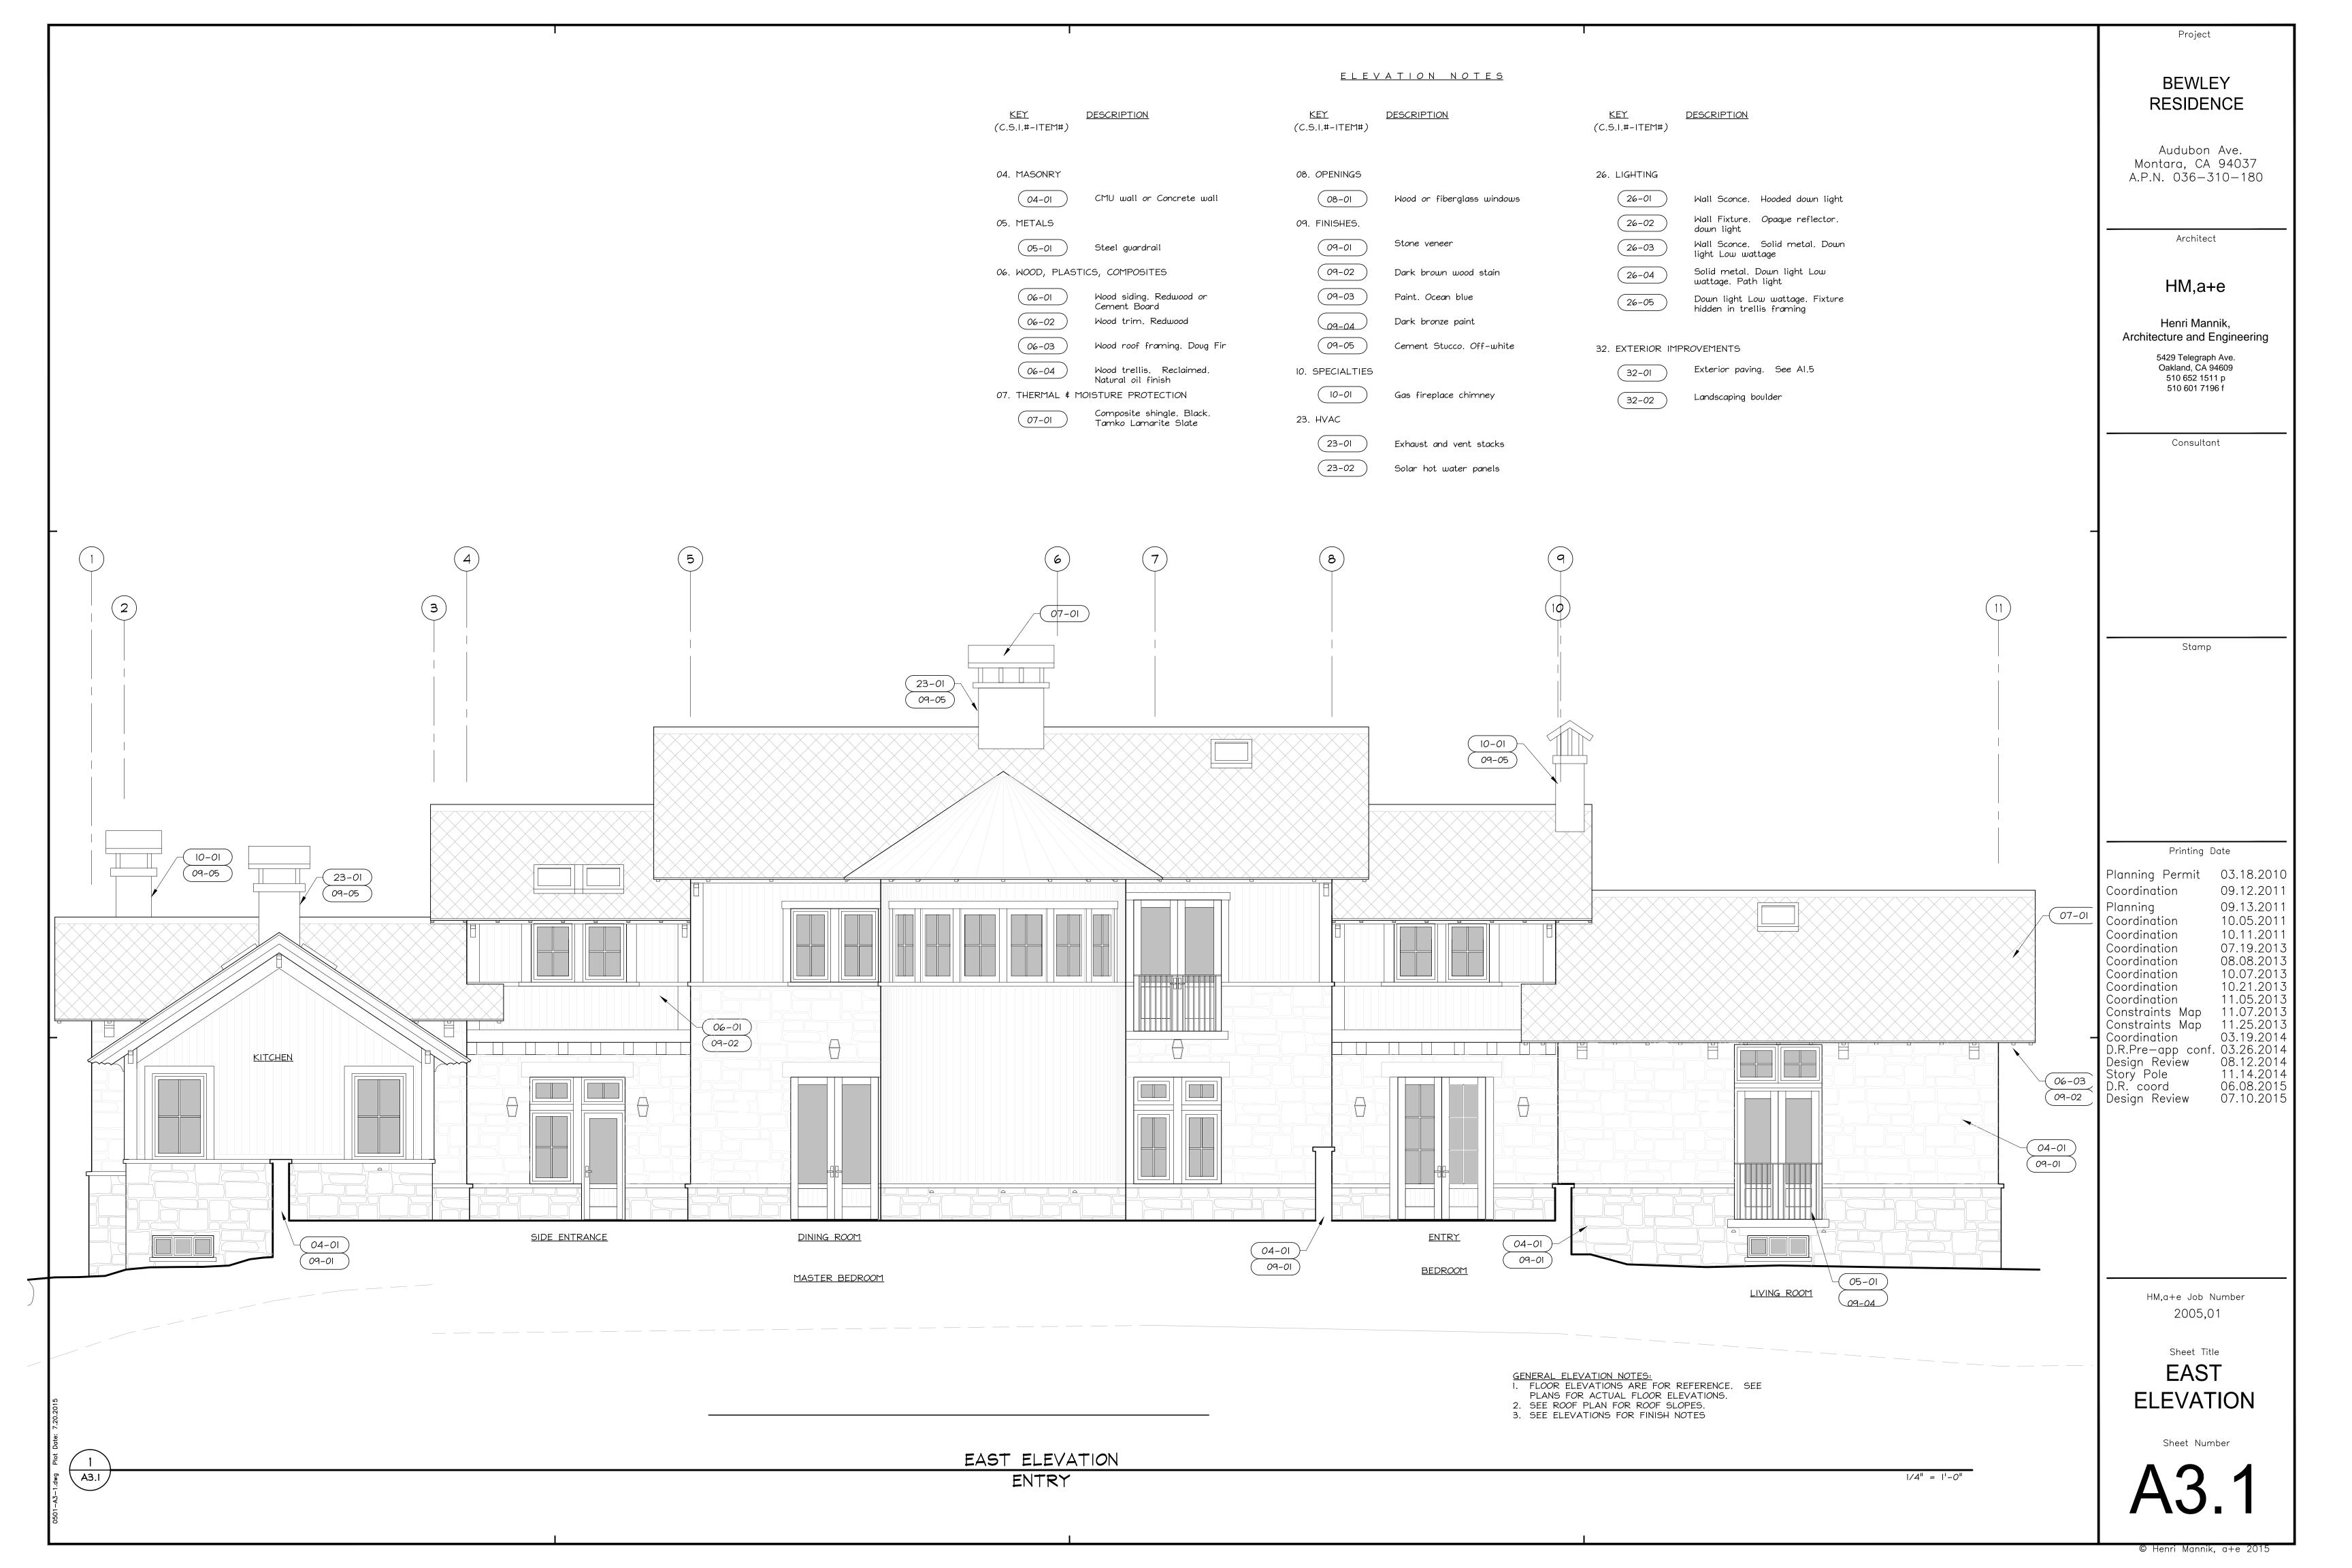

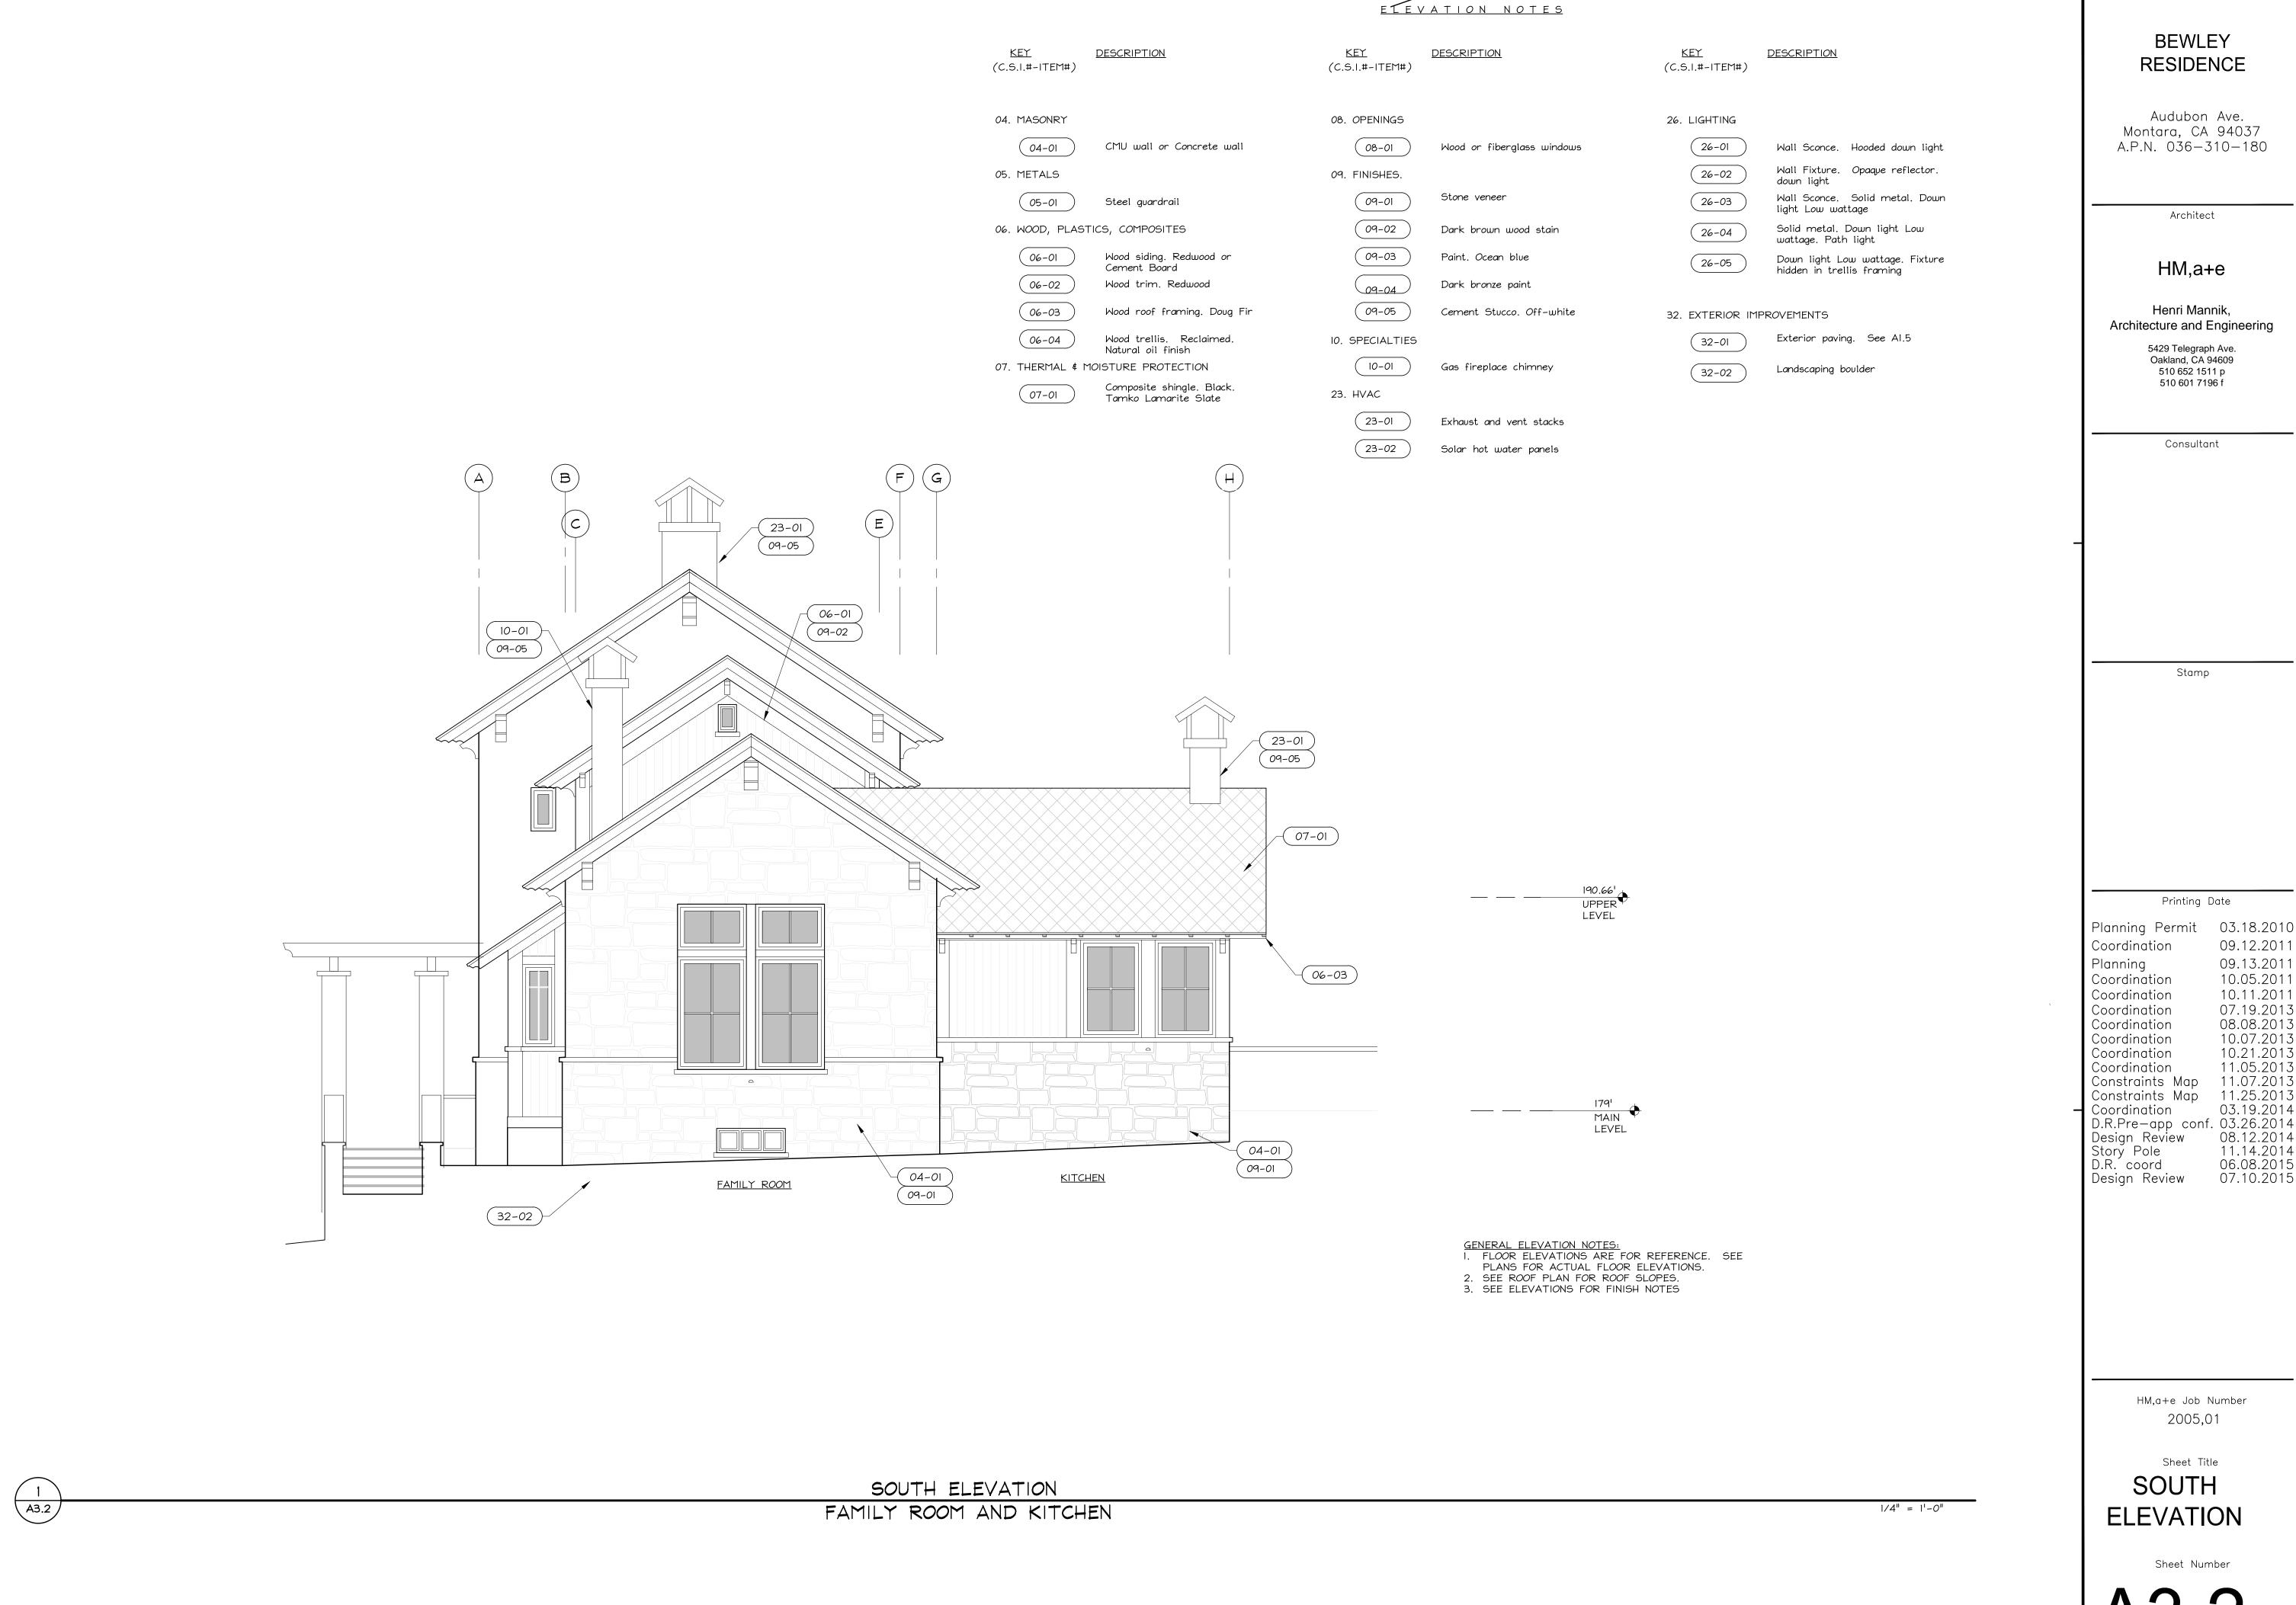

BEWLEY

Audubon Ave. Montara, CA 94037 A.P.N. 036-310-180

Henri Mannik, Architecture and Engineering


> Oakland, CA 94609 510 652 1511 p 510 601 7196 f

09.12.2011 09.13.2011 10.05.2011 10.11.2011 07.19.2013 08.08.2013 10.07.2013 10.21.2013 11.05.2013 11.07.2013 11.25.2013 Coordination 03.19.2014 D.R.Pre—app conf. 03.26.2014 08.12.2014 11.14.2014 06.08.2015 07.10.2015


HM,a+e Job Number

SOUTH **ELEVATION**

Sheet Number

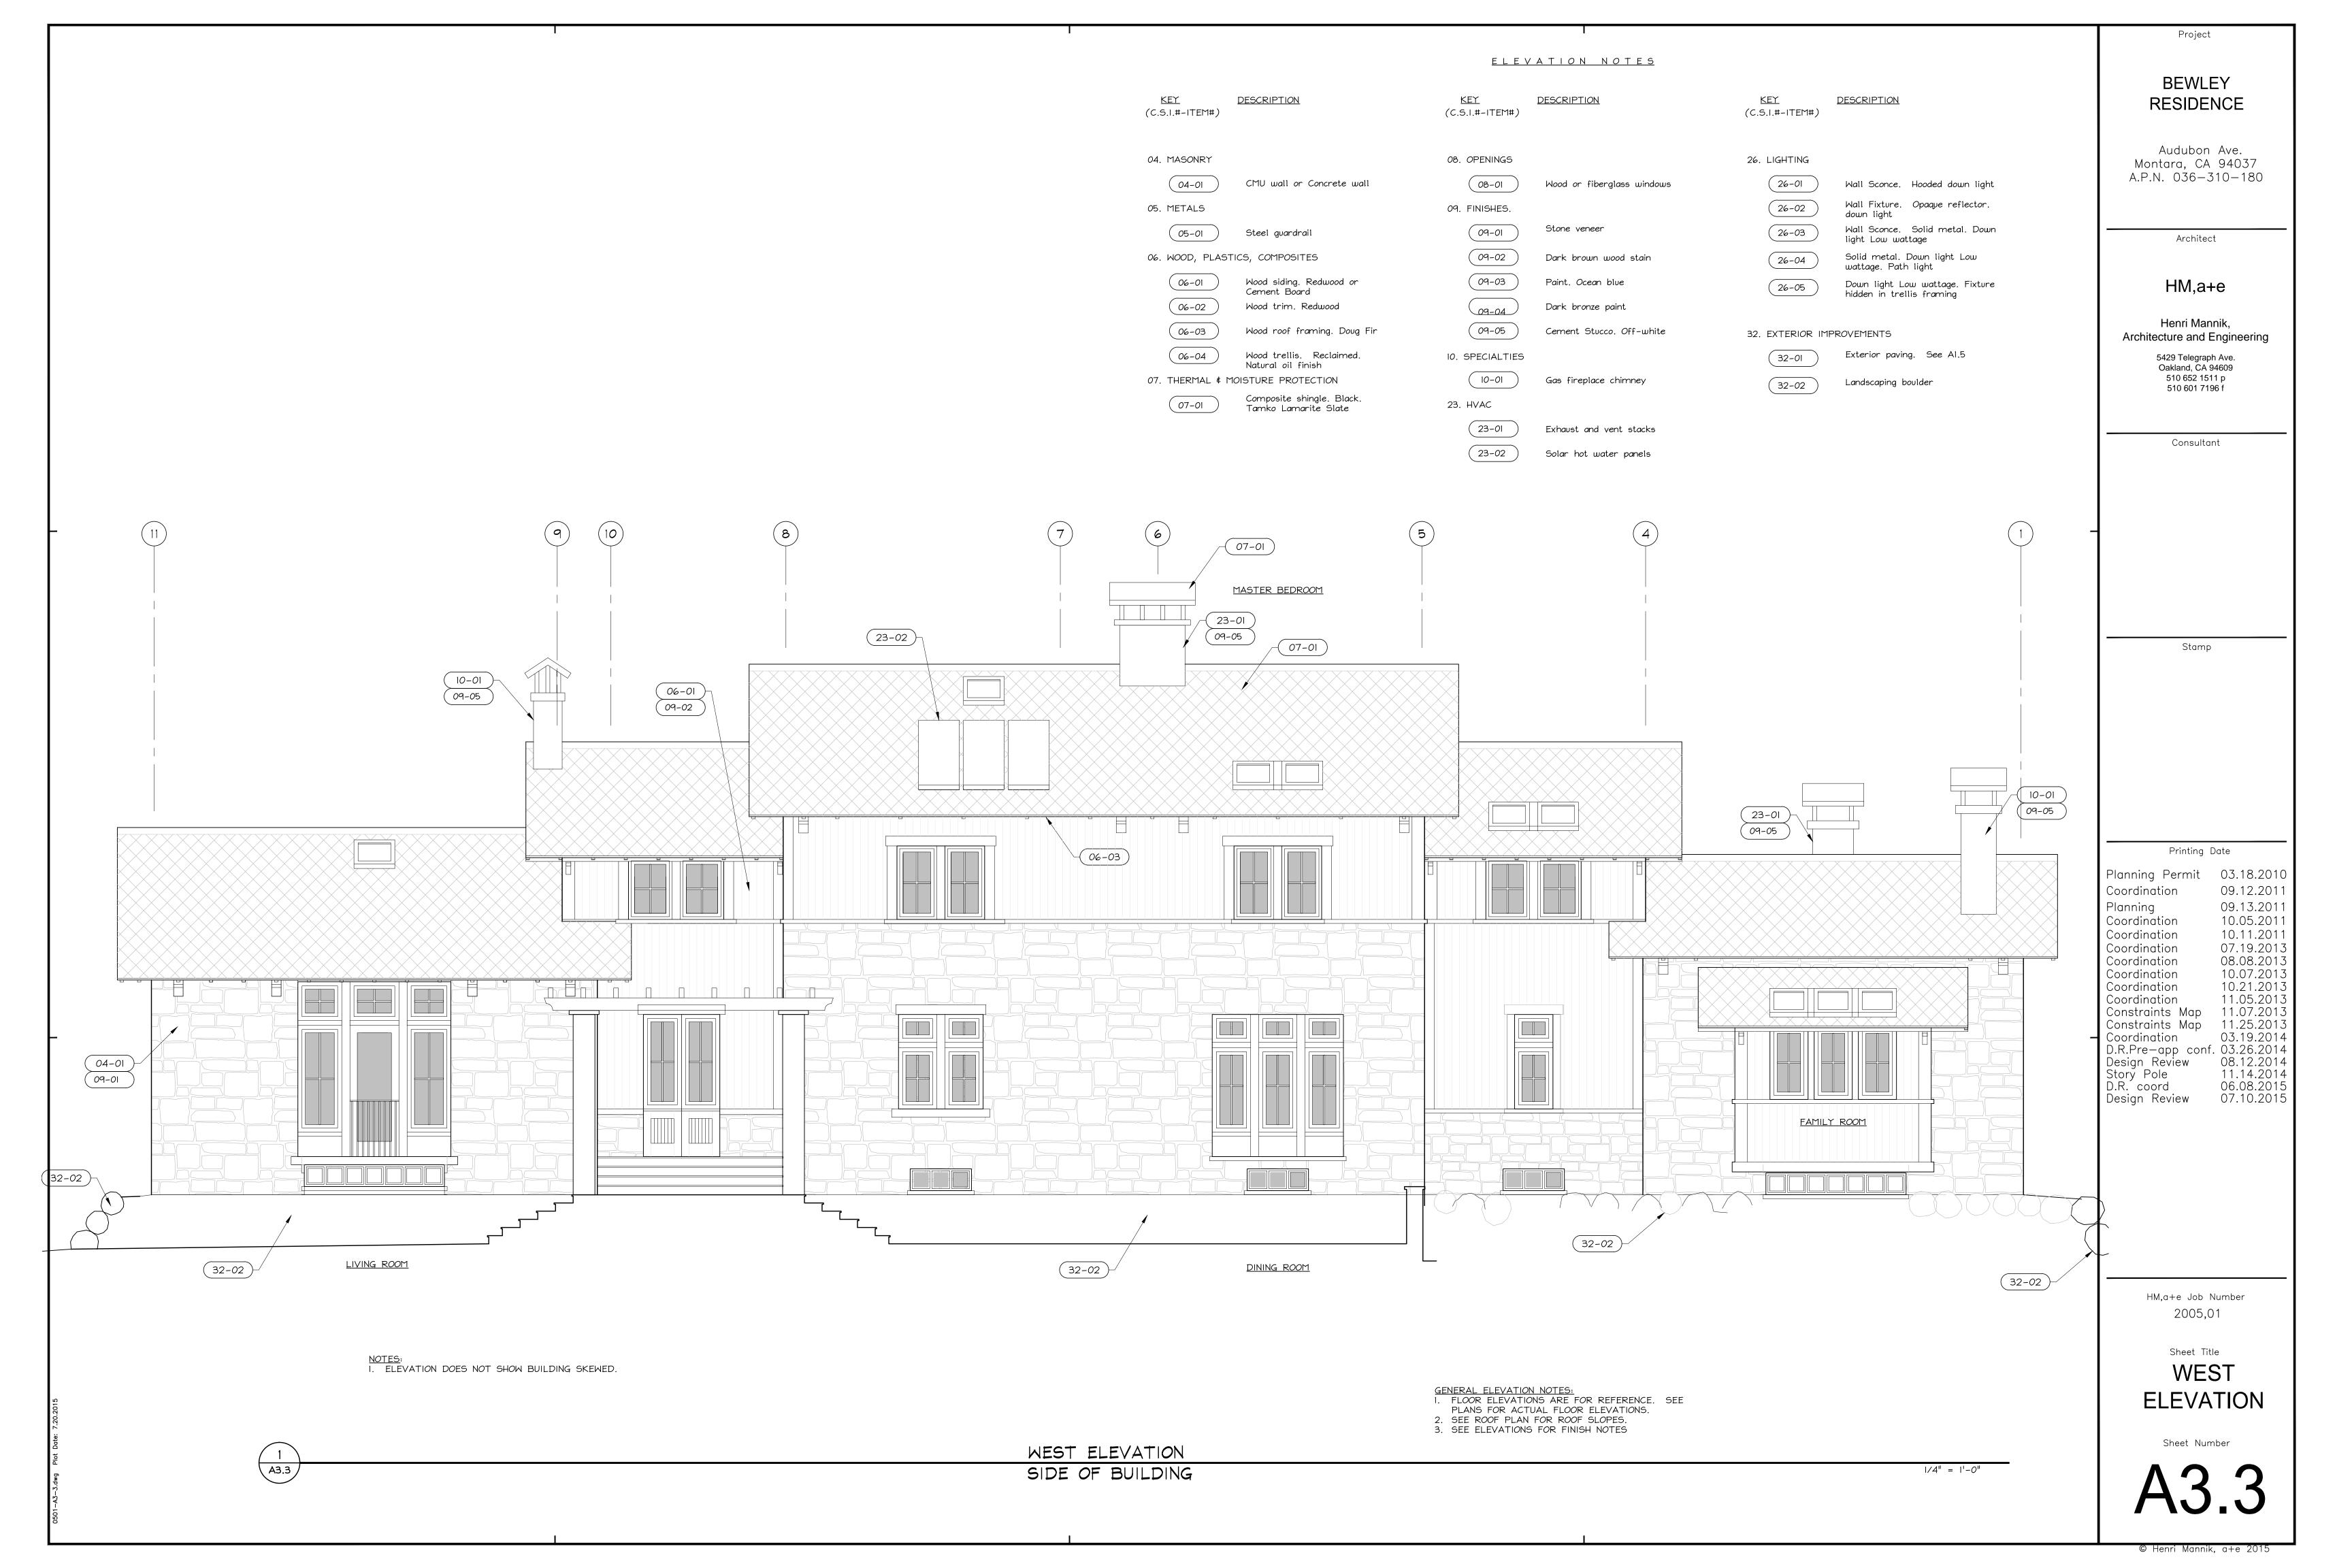

<u>ELEVATION NOTES</u>

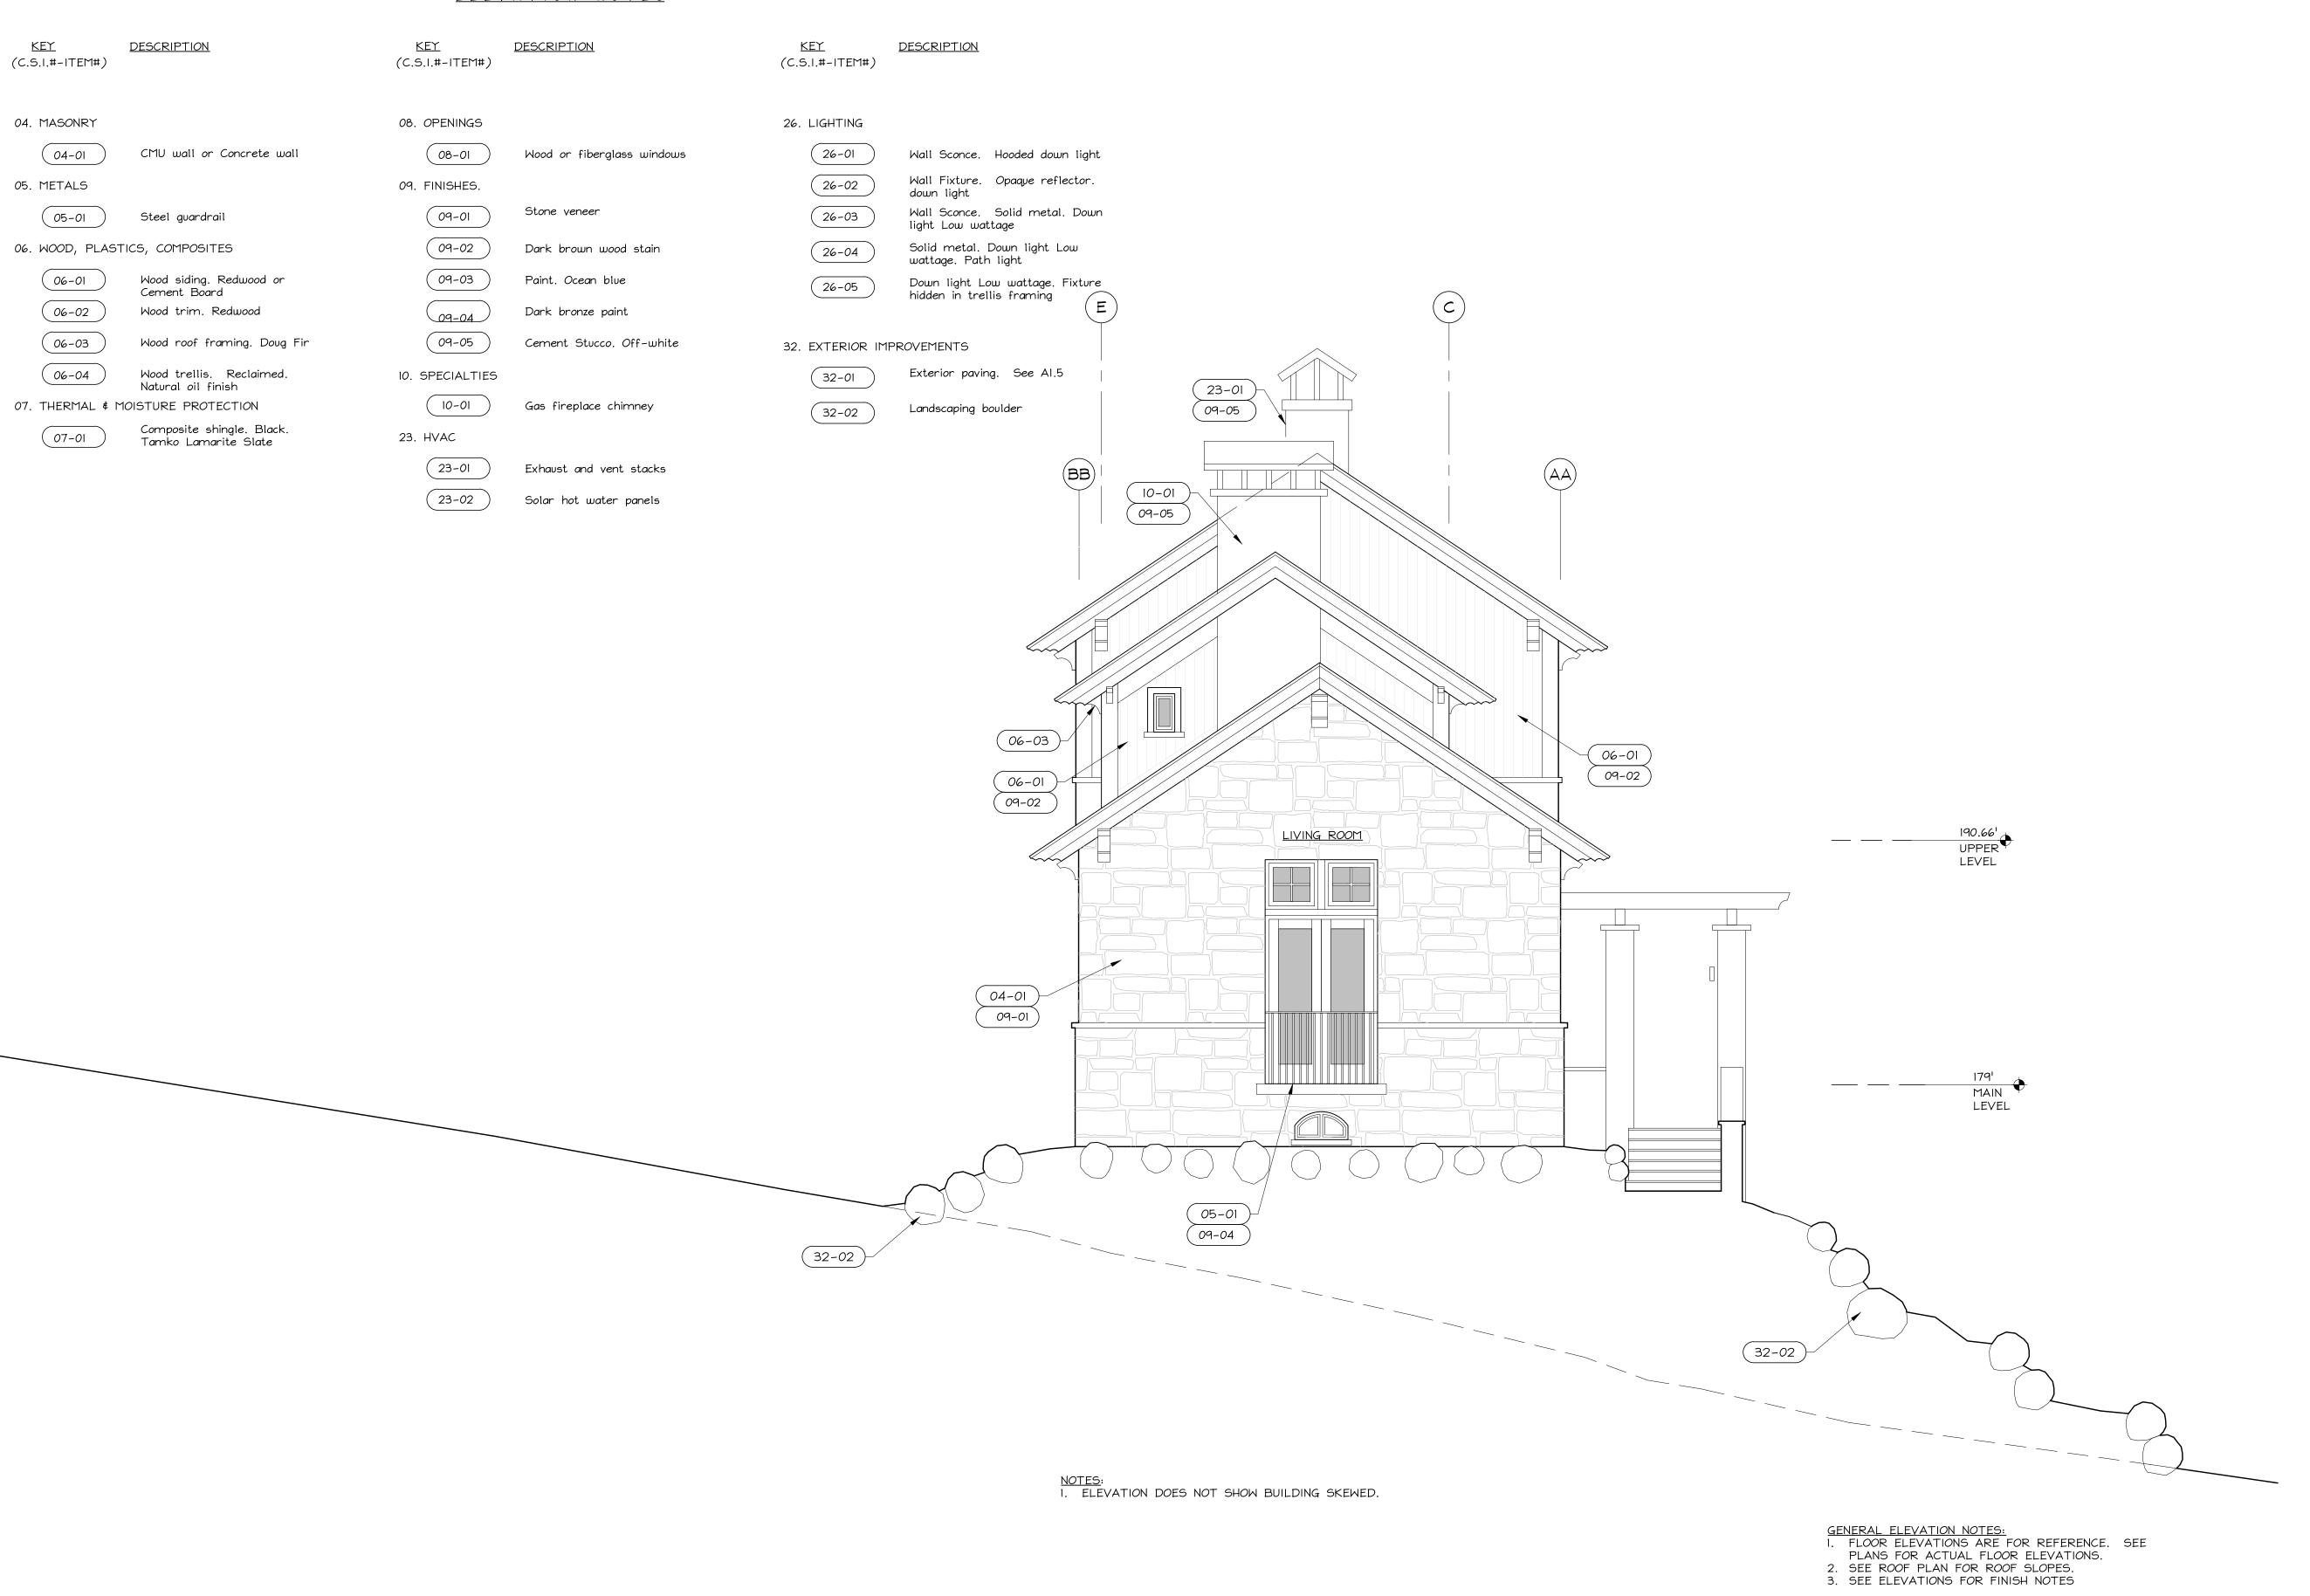

NORTH ELEVATION

LIVING ROOM

BEWLEY RESIDENCE

Project

Audubon Ave. Montara, CA 94037 A.P.N. 036—310—180

Architect

HM,a+e

Henri Mannik, Architecture and Engineering

> 5429 Telegraph Ave. Oakland, CA 94609 510 652 1511 p 510 601 7196 f

> > Consultant

Stamp

Printing Date

Planning Permit 03.18.2010 09.12.2011 Coordination 09.13.2011 Planning 10.05.2011 Coordination 10.11.2011 Coordination 07.19.2013 Coordination Coordination 08.08.2013 Coordination Coordination 10.07.2013 10.21.2013 Coordination 11.05.2013 Constraints Map 11.07.2013
Constraints Map 11.25.2013
Coordination 03.19.2014
D.R.Pre—app conf. 03.26.2014
Design Review 08.12.2014
Story Pole 11.14.2014
D.R. coord 06.08.2015
Design Review 07.10.2015

HM,a+e Job Number 2005,01

Sheet Title NORTH

1/4" = $1^1 - 0$ "

ELEVATION


Sheet Number

A3.4


© Henri Mannik, a+e 2015


0501-A3-4.dwg Plot Date: 7.20.201

A3.4

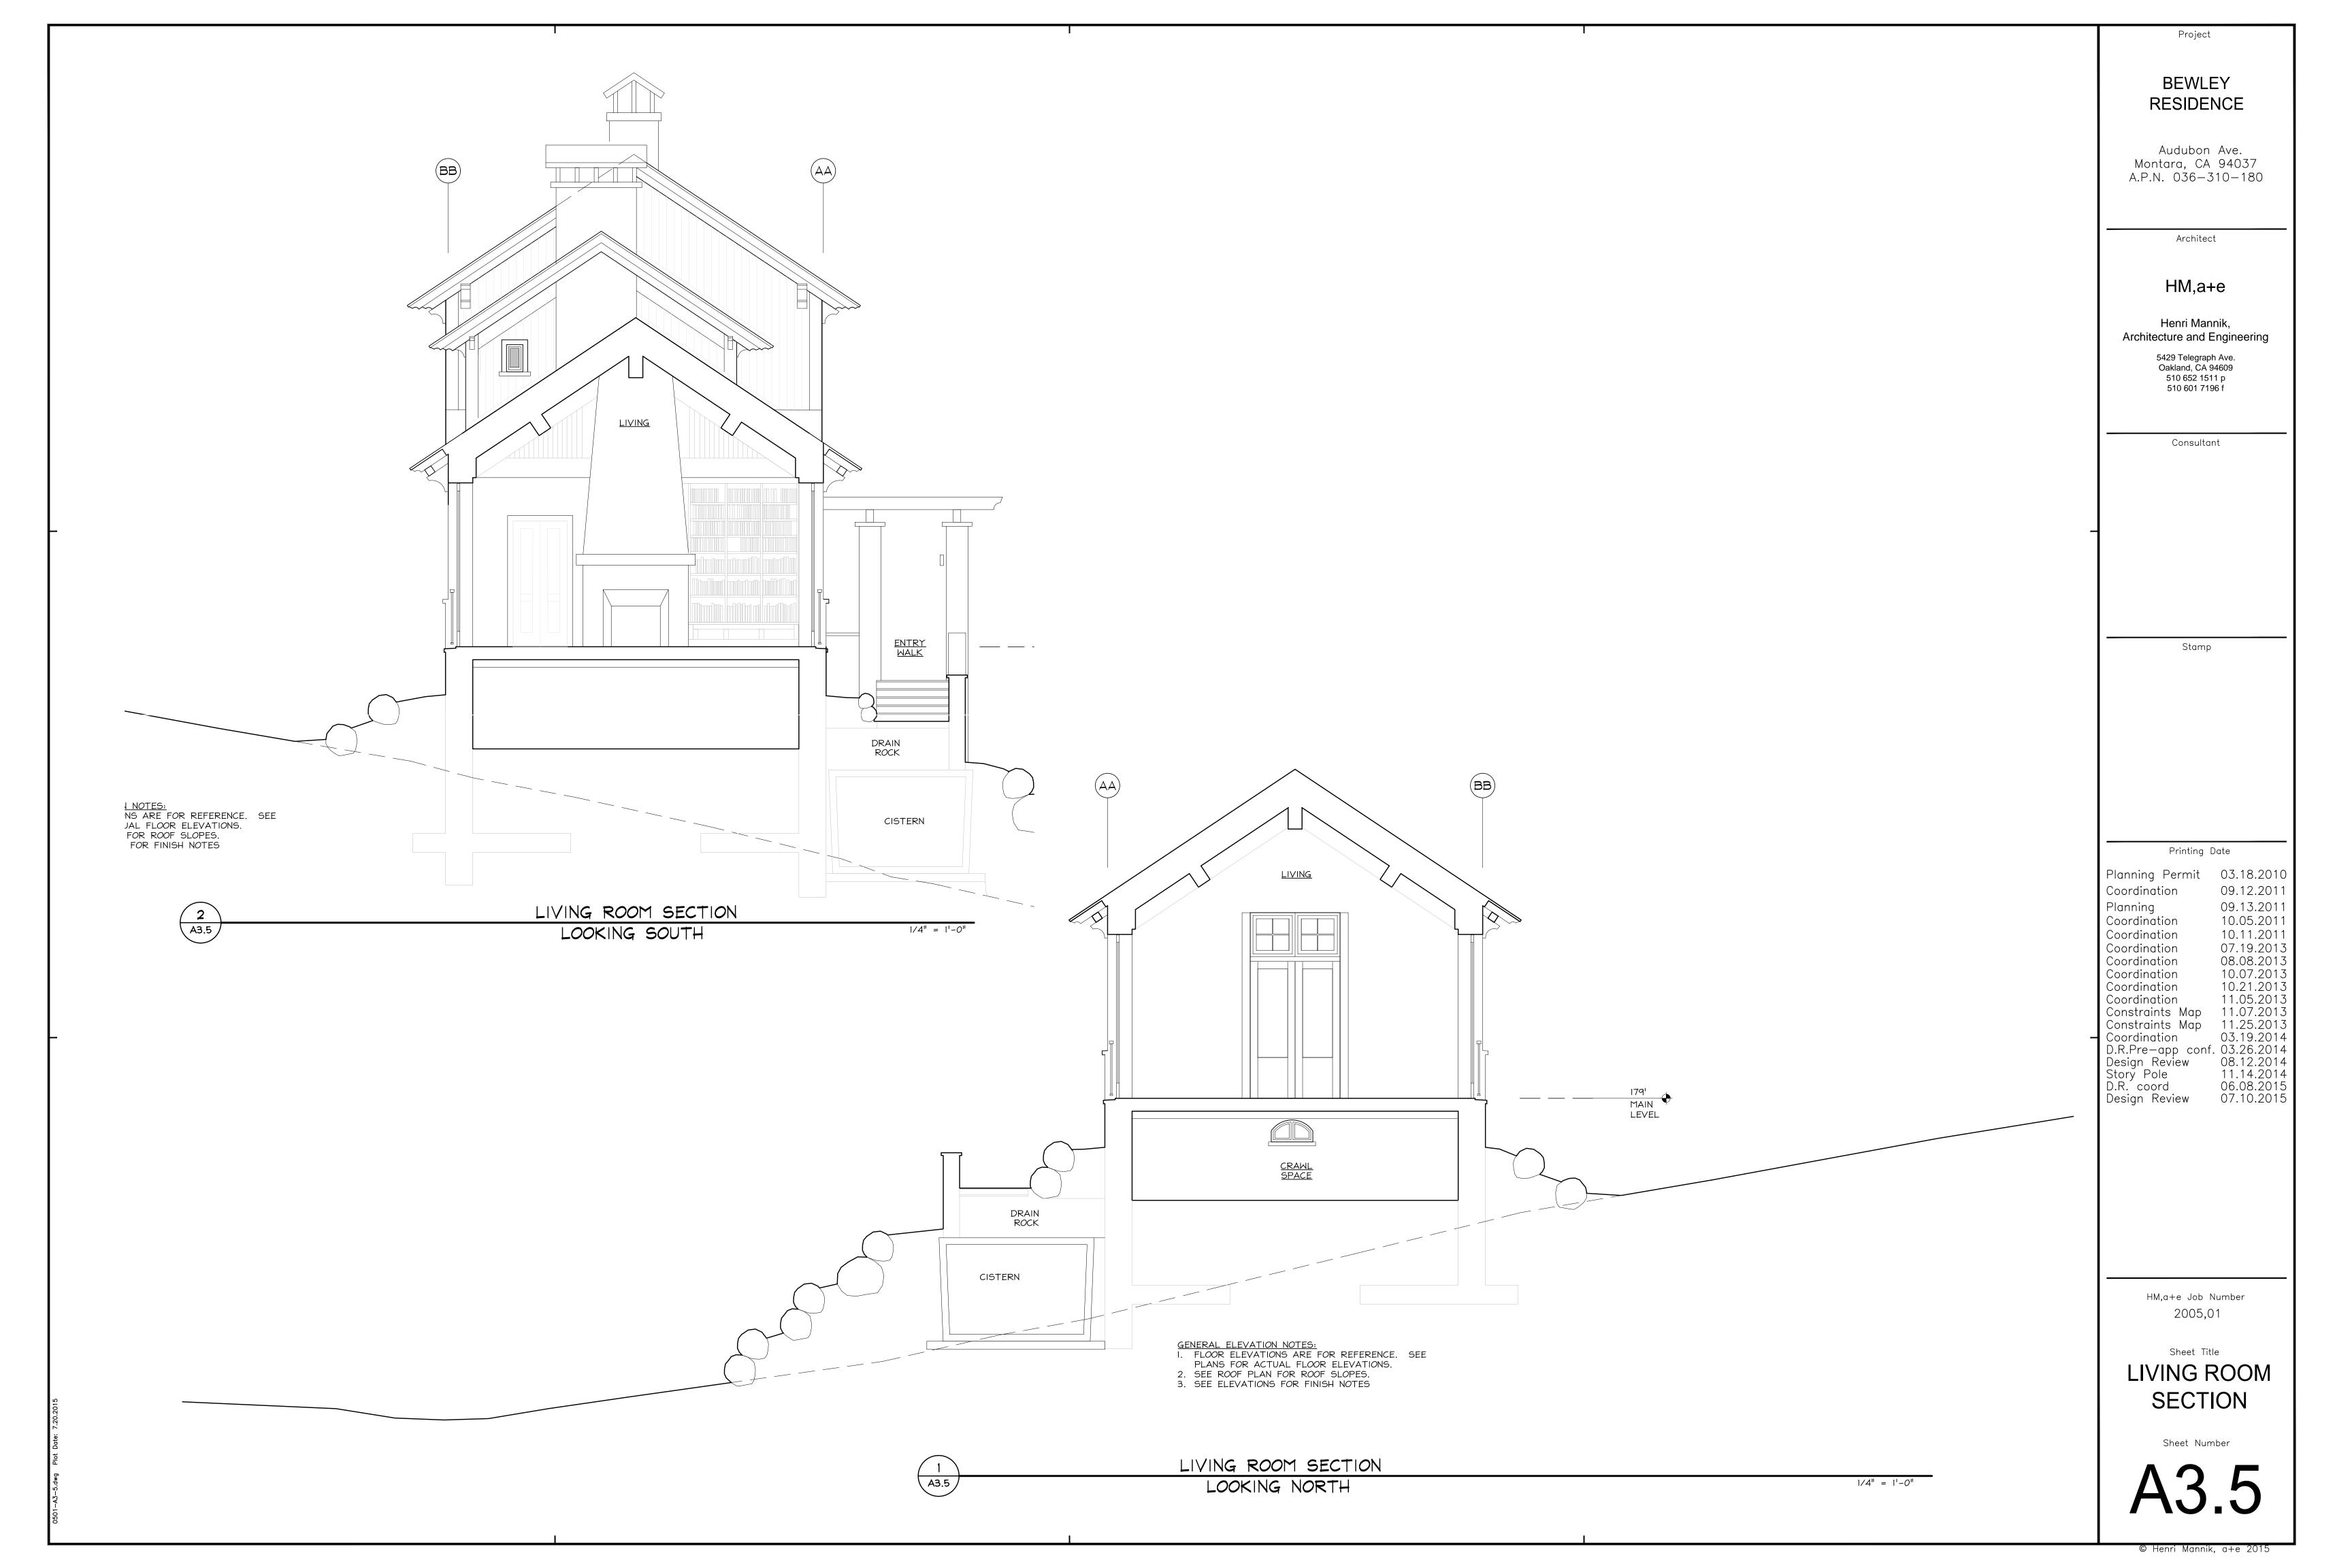



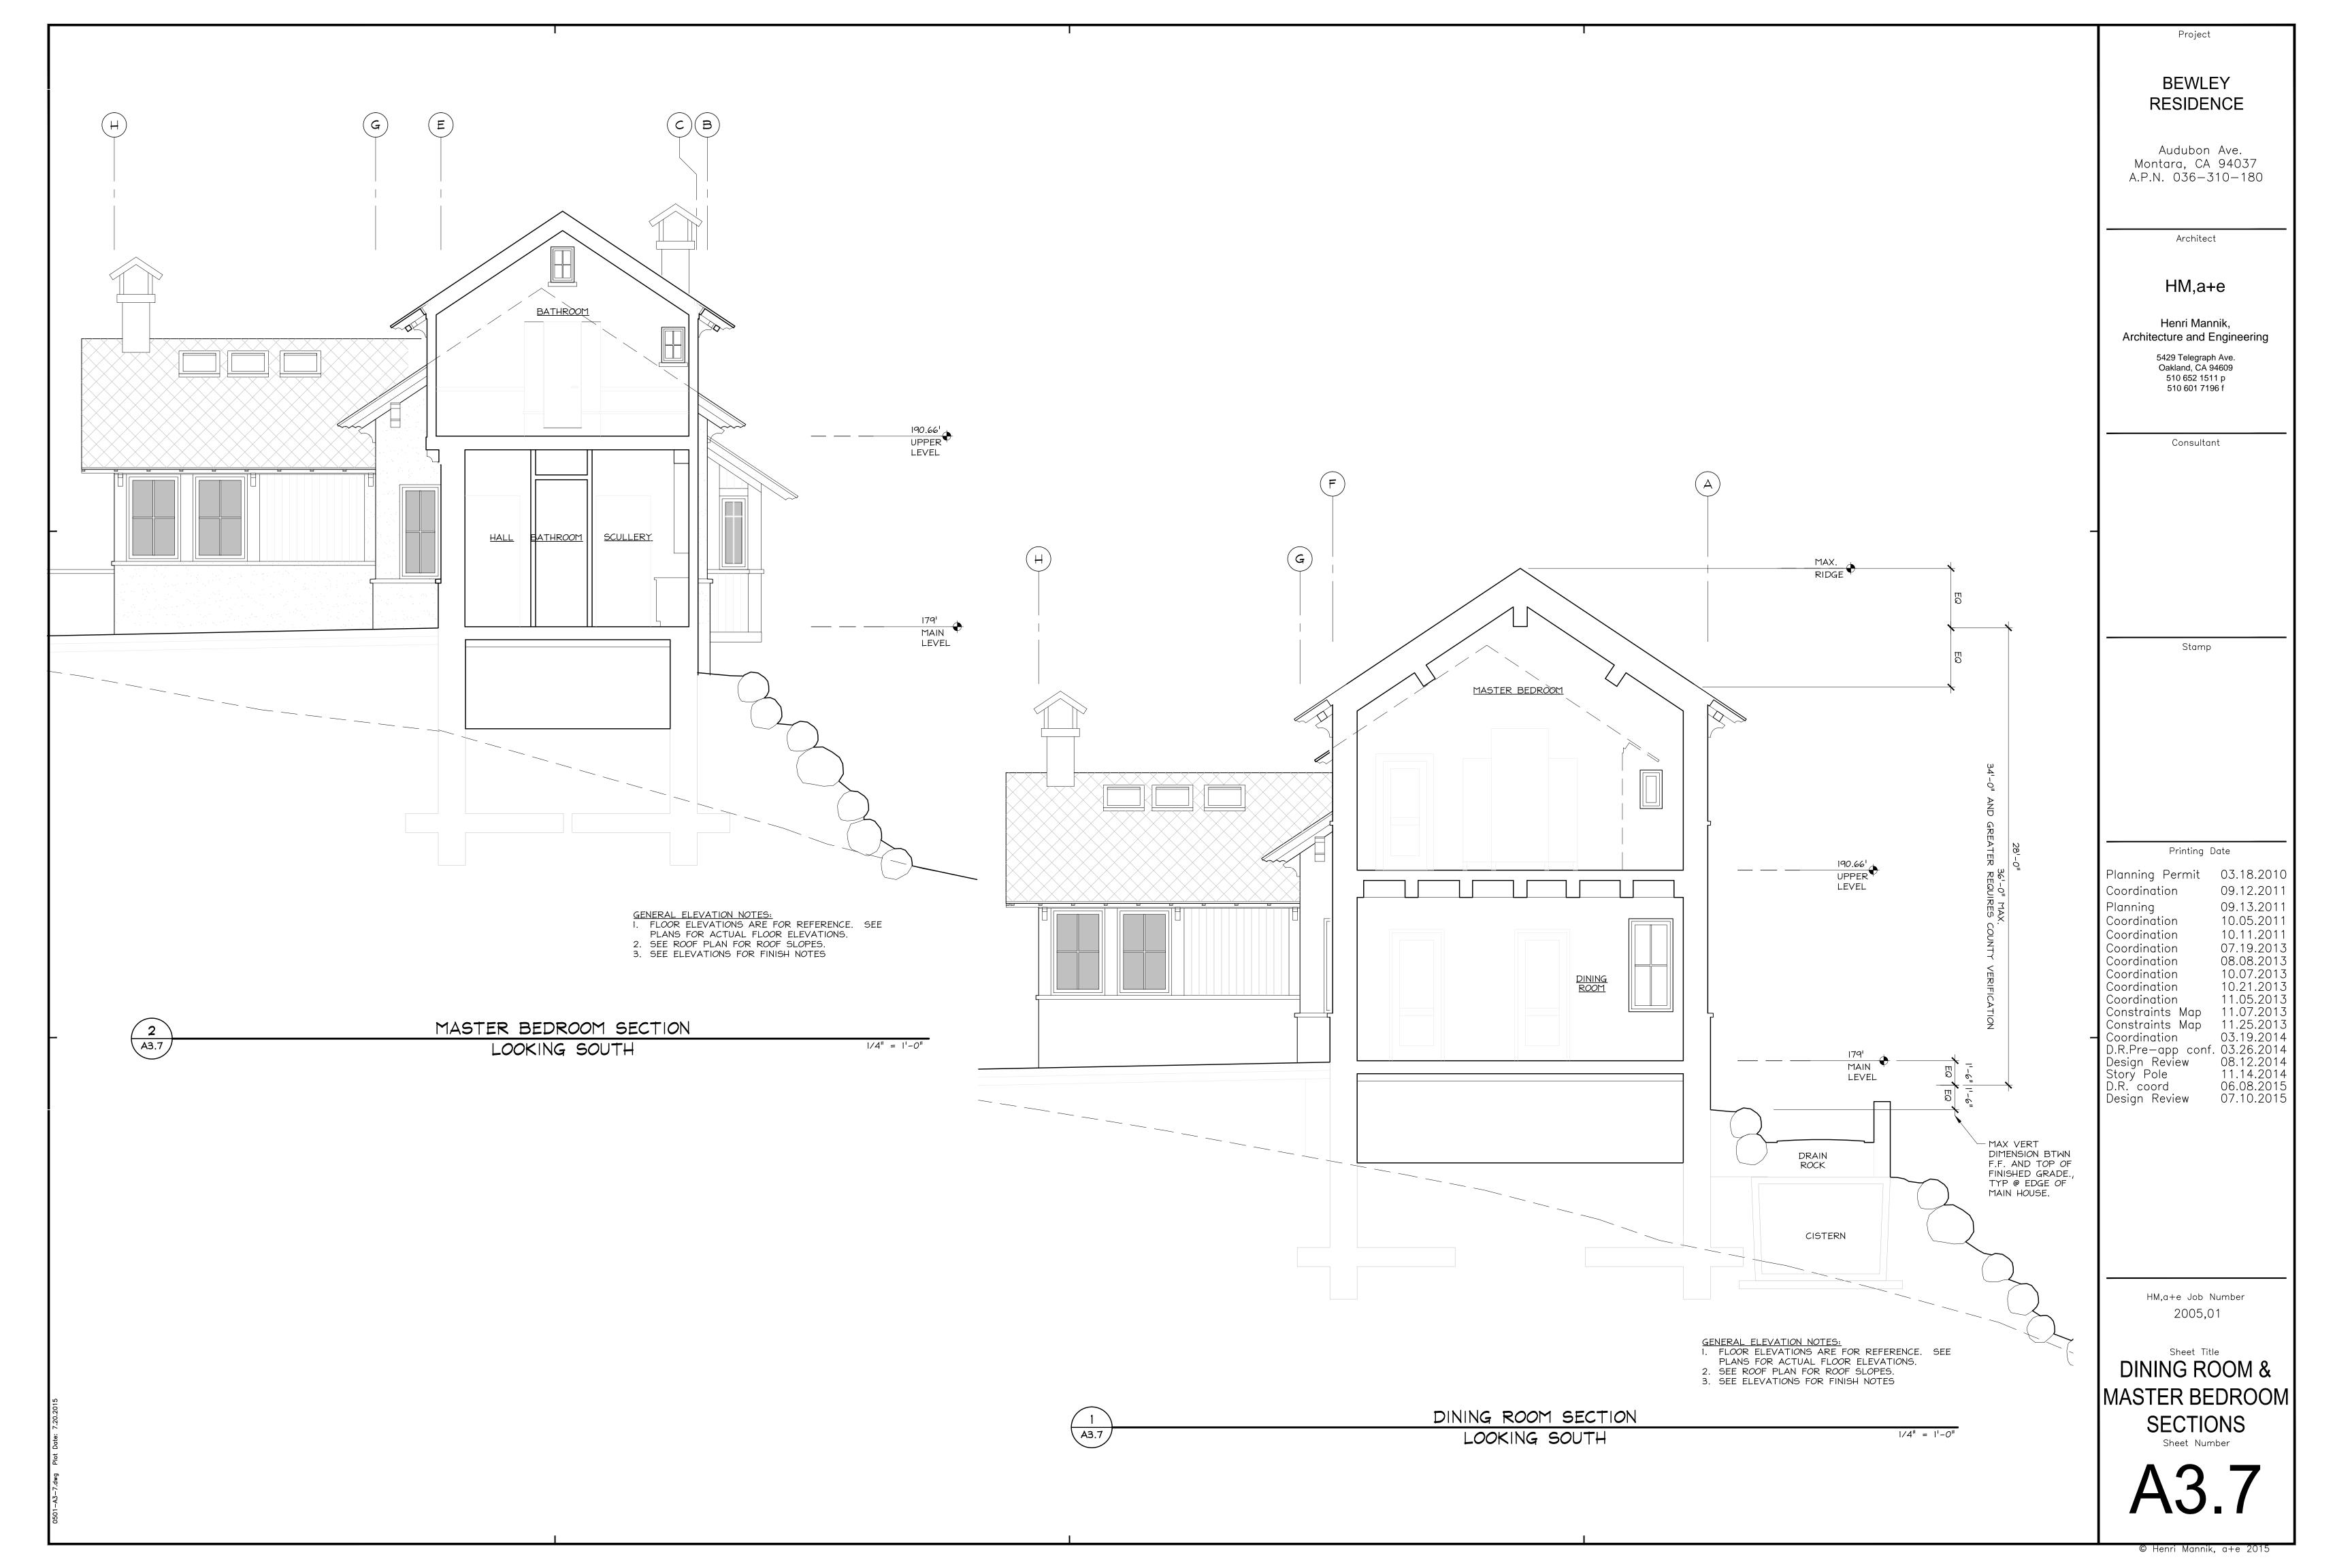

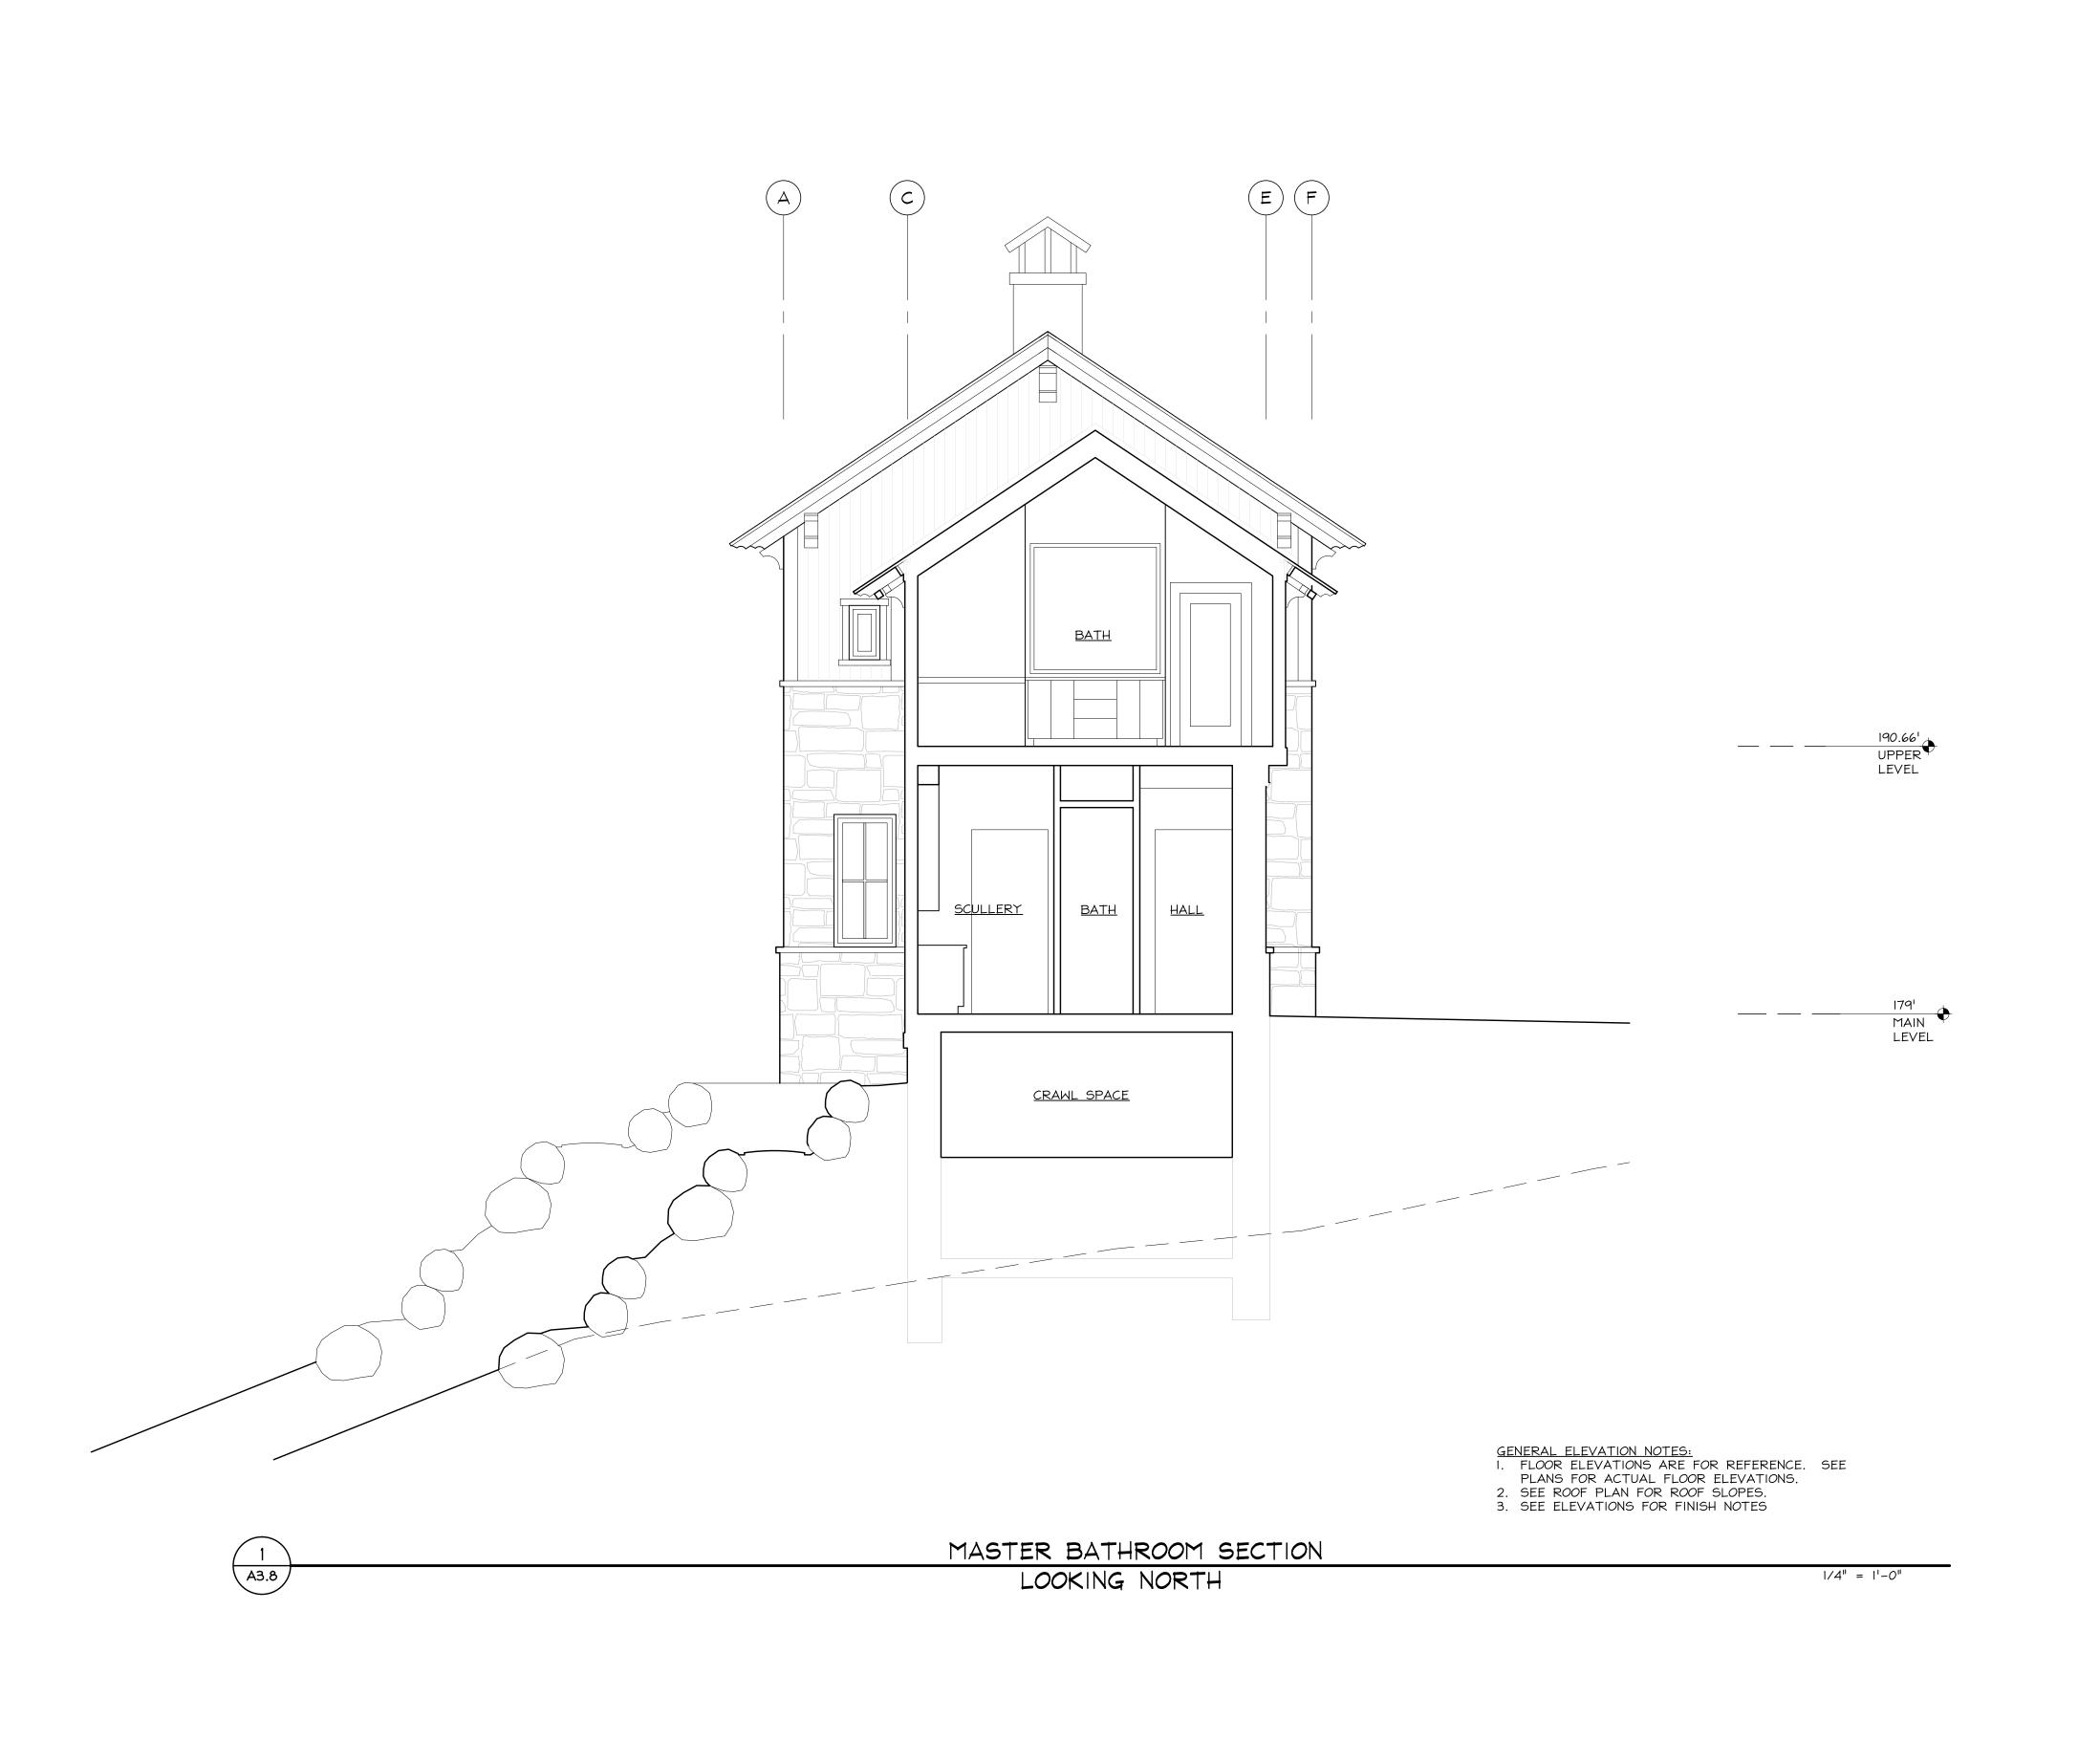

BEWLEY RESIDENCE

Audubon Ave. Montara, CA 94037 A.P.N. 036—310—180

Architect

HM,a+e

Henri Mannik, Architecture and Engineering

> 5429 Telegraph Ave. Oakland, CA 94609 510 652 1511 p 510 601 7196 f

> > Consultant

Stamp

Printing Date

 Planning Permit
 03.18.2010

 Coordination
 09.12.2011

 Planning
 09.13.2011

 Coordination
 10.05.2011

 Coordination
 07.19.2013

 Coordination
 08.08.2013

 Coordination
 10.07.2013

 Coordination
 11.05.2013

 Constraints Map
 11.07.2013

 Constraints Map
 11.25.2013

 Coordination
 03.19.2014

 D.R.Pre-app conf.
 03.26.2014

 Design Review
 08.12.2014

 Story Pole
 11.14.2014

 D.R. coord
 06.08.2015

 Design Review
 07.10.2015


HM,a+e Job Number 2005,01


MASTER
BEDROOM
SECTION


A3.8

© Henri Mannik, a+e 2015

Sheet Number

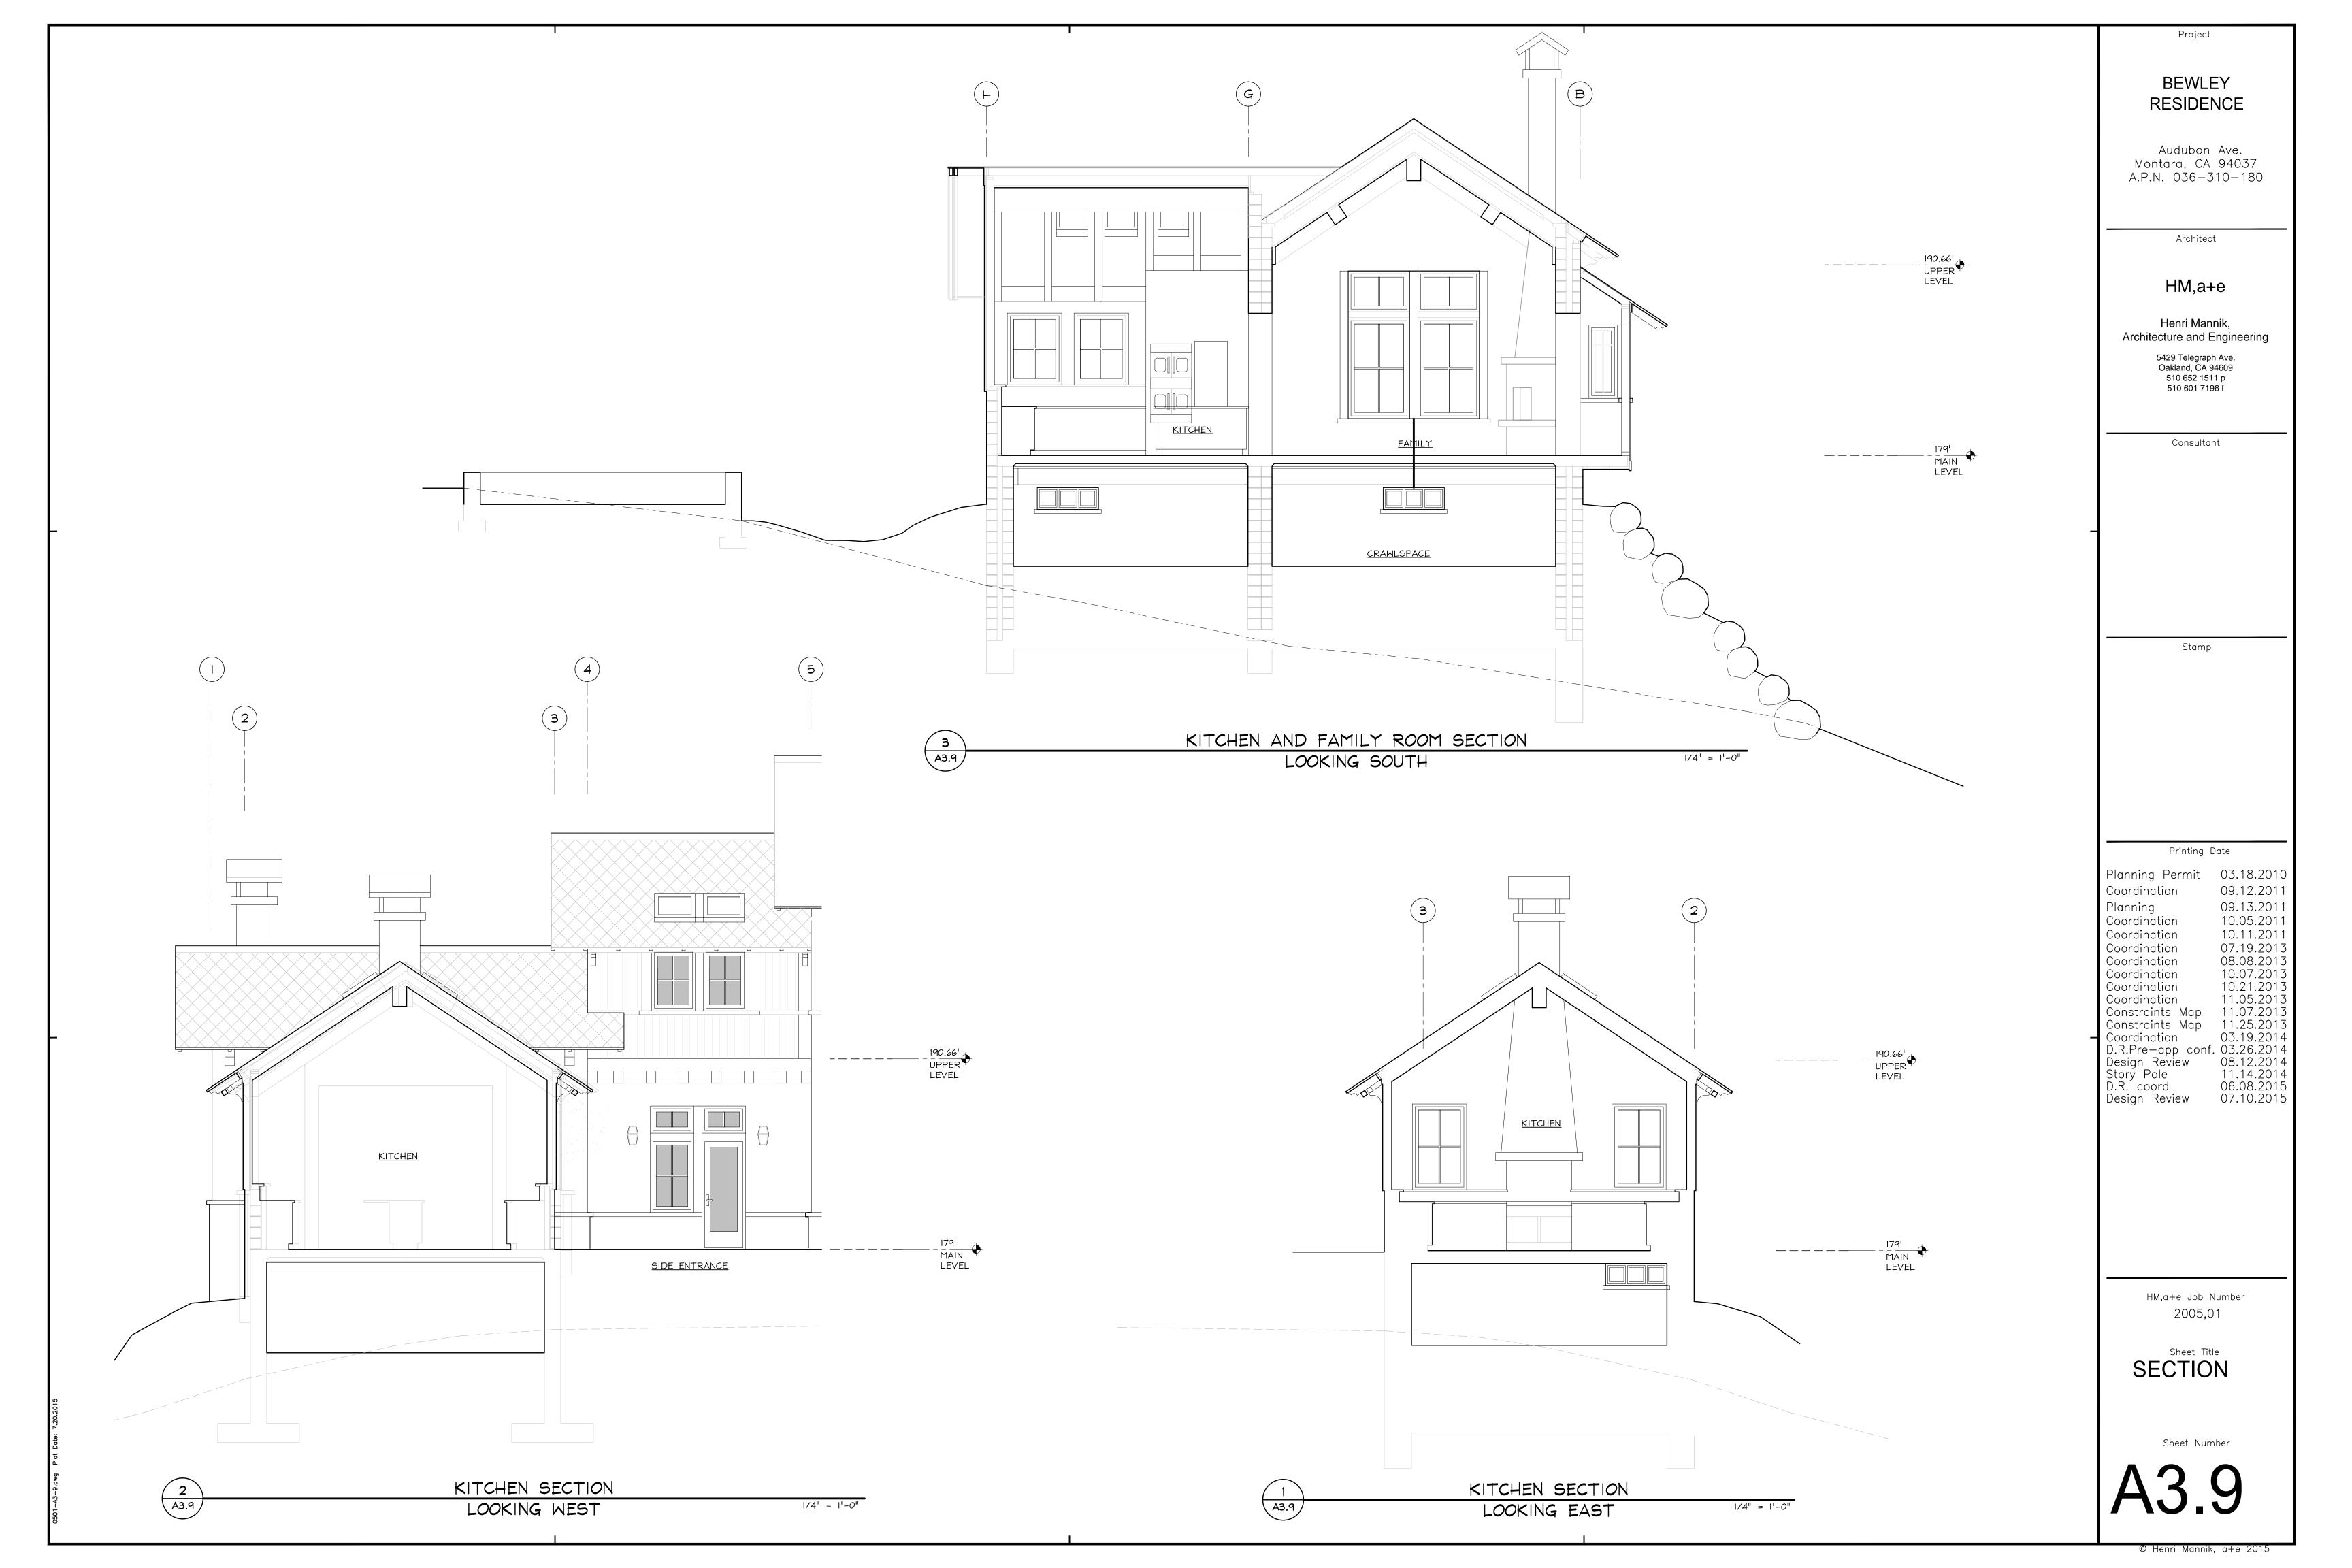

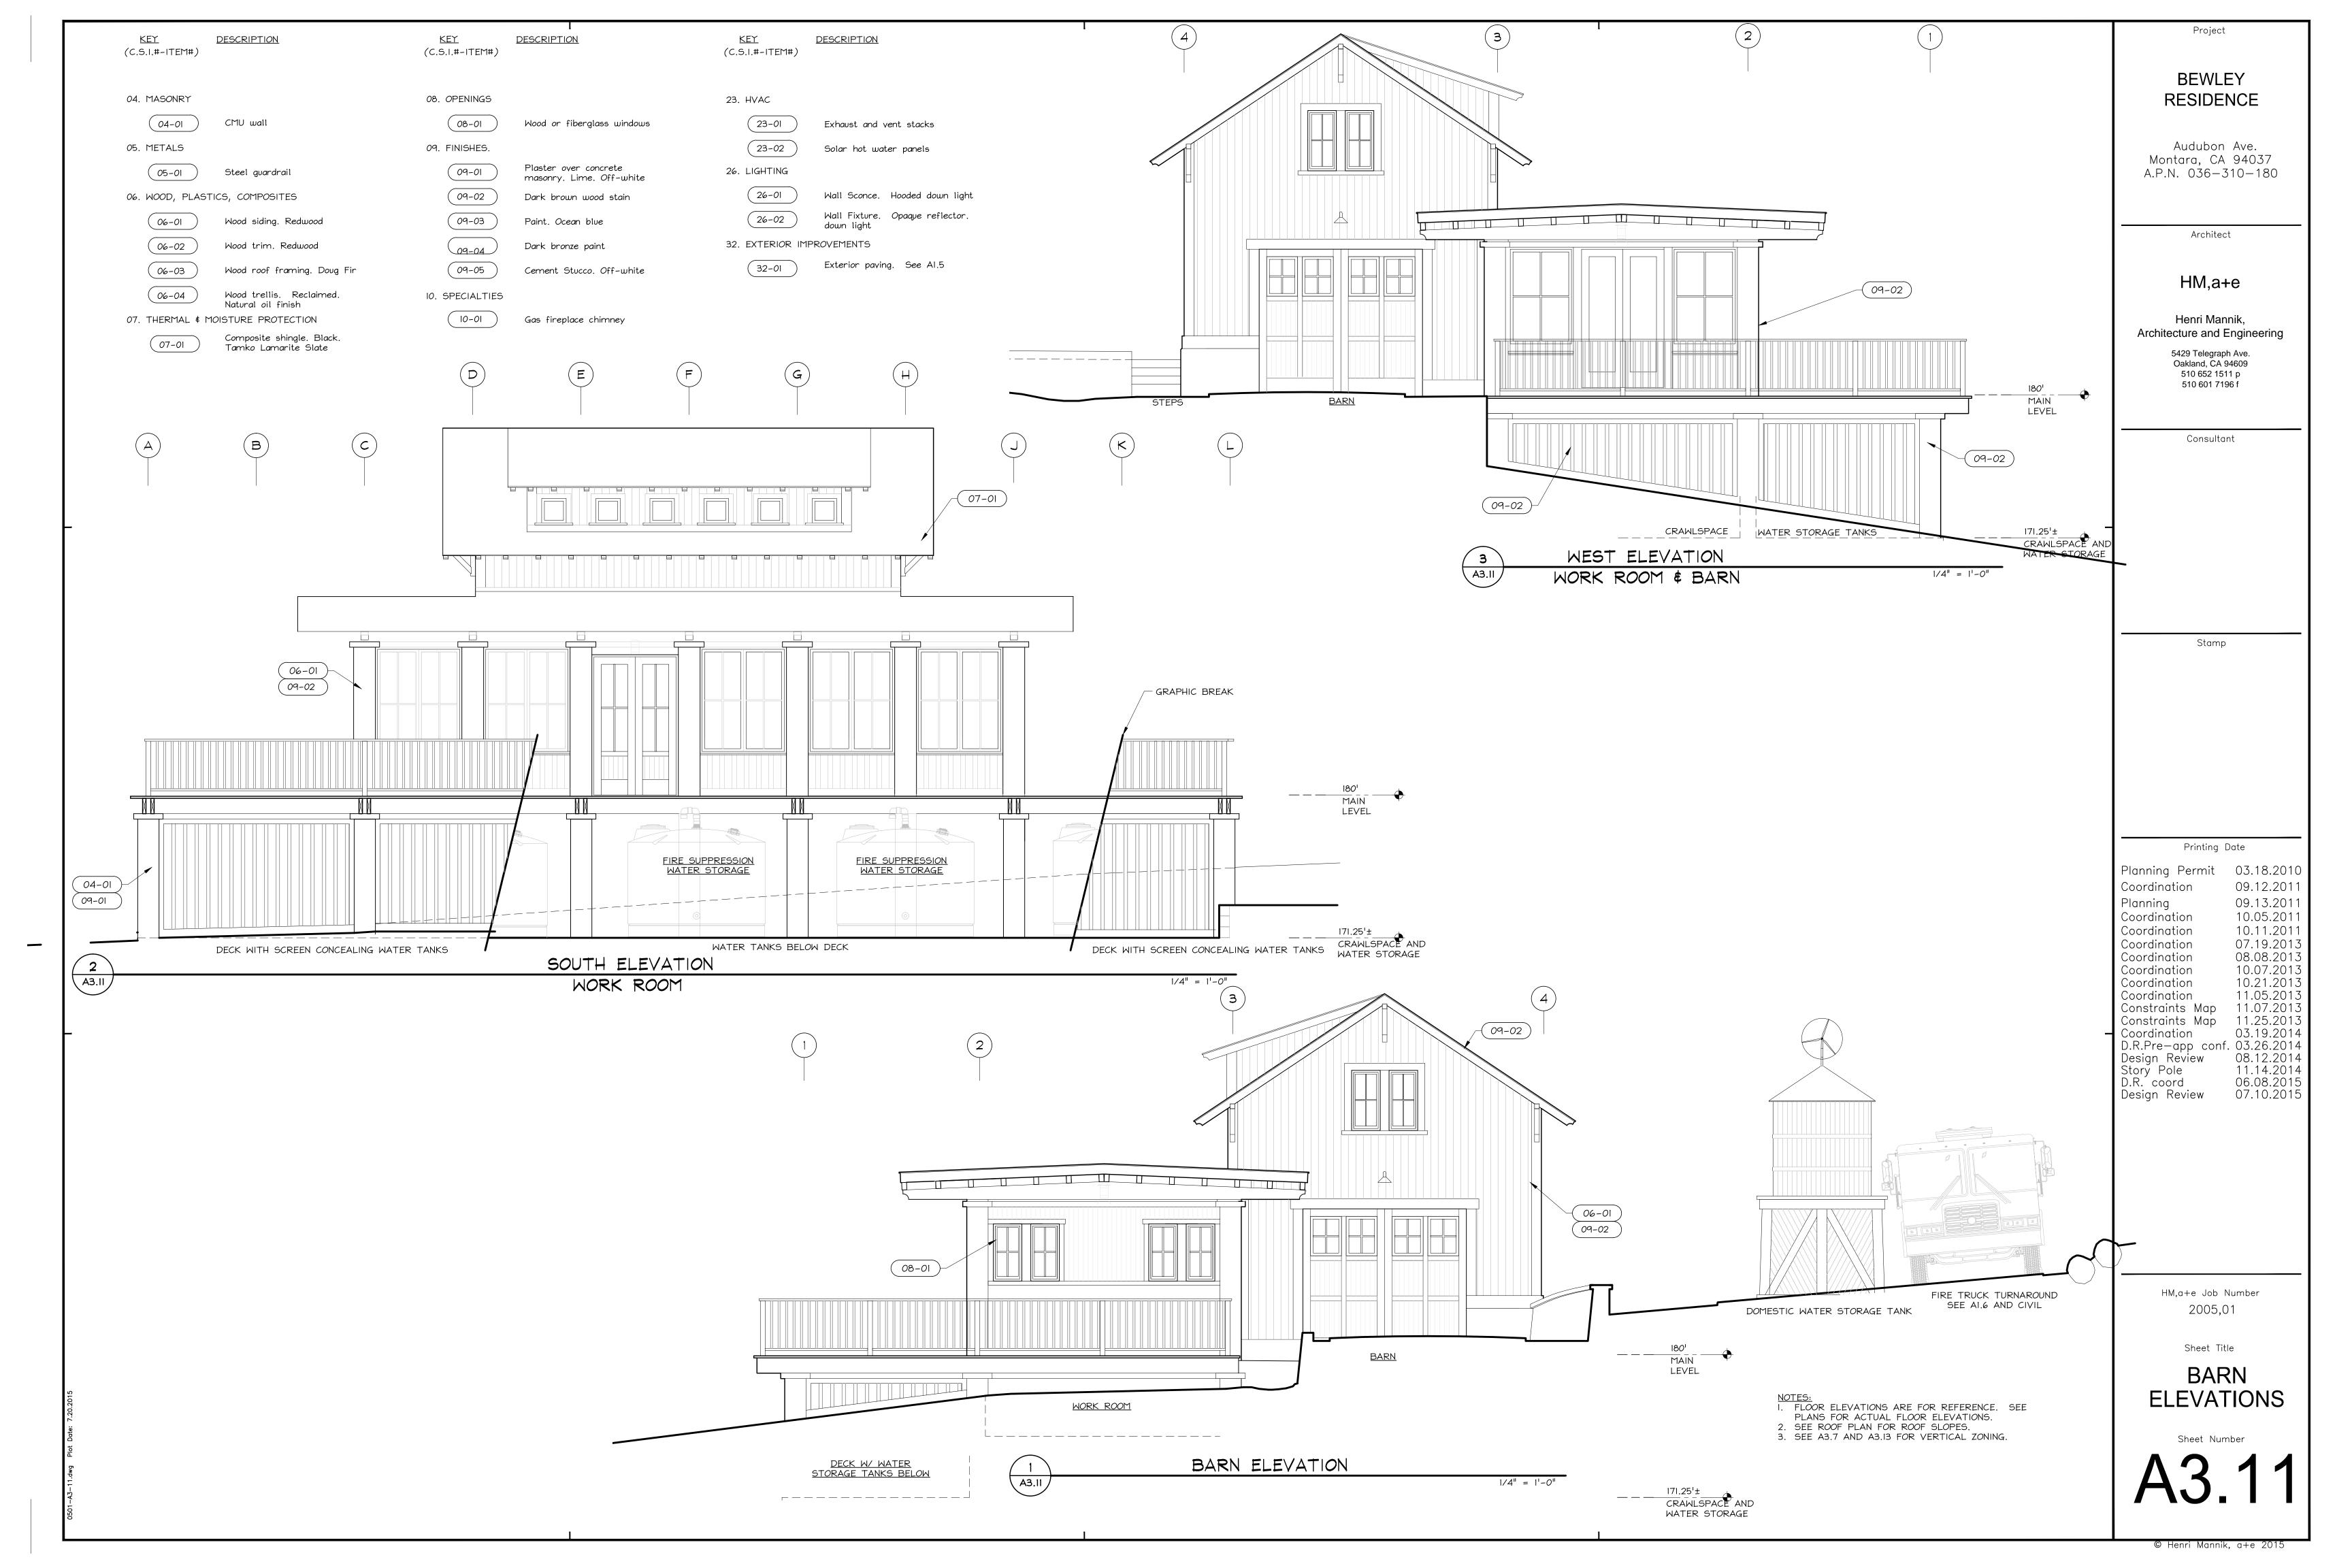

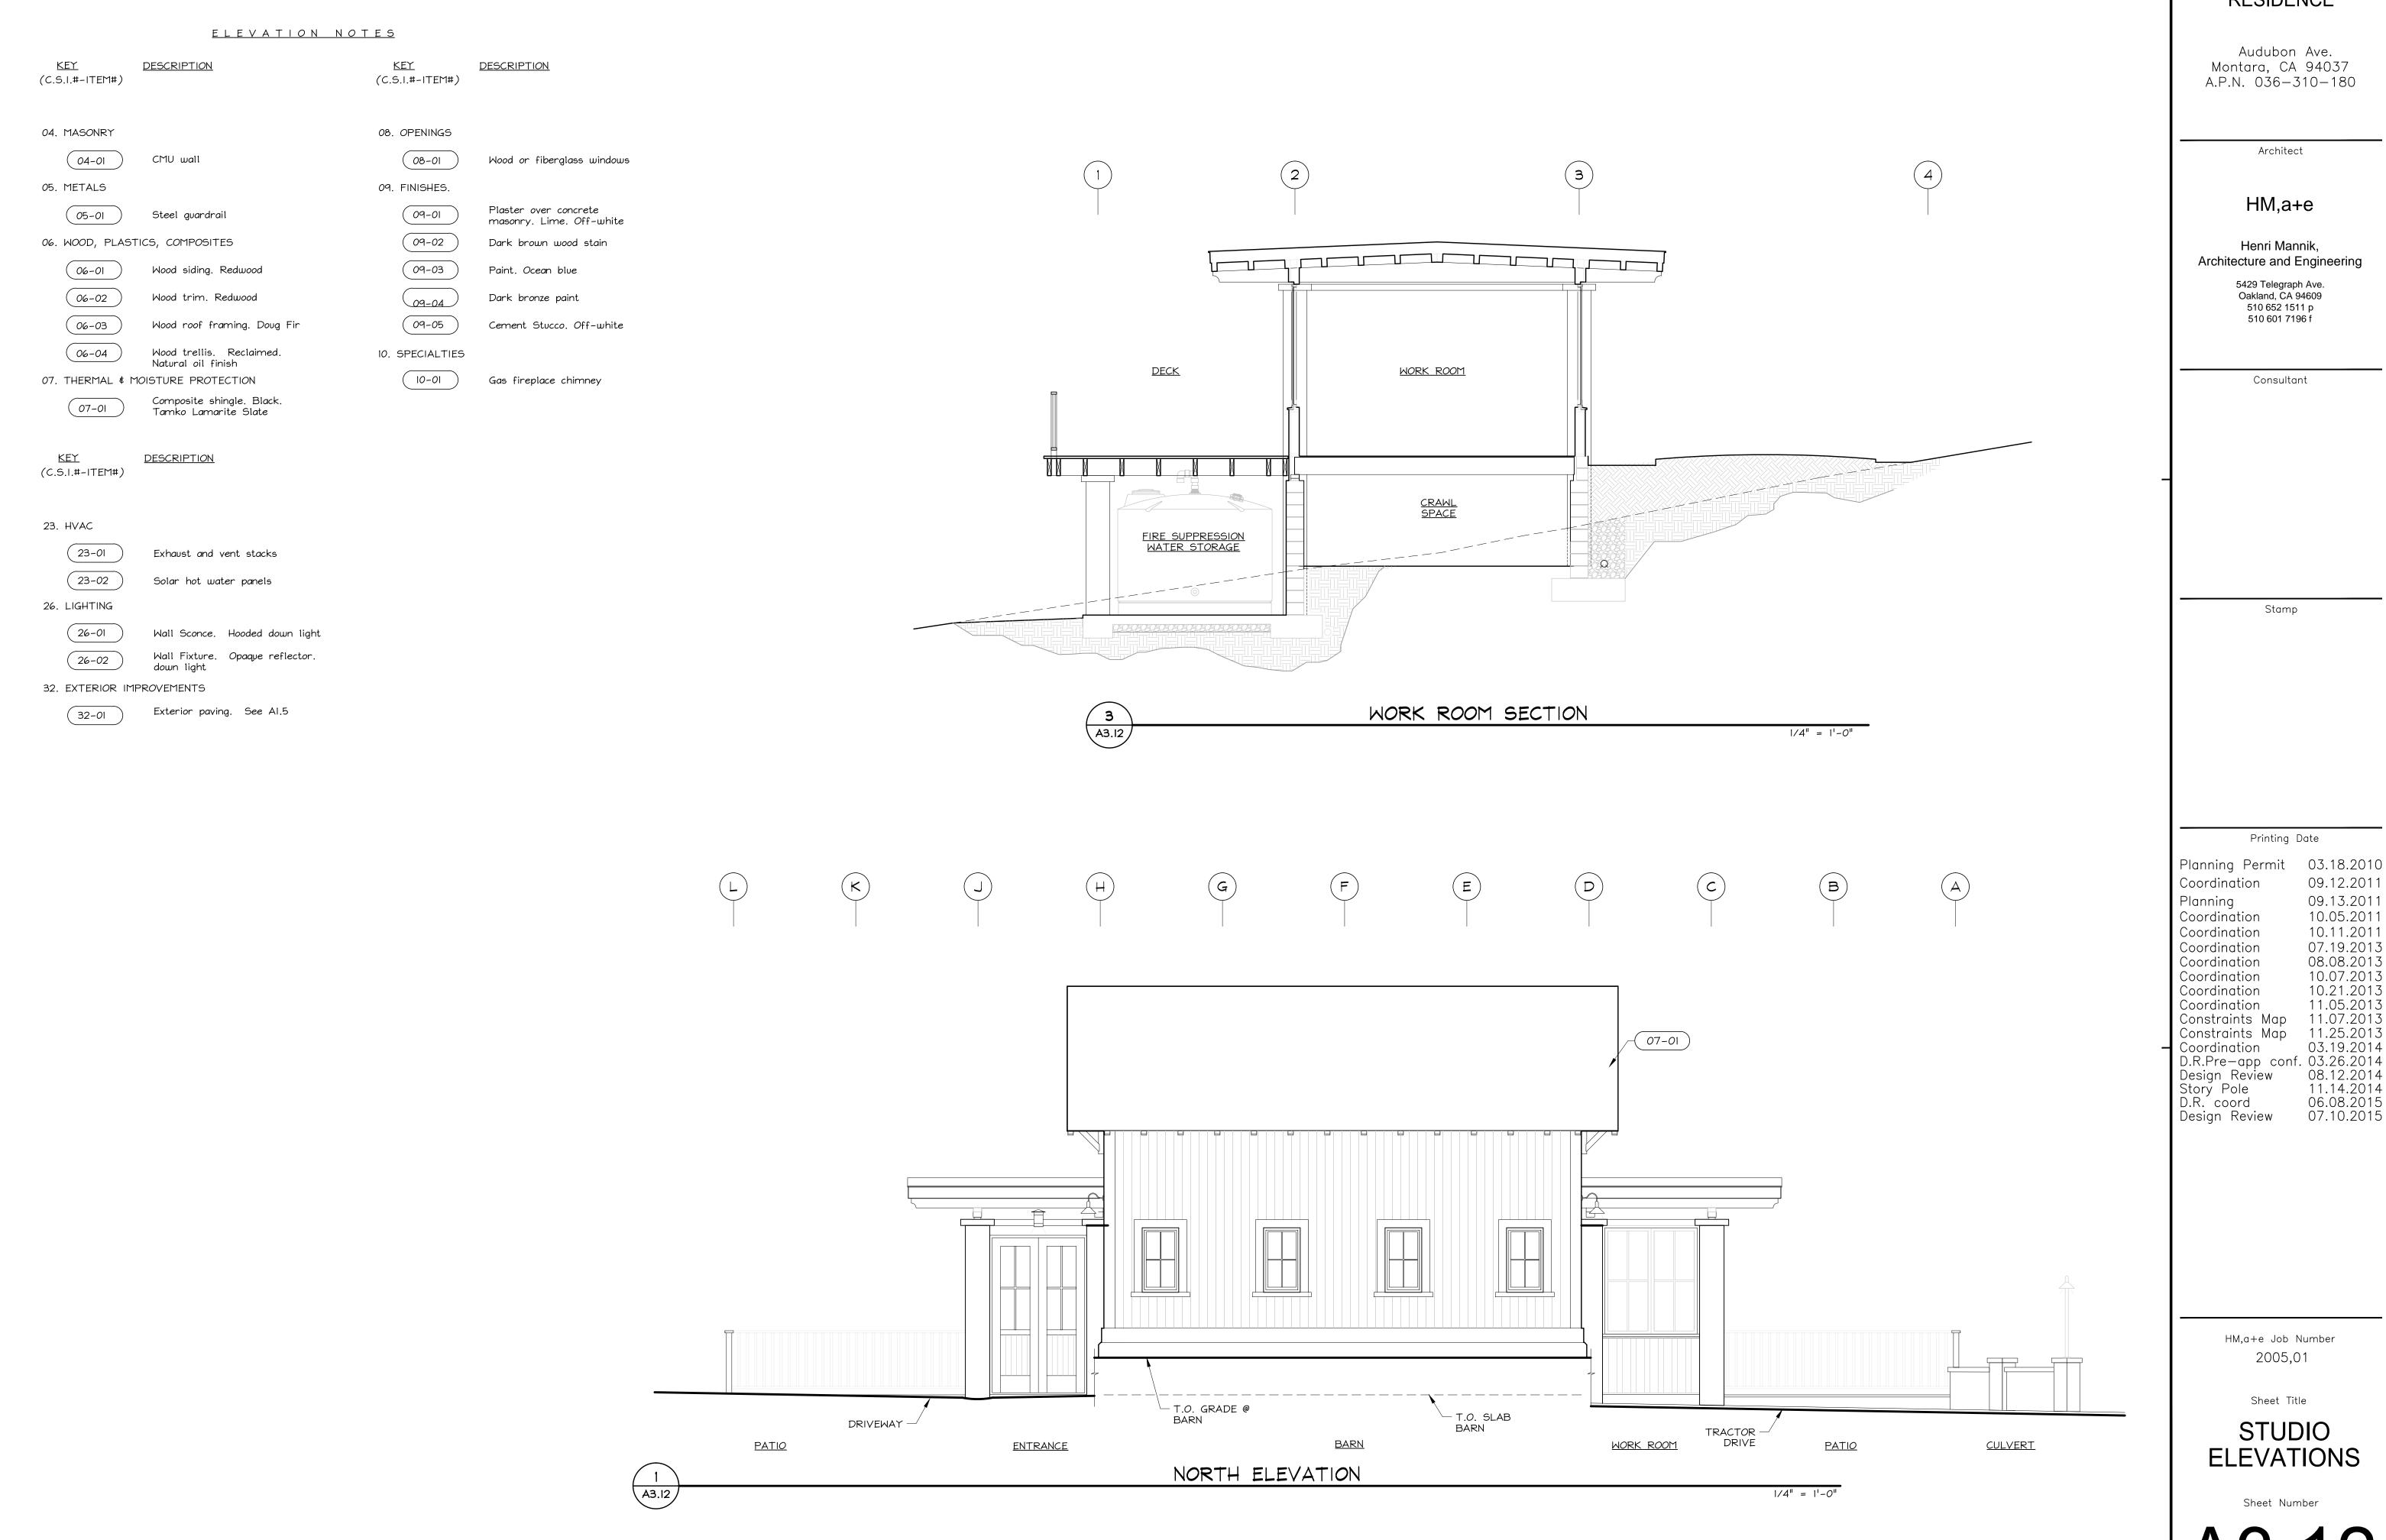

BEWLEY RESIDENCE

09.12.2011 09.13.2011 10.05.2011 10.11.2011 07.19.2013 08.08.2013 Coordination 08.08.2013
Coordination 10.07.2013
Coordination 10.21.2013
Coordination 11.05.2013
Constraints Map 11.07.2013
Constraints Map 11.25.2013
Coordination 03.19.2014
D.R.Pre—app conf. 03.26.2014
Design Review 08.12.2014
Story Pole 11.14.2014
D.R. coord 06.08.2015
Design Review 07.10.2015 07.10.2015

<u>ELEVATION NOTES</u>

<u>KEY</u> **DESCRIPTION DESCRIPTION** (C.S.I.#-ITEM#) (C.S.I.#-ITEM#) 04. MASONRY 08. OPENINGS

> CMU wall Wood or fiberglass windows

05. METALS 09. FINISHES. Plaster over concrete

masonry. Lime. Off-white 06. WOOD, PLASTICS, COMPOSITES Dark brown wood stain

> Wood siding. Redwood Paint. Ocean blue Wood trim. Redwood Dark bronze paint Wood roof framing. Doug Fir Cement Stucco. Off-white

> > A3.I3

Wood trellis. Reclaimed. 10. SPECIALTIES Natural oil finish

07. THERMAL & MOISTURE PROTECTION Gas fireplace chimney

> Composite shingle. Black. Tamko Lamarite Slate

Steel guardrail

<u>KEY</u> <u>DESCRIPTION</u> (C.S.I.#-ITEM#)

23. HVAC

Exhaust and vent stacks

Solar hot water panels


26. LIGHTING


Wall Sconce. Hooded down light

Wall Fixture. Opaque reflector. down light

32. EXTERIOR IMPROVEMENTS

Exterior paving. See A1.5

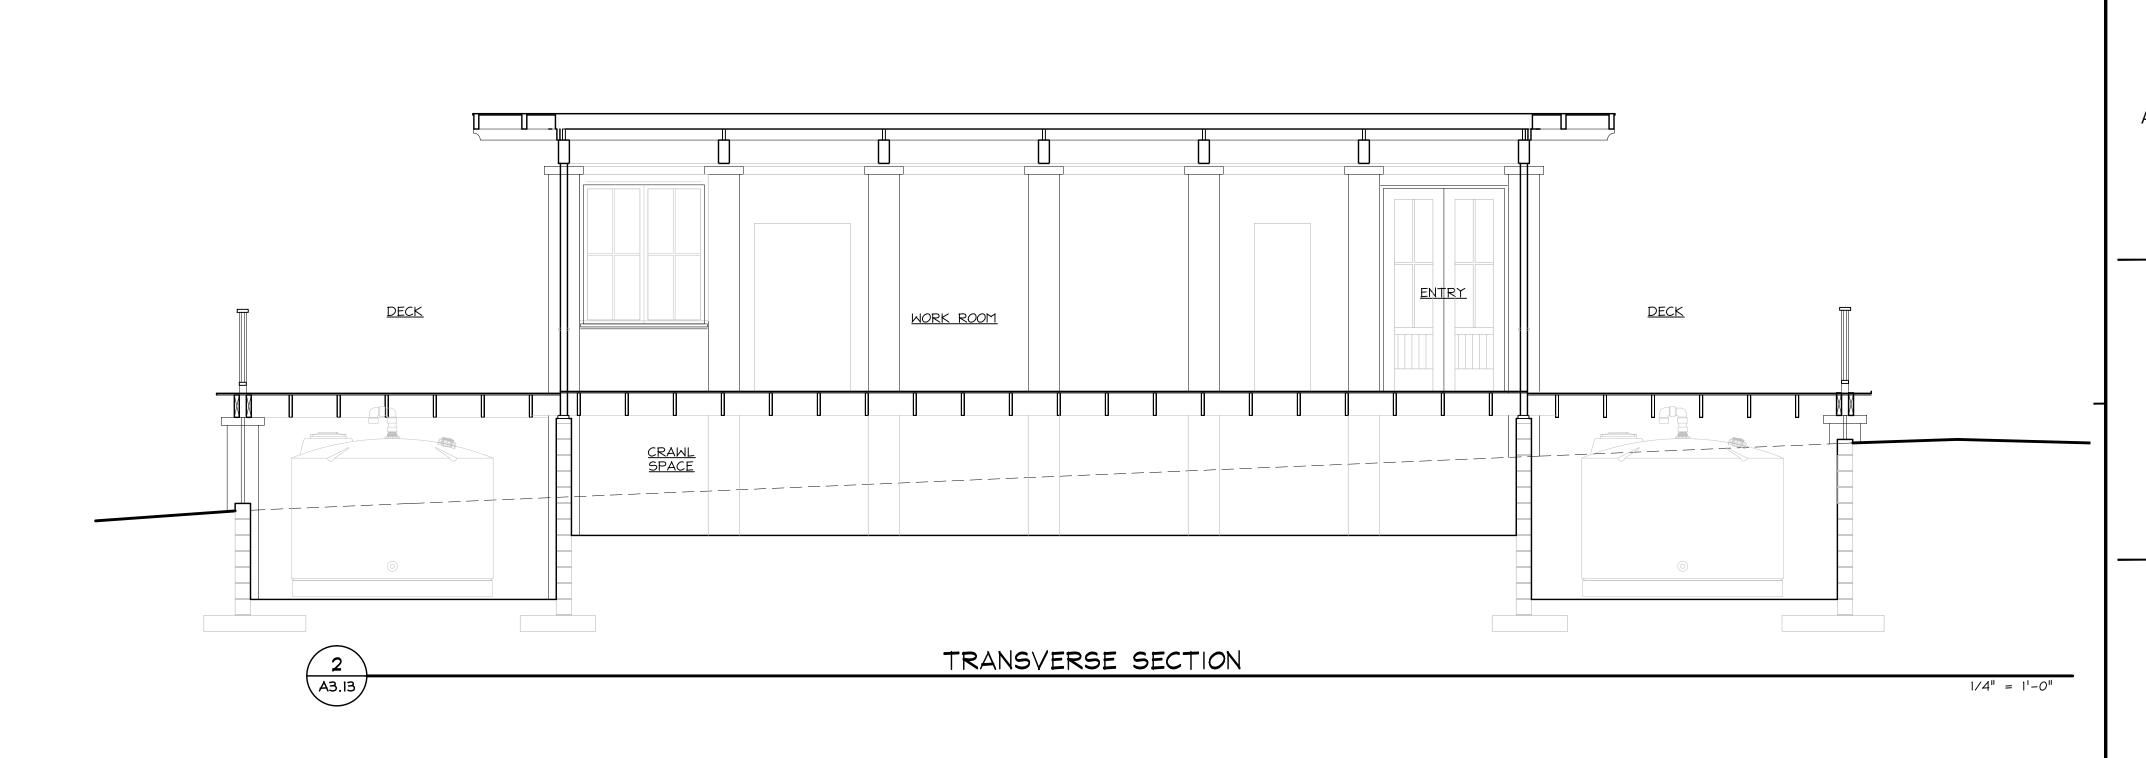

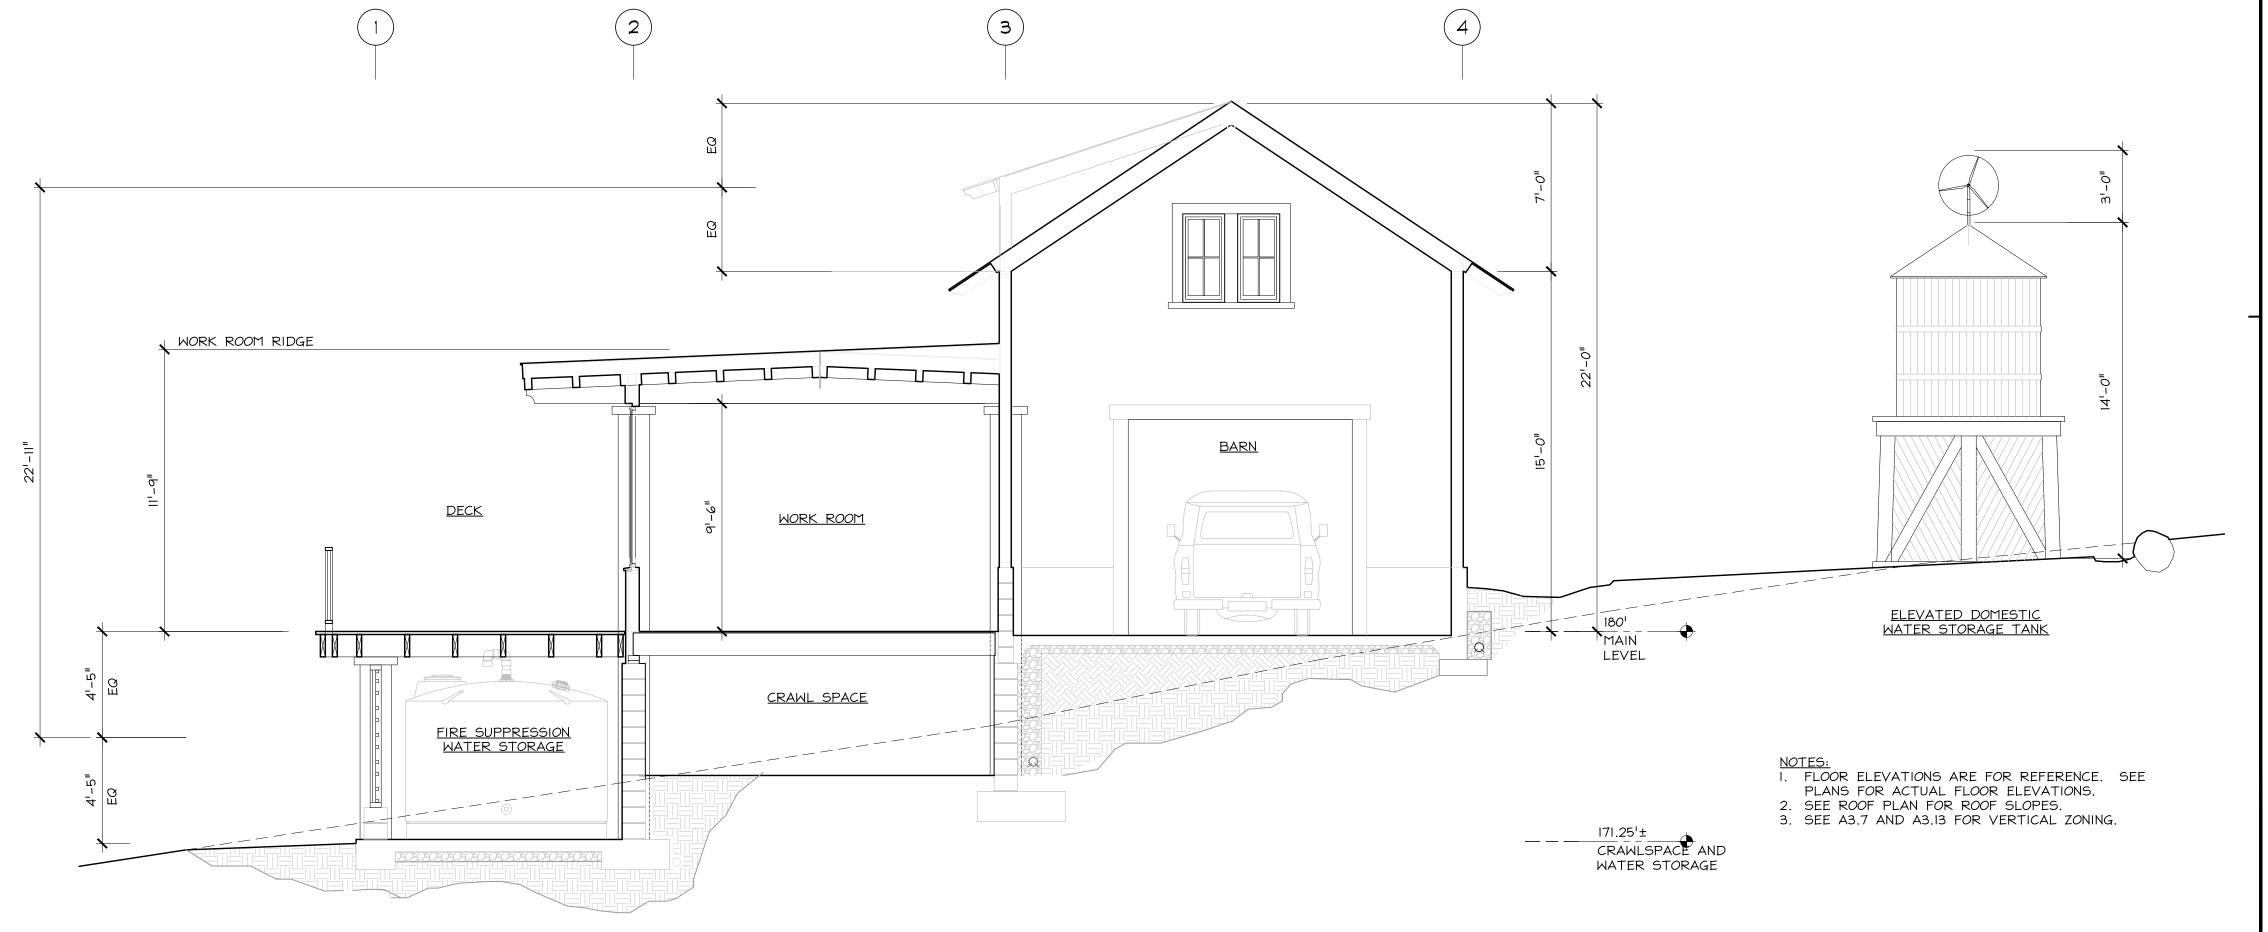

WORK ROOM AND BARN SECTION

BEWLEY

Project

RESIDENCE

Audubon Ave. Montara, CA 94037 A.P.N. 036-310-180

Architect

HM,a+e

Henri Mannik, Architecture and Engineering

> 5429 Telegraph Ave. Oakland, CA 94609 510 652 1511 p 510 601 7196 f

> > Consultant

Stamp

Printing Date


Planning Permit 03.18.2010 09.12.2011 Coordination 09.13.2011 Planning 10.05.2011 Coordination 10.11.2011 Coordination 07.19.2013 Coordination Coordination 08.08.2013 10.07.2013 10.21.2013 Coordination Coordination 11.05.2013 Coordination Constraints Map 11.07.2013 11.25.2013 Constraints Map Coordination 03.19.2014
D.R.Pre-app conf. 03.26.2014
Design Review 08.12.2014
Story Pole 11.14.2014
D.R. coord 06.08.2015 Design Review 07.10.2015

> HM,a+e Job Number 2005,01

Sheet Title BARN **ELEVATIONS**

Sheet Number

1/4'' = 1' - 0''

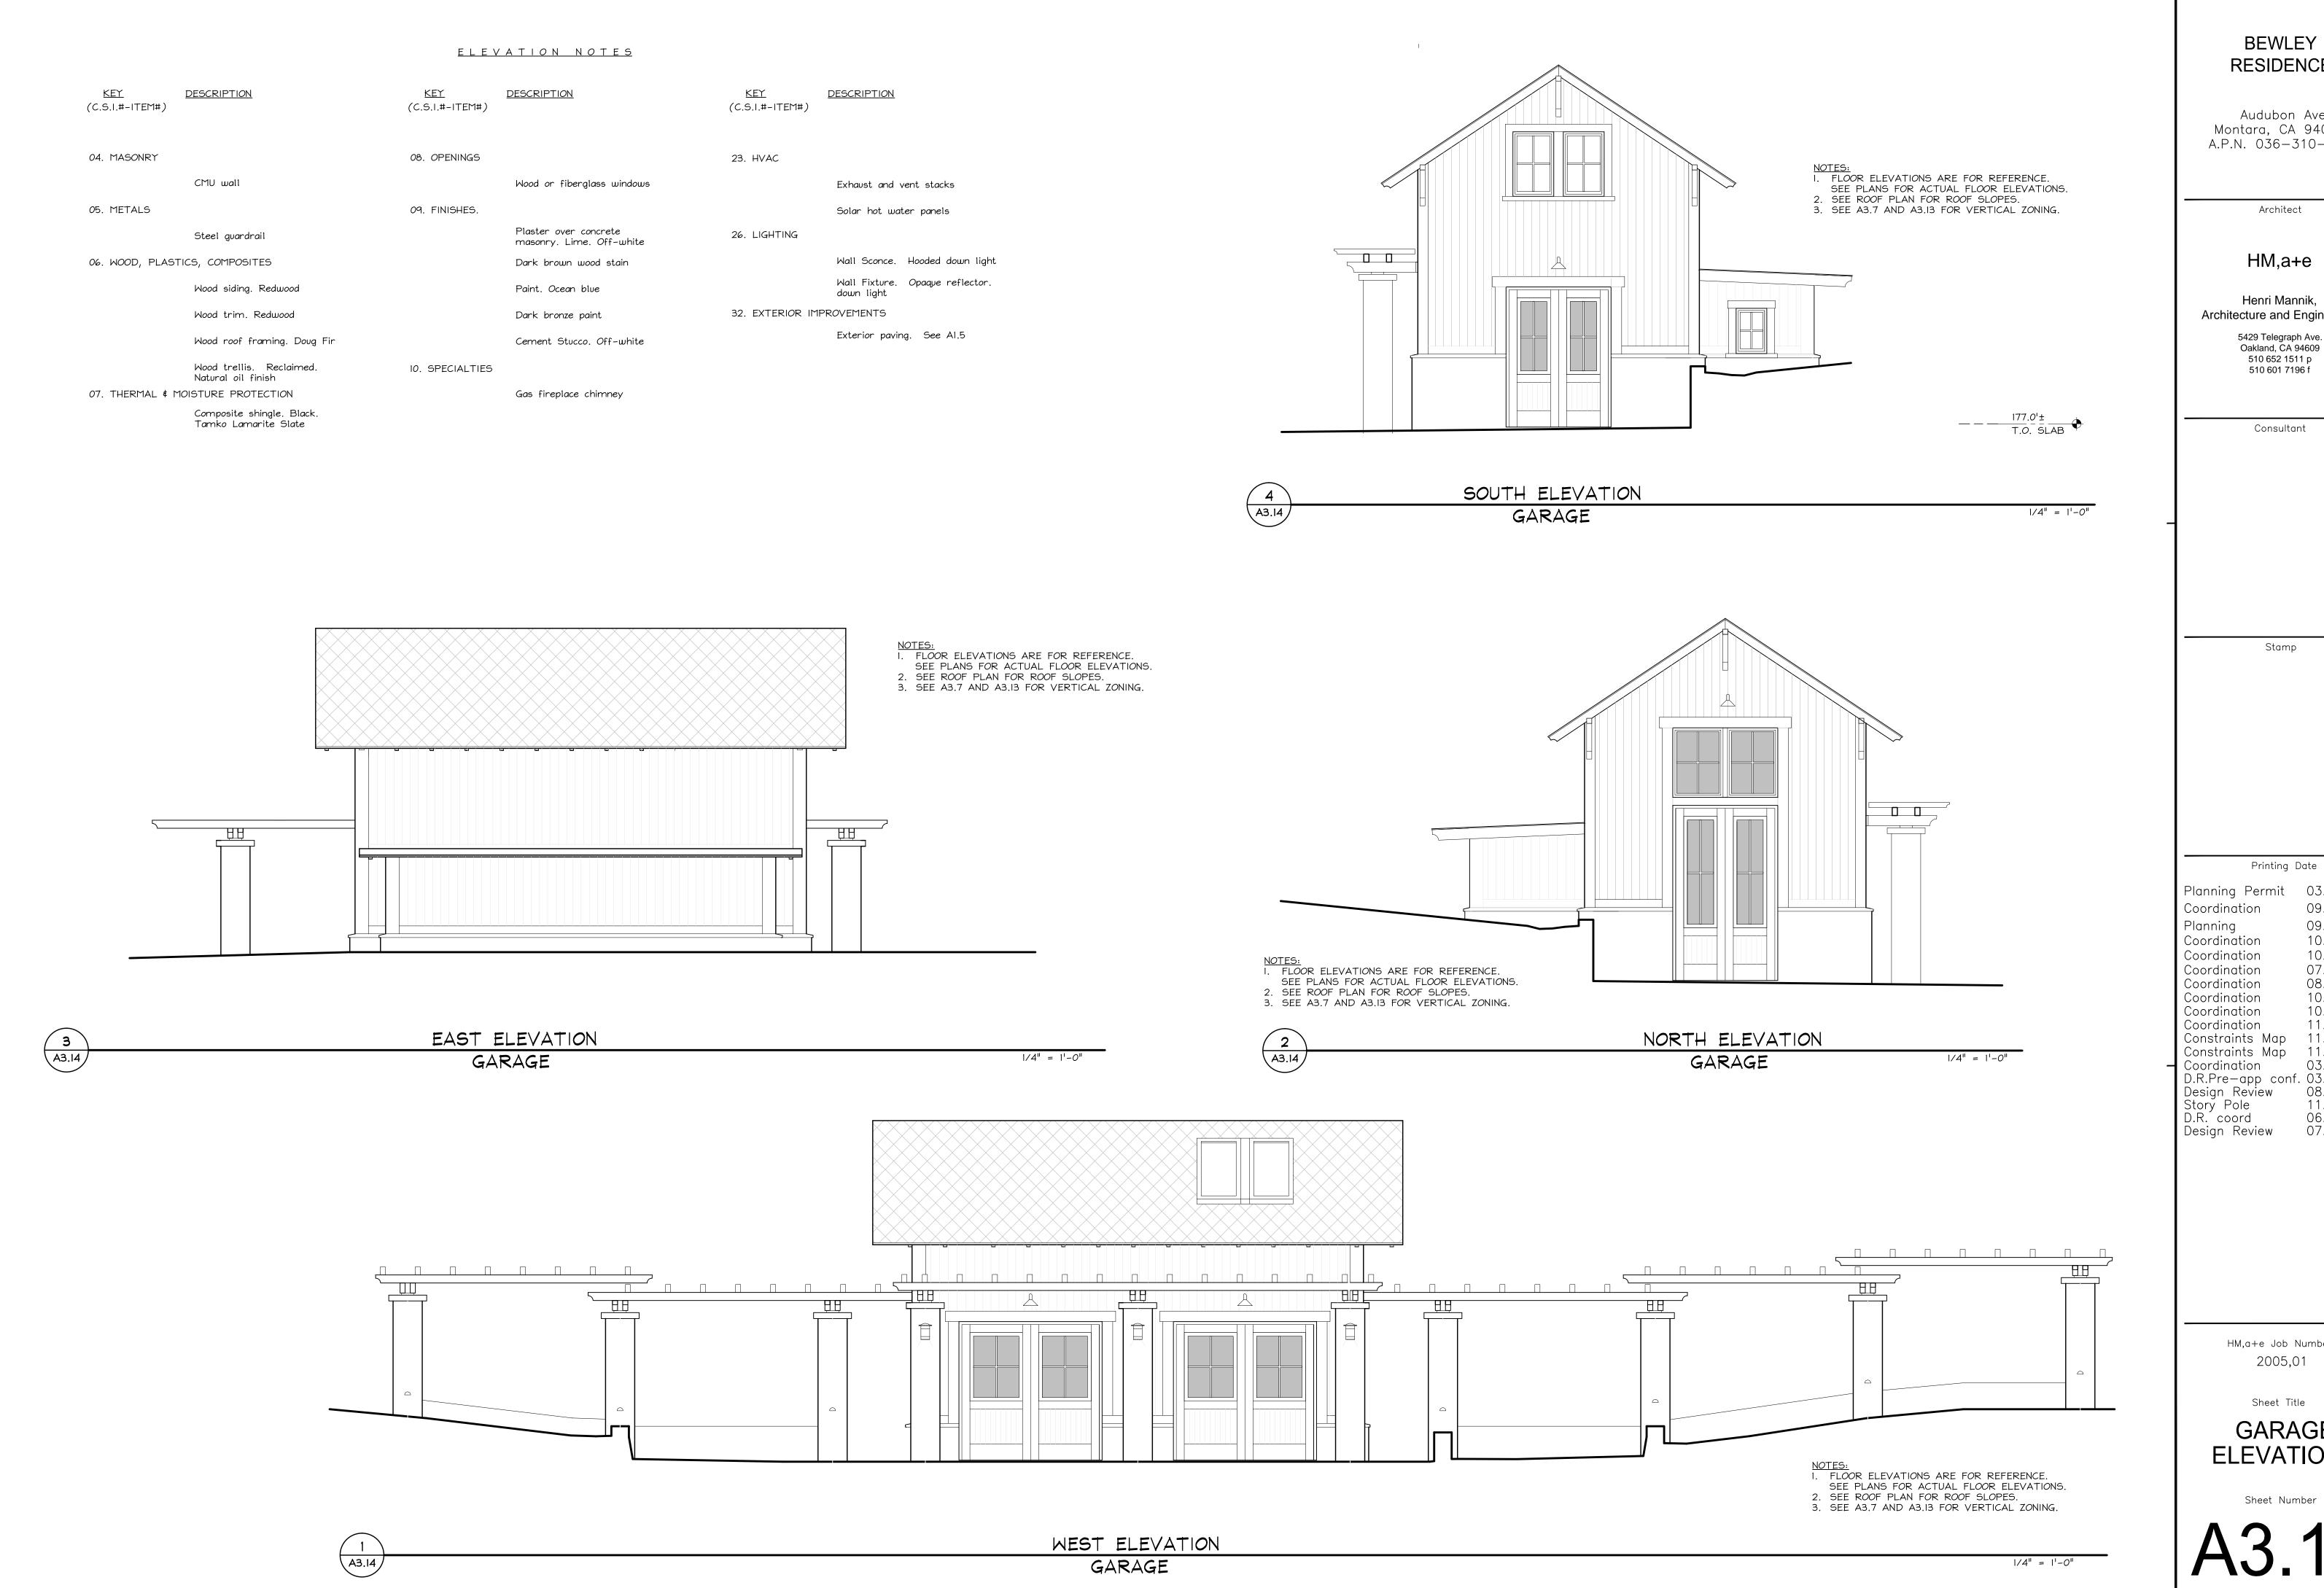

BEWLEY RESIDENCE

Audubon Ave. Montara, CA 94037 A.P.N. 036-310-180

Henri Mannik, Architecture and Engineering

> 5429 Telegraph Ave. Oakland, CA 94609 510 652 1511 p 510 601 7196 f

> > Consultant

Stamp

Planning Permit 03.18.2010 09.12.2011 09.13.2011 10.05.2011 10.11.2011 07.19.2013 08.08.2013 10.07.2013 10.21.2013 11.05.2013 Constraints Map 11.07.2013 Constraints Map 11.25.2013 Coordination 03.19.2014
D.R.Pre—app conf. 03.26.2014
Design Review 08.12.2014
Story Pole 11.14.2014
D.R. coord 06.08.2015 07.10.2015


> HM,a+e Job Number 2005,01


GARAGE **ELEVATIONS**


Sheet Number

<u>ELEVATION NOTES</u>

| | | <u> </u> | ATTON NOTES | | |
|-------------------------------|---|-------------------------------|---|-------------------------------|---|
| <u>KEY</u> (C.S.I.#-ITEM#) | <u>DESCRIPTION</u> | <u>KEY</u> (C.S.I.#-ITEM#) | DESCRIPTION | <u>KEY</u> (C.S.I.#-ITEM#) | <u>DESCRIPTION</u> |
| 04. MASONRY | | 08. OPENINGS | | 23. HVAC | |
| | CMU wall | | Wood or fiberglass windows | | Exhaust and vent stacks |
| 05. METALS | | 09. FINISHES. | | | Solar hot water panels |
| | Steel guardrail | | Plaster over concrete masonry. Lime. Off-white | 26. LIGHTING | |
| 06. WOOD, PLAST | ICS, COMPOSITES | | Dark brown wood stain | | Wall Sconce. Hooded down light |
| | Wood siding. Redwood | | Paint. Ocean blue | | Wall Fixture. Opaque reflector. down light |
| | Wood trim. Redwood | | Dark bronze paint | 32. EXTERIOR IMP | PROVEMENTS |
| | Wood roof framing. Doug Fir | | Cement Stucco. Off-white | | Exterior paving. See A1.5 |
| | Wood trellis. Reclaimed. Natural oil finish | 10. SPECIALTIES | | | |
| 07. THERMAL & MO | OISTURE PROTECTION | | Gas fireplace chimney | | |
| | Composite shingle. Black. Tamko Lamarite Slate | | | | |

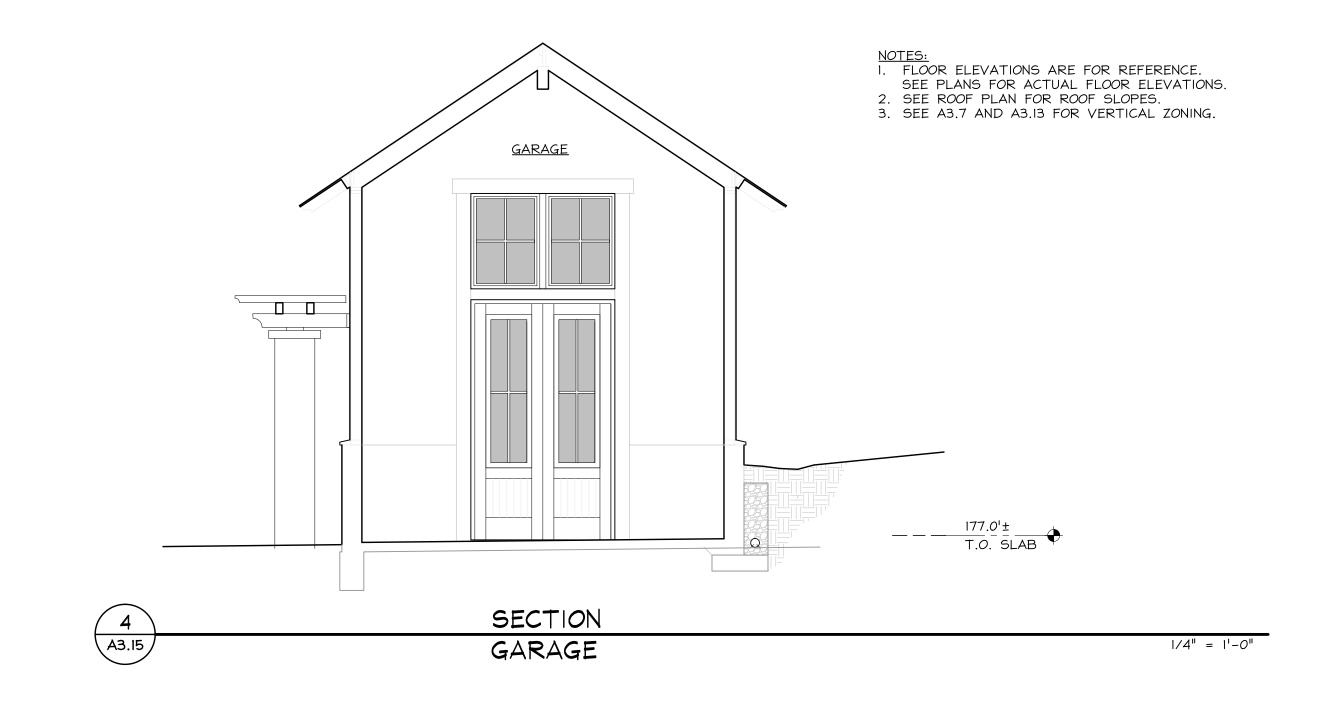

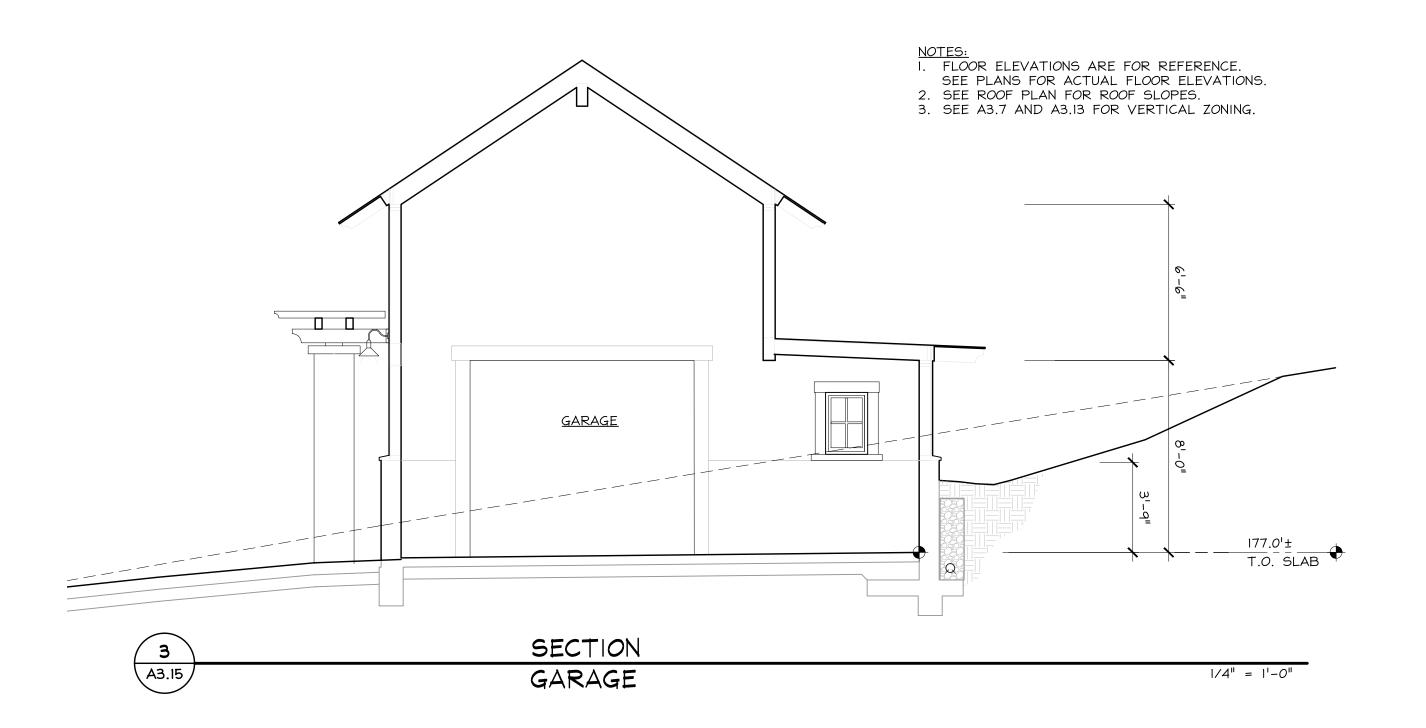

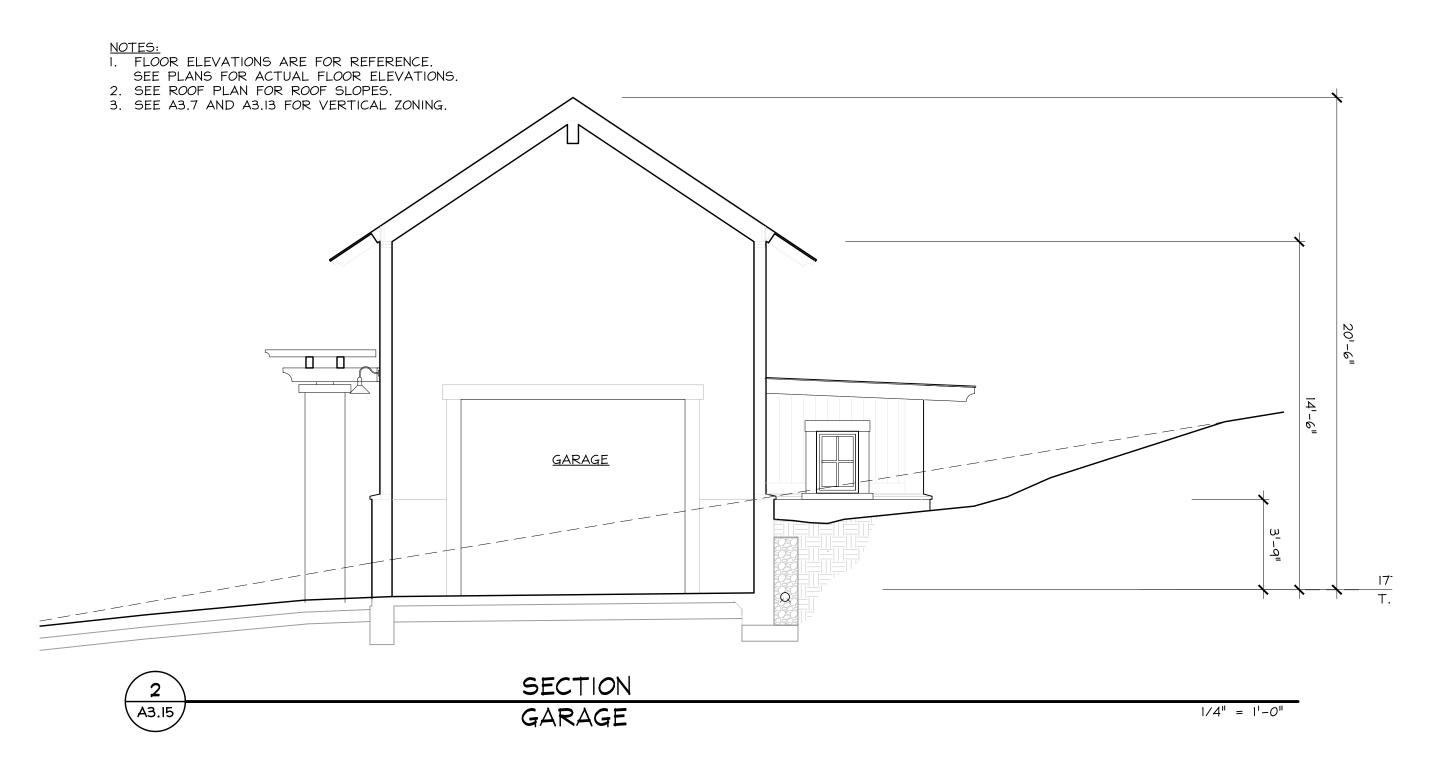

1/4" = 1'-0"

BEWLEY RESIDENCE

Project

Audubon Ave. Montara, CA 94037 A.P.N. 036-310-180

Architect

HM,a+e

Henri Mannik, Architecture and Engineering

> 5429 Telegraph Ave. Oakland, CA 94609 510 652 1511 p 510 601 7196 f

> > Consultant

Stamp

Printing Date

 Planning Permit
 03.18.2010

 Coordination
 09.12.2011

 Planning
 09.13.2011

 Coordination
 10.05.2011

 Coordination
 07.19.2013

 Coordination
 08.08.2013

 Coordination
 10.07.2013

 Coordination
 11.05.2013

 Constraints Map
 11.07.2013

 Constraints Map
 11.25.2013

 Coordination
 03.19.2014

 D.R.Pre-app conf.
 03.26.2014

 Design Review
 08.12.2014

 Story Pole
 11.14.2014

 D.R. coord
 06.08.2015

 Design Review
 07.10.2015

HM,a+e Job Number 2005,01


Sheet Title
GARAGE
ELEVATIONS


Sheet Number


A3.15


1 A3.14 NOT USED


1-A3-15.dwg Plot Date: 7.20.20

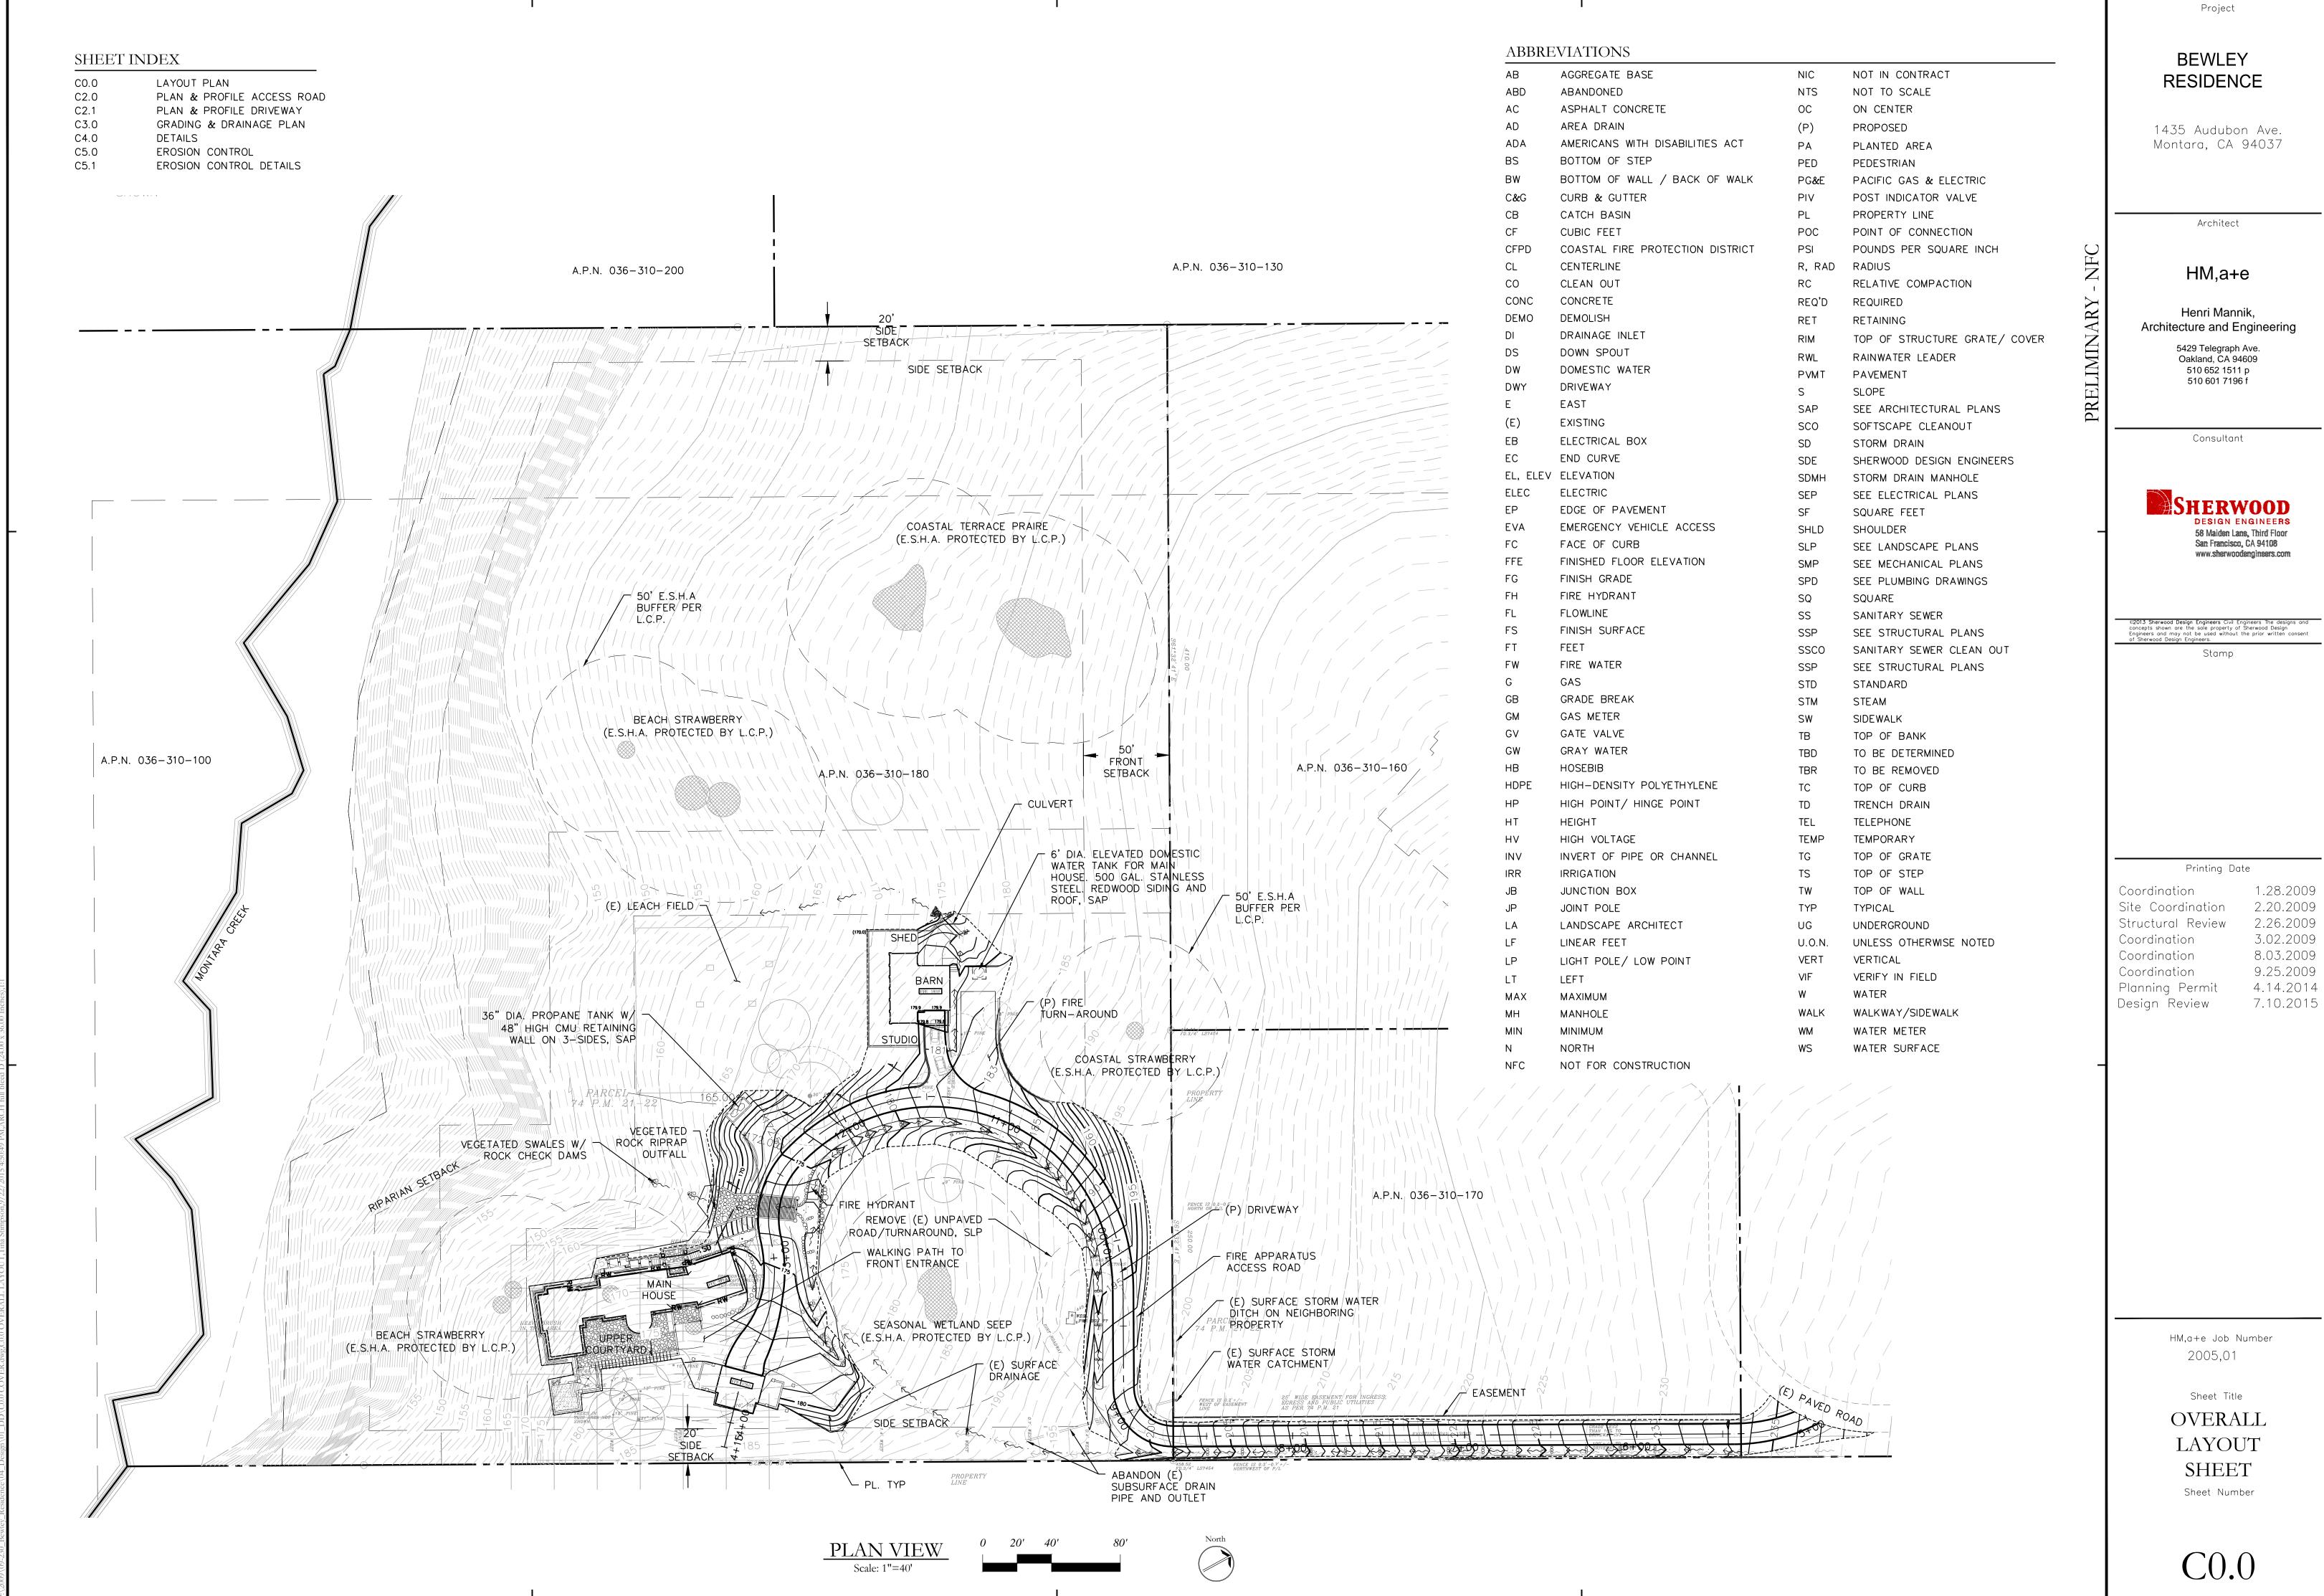


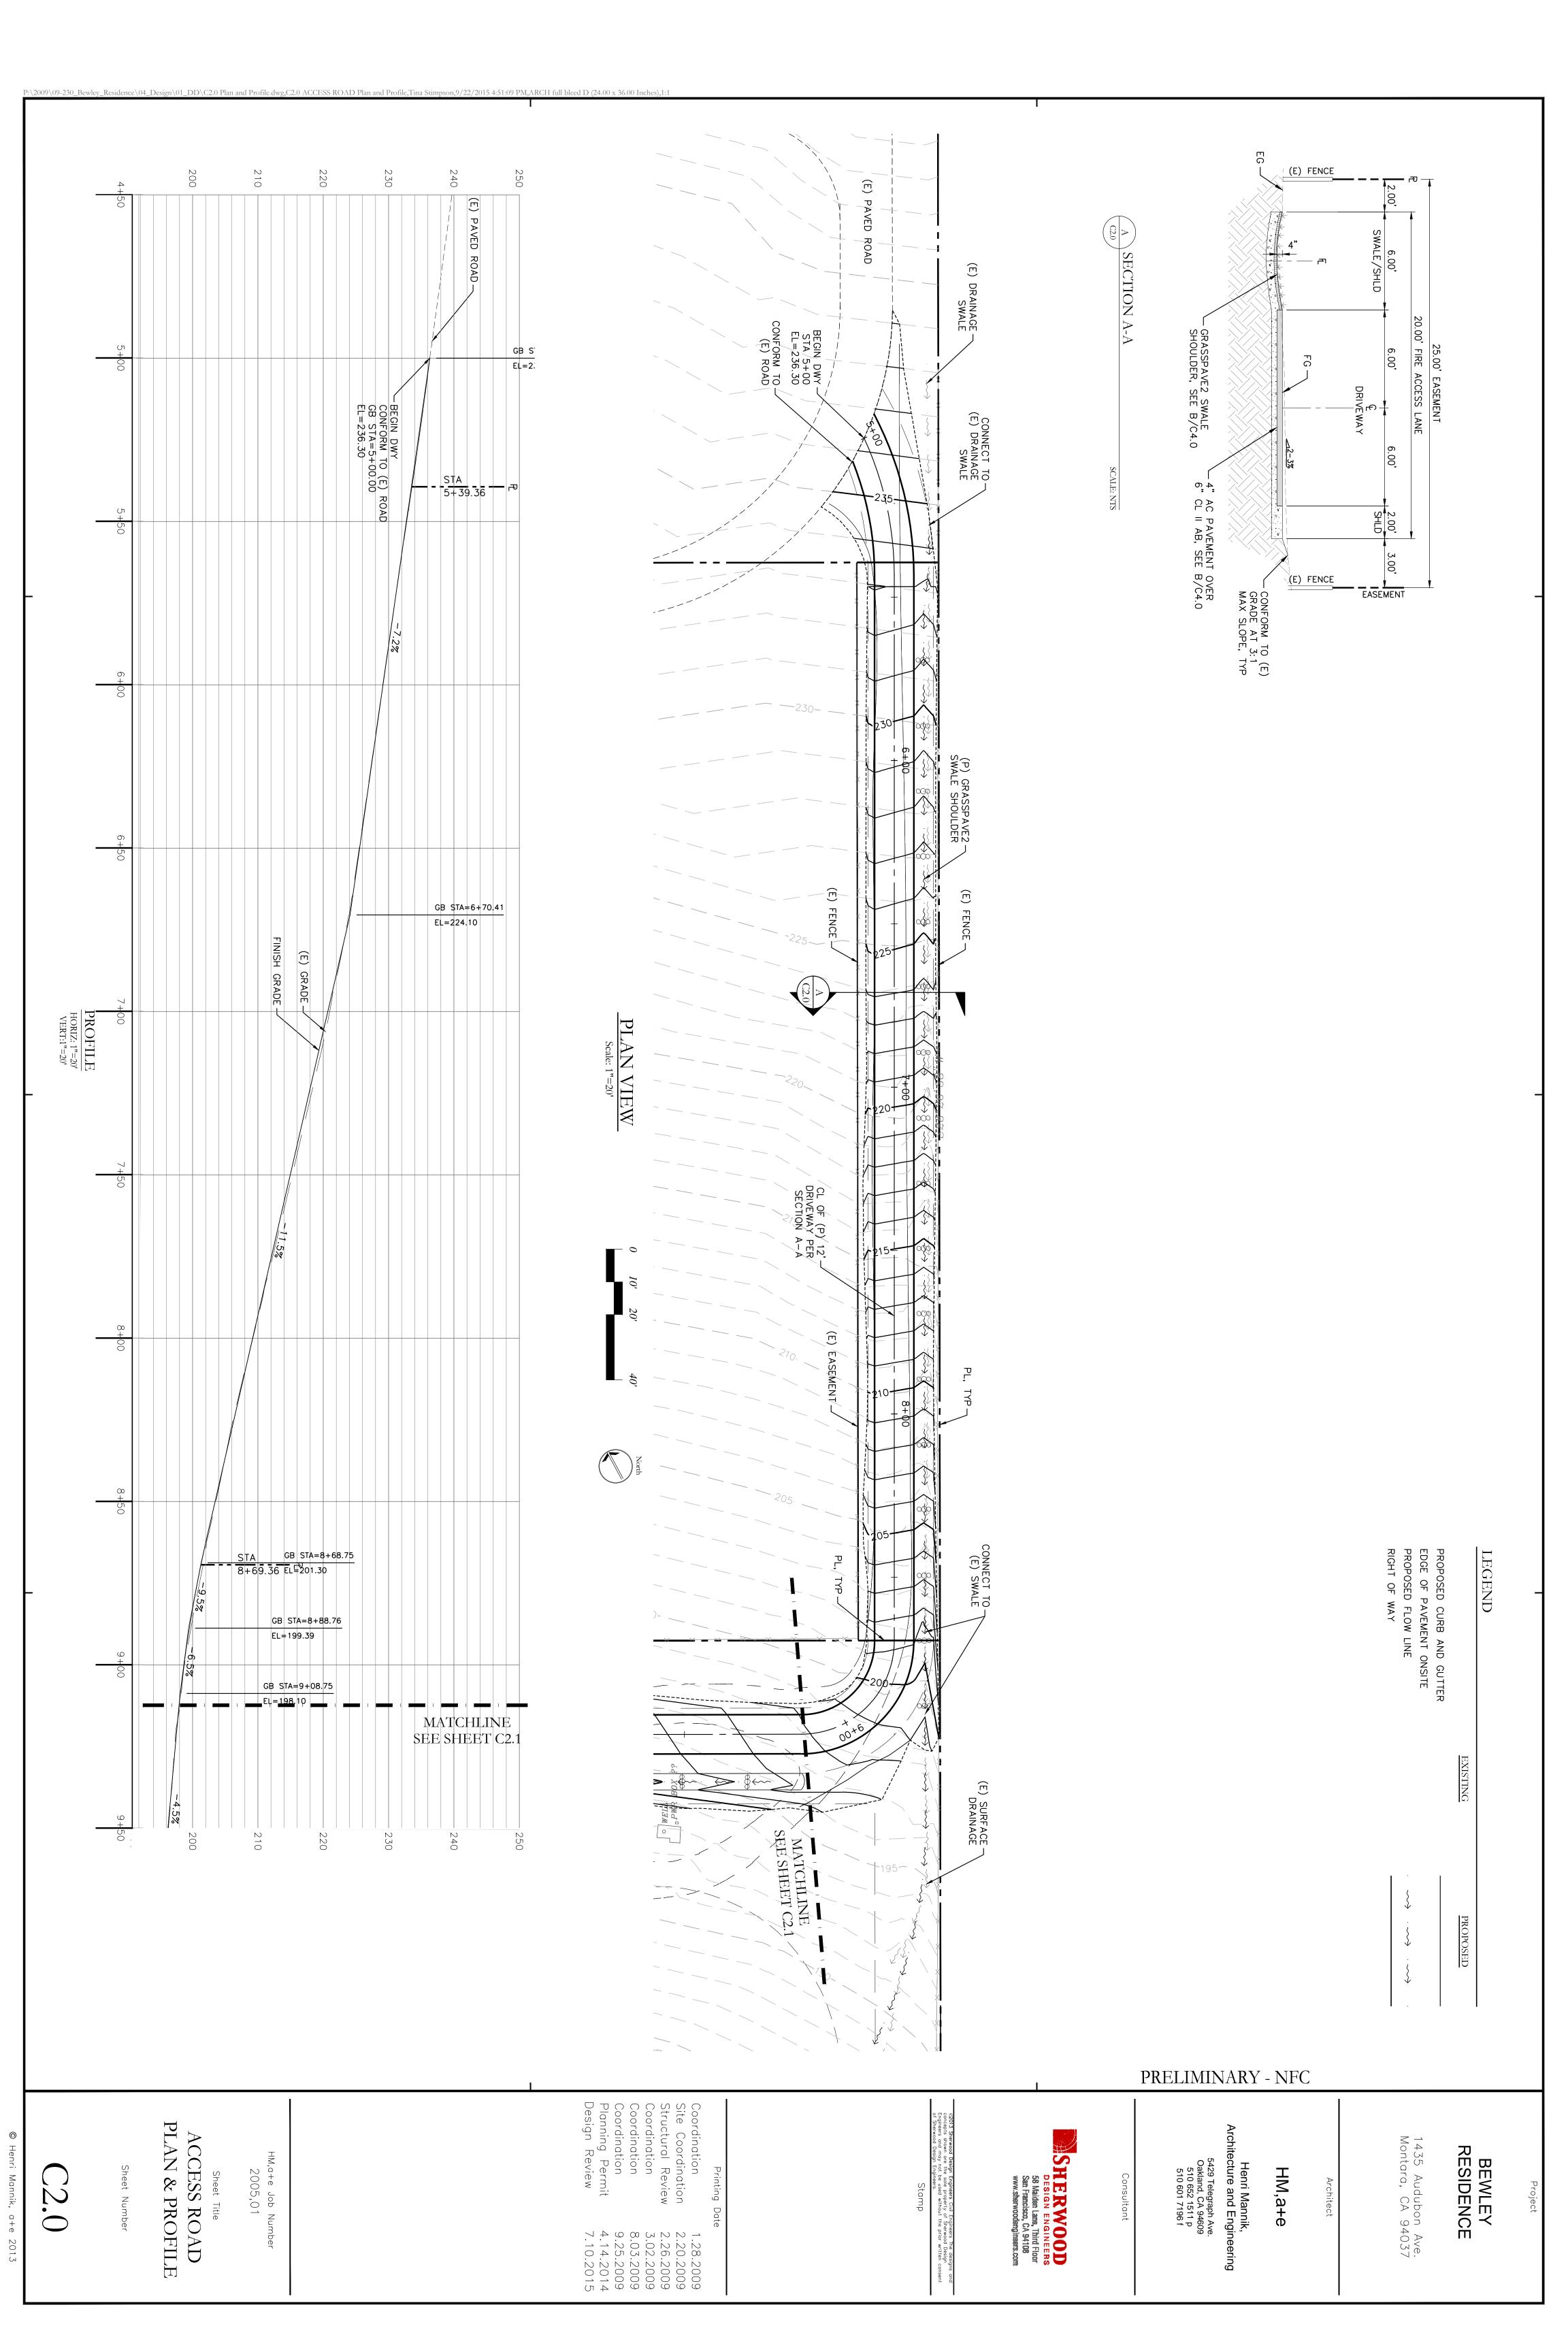


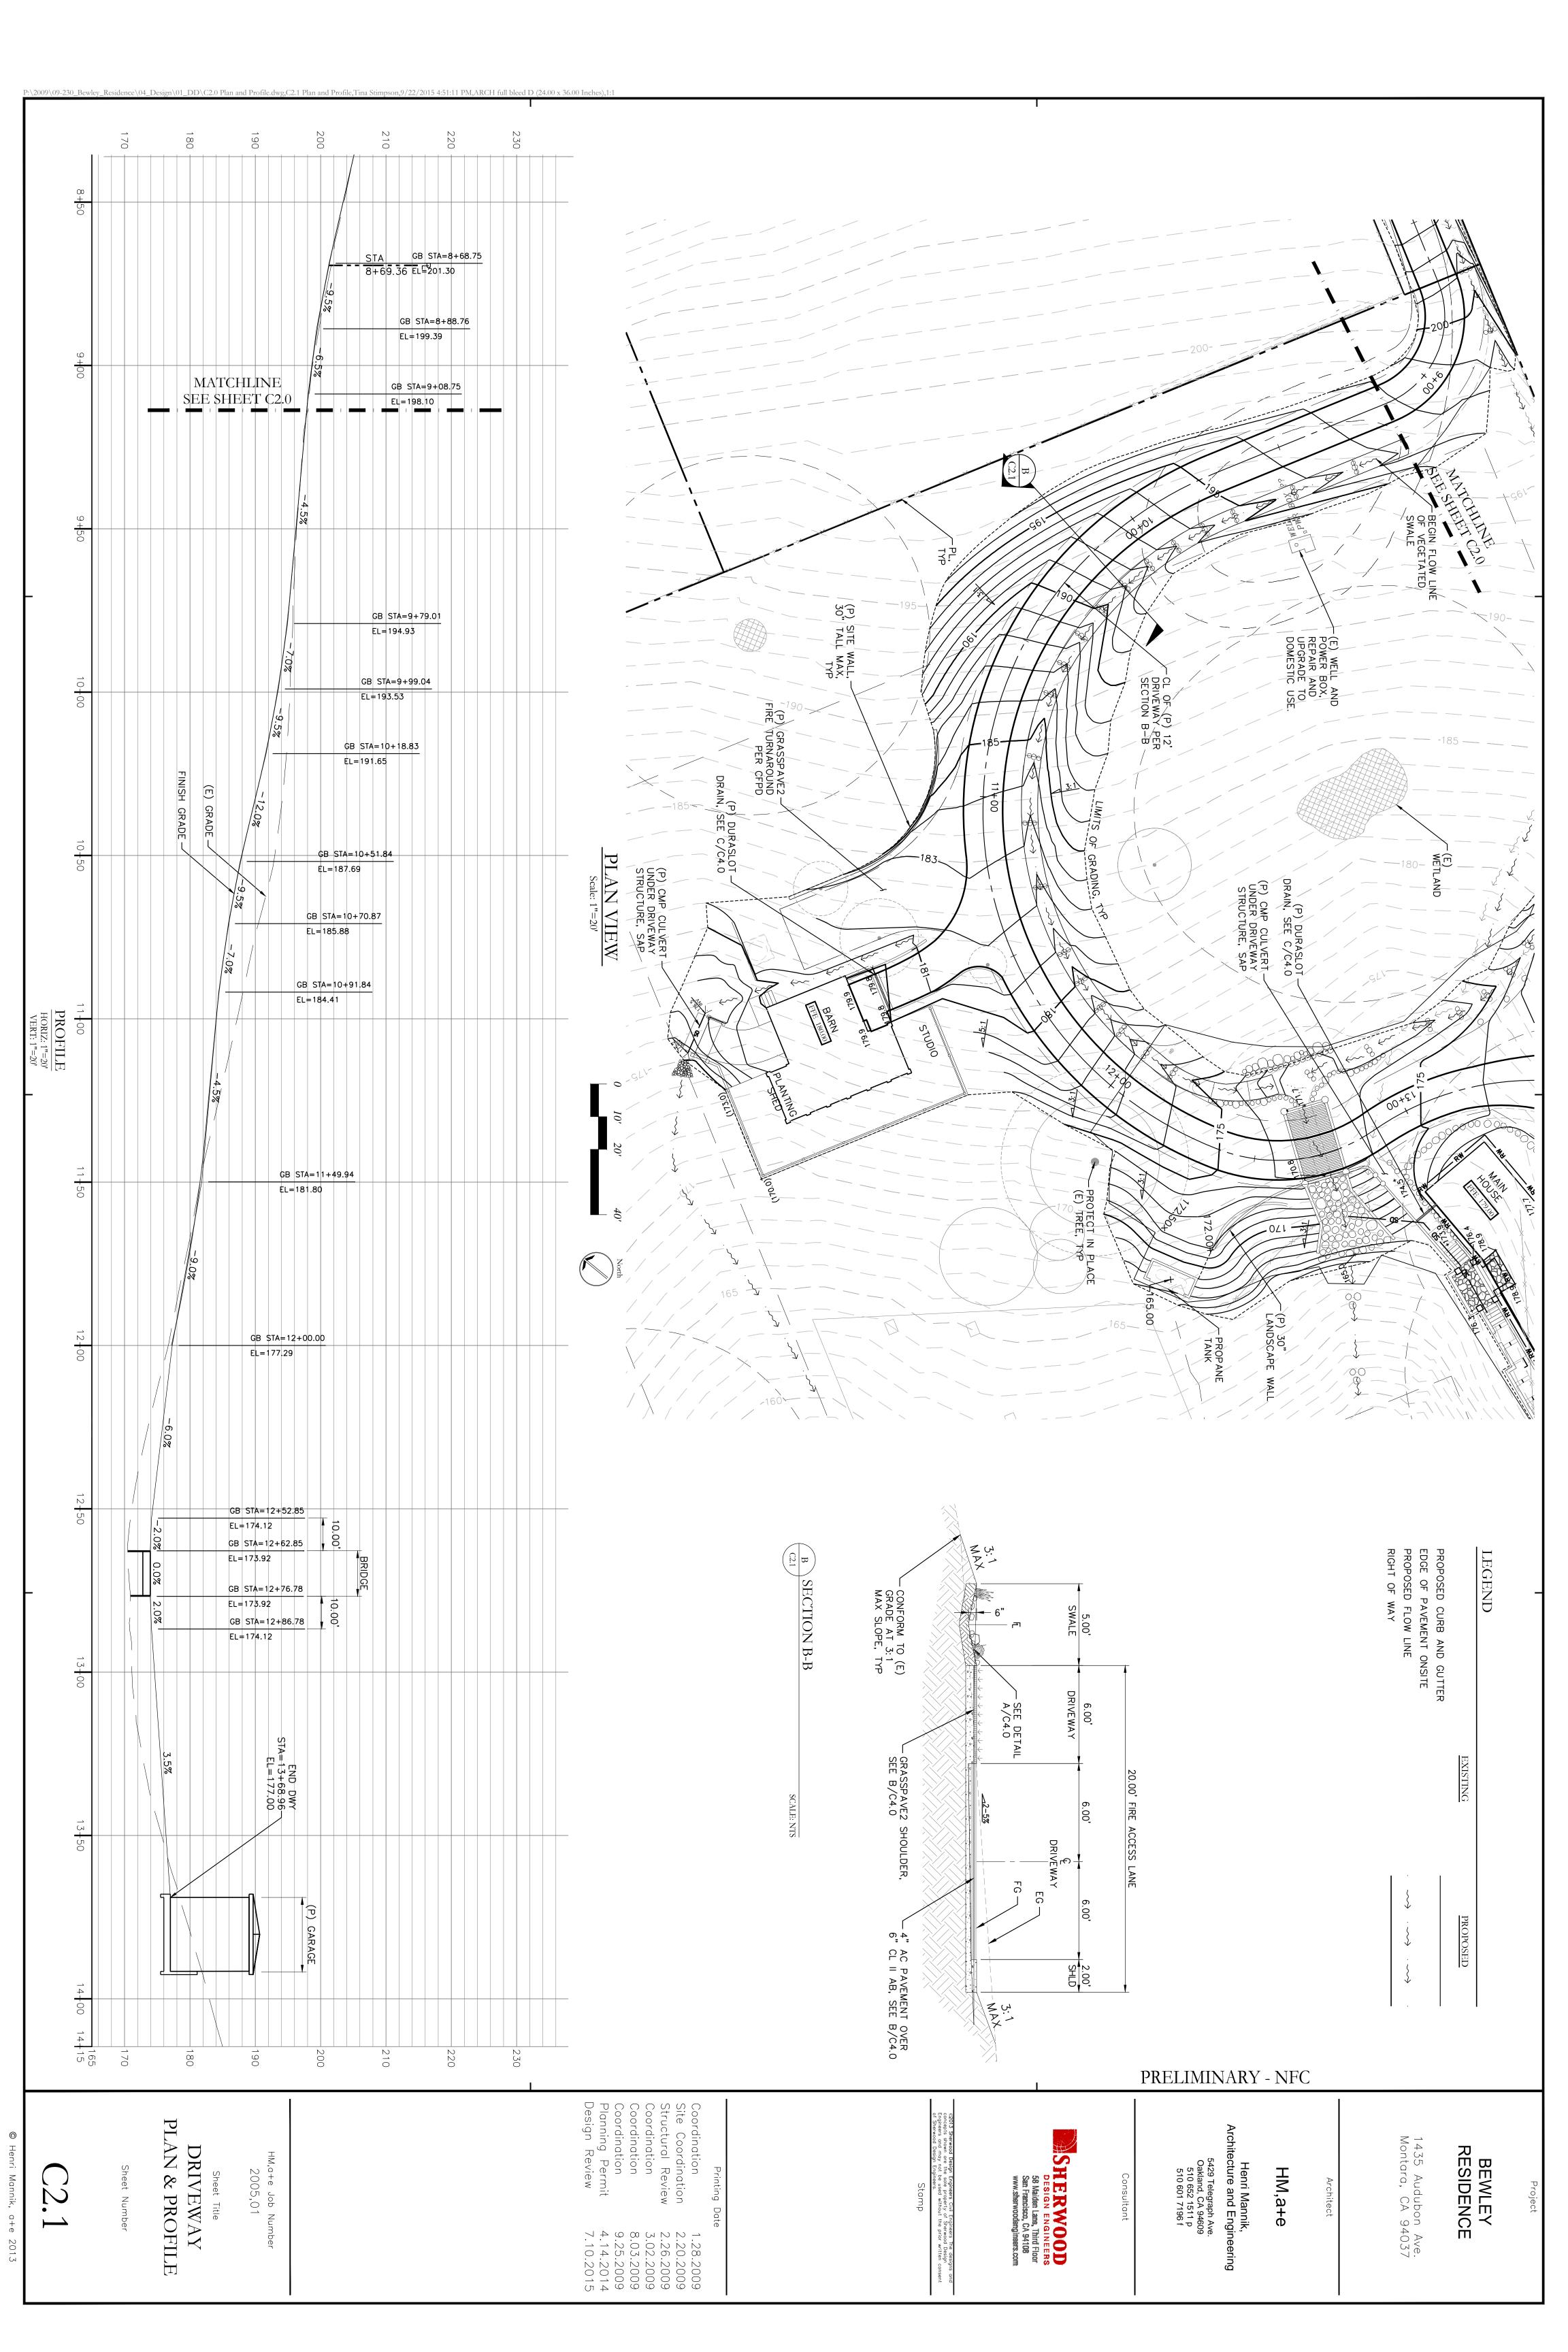

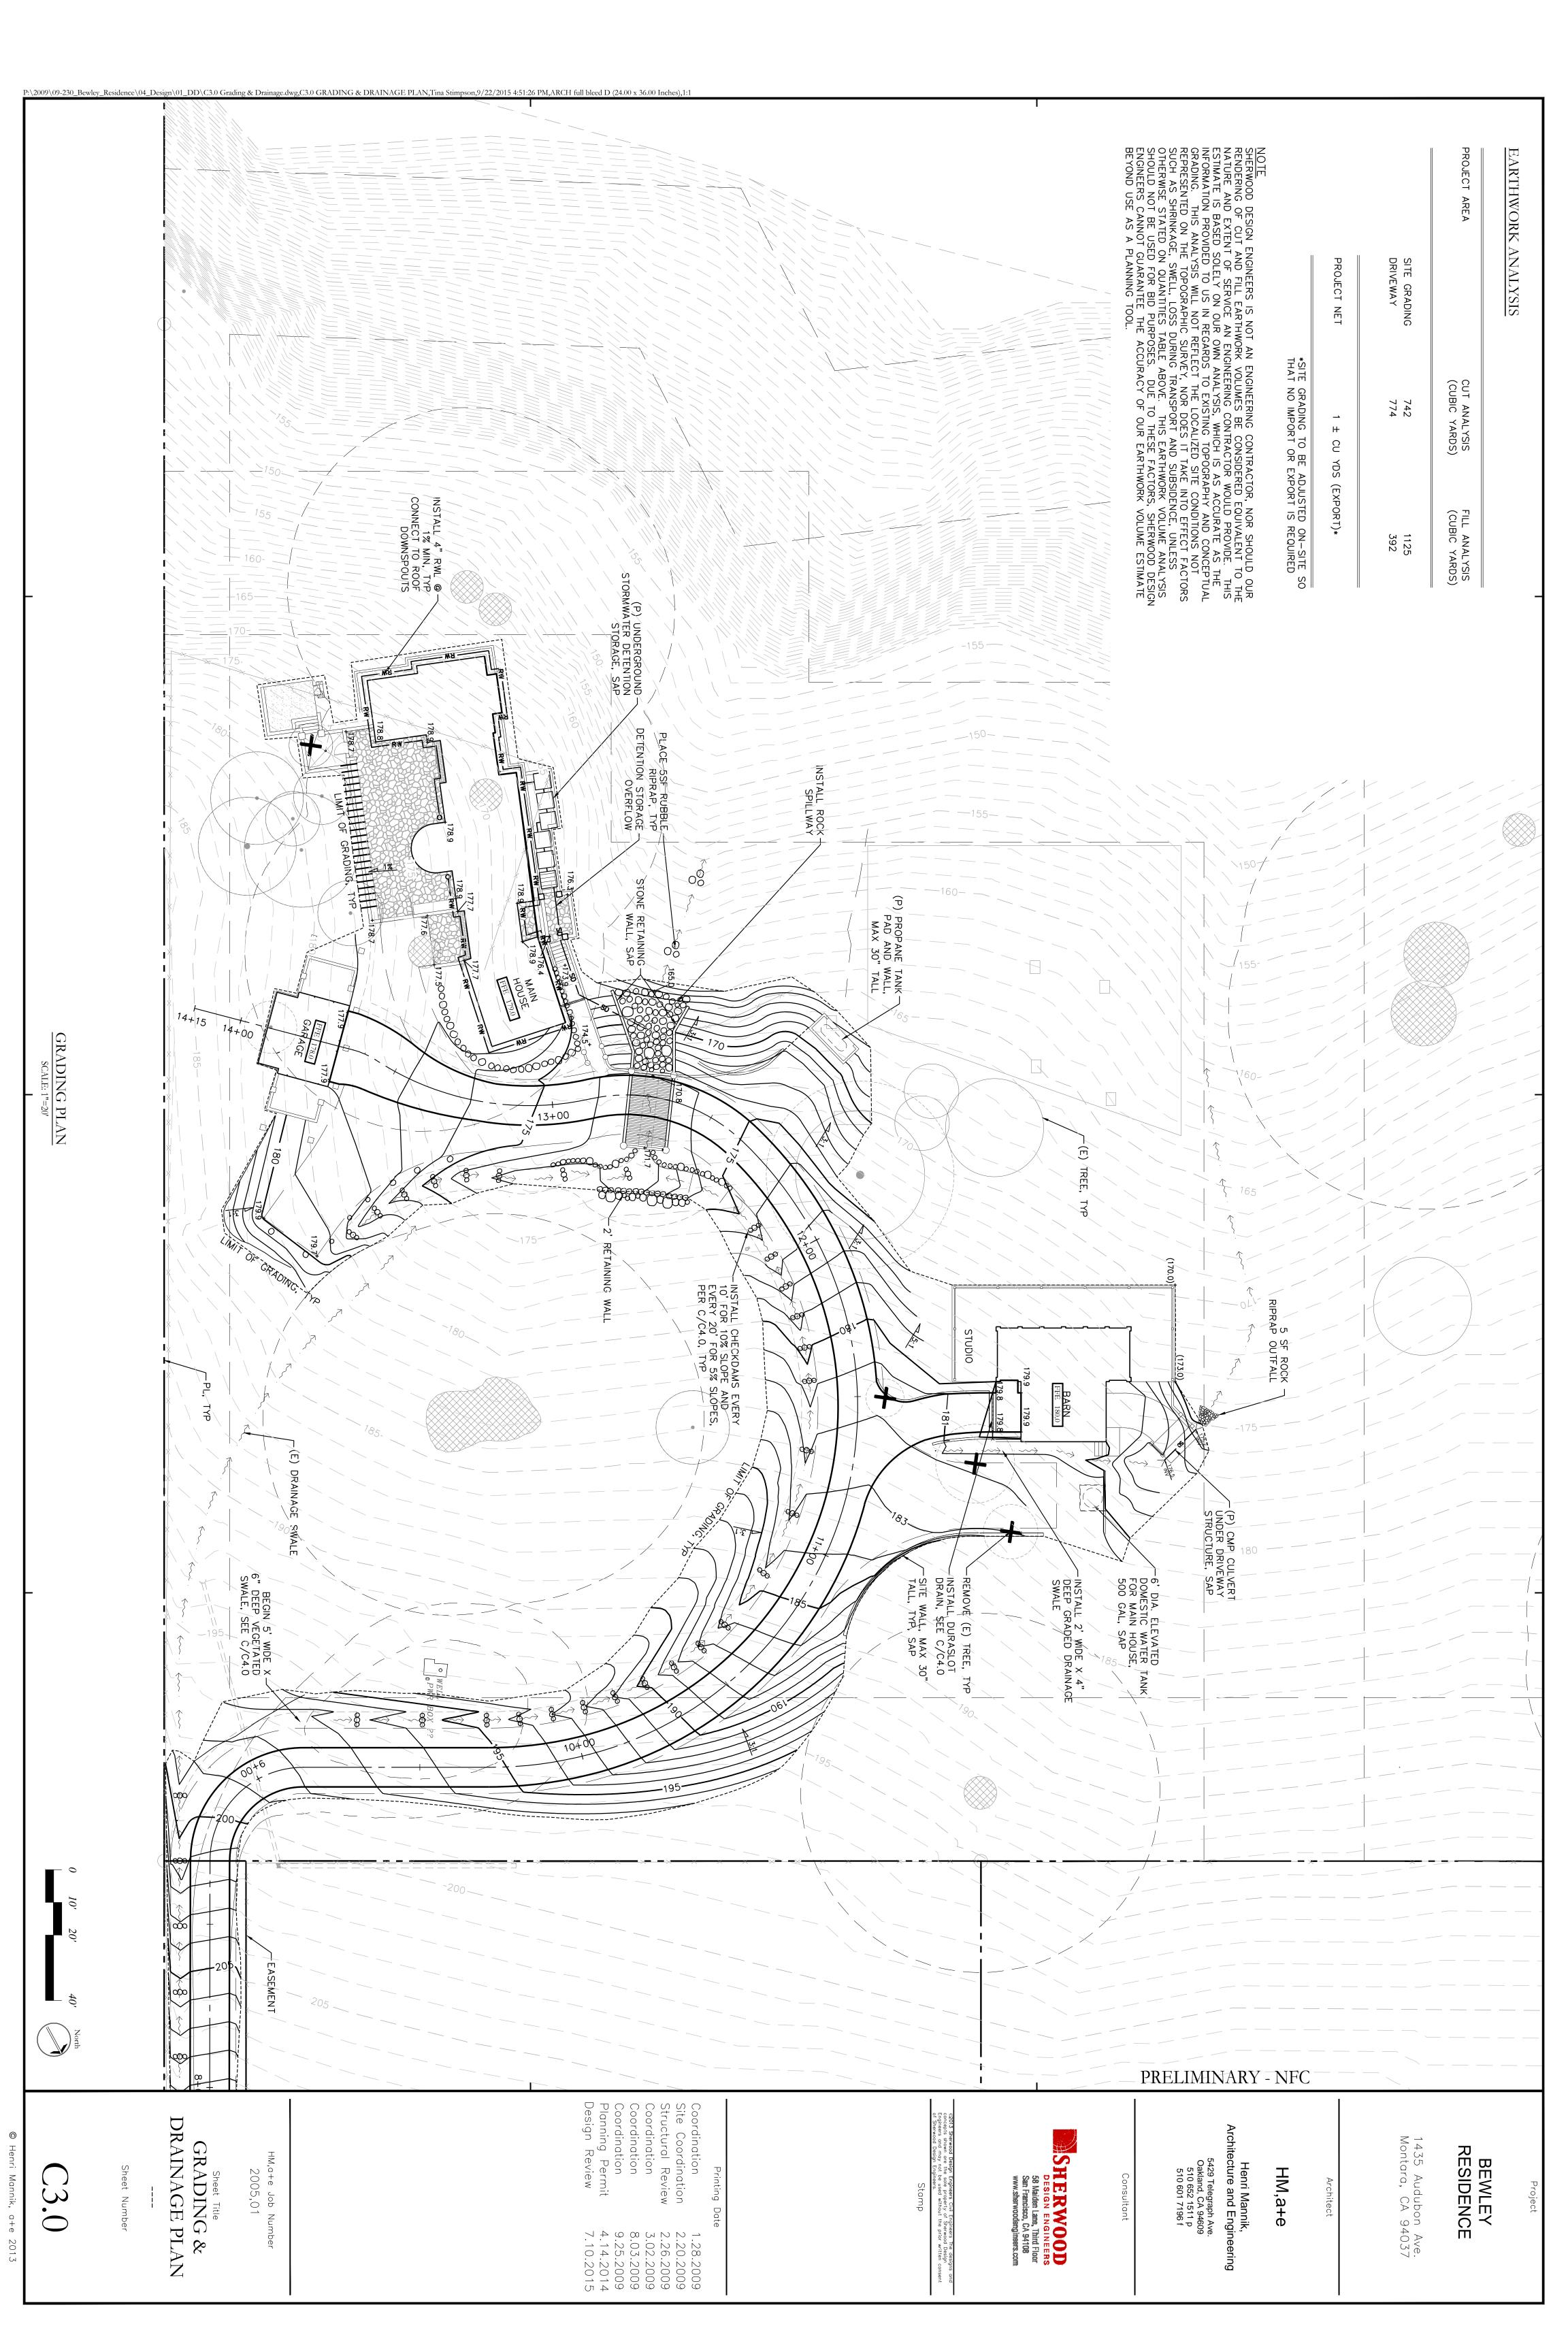

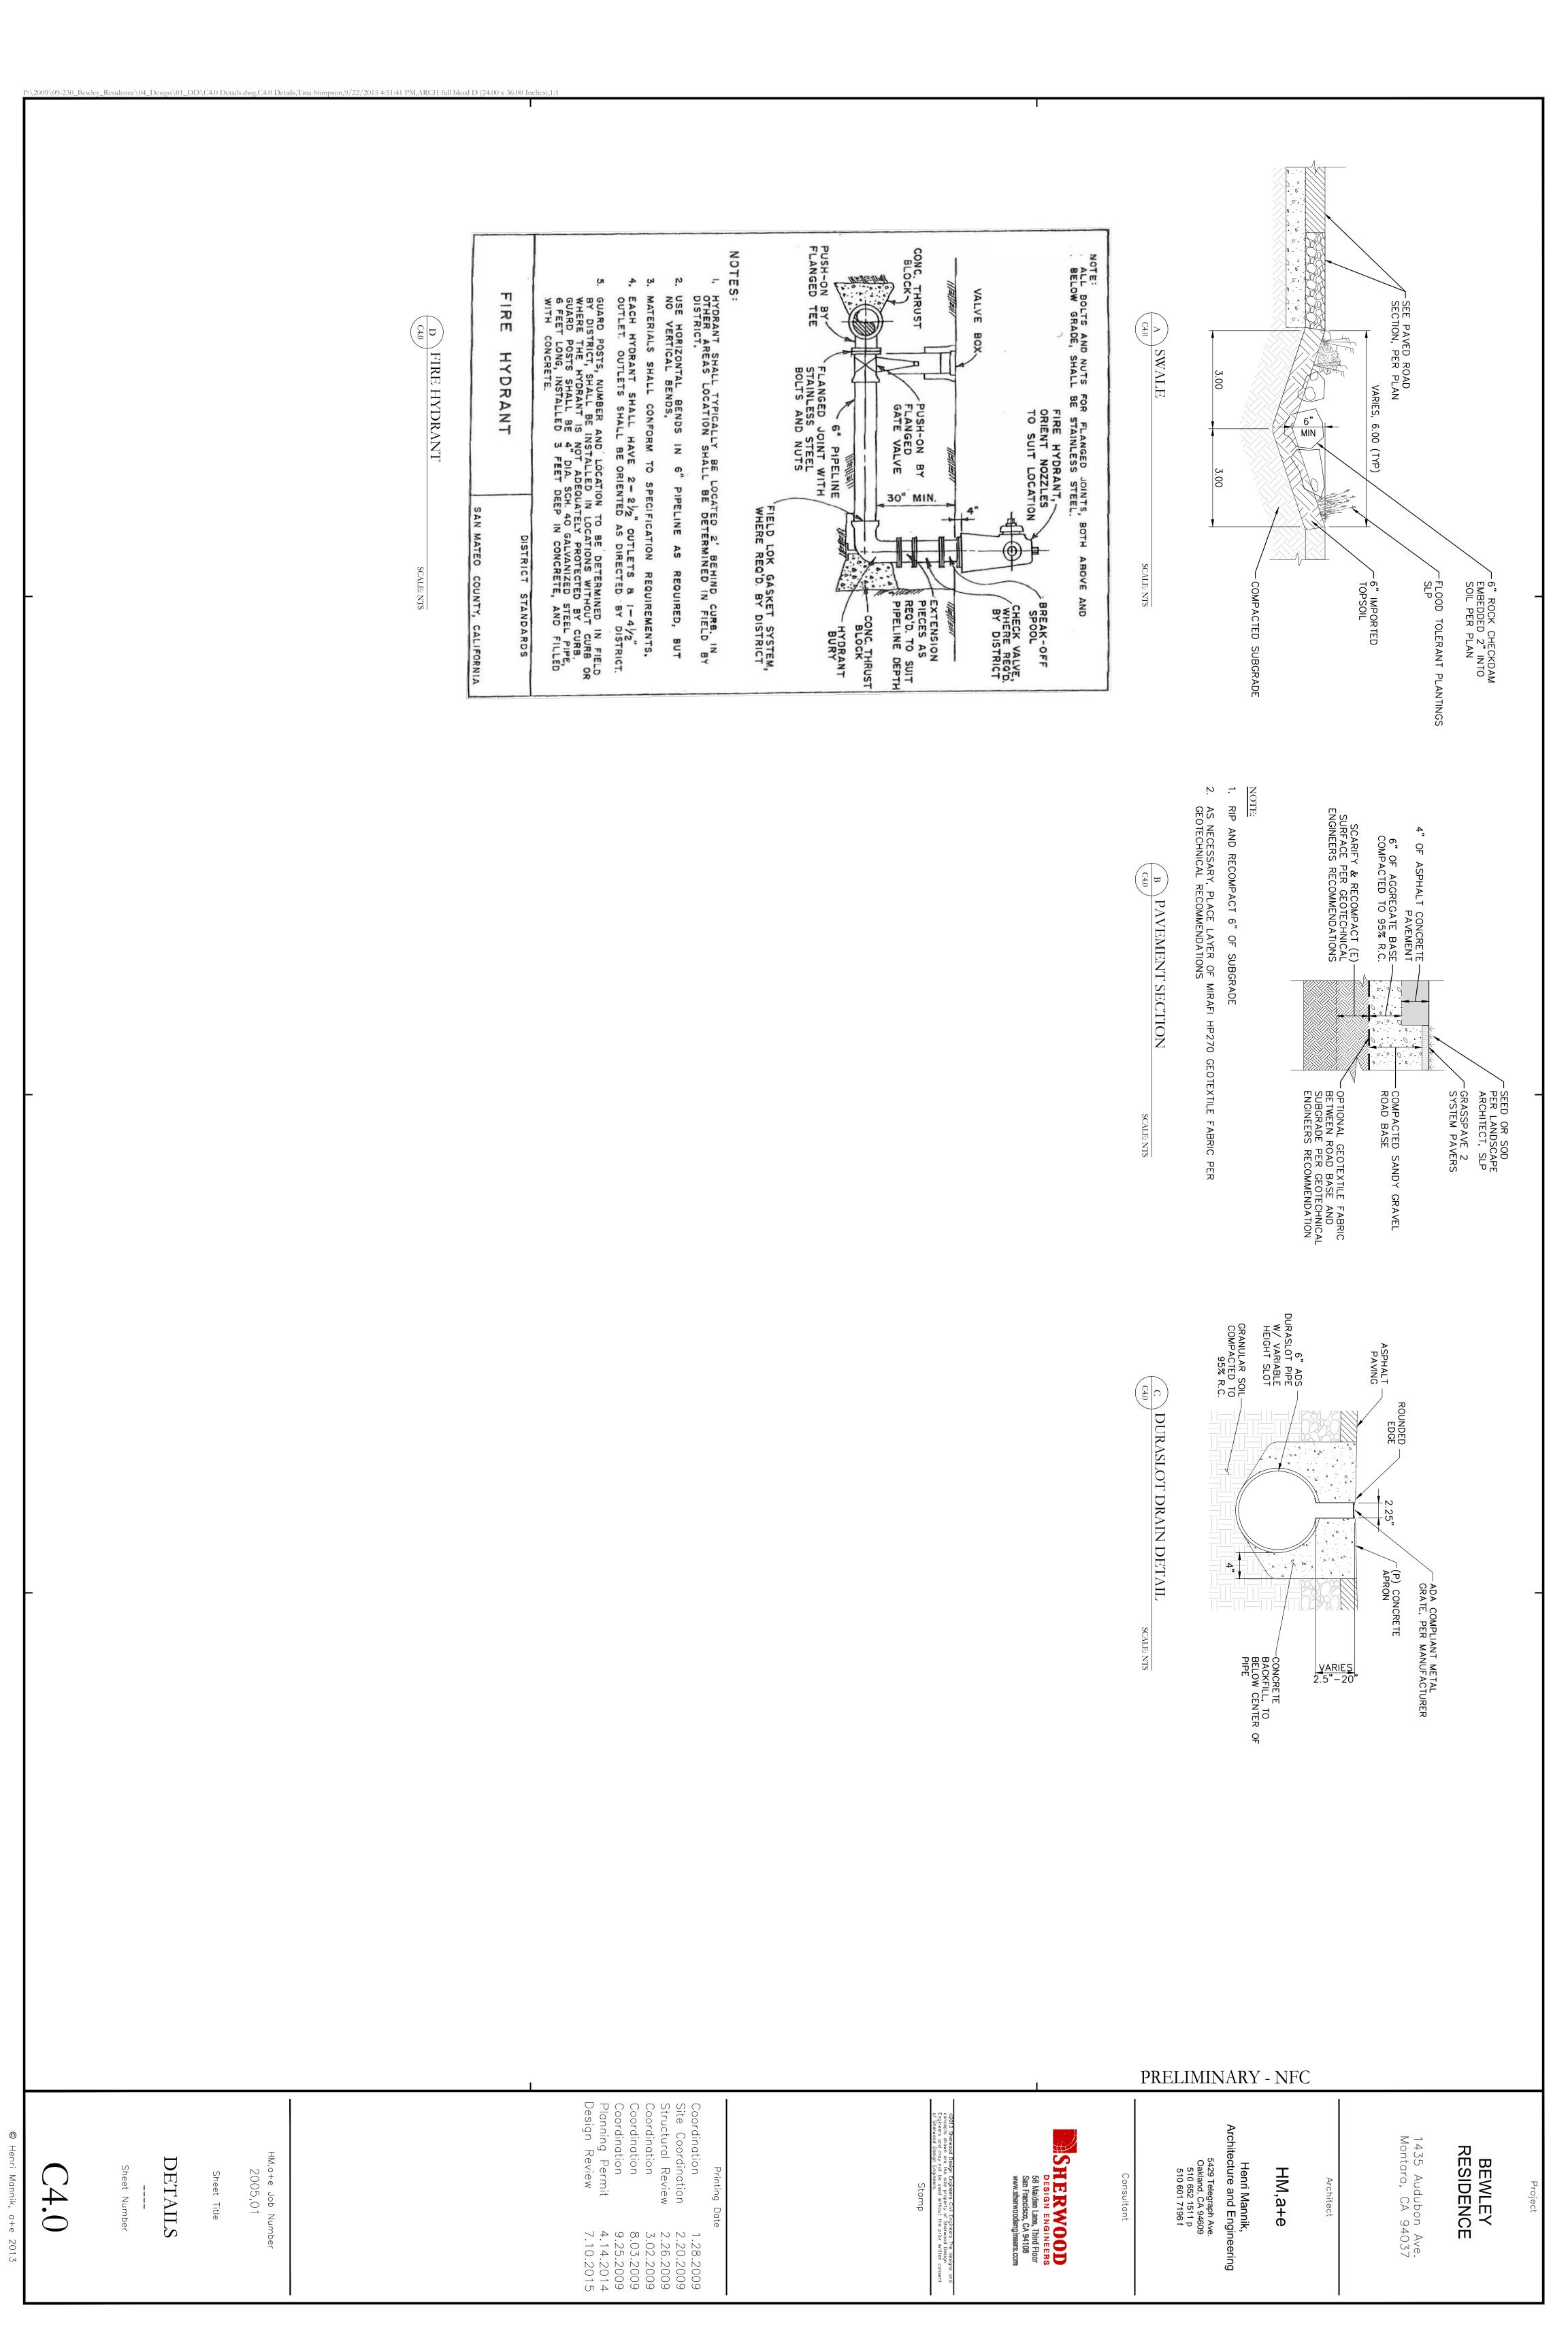

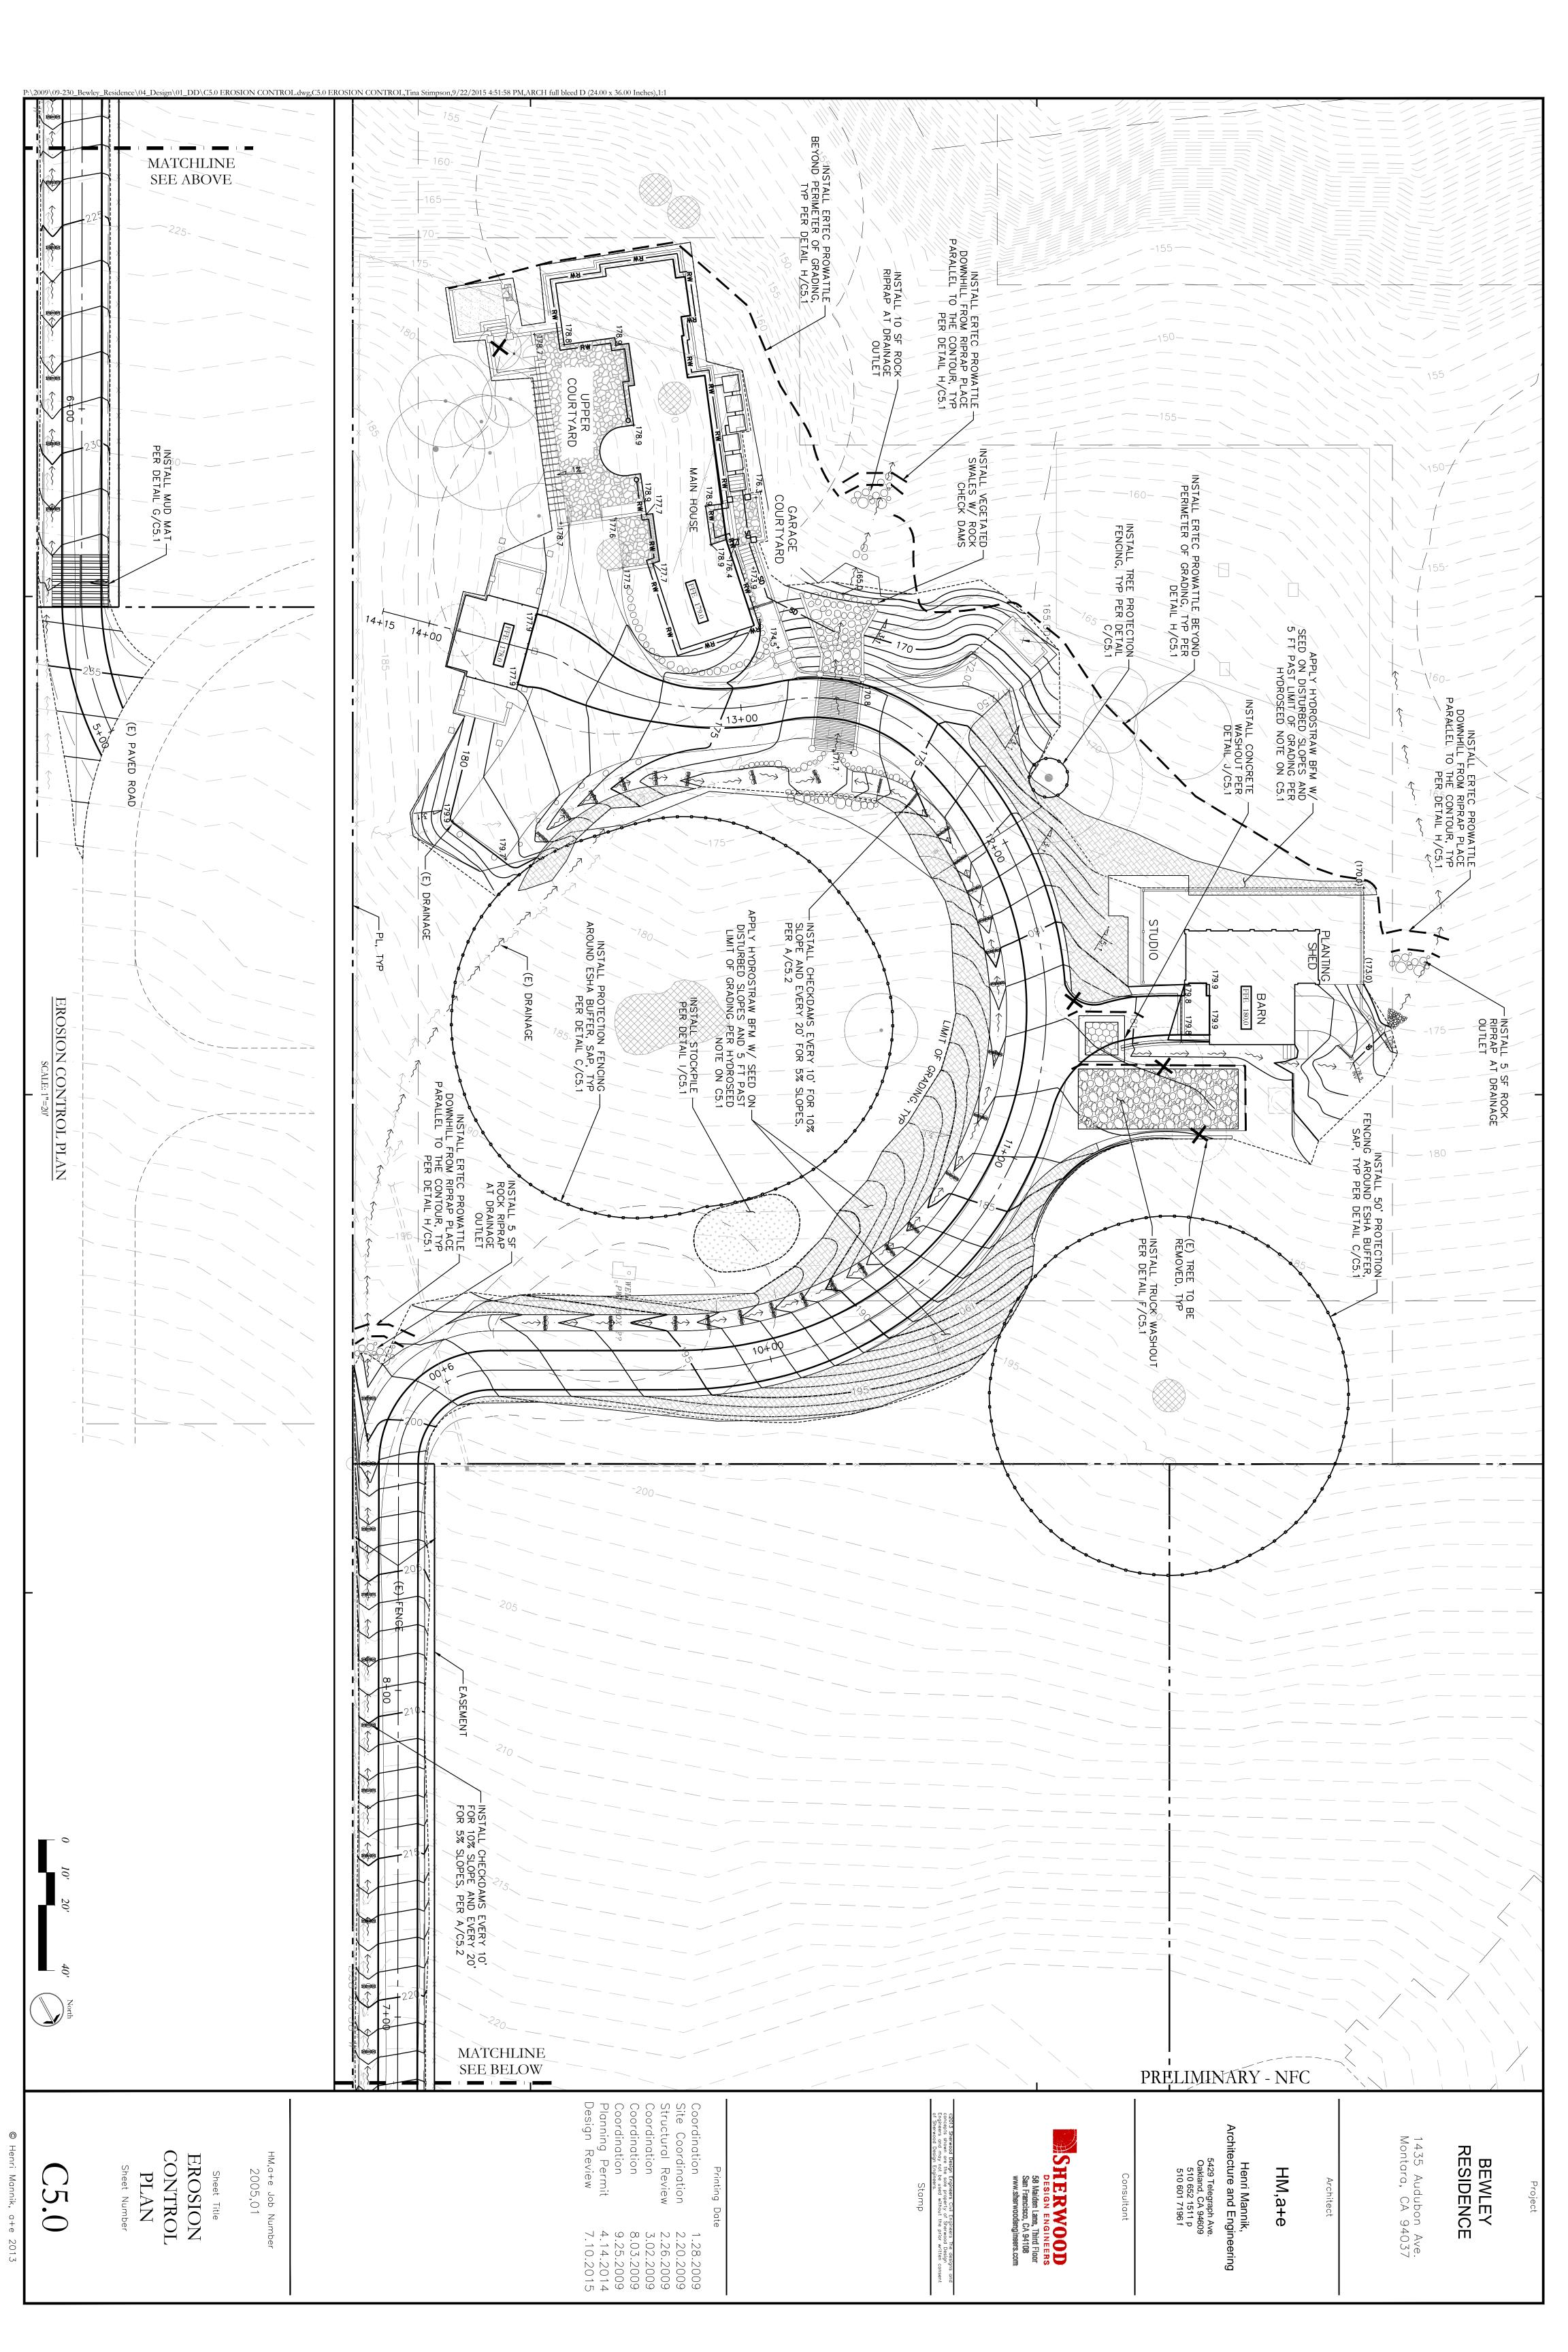

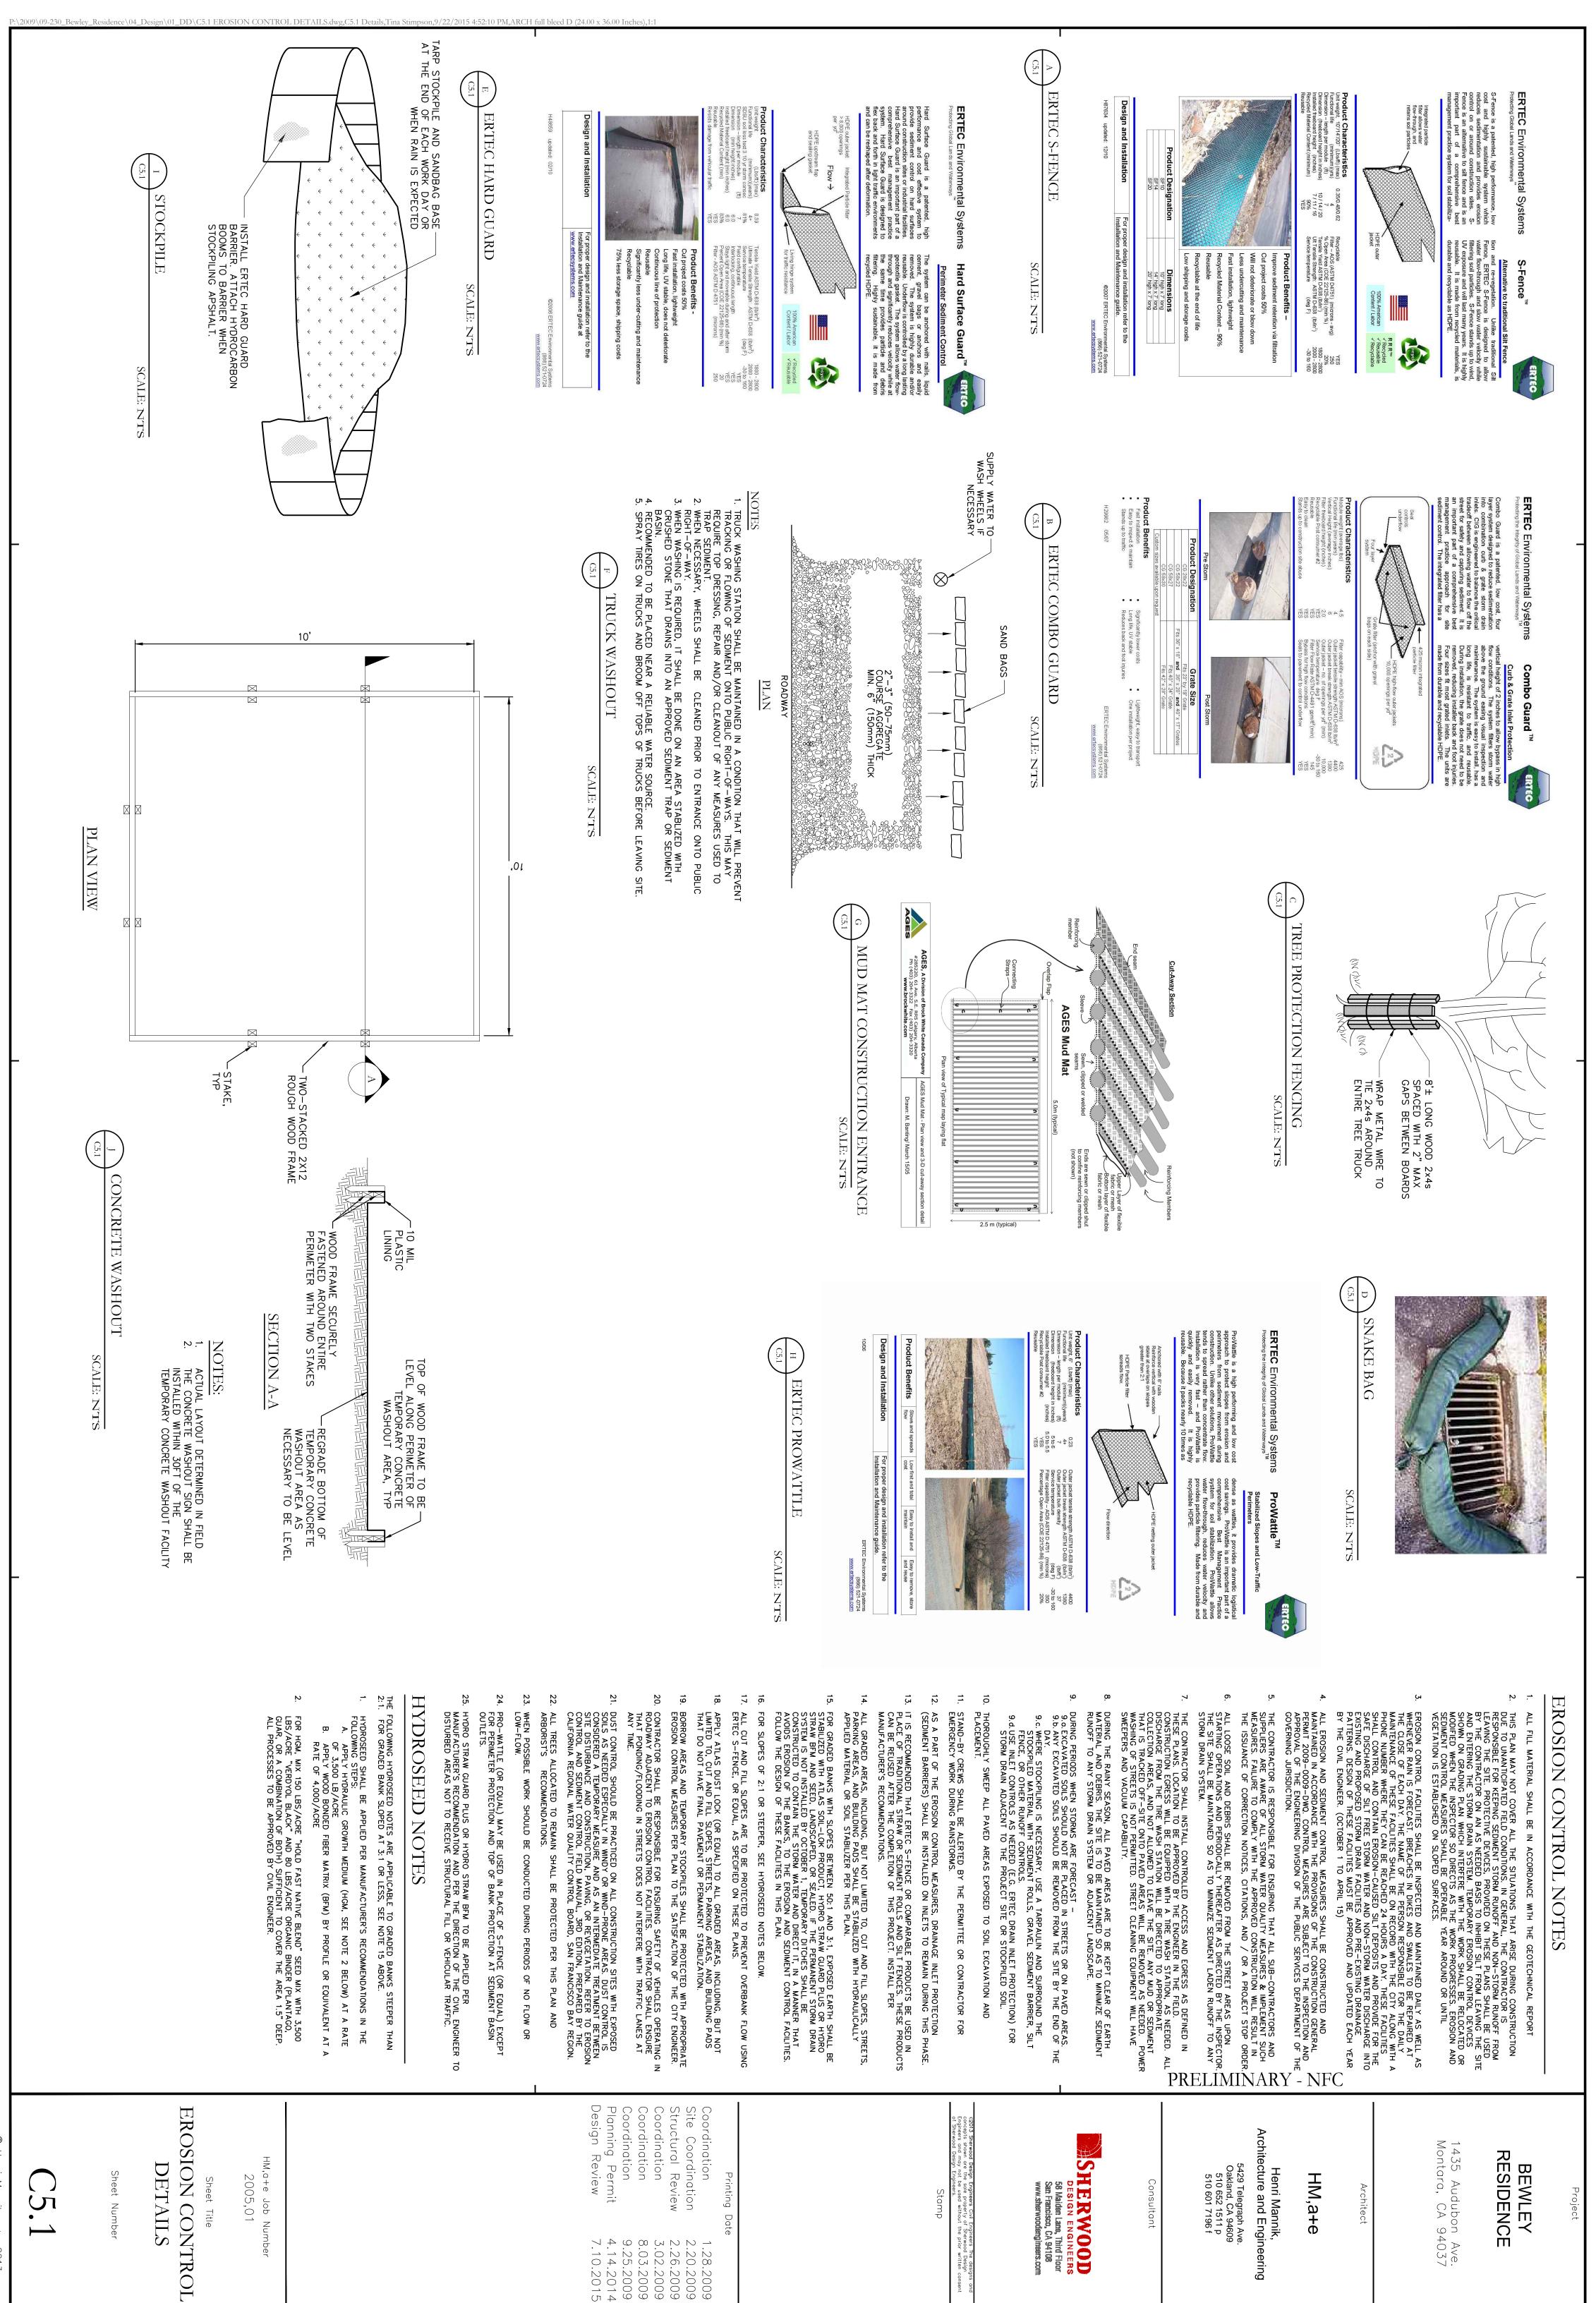

Date

1.28.2009 2.20.2009 2.26.2009 3.02.2009 8.03.2009 9.25.2009 4.14.2014 7.10.2015

© Henri Mannik, a+e 2013

Job Numl

Title


ERTEC PROWATTLE TEMPORARY CHECK DAM & INSTALLATION

SCALE: NTS

Coordination
Site Coordination
Structural Review
Coordination
Coordination
Coordination
Planning Permit
Design Review

1.28.2009 2.20.2009 2.26.2009 3.02.2009 8.03.2009 9.25.2009 4.14.2014 7.10.2015

P:\2009\09-230_Bewley_Residence\04_Design\01_DD\C5.1 Erosion Control Details.dwg,C5.2 Details,Tina Stimpson,9/22/2015 4:52:24 PM,ARCH full bleed D (24.00 x 36.00 Inches),1:1

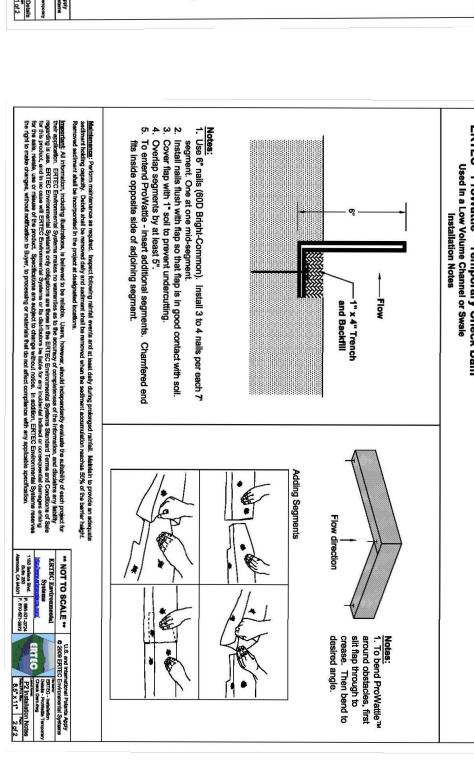

ERTEC[®] ProWattle™ Temporary Check Dam Used In a Low Volume Channel or Swale Installation Notes

SHERWOOD

DESIGN ENGINEERS
58 Maiden Lame, Third Floor
San Francisco, CA 94108

www.sherwoodengineers.com

Consultant

5429 Telegraph Ave. Oakland, CA 94609 510 652 1511 p 510 601 7196 f

PRELIMINARY - NFC

Henri Mannik, Architecture and Engineering HM,a+e

1435 Audubon Ave. Montara, CA 94037

BEWLEY RESIDENCE

C5.2

Sheet Title
EROSION CONTROL
DETAILS

Sheet Number

HM,a+e Job Number 2005,01