

#### **Application for** Design Review by the County Coastside Design Review Committee

County Government Center • 455 County Center • Redwood City CA 94063

Mail Drop PLN 122 • 650 · 363 · 4161 • FAX 650 · 363 · 4849

Permit #: PLN

Other Permit #: WA

Applicant:	<b>Owner</b> (if different from Applicant):
Name: Scott Yamamoto	Name: Lywe
Address: 951 Malaga St.	Address:
Half Moon Bay Zip: 94019	Zip:
Phone, W: 6502704446 H: 650270	4446 Phone, W: H:
Email: yamamotos1@gmail.com	Email:
Architect or Designer (if different from Name: Landmark Designs -Krista Brass	
Address: 2378 Huntington Dr., Aptos, Ca	A Zip:
Phone, W: 4087611218 H: 831331	0432 Email: landmarkdesigns@gmail.com
APN: 047293330  Address: 951 Malaga Street  EL Granada, CA Zip: 94,019	Existing Development (Please describe):  560 S/F single Family Home  TB Demolished
EL Granada, CA Zip: 94,019 Zoning:R1	560 S/F single Family Home
Parcel/lot size: 6000	sq. ft.
Project:	Additional Permits Required:
New Single Family Residence: $2,2$	78.4 sq. ft   Certificate of Compliance Type A or Type B
Addition to Residence:	sq. ft Coastal Development Permit
Other:	Fence Height Exception (not permitted on coast)
	Grading Permit or Exemption
Describe Project:	☐ Home Improvement Exception
New Construction single	Family   Non-Conforming Use Comil
Two Story Home,	<ul> <li>Off-Street Parking Exception</li> </ul>
1 -1	JUL 0 9 2015

San Mateo County Planning and Building Department

#### **San Mateo County**

#### Planning and Building Department

**Certificate of Exemption** or Exclusion from a Coastal **Development Permit** 

Permit #: PLN 20 15-2 Permit #: BLD \_\_

455 County Center, 2nd Floor • Redwood City, CA • 94063 Mail Drop: PLN 122 • TEL (650) 363-4161 • FAX (650) 363-4849

Permanent Record Microfilming Required

f. :exchiometton	
Owner Name: SCOTT YAMA MOTO  Address: 951 MALAGA STREET  ELGRANADA, CA  Zip: Phone, W: H: 650.270.444	Applicant Name: MIKE MCCARTHY Address: 122 SAVATOGA AVE.  SUITE 100  SANTA CLASSA 95051  Phone, W: (408) 747.9420
Email Address: Yamamoto S 1 @gmay	
Project Description:  DEMA (E) 560 S.F. HOME  BULLD (N) 2. STORY SINGLE  FAMILY HOME OF 2,2785.F.  Assessor's Parcel Number(s):  047 -293- 330	Existing water source:  Utility connection P.U.C. EL GRANADA, DISTRETANDA DIST
basis for exemption or exclusion are true and correct to the be in accordance with the terms of the exemption/exclusion cate exemption or exclusion issued for a water well and/or storage event the future house, the well, and/or storage tank requires	is for this exemption or exclusion. The information herein and the est of our knowledge and we hereby agree to carry out this project igory selected on reverse. We also understand and agree that any tank in the single family exclusion area will be invalidated in the avariance.  The single family exclusion area will be invalidated in the avariance.
Owner Date	Applicant Date

Both Owner and Applicant must sign unless this Application for Exemption or Exclusion accompanies a Building Permit Application for which the Applicant is an agent for the Owner acceptable to the Building Inspection Section.

#### Staff Use Only

#### 4. Basis of Exemption or Exclusion

Use attached review sheet to determine basis of exemption and whether project qualifies. Review basis of exemption with applicant/owner and initial appropriate category below:

Initial A. Improvements to Existing Single Family Residence [PRC 30610(a), CCAG 13250, ZR 6328.5(a)] B. Improvements to Existing Structure Other Than Single Family Residence or Public Works Facility. [PRC 30610(b), CCAG 13253, ZR 6328.5(b)] C. Existing Navigation Channel. [PRC 30610(c). ZR 6328.5(c)] D. Repair or Maintenance Activity. [PRC 30610(d), CCAG 13252, ZR 6328.5(d)] E. Single Family Residence Categorical Exclusion Area. [PRC 30610(e), CCAG 13240, AB 643, ZR 6328.5(e)] Required	F. Agriculturally-Related Development Categorical Exclusive Area. [PRC 30610(e), CCAG 13240, ORDERS E-79-7
Inspection made by:  Yes No  Removal of trees? If Yes, is tree removal permit included? Trimming of trees? Excessive removal of vegetation? Excessive grading? (If Yes, CDP is required) Erosion control plan required?	Approval of Permit is subject to the following: (check if applicable)  Submittal and Approval of a Tree Removal Permit  Submittal and Approval of a Grading Permit  Submittal and Approval of an Erosion Control Plan  Submittal and Approval of a Coastal Dev. Permit
I have reviewed the above-described project and have determ checked above.  Exemption/Exclusion is approved.  Planning Department  Project is subject to the following condition(s) of approval:	nined that it meets all criteria for the exemption/exclusion  Date
<ul> <li>Fee collected</li> <li>Original Certificate of Exemption to Building Inspection file.</li> <li>Copies of Certificate of Exemption to: <ol> <li>Applicant/Owner.</li> </ol> </li> <li>Planning Department Exemption Binder.</li> </ul>	3. Any relevant Planning or Building Inspection files. 4. California Coastal Commission, 45 Fremont Street, Suite 2000, San Francisco, CA 94105Update Permit*Plan Case Screen and Activities

## **Environmental Information Disclosure Form**

PLN 2013-27-8
BLD\_

Projec	t Addres	s: 951 MALAGA STREET	Name of Owner: SCOTT YAMAMOTO  Address: - SAME - GEO 270 444
Assess	sor's Par	cel No. 047 _ 293 _ 330	Phore: MIKE MCCARTH  Name of Applicant: Scott YAMAMOTO)
Zoning	District:	PISIT	Phone: 408 • 747.9420
Parcel Describ purposi creeks,	size:  pe the ext e of any e vegetation	easements on the parcel and a description of	ises on the project parcel, including the existence and any natural features on the project parcel (i.e. steep terrain, SINENCE, WILD NEW TWO STURY
SHARIOTER COLUMN		Environmental Quality Act (CEQA) F	Review
Yes	No	Will this project involve:	
	V	a. Addition to an existing structure > 50% o	f the existing area OR > 2,500 sq. ft?
	V	b. Construction of a new multi-family reside	
	V	c. Construction of a commercial structure >	
		<ul> <li>d. Removal of mature tree(s) ( ≥ 6" d.b.h. in residential zoning district)?</li> <li>If yes, how many trees to be removed?</li> </ul>	Emerald Lake Hills area or ≥ 12" d.b.h. in any
V		e. Land clearing or grading?  If yes, please state amount in cubic yards  Excavation: 40 c.y.	s (c.y.): Fill: 20 c.y.
	<u> </u>	f. Subdivision of land into 5 or more parcels	9?
	/	g. Construction within a State or County sce	
		h. Construction within a sensitive habitat?	
		i. Construction within a hazard area (i.e. sei	
		J. Construction on a hazardous waste site (c	check with Co. Env. Health Division)?
Please	-	all "Yes" answers:	
	E	F.F. LOV	BL IS ONE LEVEL,
		OT IS FAIRLY LEVEL!	

Yes	No	Will the project involve:
V		a. Construction of side of the of the of an existing, legal structure?
HOLE THE SECOND CO.	/	b. Exterior construction within 100-feet of a stream?
	/	c. Construction, maintenance or use of a road, bridge, or trail on a stream bank or unstable hill slope
	<b>V</b>	d. Land-use within a riparian area?
ø	/	e. Jimber harvesting, mining, grazing or grading?
	V,	f. Any work inside of a stream, riparian corridor, or shoreline?
	·V.	g. Release or capture of fish or commerce dealing with fish?
lease		any "Yes" answers:
	• . • .	
		·

3. Na	tional	Pollutant Discharge Elimination System (NPDES) Review
Yes	No	Will the project involve:
	1	a. A subdivision or Commercial / Industrial Development that will result in the addition or replacement o 10,000 sq. ft. or more of impervious surface?
	/	If yes, Property Owner may be required to implement appropriate source control and site design measures and to design and implement stormwater treatment measures, to reduce the discharge of stormwater pollutants. Please consult the Current Planning Section for necessary forms and both construction and post-construction requirements.
	1	b. Land disturbance of 1 acre or more of area?
	V	If yes, Property Owner must file a Notice of Intent (NOI) to be covered under the statewide General Construction Activities Storm Water Permit (General Permit) prior to the commencement of construction activity. Proof of coverage under State permit must be demonstrated prior to the issuance of a building permit.

I hereby certify that the statements furnished above and in the attached exhibits present the data and information required for this initial evaluation to the best of my ability, and the facts, statements and information presented are true and correct to the best of my knowledge and belief. If any of the facts represented here change, it is my responsibility to inform the County.

Signed:

Applicant may sign

Date:

7-9-15



## ROOFING STANDING SEAM METAL ROOF

#### Metallic KYNAR 500<sup>®</sup> Coatings



Charcoal Grey SRI-23


#### **SIDING**

SHERWIN WILLIAMS
SOFTENED GREEN SW 6177



#### **TRIM**

SHERWIN WILLIAMS CREAMY SW7017

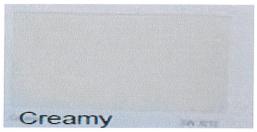


#### CULTURED STONE/ COUNTRY LEDGESTONE

**COLOR: Caramel** 

BY BORAL



<a href="http://www.culturedstone.ca/Products/colors-country-ledgestone.aspx">http://www.culturedstone.ca/Products/colors-country-ledgestone.aspx</a>

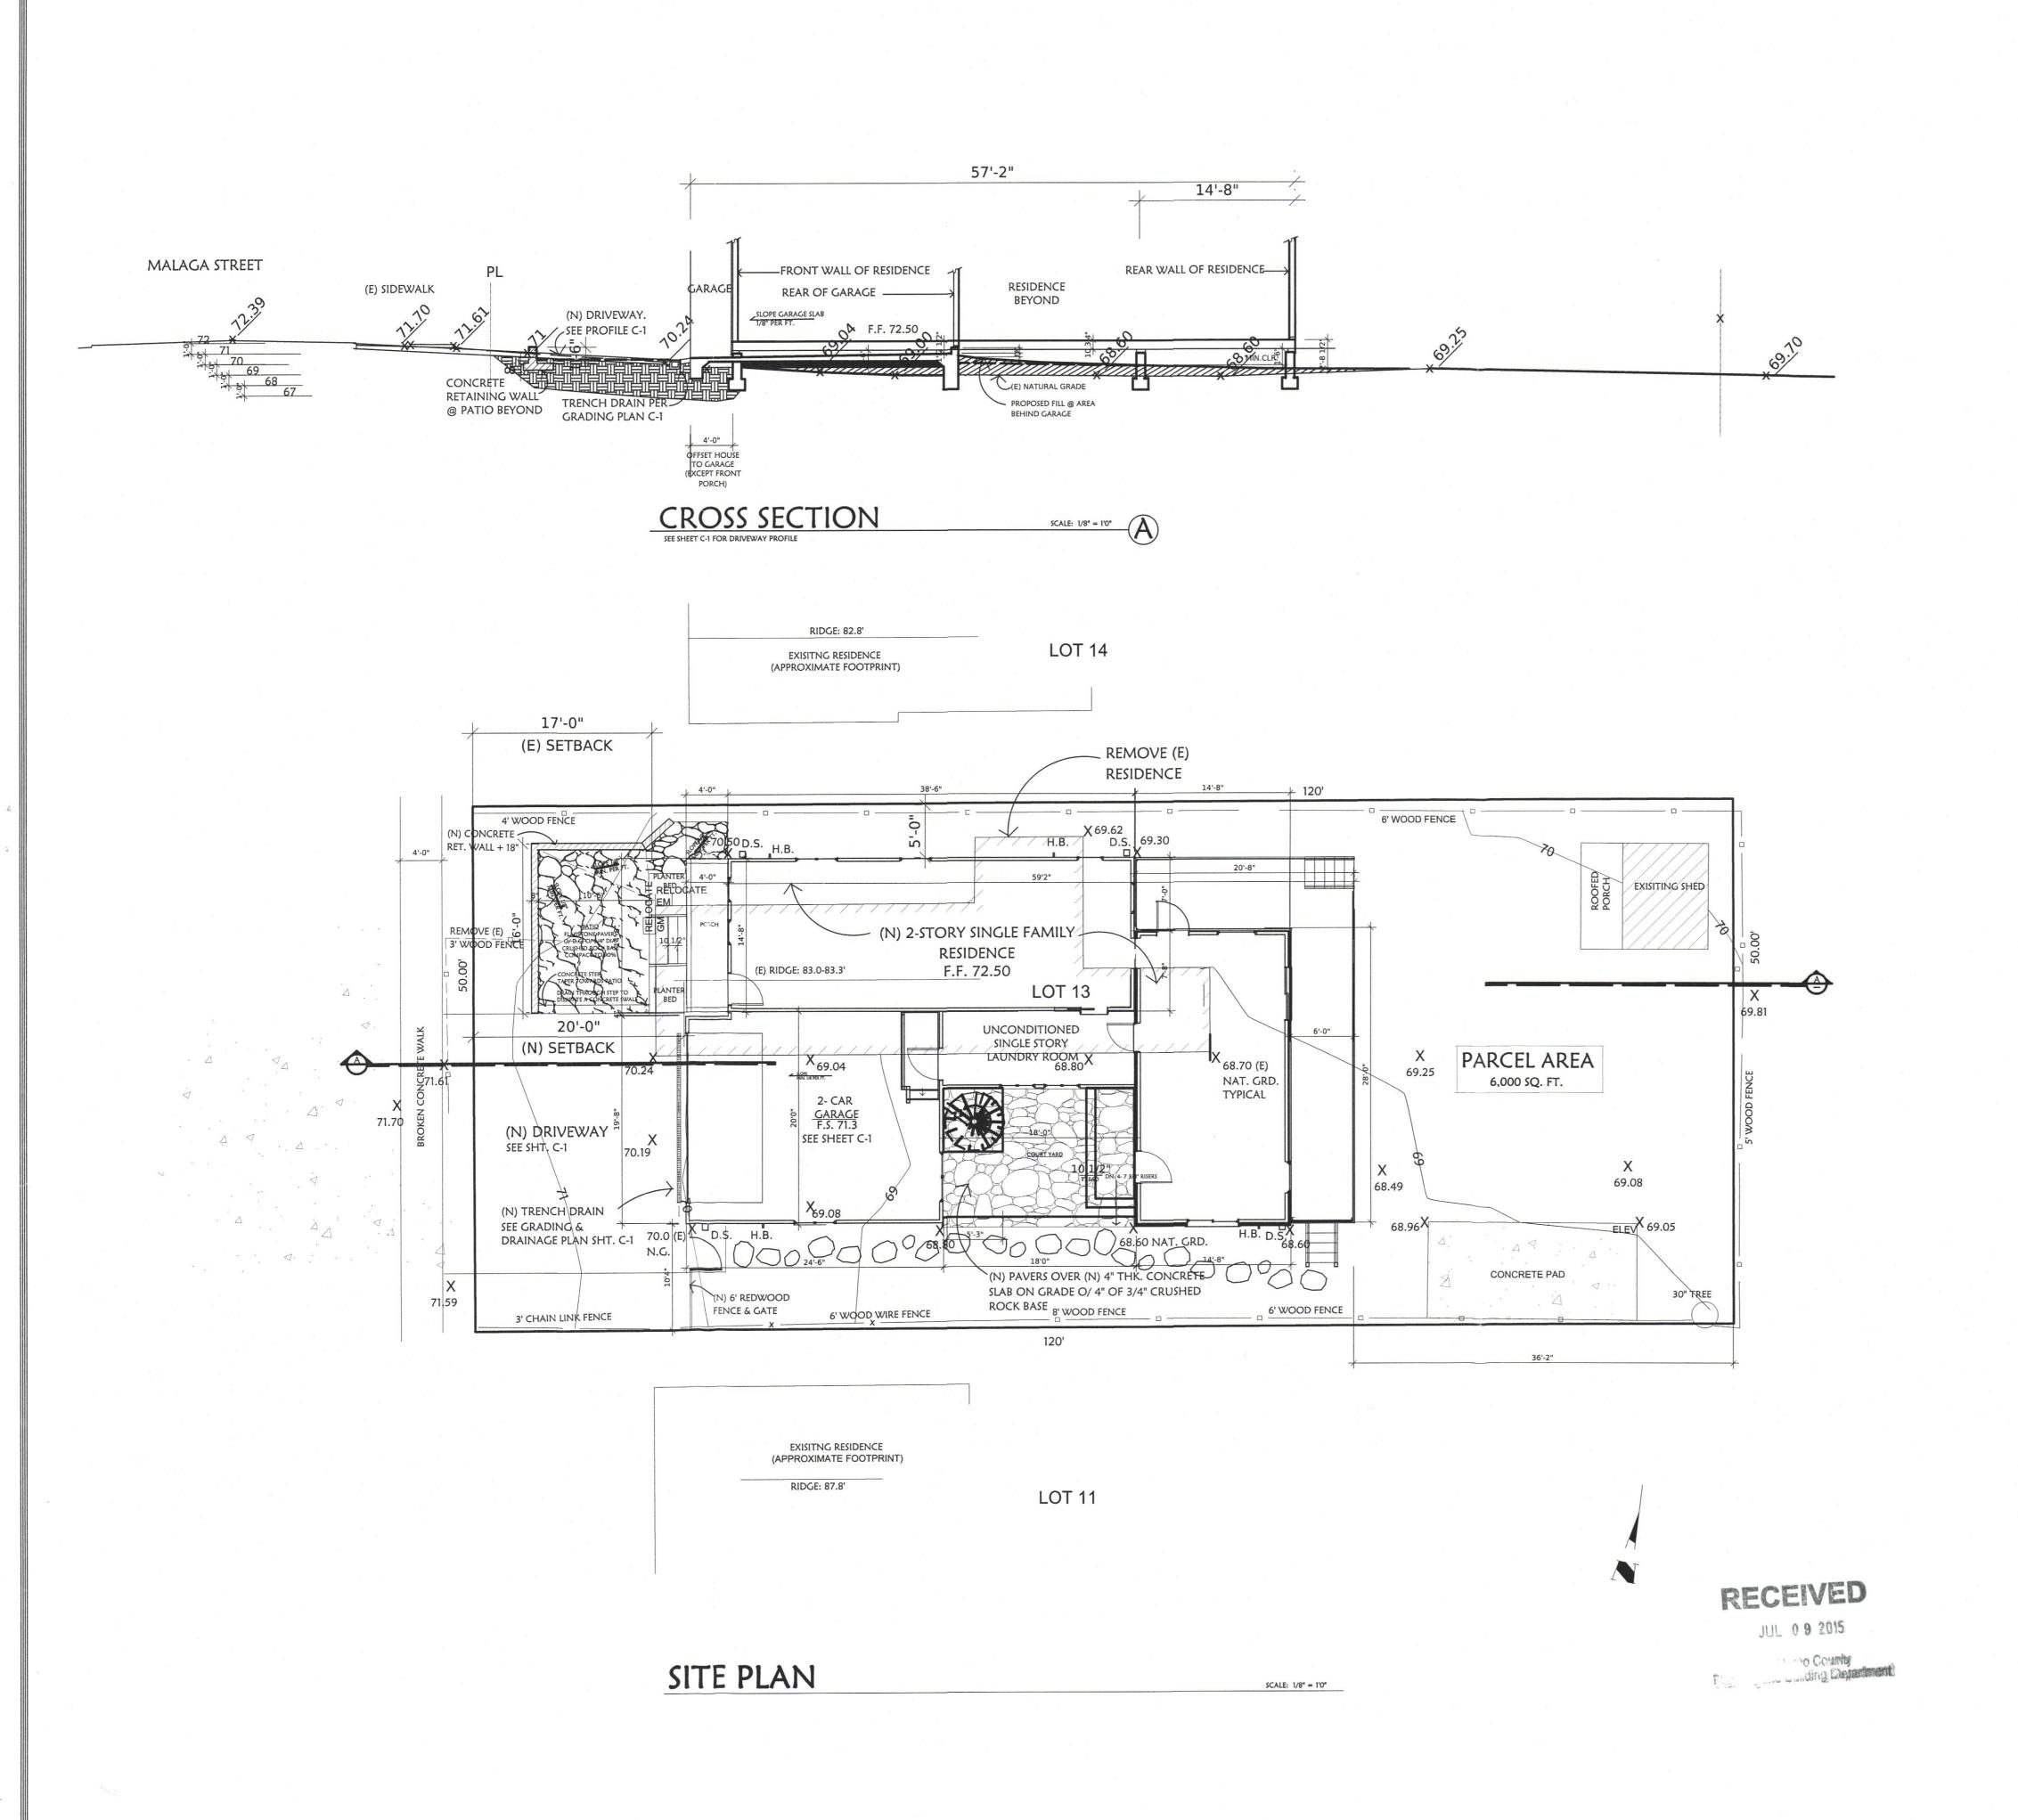

A NEW HOME

~for~

THE YAMAMOTO FAMILY

951 MALAGA STREET

EL GRANADA, CA 94019

#### INDEX

- A-1 COVER SHEET, SITE PLAN, INDEX, VICINITY MAP CROSS SECTION A
- SU-1 TOPOGRAPHIC SURVEY
  - LANDSCAPE PLAN
- A-2 FIRST FLOOR PLAN, SECOND FLOOR PLAN
- A-3 FRONT, REAR & SIDE ELEVATIONS
- A-4 ROOF PLAN
- C-1 GRADING, DRAINAGE, EROSION CONTROL PLAN
- BMP BEST MANAGEMENT PRACTICES, WATER POLLUTION PREVENTION PROGRAM

#### PROJECT INFORMATION

SCOPE OF WORK: DEMOLISH (E) HOME AND REPLACE W/ A NEW SINGLE FAMILY, TWO STORY HOME WITH 3-BEDROOMS AND 2 1/2 BATHS INCLUDING 2- CAR GARAGE AND UNCONDITIONED LAUNDRY ROOM

<u>APN:</u> 047293330 <u>ADDRESS:</u> 951 MALAGA STREET, EL GRANADA, CA, 94019-3141 <u>LOT SIZE (SQ. FT.):</u> 6000 <u>YEAR BUILT:</u> 1931 <u>ZONING:</u> R-1/S-17/DR/CD

EXISTING S.F.: 560

 NEW FIRST FLOOR:
 949.6
 S.F.

 NEW SECOND FLOOR:
 1,328.8
 S.F.

 TOTAL:
 2,278.4
 S.F.

<u>NEW 2- CAR GARAGE:</u> 490 S.F. <u>NEW UNCONDITIONED LAUNDRY ROOM:</u> 131.4 S.F. <u>ROOF COVERAGE:</u> 1,408.5 S.F. (620.5 +438+350) <u>ROOF DECK COVERAGE MAXIMUM</u>: 1,408.5 X .20 (20 %) = 281.7 MAX.

<u>ROOF DECK:</u> 131.4 (7.3X18)+140 (7X20)=271.< 281.7 <u>F.A.R. MAXIMUM:</u> 6,000 x .45 = 2,700 S.F <u>LOT COVERAGE S.F.:</u> 1,582.5 < 2,700

# VICINITY MAP N.T.S PARCEL MAP N.T.S

REVISIONS BY

COVER SHEET,

SITE PLAN

INDEX,

PROJECT DESCR.

VICINITY MAP

HE YAMAMOTO FAMILY 951 MALAGA STREET L GRANADA, CA 94019

DESIGN • DIEVELOPAMENT

CONSTRUCTION MANAGEMENT • PPESSIEVATION

WWW.landmarkdesigns.net

P.O. BOX 2221 LOS GATOS, CA. 95031 408-761-1218

DRAWN BY:
K.B.

CHECKED BY:
S.Y.


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JULY 6, 2015


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AS SHOWN


JOB NO.

SHEET

PLN 2015-278

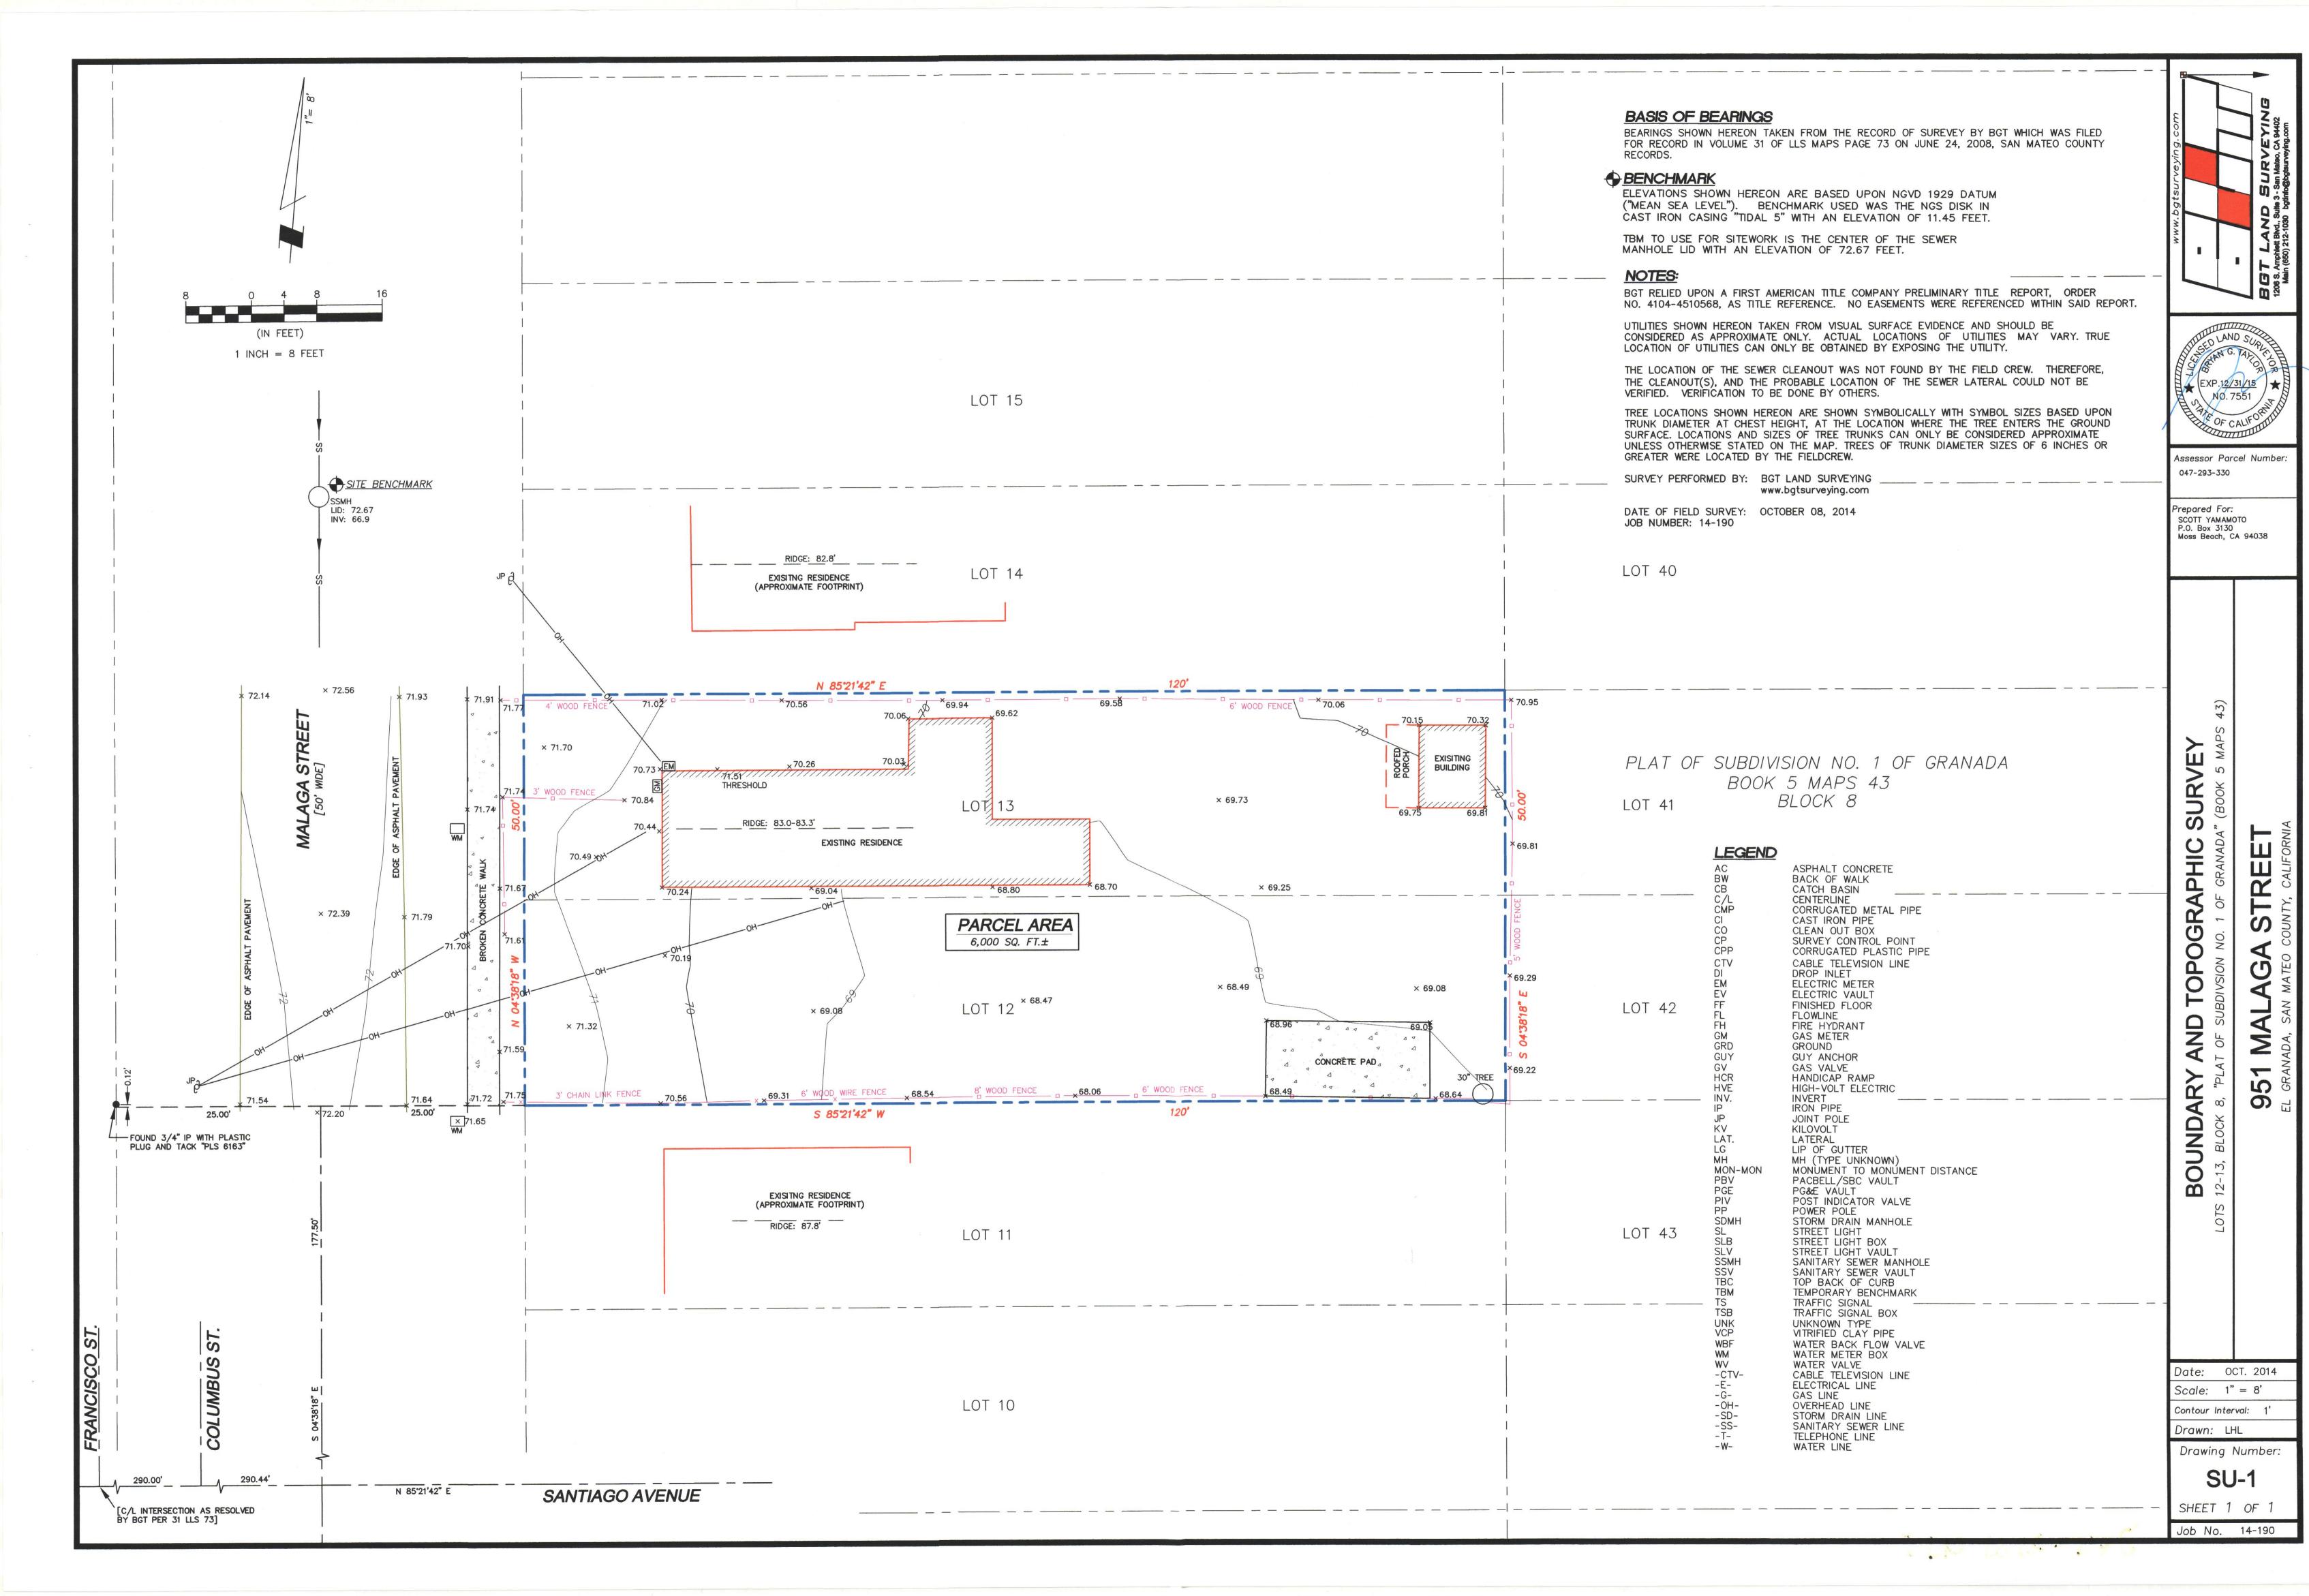

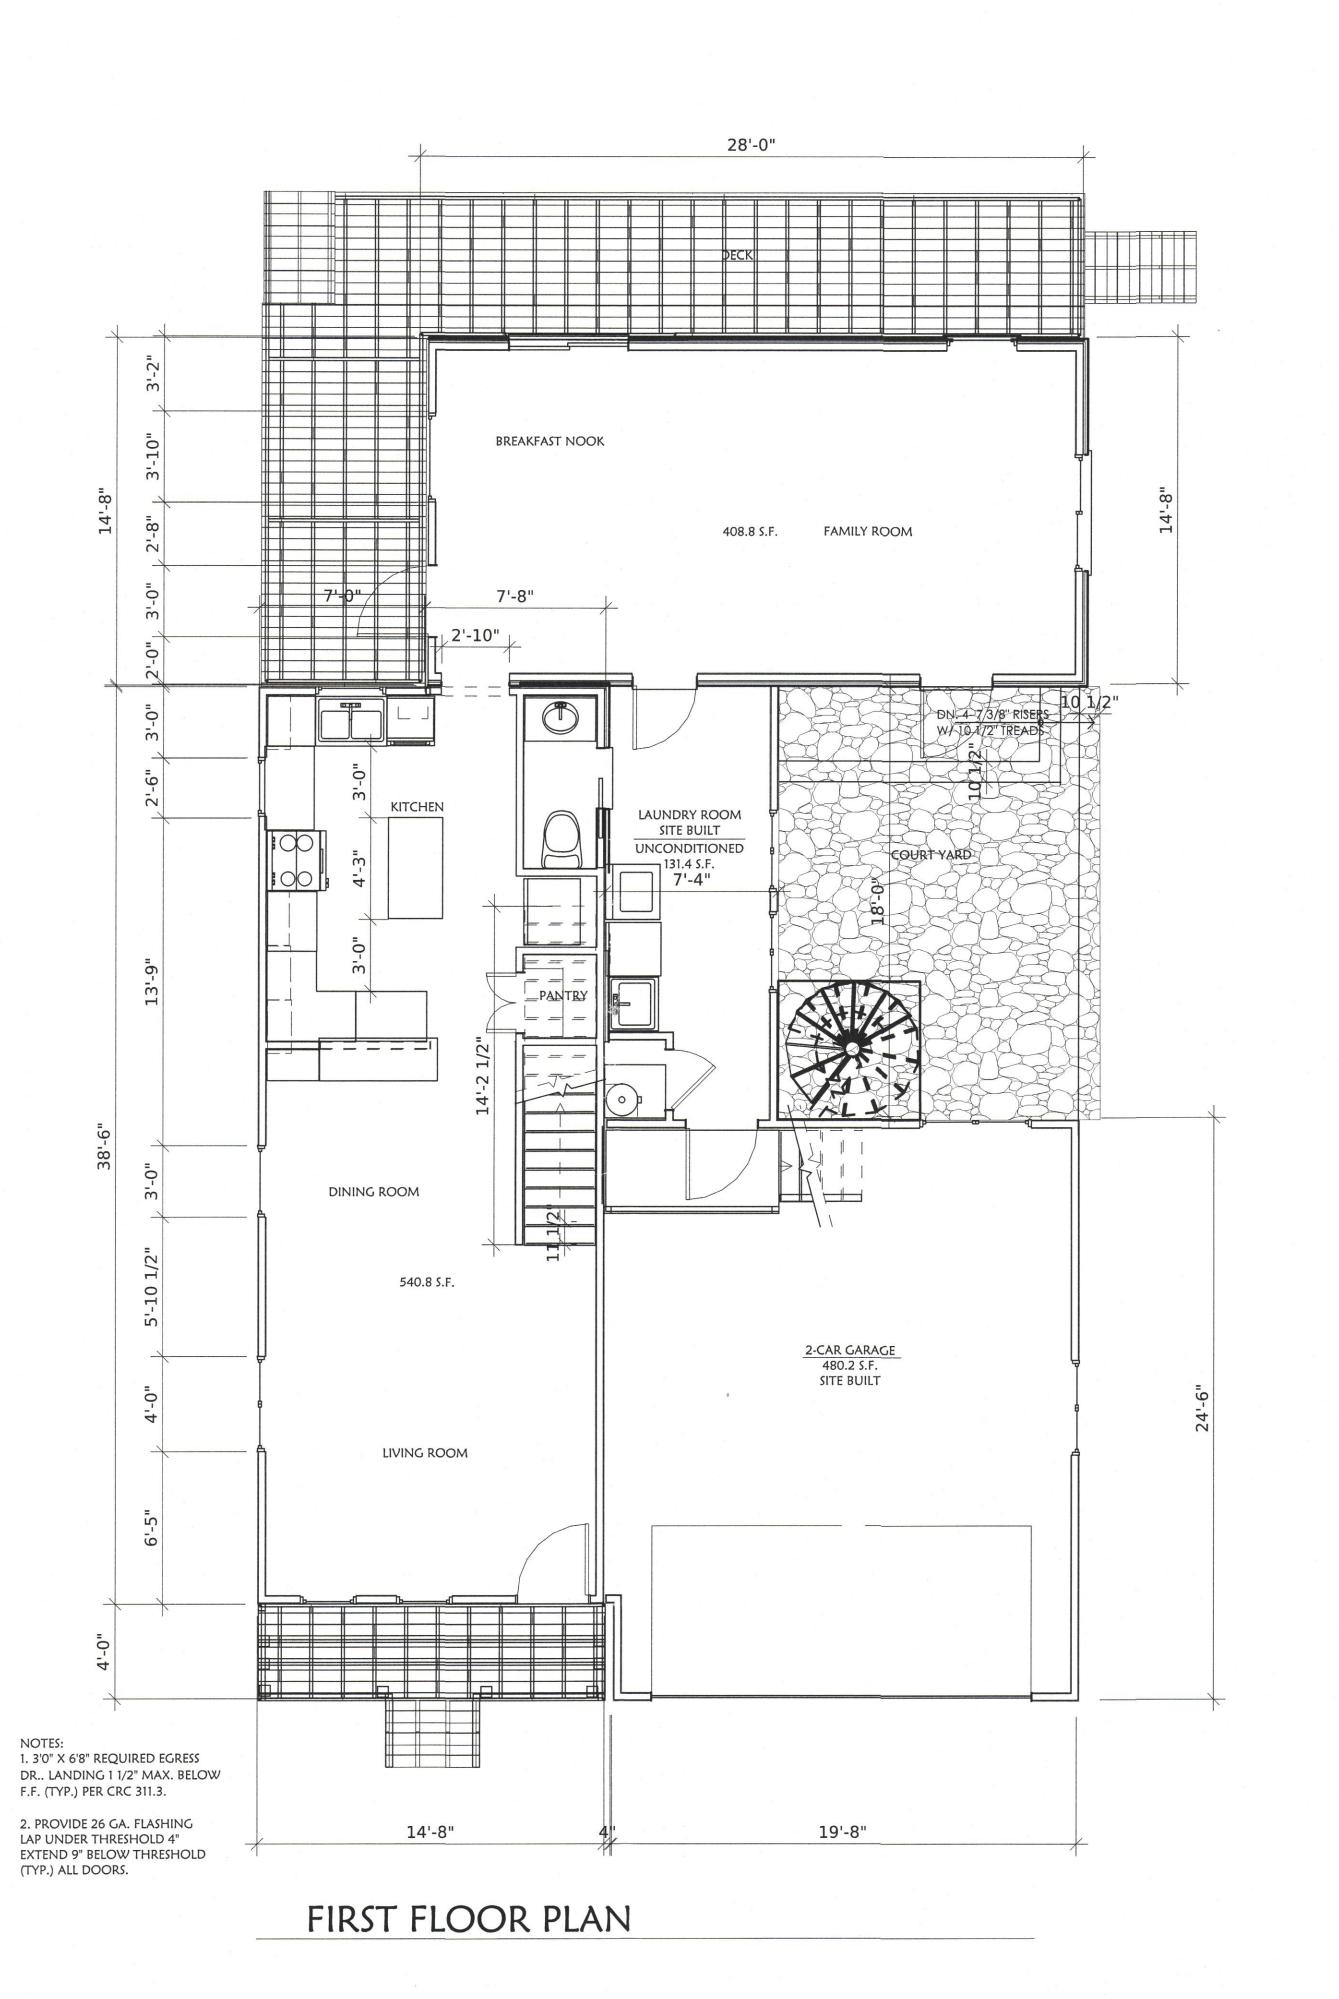

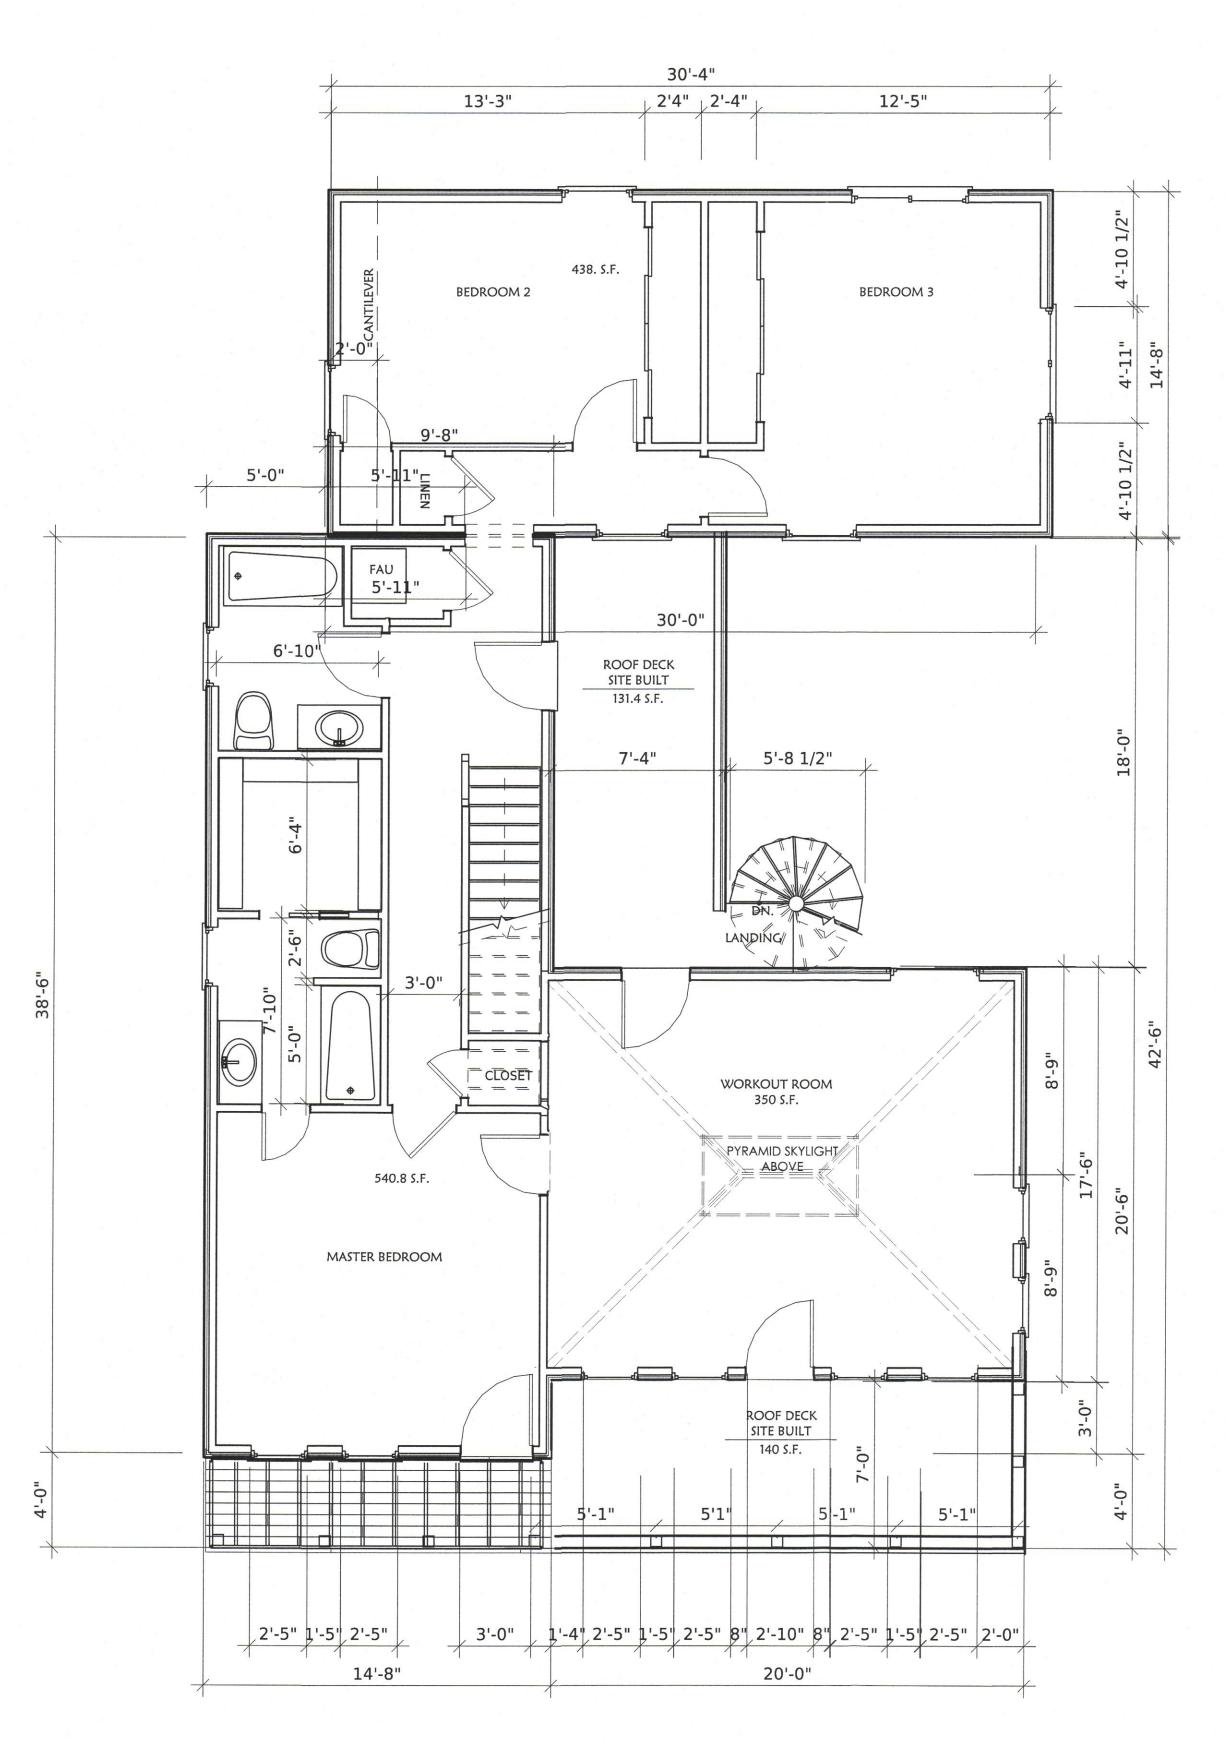

SECOND FLOOR PLAN

1/4" = 1'0"

ROOF DECK COVERAGE:

ROOF AREA S.F. = 1408.5 (350+620.5+438)

ROOF DECK 131.4 + 140 = 271.4 1408.5 \* .20 (20%) = 281.7 MAX. ROOF DECK COVERAGE 271.4 < 281.7 (20% OF (E) ROOF) REVISIONS BY

FIRST FLOOR PLAN SECOND FLOOR PLAN

E YAMAMOTO FAMIL

DATESHIGH \* DIEVELOPMENT CONSTRUCTION MAINTAGEMENT \* PRESIDENT WWW.landmarkdesigns.net www.landmarkdesigns.net P.O. BOX 221 LOS GATOS, CA. 95051 408-761-1218

DRAWN BY:
K.B.

CHECKED BY:
S.Y.

DATE
JULY 6, 2015

SHEET

1/4"=1'0"

JOB NO.

A2



REVISIONS BY

FRONT ELEVATION SIDE ELEVATIONS REAR ELEVATION

A NEW RESIDENCE FOR:

E YAMAMOTO FAMILY

CONSTRUCTION MANAGEMENT • PPEESERVATION

WWW.landmarkdesigns.net

\*\*O.BOX 2221 LOS GATOS, CA. 95081 408-761-1218

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K.B.


CHECKED BY:
S.Y.

DATE
JULY 6, 2015

SCALE
1/4" = 1'0"

JOB NO.

A3

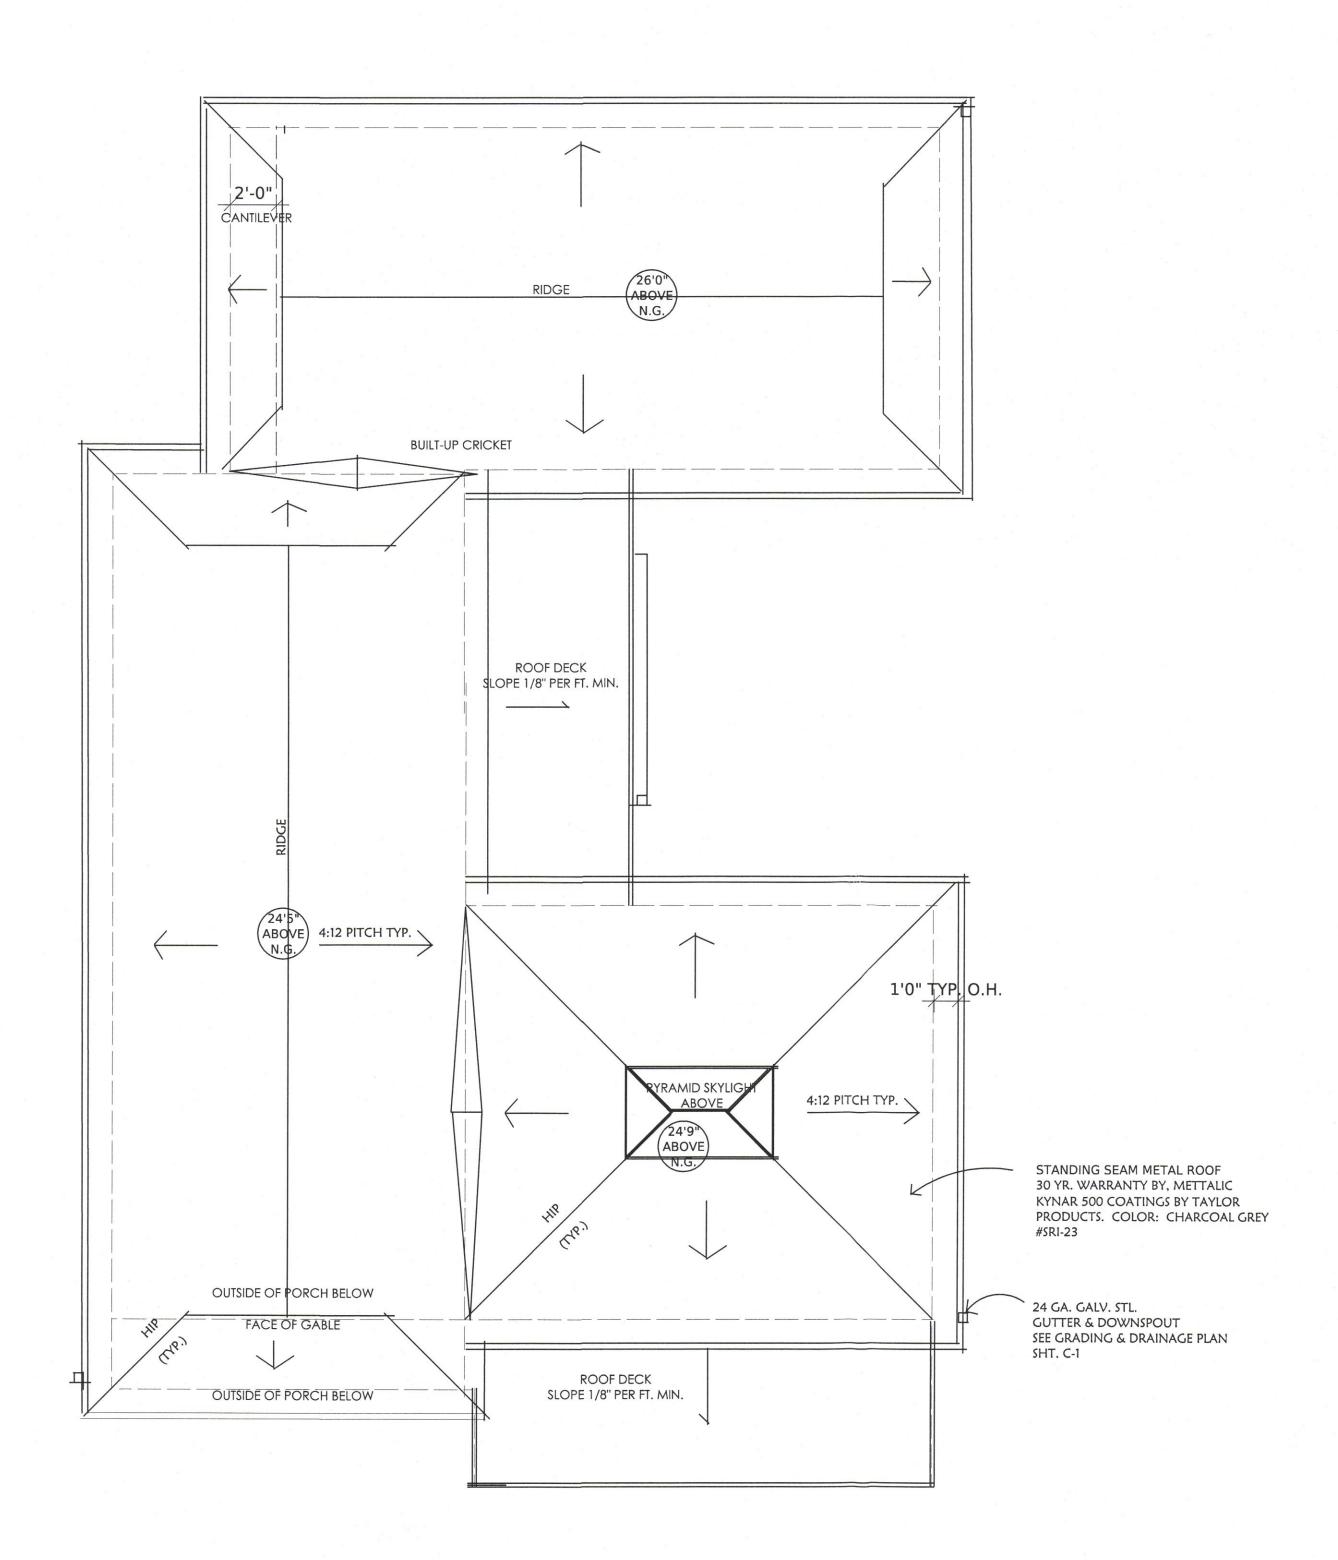


ROOF PLAN

1/4" = 1'0"

REVISIONS BY

**ROOF PLAN** 

HE YAMAMOTO FAMILY
951 MALAGA STREET
1 GRANADA CA 94019

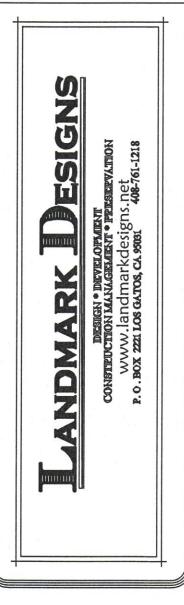

DRAWN BY:
K.B.


CHECKED BY:
S.Y.

DATE
JULY 6, 2015

SCALE
1/4"=1'0"

JOB NO.

A4

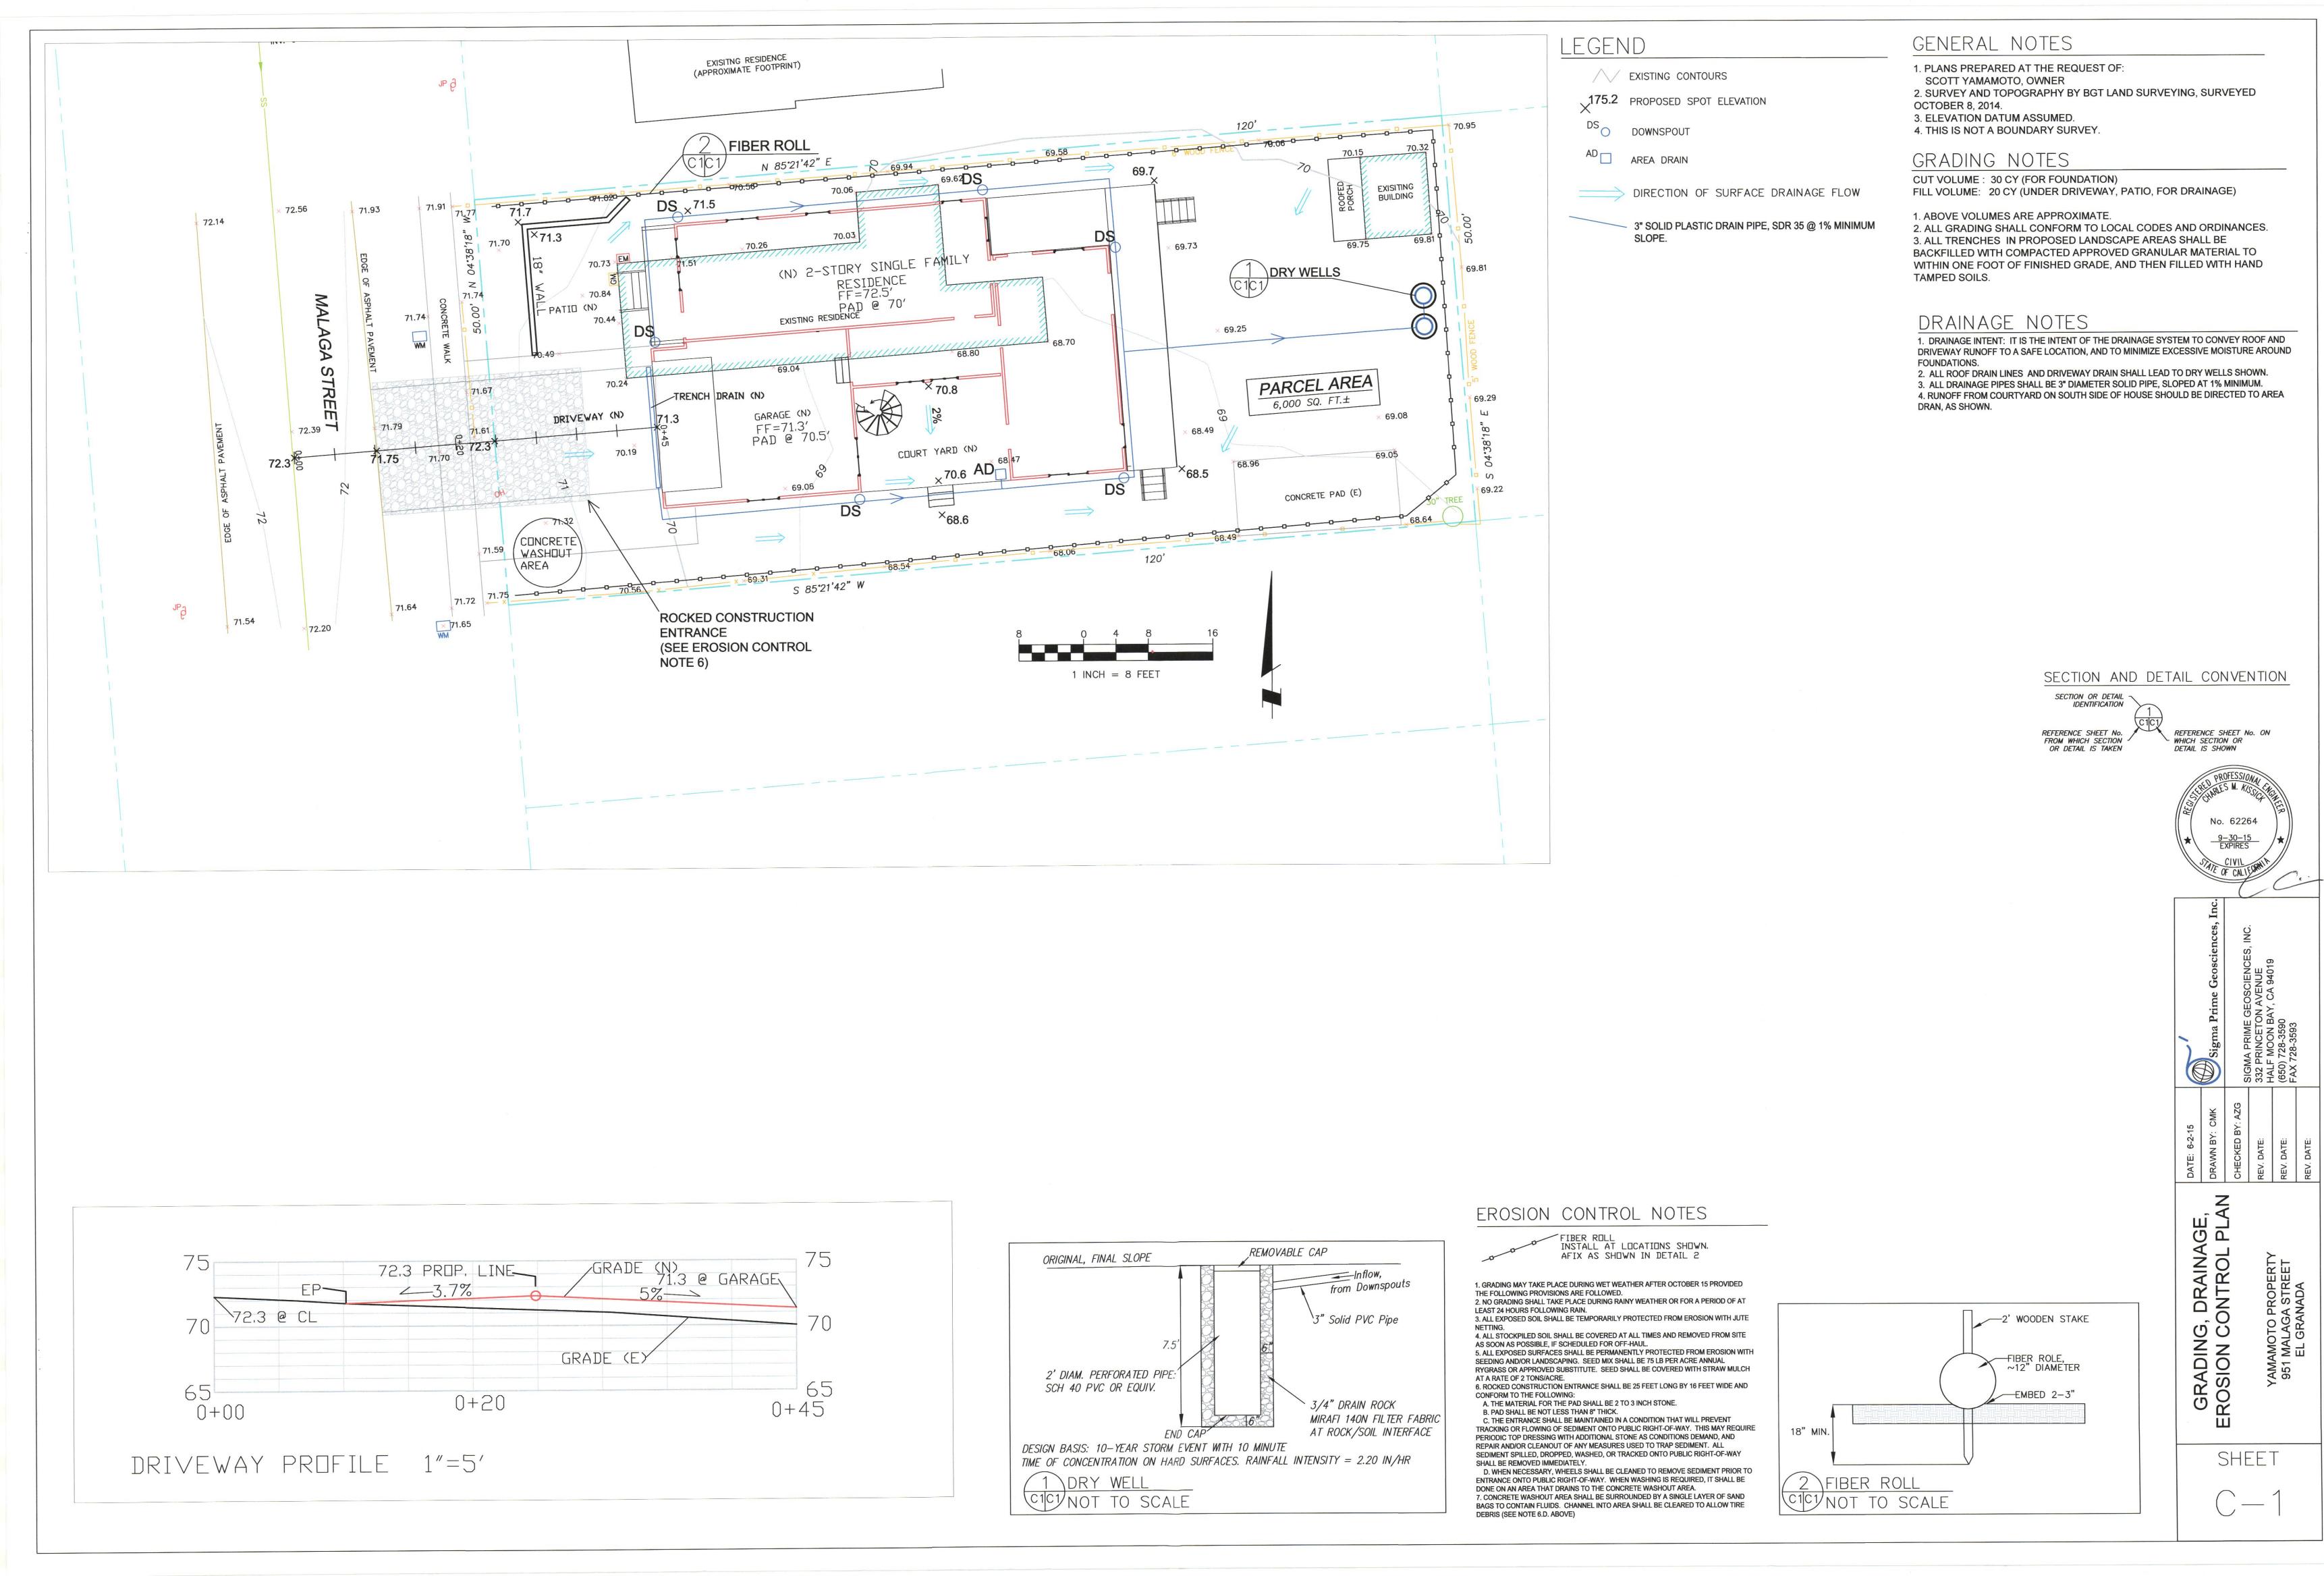




## Construction Best Management Prac

## Water Pollution Prevention Program

Construction projects are required to implement the stormwater best management pra as they apply to your project, all year long.

Clean Water. Healthy Community.

#### **Materials & Waste Management**

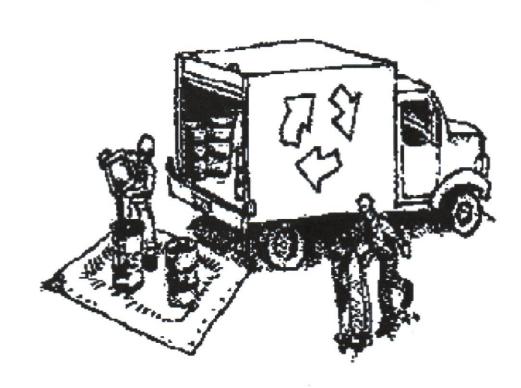

#### **Non-Hazardous Materials**

- ☐ Berm and cover stockpiles of sand, dirt or other construction material with tarps when rain is forecast or if not actively being used within 14 days.
- ☐ Use (but don't overuse) reclaimed water for dust control.

#### **Hazardous Materials**

- ☐ Label all hazardous materials and hazardous wastes (such as pesticides, paints, thinners, solvents, fuel, oil, and antifreeze) in accordance with city, county, state and federal regulations.
- ☐ Store hazardous materials and wastes in water tight containers, store in appropriate secondary containment, and cover them at the end of every work day or during wet weather or when rain is forecast.
- ☐ Follow manufacturer's application instructions for hazardous materials and be careful not to use more than necessary. Do not apply chemicals outdoors when rain is forecast within 24 hours.
- ☐ Arrange for appropriate disposal of all hazardous wastes.

#### Waste Management

- ☐ Cover waste disposal containers securely with tarps at the end of every work day and during wet weather.
- ☐ Check waste disposal containers frequently for leaks and to make sure they are not overfilled. Never hose down a dumpster on the construction site.
- ☐ Clean or replace portable toilets, and inspect them frequently for leaks and spills.
- ☐ Dispose of all wastes and debris properly. Recycle materials and wastes that can be recycled (such as asphalt, concrete, aggregate base materials, wood, gyp board, pipe, etc.)
- ☐ Dispose of liquid residues from paints, thinners, solvents, glues, and cleaning fluids as hazardous waste.

#### **Construction Entrances and Perimeter**

- ☐ Establish and maintain effective perimeter controls and stabilize all construction entrances and exits to sufficiently control erosion and sediment discharges from site and tracking off site.
- ☐ Sweep or vacuum any street tracking immediately and secure sediment source to prevent further tracking. Never hose down streets to clean up tracking.

## **Equipment Management & Spill Control**




#### **Maintenance and Parking**

- ☐ Designate an area, fitted with appropriate BMPs, for vehicle and equipment parking and storage.
- ☐ Perform major maintenance, repair jobs, and vehicle and equipment washing off site.
- ☐ If refueling or vehicle maintenance must be done onsite, work in a bermed area away from storm drains and over a drip pan big enough to collect fluids. Recycle or dispose of fluids as hazardous waste.
- ☐ If vehicle or equipment cleaning must be done onsite, clean with water only in a bermed area that will not allow rinse water to run into gutters, streets, storm drains, or surface waters.
- ☐ Do not clean vehicle or equipment onsite using soaps, solvents, degreasers, steam cleaning equipment, etc.

#### **Spill Prevention and Control**

- ☐ Keep spill cleanup materials (rags, absorbents, etc.) available at the construction site at all times.
- ☐ Inspect vehicles and equipment frequently for and repair leaks promptly. Use drip pans to catch leaks until repairs are made.
- ☐ Clean up spills or leaks immediately and dispose of cleanup materials properly.
- ☐ Do not hose down surfaces where fluids have spilled. Use dry cleanup methods (absorbent materials, cat litter, and/or rags).
- ☐ Sweep up spilled dry materials immediately. Do not try to wash them away with water, or bury them.
- ☐ Clean up spills on dirt areas by digging up and properly disposing of contaminated soil.
- Report significant spills immediately. You are required by law to report all significant releases of hazardous materials, including oil. To report a spill: 1) Dial 911 or your local emergency response number, 2) Call the Governor's Office of Emergency Services Warning Center, (800) 852-7550 (24 hours).

# Earthwork & Contaminated Soils

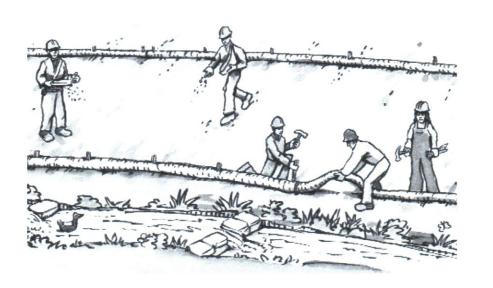


#### **Erosion Control**

- ☐ Schedule grading and excavation work for dry weather only.
- ☐ Stabilize all denuded areas, install and maintain temporary erosion controls (such as erosion control fabric or bonded fiber matrix) until vegetation is established.
- ☐ Seed or plant vegetation for erosion control on slopes or where construction is not immediately planned.

#### **Sediment Control**

- ☐ Protect storm drain inlets, gutters, ditches, and drainage courses with appropriate BMPs, such as gravel bags, fiber rolls, berms, etc.
- ☐ Prevent sediment from migrating offsite by installing and maintaining sediment controls, such as fiber rolls, silt fences, or sediment basins.
- ☐ Keep excavated soil on the site where it will not collect into the street.
- ☐ Transfer excavated materials to dump trucks on the site, not in the street.
- ☐ Contaminated Soils
- ☐ If any of the following conditions are observed, test for contamination and contact the Regional Water Quality Control Board:
  - Unusual soil conditions, discoloration, or odor.
  - Abandoned underground tanks.
  - Abandoned wells
  - Buried barrels, debris, or trash.

### Paving/Asphalt Wo

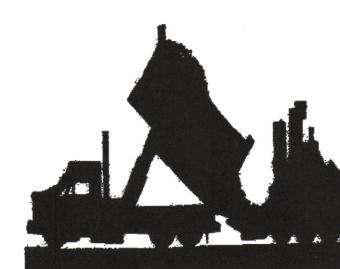


- ☐ Avoid paving and seal coating in weather, or when rain is forecast fresh pavement will have time to
- ☐ Cover storm drain inlets and mar when applying seal coat, tack cos seal, fog seal, etc.
- ☐ Collect and recycle or appropriate dispose of excess abrasive grave! Do NOT sweep or wash it into grave!
- ☐ Do not use water to wash down fasphalt concrete pavement.

#### Sawcutting & Asphalt/Concrete R

- ☐ Completely cover or barricade storain inlets when saw cutting. Uf fabric, catch basin inlet filters, or bags to keep slurry out of the storaystem.
- ☐ Shovel, abosorb, or vacuum saw-slurry and dispose of all waste as as you are finished in one location the end of each work day (which sooner!).
- ☐ If sawcut slurry enters a catch basit up immediately.

Storm drain polluters may be liable for fines of up

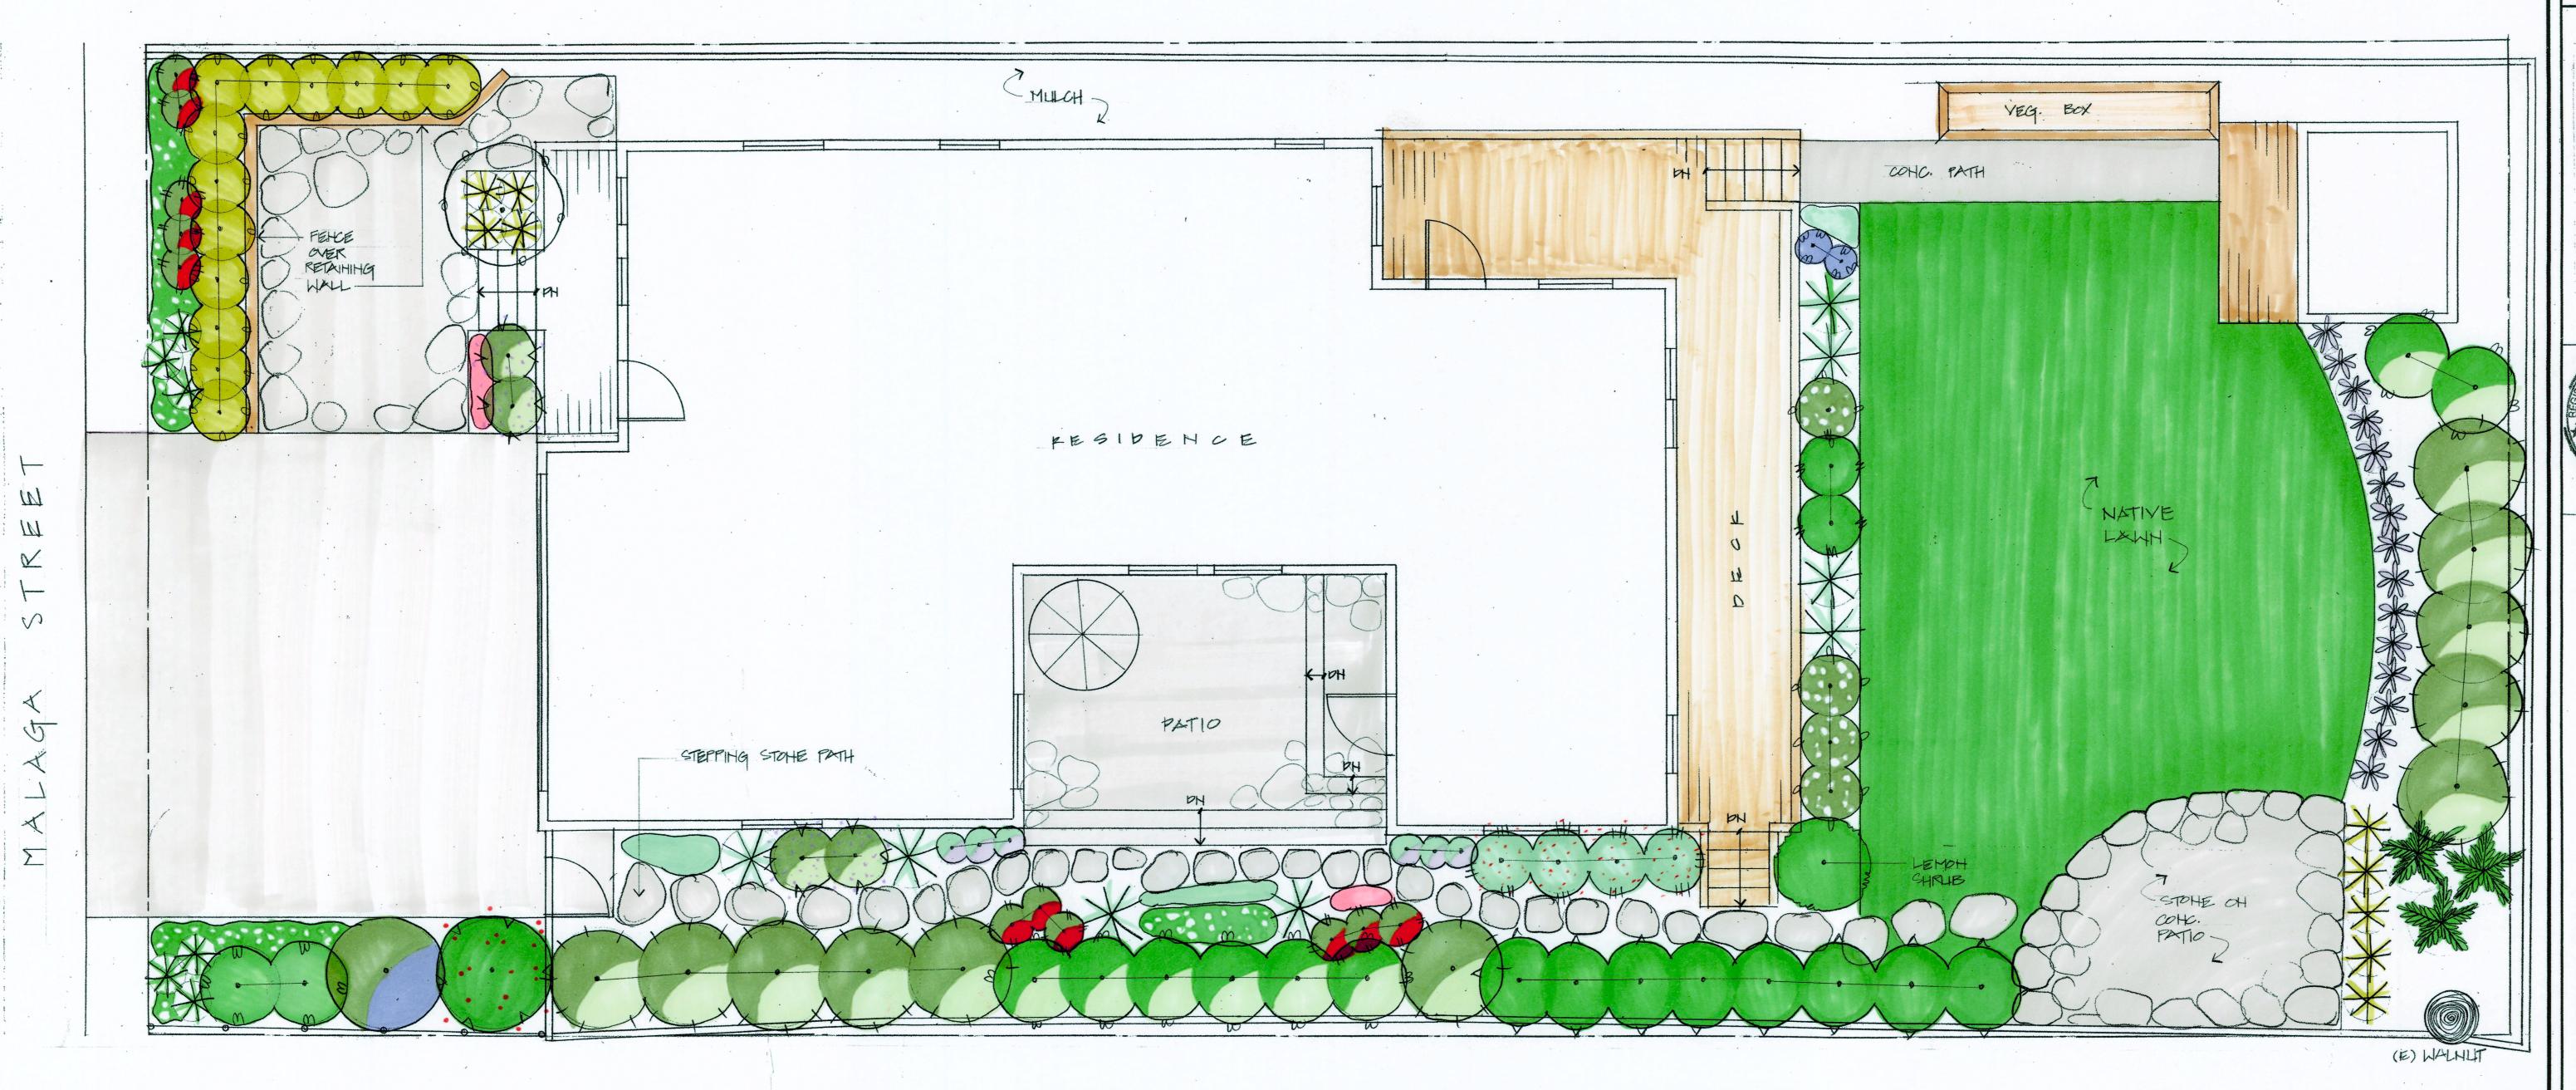

#### SCHEMATIC PLANT LIST

S	H	R	U	В	S

LATIN NAME	COMMON NAME	NATIVE	WATER USE
ARBUTUS UNEDO 'ELFIN KING'	STRAWBERRY BUSH	Х	LOW
BAMBUSA MULTIPLEX 'ALPHONSE KARR'	ALPHONSE KARR BAMBOO		LOW
CARISSA MACROCARPA	NATAL PLUM	Х	LOW
CITRUS 'IMPROVED MEYER' SHRUB FORM	MEYER LEMON		REGULAR
COPROSMA 'MARBLE QUEEN'	MIRROR PLANT		LOW
CORREA REFLEXA 'CARPENTER ROCKS'	AUSTRALIAN FUSCHIA		LOW
ESCALLONIA 'COMPAKTA'	ESCALLONIA		MODERATE
HEBE ANDERSONII 'VARIEGATA'	HEBE		REGULAR
LAVANDULA ANGUSTIFOLIA 'HIDCOTE'	ENGLISH LAVENDER		MODERATE
PHYLOSTACHYS NIGRA (IN BAMBOO BARRIER)	BLACK BAMBOO		LOW
PITTOSPORUM TOBIRA 'VARIEGATA'	PITTOSPORUM		MODERATE
ROSMARINUS OFFICINALIS 'BARBECUE'	ROSEMARY		LOW
SARCOCOCCA RUSCIFOLIA	FRAGRANT SARCOCOCCA		MODERATE

#### DEDENNIAL

LATIN NAME	COMMON NAME	NATIVE	<b>WATER USE</b>
ACHILLEA MILLEFOLIUM 'STRAWBERRY SEDUCTION'	YARROW .	X	LOW
ARGYRANTHEMUM FRUTESCENS 'SILVER LADY'	MARGUERITE DAISY		LOW
CAREX DIVULSA	BERKELEY SEDGE		LOW
ECHIUM CANDICANS	PRIDE-OF-MADEIRA	Х	LOW
LIMONIUM PEREZII	STATICE		MODERATE
PENNISETUM ORIENTALE 'KARLEY ROSE'	FOUNTAIN GRASS		MODERATE
TULBAGHIA VIOLACEA	SOCIETY GARLIC		MODERATE
WOODWARDIA FIMBRIATA	GIANT CHAIN FERN	X	MODERATE

#### GROUND COVER

LATIN NAME	<b>COMMON NAME</b>	NATIVE	<b>WATER USE</b>
ARMERIA MARITIMA	SEA PINK	X	LOW
COTYLEDON ORBICULATA 'PIG'S EAR'	COTYLEDON		LOW
DYMONDIA MARGARETAE	DYMONDIA		MODERATE
ECHEVERIA ELEGANS	HEN AND CHICKS		MODERATE
ERIGERON GLAUCUS 'CAPE SEBASTIAN'	SEASIDE DAISY	Х	LOW
SEDUM RUPESTRE 'ANGELINE'	STONECROP		LOW

#### JAPANESE ENTRY GARDEN

LATIN NAME	COMMON NAME	NATIVE	WATER USE
FAMILY JAPANESE MAPLE FROM POT	JAPANESE MAPLE		REGULAR
HAKONECHLOA MACRA 'AUREOLA'	JAPANESE FOREST GRASS		REGULAR

H

SCHEMATIC LANDSCAPE PLAN

Of 1 Sheets