

Application for Design Review by the

County Government Center •	455	County Center *	Redwood	City CA 94063	3
		■ 650 · 363 · 416			

Permit #: PLN .	2014-	0025	7	
Othor Down #				
Other Permit #:				

County Coastside Design	Permit #: PLN 10/4- 6065		
Review Committee	Other Permit #:		
Ferror information			
Applicant:	Owner (if different from Applicant): SAME		
Name: Joanna Livadas	Name:		
Address: 128 Alla Mesa Dr.	Address:		
SOUTH SAN FRANCISCO CAZID: 94080	Zjp		
Phone, W: 650.450.2475 H: 650.450.2475	Phone,W: H:		
Email: joanna. livadus @ nocketmail. com	Email:		
Architect or Designer (if different from Applicant):			
Name: 3NORTH MORGAN PIERCE			
Address: 427 Bryant Street, San Francisco,	СА Zip: 9407		
·	Email: mpierce@3north.com		
	· · · · · · · · · · · · · · · · · · ·		
2 Project Site Information			
Project location:	Site Description:		
APN: 037-131+110	☑ Vacant Parcel		
Address: EUGNDALE + CALIFORNIA	☐ Existing Development (Please describe):		
moss beach, ca Zip: 94038			
Zoning: R1/S-17/D/Z			
Parcel/lot size: 100' x 50' 5000 sq. ft.			

Project:

- New Single Family Residence: 1752. sq. ft

 Addition to Residence: Wdefached 417 4f

 garage sq. ft
- Other:

Describe Project:

2 level home with detached garage. Kit home is green (low impact). Roof top patio on garage and curred pations back of house. Landscape plan includes low water reginrement plants and trees & a lap pool.

Additional Permits Required:

- Certificate of Compliance Type A or Type B
- Coastal Development Permit
- Fence Height Exception (not permitted on coast)
- Grading Permit or Exemption
- Home Improvement Exception
- Non-Conforming Use Permit
- Off-Street Parking Exception
- □ Variance

Fill in Blanks:	Material	Color/Finish (If different from existing, attach sample)	Check if matches existing
a. Exterior walls	viny/fiber cement/state	attached	S
b. Trim	ind	K	¥
c. Windows	Aluminium		
d. Doors	Wood		M
e. Roof	Fiberglass Asphalt Shingles		₩ W
f. Chimneys	W/A		
g. Decks & railings	Lood		
h, Stairs	wood/metal	· · · · · · · · · · · · · · · · · · ·	
. Retaining walls	NA NA	1 3 1 1 1 1 1 1 1 1 1 1 1 1 1 1 1 1 1 1	
j. Fences	Wood	light stain-Summer wheat	
k, Accessory buildings	NIR		
I. Garage/Carport	same as house	the second of the second	
ncluding the required fi applicable to the locatio	ion; the County must determine that this proint indings that the project does conform to the n of the project pursuant to Section 6565.1 ant's Statement of project compliance with s	e standards and guidelines for design r 0.	eview
I hereby certify that the support of the application	information stated above and on forms, pla on is true and correct to the best of my know assigned project planner of any changes to	viedge. It is my responsibility to inform	the County of
	La		
Owner:	Applica	nt;	
		er a grant Germala Maria Sente Grant Sente	
7-17-14			
Date:	Date:	***************************************	

Environmental Information Disclosure Form

PLN 2014-0025 |

BLD_


		MOSS BEACH ICA 94038	Name of Owner: JOHNNA LIVADAS Address: 128 ALTA MESA DR.
		THE DENCY POT 1 1008	au o
			SWITT SAN FRANCISCO, CA. Phone: 650-450-2475
sesso	or's Parc	el No.: 637 — 131 — 110	Name of Applicant: SAME
<u> </u>			Address:
ning	District:	RI/SI7/DR/CD	Phone:
	a de la constante de la consta	Site Conditions	1
		'x 50' 5000 SF	
			uses on the project parcel, including the existence and
rpose	of anv e	asements on the parcel, and a description of	any natural features on the project parcel (i.e. steep terrain,
	vegetatio		any matara realaree on the project pareer (no. steep terrain,
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45 W T			
ΠV	ronm	ental Review Checklist	
C a	lifornia	Environmental Quality Act (CEQA)	ECVICW TO THE REPORT OF THE PROPERTY OF THE PR
	No		09/19/4
95		Will this project involve:	
9 s 	X	a. Addition to an existing structure > 50% of	
es -	X		
es	X	a. Addition to an existing structure > 50% of	ential structure having 5 or more units?
	X	 a. Addition to an existing structure > 50% of b. Construction of a new multi-family residence. c. Construction of a commercial structure of d. Removal of mature tree(s) (≥ 6" d.b.h. in 	ential structure having 5 or more units?
	X	 a. Addition to an existing structure > 50% of the construction of a new multi-family residence. b. Construction of a commercial structure : d. Removal of mature tree(s) (≥ 6" d.b.h. in residential zoning district)? 	ential structure having 5 or more units? > 2,500 sq.ft? n Emerald Lake Hills area or ≥ 12" d.b.h. in any
es X	X	 a. Addition to an existing structure > 50% of the construction of a new multi-family resident. b. Construction of a new multi-family resident. c. Construction of a commercial structure of the commer	ential structure having 5 or more units? > 2,500 sq.ft? n Emerald Lake Hills area or ≥ 12" d.b.h. in any
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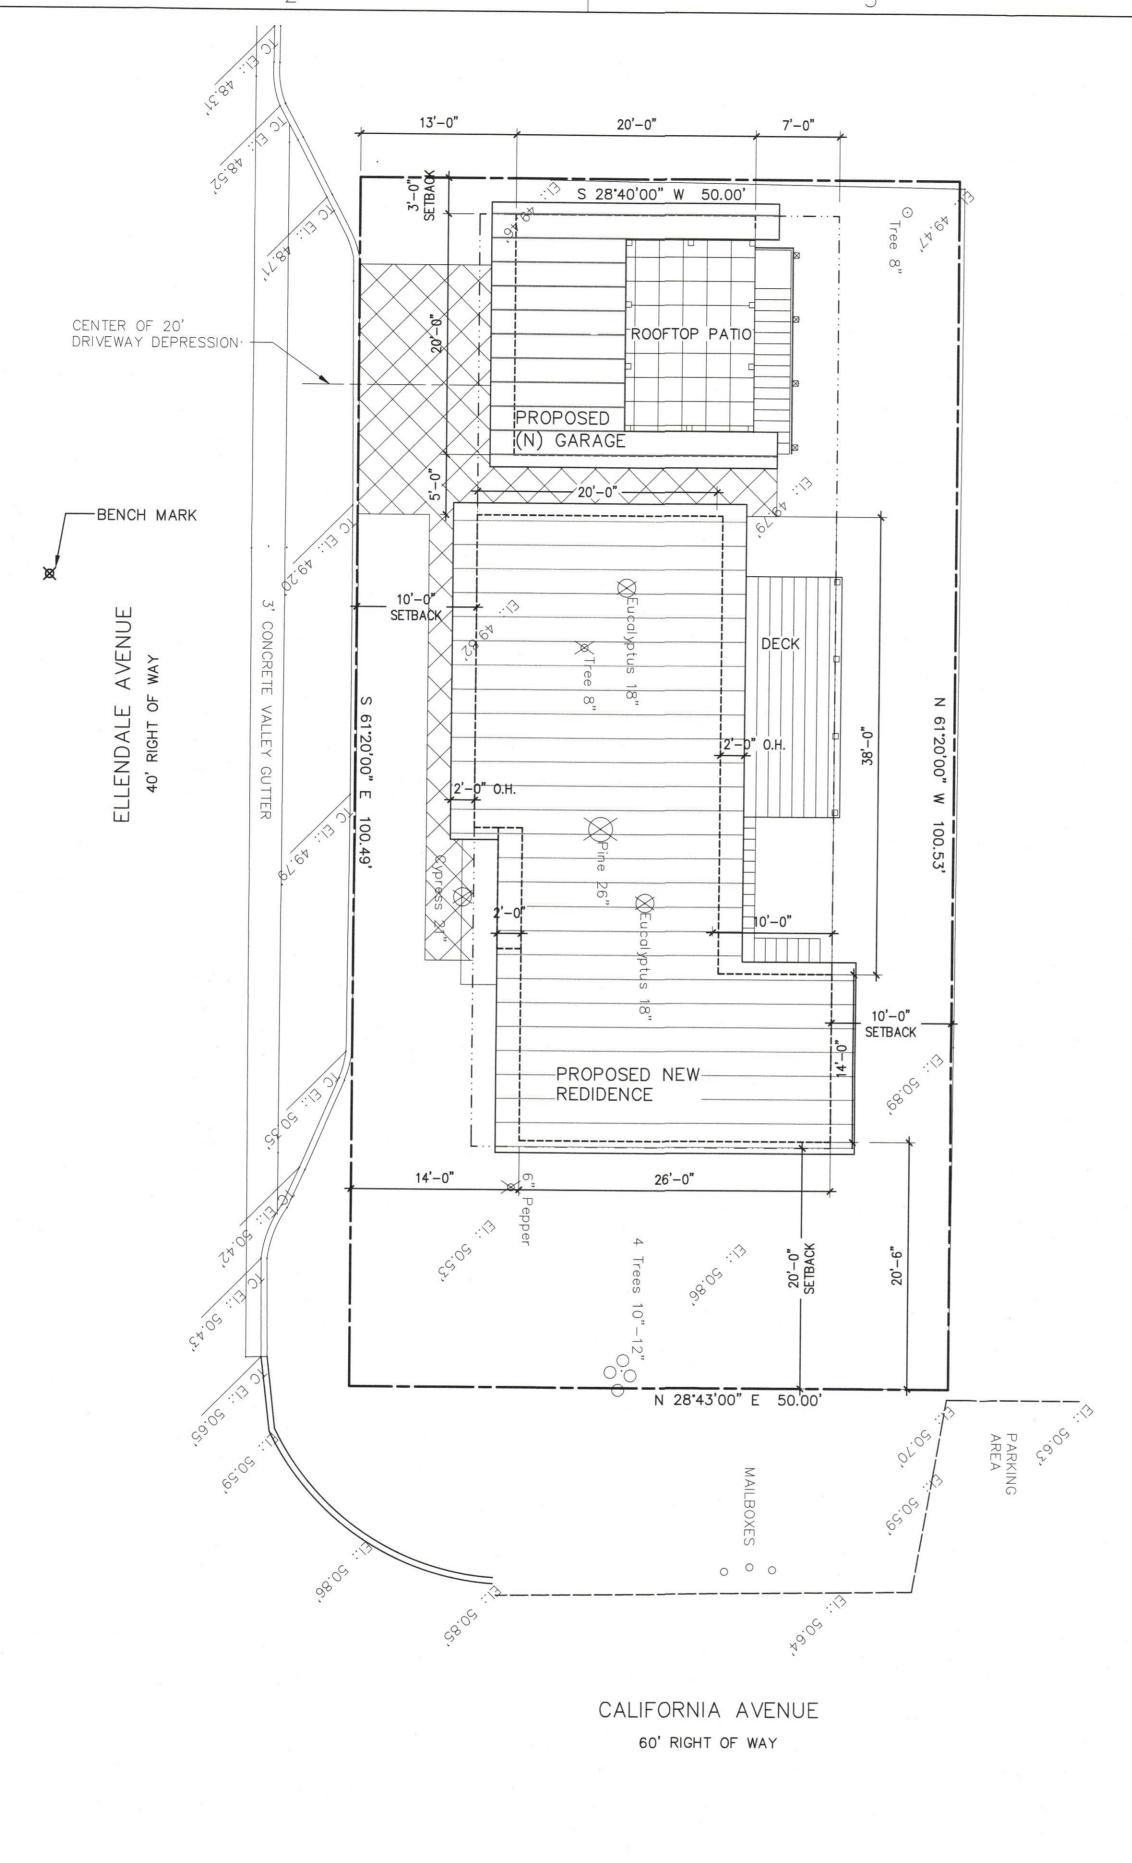
	No	Will the project involve:
	X	a. Construction outside of the footprint of an existing, legal structure?
	х	b. Exterior construction within 100-feet of a stream?
x c. Construction, maintenance or use of a road, bridge, or trail on a stream bank or unstable hill slope?		
	×	d. Land-use within a riparian area?
e. Timber harvesting, mining, grazing or grading?		
	×	f. Any work inside of a stream, riparian corridor, or shoreline?
	Σ	g. Release or capture of fish or commerce dealing with fish?
lease	explain	any "Yes" answers:
	·	
. Nat	lonal P	ollutant Discharge Elimination System (NPDES) Review Will the project involve:
		a. A subdivision or Commercial / Industrial Development that will result in the addition or replacement 10,000 sq. ft. or more of impervious surface?
	X	If yes, Property Owner may be required to implement appropriate source control and site design measures and to design and implement stormwater treatment measures, to reduce the discharge of stormwater pollutants. Please consult the Current Planning Section for necessary forms and both construction and post-construction requirements.
		b. Land disturbance of 1 acre or more of area?
		If yes, Property Owner must file a Notice of Intent (NOI) to be covered under the statewide General Construction Activities Storm Water Permit (General Permit) <u>prior</u> to the commencement of construction activity. Proof of coverage under State permit must be demonstrated prior to the issuance of a building permit.
		todation of a containing polymer
	•	E.
	1	 b. <u>Land disturbance of 1 acre or more of area?</u> If yes, Property Owner must file a Notice of Intent (NOI) to be covered under the statewide Ger Construction Activities Storm Water Permit (General Permit) <u>prior</u> to the commencement of construction activity. Proof of coverage under State permit must be demonstrated prior to the


Date: 17-17

22010-2.vp 5/28/09 rp

Signed:



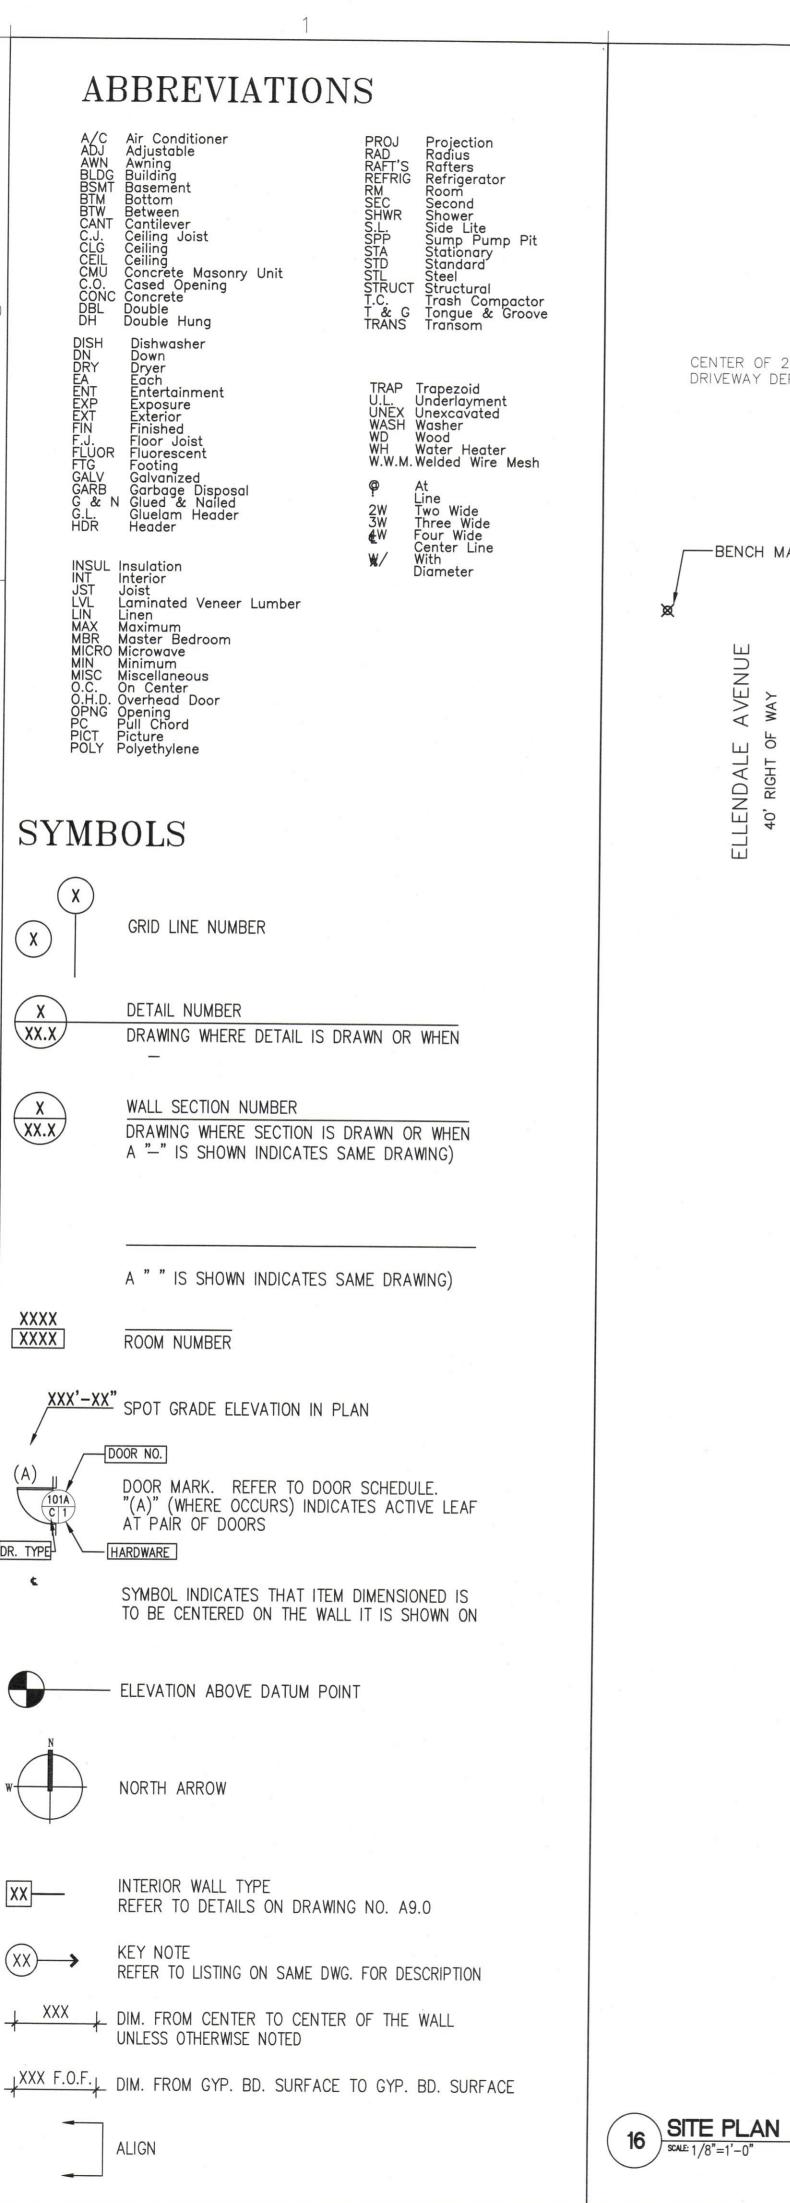

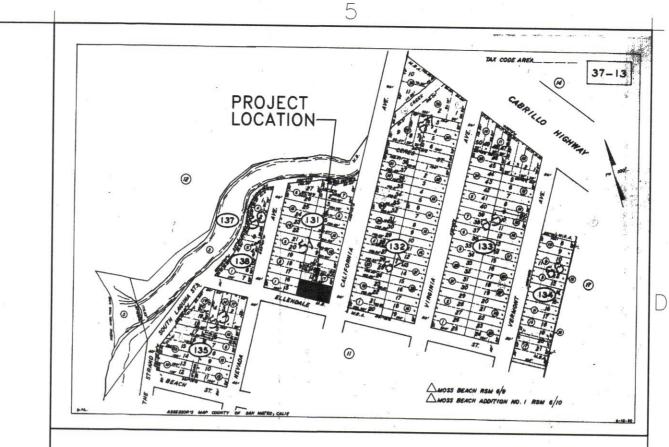

VICINITY MAP
SCALE N.T.S.

DRAWING INDEX

<u>ARCHITECTURAL</u>

A-1 COVER SHEET, SITE PLAN

A-2 FLOOR PLANS

A-3 ROOF PLANS

A-4 HOUSE ELEVATIONS

A-5 GARAGE ELEVATIONS, SECTION

PROJECT DATA

SCOPE OF WORK:

A NEW 2 STORY RESIDENCE, A 2 CAR GARAGE.

1st floor: 2nd floor:

1,100 sf 1,100 sf

Garage:

400 sf

Lot size:

 $\pm 5,025.4$ sf

Allowable Lot Coverage: 0.35 x 5,024.5=1,758.5 sf

(N) Lot Coverage:

1,753 sf

Allowable FAR:

 $0.53 \times 5,024.5 = 2,663 \text{ sf}$

(N) FAR:

 $\pm 2,600 \text{ sf}$

037-131-110

APPLICANT: JOANNA LIVIDAS

128 ALTA MESA

SOUTH SAN FRANCISCO, CA 94080

SUMMARY

ZONING: LOT AREA SQ.FTG.: R-1/S-17/DR/CD

5,025.4 S.F. Approx.

CODE EDITION: 2013 CBC, 2013 CALIFORNIA RESIDENTIAL CODE (WHERE APPLICABLE), 2013 CFC, 2013 CPC, 2013 CMC, 2013 CEC, AND CITY OF MOSS BEACH ORDINANCE INCLUDING ANY AND ALL APPLICABLE LOCAL, STATE AND FEDERAL CODES, LAWS, AND REGULATIONS.

Joanna Livadas

128 Alta Mesa South San Francisco CA 94080 TEL: 650/450-2475

CONSULTANTS:

PROJECT:

101 California Ave. Moss Beach, CA

△ DATE DESCRIPTION


PROJ. NO: 15-04.01 CAD DWG FILE: DRAWN BY: DESIGNER: CHK'D BY: DATE: 6/26/2015

> COVER SHEET

SHEET NUMBER:


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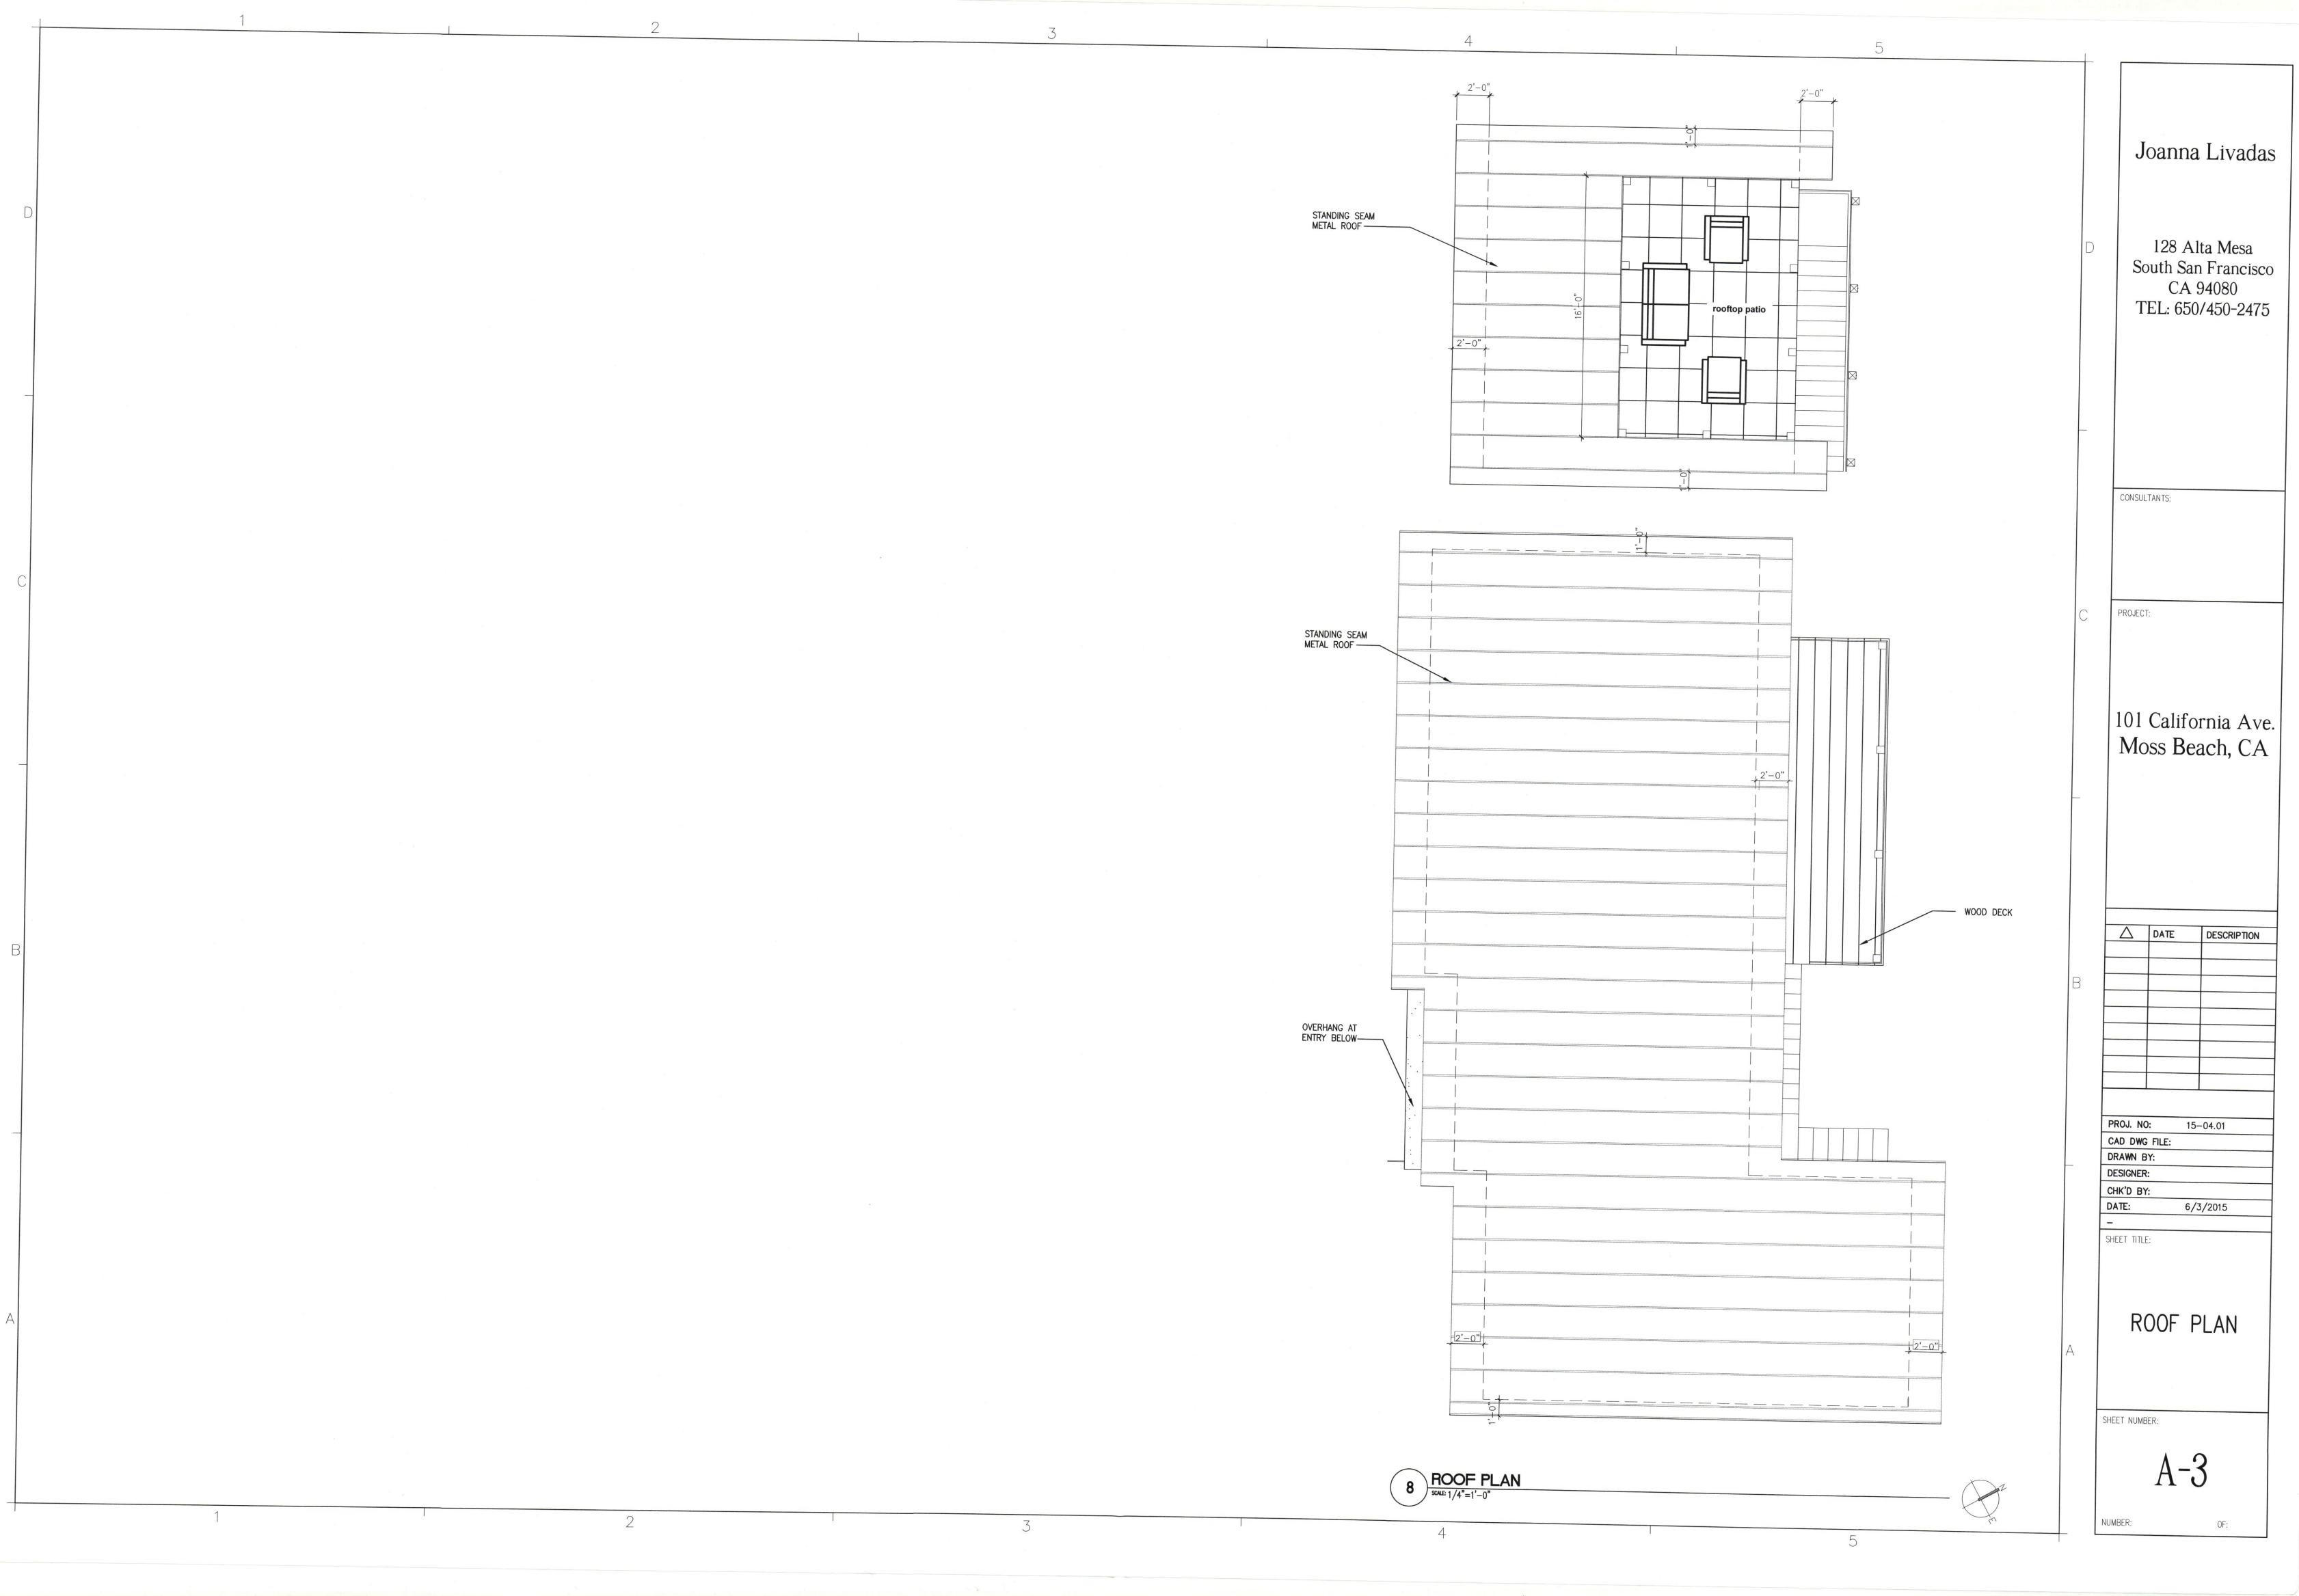



RECEIVED

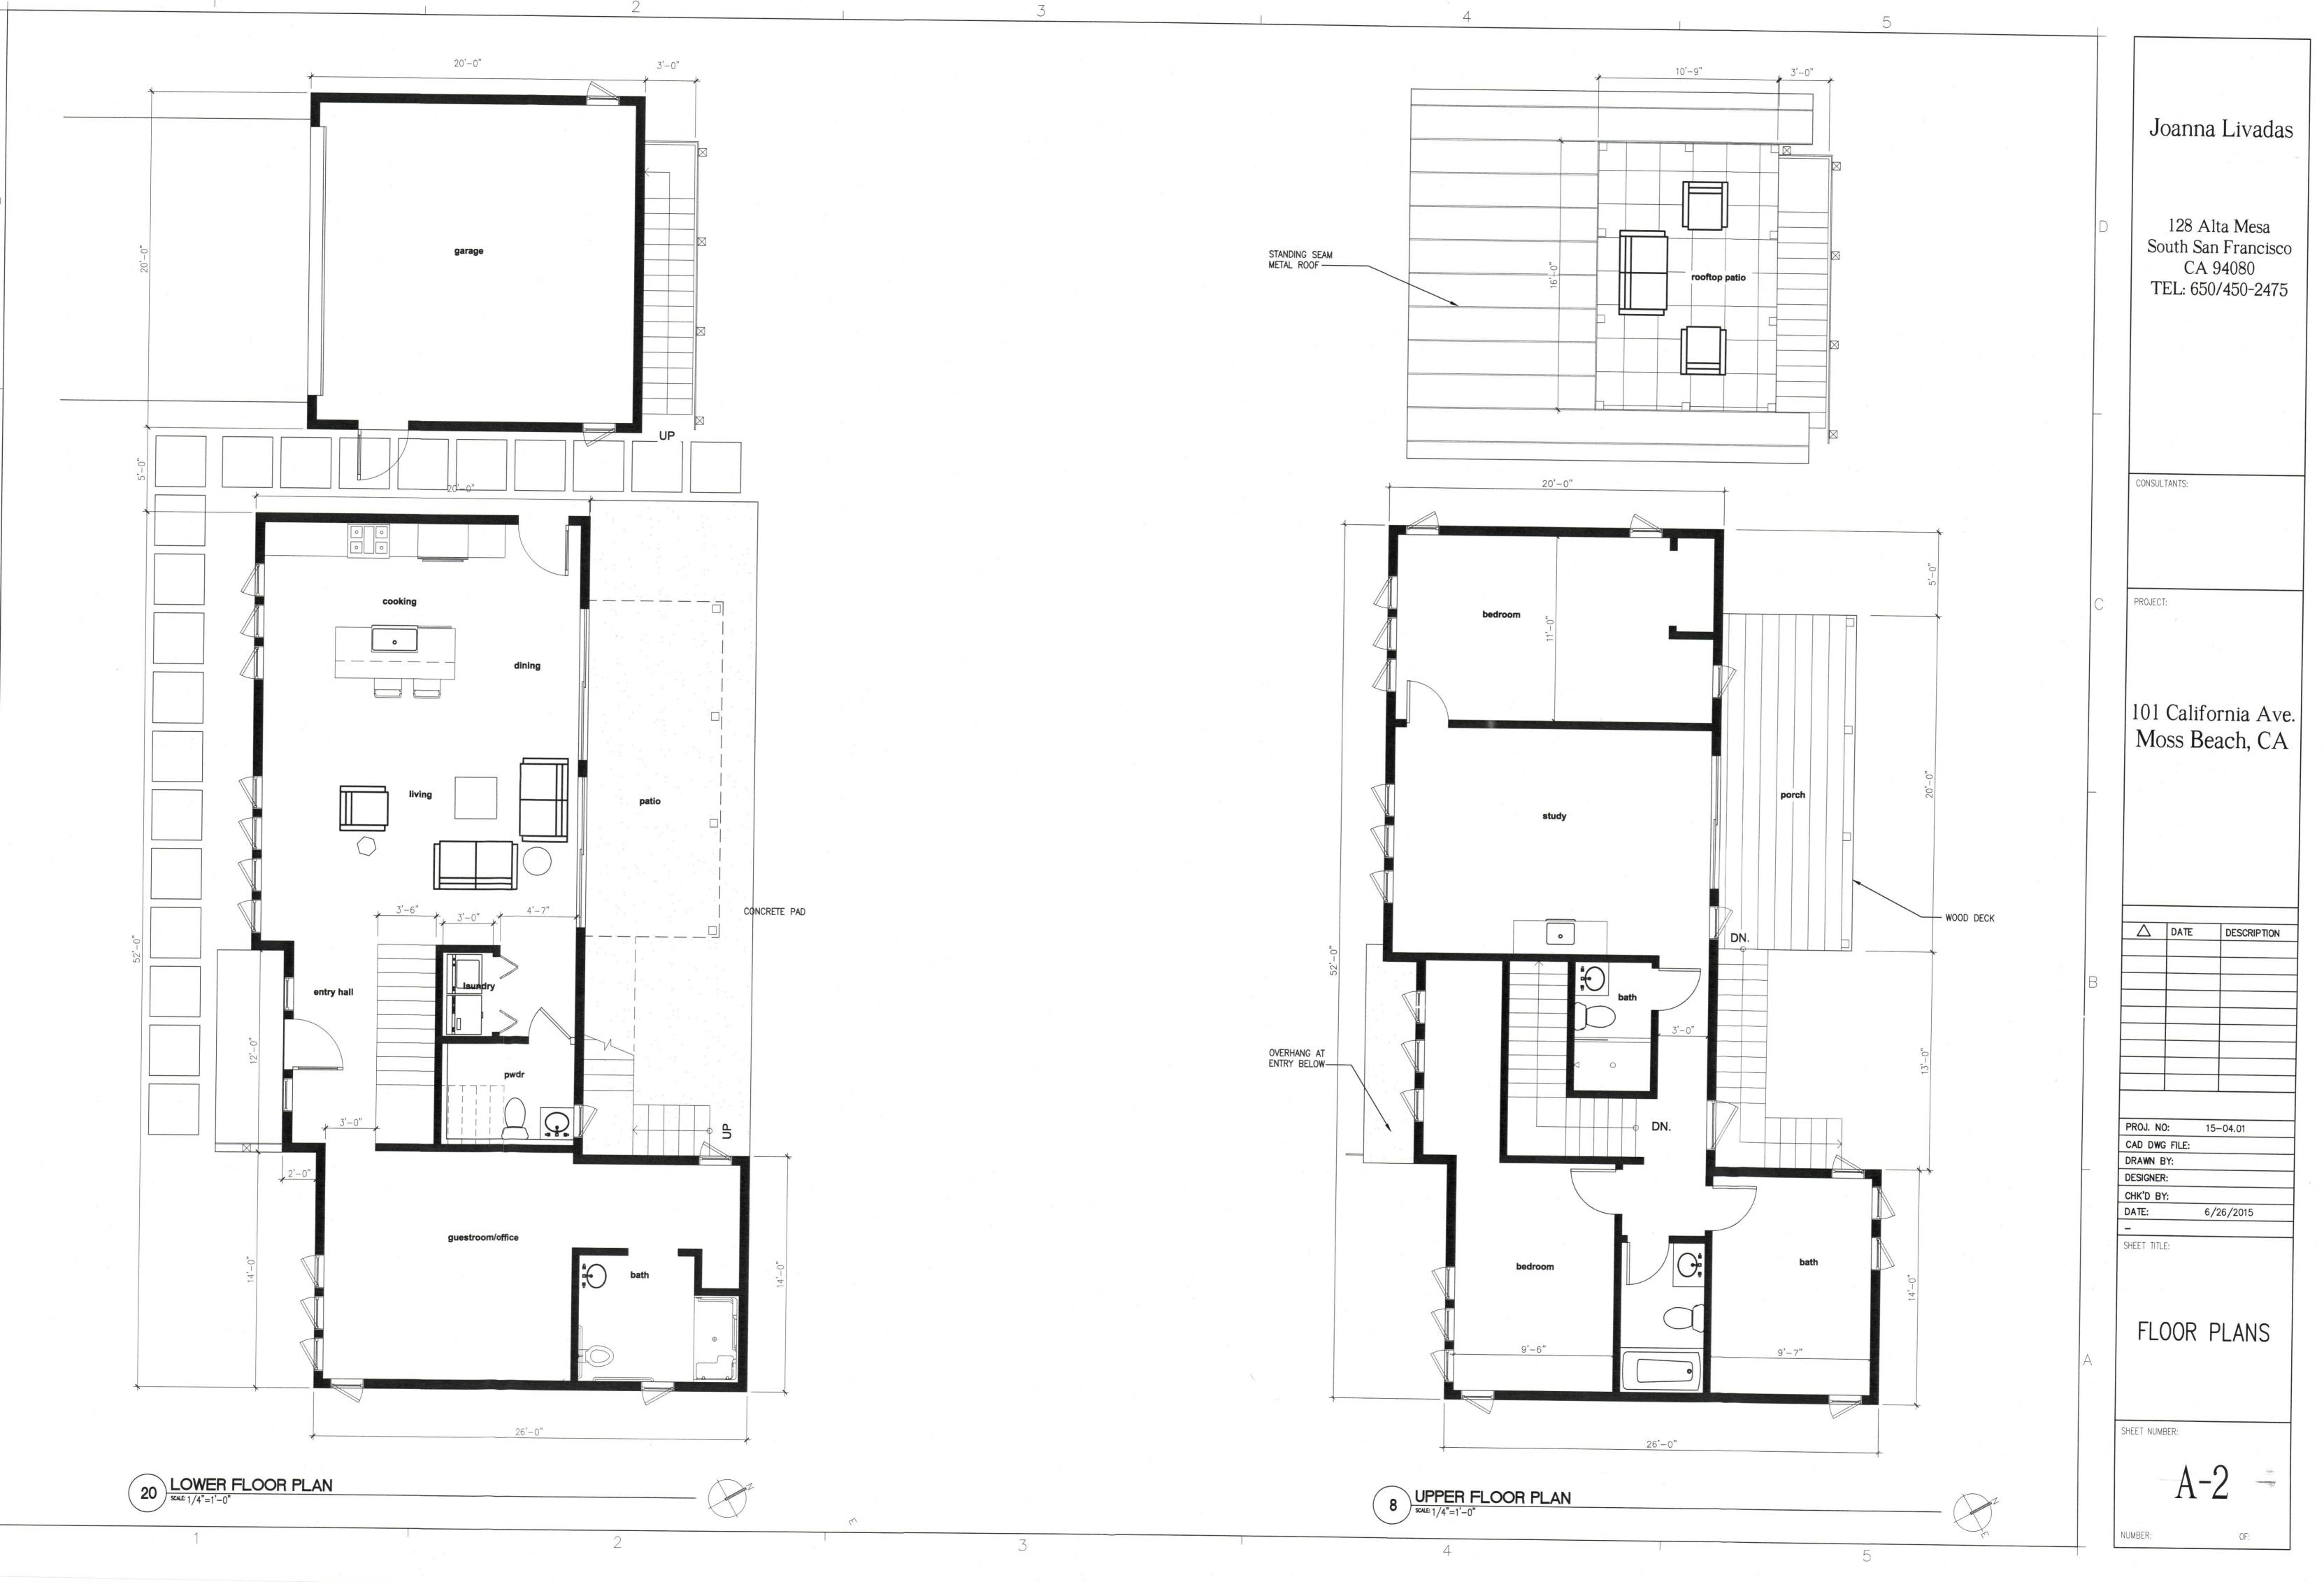



101 California Ave. Moss Beach, CA

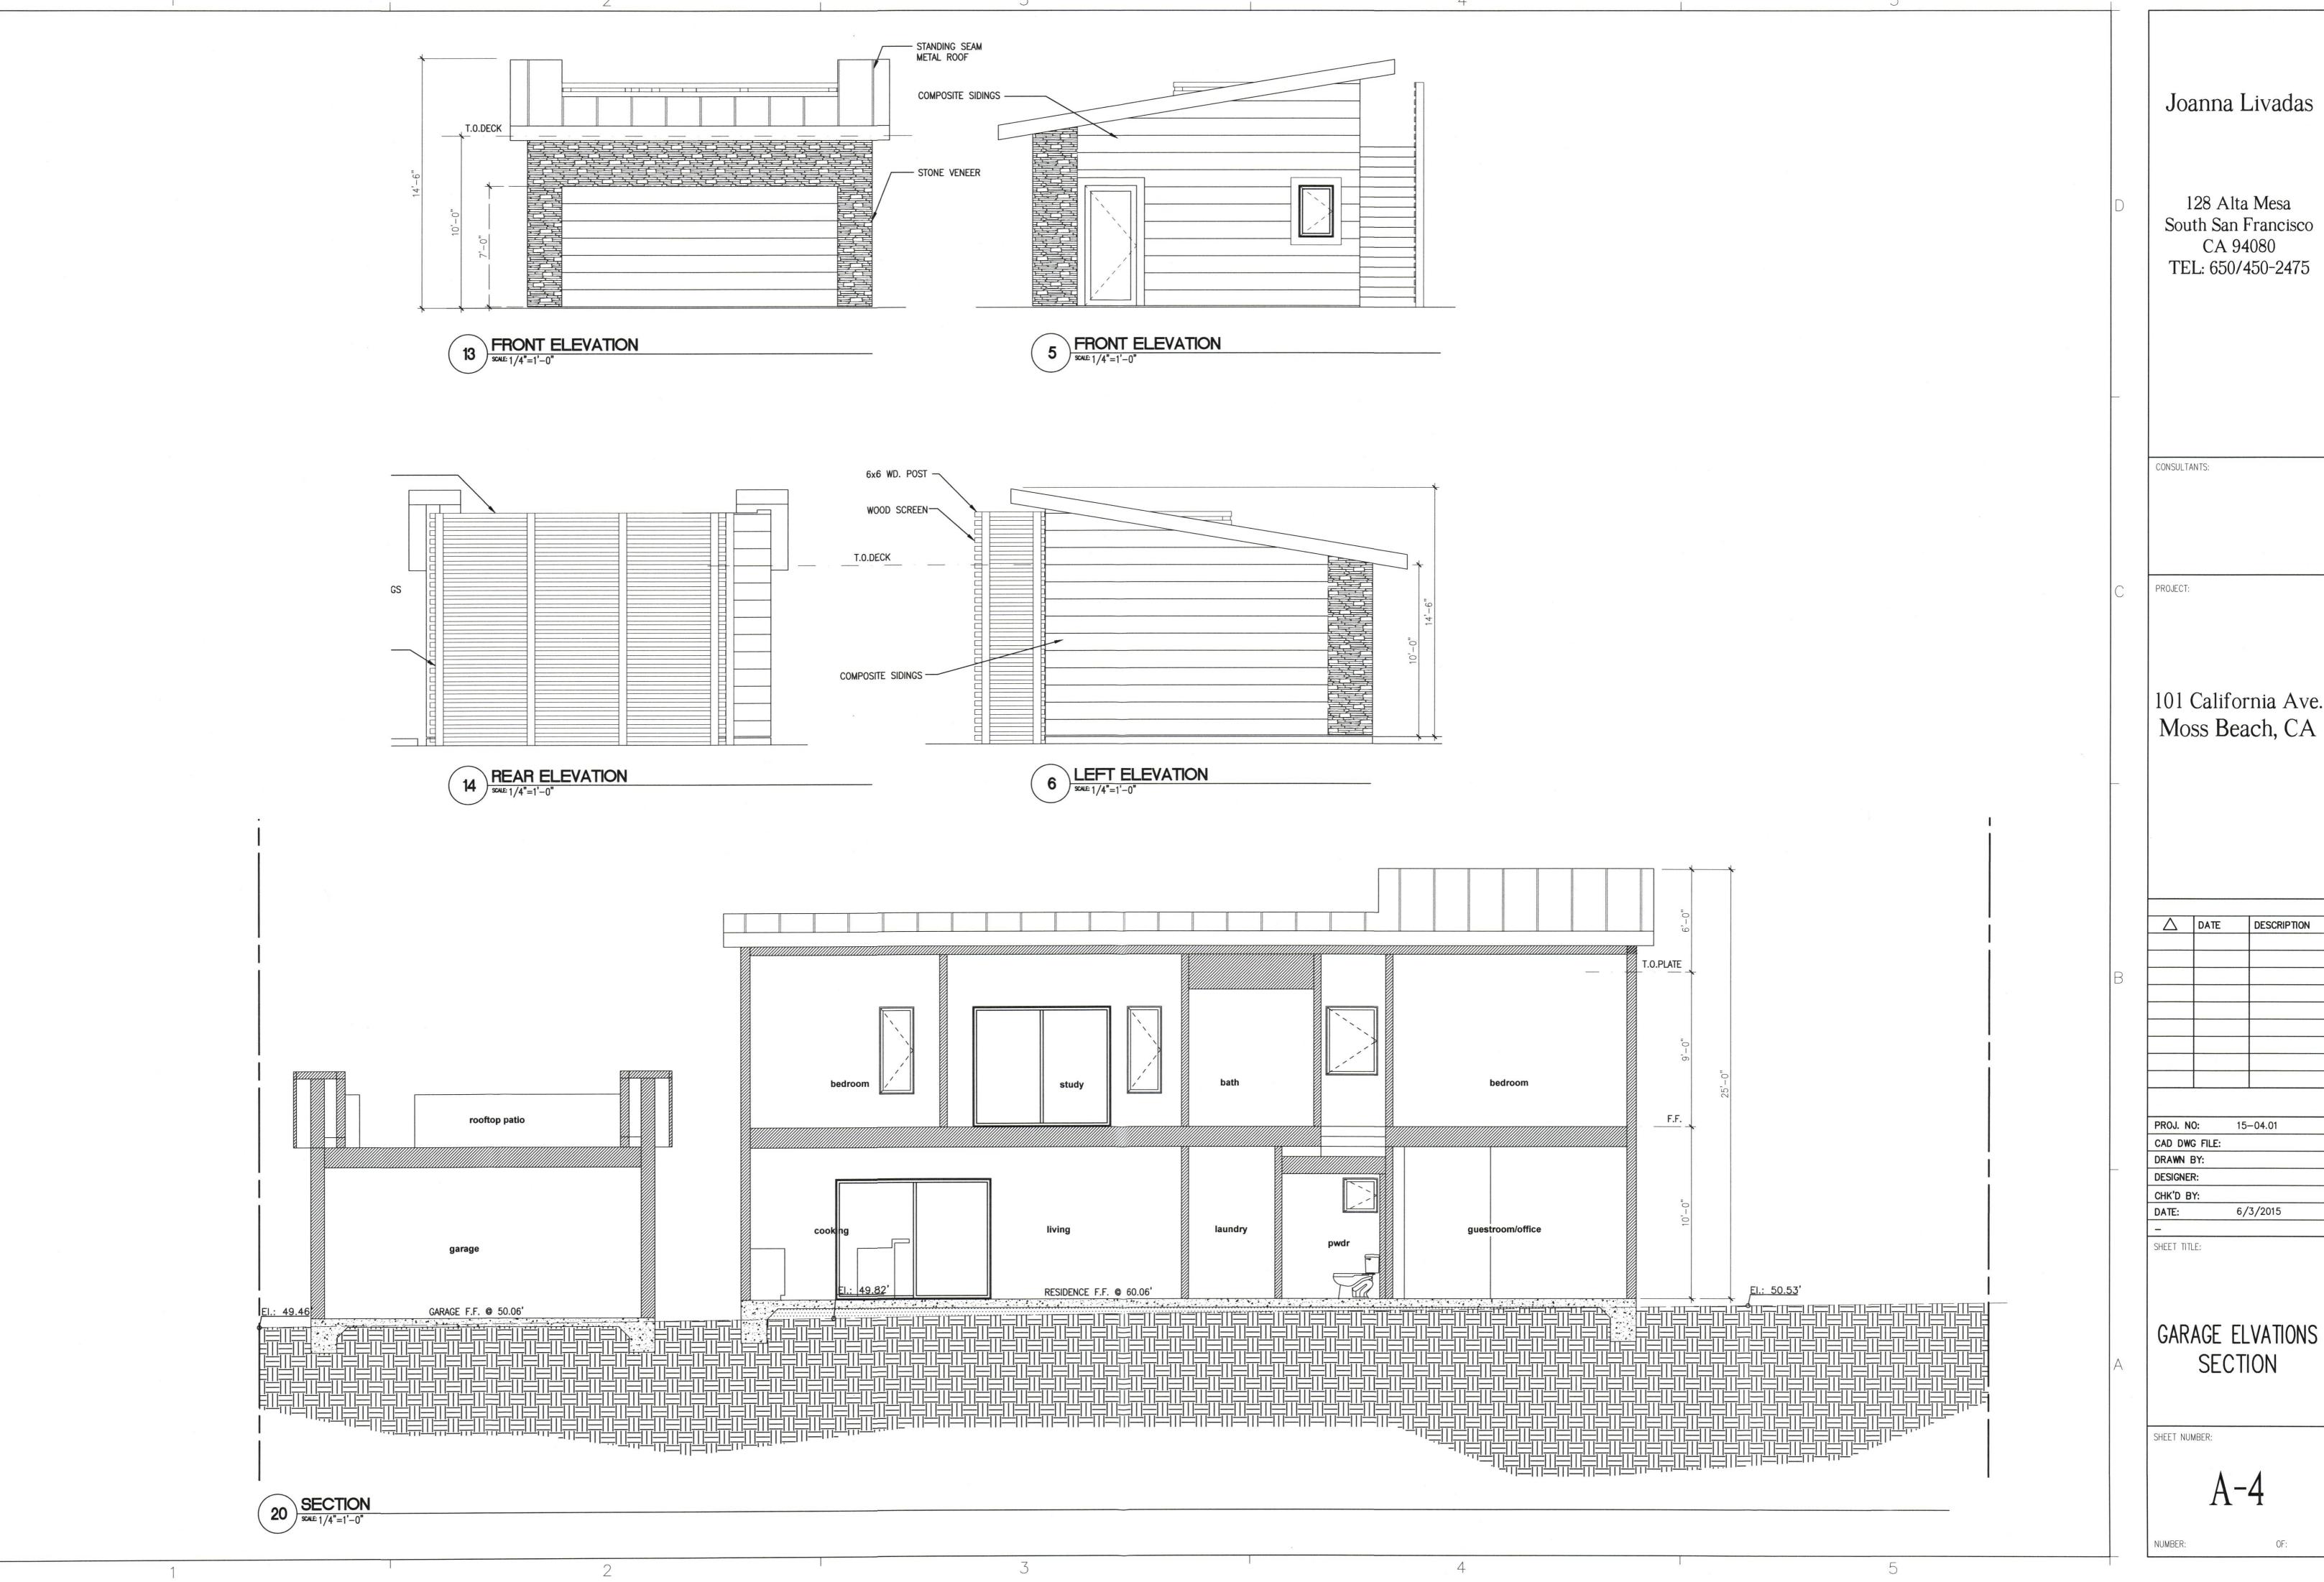

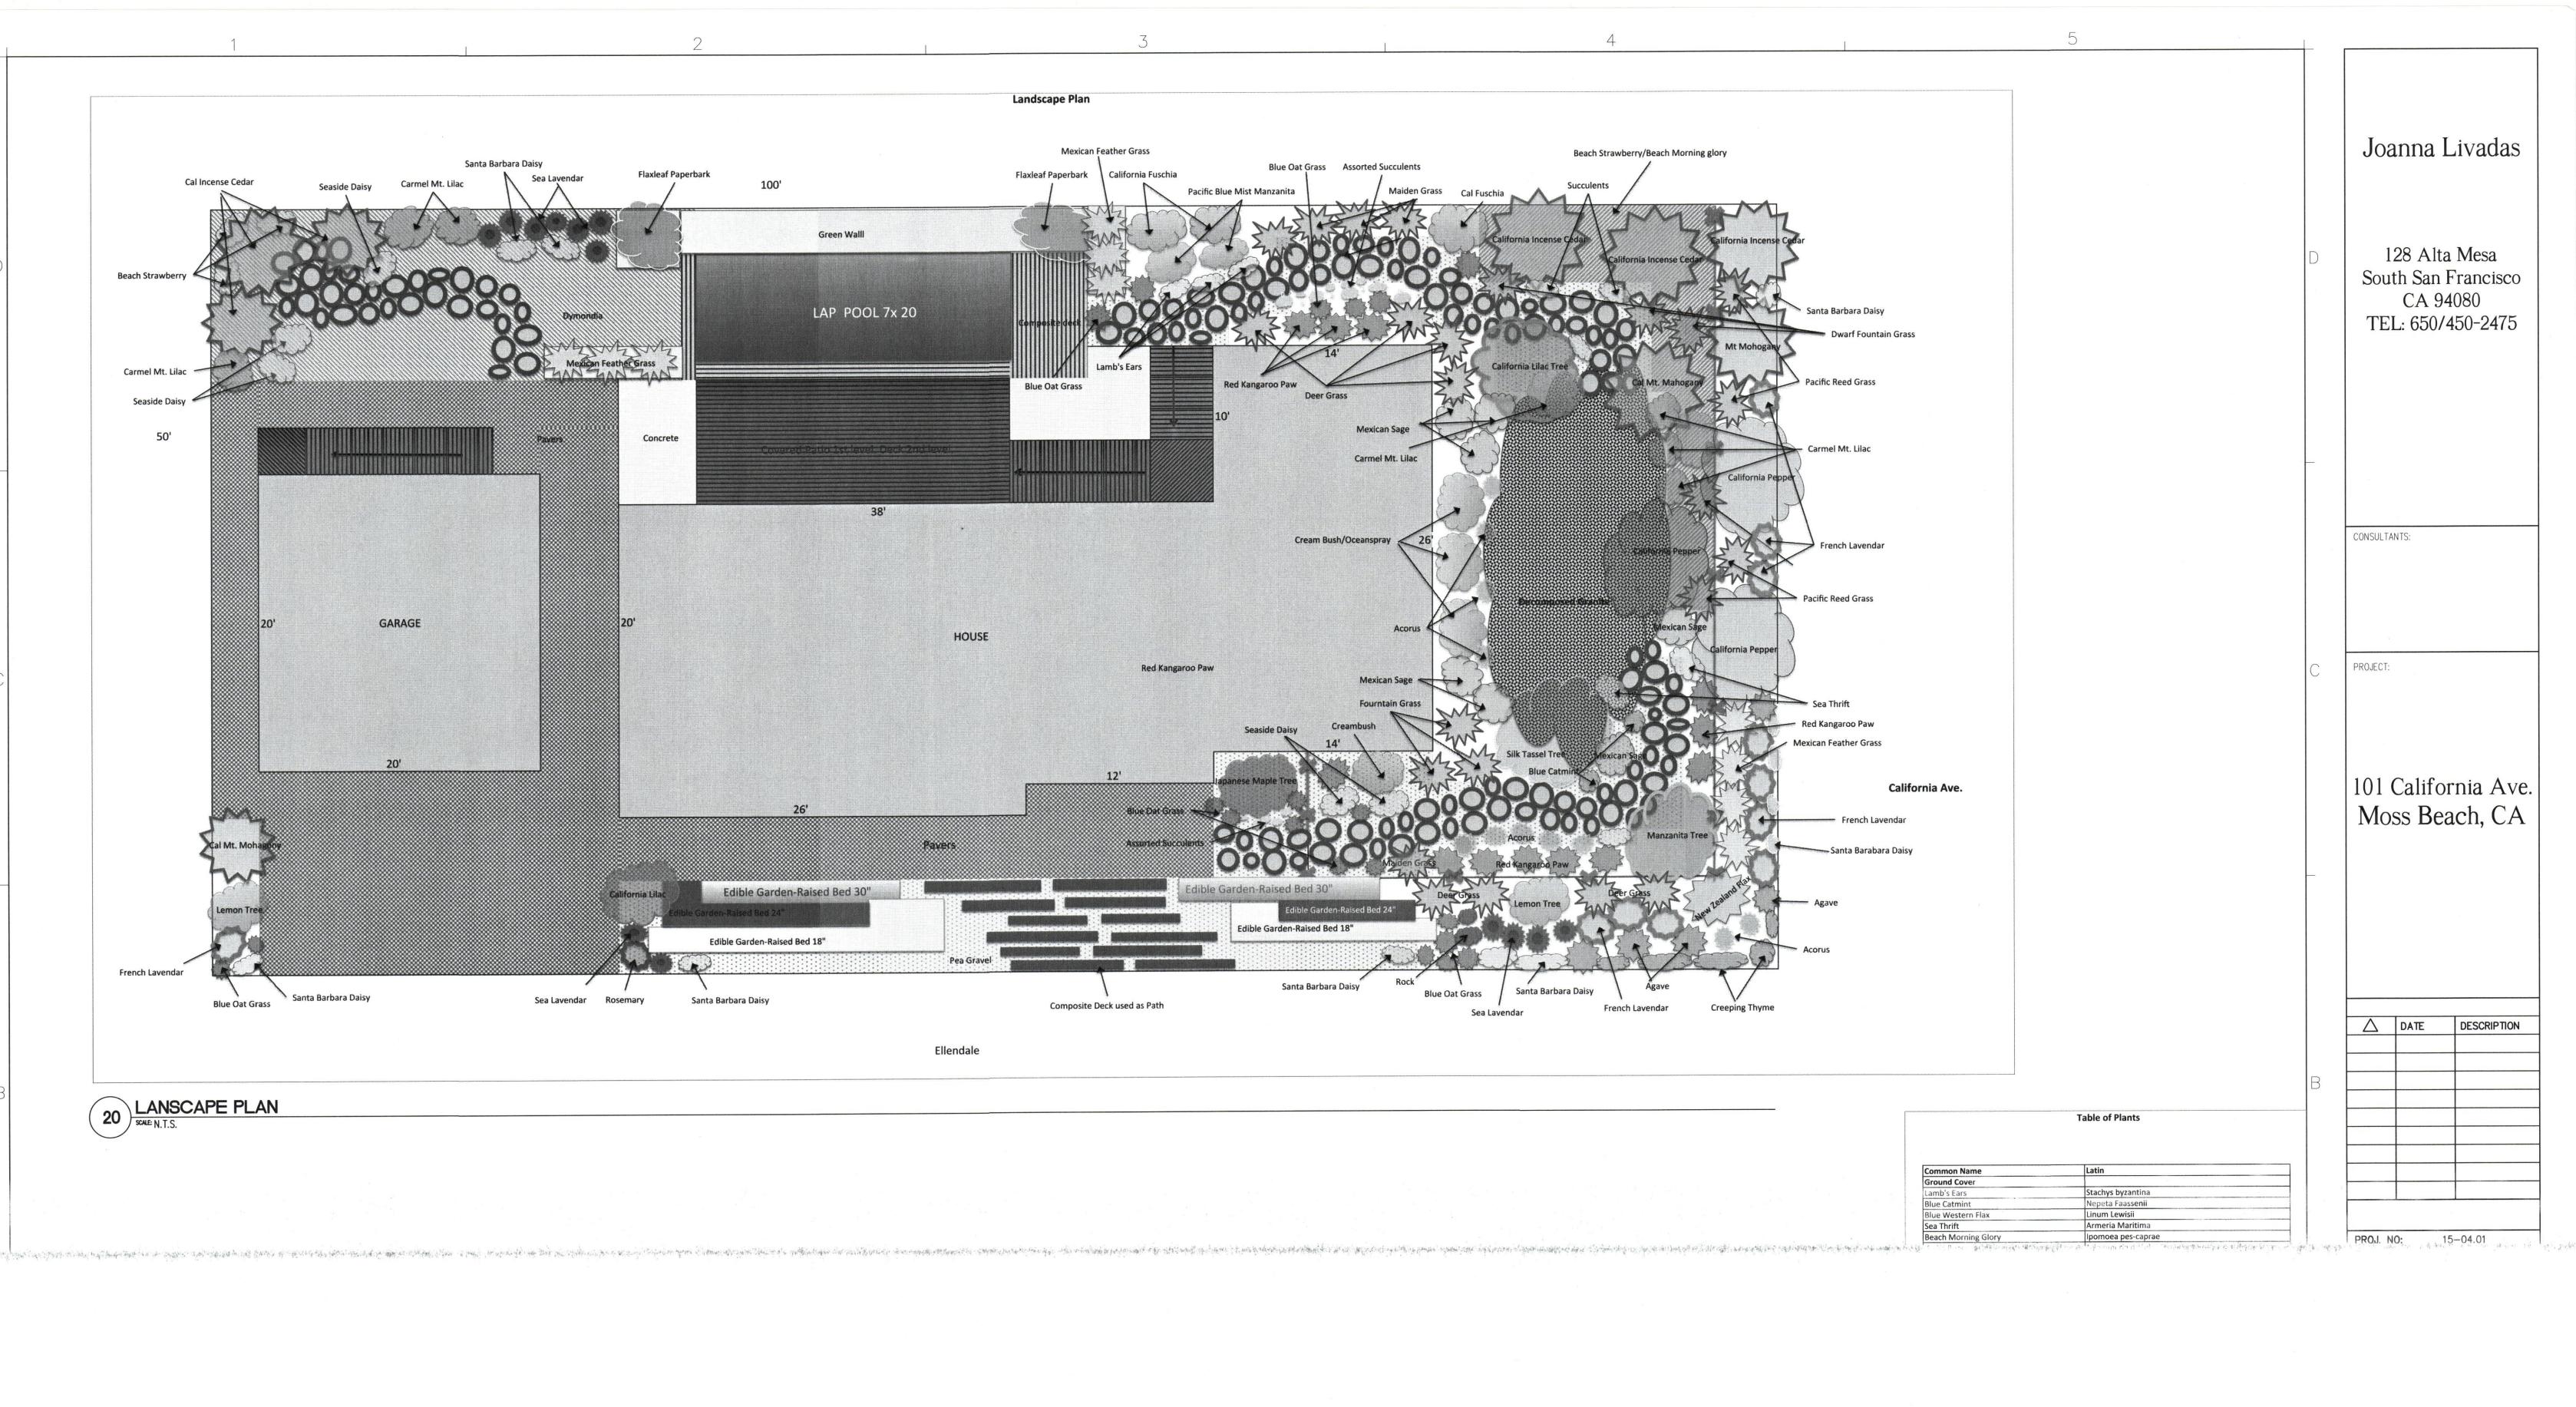

Erigeron glaucus
Holodiscus discolor California Lilac Assorted Succulents Grasses
Maiden grass
Deer Grass Miscanthus sinensis 'Gracillimus. Muhlenbergia rigens Mexican Feather Grass Blue Oat Grass Dwarf Fountain Grass Helictotrichon sempervirens Pennisetum alopecuroides 'Hameln' Purple Fountain Grass
Pacific reed grass Pennisetum Setaceum "Rubrum" Calamagrostis nutkaensis Arctostaphylos Ceanothus 'Concha' Manzanita California Lilac **NOTES** Calocedrus decurrens California Incense Cedar Schinus molle California Pepper California Mountain Mohagany Cercocarpus betuloides -Irrigation is drip through out. Flaxleaf Paperbark Melaleuca linariifolia -All plants native to California, most are coastal natives and apanese Maple Bloodgood Acer palmatum atropurpureum drought tolerant. Garrya elliptica -Pavers are pervious.

LANSCAPE PLAN


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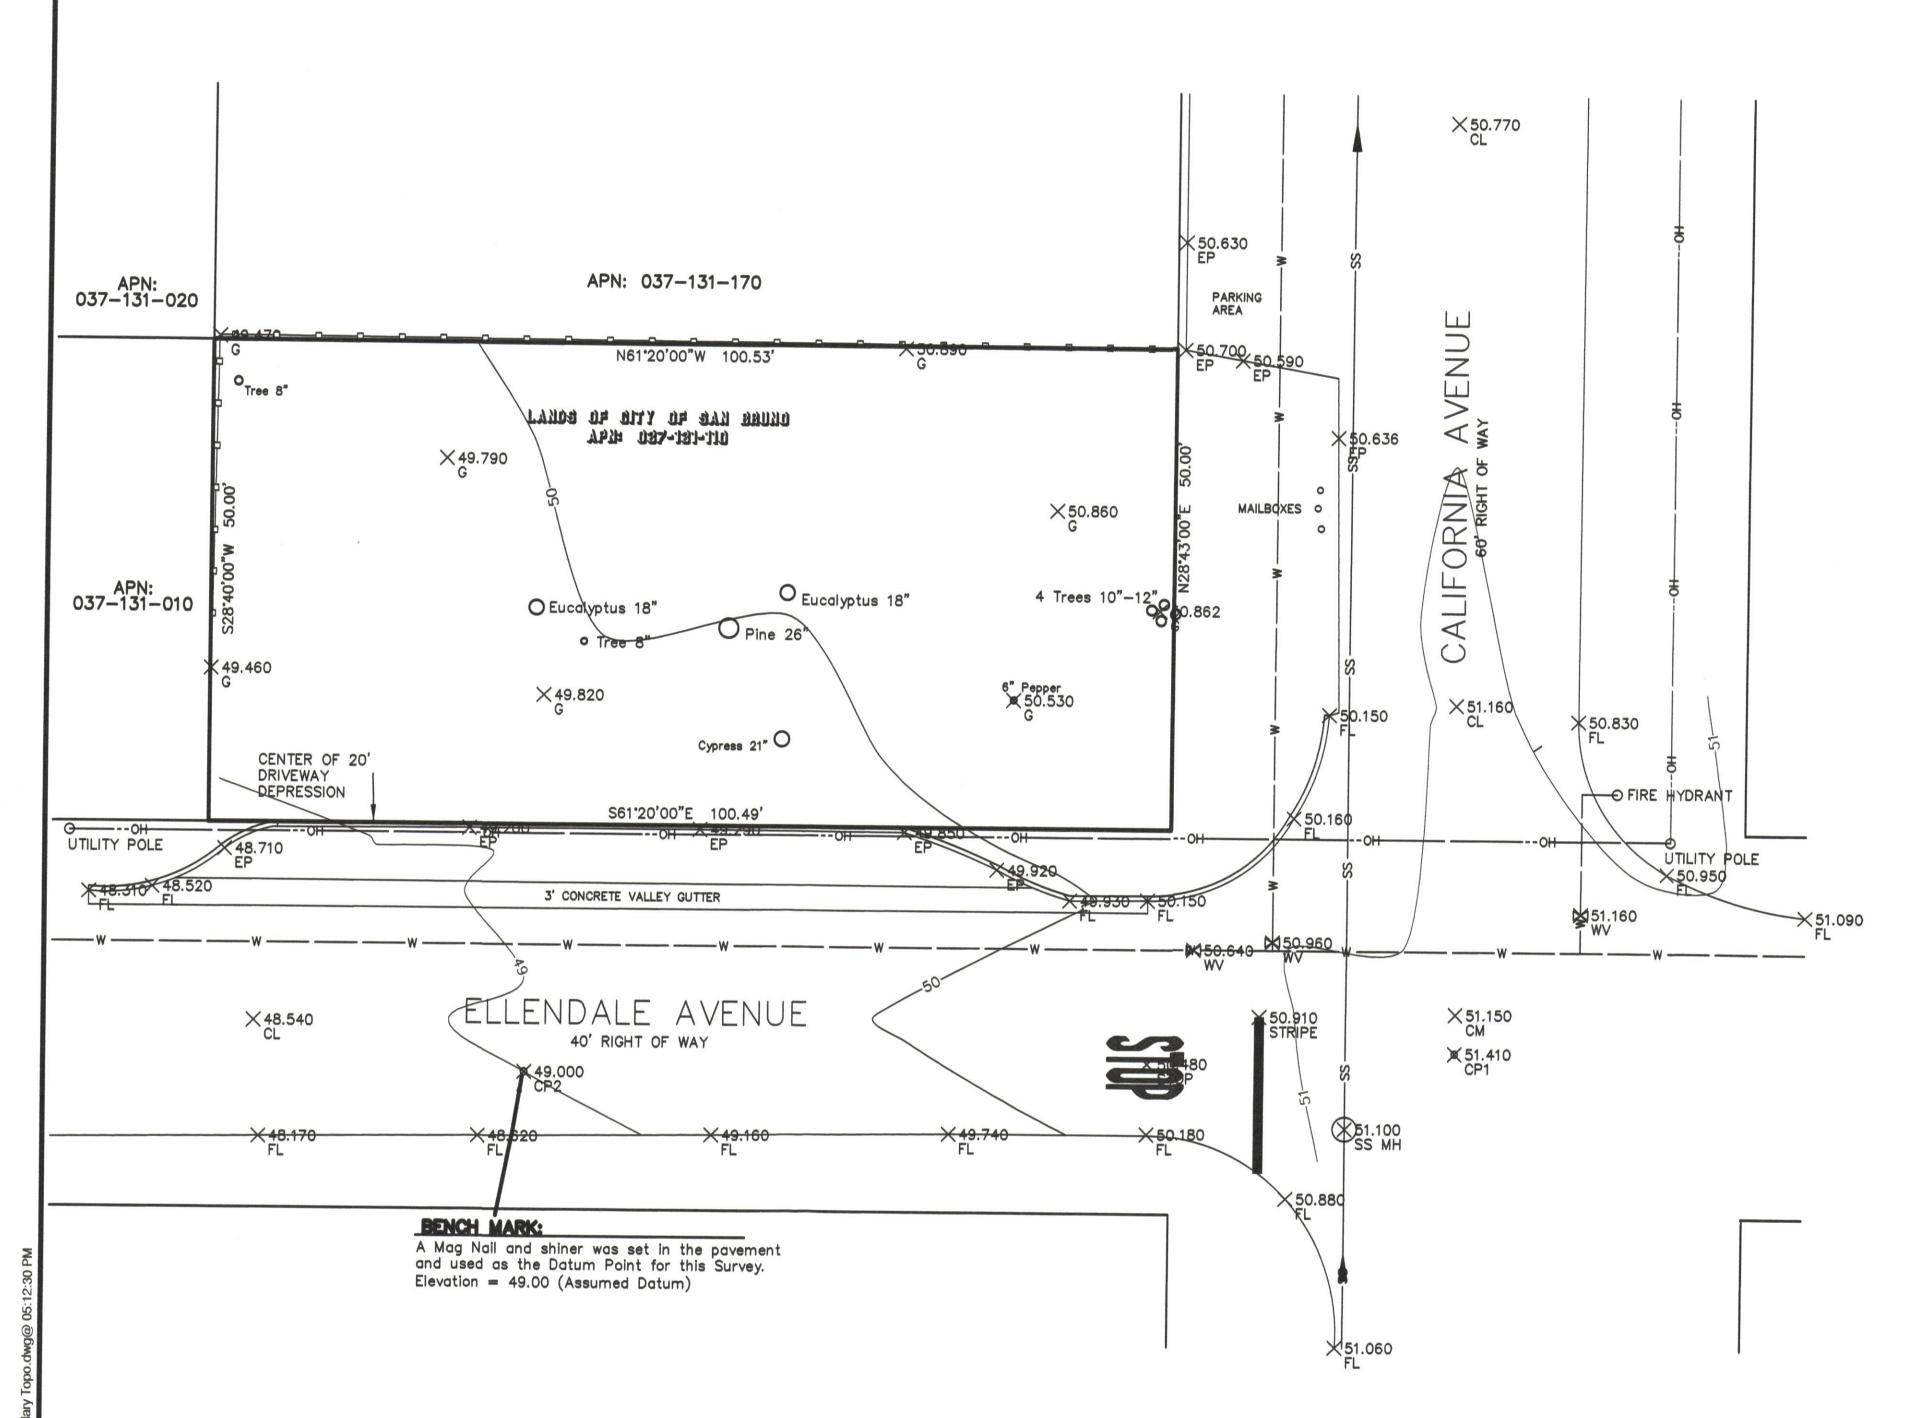
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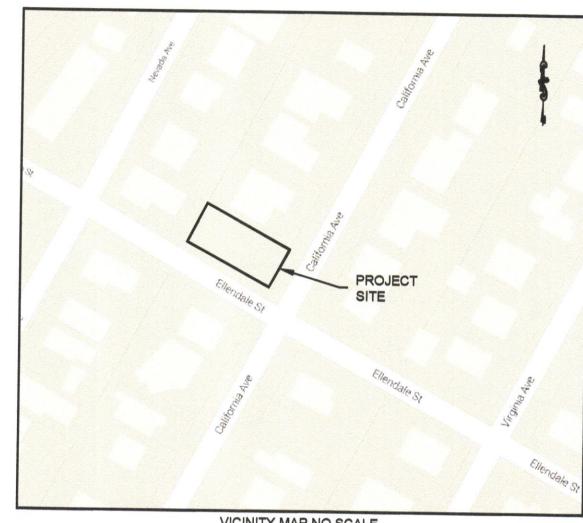
NUMBER:

OF:

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VICINITY MAP NO SCALE

Survey Prepared for: Joanna Livadas SITE ADDRESS: Vacant lot at Ellendale St. & California Ave. LEGAL DESCRIPTION: Lots 13 & 14 Block 51 Record Subdivision Book 6 at Page 9 A.P.N. 037-131-110 AREA: 5,025.4 SQ. FT. +/-

LEGEND
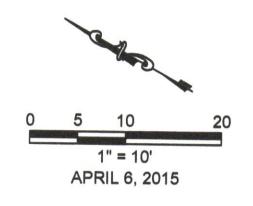
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	59	_
_ w _	ss	
	<u>•</u>	
	EP INV	
	RIM CP	
	SS MH	
	SP	
	NE.	

BOUNDARY LINE/PROPERTY LINE (P/L)
BOUNDARY OF ADJOINING PROPERTIES
WOODEN FENCE LINE
CONTOUR LINE W/ ELEVATION
OVERHEAD UTILITY LINES OVERHEAD UTILITY LINES
WATER LINE (BASED ON SURFACE UTILITIES)
SANITARY SEWER & FLOW DIRECTION
SIGN POST
CONTROL POINT
EDGE OF PAVEMENT
INVERT ELEVATION OF MANHOLE
RIM ELEVATION OF MANHOLE
CONTROL POINT
SANITARY SEWER
STANDARD 48" MANHOLE WITH 24" LID
SIGN POST
GROUND ELEVATION
NOT AN ELEVATION
FLOW LINE

SURVEY DATA:

THE SURVEY DATA SHOWN HEREON IS BASED ON A SURVEY PROVIDED BY JOANNA LIVADAS TO PROFESSIONAL LAND SERVICES. THE TOPOGRAPHY AND BOUNDARY WAS PREPARED BY PAT MCNULTY, AND SUPPLEMENTED WITH ADDITIONAL SURVEYING BY PROFESSIONAL LAND SERVICES.

ach				
Bea	4	BUILDING FOOTPRINT REVISED	06/04/2015	
				2015 3001
Moss	\triangle			JOB#: <u>2015.3001</u>
3001				DATE: 06/04/15
15				DATE . STATE
F:\2015	NO.	REVISIONS		100% SUBMITTAL
ii.	110.	REVISIONS	DATE	TOOK CODMITTAL
	Plotted	on: 06/04/15 @ 05:12:30 PM		

	(650) 244-9667 jgmahoney@pls-corp.com 901 Sneath Ln, Sulte 117
Professional La	San Bruno, CA 94066 IND SERVICES IENT SPECIALISTS

PREPARED FOR:
JOANNA LIVADAS
SOMINA LIVADAS
100 MECA DOME
128 MESA DRIVE
1942 (1949) 1944 (
SO. SAN FRANCISCO.
Jo. JAN INANCISCO,
CA 04000
CA 94080

DESIGNED: __JKO_


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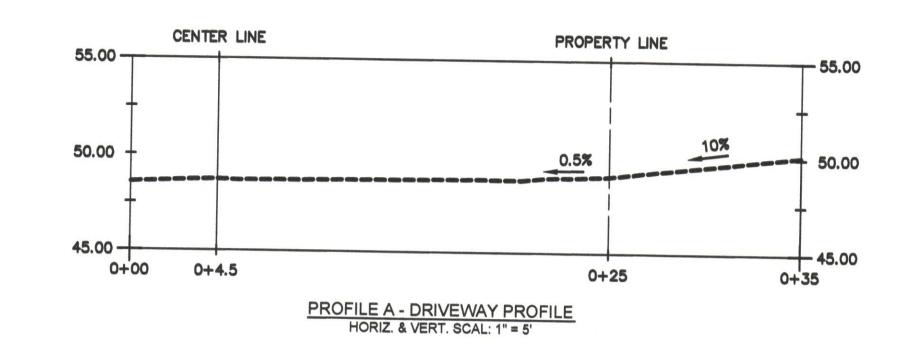
APPROVED: JKO


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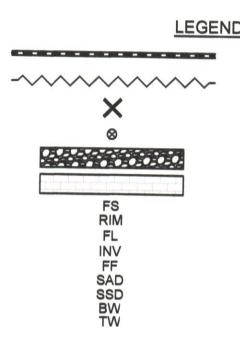
EXISTING T	OPOGRAPHY
	T ELLENDALE H, CA 94038

SHEET	1
OF	
2	







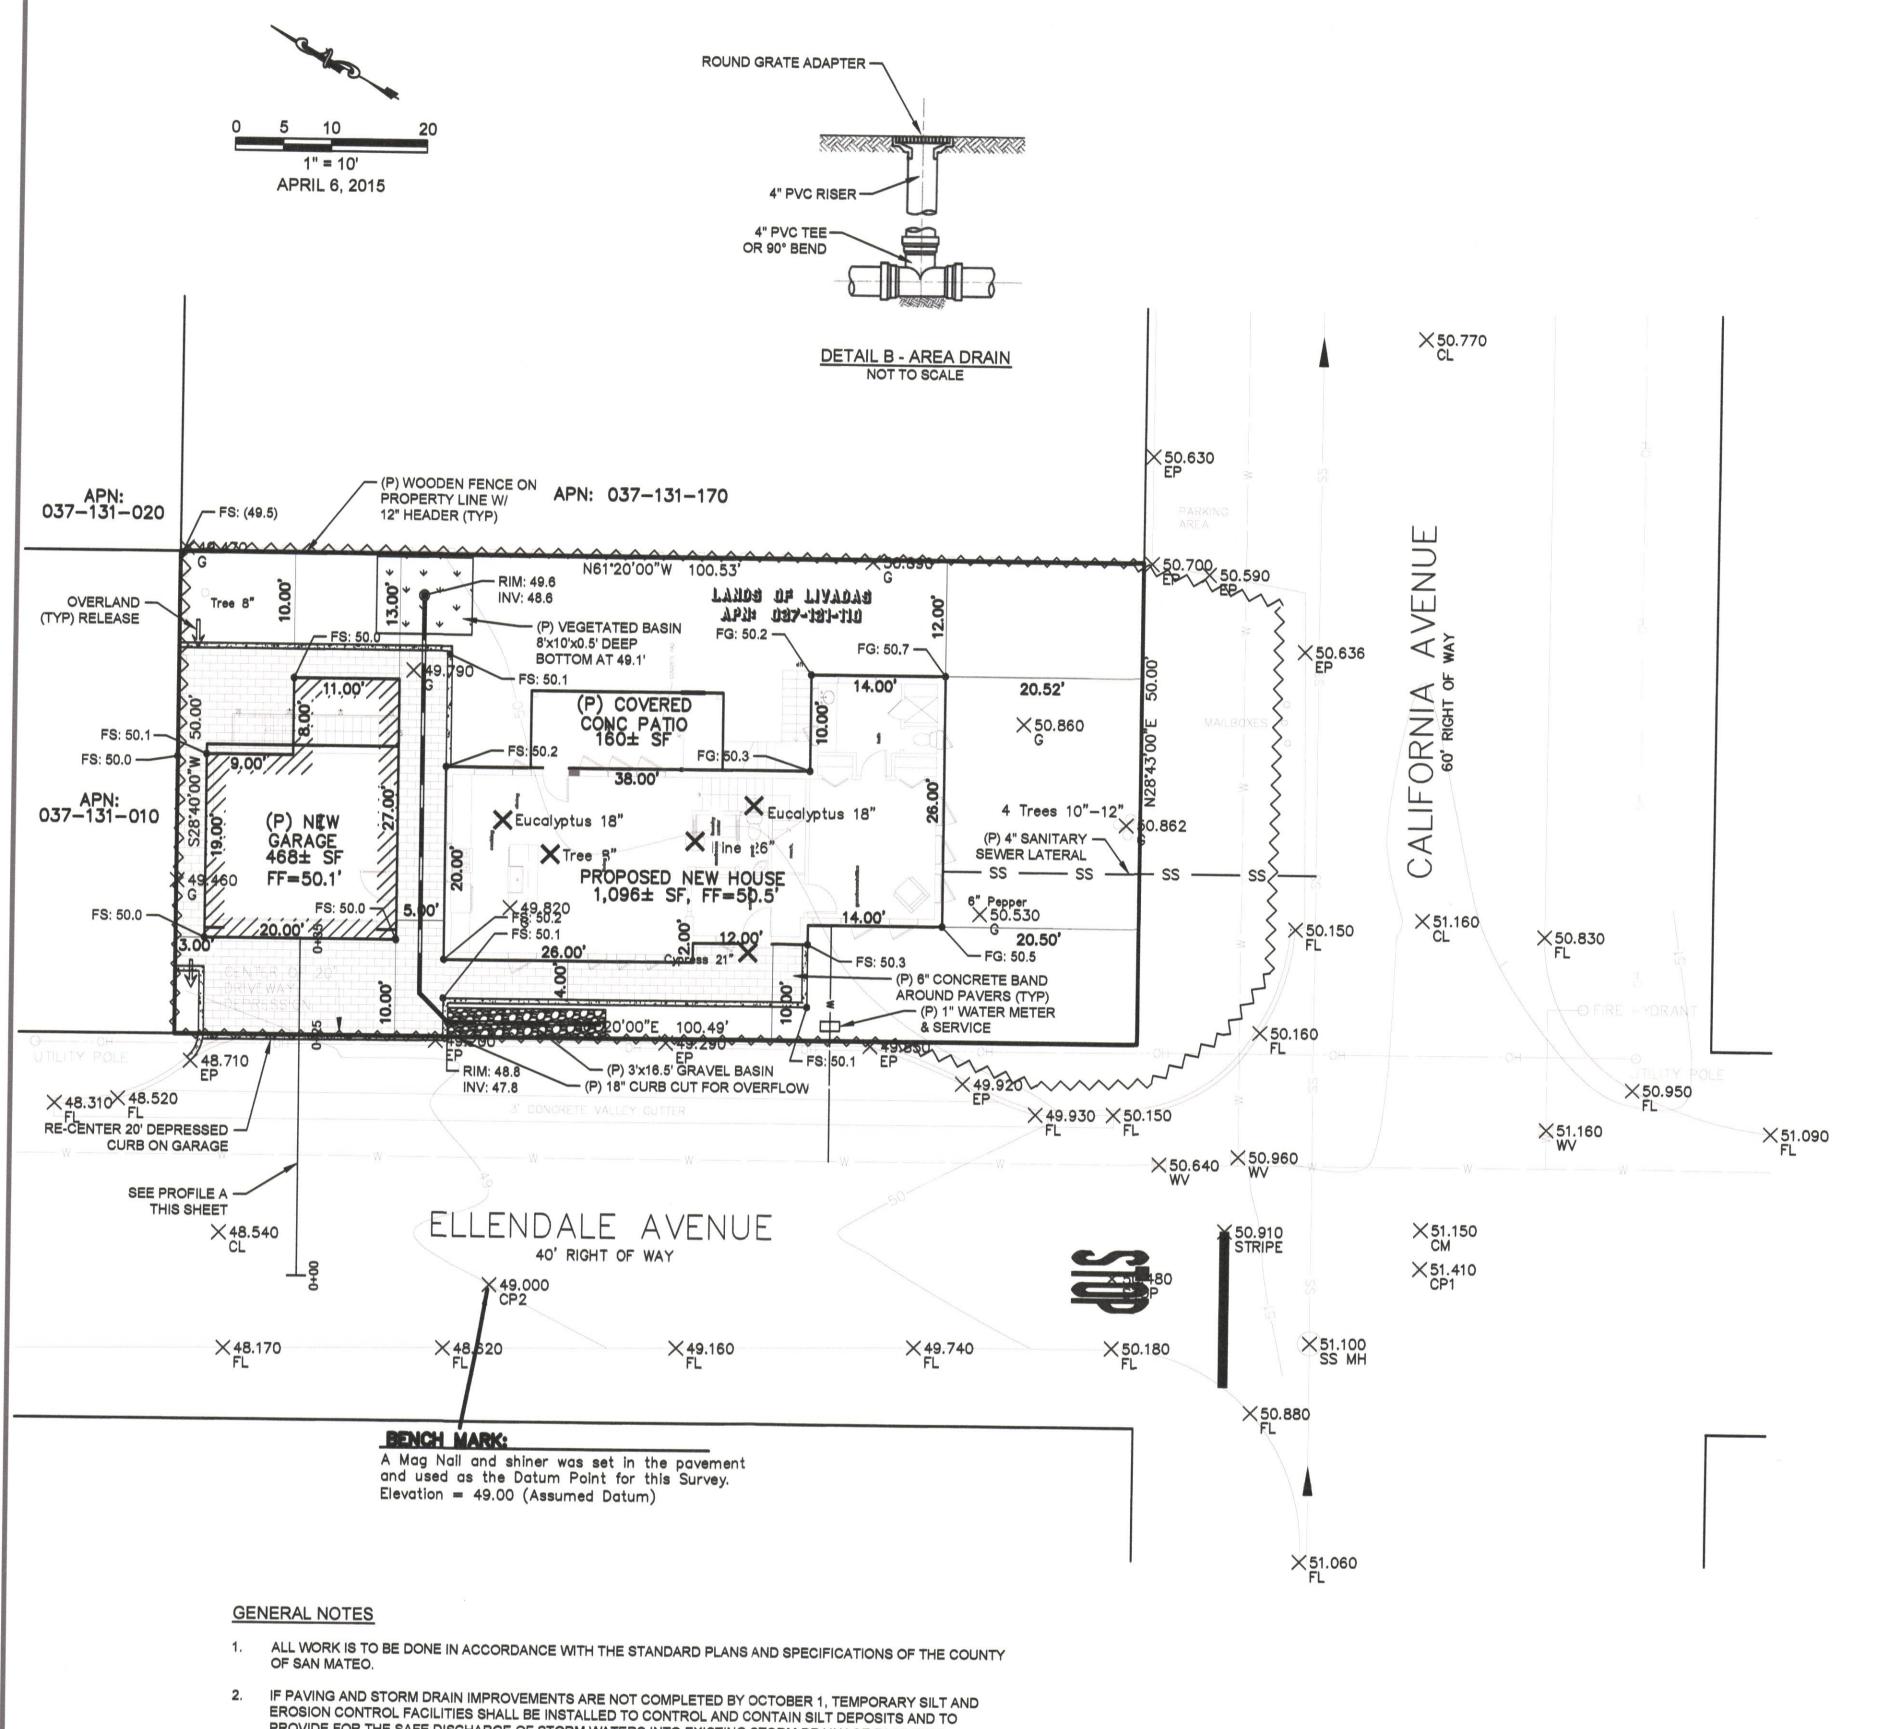

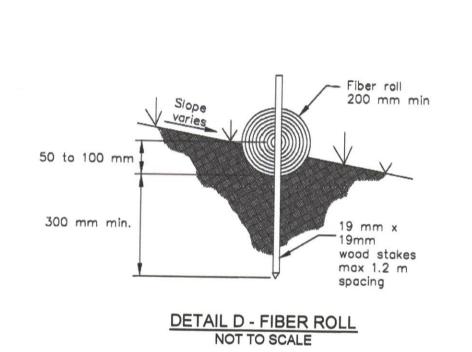

4" SOLID PVC PIPE, UNLESS OTHERWISE NOTED FIBER ROLLS, "DETAIL D" THIS SHEET TREE TO BE REMOVED AREA DRAIN (AD), "DETAIL B" THIS SHEET GRAVEL BASIN, "DETAIL C" THIS SHEET PERMEABLE PAVERS, "DETAIL A" THIS SHEET FINISHED SURFACE RIM ELEVATION FLOW LINE ELEVATION INVERT ELEVATION
INVERT ELEVATION
FINISHED FLOOR ELEVATION
SEE ARCHITECTURAL DRAWINGS
SEE STRUCTURAL DRAWINGS
BOTTOM OF WALL
TOP OF WALL

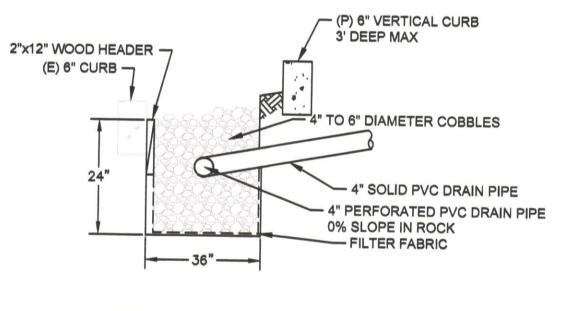

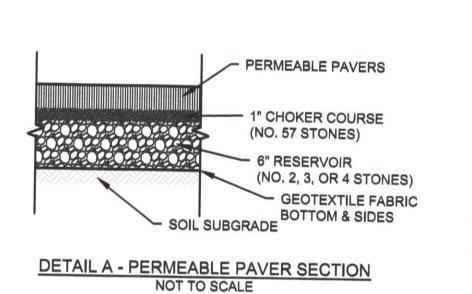

DETAIL C - GRAVEL BASIN NOT TO SCALE

EARTHWORK QUANTITIES 48.0 CY 24.4 CY 23.6 CY

TITLE:

PROVIDE FOR THE SAFE DISCHARGE OF STORM WATERS INTO EXISTING STORM DRAINAGE FACILITIES. ADDITIONAL EROSION CONTROL MAY BE NEEDED AT THAT TIME.

G G			
Beach Z	BUILDING FOOTPRINT REVISED	06/04/2015	
			100 # 2015 3001
SS Z			JOB#: <u>2015.3001</u>
<u> </u>			
			DATE: 06/04/15
N N			
N SS	D. REVISIONS	DATE	100% SUBMITTAL
Plot	ted on: 06/04/15 @ 05:11:43 PM		



PREPARED FOR: DESIGNED: __JKO JOANNA LIVADAS 128 MESA DRIVE DRAWN: JKO SO. SAN FRANCISCO, APPROVED: JKO CA 94080

PRELIMINARY GRADING, DRAINAGE, & EROSION CONTROL VACANT LOT ELLENDALE MOSS BEACH, CA 94038

SHEET 2