

PPROVED MARCH 21, 2003 DATE: Rall NEIL R. CULLEN, DIRECTOR OF PUBLIC WORKS R. C. E. # 19109 / EXPIRES 9-30-2005

1. THE PLANIMETRIC MAPPING SHOWN ON THE PLANS WAS GENERALLY REPRESENTATIVE OF THE SITE CONDITIONS AT THE TIME IT WAS PRODUCED AND IS NOT NECESSARILY REPRESENTATIVE OF THE CURRENT CONDITIONS. THE CONTRACTOR IS ADVISED THAT THE COASTLINE IS SUBJECT TO SEVERE EROSION AND THAT THE GRADES AND SLOPES SHOWN ON THE PLANS MAY HAVE CHANGED FROM THE TIME THEY WERE PRODUCED. THE CONTRACTOR SHALL BE SOLELY RESPONSIBLE FOR VISITING THE SITE TO VERIFY THE EXISTING CONDITIONS.

2. CONTRACTOR SHALL CONFINE HIS OPERATIONS AND ACTIVITIES RIGHTS OF ENTRY AND/OR PROJECT CONFORMS, AS SHOWN ON THE PLANS AND AS DIRECTED BY THE ENGINEER.

3. CONTINUOUS DUST CONTROL SHALL BE PROVIDED AS REQUIRED BY SECTION 17 OF THE SPECIAL PROVISIONS AND AS DIRECTED

4. LOCATIONS AND DEPTHS OF EXISTING UTILITIES SHOWN ON THE PLANS ARE APPROXIMATE ONLY. CONTRACTOR SHALL BE RESPONSIBLE FOR CONTACTING THE UTILITIES TO DETERMINE EXACT LOCATIONS AND DEPTHS. CONTRACTOR SHALL CALL "UNDERGROUND SERVICE ALERT" (U.S.A.) AT 1-800-642-2444, TWO (2) WORKING DAYS BEFORE EXCAVATION WORK IS TO BEGIN. WHEN CALLING, BE PREPARED TO GIVE LOCATION AND NATURE OF WORK, START DATE, COMPANY NAME, ADDRESS, AND TELEPHONE NUMBER.

PLANS MAY NOT SHOW ALL EXISTING WATER, GAS OR SANITARY SEWER LATERALS. CONTRACTOR SHALL BE RESPONSIBLE FOR VERIFICATION AND PRESERVATION OF ALL SUCH FACILITIES, SHOWN ON THE PLANS OR IDENTIFIED BY U.S.A., WHICH ARE NOT TO BE RELOCATED.

6. WHEN DIRECTED BY THE ENGINEER, CUT AND FILL SLOPE RATIOS SHALL BE VARIED TO AVOID TREES OR OTHER EXISTING IMPROVEMENTS.

7. CONTRACTOR IS ADVISED THAT EXCAVATION MAY CONFLICT WITH SANITARY SEWER LATERALS, GAS LINES, WATER LINES AND OTHER UNDERGROUND UTILITIES. ANY DAMAGE TO EXISTING FACILITIES CAUSED BY THE CONTRACTOR SHALL BE REPAIRED AT THE CONTRACTOR'S EXPENSE.

8. VEGETATION AND IMPROVEMENTS (INCLUDING FENCES) WHICH ARE DESIGNATED TO BE REMOVED SHALL BECOME THE PROPERTY OF THE CONTRACTOR. VEGETATION AND IMPROVEMENTS (INCLUDING FENCES) SHALL BE REMOVED ONLY WHEN DIRECTED IN WRITING BY THE ENGINEER. NO TREES, VEGETATION OR IMPROVEMENTS (INCLUDING FENCES) SHALL BE RÉMOVED WITHOUT THE PRIOR WRITTEN CONSENT AND APPROVAL OF THE ENGINEER. REFER TO PROJECT SPECIAL PROVISIONS SECTION 11 REGARDING REQUIREMENTS FOR ADVANCE NOTIFICATION OF PROPERTY OWNERS


PROJECT SURVEY AND STAKING SERVICES WILL BE PROVIDED BY THE ENGINEER. THE CONTRACTOR'S ATTENTION IS DIRECTED TO SECTION 5-1.07 OF THE STANDARD SPECIFICATIONS.


10. DIMENSIONS OF THE STRUCTURAL SECTION ARE SUBJECT TO TOLERANCES IN THE STANDARD SPECIFICATIONS.


11. NO FALSEWORK SHALL BE ALLOWED IN CREEK FOR CONSTRUCTION.

12. CONTRACTOR SHALL VERIFY ALL CONTROLLING FIELD DIMENSIONS BEFORE OPERATING OR FABRICATING ANY MATERIAL

| | DESIGNED BY: AS | | | SCALE: AS SHOWN |
|---------------------------------|-----------------|--------------------------|---|------------------|
| | CHECKED BY: JV | MIRADA ROAD | PEDESTRIAN BRIDGE | DATE: 4-12-2002 |
| | DRAWN BY: KA | TITLE | SHEET | FILE NO.: 1/4657 |
| DATE | | DIRECTOR OF PUBLIC WORKS | 555 COUNTY CENTER, 5 REDWOOD CITY, CAL | |
| 0 1 2 3 4 | | | | |
| FOR REDUCED P ORIGINAL SCALE | | | | SHEET I of IO |

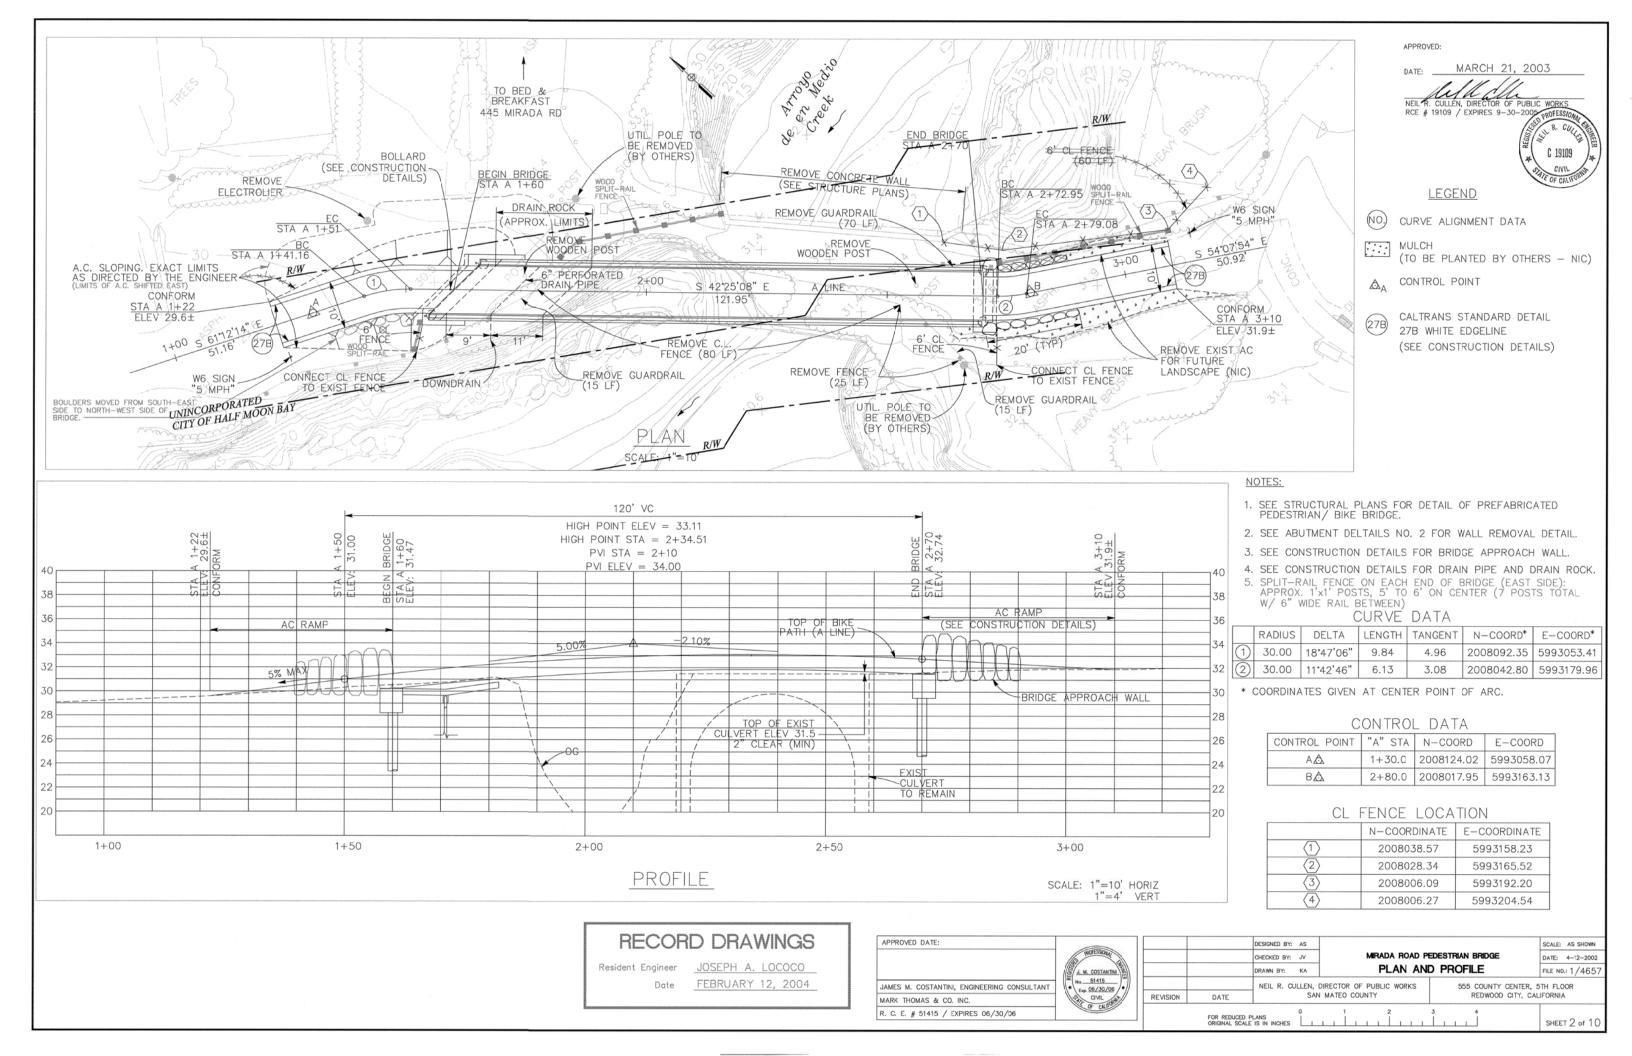

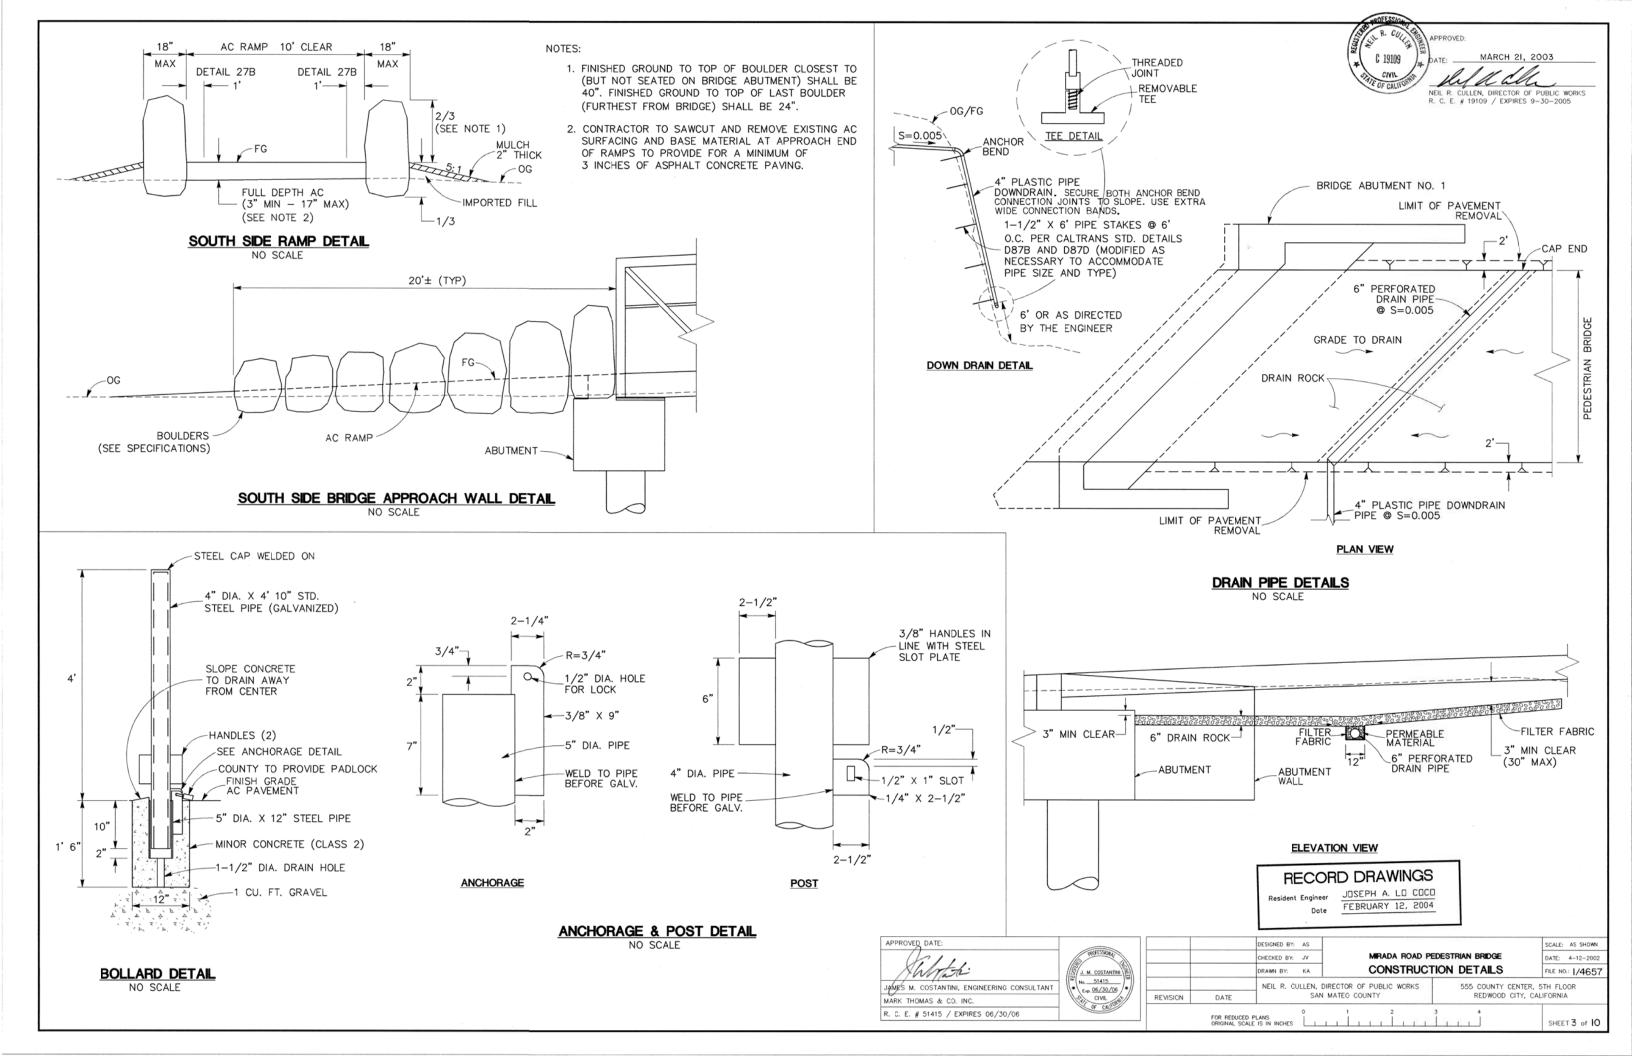

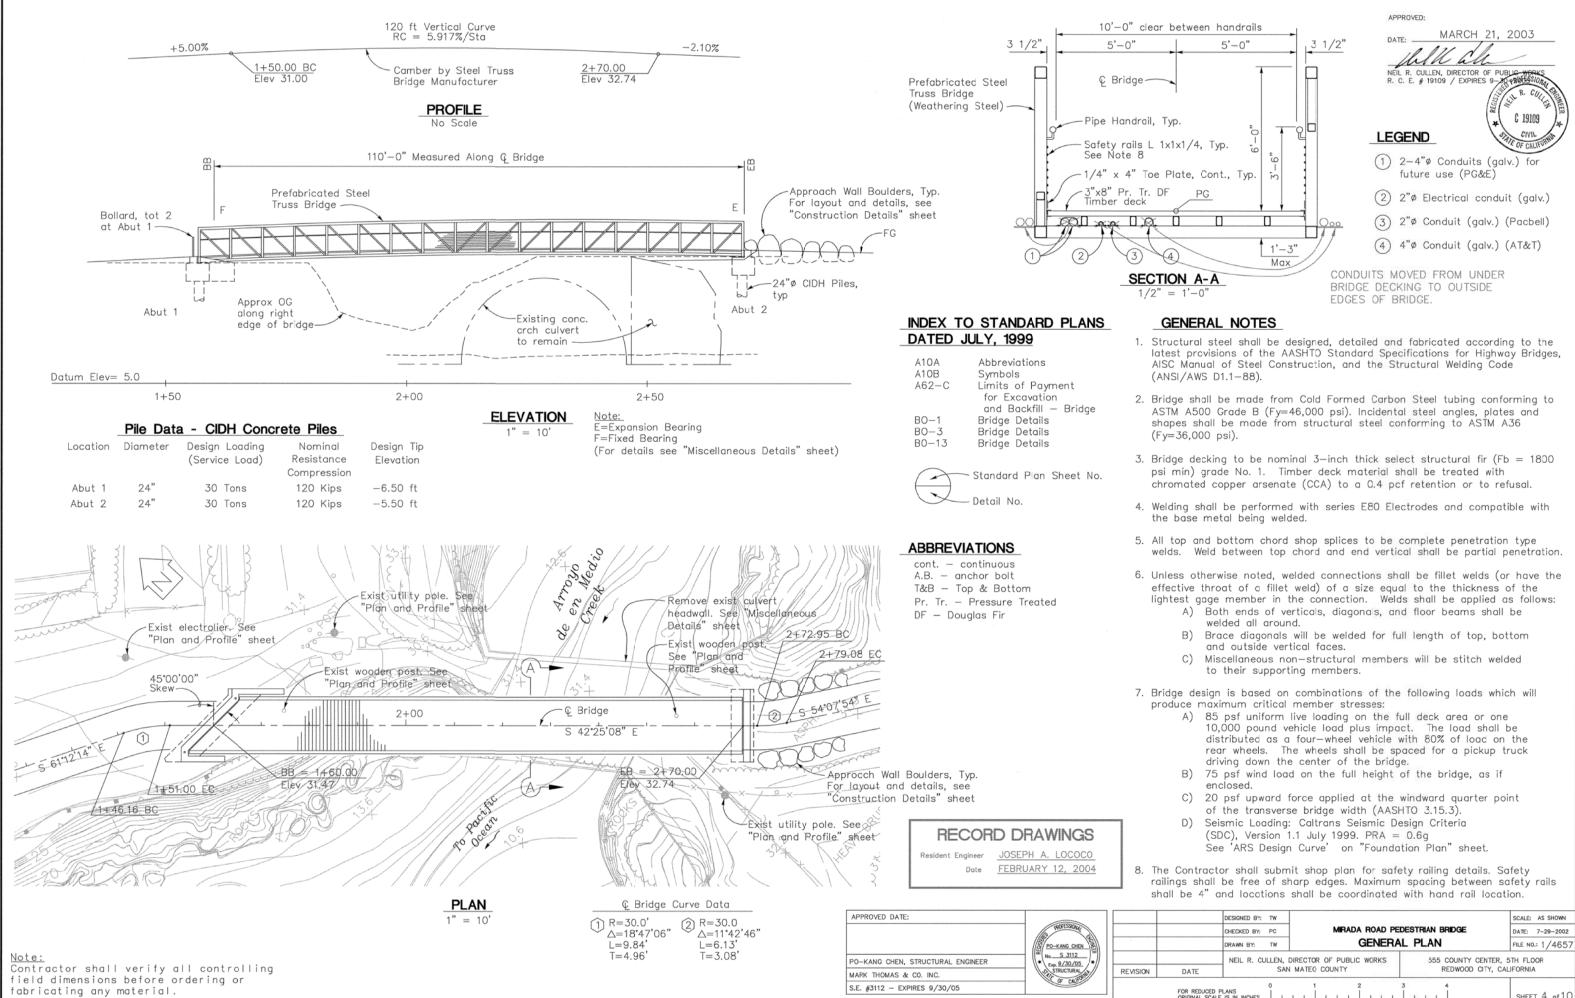

| | DESIGNED BY: TW | | | SCALE: AS SHOWN | |
|--|--|------------------|---------------|------------------|--|
| | CHECKED BY: PC | MIRADA ROAD PEDE | STRIAN BRIDGE | DATE: 7-29-2002 | |
| | DRAWN BY: TW | GENERAL | PLAN | FILE NO.: 1/4657 | |
| 0.175 | NEIL R. CULLEN, DIRECTOR OF PUBLIC WORKS 555 COUNTY CENTER, 5 SAN MATEO COUNTY REDWOOD CITY, CALL | | | | |
| DATE | SAV MALEO COONTI | | | | |
| FOR REDUCED PLANS 0 1 2 3 4 ORIGINAL SCALE IS IN INCHES LIFE 4 of 10 | | | | | |

BENCH MARKS

MT-102


Brass disk in Mirada Road cul-de-sac. Elev=31.68 N2007975.941 E5993224.309

<u>City of Half Moon Bay Monument</u> Elev.=34.94

N2007980.631 E5993467.872

DATUM:

National Geodetic Vertical Datum 1929-61 Mean Sea Level

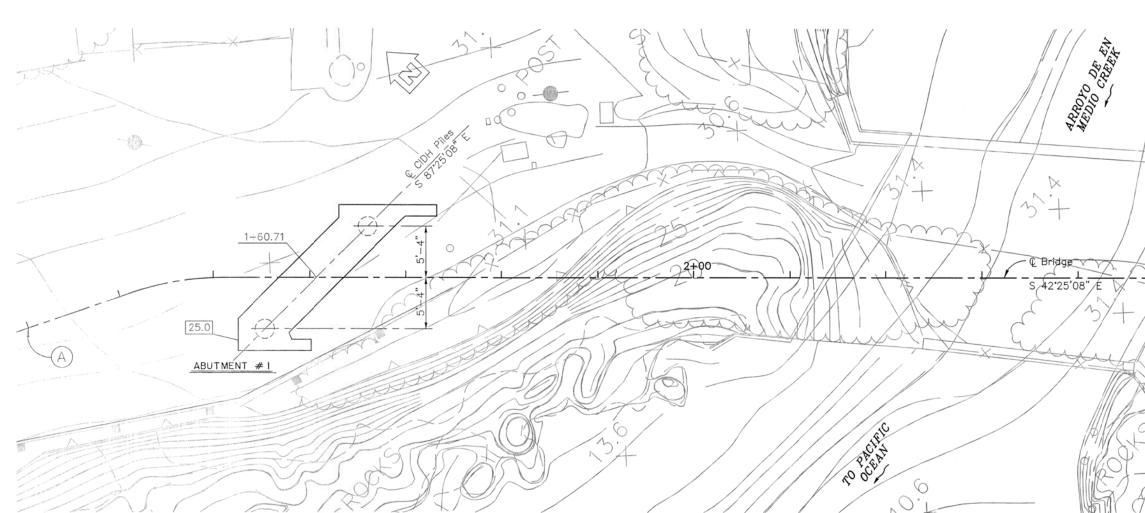



PLAN 1" = 5'


C BRIDGE ALIGNMENT DATA

| | | | North | East |
|---|---------|-----|------------|------------|
| A | 1+30.00 | POT | 2008124.02 | 5993058.07 |
| B | 2+80.00 | POT | 2008017.95 | 5993163.13 |


<u>Note:</u> Contractor shall verify all controlling field dimensions before ordering or fabricating any material.

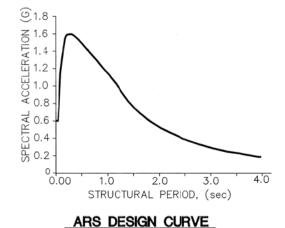


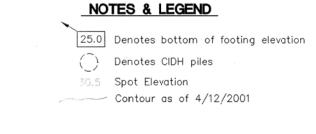

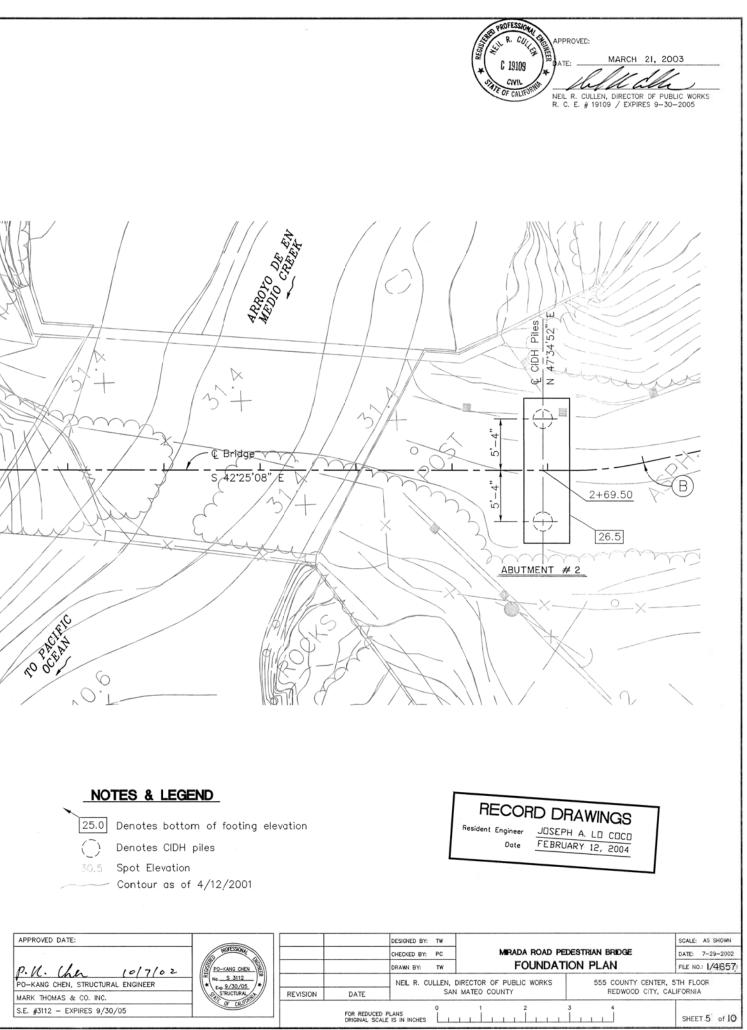


No scale

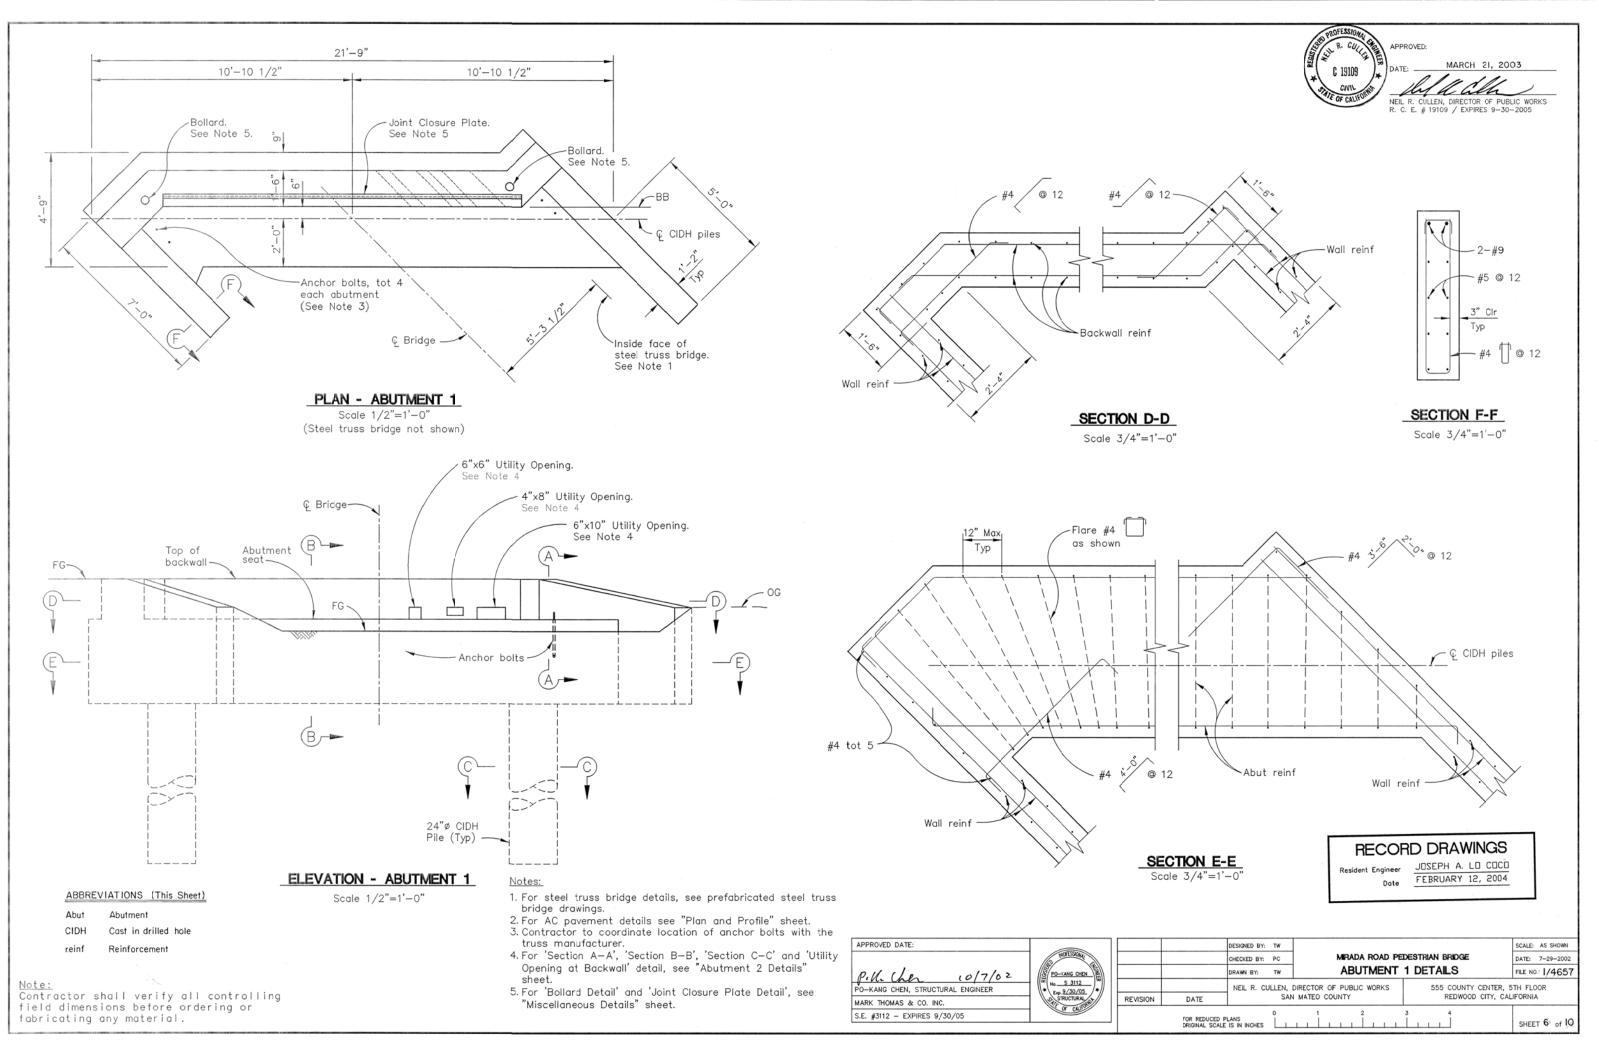

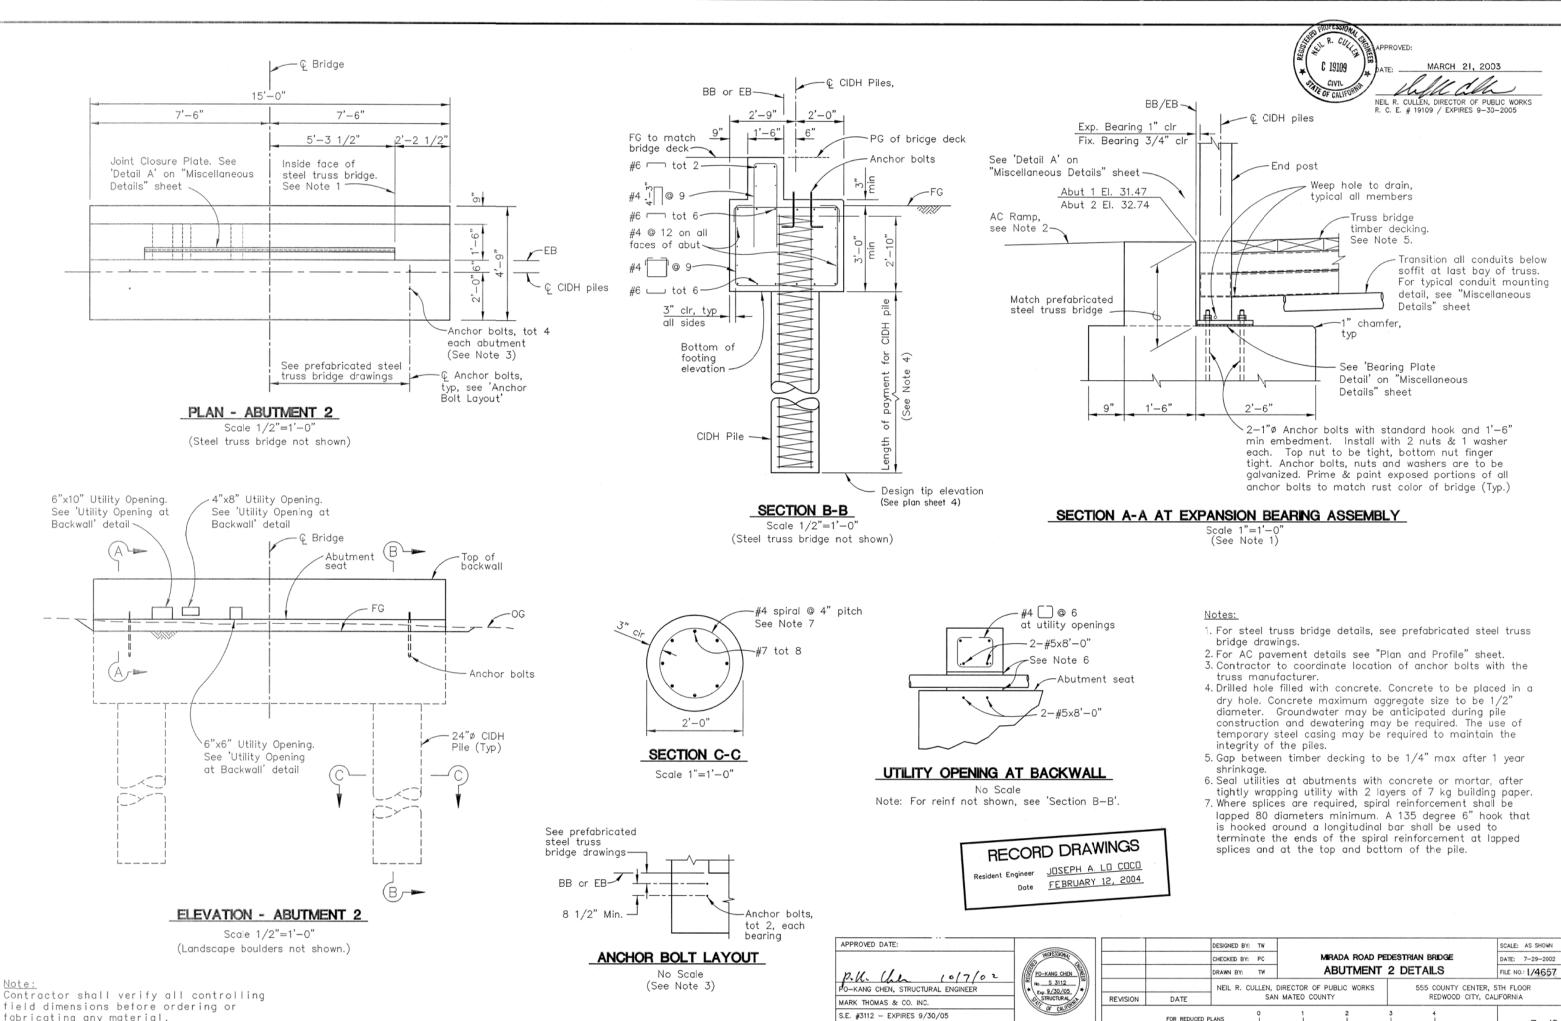

fabricating any material.

| | DESIGNED BY: | TW | | | | | SCALE: AS SHOWN |
|---|--|---|----|-----------------|---|---------|------------------|
| | CHECKED BY: | HECKED BY: PC MIRADA ROAD PEDESTRIAN BRIDGE | | DATE: 7-29-2002 | | | |
| | DRAWN BY: | тw | AB | UTMENT | 2 | DETAILS | FILE NO.: 1/4657 |
| DATE | NEIL R. CULLEN, DIRECTOR OF PUBLIC WORKS 555 COUNTY CENTER, 5TH FLOOR SAN MATEO COUNTY REDWOOD CITY, CALIFORNIA | | | | | | |
| R REDUCED PLANS 0 1 2 3 4 RIGINAL SCALE IS IN INCHES 1 SHEET 7 of 10 | | | | | | | |
| | | | | | _ | | |

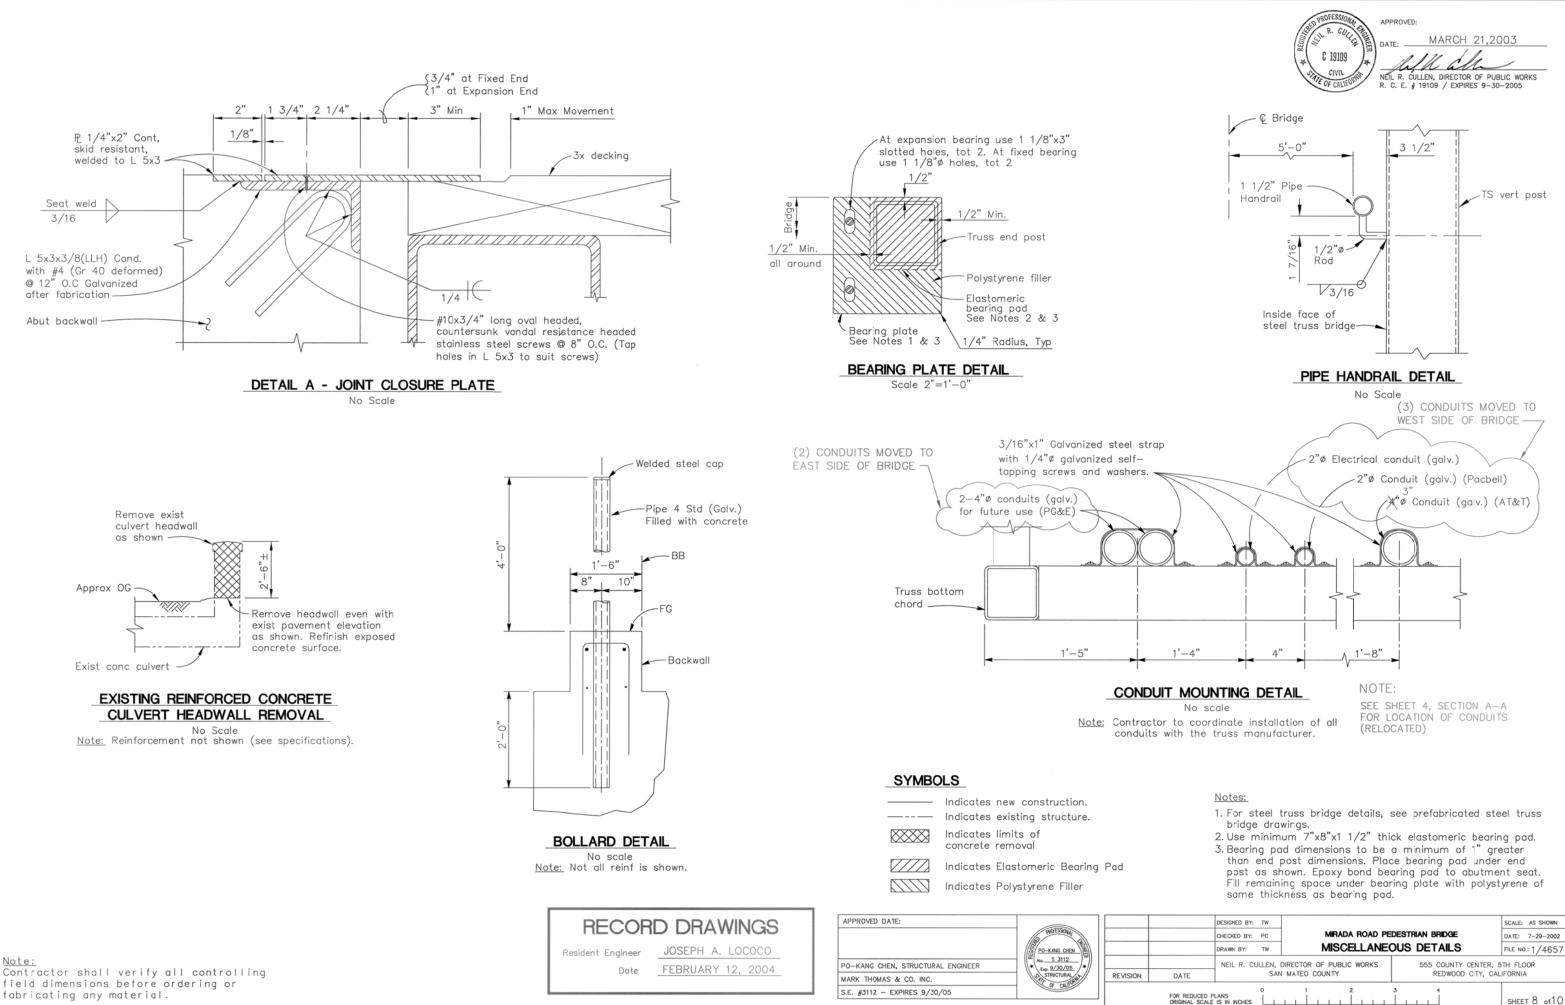

SHEET 8 of 10

| GENERAL NOTES | GENERAL NOTES CONTINUATION | | APPROVED: |
|--|--|--|--|
| ALL WORK SHALL BE DONE IN ACCORDANCE WITH THE CALIFORNIA ELECTRICAL CODE 1998 EDITION AND THE COUNTY OF SAN MATEO "STANDARD DRAWINGS FOR PUBLIC IMPROVEMENT - COUNTY LIGHTING STANDARD" THE CONTRACTOR SHALL BE RESPONSIBLE FOR FIELD INSPECTION AND INVESTIGATION TO DETERMINE ACTUAL FIELD CONDITIONS PRIOR TO BIDDING THE PROJECT. CONTRACTOR SHALL CONFIRM LOCATIONS OF ELECTROLIERS WITH COUNTY REPRESENTATIVE BEFORE INSTALLATION. THE COUNTY OF SAN MATEO ELECTRIC UTILITIES WILL DISCONNECT EXISTING ELECTRIC SERVICE TO STREET LIGHTS IN CONFLICT WITH CONSTRUCTION BEFORE THE CONTRACTOR BEGINS ANY WORK. THE ELECTRICAL PLANS ARE ACCURATE FOR ELECTRICAL WORK ONLY. ALL EXISTING EQUIPMENT SHALL REMAIN IN PLACE UNLESS OTHERWISE NOTED. LOCATION OF STANDARDS, CONDUITS, PULL BOXES AND OTHER EQUIPMENT SHOWN ON THE PLANS ARE APPROXIMATE. CONTRACTOR SHALL CONFIRM EXACT LOCATION OF ELECTROLIERS WITH THE | ALL ELECTRICAL EQUIPMENT AND MATERIALS SHALL BE NEW. ALL ELECTRICAL EQUIPMENT AND MATERIALS USED ON THIS PROJECT SHALL BE U.L. LABELED, LISTED AND APPROVED FOR THE INTENDED APPLICATION. ALL UNDERGROUND PVC CONDUIT SHALL HAVE A BURIAL DEPTH OF 24" MINIMUM, UNLESS OTHERWISE NOTED. EACH STREET LIGHT STANDARD SHALL BE INSTALLED WITH CALTRANS 3 1/2 STREET LIGHT PULL BOX AND A SPLICED-FUSED CONNECTOR. SHOP DRAWINGS OF ALL LIGHTING AND ELECTRICAL MATERIALS USED IN THIS PROJECT SHALL BE SUBMITTED TO THE COUNTY FOR APPROVAL PRIOR TO ORDERING MATERIALS. | NEW 240V, 70 W HPS LUMINAIRE, BRONZE, DIE CAST ALUMINUM HOUSING WITH PHOTO ELECTRIC UNIT, HIGH POWER FACTOR BALLAST, FLAT GLASS TYPE II DISTRIBUTION. LUMINAIRE SHALL BE "AMERICAN ELECTRIC LIGHTING" CATALOG No. 53-9F1E2-AJ OR APPROVED EQUIVALENT. MOUNTED ON 35'-0" CENTERED BORED WOOD POLE. POLE DEPTH SETTING SHALL BE 6'. POLE HOLE DIAMETER SHALL HAVE 3" ALL AROUND AND SHALL BE SUPPORTED BY CRIBBING USING A BARREL TO BE FILLED WITH LEAN MIX CONCRETE TO MAKE THE POLE SECURED. EXISTING ELECTROLIER ON PG&E WOOD POLE WITH 2-FT MAST ARM, 100 W HPS LUMINAIRE AND INTEGRAL BALLAST. SCHEDULE 40 PVC UNDERGROUND CONDUIT WITH CONDUCTORS. SEE PROJECT NOTES FOR SIZES. CALTRANS No. 6(E) PULL BOX EXISTING WOODEN UTILITY POLE | DATE: MARCH 21, 2003 |
| COUNTY REPRESENTATIVE. 7. LOCATION OF ELECTROLIERS IS DIRECTLY RELATED TO THE GEOMETRIC LAYOUT. IF THE GEOMETRIC LAYOUT IS CHANGED FROM THAT SHOWN ON THESE PLANS, NEW ELECTROLIER OR LUMINAIRE LOCATIONS SHALL BE ESTABLISHED BY THE ENGINEER. | PROJECT NOTES 1 EXISTING PG&E POLE AND LTG TO REMAIN. 2 INSTALL 1 1/2"C, 2 #8 (LTG, 240V) 1 #8 (G) | PROJECT NOTE REFERENCE. IN THIS CASE, SEE NOTE 1. INSTALL PULLBOX IN EXISTING CONDUIT RUN. SC SPLICE NEW TO EXISTING CONDUCTORS. | E-1 Electrical general E-2 LIGHTING PLAN |
| 8. THE CONTRACTOR SHALL BE RESPONSIBLE UNDER THIS CONTRACT TO REPAIR AND REPLACE ANY AND ALL DAMAGES TO EXISTING PCC WALKS, AC PAVINGS, UTILITIES, TREES, TURF, PLANTED AREAS AND OTHER FACILITIES RESULTING FROM THIS PROJECT. WHEN CUTTING OR TRENCHING THROUGH EXISTING CONCRETE SIDEWALKS, DRIVEWAYS AND WALKWAYS, CONTRACTOR SHALL BE REQUIRED TO COMPLETELY REPLACE SECTIONS OF CONCRETE PANELS FROM SCOREMARK TO SCOREMARK AFFECTED BY THE CONSTRUCTION WORK. ALL SIDEWALKS, DRIVEWAYS, AND WALKWAYS, SHALL BE REPLACED PER COUNTY STANDARDS. | INSTALL 2" RSC (FUTURE LTG CIRCUIT). SEE CIVIL DRAWINGS FOR CONDUIT LOCATION AND ATTACHMENT UNDER BRIDGE DECK. INSTALL 2"C (FUTURE LTG CIRCUIT). | MT EMPTY CONDUIT WITH PULL WIRE. | ABBREVIATIONS |
| 9. UNLESS NOTED OTHERWISE, ALL UNDERGROUND CONDUIT SHALL BE SCHEDULE 40 PVC, U.L. APPROVED FOR DIRECT BURIAL AND TERMINATED WITH THE FACTORY END BELL FITTINGS. ALL ELBOWS, BENDS AND TURNS TRANSITIONING TO GRADE SHALL BE INSTALLED USING PREMANUFACTURED 40-MIL PVC COATED GALVANIZED RIGID STEEL ELBOWS AND OFFSETS. | | | AWG AMERICAN WIRE GAUGE CKT CIRCUIT (E) EXISTING (G) GROUND |
| 10. IT SHALL BE THE RESPONSIBILITY OF THE CONTRACTOR TO VERIFY THE LOCATION OF ALL EXISTING UTILITIES AT LEAST TWO (2) WORKING DAYS BEFORE EXCAVATION BEGINS. CALL UNDERGROUND SERVICE ALERT AT 1-800-642-2444. CONTRACTOR SHALL CONTACT THE LOCAL AGENCIES TO LOCATE EXISTING WATER, SANITARY SEWER AND STORM DRAIN LINES. | | | HPS HIGH PRESSURE SODIUM LTG LIGHTING (N) NEW PEU (N) PHOTOELECTRIC UNIT |
| 11. ALL CONDUCTORS SHALL BE 600 VOLT, STRANDED COPPER WITH TYPE THW OR XHHW INSULATION, UNLESS OTHERWISE NOTED. ALL CONDUCTORS SHALL BE COLOR CODED TO MEET COUNTY STANDARD SPECIFICATIONS AND NEC REQUIREMENTS. | | | peu (E) PHOTOELECTRIC UNIT PG&E PACIFIC GAS AND ELECTRIC |
| 12. ALL UNDERGROUND SPLICES SHALL BE MADE WATERPROOF WITH "SPLICE-KOTE" SPLICE KITS ALL FUSEHOLDERS SHALL BE WATERTIGHT. 13. ALL RACEWAYS SHALL BE INSTALLED WITH SOLID COPPER EQUIPMENT | | | W WATT RSC RIGID STEEL CONDUIT (GALVANIZED) |
| IS. ALL RACEWATS SHALL BE INSTALLED WITH SOLID COPPER EQUIPMENT GROUNDING CONDUCTOR. BONDING SHALL COMPLY WITH THE STANDARD PROVISIONS. | | | |
| | RECORD DRAW Resident Engineer JUSEPH A. L Dote FEBRUARY | INGS | DESIGNED BY: HR MIRADA ROAD PEDESTRIAN BRIDGE SCALE: NONE OHECKED BY: JH BELECTRICAL GENERAL DATE: 02/08/02 DRAWN BY: TD ELECTRICAL GENERAL FILE NO.: 1/465 NEIL R. CULLEN, DIRECTOR OF PUBLIC WORKS 555 COUNTY CENTER, 5TH FLOOR DATE SAN MATEO COUNTY REDWOOD CITY, CALIFORNIA FOR REDUCED PLANS 0 1 2 3 4 E-1 ORIGINAL SCALE IS IN INCHES 0 1 2 3 4 E-1 |

34x22 11 Ľ.

CALE

| | | PROFESSIONAL CHERREN |
|-----------|-------------------------|---------------------------|
| APPROVED: | | (★ C 19109)★ |
| DATE: | MARCH 21, 2003 | CIVIL CIVIL OF CALIFORNIA |
| the | lall | |
| | , DIRECTOR OF PUBLIC WO | |

| | DESIGNED BY: HR | | | SCALE: NONE | |
|--|-----------------|--|-----------|------------------|--|
| | CHECKED BY: JH | MIRADA ROAD PEDESTRIAN BRIDGE | | DATE: 02/08/02 | |
| | DRAWN BY: TD | ELECTRICA | L GENERAL | FILE NO.: 1/4657 | |
| DATE | | CULLEN, DIRECTOR OF PUBLIC WORKS 555 COUNTY CENTER, 5TH FLOOR SAN MATEO COUNTY REDWOOD CITY, CALIFORNIA | | | |
| FOR REDUCED PLANS 0 1 2 3 4 E-1 ORIGINAL SCALE IS IN INCHES 1 0 0 0 0 | | | | | |

