# COUNTY OF SAN MATEO DEPARTMENT OF PUBLIC WORKS

James C. Porter Director

County Government Center 555 County Center, 5<sup>th</sup> Floor Redwood City, CA 94063 650-363-4100 T 650-361-8220 F www.smcgov.org

March 15, 2018

#### **COUNTY OF SAN MATEO**

# RECONSTRUCTION OF SEVENTH AVENUE FROM MIDDLEFIELD ROAD TO EDISON WAY IN THE NORTH FAIR OAKS AREA COUNTY ROAD NUMBER 561-A

# TOTAL PROJECT APPROXIMATELY 0.39 MILE IN LENGTH WITH APPURTENANT WORK THERETO IN SAN MATEO COUNTY

COUNTY PROJECT NO. RW703 PROJECT FILE NO. E4957000

#### ADDENDUM NO. 2

#### TO ALL PLAN HOLDERS:

The following **Addendum No. 2** to the above referenced project Plans and Specifications dated <u>February 9, 2018</u>, shall be included in the project plans and specifications.

1. The following pages shall be replaced in the Project Specifications:

Replace pages 3 and 4 of the Notice to Contractors, pages 84, 97 and 98 of the Special Provisions and pages 3 and 4 of the Proposal with pages 3 (REV) and 4 (REV) of the Notice to Contractors, pages 84 (REV) 97 (REV) and 98 (REV) of the Special Provisions and pages 3 (REV) and 4 (REV) of the Proposal, respectively.

2. The following pages shall be replaced in the Project Plans:

Replace Plan sheets 1, 3, 4, 5, 6, 7, 10 and 14 of the Plans with sheets 1 (REV), 3 (REV), 4 (REV), 5 (REV), 6 (REV), 7 (REV), 10 (REV) and 14 (REV) of the Project Plan sheets, respectively.

Please sign and return the attached "Receipt of Addendum No. 2" form. The "Receipt of Addendum No. 2" form MUST be received in this office no later than 4:00 PM Monday, March 19, 2018 or the bid will NOT be considered. The Receipt of Addendum can be faxed to Gil Tourel's attention at (650)361-8220 or email at gtourel@smcgov.org.



To All Plan Holders

Reconstruction of Seventh Avenue from Middlefield Road To Edison Way

Addendum No. 2

March 15, 2018

Page 2

If you have any questions or require additional information, please contact John Schabowski, Wency Ng, or Gil Tourel of our office at (650) 363-4100. They can also be reached by e-mail at:

jschabowski@smcgov.org wng@smcgov.org gtourel@smcgov.org

Very truly yours,

James C. Porter Director of Public Works

JCP:AMS:GT:WN:JS

F:\Users\design\C3D\E4957000\Docs\Design\Addendum\Addendum 2\E4957 Addendum 2.docx

Encl.- "Receipt of Addendum No. 2" Form
Pages 3 (REV) and 4 (REV) of the Notice to Contractors
Pages 84 (REV) 97 (REV) and 98 (REV) of the Special Provisions
Pages 3 (REV) and 4 (REV) of the Proposal
Plans Sheets 1 (REV), 3 (REV), 4 (REV), 5 (REV), 6 (REV), 7 (REV), 10 (REV) and 14 (REV)

cc: Ann M. Stillman, Deputy Director, Engineering and Resource Protection Gil Tourel, Principal Civil Engineer, Engineering and Construction Wency Ng, Senior Civil Engineer, Project Development and Design John Schabowski, Assistant Engineer, Project Development and Design

## COUNTY OF SAN MATEO DEPARTMENT OF PUBLIC WORKS

James C. Porter Director

County Government Center 555 County Center, 5<sup>th</sup> Floor Redwood City, CA 94063 650-363-4100 T 650-361-8220 F www.smcgov.org

March 15, 2018

#### **COUNTY OF SAN MATEO**

# RECONSTRUCTION OF SEVENTH AVENUE FROM MIDDLEFIELD ROAD TO EDISON WAY IN THE NORTH FAIR OAKS AREA COUNTY ROAD NUMBER 561-A

# TOTAL PROJECT APPROXIMATELY 0.39 MILE IN LENGTH WITH APPURTENANT WORK THERETO IN SAN MATEO COUNTY

COUNTY PROJECT NO. RW703 PROJECT FILE NO. E4957000

#### **RECEIPT OF ADDENDUM NO. 2**

I,, an authorized
representative for, have
received Addendum No. 2 for the Reconstruction of Seventh Avenue from Middlefield Road
to Edison Way in the North Fair Oaks Area from an authorized representative of the County of San
Mateo, to be included in the Plans and Specifications for the above referenced project.
This form must be signed and received in the offices of the County of San Mateo,
Department of Public Works no later than 4:00 PM, Monday, March 19, 2018.
"Contractor"
(Print)
(Signature)
(Date)

#### **ENGINEER'S ESTIMATE**

## RECONSTRUCTION OF SEVENTH AVENUE FROM MIDDLEFIELD ROAD TO EDISON WAY IN THE NORTH FAIR OAKS AREA COUNTY ROAD NUMBER 561-A

# TOTAL PROJECT APPROXIMATELY 0.39 MILE IN LENGTH WITH APPURTENANT WORK THERETO IN SAN MATEO COUNTY

Item No.	Section No.	Estimated Quantity	Unit of Measure	Item Description
1	10	1	LS	Construction Waste Management
2	11	1	LS	Mobilization
3	11-1	1	LS	Water Pollution Control
4	12	1	LS	Maintaining Traffic
5	15-1	6	EA	Adjust Sanitary Sewer Manholes to Grade
6	15-2	1	EA	Reconstruct Sanitary Sewer Manholes to Grade
7	15-3	100	LF	Sanitary Sewer Lateral Replacement
8	15-5	19	EA	Remove and Reset Mailboxes
9	15-6	4	EA	Remove and Reinstall Wooden Neighborhood Street Gate or Fence
10	15-7	15	EA	Potholing
11	15-10	20	LF	Remove and Dispose Existing Abandoned Asbestos Water Pipe
12	15-11	9	EA	Adjust Water Valve Box to Grade (Cal Water)
13	15-12	6 <u>4</u>	EA	Adjust Gas Valve to Grade (PG&E)
14	16	1	LS	Clearing and Grubbing

Engineer's Estimate - Continued on Next Page

#### **ENGINEER'S ESTIMATE**

## RECONSTRUCTION OF SEVENTH AVENUE FROM MIDDLEFIELD ROAD TO EDISON WAY IN THE NORTH FAIR OAKS AREA COUNTY ROAD NUMBER 561-A

# TOTAL PROJECT APPROXIMATELY 0.39 MILE IN LENGTH WITH APPURTENANT WORK THERETO IN SAN MATEO COUNTY

Item No.	Section No.	Estimated Quantity	Unit of Measure	Item Description
15	16-1	3	EA	Remove Tree
16	17	1	LS	Develop and Apply Water
17	19-1	2,300	CY	Roadway Excavation
18	19-2	250	SY	Miscellaneous Driveway Earthwork
19	22	1	LS	Finishing Roadway
20	26	420	CY	Aggregate Base (Class 2)
21	27(S)	5,200	SY	Cement Treatment
22	27-1	30	TON	Sand Cover
23	39-1	1,275	TON	Asphalt Concrete (Type B, 1/2" Maximum Medium Grading)
24	39-2	<del>1,120</del> <u>330</u>	SY	Place Asphalt Concrete (Miscellaneous Areas)
25	39-3	1,650	SY	Deep Lift Asphalt Concrete (Type B, 3/4" Maximum Medium Grading) (0.50' Deep)
26	51-2	235	CY	Class 3 Concrete
27	56-1	8	EA	Remove and Reset Existing Roadside Signs
28	56-2	24	EA	Install Object Markers
29	64	100	LF	Three-inch (3") schedule 40 PVC Drain Pipe

Engineer's Estimate - Continued on Next Page

# SECTION 26. AGGREGATE BASE (CLASS 2)

Aggregate base shall be Class 2 and shall conform to the provisions in Section 26, "Aggregate Bases," of the Standard Specifications and these Special Provisions.

Aggregate base shall be placed where shown on the Plans, as specified in these Special Provisions, and as directed by the Engineer.

Aggregate base shall be produced from commercial quality aggregate consisting of broken stone, crushed gravel, natural, clean, rough-surfaced gravel and sand, or a combination thereof.

Aggregate base shall consist of reclaimed aggregate material up to 50% of the total volume whenever possible, as allowed in tThe first paragraph of Section 26-1.02A, "Class 2 Aggregate Base," which states is amended to state:

".... Aggregate may include material processed from reclaimed asphalt concrete, portland cement concrete, lean concrete base, cement treated base or a combination of any of these materials. The amount of reclaimed material shall not exceed 50 percent of the total volume of the aggregate used."

The grading of the material shall conform to the three-quarter inch (3/4") maximum specified in Section 26-1.02A, "Class 2 Aggregate Base," of the Standard Specifications.

Spreading and compacting shall be performed by methods that will produce a uniform base, firmly and properly compacted to not less than ninety-five percent (95%) relative compaction, and free from pockets of course or fine material. All compacted materials may be tested by the County. The Contractor's attention is directed to Section 6-2, "Materials Testing," of these Special Provisions. Acceptance testing shall be performed using California Test Method (CT) 338 or ASTM D6938, as directed by the Engineer.

The Contractor shall notify the County a minimum of one (1) working day prior to when compacted materials are ready to be tested. The County pays for Contractor's call for first test only. Should the first test fail, or the Engineer's designee to perform the first test arrive and the Contractor not be ready for the test, then all subsequent tests will

as included in the Contract price paid per ton of asphalt concrete, and no additional compensation will be allowed therefore.

The Contractor's attention is directed to Paragraph 12 of Section 39-6.01, "General Requirements," of the Standard Specifications for spreading and compacting asphalt concrete:

"Longitudinal joints in the top layer shall correspond with the edges of proposed traffic lanes. Longitudinal joints in all layers shall be offset not less than 0.50 foot alternately each side of the edges of traffic lanes."

Any asphalt concrete placed outside the lines and dimensions shown on the Plans, and that is not authorized by the Engineer in writing, shall not be paid for. Such quantity of asphalt concrete will be determined by the Engineer using any method he/she deems best suited to obtain an accurate quantity, and such quantity will be deducted from the total paid the Contractor, and no additional compensation will be allowed therefore. The unit weight of asphalt concrete for purposes of deduction shall be the average tested weight of the asphalt concrete used on this Project, or, absent any testing, 155 pounds per cubic foot.

The Contract unit price paid per ton for this item, "Asphalt Concrete (Type B, 1/2" Maximum, Medium grading)," shall include full compensation for furnishing all labor, materials, tools, equipment and incidentals, and for doing all work involved in furnishing and placing asphalt concrete, as shown on the Plans, as specified in these Special Provisions, and as directed by the Engineer, and no additional compensation will be allowed therefore.

### 39-2. Place Asphalt Concrete (Miscellaneous Areas)

Place Asphalt Concrete (Miscellaneous Areas) shall conform to the provisions of Sections 39-7, "Miscellaneous," of the Standard Specifications, these Special Provisions, the Plans, and the directions of the Engineer.

Paragraph 1 of Section 39-7.01, "Miscellaneous areas," is amended to read:

"The surfacing of miscellaneous areas to be paid for at the Contract price per square yard for Place Asphalt Concrete (Miscellaneous Areas), in addition to the price paid for the materials involved, shall be limited to driveway and roadway conforms, and designated shoulder areas, pedestrian walkways, gutters, gutter flares, areas outside the traveled way which are shown on the plans as miscellaneous areas "Miscellaneous Asphalt Concrete" area, and other areas designated by the Engineer."

Asphalt concrete used for miscellaneous asphalt concrete areas shall be Type B (1/2" maximum, medium grading) and shall conform to the provisions of Section 39, "Asphalt Concrete (Type B)," of these Special Provisions.

Aggregate base required for miscellaneous asphalt concrete areas shall conform to the provisions of Section 26, "Aggregate Bases," of these Special Provisions.

Asphaltic Emulsion (Tack Coat) required for miscellaneous asphalt concrete areas shall conform to the provisions of Section 94, "Asphaltic Emulsion (Prime Coat, Curing Seal and Tack Coat)," of these Special Provisions.

The Contractor is advised that it will be his responsibility to assure that existing drainage patterns are maintained at all locations, as indicated on the Plans, unless otherwise directed by the Engineer.

Any miscellaneous asphalt concrete placed beyond the limits, as shown on Plans or as directed by the Engineer, and resulting from the Contractor's operations, shall be at the Contractor's expense, and no additional compensation will be allowed therefore.

The Contractor's attention is directed to the fact that payment for all roadway excavation, driveway conforms, deep lift excavation and furnishing asphalt concrete (Type B) and aggregate base <u>for miscellaneous asphalt concrete areas (driveway and shoulder conforms)</u>, shall be paid for separately in accordance with the provisions of Section 19, "Earthwork," Section 26, "Aggregate Base (Class 2)," and Section 39, "Asphalt Concrete (Type B)," of these Special Provisions.

The Contractor's attention is directed to the fact that full compensation for furnishing and placing asphaltic emulsion (tack coat), complete in-place, shall be considered as included in the Contract price paid per square yard for this item, "Place Asphalt Concrete (Miscellaneous Areas)". Reference is made to Section 94, "Asphaltic Emulsion (Prime Coat, Curing Seal and Tack Coat)".

The Contract price paid per square yard for this item, "Place Asphalt Concrete (Miscellaneous Areas)," shall include full compensation for preparing areas to receive asphalt concrete and for furnishing all labor, materials (except for asphalt concrete (Type B) and aggregate base), tools, equipment and incidentals, and for doing all work involved in placing asphalt concrete in miscellaneous <u>asphalt concrete</u> areas, including, but not limited to, all backfill, and sub-grade preparation, hauling, placing, spreading, and compacting of asphalt concrete in miscellaneous <u>asphalt concrete</u> areas, as shown on the Plans, as specified in the Standard Specifications and these Special Provisions, and as directed by the Engineer, and no additional compensation will be allowed therefore.

#### PROPOSAL TO THE COUNTY OF SAN MATEO

## RECONSTRUCTION OF SEVENTH AVENUE FROM MIDDLEFIELD ROAD TO EDISON WAY IN THE NORTH FAIR OAKS AREA COUNTY ROAD NUMBER 561-A

# TOTAL PROJECT APPROXIMATELY 0.39 MILE IN LENGTH WITH APPURTENANT WORK THERETO IN SAN MATEO COUNTY

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1	10	1	LS	Construction Waste Management	\$	\$
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4	12	1	LS	Maintaining Traffic	\$	\$
5	15-1	6	EA	Adjust Sanitary Sewer Manholes to Grade	\$	\$
6	15-2	1	EA	Reconstruct Sanitary Sewer Manholes to Grade	\$	\$
7	15-3	100	LF	Sanitary Sewer Lateral Replacement	\$	\$
8	15-5	19	EA	Remove and Reset Mailboxes	\$	\$
9	15-6	4	EA	Remove and Reinstall Wooden Neighborhood Street Gate or Fence	\$	\$
10	15-7	15	EA	Potholing	\$	\$
11	15-10	20	LF	Remove and Dispose Existing Abandoned Asbestos Water Pipe	\$	\$
12	15-11	9	EA	Adjust Water Valve Box to Grade (Cal Water)	\$	\$
13	15-12	<u>64</u>	EA	Adjust Gas Valve to Grade (PG&E)	\$	\$
14	16	1	LS	Clearing and Grubbing	\$	\$

Proposal - Continued on Next Page

#### PROPOSAL TO THE COUNTY OF SAN MATEO

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28	56-2	24	EA	Install Object Markers		
29	64	100	LF	Three-inch (3") schedule 40 PVC Drain Pipe	\$	\$

Proposal - Continued on Next Page

# PACIFIC **PROJECT LOCATION** OCEAN BC BLB BOX VICINITY MAP PROJECT LOCATION SEVENTH (7TH) AVENUE. COUNTY ROAD NO 561-A, MENLO PARK, NORTH FAIR OAKS AREA

CATV


CONC

CTN

DIP

D/W

DIAMETER

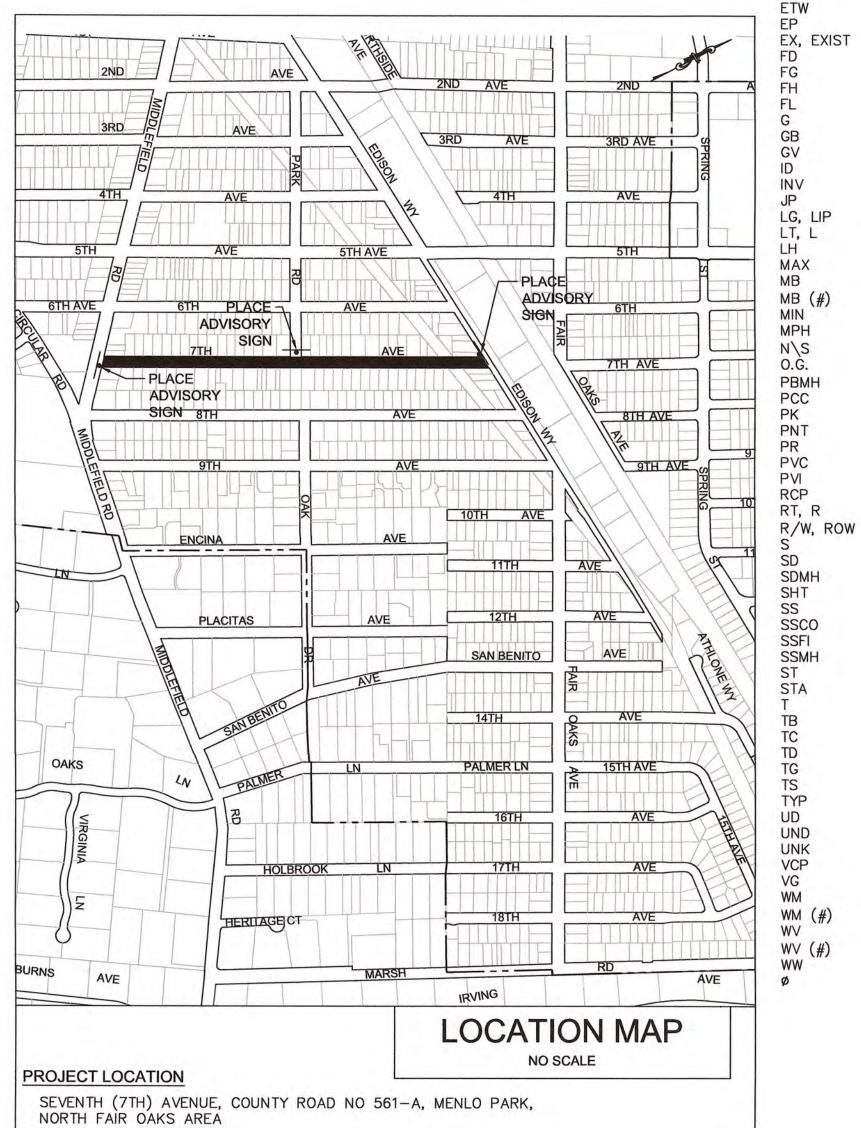

# SAN MATEO COUNTY CALIFORNIA



FEBRUARY 9, 2018

R. C. E. # 48056 / EXPIRES 12-31-2019


MARCH 15, 2018

# RECONSTRUCTION OF SEVENTH (7TH) AVENUE

FROM MIDDLEFIELD ROAD TO EDISON WAY IN THE NORTH FAIR OAKS AREA **COUNTY ROAD NUMBER 561-A** 

TOTAL PROJECT LENGTH, APPROXIMATELY 0.39 MILES

TO BE SUPPLEMENTED BY STATE OF CALIFORNIA DEPARTMENT OF TRANSPORTATION STANDARD PLANS DATED MAY 2006 AND ADOPTED BY SAN MATEO COUNTY, NOVEMBER 14, 2006, BY RESOLUTION NO. 68389

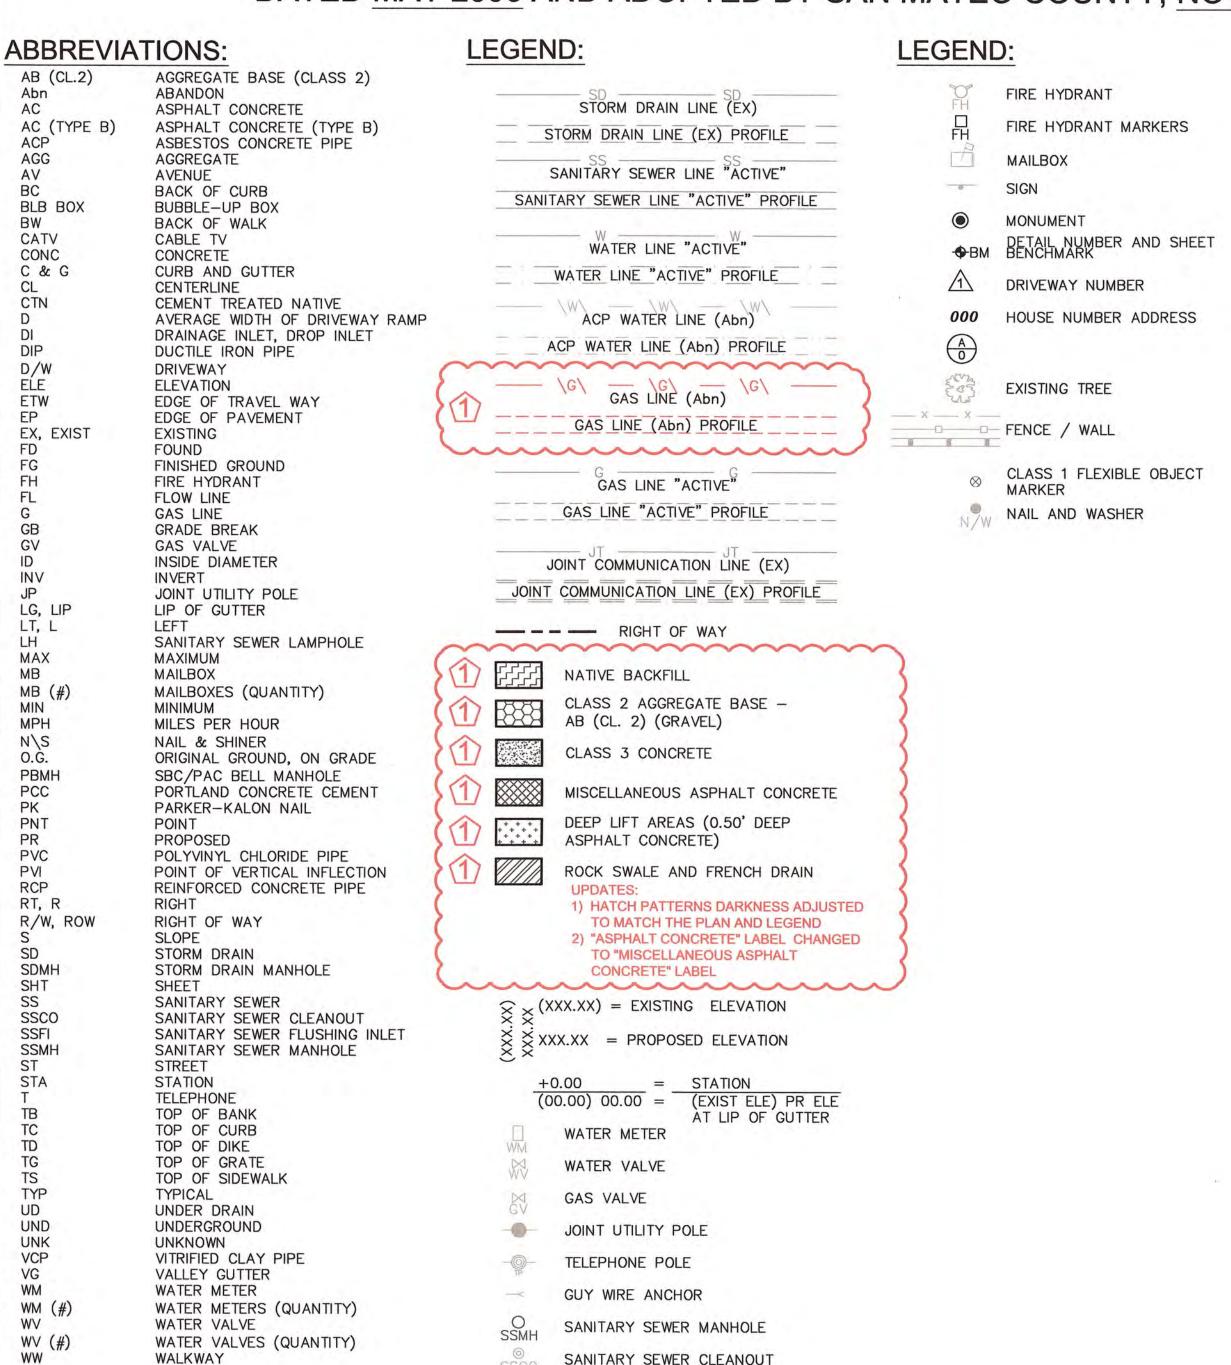

SANITARY SEWER FLUSHING INLET

STORM DRAIN MANHOLE

UNDERDRAIN

BUBBLE-UP BOX

UNKNOWN MANHOLE

## NOTES:

- CONTRACTOR SHALL CONFINE HIS OPERATIONS AND ACTIVITIES WITHIN THE PROJECT LIMITS, CONSISTING OF ROAD RIGHT-OF-WAY, RIGHTS OF ENTRY AND/OR PROJECT CONFORMS, AS SHOWN ON THE PLANS AND AS
- CONTINUOUS DUST CONTROL SHALL BE PROVIDED AS REQUIRED BY
- ATERALS. CONTRACTOR SHALL BE RESPONSIBLE FOR VERIFICATION AND PRESERVATION OF ALL SUCH FACILITIES WHICH ARE NOT TO BE
- 5. CONTRACTOR IS ADVISED THAT EXCAVATION MAY CONFLICT WITH SANITARY SEWER LATERALS, GAS LINES, WATER LINES AND OTHER UNDERGROUND UTILITIES. ANY DAMAGE TO EXISTING FACILITIES CAUSED BY THE CONTRACTOR SHALL BE REPAIRED AT THE CONTRACTOR'S EXPENSE.
- 6. DRIVEWAY OPENINGS AND CONFORM LOCATIONS SHOWN ARE APPROXIMATE ONLY, EXACT LOCATIONS WILL BE DETERMINED IN THE FIELD BY THE ENGINEER. SURFACED SHOULDER CONFORM LIMITS ARE AS INDICATED AT 3 FEET FROM OUTSIDE EDGE OF THE GUTTER, UNLESS DIRECTED OTHERWISE BY THE ENGINEER OR OTHERWISE NOTED ON THE PLANS.
- 7. NO TREES, VEGETATION OR IMPROVEMENTS (INCLUDING FENCES) SHALL BE REMOVED WITHOUT THE PRIOR WRITTEN CONSENT AND APPROVAL OF THE ENGINEER. VEGETATION AND IMPROVEMENTS WHICH ARE DESIGNATED TO BE REMOVED SHALL BECOME THE PROPERTY OF THE CONTRACTOR, UNLESS OTHERWISE DIRECTED BY THE ENGINEER. REFER TO PROJECT SPECIAL PROVISIONS SECTION 16 REGARDING REQUIREMENTS FOR ADVANCE NOTIFICATION OF PROPERTY OWNERS.
- 8. THE CONTRACTOR'S ATTENTION IS DIRECTED TO SECTION 5-1.07 OF THE STANDARD SPECIFICATIONS. THE SURVEY AND ASSOCIATED STAKING SHALL BE IN CONFORMANCE WITH SECTION 100. CONSTRUCTION STAKING AND LAYOUT OF THE SPECIAL PROVISIONS.
- 9. WHEN DIRECTED BY THE ENGINEER, CUT AND FILL SLOPE RATIOS SHALL BE VARIED TO AVOID TREES OR OTHER EXISTING IMPROVEMENTS.
- 10. CONTRACTOR SHALL EXERCISE CARE WHEN EXCAVATING NEAR TREES AND ROOTS OF TREES TO REMAIN. SEE SECTION 19 OF THE SPECIAL
- 11. ANY DAMAGE, AS A RESULT OF THE CONTRACTOR'S OPERATION, TO PAVEMENT AND BASE MATERIAL THAT IS TO REMAIN SHALL BE REPAIRED, OR REMOVED AND REPLACED WITH SAME TYPE OF MATERIAL OR APPROVED EQUAL, AS DIRECTED BY THE ENGINEER, AND AT THE SOLE EXPENSE OF THE CONTRACTOR. THE ENGINEER SHALL BE THE SOLE JUDGE OF THE ADEQUACY OF THE COMPLETED REMEDIAL WORK.
- 12. CONTRACTOR'S ATTENTION IS DIRECTED TO THE CONSTRUCTION CENTERLINE ALIGNMENTS LISTED BELOW:
  - "7-CL" LINE SEVENTH (7TH) AVENUE (BETWEEN MIDDLEFIELD ROAD AND EDISON WAY)
  - "P-CL" LINE PARK ROAD (BETWEEN SEVENTH (7TH) AVENUE AND SECOND (2ND) AVENUE) "E-CL" LINE - EDISON WAY
  - (BETWEEN FIRST (1ST) AVENUE AND ELEVENTH (11TH) AVENUE) "M-CL" LINE - MIDDLEFIELD ROAD (BETWEEN FIFTH (5TH) AVENUE AND EIGHTH (8TH) AVENUE)

## SHEET INDEX:

REFERENCE DWG:

TITLE SHEET / GENERAL NOTES TYPICAL SECTIONS

AND CORRIDOR IMPROVEMENTS (1/4511)

APPLICABLE STANDARD PLANS:


A20A, A20B, A24D, A73A, A87, A88A, A88B, D97H, T13


MIDDLEFIELD ROAD UNDERGROUND UTILITY DISTRICT (PHASE 1)


NORTH FAIR OAKS IMPROVEMENTS - YEAR 1 (FILE NO. 1/4663)

- 3. 7. PLAN AND PROFILE 8. - 9. DRIVEWAY AND GUTTER DETAIL
- PLAN AND GRID DATA 11. - 14. MISCELLANEOUS DETAILS SURVEY CONTROL PLAN

OF SAA	REVISION	DATE	DESIGNED BY:	JS	RECONSTRUCTION OF S	SEVENTH (7TH) AVENUE	SCALE: NONE
	1	03-15-18, ADDENDUM 2	CHECKED BY:	WN			DATE: 02-09-2018
			DRAWN BY:	JS	TITLE SHEET / G	SENERAL NOTES	FILE NO.: 1/4957
S S S S S S S S S S S S S S S S S S S			JAMES C. PORTER, DIRECTOR OF PUBLIC WORKS  SAN MATEO COUNTY  555 COUNTY CENTER REDWOOD CITY, CALI				
SOLIC WORKS		FOR REDUCED P ORIGINAL SCALE		0	1 2	3 4	1 (REV) SHEET 1 OF 15

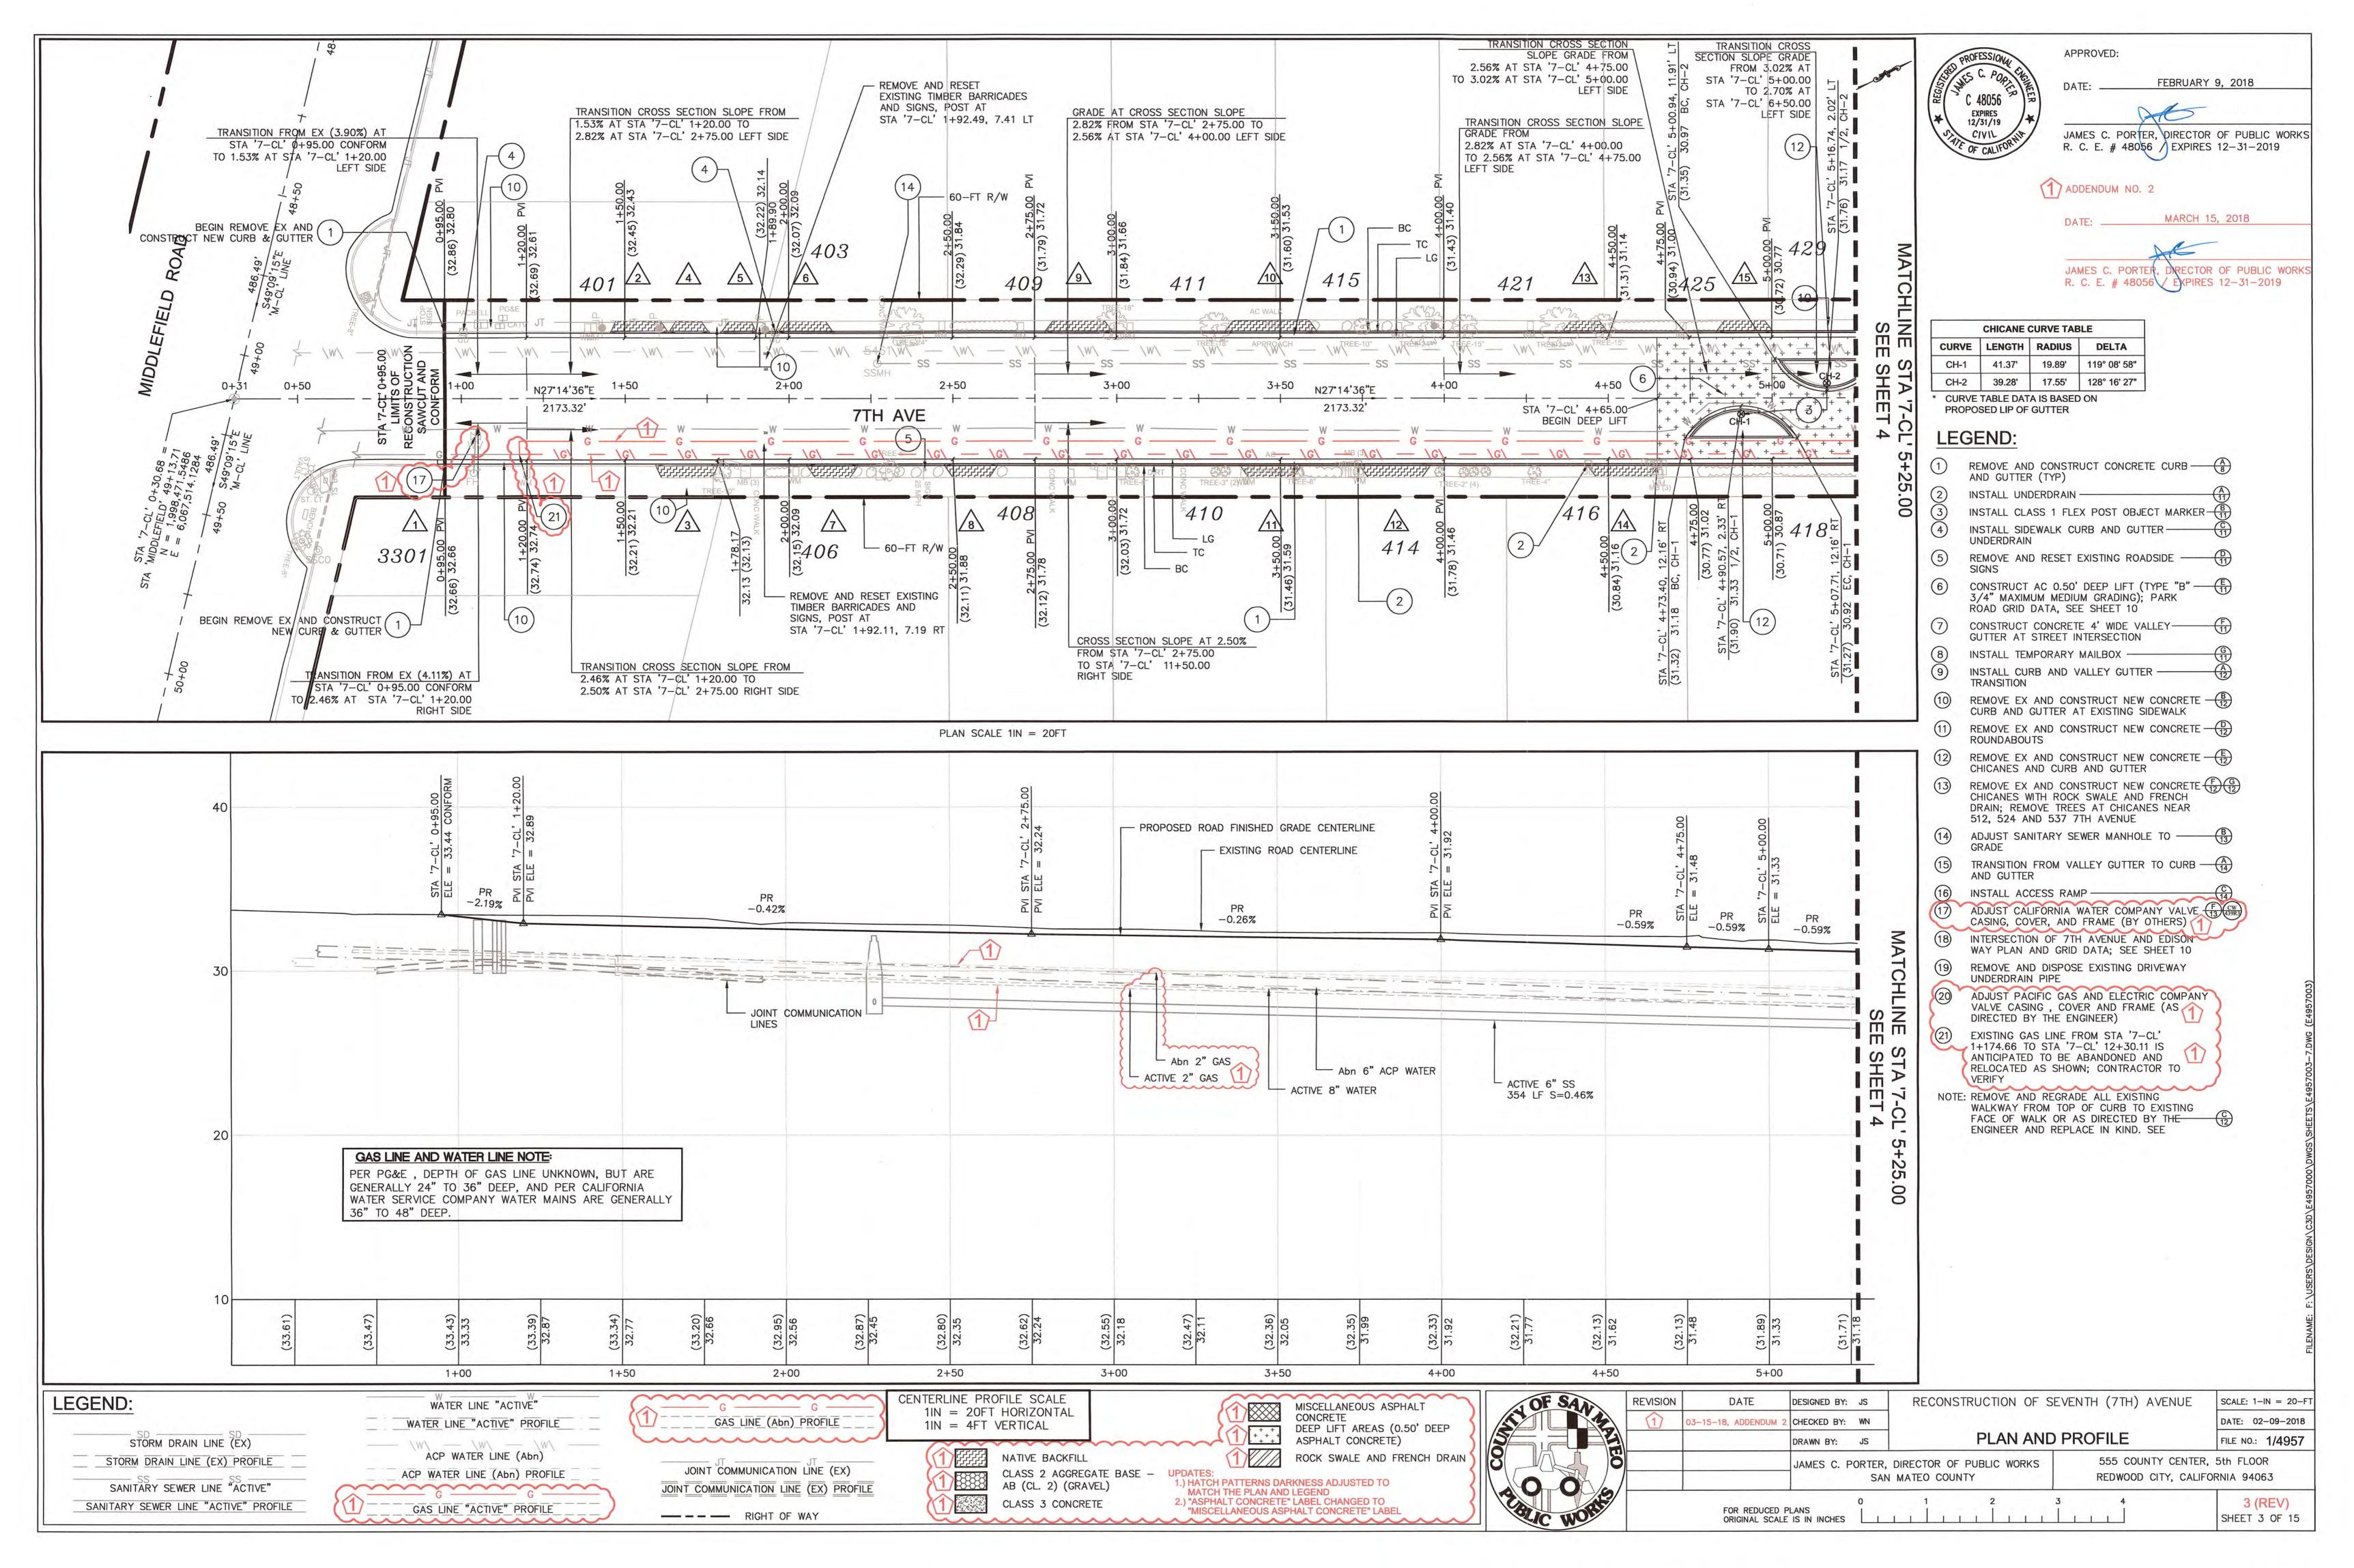

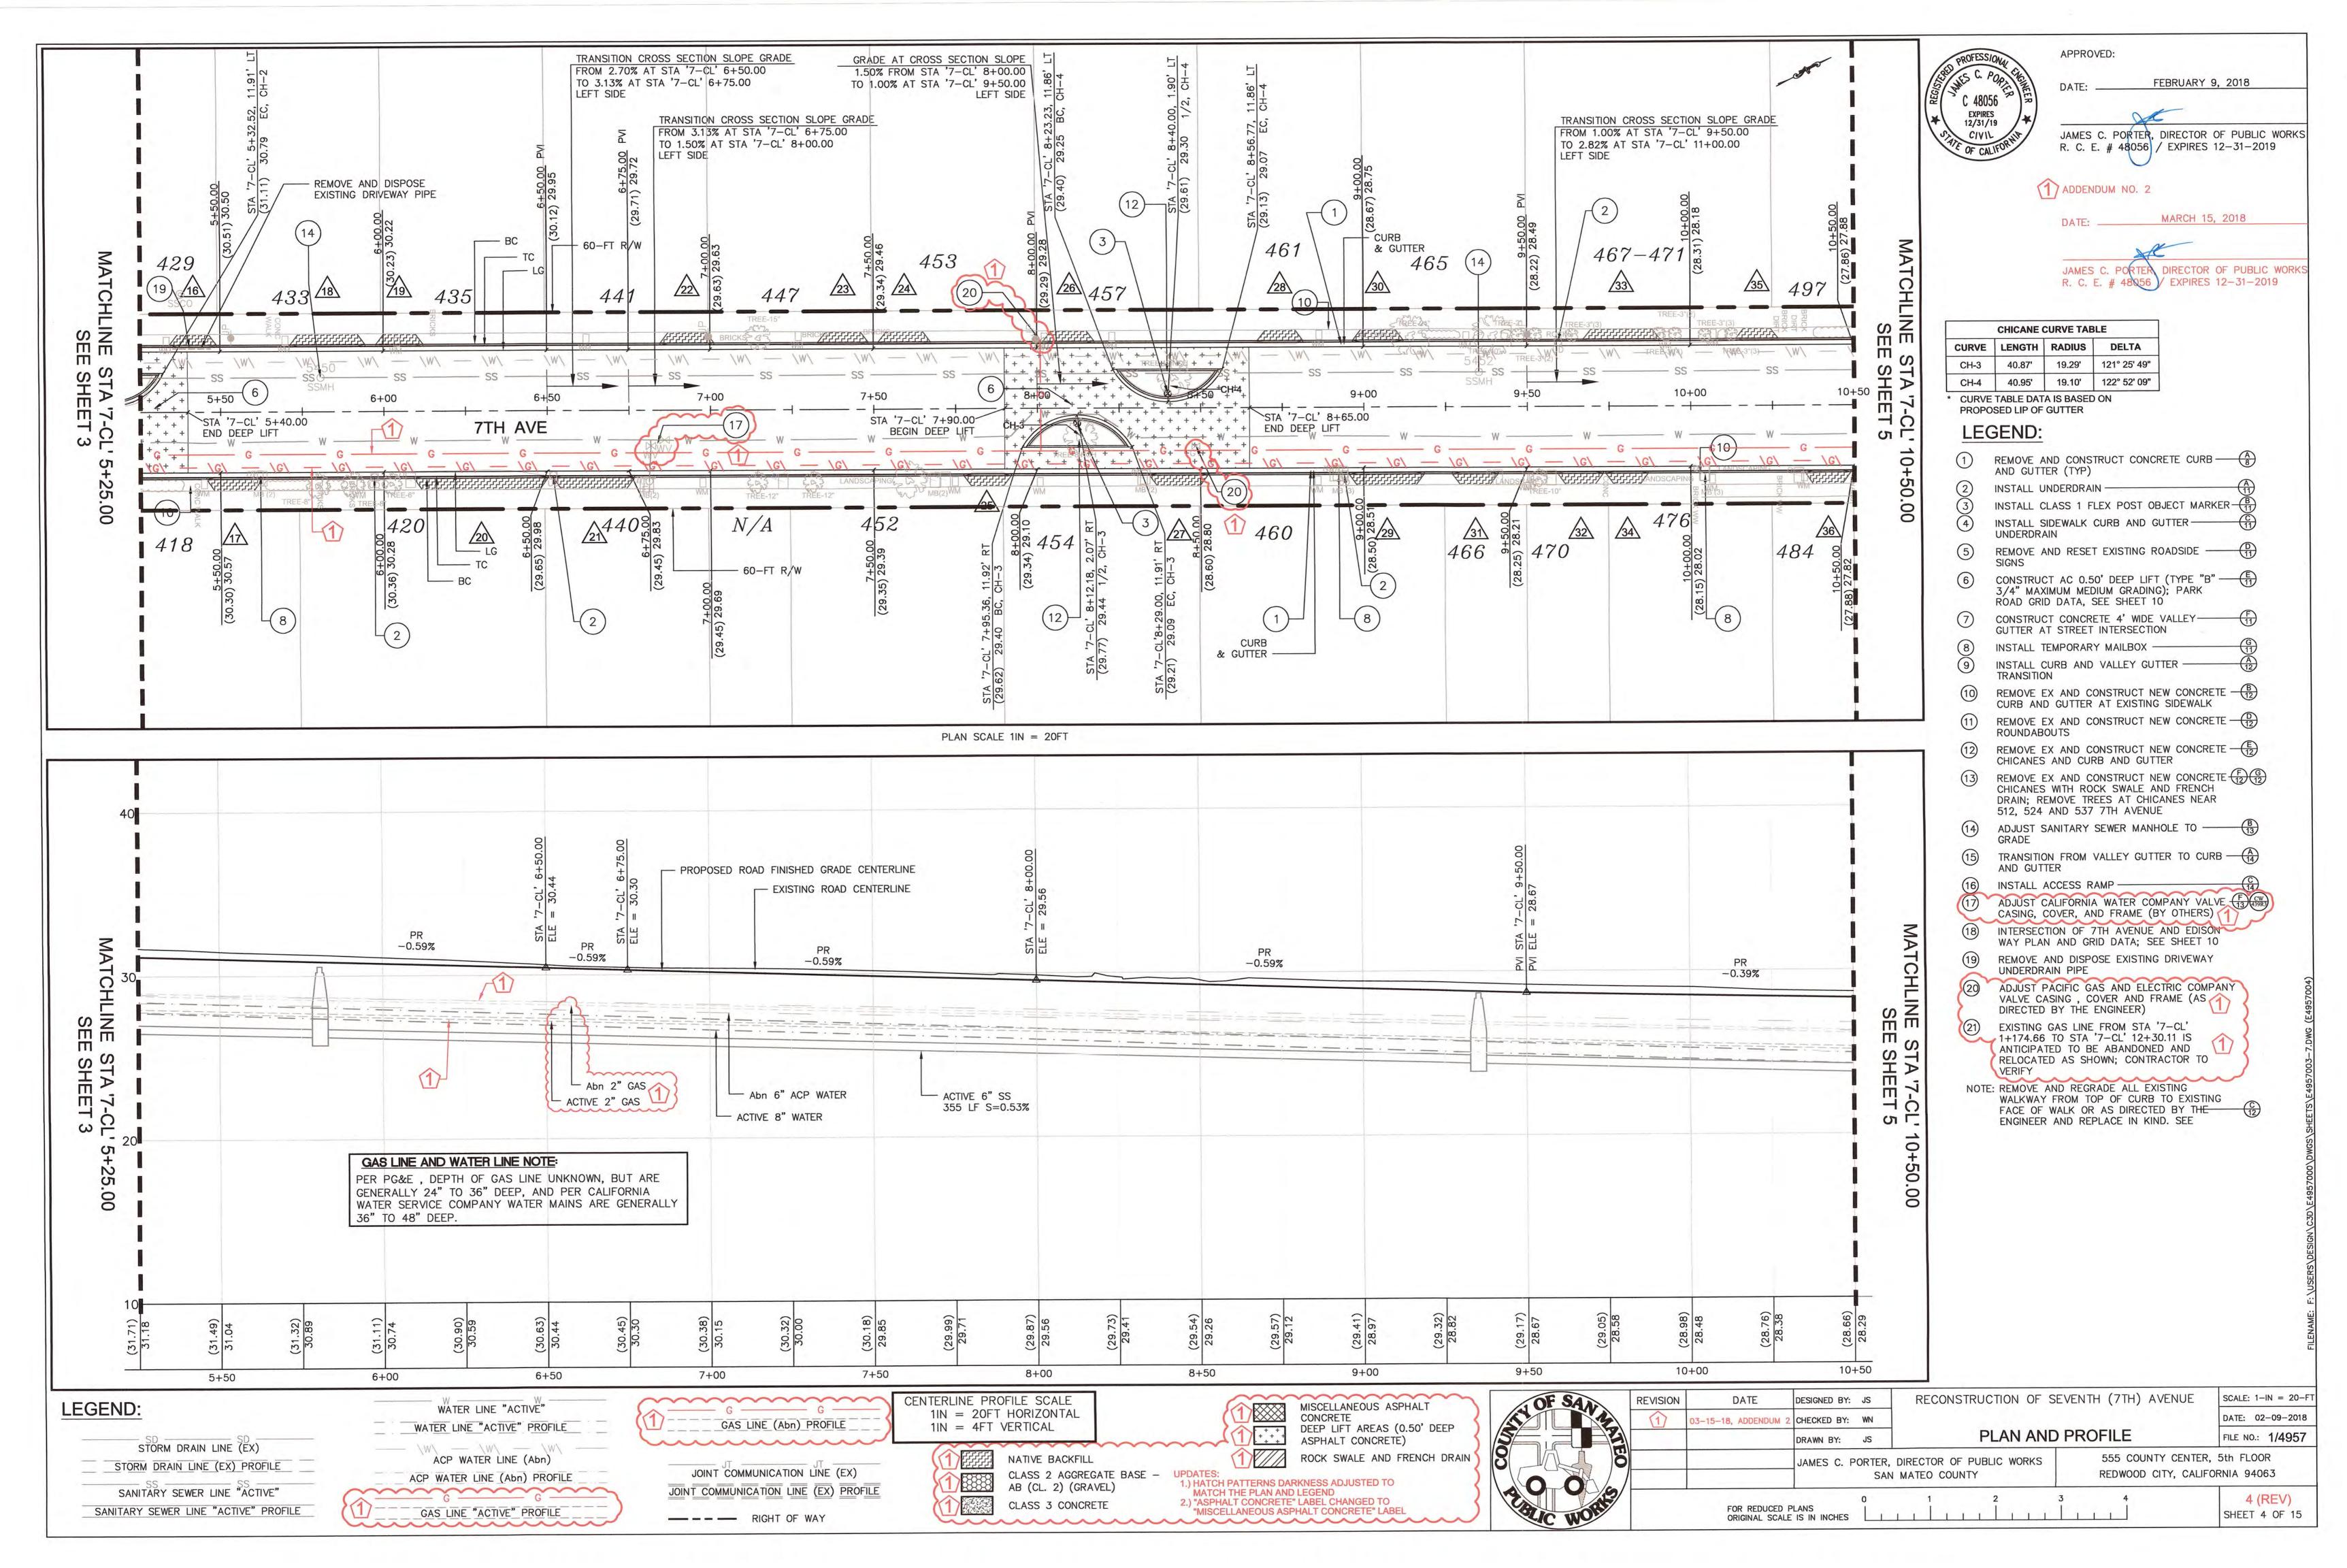

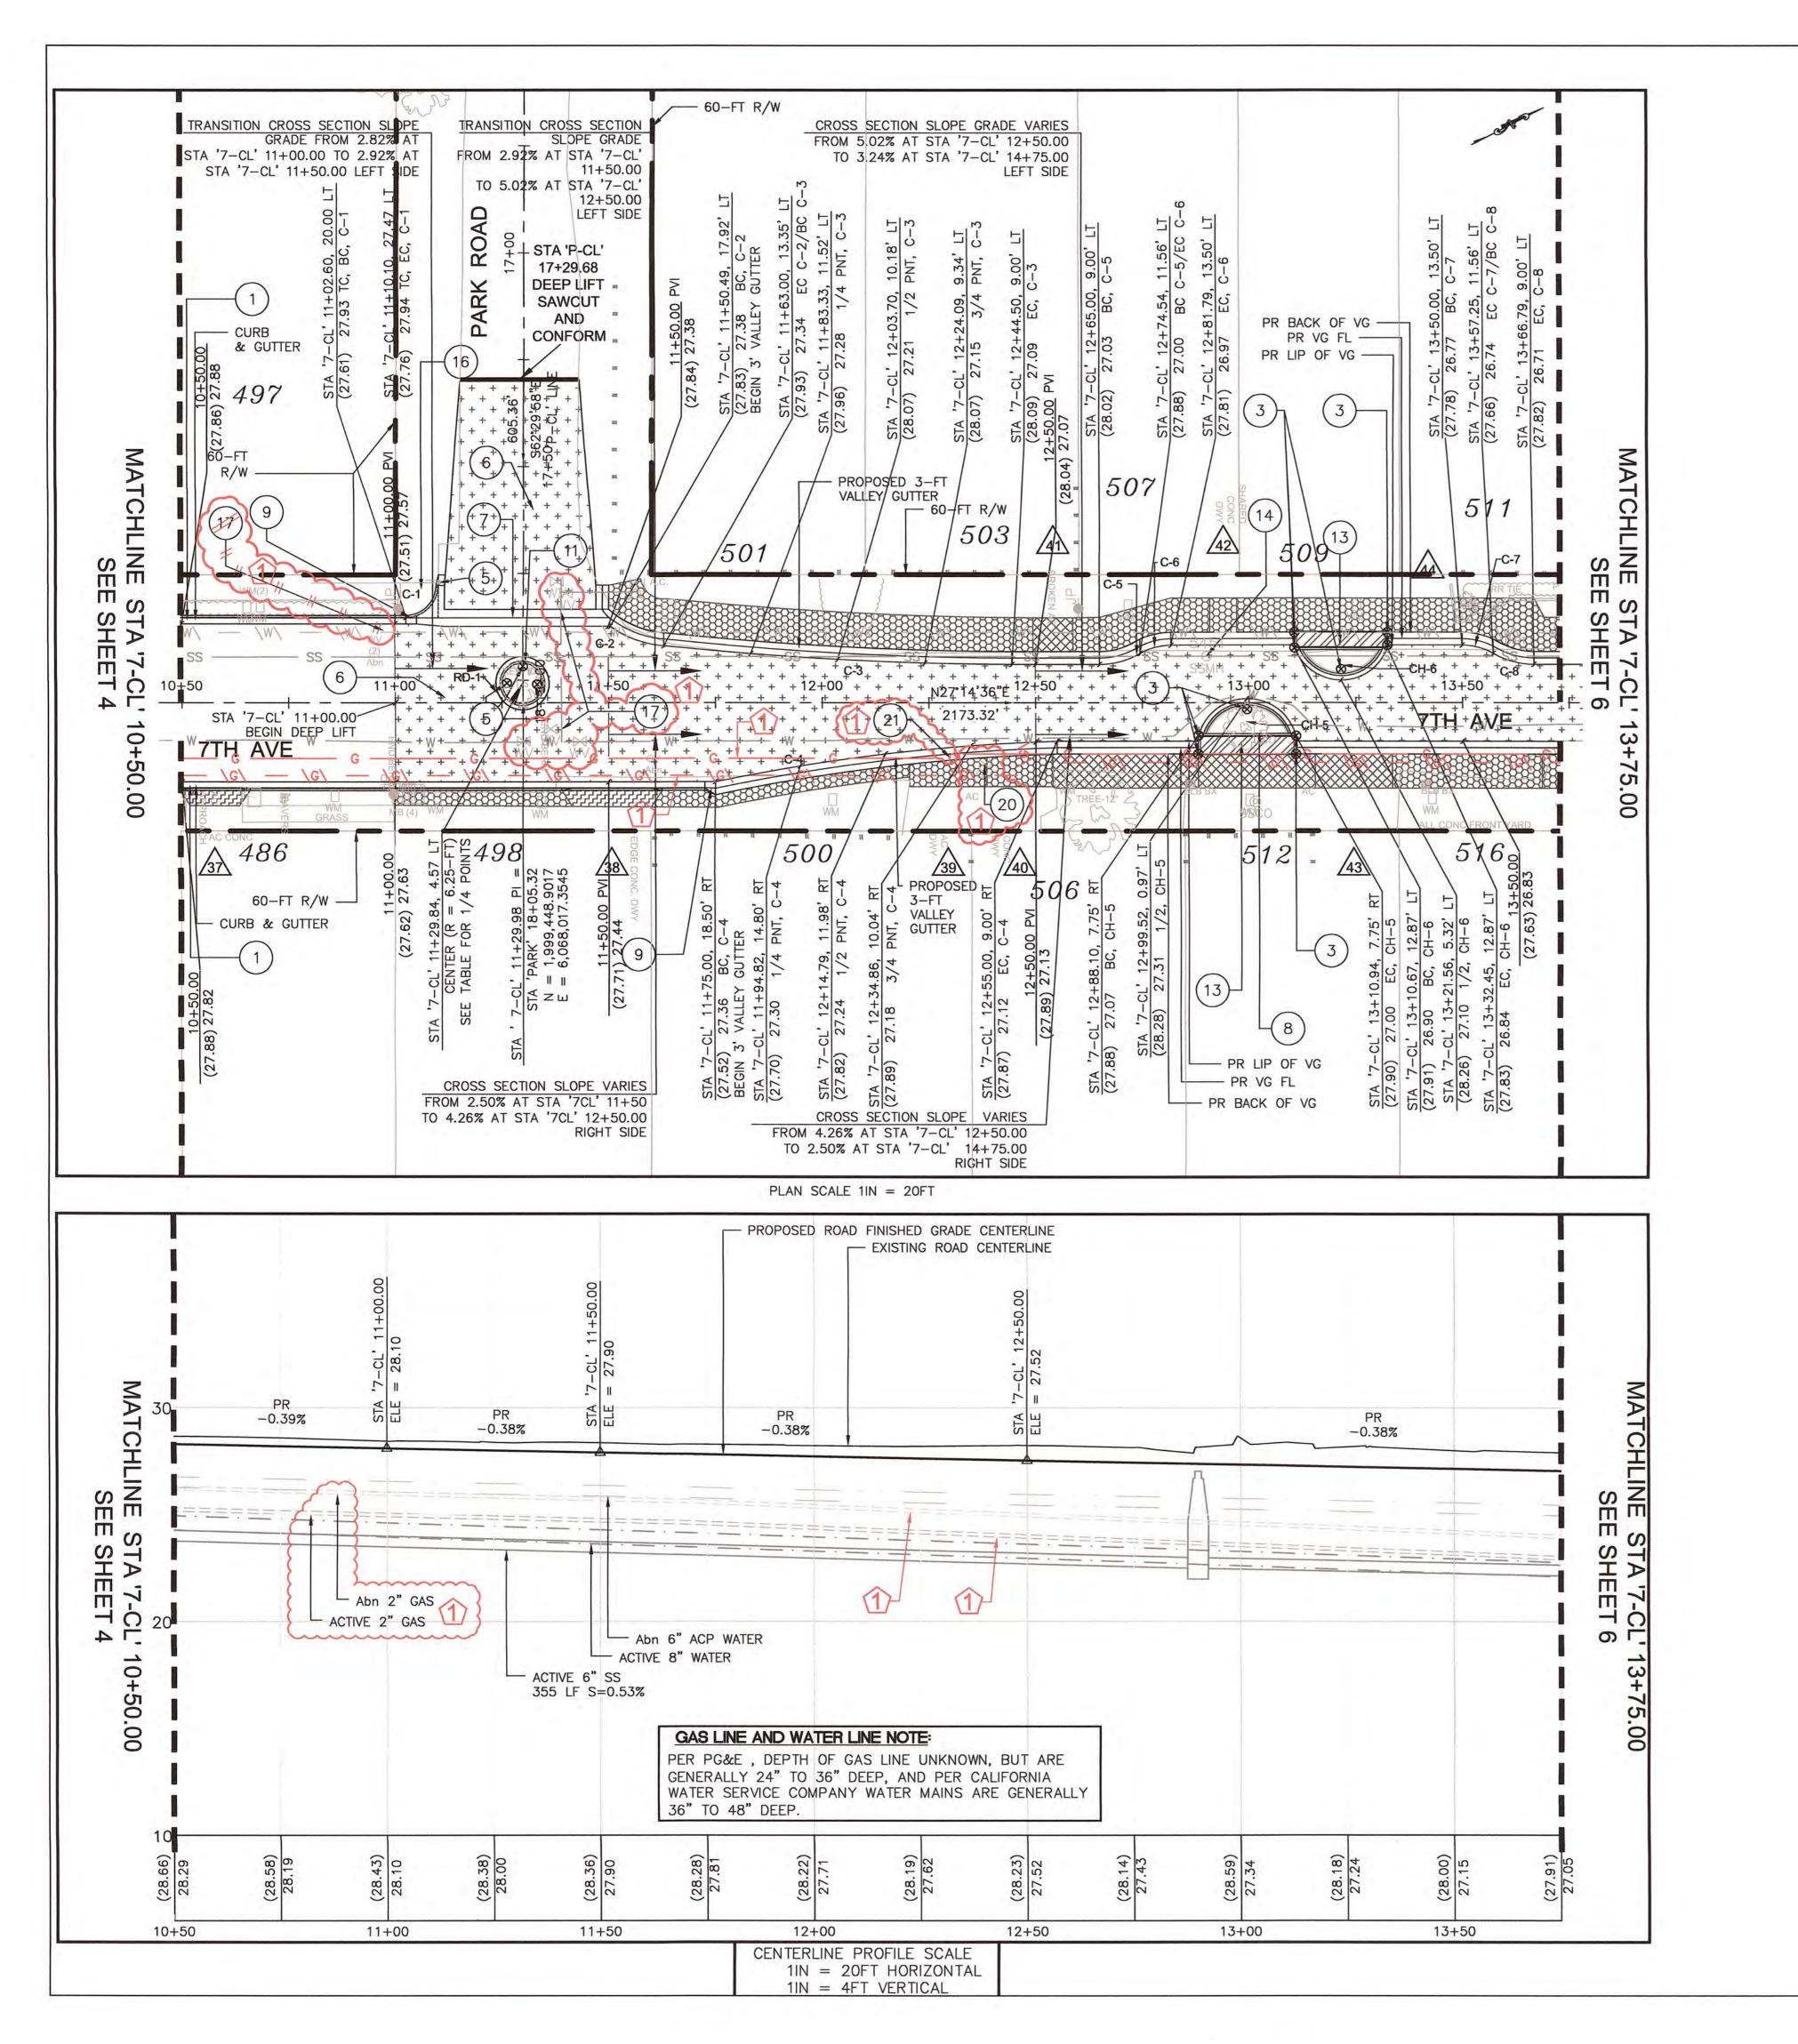



APPROVED: FEBRUARY 9, 2018

R. C. E. # 48056 EXPIRES 12-31-2019

JAMES C. PORTER, DIRECTOR OF PUBLIC WORKS

ADDENDUM NO. 2

DATE: \_\_\_\_\_\_ MARCH 15, 2018

R. C. E. # 48056 EXPIRES 12-31-2019

CURVE TABLE*								
CURVE	DELTA							
C-1	11.75'	7.50'	89° 44' 34"					
C-2	13.48'	24.60'	31° 24' 04"					
C-3	81.65'	835.49'	05° 35' 57"					
C-4	80.67'	455.47'	10° 08' 52"					
C-5	9.99'	19.08'	30° 00' 00"					
C-6	7.60'	14.51'	29° 59' 59"					
C-7	7.60'	14.51'	30° 00' 00"					
C-8	9.99'	19.08'	30° 00' 00"					
CH-5	30.88'	11.84'	149° 24' 46"					
CH-6	28.20"	11.63'	138° 57' 58"					
RD-1		6.50'						

RD-1, CENTER AT STA'7-CL' 11+29.84, 4.57 LT \* CURVE TABLE DATA IS BASED ON PROPOSED LIP OF GUTTER, EXCEPT C-1 BASED ON PROPOSED TOP OF CURB

## LEGEND:

STORM DRAIN LINE (EX) STORM DRAIN LINE (EX) PROFILE SANITARY SEWER LINE "ACTIVE" SANITARY SEWER LINE "ACTIVE" PROFILE WATER LINE "ACTIVE" WATER LINE "ACTIVE" PROFILE ACP WATER LINE (Abn) ACP WATER LINE (Abn) PROFILE

JOINT COMMUNICATION LINE (EX) JOINT COMMUNICATION LINE (EX) PROFILE

--- RIGHT OF WAY

NATIVE BACKFILL CLASS 2 AGGREGATE BASE -AB (CL. 2) (GRAVEL) CLASS 3 CONCRETE

MISCELLANEOUS ASPHALT CONCRETE DEEP LIFT AREAS (0.50' DEEP

ASPHALT CONCRETE)

1.) HATCH PATTERNS DARKNESS ADJUSTED TO MATCH THE PLAN AND LEGEND 2.) "ASPHALT CONCRETE" LABEL CHANGED TO

"MISCELLANEOUS ASPHALT CONCRETE" LABEL

ROCK SWALE AND FRENCH DRAIN

## LEGEND:

		AND GOTTEN (TIT)
	2	INSTALL UNDERDRAIN (A)
	3	INSTALL CLASS 1 FLEX POST OBJECT MARKER (1)
	4	INSTALL SIDEWALK CURB AND GUTTER — CC 11 UNDERDRAIN
	5	REMOVE AND RESET EXISTING ROADSIDE  SIGNS
	6	CONSTRUCT AC 0.50' DEEP LIFT (TYPE "B" — (1) 3/4" MAXIMUM MEDIUM GRADING); PARK ROAD GRID DATA, SEE SHEET 10
	7	CONSTRUCT CONCRETE 4' WIDE VALLEY———————————————————————————————————
	8	INSTALL TEMPORARY MAILBOX (G)
	9	INSTALL CURB AND VALLEY GUTTER ———————————————————————————————————
	10	REMOVE EX AND CONSTRUCT NEW CONCRETE $-\frac{B}{12}$ CURB AND GUTTER AT EXISTING SIDEWALK
	11)	REMOVE EX AND CONSTRUCT NEW CONCRETE - D 12 ROUNDABOUTS
	12	REMOVE EX AND CONSTRUCT NEW CONCRETE $-\frac{\mathbb{E}}{12}$ CHICANES AND CURB AND GUTTER
	13	REMOVE EX AND CONSTRUCT NEW CONCRETE (F) (G) (12) (T) (T) (T) (T) (T) (T) (T) (T) (T) (T
	14)	ADJUST SANITARY SEWER MANHOLE TO   B  3  GRADE
5	15)	TRANSITION FROM VALLEY GUTTER TO CURB $-\frac{A}{4}$ AND GUTTER
)	(16)	INSTALL ACCESS RAMP (74)
5	(17)	ADJUST CALIFORNIA WATER COMPANY VALVE (13) (33) (33) CASING, COVER, AND FRAME (BY OTHERS)
3	18	INTERSECTION OF 7TH AVENUE AND EDISON WAY PLAN AND GRID DATA; SEE SHEET 10
J		


1) REMOVE AND CONSTRUCT CONCRETE CURB — (A)
AND GUTTER (TYP)


REMOVE AND DISPOSE EXISTING DRIVEWAY UNDERDRAIN PIPE ADJUST PACIFIC GAS AND ELECTRIC COMPANY VALVE CASING , COVER AND FRAME (AS DIRECTED BY THE ENGINEER) EXISTING GAS LINE FROM STA '7-CL' 1+174.66 TO STA '7-CL' 12+30.11 IS ANTICIPATED TO BE ABANDONED AND RELOCATED AS SHOWN; CONTRACTOR TO

NOTE: REMOVE AND REGRADE ALL EXISTING WALKWAY FROM TOP OF CURB TO EXISTING FACE OF WALK OR AS DIRECTED BY THE ENGINEER AND REPLACE IN KIND. SEE

RECONSTRUCTION OF SEVENTH (7TH) AVENUE REVISION DATE SCALE: 1-IN = 20-F DESIGNED BY: JS DATE: 02-09-2018 3-15-18, ADDENDUM 2 CHECKED BY: WN PLAN AND PROFILE FILE NO.: 1/4957 DRAWN BY: JS 555 COUNTY CENTER, 5th FLOOR JAMES C. PORTER, DIRECTOR OF PUBLIC WORKS SAN MATEO COUNTY REDWOOD CITY, CALIFORNIA 94063 5 (REV) FOR REDUCED PLANS SHEET 5 OF 15

ORIGINAL SCALE IS IN INCHES

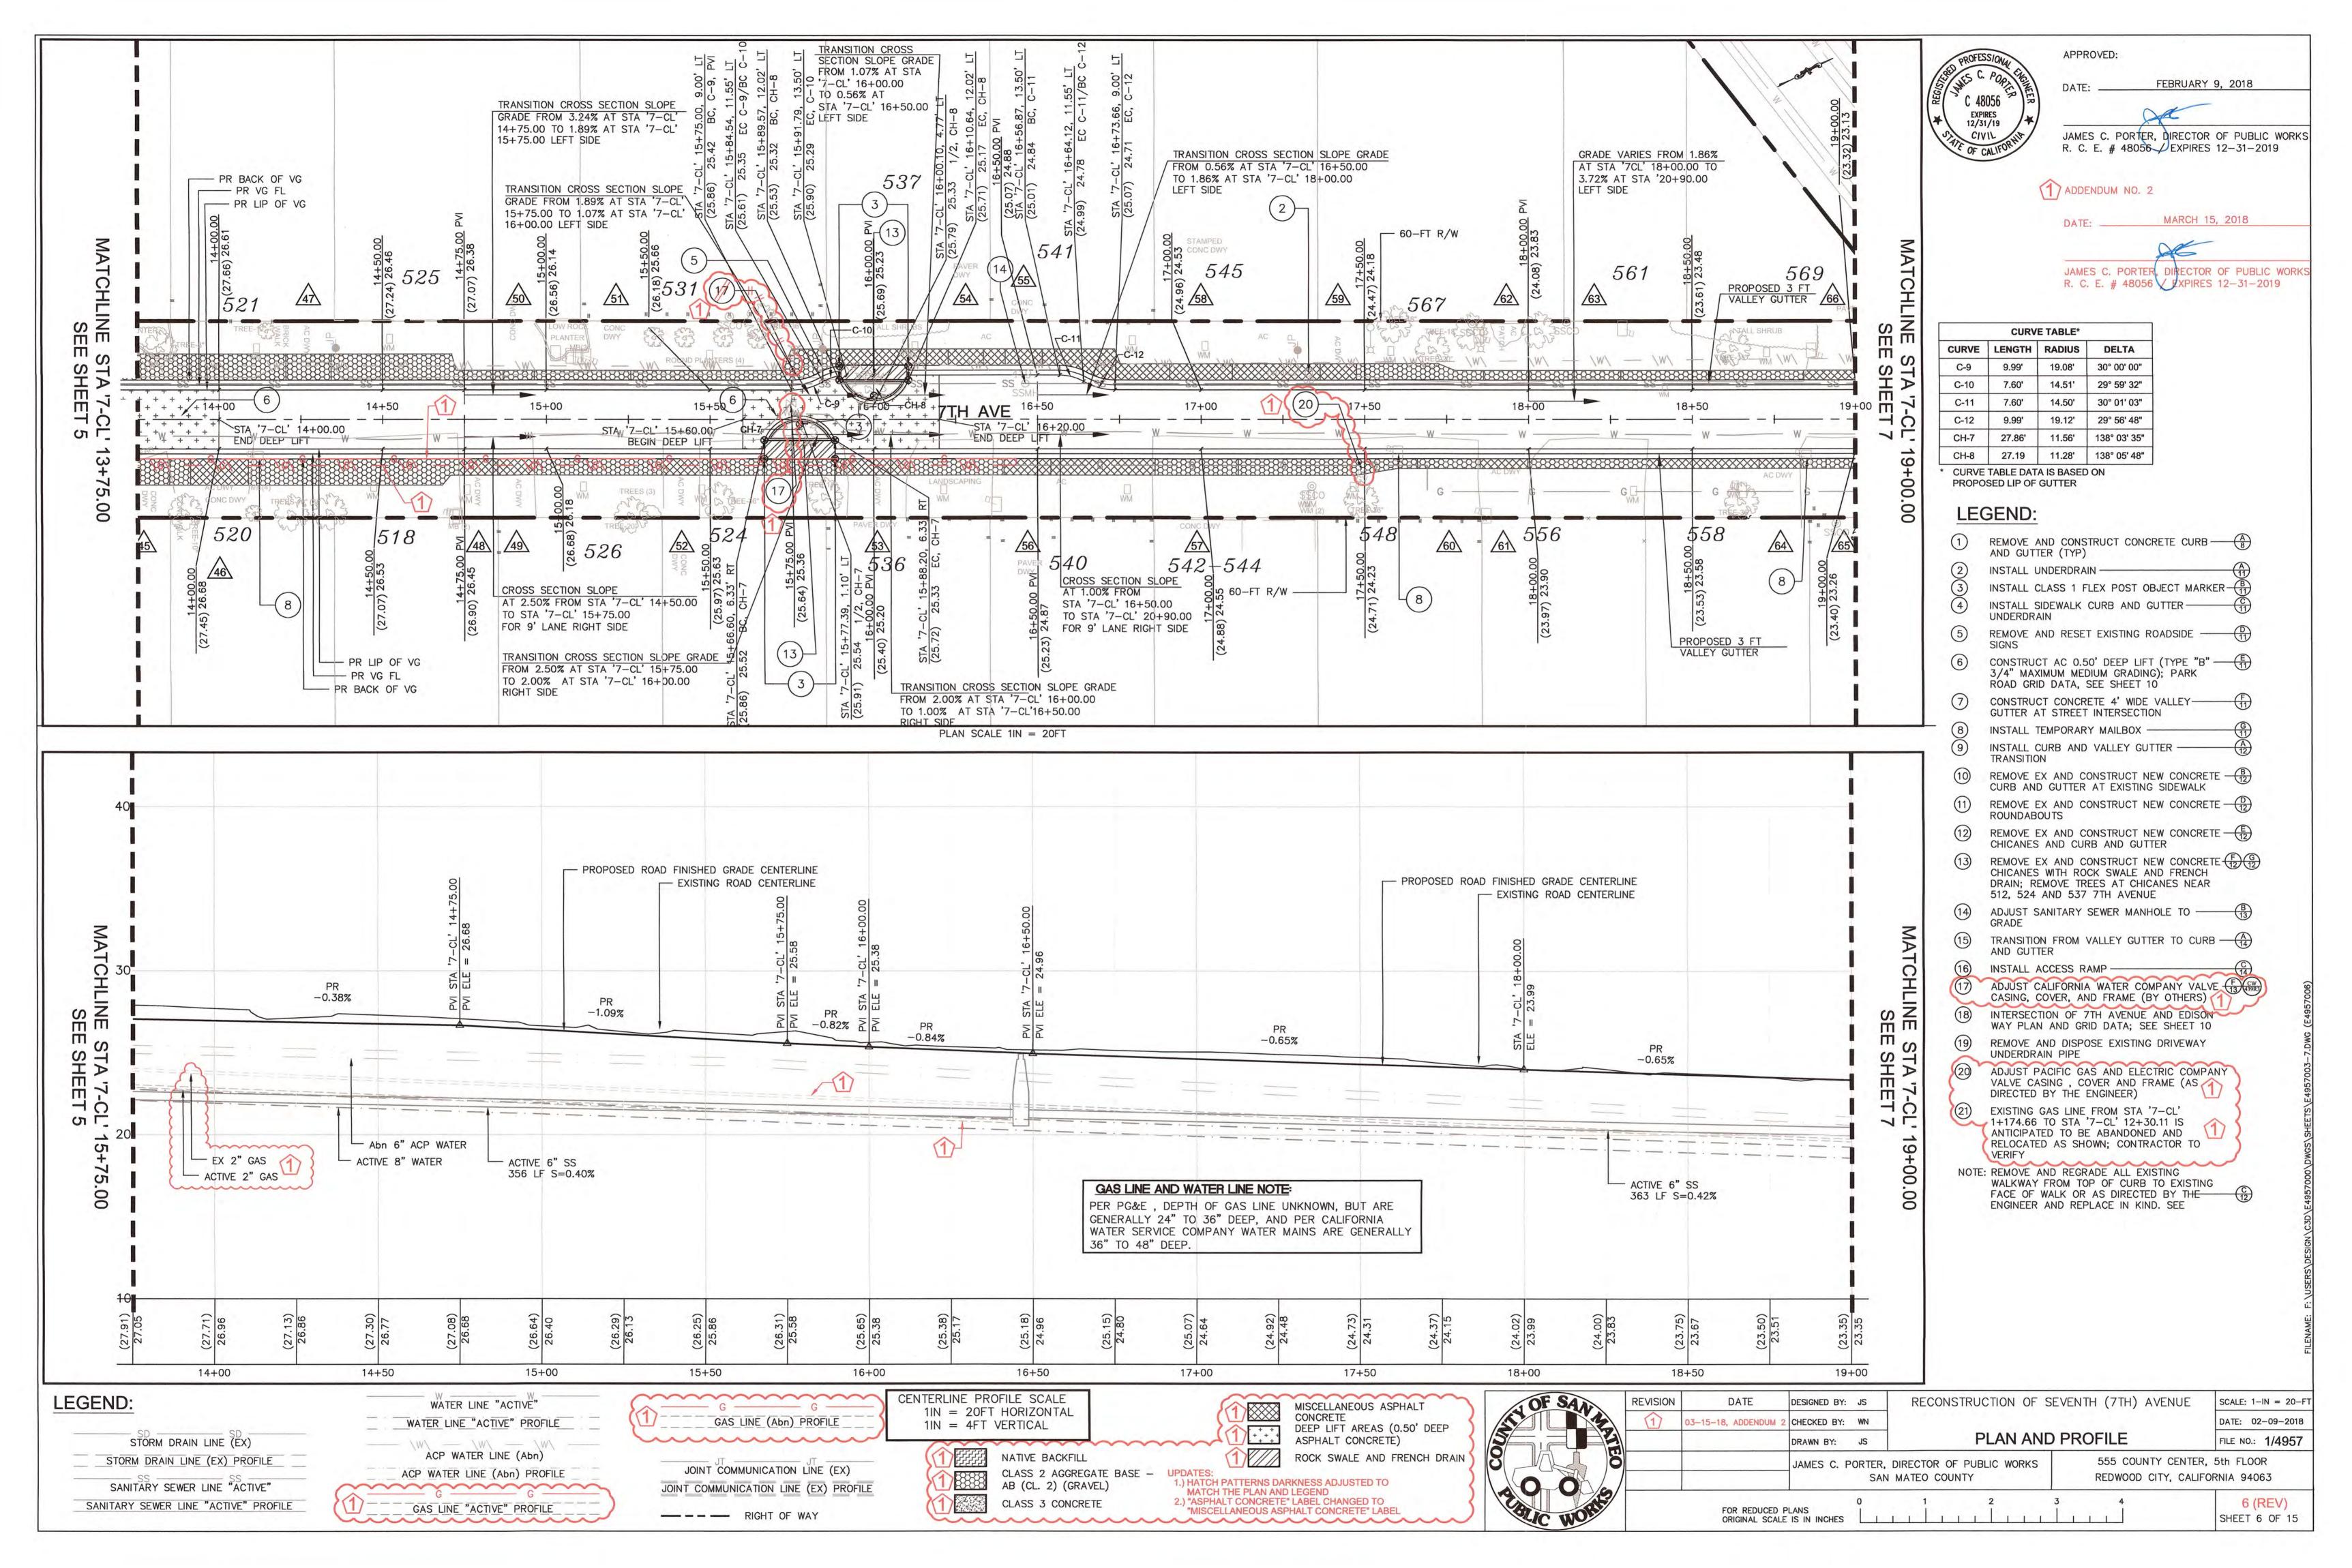

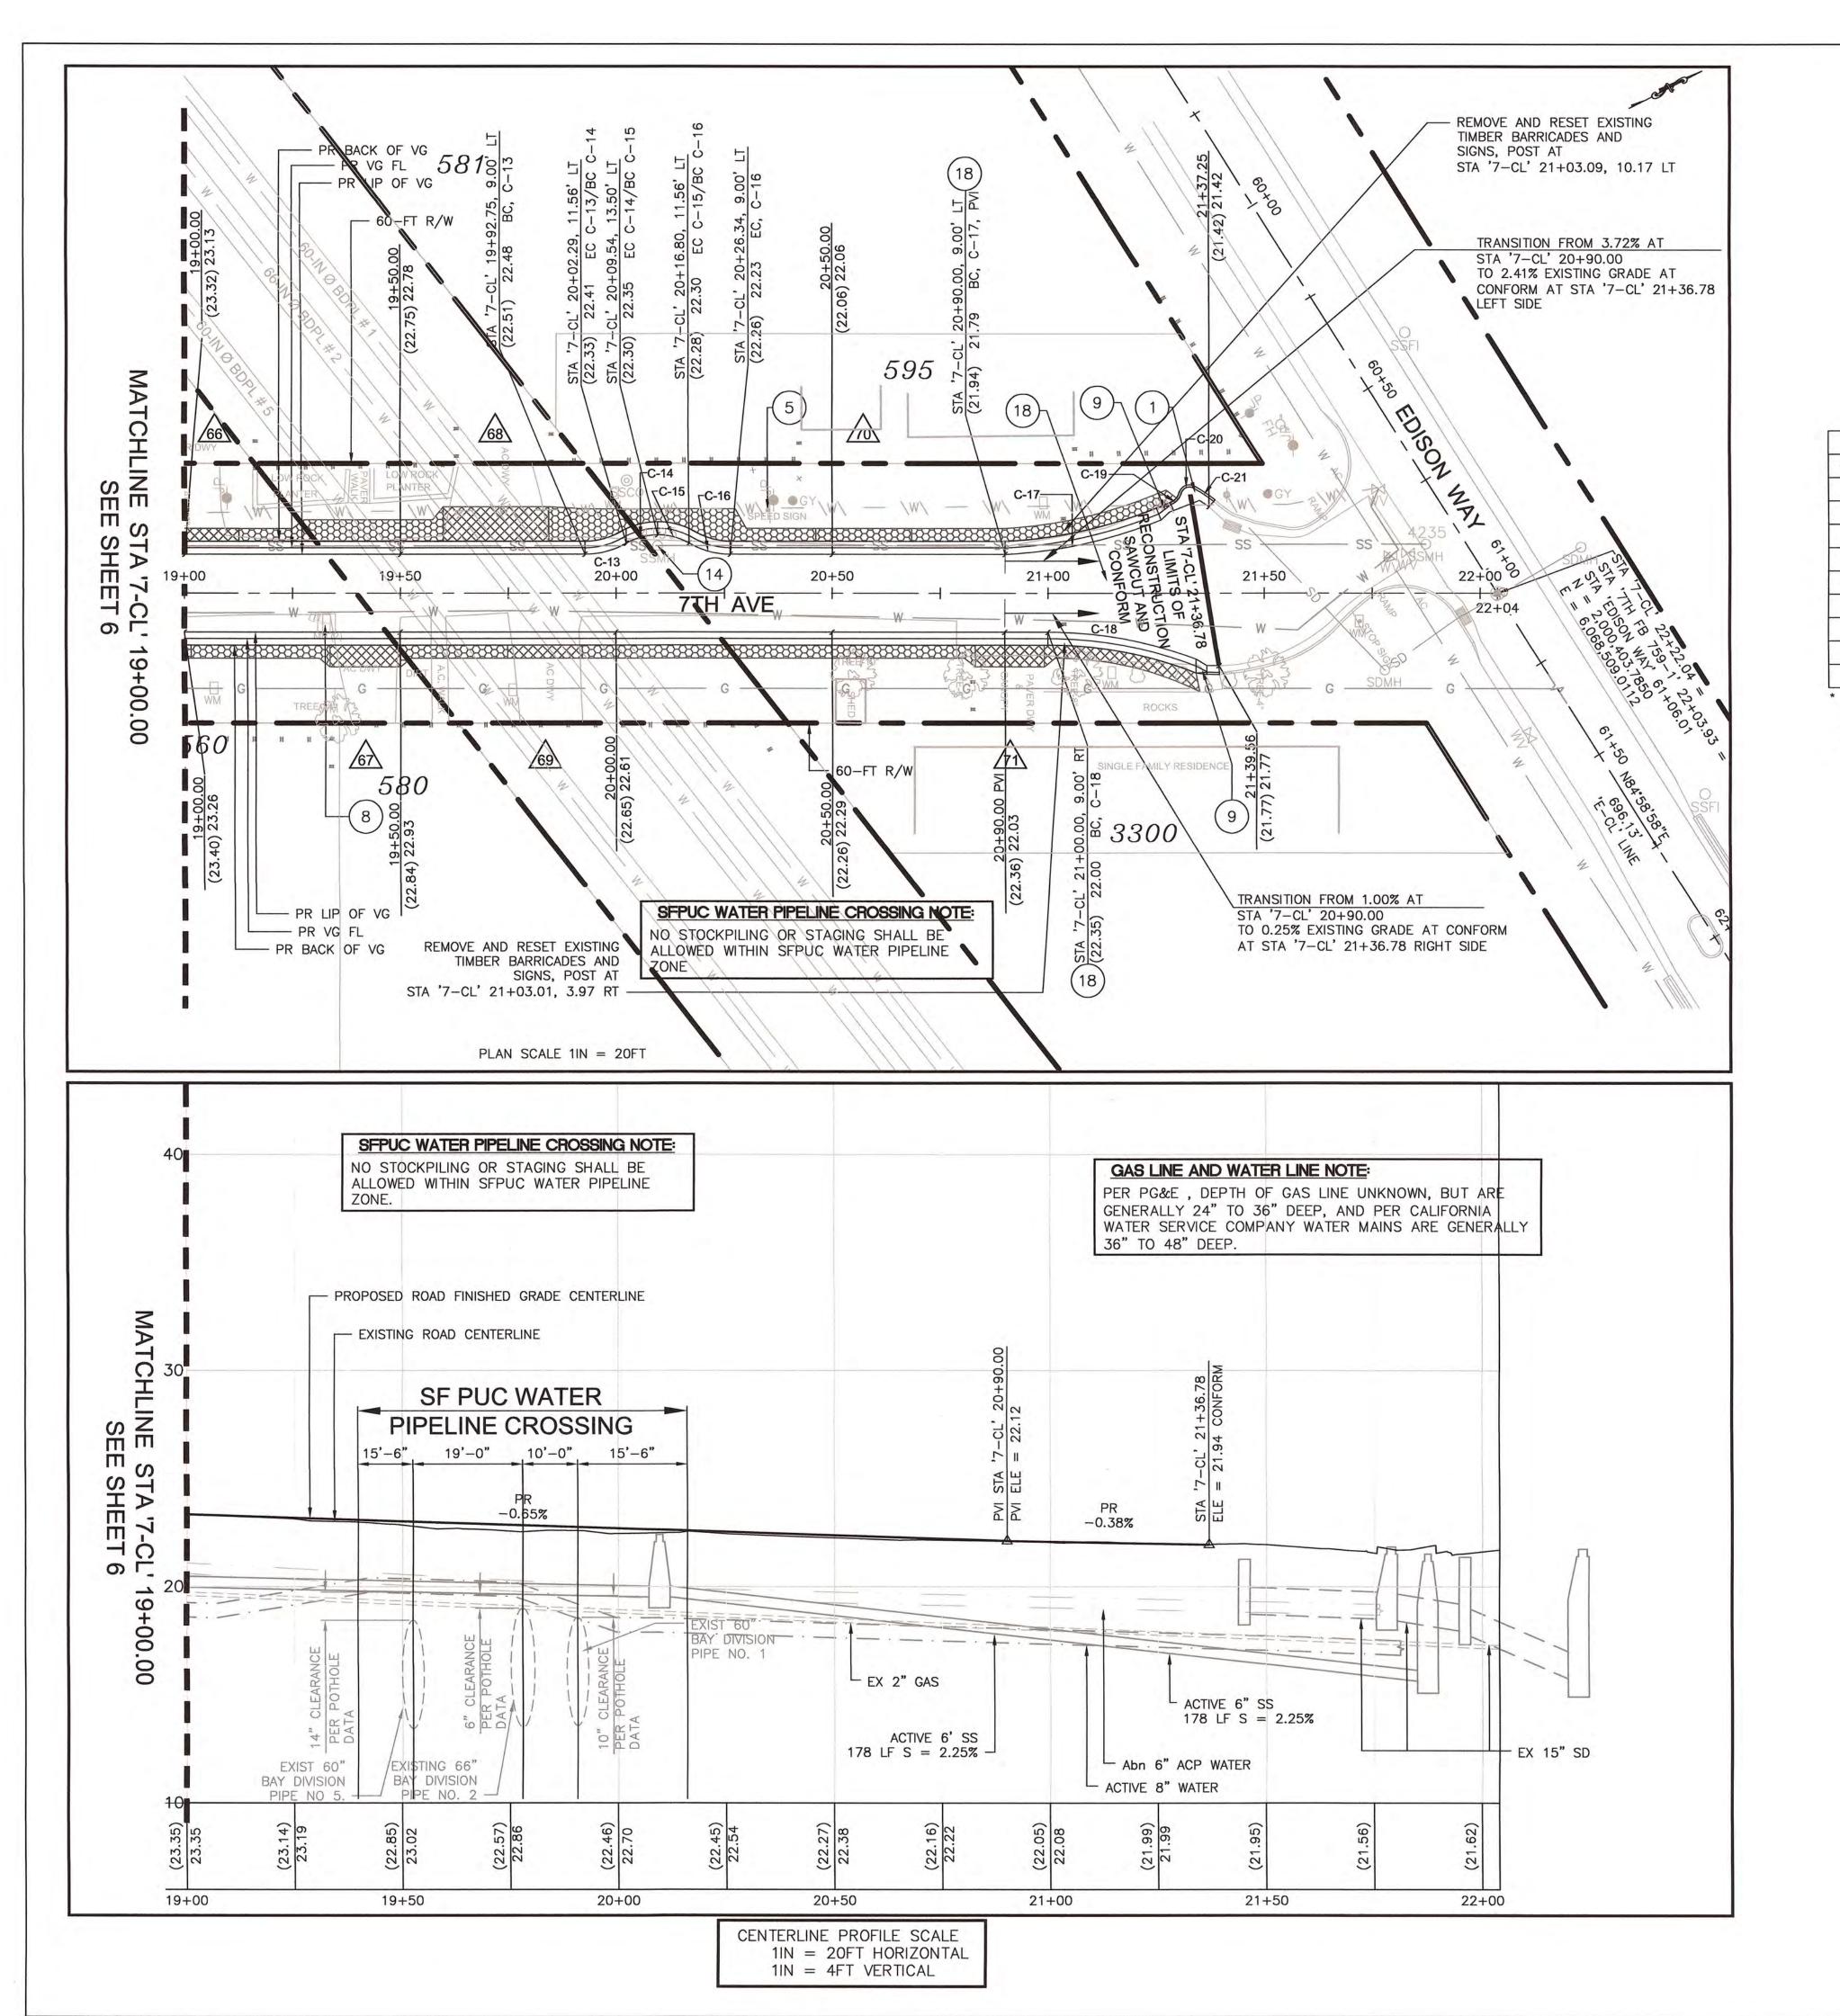



APPROVED:

DATE: FEBRUARY 9, 2018

JAMES C. PORTER, DIRECTOR OF PUBLIC WORKS R. C. E. # 48056 / EXPIRES 12-31-2019

1 ADDENDUM NO. 2

ATE: MARCH 15, 2018

JAMES C. PORTER, DIRECTOR OF PUBLIC WORKS R. C. E. # 48056 / EXPIRES 12-31-2019

CURVE TABLE*								
URVE	LENGTH	RADIUS	DELTA					
C-13	9.99'	19.07'	30° 01' 22"					
C-14	7.60'	14.51'	29° 59' 59"					
C-15	14.51'	14.51'	30° 00' 00"					
C-16	9.99'	19.08'	30° 00' 00"					
C-17	37.18'	110.45'	19° 17' 02"					
C-18	35.01	94.19'	21° 17' 49"					
C-19	3.57'	3.64'	56° 13' 50"					
C-20	3.71'	1.96'	108° 22' 47"					
C-21	5.53'	40.43'	7° 22' 47"					

CURVE TABLE DATA IS BASED ON PROPOSED LIP OF GUTTER FOR CURVES C-13 TO C-18. CURVES C-19, C-20 AND C-21 BASED ON PROPOSED TOP OF CURB.

## LEGEND:

STORM DRAIN LINE (EX)

STORM DRAIN LINE (EX) PROFILE

SS SANITARY SEWER LINE "ACTIVE"

SANITARY SEWER LINE "ACTIVE" PROFILE

WATER LINE "ACTIVE" PROFILE

WATER LINE "ACTIVE" PROFILE

ACP WATER LINE (Abn)

ACP WATER LINE (Abn) PROFILE

GAS LINE (Abn) PROFILE

JOINT COMMUNICATION LINE (EX)

GAS LINE "ACTIVE" PROFILE

JOINT COMMUNICATION LINE (EX) PROFILE

---- RIGHT OF WAY

1) POO CLASS 2 AGGREGATE BASE -

AB (CL. 2) (GRAVEL)

CLASS 3 CONCRETE

MISCELLANEOUS ASPHALT
CONCRETE
DEEP LIFT AREAS (0.50' DEEP

DEEP LIFT AREAS (0.50' DEEP ASPHALT CONCRETE)

ROCK SWALE AND FRENCH DRAIN

UPDATES:

1.) HATCH PATTERNS DARKNESS ADJUSTED TO
MATCH THE PLAN AND LEGEND

2.) "ASPHALT CONCRETE" LABEL CHANGED TO
"MISCELLANEOUS ASPHALT CONCRETE" LABEL

## LEGEND:

1 REMOVE AND CONSTRUCT CONCRETE CURB — (A)
AND GUTTER (TYP)

2 INSTALL UNDERDRAIN — (11)
3 INSTALL CLASS 1 FLEX POST OBJECT MARKER—(B)
INSTALL SIDEWALK CURB AND GUTTER—(11)
UNDERDRAIN

5 REMOVE AND RESET EXISTING ROADSIDE — (D)
SIGNS

6 CONSTRUCT AC 0.50' DEEP LIFT (TYPE "B" — (E)
3/4" MAXIMUM MEDIUM GRADING); PARK
ROAD GRID DATA, SEE SHEET 10

CONSTRUCT CONCRETE 4' WIDE VALLEY

GUTTER AT STREET INTERSECTION

INSTALL TEMPORARY MAILBOX

(G)

(1)

INSTALL TEMPORARY MAILBOX — GITTER — GI

REMOVE EX AND CONSTRUCT NEW CONCRETE (12)
CURB AND GUTTER AT EXISTING SIDEWALK

(11) REMOVE EX AND CONSTRUCT NEW CONCRETE — (12) ROUNDABOUTS

(12) REMOVE EX AND CONSTRUCT NEW CONCRETE — (E) (12) CHICANES AND CURB AND GUTTER

REMOVE EX AND CONSTRUCT NEW CONCRETE (F) (G)
CHICANES WITH ROCK SWALE AND FRENCH
DRAIN; REMOVE TREES AT CHICANES NEAR
512, 524 AND 537 7TH AVENUE

ADJUST SANITARY SEWER MANHOLE TO GRADE

TRANSITION FROM VALLEY GUTTER TO CURB  $\frac{A}{4}$  AND GUTTER

WAY PLAN AND GRID DATA; SEE SHEET 10

REMOVE AND DISPOSE EXISTING DRIVEWAY

UNDERDRAIN PIPE

20 ADJUST PACIFIC GAS AND ELECTRIC COMPANY VALVE CASING, COVER AND FRAME (AS DIRECTED BY THE ENGINEER)

EXISTING GAS LINE FROM STA '7-CL'
1+174.66 TO STA '7-CL' 12+30.11 IS
ANTICIPATED TO BE ABANDONED AND
RELOCATED AS SHOWN; CONTRACTOR TO
VERIFY

NOTE: REMOVE AND REGRADE ALL EXISTING
WALKWAY FROM TOP OF CURB TO EXISTING
FACE OF WALK OR AS DIRECTED BY THE
ENGINEER AND REPLACE IN KIND. SEE

REVISION DATE RECONSTRUCTION OF SEVENTH (7TH) AVENUE DESIGNED BY: JS SCALE: 1-IN = 20-FDATE: 02-09-2018 03-15-18, ADDENDUM 2 CHECKED BY: WN PLAN AND PROFILE FILE NO.: 1/4957 DRAWN BY: JS 555 COUNTY CENTER, 5th FLOOR JAMES C. PORTER, DIRECTOR OF PUBLIC WORKS SAN MATEO COUNTY REDWOOD CITY, CALIFORNIA 94063 7 (REV) FOR REDUCED PLANS ORIGINAL SCALE IS IN INCHES SHEET 7 OF 15



APPROVED: FEBRUARY 9, 2018

JAMES C. PORTER, DIRECTOR OF PUBLIC WORKS R. C. E. # 48056 / EXPIRES 12-31-2019

DEEP LIFT AREAS (0.50' DEEP

CLASS 2 AGGREGATE BASE -

ASPHALT CONCRETE)

AB (CL. 2) (GRAVEL)

ASPHALT CONCRETE

DRAIN

ROCK SWALE AND FRENCH

1) HATCH PATTERNS DARKNESS ADJUSTED


2) "ASPHALT CONCRETE" LABEL CHANGED TO "MISCELLANEOUS ASPHALT CONCRETE"

TO MATCH THE PLAN AND LEGEND

NATIVE BACKFILL

MARCH 15, 2018

STA 'P-CL' 17+29.61, 14.95' RT (27.82) 27.82 EP STA 'P-CL' 17+29.61, 0.00' (28.47) 28.47 CL STA 'P-CL' 17+29.61, 12.95' LT (28.02) 28.03 EP + STA+P-CL +17+29.61 STA 'P-CL' 17+43.06, 15.93' RT (27.77) 27.74 EP + LIMITS OF DEEP LIFT STA 'P-CL' 17+43.06, 0.00' (28.38) 28.22 CL SAW CUT AND CONFORM STA 'P-CL' 17+43.06, 14.08' LT (27.81) 27.85 EP 497 STA 'P-CL' 17+56.50, 16.92' RT (27.56) 27.67 EP STA 'P-CL' 17+56.50, 0.00' (28.29) 27.97 CL STA 'P-CL' 17+56.51, 15.21' LT STA 'P-CL' 17+75.44, 18.32' RT (27.67) 27.68 EP (27.58) 27.57 EP/LIP END CURB STA 'P-CL' 17+69.95, 17.91' RT AND GUTTER TAPPER (27.55) 27.60 EP STA 'P-CL' 17+69.95, 0.00' RT STA 'P-CL' 17+77.94, 18.50' RT (27.62) 27.56 LIP BEGIN CURB AND GUTTER STA 'P-CL' 17+69.95, 16.35' LT (27.76) 27.53 EP 501 STA 'P-CL' 17+83.49, 18.50 RT (27.75) 27.53 LIP STA 'P-CL' 17+77.70, 17.00' LT (27.76) 27.45 BEGIN VALLEY GUTTER STA 'P-CL' 17+83.33, 17.03 LT (27.82) 27.39 LIP STA '7-CL' 11+02.60, 18.50 LT (27.50) 25.55 LIP BEGIN TRANSITION C&G TO VG STA '7-CL' +1+47/10, 21.92 LT STA P-CL 17+83.40, 0.00 RT (28.07)+27.46+LIP + + + + STA 7-CL 11+30.08, 21.92+LT STA '7-CL' 11+11.56, 17.92 LT (27.75) 27.53 LIP TTH AVENUE 500 486

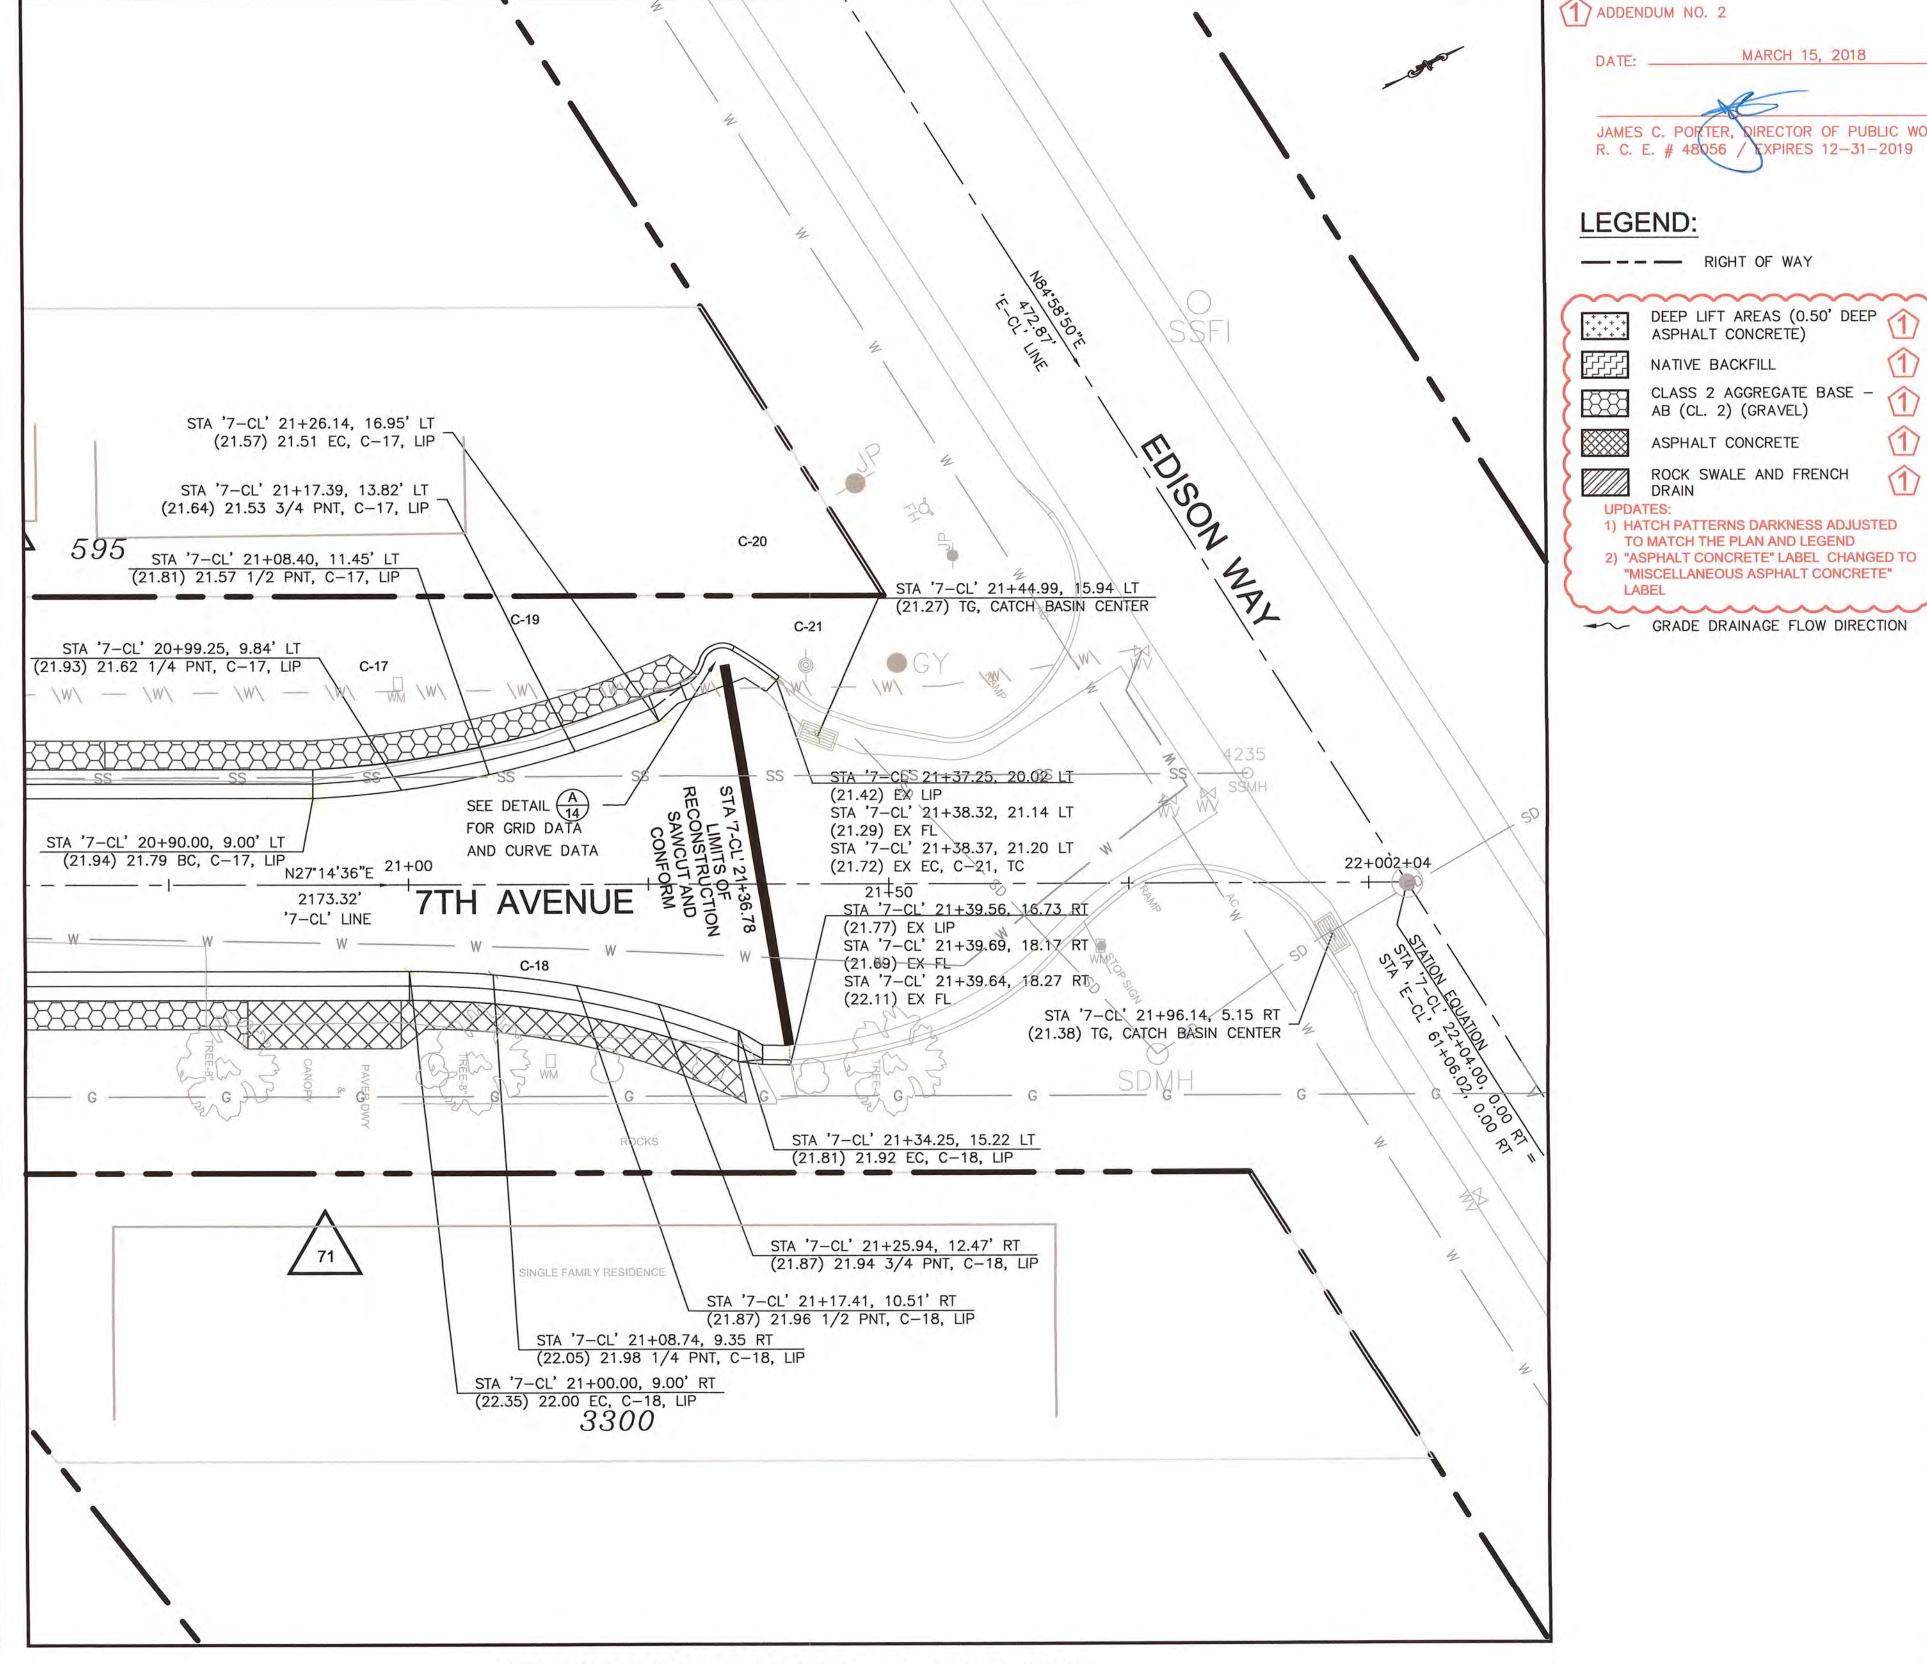

## INTERSECTION OF 7TH AVENUE AND PARK ROAD PLAN AND GRID DATA

SCALE 1" = 10FT

ROUNDABOUT (RD-1), CENTER AT STA '7-CL' 11+29.84, 4.57 LT


## ROUNDABOUT (RD-1) GRID DATA


LOCATION	LIP	OFFSET	ELE FG	ELE (EX)	тс	OFFSET	ELE FG	ELE (EX)	ВС	OFFSET	ELE FG	ELE (EX)
Α	STA '7-CL' 11+23.59	4.57 LT	27.87'	(28.28')	STA '7-CL' 11+24.59	4.57 LT	28.37'	(27.98')	STA '7-CL' 11+25.09	4.57 LT	28.37'	(28.33')
В	STA '7-CL' 11+29.84	10.82 LT	27.67'	(28.14')	STA '7CL' 11+29.84	9.82 LT	28.17'	(28.16')	STA '7-CL' 11+29.84	9.32 LT	28.17'	(28.16')
С	STA '7CL' 11+36.09	4.57 LT	27.82'	(28.28')	STA '7-CL' 11+35.09	4.57 LT	28.32'	(28.29')	STA '7-CL' 11+34.59	4.57 LT	28.32'	(28.28')
D	STA '7-CL' 11+29.84	1.68 RT	27.94'	(28.32')	STA '7-CL' 11+29.84	0.68 RT	28.44'	(28.37')	STA '7-CL' 11+29.84	0.18 RT	28.44'	(28.35')

## INTERSECTION OF 7TH AVENUE AND EDISON WAY PLAN AND GRID DATA


SCALE 1" = 10FT


OF SAA	REVISION	DATE	DESIGNED BY:	EHB/JS	RECONSTRUCTION OF SEVENTH (7TH) AVENUE		SCALE: 1IN = 10FT
	1	03-15-18, ADDENDUM 2	CHECKED BY:	WN			DATE: 02-09-2018
			DRAWN BY:	EHB/JS	PLAN AND (	GRID DATA	FILE NO.: 1/4957
6			JAMES C. F		DIRECTOR OF PUBLIC WORKS MATEO COUNTY	555 COUNTY CENTER, REDWOOD CITY, CALIFO	
I'C WORKS		FOR REDUCED P ORIGINAL SCALE		0	1 2	3 4	10 (REV) SHEET 10 OF 15

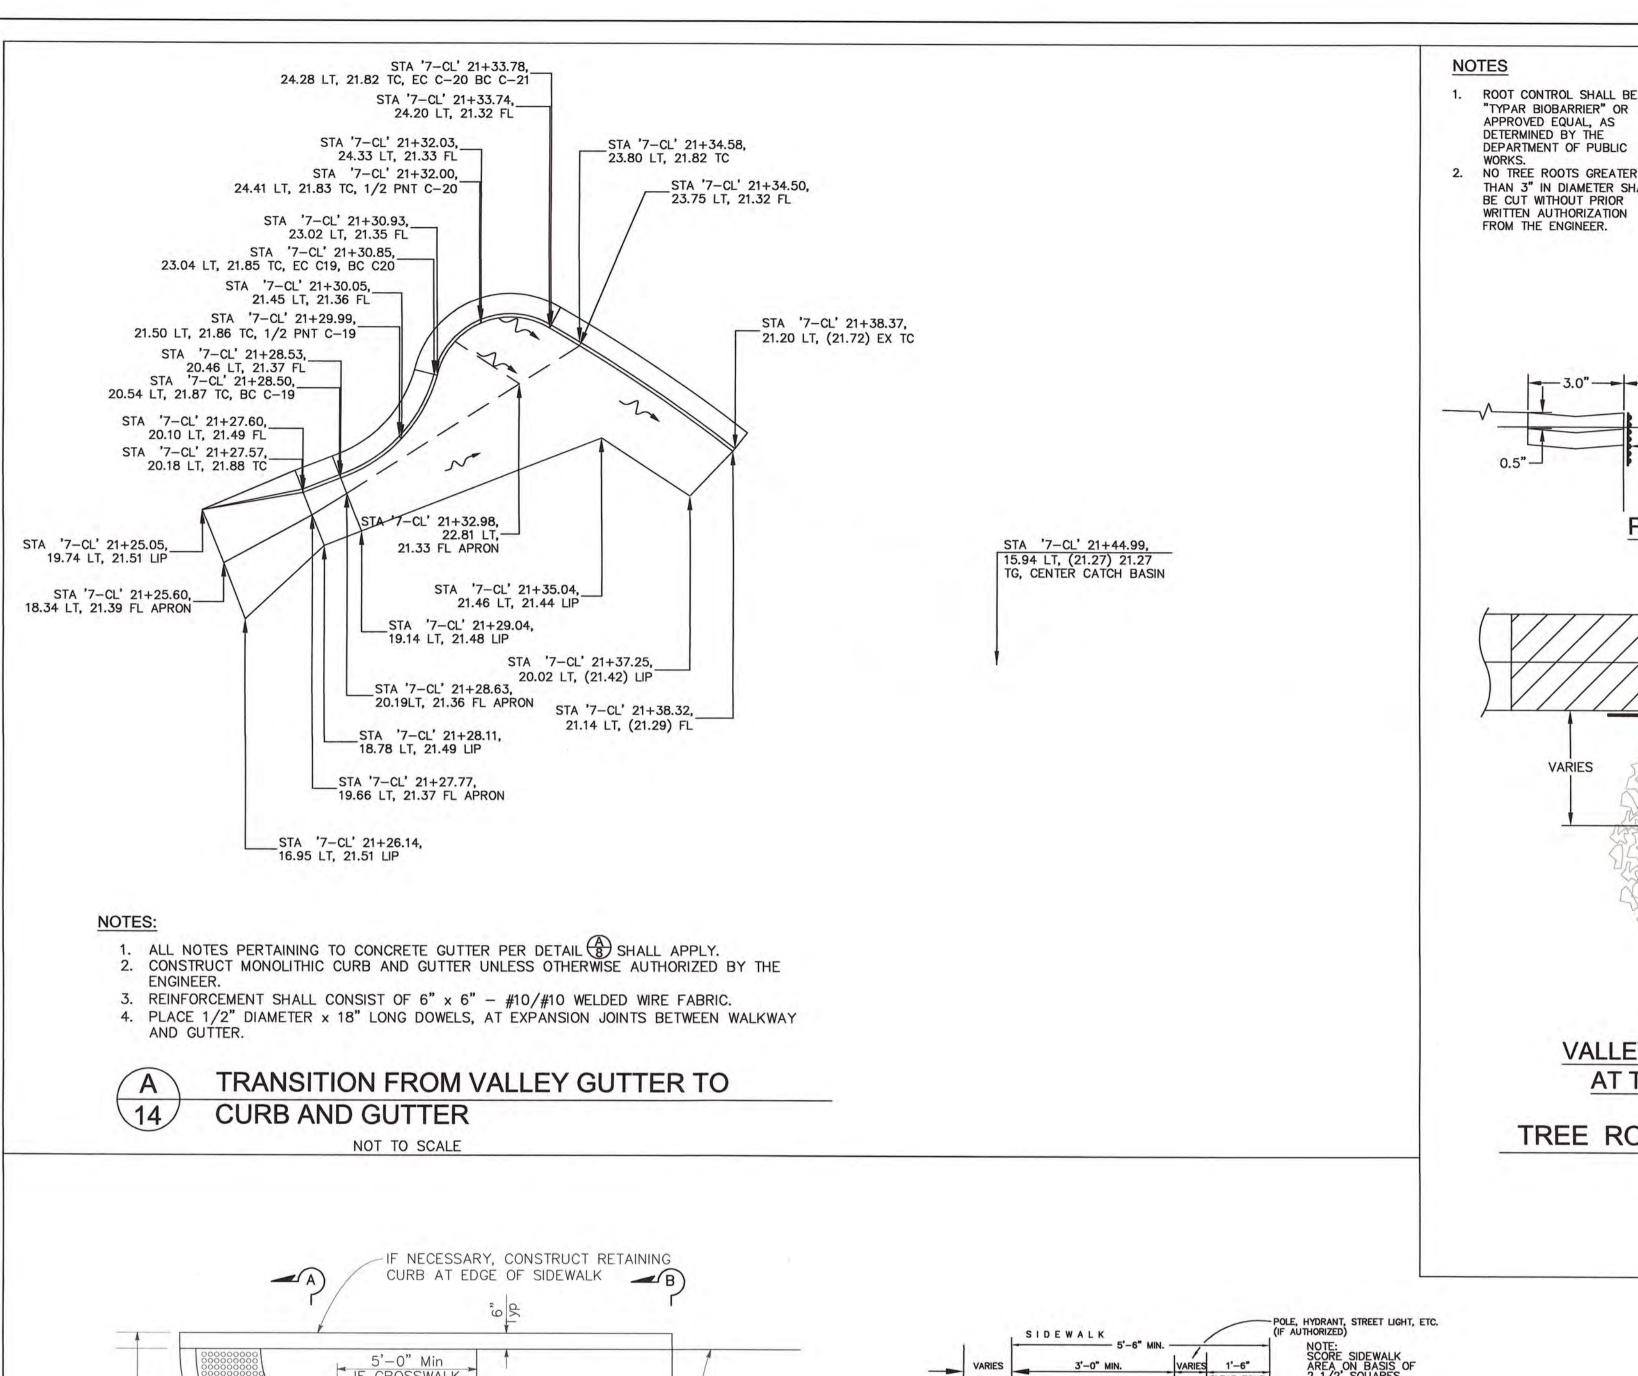


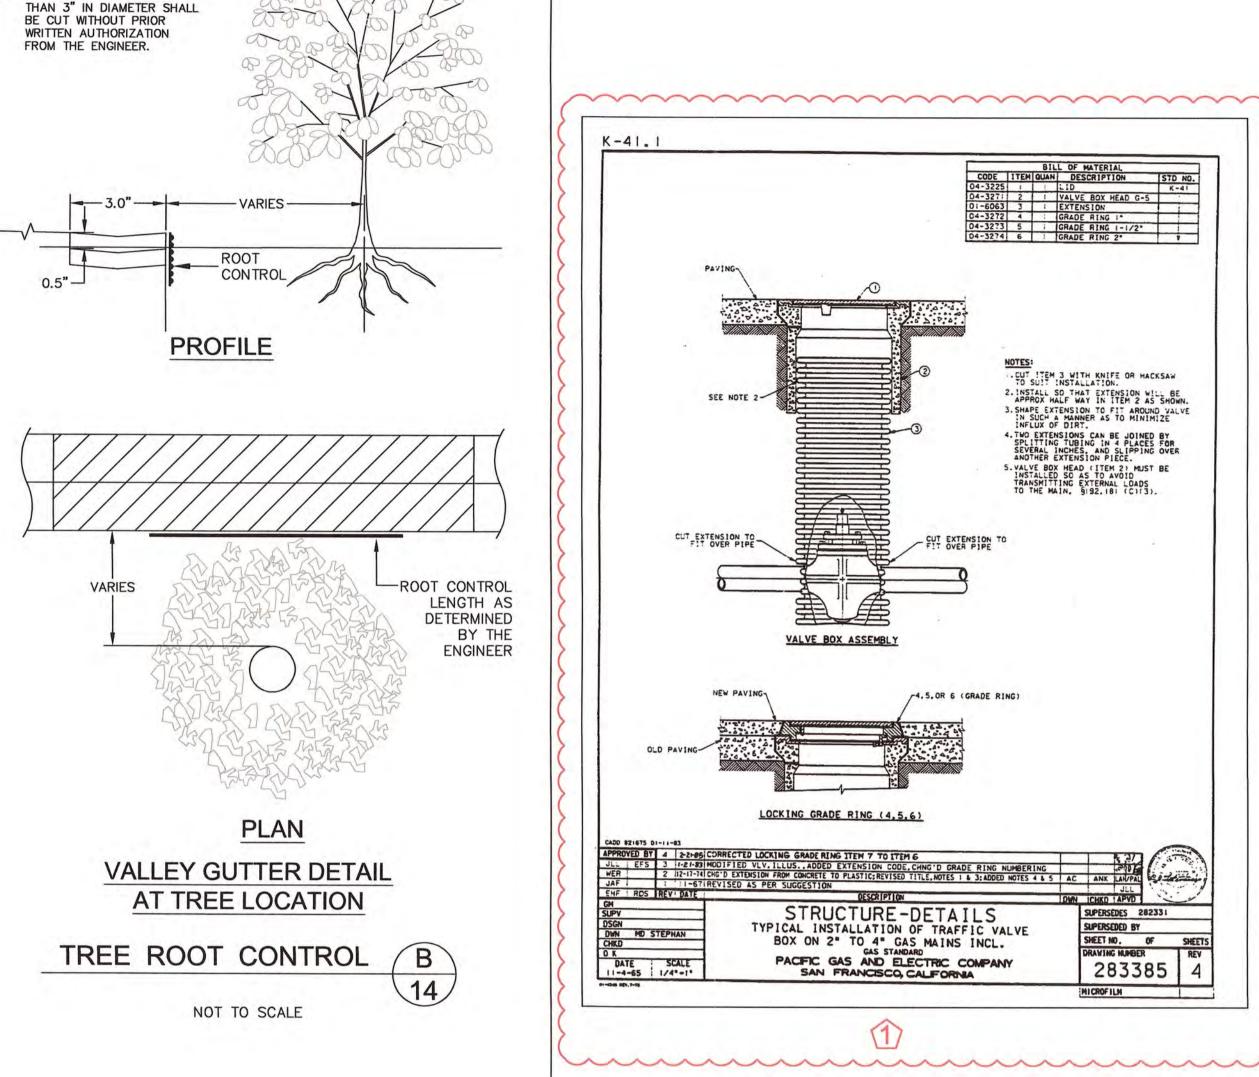

APPROVED EQUAL, AS

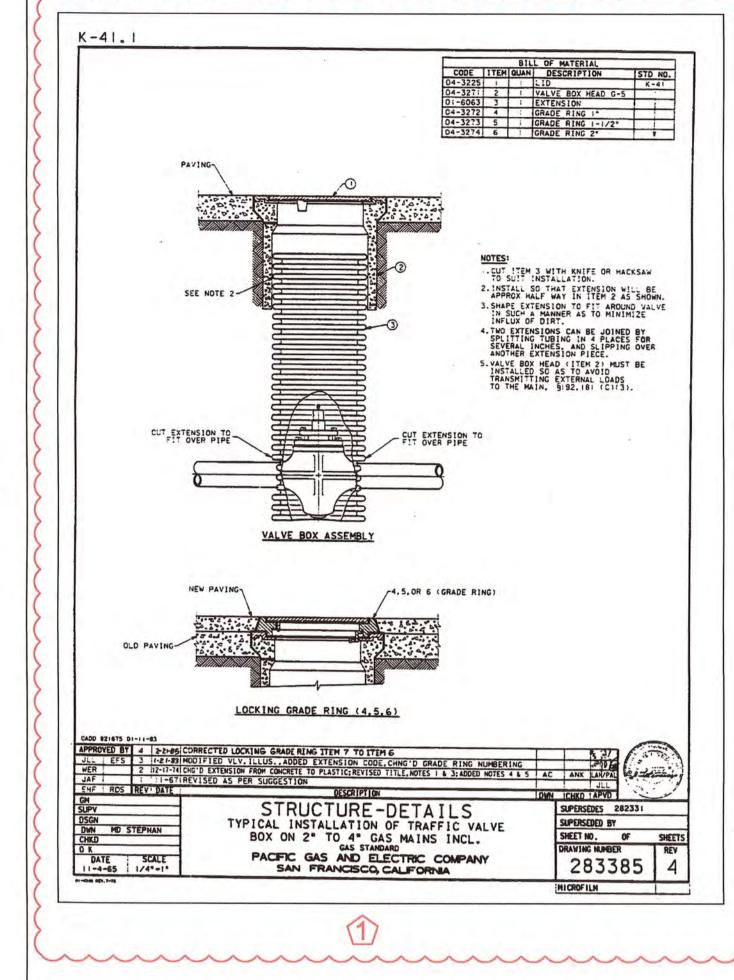


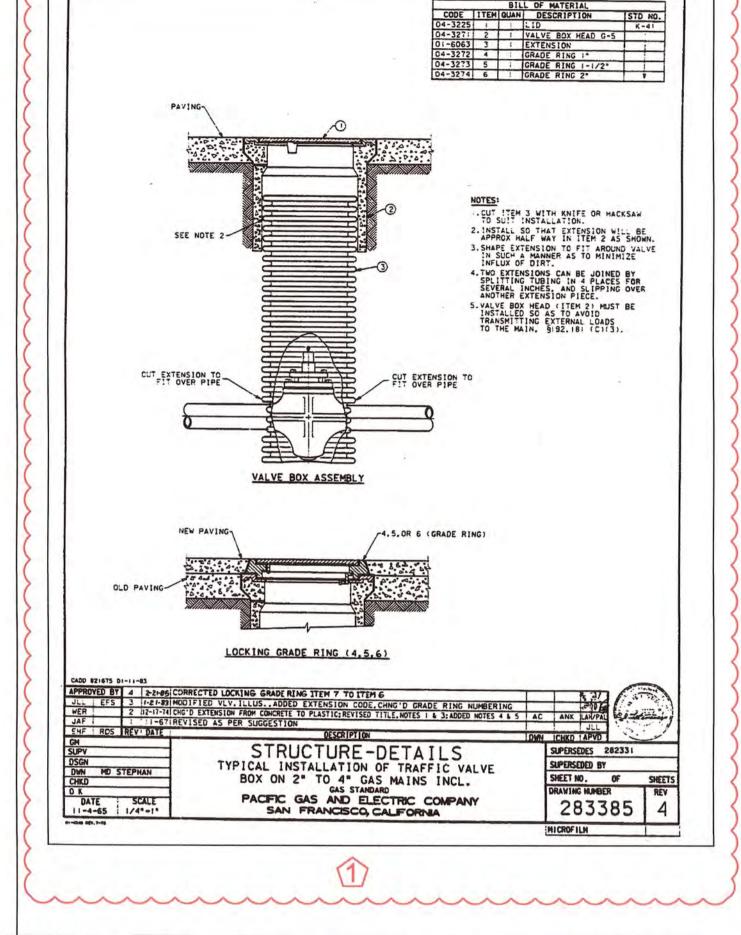

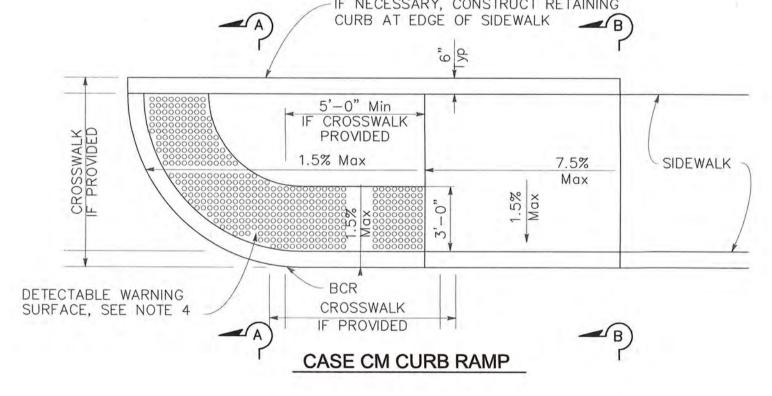


TO 0 0 2.3" Min AND 2.4" Max CENTER TO CENTER SPACING  $\bigcirc$   $\bigcirc$   $\bigcirc$ 

## RAISED TRUNCATED DOME PATTERN (IN-LINE) **DETECTABLE WARNING SURFACE**

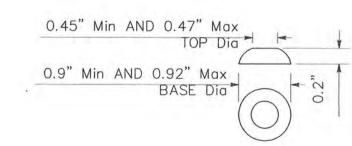

RAISED TRUNCATED DOME

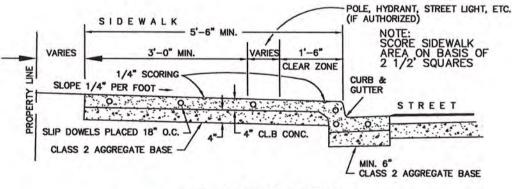

## TYPICAL SECTION URBAN CURB, GUTTER AND SIDEWALK

NOTE: OBSTRUCTIONS SUCH AS POLES, HYDRANTS, STREET SIGNS, UTILITY BOXES, STREET LIGHTS, ETC. SHALL BE LOCATED BEHIND THE SIDEWALK, UNLESS OTHERWISE SPECIFICALLY AUTHORIZED BY THE ENGINEER. A CLEAR ZONE ALONG THE CURB AND SIDEWALK 18 INCHES IN WIDTH (MEASURED FROM THE FACE OF THE CURB) SHALL BE KEPT CLEAR AND OPEN FROM ALL OBSTRUCTIONS. IN ADDITION, AN AREA 3 FEET IN WIDTH ALONG THE SIDEWALK, EXCLUSIVE OF THE CURB WIDTH, SHALL BE KEPT CLEAR AND OPEN FROM ALL OBSTRUCTIONS IN COMPLIANCE WITH THE STATE BUILDING CODE (PART 2, TITLE 24, C.A.C.).

TYPICAL SECTIONS NOTES:

1. ALL CONCRETE TO BE CLASS B CONCRETE. 2. MINIMUM SIDEWALK THICKNESS = 4 INCHES PCC. 3. PLACE 1/2" DIAMETER X 18" LONG DOWELS AT EXPANSION JOINTS AS SHOWN. 4. PLACE 1/2" THICK EXPANSION JOINTS FULL WIDTH 20' ON CENTER.

5. CONSTRUCT MONOLITHIC CURB, GUTTER AND SIDEWALK UNLESS OTHERWISE SPECIFICALLY AUTHORIZED BY THE DIRECTOR OF PUBLIC WORKS. 6. SUB-BASE MATERIALS WITHIN 30" OF SUBGRADE SHALL BE COMPACTED TO 95%.

**CURB AND GUTTER** 

\_A1-6 CURB O" LIP (IF NECCESSARY) -BACKFILL MATERIAL 4" CL.2 AB -6" CL. 2 AB-4" CL. 3 CONC -EXTEND MESH REINFORCEMENT (4" X 4", 10 GAUGE) THROUGHOUT RAMP AREA. SECTION A - A - CL. 3 CONC \_\_ A1-6 CURB CURB & GUTTER (IF NECCESSARY) -BACKFILL MATERIAL 6" CL.2 AB -4" CL. 3 CONC -- 6" CL.2 AB -SLIP DOWELS PLACED 18" O.C.

SECTION B - B

## NOTES:

- 1. AS SITE CONDITIONS DICTATE, MODIFIED CASE C CURB RAMPS MAY BE USED FOR CORNER INSTALLATIONS AND AT MID-BLOCK LOCATIONS.
- 2. IF LOCATED ON A CURVE, THE SIDES OF THE RAMP NEED NOT BE PARALLEL, BUT THE MINIMUM WIDTH OF THE RAMP SHALL BE 4'-2".
- 3. TRANSITIONS FROM RAMPS AND LANDING TO WALKS, GUTTERS OR STREETS SHALL BE FLUSH AND FREE OF ABRUPT CHANGES. THE BOTTOM OF THE RAMP SHALL HAVE NO LIP AND CONFORM TO THE GUTTER FLOWLINE.
- 4. CURB RAMPS SHALL HAVE A DETECTABLE WARNING SURFACE THAT EXTENDS THE FULL WIDTH AND 3'-0" DEPTH OF THE RAMP DETECTABLE WARNING SURFACES SHALL BE GRAY AND CONFORM TO THE DETAILS ON THIS PLAN, THE REQUIREMENTS OF THE SPECIAL PROVISIONS AND THE DIRECTIONS OF THE ENGINEER.
- 5. THE EDGE OF THE DETECTABLE WARNING SURFACE NEAREST THE STREET SHALL BE BETWEEN 6" AND 8" FROM THE GUTTER FLOWLINE.
- 6. RECONSTRUCT SIDEWALK TO NEAREST SCORE LINE AND INSTALL EXPANSION JOINT, UNLESS OTHERWISE DIRECTED BY THE ENGINEER.
- 7. UNLESS OTHERWISE SHOWN ON THE PLANS OR DIRECTED BY THE ENGINEER, IN WRITING, UTILITY PULL BOXES, MANHOLES, VALVE BOXES AND ALL OTHER FACILITIES WITHIN THE BOUNDARIES OF THE CURB RAMP SHALL BE ADJUSTED BY THE CONTRACTOR.
- 8. ADDITIONAL NOTES:
- (a) TYPICAL FIXED OBJECTS INCLUDE BUT ARE NOT LIMITED TO THE FOLLOWING:

   TRAFFIC SIGNAL POLE
- UTILITY POLE - PULL BOXES
- PHONE OR UTILITY BOXES - CATCH BASINS
- (b) RELATIVE COMPACTION OF NOT LESS THAN 95% SHALL BE OBTAINED FOR MINIMUM DEPTH OF 2.5 FEET BELOW FINISH GRADE.
- (c) A 5'-6" WIDTH FROM FACE OF CURB TO BACK OF SIDEWALK IS THE COUNTY STANDARD WIDTH FOR SIDEWALKS AND ACCESS RAMPS, WITH A PREFERRED MINIMUM CLEAR SIDEWALK WIDTH OF 48" FROM BACK OF CURB TO BACK OF SIDEWALK. IF A CLEAR SIDEWALK WIDTH OF 48" IS NOT POSSIBLE TO CONSTRUCT DUE TO NATURAL BARRIERS AND OTHER EXISTING CONDITIONS, THE CLEAR SIDEWALK WIDTH MAY BE REDUCED TO 36", AS STIPULATED BY TITLE 28 CODE OF FEDERAL REGULATIONS (CRF), PART 36: ADA (AMERICANS WITH DISABILITIES ACT) STANDARDS FOR ACCESSIBLE DESIGN.
- (d) RECONSTRUCT SIDEWALK TO NEAREST EXPANSION JOINT OR, AS APPROVED BY THE ENGINEER IN WRITING, TO THE NEAREST SCORE LINE AND INSTALL EXPANSION
- (e) INSTALL SLIP DOWELS 18" O.C. AT EXPANSION JOINTS.
- (f) CONSTRUCT MONOLITHIC CURB, GUTTER, AND SIDEWALK.
- (g) SCORE SIDEWALK AREA WITH 1/4" SCORING ON BASIS OF 2.5' SQUARES (CRACK CONTROL JOINTS), OR AS DETERMINED BY THE ENGINEER.
- (h) BACKFILL MATERIAL TO BE REPLACED IN KIND AND FLUSH WITH TOP OF CURB, OR AS DIRECTED BY THE ENGINEER.
- (i) 4' WIDTH MINIMUM CLEARANCE FOR PEDESTRIAN PATH OF TRAVEL SHALL BE MAINTAINED FROM WITHIN THE PROPOSED CROSSWALK.
- (j) AC PLUG SHALL BE 1' WIDE AND 0.5' DEEP. SUBGRADE SHALL BE COMPACTED TO 95% R.C. OR REPLACED WITH CLASS 2 AB AS NEEDED AND AS DETERMINED
- BY THE ENGINEER.

(k) AC PLUGS ARE REQUIRED FOR ALL CURB RAMPS, VALLEY GUTTERS, AND OTHER CONCRETE STRUCTURES WHICH CONFORM TO THE EXISTING ROADWAY.

ACCESS RAMP DETAILS 14

NOT TO SCALE



	REVISION	DATE	DESIGNED BY: EHB/JS
	1	03-15-18, ADDENDUM 2	CHECKED BY: WN
1			DRAWN BY: EHB/JS
			JAMES C. PORTER

RECONSTRUCTION OF SEVENTH (7TH) AVENUE

APPROVED:

1) ADDENDUM NO. 2

EXPIRES 12/31/19

FEBRUARY 9, 2018

MARCH 15, 2018

JAMES C. PORTER, DIRECTOR OF PUBLIC WORKS

JAMES C. PORTER, DIRECTOR OF PUBLIC WORK

R. C. E. # 48056 \ EXPIRES 12-31-2019

R. C. E. # 48056 / EXPIRES 12-31-2019

DATE: 02-09-2018 MISCELLANEOUS DETAILS FILE NO.: 1/4957

555 COUNTY CENTER, 5th FLOOR ER, DIRECTOR OF PUBLIC WORKS SAN MATEO COUNTY

REDWOOD CITY, CALIFORNIA 94063

FOR REDUCED PLANS ORIGINAL SCALE IS IN INCHES

14 (REV) SHEET 14 OF 15

SCALE: AS SHOWN