San Mateo County

Application for Design Review by the County Coastside Design Review Committee

Ranning and Building Departmen

County Government Center = 455 County Center = Redwood City CA 94063 Mail Drop PLN 122 = 650 • 363 • 4161 = FAX 650 • 363 • 4849

Permit	#.	PINI	
1 Cittine	π .		

Other Permit #:

PRE2020-00008

Owner (if different from Applicant):

Name: Russ Imbat & Marie Tumusok

 Address:
 5015
 Cowell
 Blvd.

 Davis
 CA
 Zip:
 95618

 Phone.W:
 6507731021
 H:

Email: russmarie2014@gmail.com

Email: edwardclovearch@gmail.com

Mill

Architect or Designer (if different from Applicant):

S+

Zip: 94638

H: 650 - 728-1723

Name:					
	Zip:				
H:	Email:				
	H:				

2. Project Site Information

Project location:		Site	Description:
APN: 047-061-06	50		Vacant Parcel
Address: 0 Carmel Ave El Gran	ada, CA		Existing Development (Please describe):
	Zip: 94019		
Zoning: R-1/S-17/DR/CD			
Parcel/lot size: 6250	sq. ft.		
St Project Descripti	on.	1. A. M. L.	
Destants		1	

Project:

Applicant:

Address: 770

Name: Edward C Love

Half Moon Bay, CA

Phone.W: 6507287615

New Single Family Residence: <u>3288</u> sq. ft
Addition to Residence: ______ sq. ft
Other: ______ sq. ft

Describe Project:

Construction of new single cmily residence with a Hachod gerage

Additional Permits Required:

- Certificate of Compliance Type A or Type B
- Coastal Development Permit
- Fence Height Exception (not permitted on coast)
- Grading Permit or Exemption
- Home Improvement Exception
- Non-Conforming Use Permit
- Off-Street Parking Exception
- Variance

4. Materials and Finish of Proposed Buildings or Structure

Fill in Blanks:	Material	Color/Finish (If different from existing, attach sample	existing
a. Exterior walls	Hardie Plank Lap Siding	Set Sail Blue	
b. Trim	Hardie Trim	Summer White	
c. Windows	Wooden Double Hung	White	
d. Doors	Craftsman Wooden Door	Summer White	
e. Roof	Asphalt Shingle	Dark Grey	
f. Chimneys	none	none	
g. Decks & railings	Trex Decking	Wood Grain	
h. Stairs	Wood	Wood Stain	
i. Retaining walls	none	none	
j. Fences	Wood	Wood	
k. Accessory buildings	None	none	
I. Garage/Carport	Aluminum	Summer White	

5. Required Findings

To approve this application, the County must determine that this project complies with all applicable regulations including the required findings that the project does conform to the standards and guidelines for design review applicable to the location of the project pursuant to Section 6565.10.

(optional) Applicant's Statement of project compliance with standards and guidelines (check if attached).

6. Signature

I hereby certify that the information stated above and on forms, plans, and other materials submitted herewith in support of the application is true and correct to the best of my knowledge. It is my responsibility to inform the County of San Mateo through my assigned project planner of any changes to information represented in these submittals.

Applicant:


8/29/2021

NG. 26, 2021 Date:

Check if

Date:



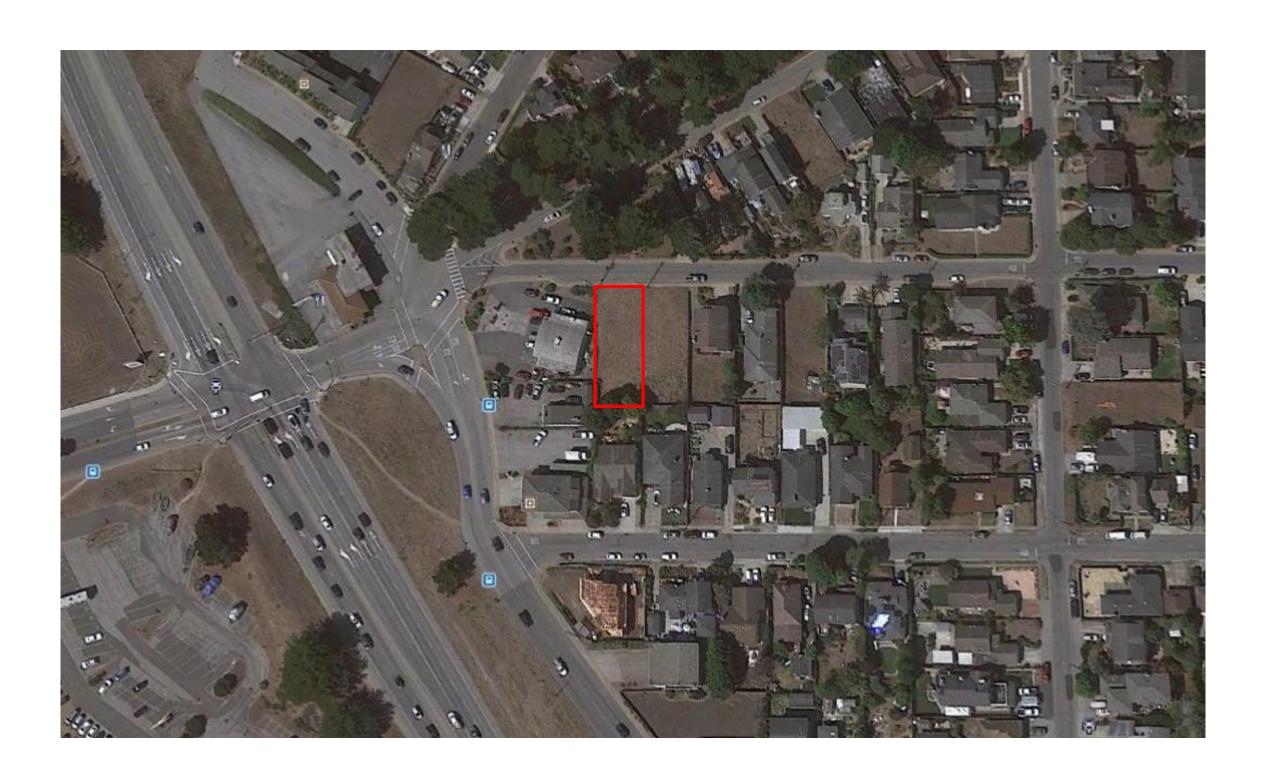

<u>SITE DATA</u>:

APN: 047-061-060 ZONING: R-1/S-17/DR/CD OCCUPANCY GROUP:R-3/U TYPE OF CONSTRUCTION: V-B

PLN: 2022-00128 BLD:

APPLICABLE CODES: SAN MATEO COUNTY

SAN MATEO COUNTY ZONING & BUILDING ORDINANCES 2022 CALIFORNIA RESIDENTIAL CODE 2022 CALIFORNIA BUILDING CODE 2022 CALIFORNIA MECHANICAL CODE 2022 CALIFORNIA PLUMBING CODE 2022 CALIFORNIA ELECTRICAL CODE 2022 CALIFORNIA ENERGY CODE 2022 CALIFORNIA FIRE CODE 2022 CALIFORNIA GREEN BUILDING STANDARDS CODE ANY APPLICABLE CITY CODES, ORDINANCES, OR AMENDMENTS TO THE CALIFORNIA BUILDING CODE

	EXISTING	ISTING PROPOSED TOTAL		PROPOSED			ALLOWED			
	AREA (SQFT)	%	AREA (SC	QFT)	%	AREA (S	QFT)	%	AREA (SQFT)	%
LOT AREA	6250									
LOT COVERAGE	0	0.0		2096	33.5		2096	33.5	2187.5	35.0
			(N) House	<u> 2861</u>		(N) House	<u>2861</u>			
FLOOR AREA			<u>Garage</u>	<u>451</u>		<u>Garage</u>	<u>451</u>			
	Total O	0.0	Total	3312	53.0	Total	3312	53.0	Total 3312.5	53.0

OWNER :	IMBAT - TUMUSOK I 22 CARMEL AVE EL GRANADA, CA 940 I 9
ARCHITECT:	EDWARD C LOVE, ARCHITECT 720 MILL ST HALF MOON BAY, CA 94019
CIVIL ≰ GEOTECH:	SIGMA PRIME GEOSCIENCES 332 PRINCETON AVE HALF MOON BAY, CA 94019 sigmaprime@gmail.com 650.728.3590
SURVEY:	BGT LAND SURVEYING 871 WOODSIDE WAY SAN MATEO, CA 94401 bgtinfo@bgtsurveying.com 650.212.1030


ALL DRAWINGS, SPECIFICATIONS, AND COPIES THEREOF, PREPARED AND/OR SUPPLIED BY THE ARCHITECT'S COMMON LAW COPYRIGHT OR OTHER RESERVED RIGHTS.

SCOPE OF WORK:

CONSTRUCTION OF NEW SINGLE FAMILY RESIDENCE WITH ATTACHED GARAGE

NOTE:

I. ALL EXTERIOR LIGHTING TO BE RECESSED

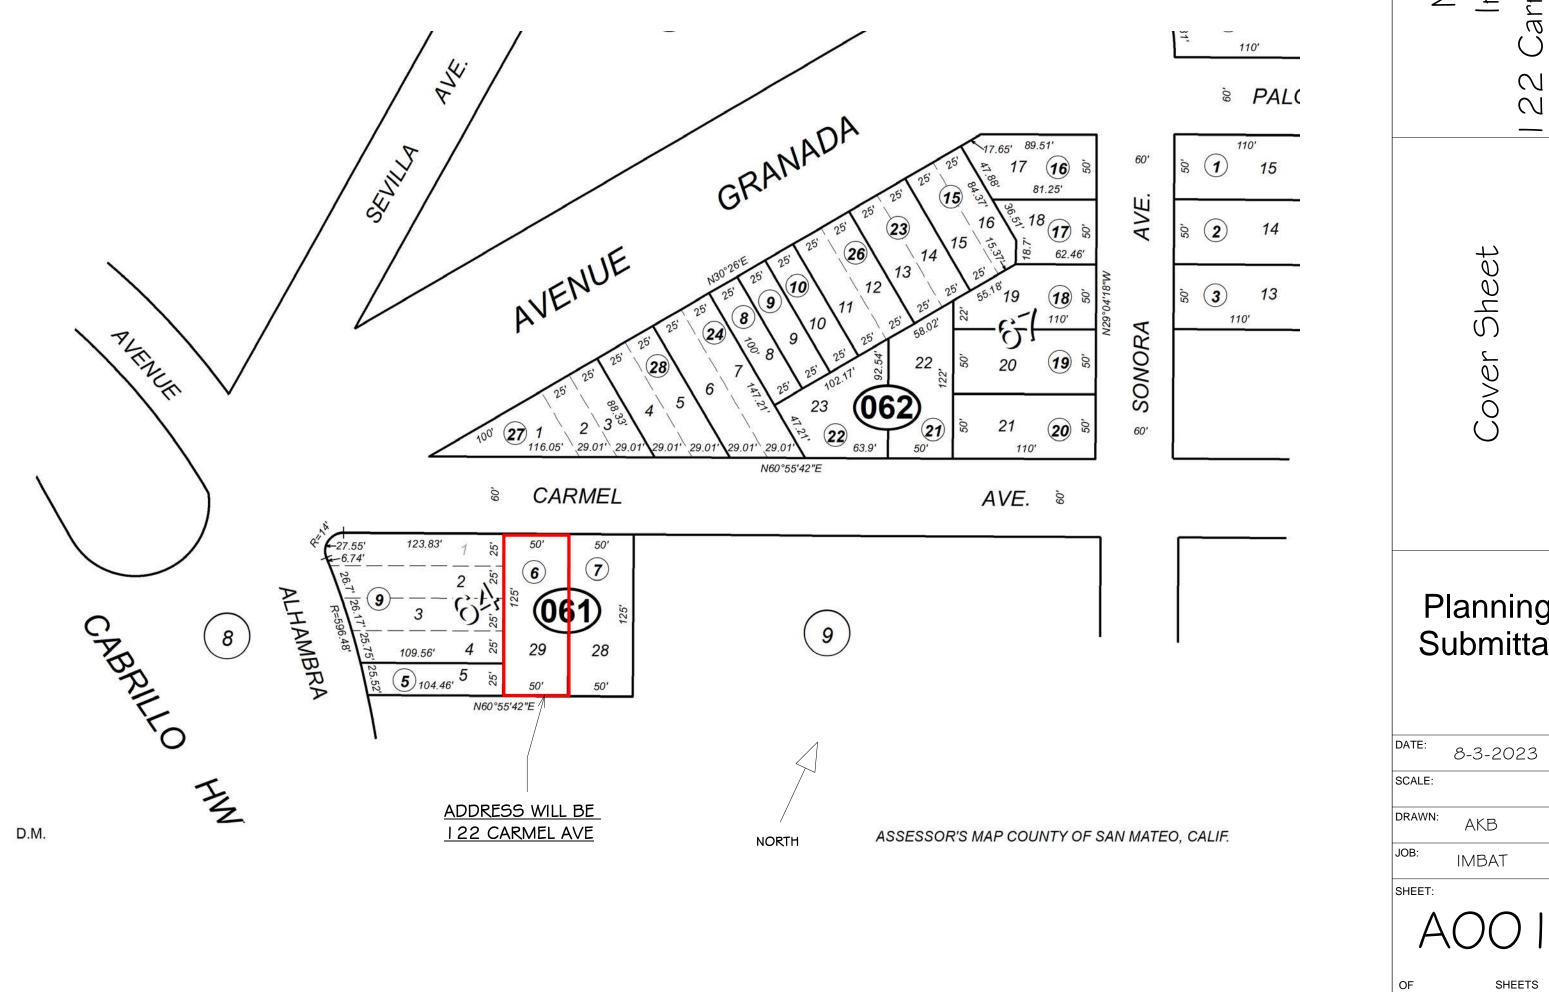

	Sheet List - CD		
<u>Sheet</u>			
<u>Number</u>	Sheet Name	Rev	
AOO I	Cover Sheet		
SU - I	Survey		
A003	Site Plan		
CI	Grading and Drainage Plan		
C2	Erosion Control		
C3 Best Managment Practices			
AIOI	First & Second Floor Plan		
A103	Loft Floor Plan ¢ Roof Plan		
A105	Floor Areas Window & Door Schedual		
AIOG	Lot Coverage		
A107	Spec Sheets		
A201	East & West Elevations		
A202	North & South Elevations		
A301	Sections		
A302	Section Loft		
A502	Material Sheet		
LPIOI	Landscape Plan		

EDWAR	RD C. LOV	
Edward C. Love	Architect	HALF MOON BAY, CA 94019 (650) 728-7615 (650) 28-7615
-	Imbat - Tumusok	I 22 Carmel Ave El Granada, CA
	Cover Sheet	
	lanr ubm	•

OF

REVISIONS

GENERAL NOTES

BEFORE SUBMITTING A PROPOSAL FOR THIS WORK, THE BIDDER SHALL VISIT THE SITE AND LEARN THE EXISTING CONDITIONS. HE SHALL EXAMINE THE PLANS AND SPECIFICATIONS AND BASE HIS BID ON THEM. DURING CONSTRUCTION, NO CHANGES FROM PLANS AND SPECIFICATIONS SHALL BE MADE WITHOUT WRITTEN CONSENT OF THE ARCHITECT AND OWNER. STRUCTURAL CHANGES MUST BE APPROVED BY THE ARCHITECT AND STRUCTURAL ENGINEER.

2. THE GENERAL CONTRACTOR (G.C.) SHALL OBTAIN AND PAY FOR ALL PERMITS (EXCEPT THOSE PAID FOR BY THE OWNER) AND LICENSES AND SHALL GIVE ALL NOTICES. THE G.C. IS REQUIRED TO COMPLY WITH ALL CURRENT CODES, ORDINANCES, & REGULATIONS RELATED TO THIS PROJECT. ANY CONFLICT BETWEEN DRAWINGS, SPECIFICATIONS AND ORDINANCES SHALL BE IMMEDIATELY REFERRED TO THE ARCHITECT IN WRITING. THE G.C. FOR THIS WORK SHALL BE CURRENTLY LICENSED BY THE STATE OF CALIFORNIA. THE EMPLOYEES AND SUBCONTRACTORS USED BY THE G.C. TO CONSTRUCT AND FINISH THE WORK SHOWN ON THE PLANS MUST ALL BE SKILLED WORKMEN UNDER THE DIRECTIONS OF A COMPETENT FOREMAN. THE G.C. SHALL CONTINUOUSLY MAINTAIN ADEQUATE PROTECTION OF ALL WORK FROM DAMAGE AND SHALL PROTECT THE OWNER'S PROPERTY AND ADJACENT PROPERTY FROM INJURY, DAMAGE, OR LOSS ARISING FROM THIS CONTRACT. SALES TAX SHALL BE PAID BY THE G.C. AND INCLUDED IN THE BID.

THE G.C. SHALL, AT ALL TIMES, KEEP THE PREMISES AND STREETS FREE OF WASTE AND RUBBISH CAUSED BY THE WORK, AND AT COMPLETION, SHALL REMOVE ALL RUBBISH, SURPLUS MATERIALS AND EQUIPMENT AND LEAVE THE WORK 'BROOM CLEAN'. THE G.C. SHALL VERIFY THE LOCATION OF ALL EXISTING UNDERGROUND UTILITIES PRIOR TO EXCAVATION AND SHALL MAINTAIN, KEEP IN SERVICE, AND PROTECT AGAINST DAMAGE, ALL EXISTING UTILITIES AND CITY SERVICES DURING CONSTRUCTION. ANY EXISTING UTILITIES TO BE ABANDONED SHALL BE PROPERLY DISCONNECTED, PLUGGED, OR CAPPED AS REQUIRED BY CODE AND/OR SOUND CONSTRUCTION PRACTICES. G.C. TO PROVIDE AN OPERATION AND MAINTENANCE MANUAL WILL BE PROVIDED TO OCCUPANT OR OWNER PER SECTION 4.410.1.

4. THE OWNER MAY ORDER EXTRA WORK OR MAKE CHANGES BY ALTERING, ADDING TO, OR DEDUCTING FROM THE WORK. THE CONTRACT SUM SHALL BE ADJUSTED ACCORDINGLY AND ADEQUATE RECORDS SHALL BE KEPT BY THE G.C. TO SUBSTANTIATE ANY ADDITIONAL CHARGES. ALL SUCH WORK SHALL BE EXECUTED UNDER THE CONDITIONS OF THE ORIGINAL CONTRACT DOCUMENTS.

THE OWNER SHALL NOT BE LIABLE OR RESPONSIBLE FOR ANY ACCIDENT, LOSS, INJURY, OR DAMAGES 5. HAPPENING OR ACCRUING DURING THE TERM OF THE PERFORMANCE OF THE WORK AND IN CONNECTION THEREWITH, TO PERSONS AND/OR PROPERTY. THE G.C. SHALL HAVE IN FULL FORCE AND EFFECT DURING THE LIFE OF THIS CONTRACT, FULL COVERAGE LIABILITY AND WORKMEN'S COMPENSATION INSURANCE, WHICH SHALL COMPLY WITH CALIFORNIA LAWS AND WILL NOT BE CANCELED OR CHANGED DURING THE TERM OF THIS CONTRACT WITHOUT NOTICE BEING GIVEN TO THE OWNER, AND SHALL REQUIRE ALL INTERMEDIATE AND SUBCONTRACTORS TO TAKE OUT AND MAINTAIN SIMILAR POLICIES OF INSURANCE. ALL SUCH POLICIES SHALL BE WITH INSURANCE COMPANIES ACCEPTABLE TO THE OWNER. UNLESS EXPRESSLY STATED OTHERWISE, THE OWNER WILL TAKE OUT AND CARRY A COMPREHENSIVE INSURANCE POLICY INCLUDING FIRE, EXTENDED COVERAGE, VANDALISM AND MALICIOUS MISCHIEF PROTECTING BOTH HIS INTEREST AND THAT OF THE G.C.

6. IN ADDITION TO GUARANTEES CALLED FOR ELSEWHERE IN THESE SPECIFICATIONS, THE G.C. SHALL GUARANTEE ALL WORK FOR A PERIOD OF ONE (1) YEAR AFTER NOTICE OF COMPLETION IS FILED, AGAINST DEFECTIVE MATERIALS OR FAULTY WORKMANSHIP, THAT IS DISCOVERED AND REPORTED WITHIN THAT PERIOD.

IN GENERAL THE DRAWINGS WILL INDICATE DIMENSIONS, POSITION, TYPE OF CONSTRUCTION SPECIFICATIONS, QUALITIES AND METHODS. ANY WORK INDICATED ON THE DRAWINGS, AND NOT MENTIONED IN THE SPECIFICATIONS, OR VICE VERSA, SHALL BE FURNISHED AS THOUGH FULLY SET FORTH IN BOTH. WORK NOT PARTICULARLY DETAILED, MARKED, OR SPECIFIED SHALL BE THE SAME AS SIMILAR PARTS THAT ARE DETAILED, MARKED OR SPECIFIED. THE LARGER THE SCALE OF THE DRAWING, THE MORE PRECEDENT, I.E.: 3 INCHES PER FOOT SCALE GOVERNS 1/4 INCH PER FOOT SCALE. WRITTEN DIMENSIONS ON THESE DRAWINGS SHALL HAVE PRECEDENCE OVER SCALED DIMENSIONS. WRITTEN DIMENSIONS ARE APPROXIMATE AND MUST BE VERIFIED BY G.C. THE G.C. SHALL VERIFY, AND BE RESPONSIBLE FOR ALL EXISTING CONDITIONS AND DIMENSIONS PRIOR TO, AND DURING, ALL PHASES OF WORK.

8. IF ANY SUBCONTRACTOR FINDS ANY LACK OF INFORMATION, DISCREPANCY, AND/OR OMISSIONS IN THESE DRAWINGS, OR IF THE SUBCONTRACTOR IS UNCLEAR AS TO THE DRAWINGS' MEANING AND/OR INTENT, THE SUBCONTRACTOR SHALL CONTACT THE G.C., WHO SHALL THEN CONTACT THE ARCHITECT AT ONCE FOR INTERPRETATION AND/OR CLARIFICATION BEFORE PROCEEDING WITH THAT PORTION OF THE WORK.

9. THE G.C. SHALL PROVIDE ADEQUATE CONCEALED BLOCKING AND ANCHORING FOR ALL CEILING- AND WALL-MOUNTED EQUIPMENT, HARDWARE, FIXTURES, AND ACCESSORIES.

10. ALL PRODUCTS LISTED IN THESE DRAWINGS BY NER NUMBER SHALL BE INSTALLED PER THE REPORT AND MANUFACTURER'S WRITTEN INSTRUCTIONS. PRODUCT SUBSTITUTION FOR PRODUCTS LISTED SHALL ALSO HAVE AN NER-APPROVED WRITTEN EVALUATION REPORT AND BE APPROVED AND LISTED BY OTHER NATIONALLY-RECOGNIZED TESTING AGENCIES.

11. EXTERIOR OPENABLE WINDOWS AND DOORS SHALL BE WEATHERSTRIPPED. ALL OPEN JOINTS, PENETRATIONS, AND OTHER OPENINGS IN THE BUILDING ENVELOPE SHALL BE SEALED, CAULKED, GASKETED, AND/OR WEATHERSTRIPPED TO LIMIT, OR ELIMINATE, AIR LEAKAGE.

12. SEE STRUCTURAL SHEETS FOR STRUCTURAL MATERIALS. DIMENSIONS AND DETAILS.

13. SEE ATTACHED TITLE 24 FORMS AND/OR CALCULATION FOR PROJECT ENERGY EFFICIENCY REQUIREMENTS.

14. A CAPILLARY BREAK SHALL BE INSTALLED IF A SLAB ON GRADE FOUNDATION SYSTEM IS USED. THE USE OF A 4" THICK BAS OF 1/2" OR LARGER CLEAN AGGREGATE UNDER A 6 MIL VAPOR RETARDER WITH JOINT LAPPED NOT LESS THAN 6" WILL BE PROVIDED PER SECTION 4.505.2 AND R506.2.3.

15. UPON REQUEST, VERIFICATION OF COMPLIANCE WITH THE RELEVANT CODES MAY INCLUDE CONSTRUCTION DOCUMENTS, PLANS, SPECIFICATIONS, BUILDER OR INSTALLER CERTIFICATION, INSPECTION REPORTS, OR OTHER METHODS ACCEPTABLE TO THE BUILDING OFFICIAL WHICH SHOW SUBSTANTIAL CONFORMANCE.

 CONSTRUCTION WASTE MANAGEMENT PLAN SHALL BE SUBMITTED PER CALGREEN 4.408.2 (OR IN ACCORDANCE WITH LOCAL ORDINANCE). MINIMUM OF 65% OF CONSTRUCTION WASTE SHALL BE **DIVERTED FOR RECYCLING OR SALVAGE PER CALGREEN 4.408.1**

17. OPERATIONS & MAINTENANCE MANUALS SHALL BE PROVIDED TO BUILDING OWNER ADDRESSING ITEMS 1 - 10 IN CALGREEN 4.410.1

18. DUCT SYSTEMS SHALL BE SIZED, DESIGNED, AND EQUIPED PER CALGREEN 4.507.2. HVAC SYSYTEM INSTALLERS MUST BE TRAINED AND CERTIFIED AND SPECIAL INSPECTORS EMPLOYED BY THE ENFORCING AGENCY MUST BE QUALIFIED.

19. BATHROOM EXHAUST FANS SHALL COMPLY WITH CALGREEN 4.506.1. EACH BATHROOM SHALL BE MECHANICALLY VENTILATED WITH AN ENERGY STAR EXHAUST FAN AND MUST BE CONTROLLED BY A HUMIDITY SENSOR.

20. PROTECT ANNULAR SPACES AROUND PIPES, ELECTRICAL CABLES, CONDUITS OR OTHER OPENINGS AT EXTERIOR WALLS AGAINST THE PASSAGE OF RODENTS (CALGREEN 4.406.1)

21. COVER DUCT OPENINGS AND OTHER RELATED AIR DISTRIBUTION COMPONENT OPENINGS DURING CONSTRUCTION (CALGREEN 4.504.1)

22. ADHESIVES, SEALANTS, AND CAULKS SHALL BE COMPLIANT WITH VOC AND OTHER TOXIC COMPOUND LIMITS (CALGREEN 4.504.2.1)

23. PAINTS, STAINS, AND OTHER COATINGS SHALL BE COMPLIANT WITH VOC LIMITS (CALGREEN 4.504.2.2)

24. AEROSOL PAINTS AND COATINGS SHALL BE COMPLIANT WITH PRODUCT WEIGHTED MIR LIMITS FOR ROC AND TOXIC COMPOUNDS (CALGREEN 4.504.2.3). VERIFICATION OF COMPLIANCE SHALL BE PROVIDED.

25. CARPET AND CARPET SYSTEMS SHALL BE COMPLIANT WITH VOC LIMITS (CALGREEN 4.504.3)

26. MINIMUM OF 80" FLOOR AREA RECEIVING RESILIENT FLOORING SHALL COMPLY WITH **CALGREEN 4.504.4**

27. PARTICLEBOARD, MEDIUM DENSITY FIBERBOARD (MDF), AND HARDWOOD PLYWOOD USED IN INTERIOR FINISH SYSTEMS SHALL COMPLY WITH LOW FORMALDEHYDE EMISSION STANDARDS (CALGREEN 4.504.5)

28. INSTALL CAPILLARY BREAK AND VAPOR RETARDER AT SLAB ON GRADE FOUNDATIONS (CALLGREEN 4.505.2)

29. CHECK MOISTURE CONTENT OF BUILDING MATERIALS USED IN WALL AND FLOOR FRAMING BEFORE ENCLOSURE (CALGREEN 4.505.3)

HERS INSPECTION ITEMS

The following is a summary of the features that must be field-verified by a certified HERS Rater as a condition for meeting the modeled energy performance for this computer analysis. Additional detail is provided in the building components tables below.

LL DRAWINGS, SPECIFICATIONS, AND COPIES THEREOF, PREPARED AND/OR SUPPLIED BY THE ARCHITECT, SHALL REMAIN HIS PROJECT AT THE COMPLETION OF THE ARCHITECT, SHALL REMAIN HIS PROJECT AT THE COMPLETION OF THE ARCHITECT, SHALL REMAIN HIS PROJECT AT THE COMPLETION OF THE ARCHITECT AT THE CONTRACT, SUCH DOCUMENTS ARE TO BE USED ON ANY OTHER PROJECT AT THE COMPLETION OF THE ARCHITECT AT THE COMPLETION OF THE ARCHITECT SCOMMON LAW COPYRIGHT OR OTHER RESERVED RIGHTS.

Building-level Verifications: • High quality insulation installation (QII) IAQ mechanical ventilation

Cooling System Verifications: • -- None --

HVAC Distribution System Verifications: Duct Sealing

Domestic Hot Water System Verifications: • -- None --

Smoke Detectors

As per the California Building Code, State Fire Marshal regulations, and Coastside Fire District Ordinance 2019-03, the applicant is required to install State Fire Marshal approved and listed smoke detectors which are hard wired, interconnected, and have battery backup. These detectors are required to be placed in each new and reconditioned sleeping room and at a point centrally located in the corridor or area giving access to each separate sleeping area. In existing sleeping rooms, areas may have battery powered smoke alarms. A minimum of one detector shall be placed on each floor. Smoke detectors shall be tested and approved prior to the building final. Date of installation must be added to exterior of the smoke alarm and will be checked at final.

Smoke alarm/detector are to be hard wired, interconnected, or with battery back up. Smoke alarms to be installed per manufacturers instruction and NFPA 72.

<u>Windows</u>

Escape or rescue windows shall have a minimum net clear openable area of 5.7 square ft (sqft), 5.0 sqft allowed at grade. The minimum net clear openable height dimension shall be 24 inches. The net clear openable width dimension shall be 20 inches. Finished sill height shall not be more than 44 inches above the finished floor (CFC) 1030).

Address Markers

New residential buildings shall have internally illuminated address numbers contrasting with the background so as to be seen from the public way fronting the building. The letters/numerals for permanent address signs shall be 6 inches in height with a minimum of 1/2 inch stroke. Residential address numbers shall be at least six feet above the finished surface of the driveway. Where buildings are located remotely to the public roadway, an additional signage at the driveway/roadway entrance leading to the building and/or on each individual building shall be required by the Coastside Fire District. This remote signage shall consist of a 6 inch by 18 inch green reflective metal sign with 3 inch reflective numbers/letters similar to Hy-Ko 911 or equivalent. (TEMPORARY ADDRESS NUMBERS SHALL BE POSTED PRIOR TO COMBUSTIBLES BEING PLACED ON SITE).

<u>Roofing</u>

As per Coastside Fire District Ordinance 2019-03, the roof covering of every new building or structure, and materials applied as part of a roof covering assembly, shall have a minimum fire rating of Class "B" or higher as defined in the current addition of the California Building Code.

Vegetation Management (LRA)

The Coastside Fire District Ordinance 2019-03, the 2019 California Fire Code 304.1.2:

A fuel break of defensible space shall is required around the perimeter of all structures to a distance of not less than 30 feet and may be required to a distance of 100 feet or to the property line. this is neither a requirement nor an authorization for the removal of living trees.

Trees located within the defensible space shall be pruned to remove dead and dying portions, and limbed up 6 feet above the ground. New trees planted in the defensible space shall be located no closer than 10 feet to adjacent trees when fully grown or at maturity.

Remove that portion of any existing trees, which extends within 10 feet of the outlet of a chimney or stovepipe or is within 5 feet of any structure. Maintain any tree adjacent to or overhanging a building free of dead or dying wood.

Fire Access Roads

The applicant must have a maintained asphalt surface road for ingress and egress of fire apparatus. The city of Half Moon Bay Department of Public Works, San Mateo County Department of Public Works, the Coastside Fire District Ordinance 2019-03, and the California Fire Code shall set road standards. As per the 2019 CFC, Deadend roads exceeding 150 feet shall be provided with a turnaround in accordance with Coastside Fire District specifications. As per the 2019 CFC, Section Appendix D, road width shall not be less than 20 feet. Fire access roads shall be installed and made serviceable prior to combustibles being placed of the project site and maintained during construction. Approved signs and painted curbs or lines shall be provided and maintained to identify fire access roads and state the prohibition of their obstruction. If the road width does not allow parking on the street (20 foot road) and on-street parking is desired, an additional improved area shall be developed for that

Fire Hydrant

As per 2019 CFC, Appendix B and C, a fire district approved fire hydrant (Clow 960) must be located within 500 feet of the proposed single-family dwelling unit measured by way of drivable access. As per 2019 CFC, Appendix B the hydrant must produce a minimum fire flow of 500 gallons per minute at 20 pounds per square inch residual pressure for 2 hours. Contact the local water purveyor for water flow details.

Automatic Fire Sprinkler System (Fire Sprinkler plans will require a separate permit)

As per San Mateo County Building Standards and Coastside Fire District Ordinance 2019-03, the applicant is required to install an automatic fire sprinkler system throughout the proposed or improved dwelling and garage. All attic access locations will be provided with a pilot head on metal upright. Sprinkler coverage shall be provided throughout the residence to include all bathrooms, garages, and any area used for storage. The only exception is small linen closets less than 24 square feet with full depth shelving. The plans for this system must be submitted to the San Mateo County Planning and Building Division or the City of HMB. A building permit will not be issued until plans are received, reviewed, and approved. Upon submission of plans, the County or City will forward a complete set to the Coastside Fire District for review.


Installation of underground sprinkler pipe shall be flushed and visually inspected by Fire District prior to hook-up to riser. Any soldered fittings must be pressure tested with trench open. Please call Coastside Fire District to schedule an inspection. Fees shall be paid prior to plan review.


An exterior bell and interior horn/strobe are required to be wired into the required flow switch on your fire sprinkler system. The bell, horn/strobe, and flow switch, along with the garage door opener, are to be wired into a separate circuit breaker at the main electrical panel and labeled.


Solar Photovoltaic Systems

These systems shall meet the requirements of the 2019 CFC Section 605.11.

F	REVIS	101	١S	
EDWAR		WE	E	
Edward C. Love	Architect			
			D Change Ave Fl Granada CA	
		UCHERAL NOLES		
R DATE: SCALE:	FC EV ON	′IE I∟	EV Y	
DRAWN: JOB: SHEET:				

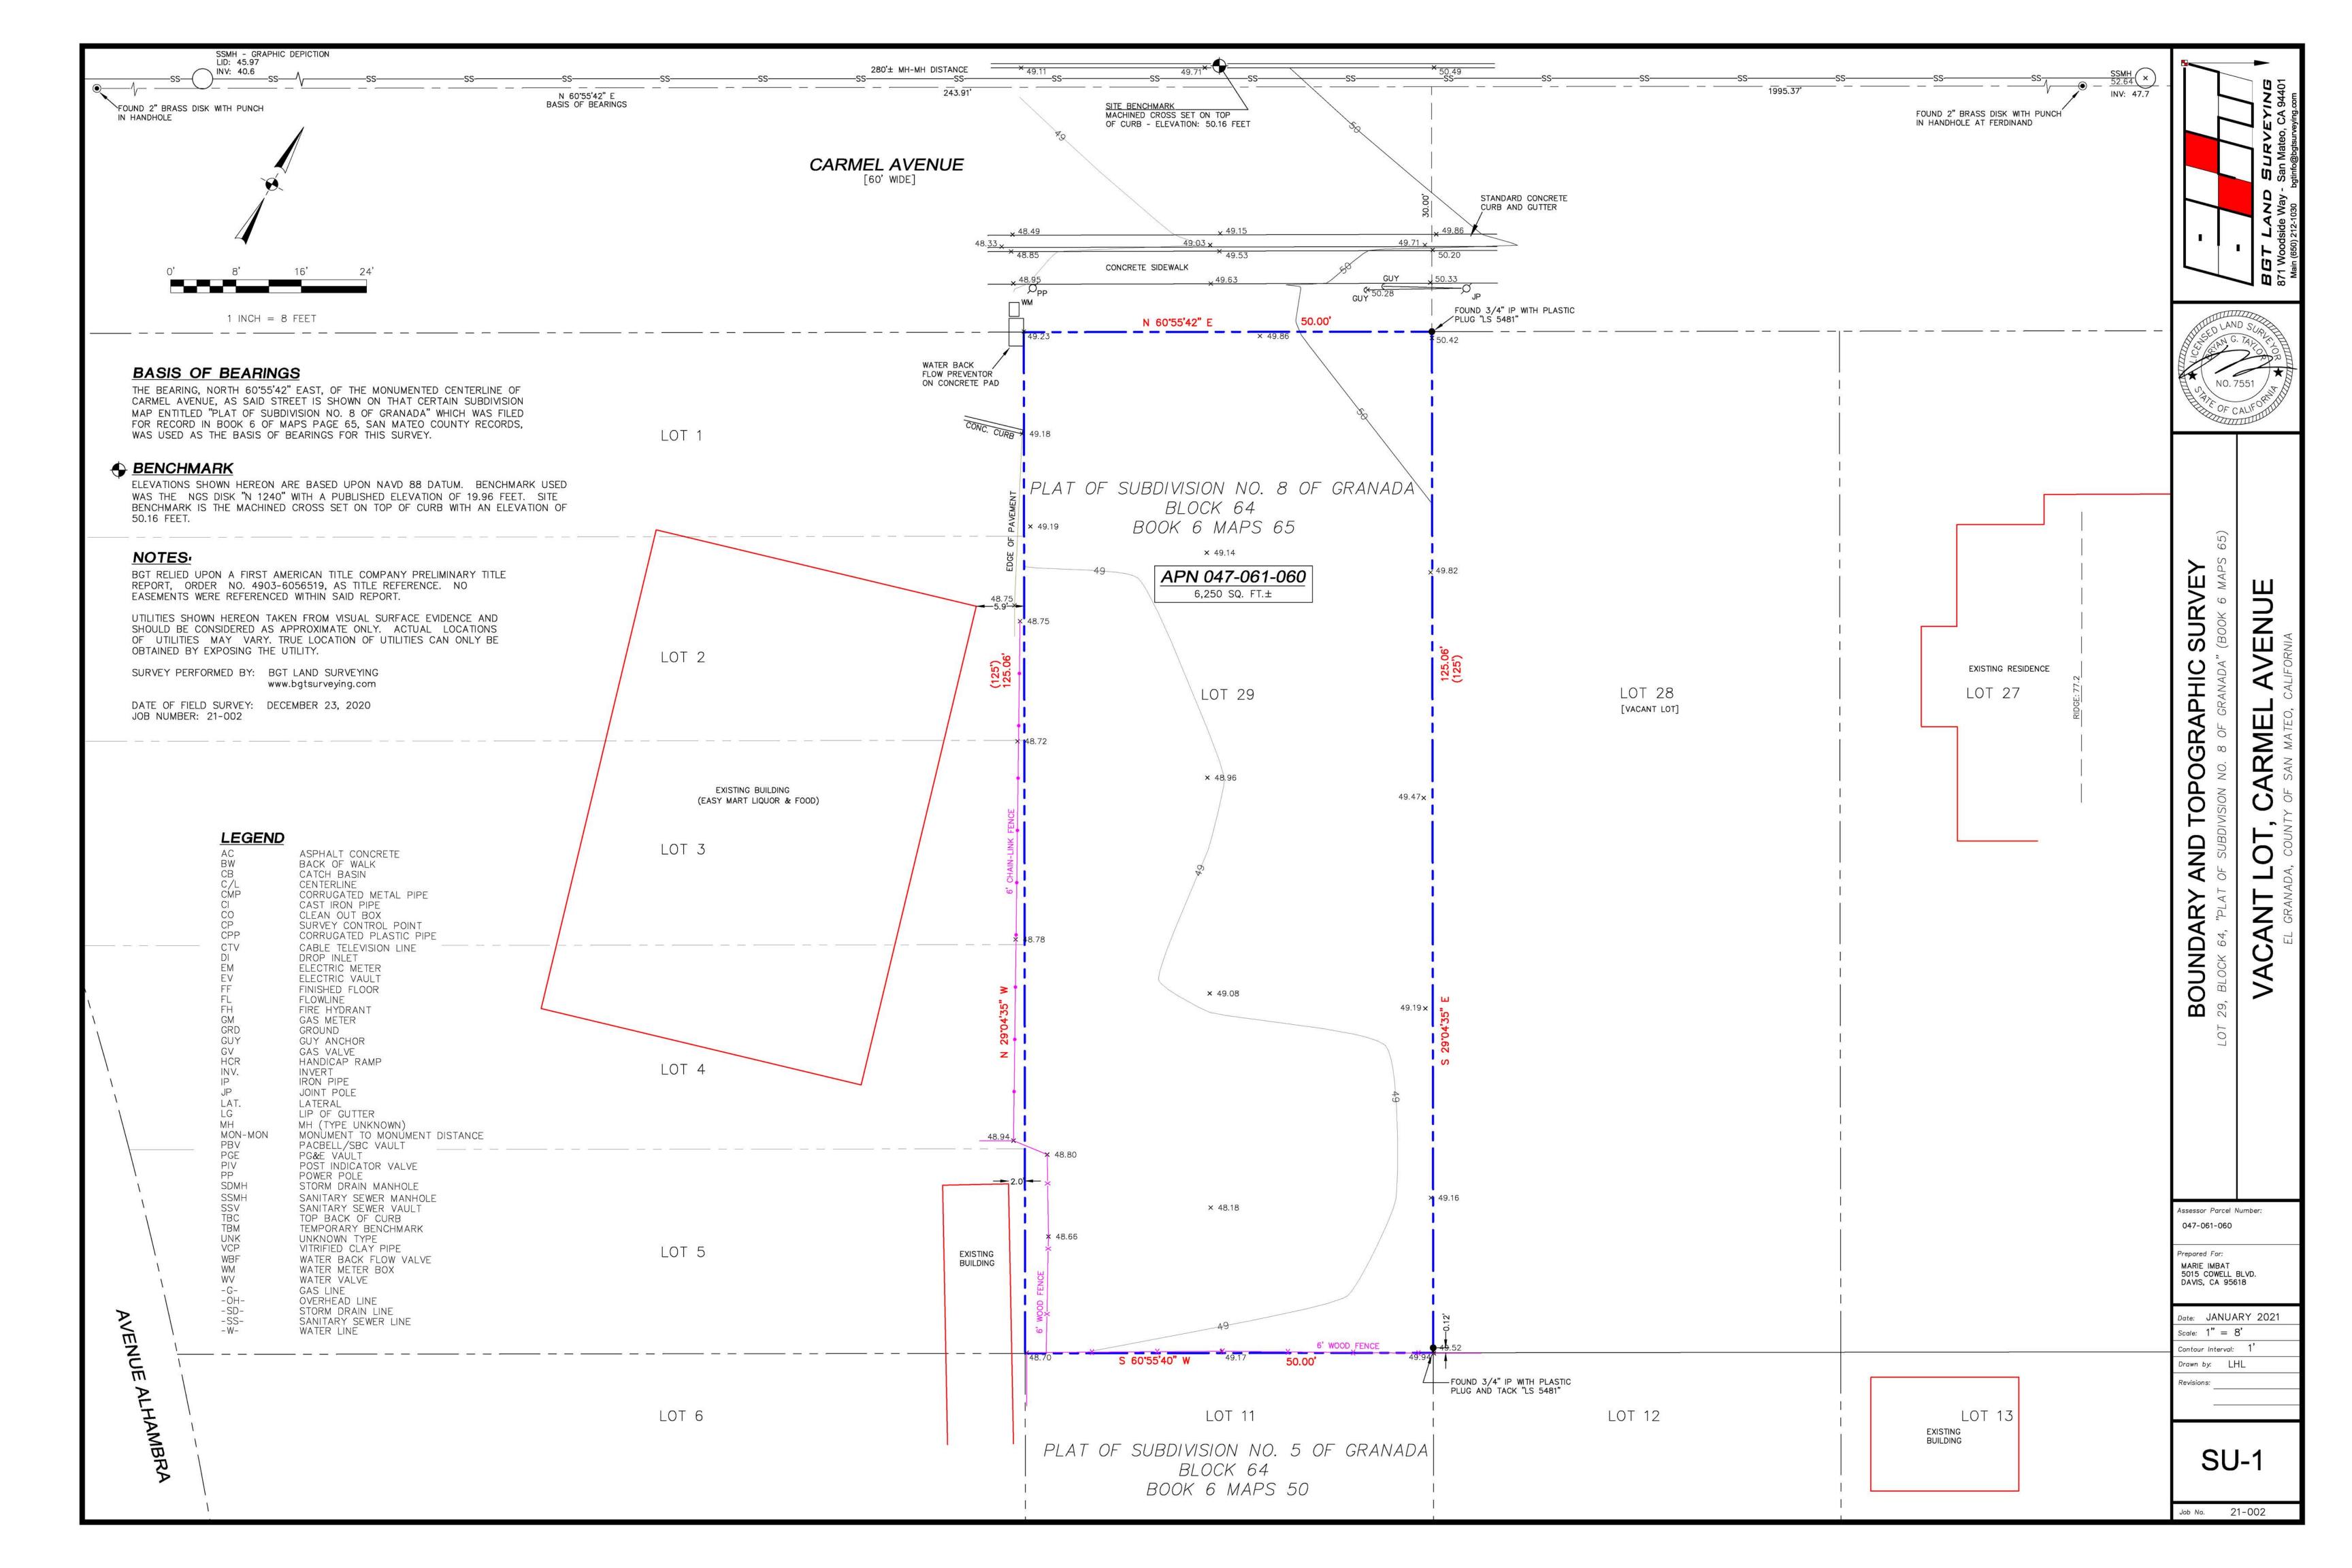

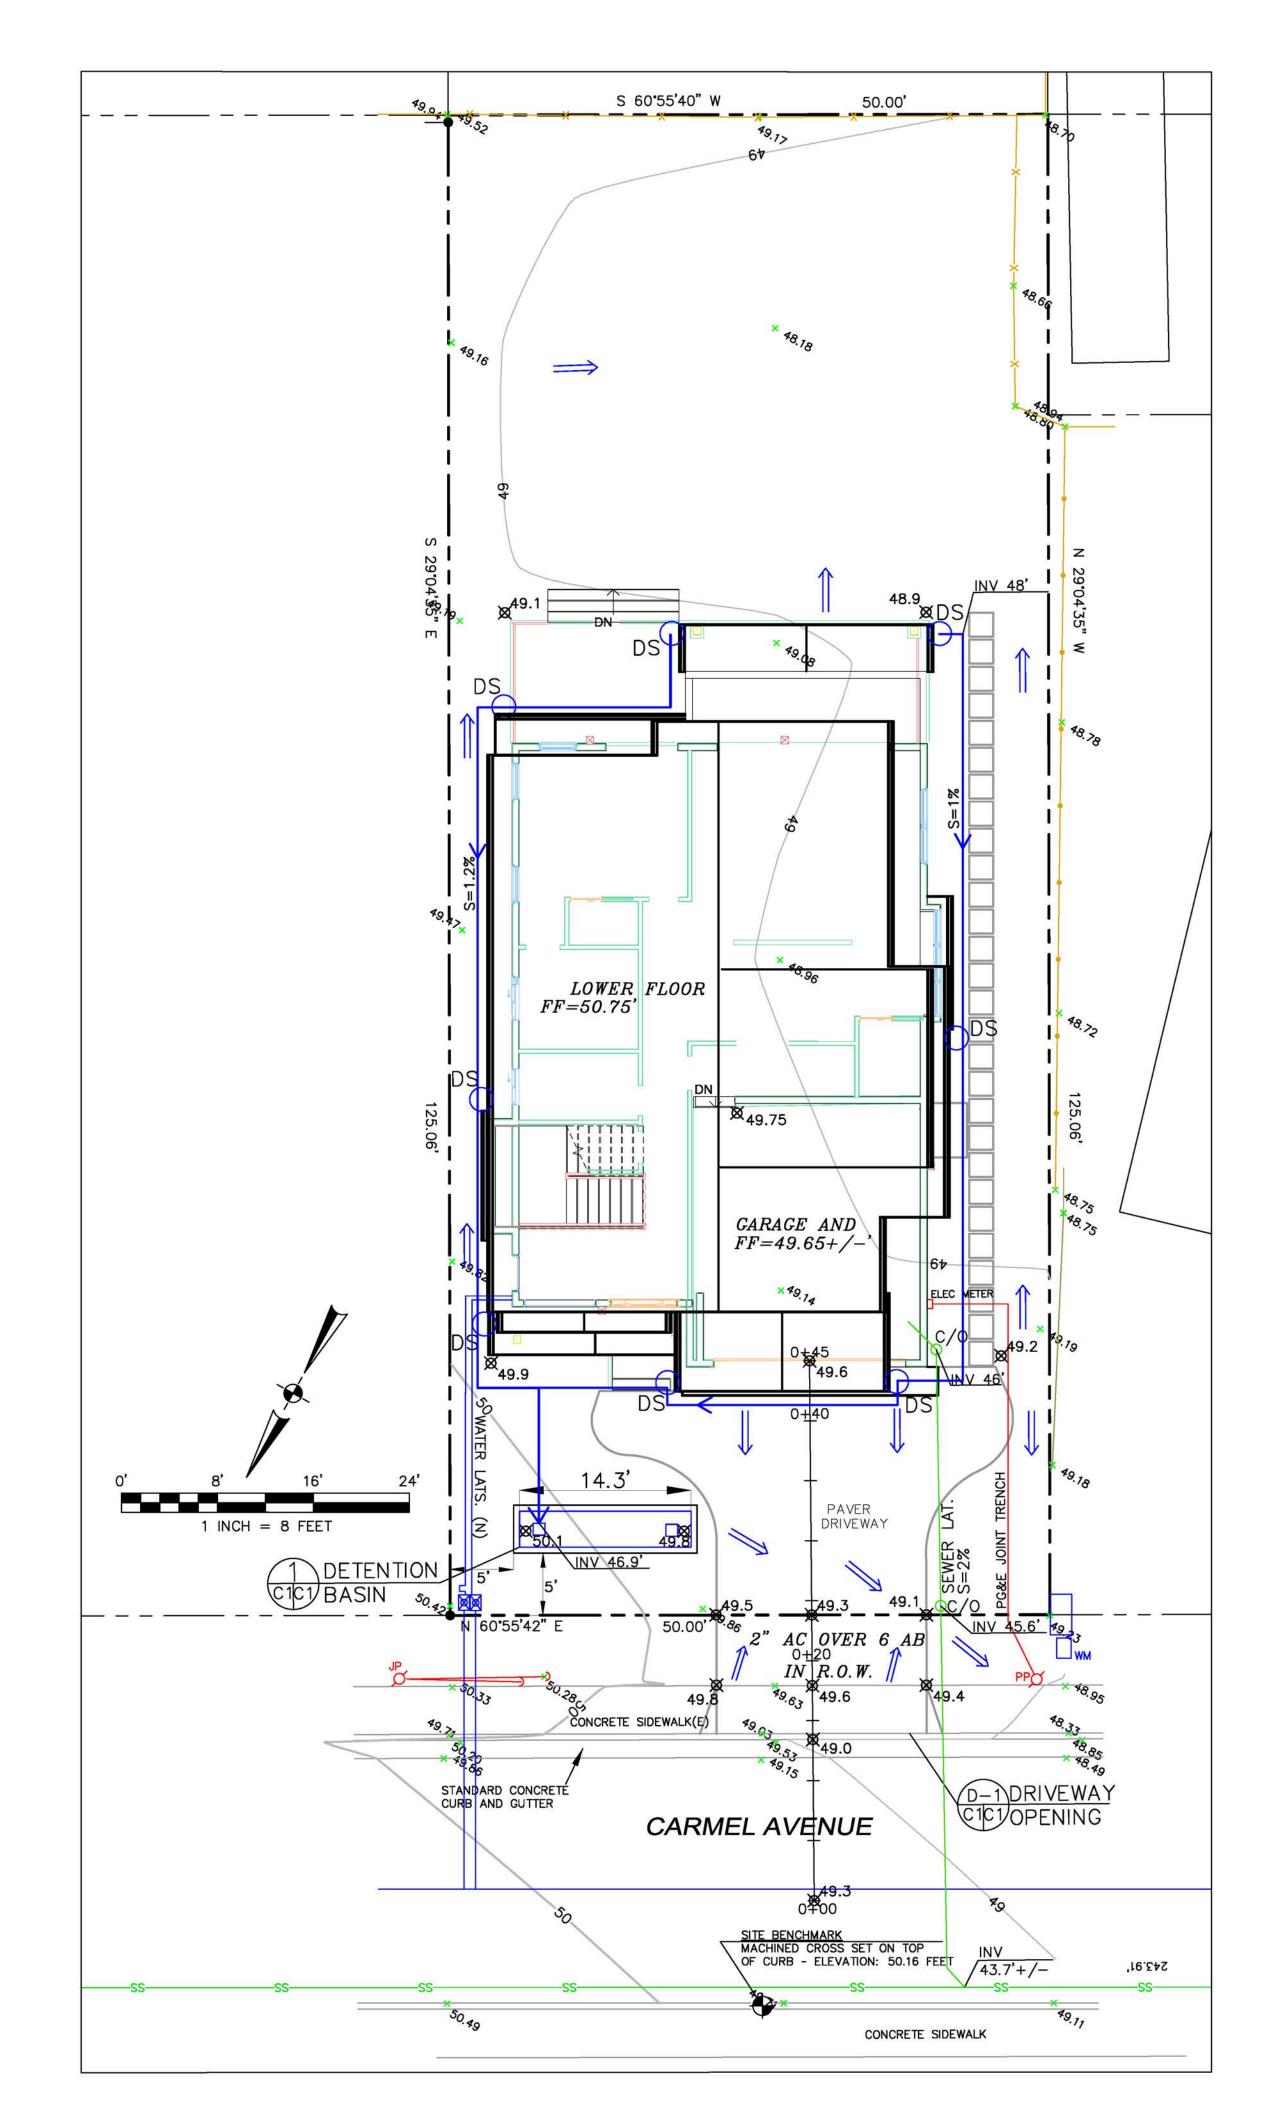

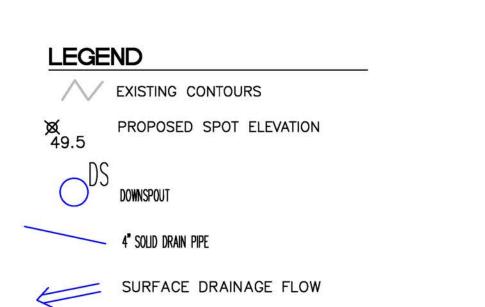

GENERAL NOTES

- 1. PLANS PREPARED AT THE REQUEST OF: RUSS IMBAT, OWNER
- 2. TOPOGRAPHY BY BGT LAND SURVEYING, SURVEYED 12-23-20.
- 3. THIS IS NOT A BOUNDARY SURVEY.
- 4. ELEVATION DATUM NAVD88.

5. THE GEOTECHNICAL REPORT: **GEOTECHNICAL STUDY: IMBAT PROPERTY, CARMEL AVENUE, EL GRANADA,** APN 047-161-060; DATE: 12-16-21, BY SIGMA PRIME GEOSCIENCES, PROJECT NO. 21-221 SHALL BE RETAINED ON THE CONSTRUCTION SITE. THE GEOTECHNICAL ENGINEER OF RECORD IS SIGMA PRIME GEOSCIENCES, WITH THE CONTACT NUMBER (650)-728-3590. THE CONTRACTOR SHALL NOTIFY THE GEOTECHNICAL ENGINEER OF RECORD AT LEAST 48 HOURS BEFORE CONSTRUCTION OF GEOTECHNICAL RELATED WORK. THE GEOTECHNICAL PART OF CONSTRUCTION WORK, INCLUDING BUT NOT LIMITED TO, ALL THE EARTHWORK AND FOUNDATION CONSTRUCTIONS, MUST SHALL BE APPROVED BY THE GEOTECHNICAL ENGINEER OF RECORD. 6. STORMWATER MANAGEMENT CONSTRUCTION INSPECTIONS SHALL BE SCHEDULED FOR APPLICABLE DRAINAGE INSPECTIONS, WHICH INCLUDE SITE CLEARANCE AND EROSION CONTROL MEASURES INSTALLATION AS WELL AS INSPECTION OF MAJOR DRAINAGE CONTAINMENT, TREATMENT, AND CONVEYANCE DEVICES BEFORE BEING BURIED (INCLUDING REQUIRED MATERIAL LABELS, E.G. PIPES, SUB-GRADE MATERIALS, ETC.). PLEASE FOLLOW THE INSPECTION CARD INSTRUCTIONS AND CALL SIGMA PRIME (650-728-3590) TO SCHEDULE DRAINAGE INSPECTIONS ACCORDINGLY. THERE SHALL BE THREE INSPECTIONS: ONE FOR EROSION CONTROL INSTALLATION, ONE BEFORE DRAINAGE FACILITIES ARE BURIED, AND ONE FOR FINAL WALK AROUND.



1. DRAINAGE INTENT: IT IS THE INTENT OF THE DRAINAGE SYSTEM TO CONVEY ROOF RUNOFF TO A SAFE LOCATION, AND TO MINIMIZE EXCESSIVE MOISTURE AROUND FOUNDATIONS. DIRECT SLOPES SUCH THAT STORMWATER WILL NOT BE DIVERTED ONTO ADJACENT PROPERTIES.

SHOWN.

PIPE, SLOPED AT 1% MINIMUM.

4. IT IS THE PROPERTY OWNER'S RESPONSIBILITY TO CHECK ON ALL STORMWATER FACILITIES SUCH AS ROOF GUTTERS, DOWNSPOUT LINES, AND THE DETENTION BASIN/ENERGY DISSIPATER TO BE SURE THAT THEY ARE CLEAR OF EXCESSIVE DEBRIS AND OPERATING EFFICIENTLY. THE FACILITIES SHALL BE CHECKED EVERY FALL AND PERIODICALLY DURING THE RAINY SEASON.

GRADING NOTES


CUT VOLUME : 30 CY (FOR FOUNDATION) FILL VOLUME: 0 CY


VOLUMES ABOVE ARE APPROXIMATE.

COMPACTED TO 95%.

ALL GRADING SHALL CONFORM TO LOCAL CODES AND ORDINANCES.

THEN FILLED WITH HAND TAMPED SOILS.

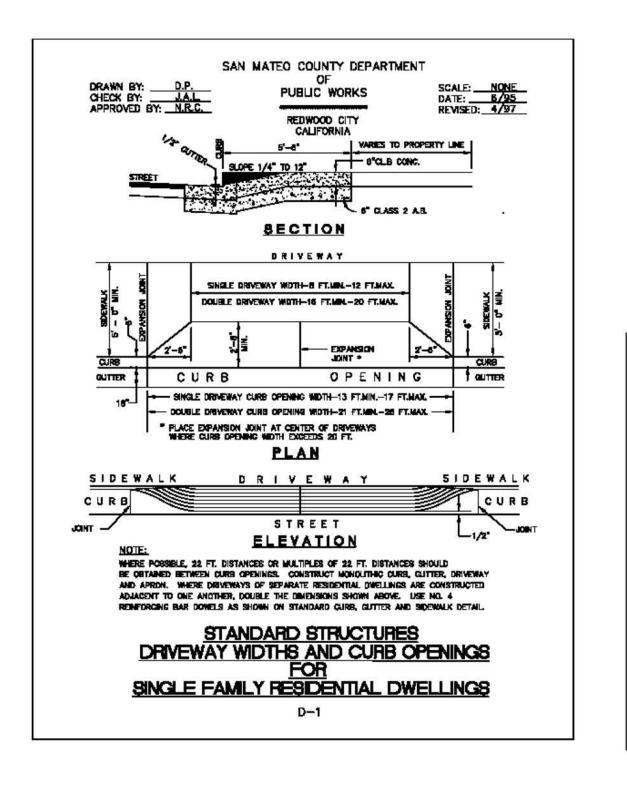

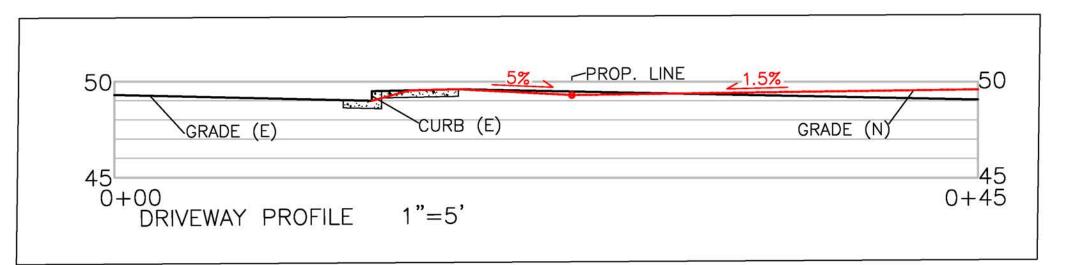


2. ALL DOWNSPOUT DRAIN LINES SHALL LEAD TO DETENTION BASIN, AS

3. ALL ROOF DRAINAGE PIPES SHALL BE 4" DIAMETER MINIMUM SOLID

THE SUBGRADE BELOW ALL PAVED AREAS SHALL BE BASEROCK

ALL TRENCHES UNDER PROPOSED PAVED AREAS OR CONCRETE SHALL BE BACKFILLED TO SUBGRADE ELEVATION WITH COMPACTED APPROVED GRANULAR MATERIALS. IF TRENCHES ARE IN PROPOSED LANDSCAPE AREAS, THEY SHALL BE BACKFILLED WITH COMPACTED APPROVED GRANULAR MATERIAL TO WITHIN ONE FOOT OF FINISHED GRADE, AND


SECTION AND DETAIL CONVENTION

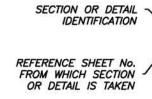


REFERENCE SHEET No. ON WHICH SECTION OR DETAIL IS SHOWN





Ì	Sigma Prime Geosciences, Inc.	SIGMA BRIME GEOSCIENCES INC	332 PRINCETON AVENUE HAI F MOON RAY CA 94019	(650) 728-3590 FAX 728-3593	
DATE: 12-16-21	DRAWN BY: CMK	CHECKED BY: AZG	REV. DATE:	REV. DATE:	REV. DATE:
GRADING AND			MBAT PROPERTY	CARMEL AVENUE FI GRANADA	APN 047-061-060
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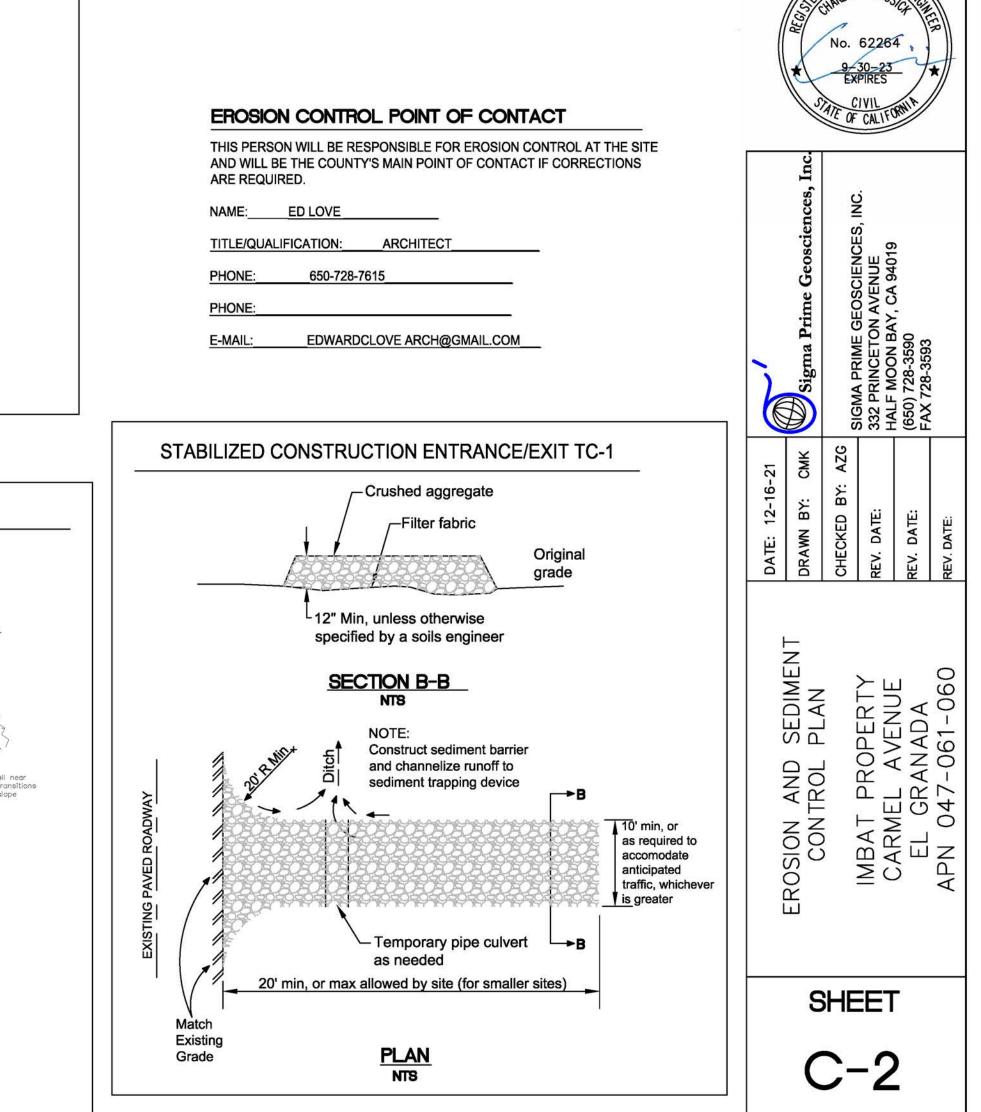


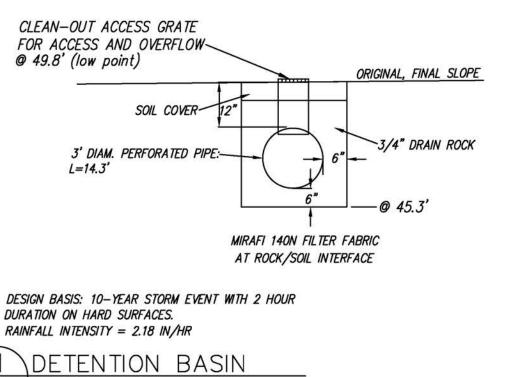
GENERAL EROSION AND SEDIMENT CONTROL NOTES

FIBER ROLE INSTALL AT LOCATIONS SHOWN. AFIX AS SHOWN IN DETAIL SE-5

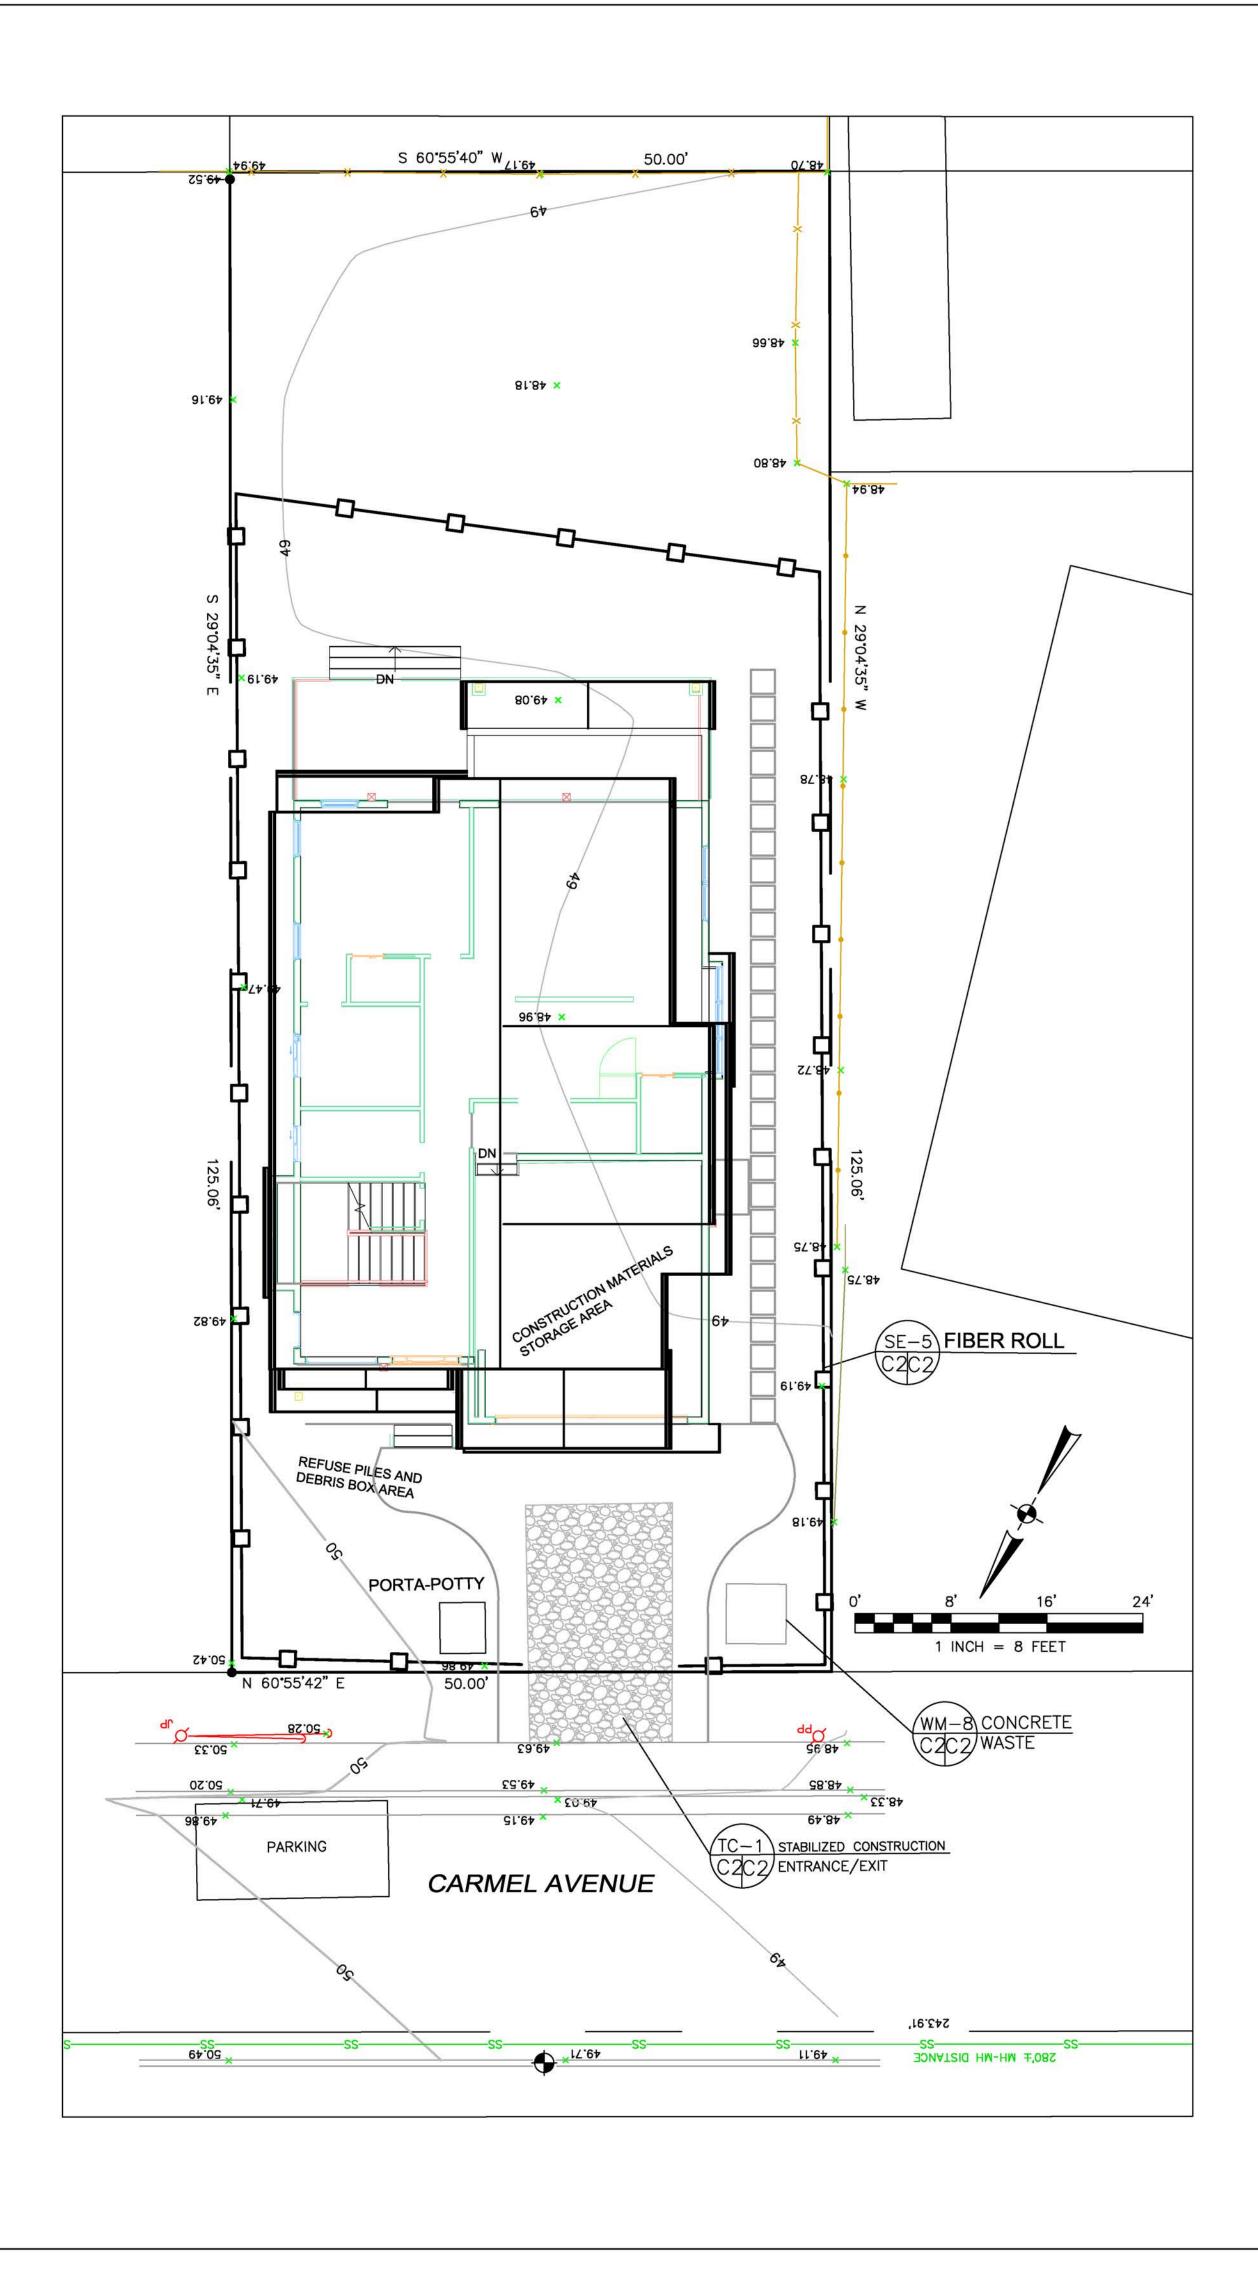 There will be no stockpiling of soil. All excavated soil will be hauled off-site as it is excavated.

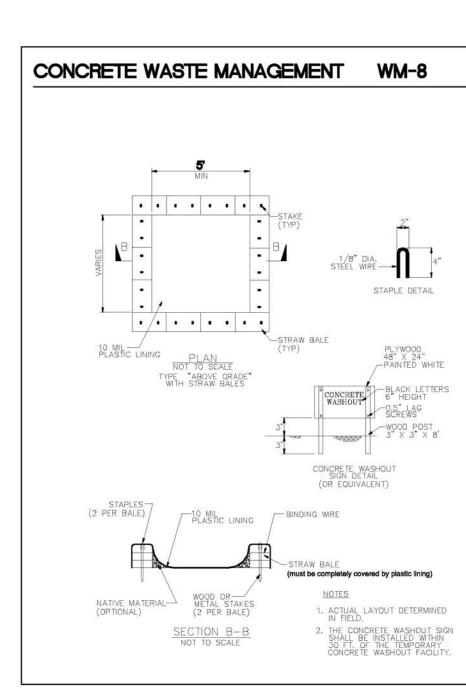
- Perform clearing and earth-moving activities only during dry weather. Measures to ensure adequate erosion and sediment control shall be installed prior to earth-moving activities and construction.
- · Erosion control materials to be on-site during off-season.
- Measures to ensure adequate erosion and sediment control are required year-round. Stabilize all denuded areas and maintain erosion control measures continuously between October 1 and April 30.
- Store, handle, and dispose of construction materials and wastes properly, so as to prevent their contact with stormwater.
- Control and prevent the discharge of all potential pollutants, including pavement cutting wastes, paints, concrete, petroleum products, chemicals, wash water or sediments, and non-stormwater discharges to storm drains and watercourses.
- Avoid cleaning, fueling, or maintaining vehicles on-site, except in a designated area where wash water is contained and treated.
- · Limit and time applications of pesticides and fertilizers to prevent polluted runoff.
- · Limit construction access routes to stabilized, designated access points
- Avoid tracking dirt or other materials off-site; clean off-site paved areas and sidewalks using dry sweeping methods.
- Train and provide instruction to all employees and subcontractors regarding the Watershed Protection Maintenance Standards and construction Best Management Practices.
- · Placement of erosion materials is required on weekends and during rain events.
- The areas delineated on the plans for parking, grubbing, storage etc., shall not be enlarged or "run over."
- · Dust control is required year-round.
- · Erosion control materials shall be stored on-site.
- · There are no trees or driplines on the site.

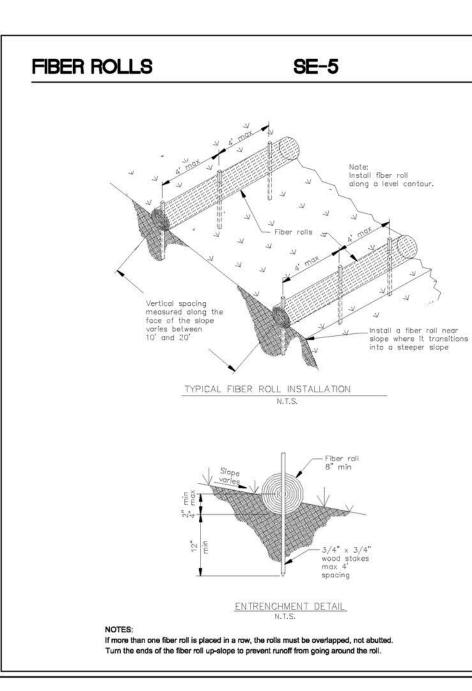

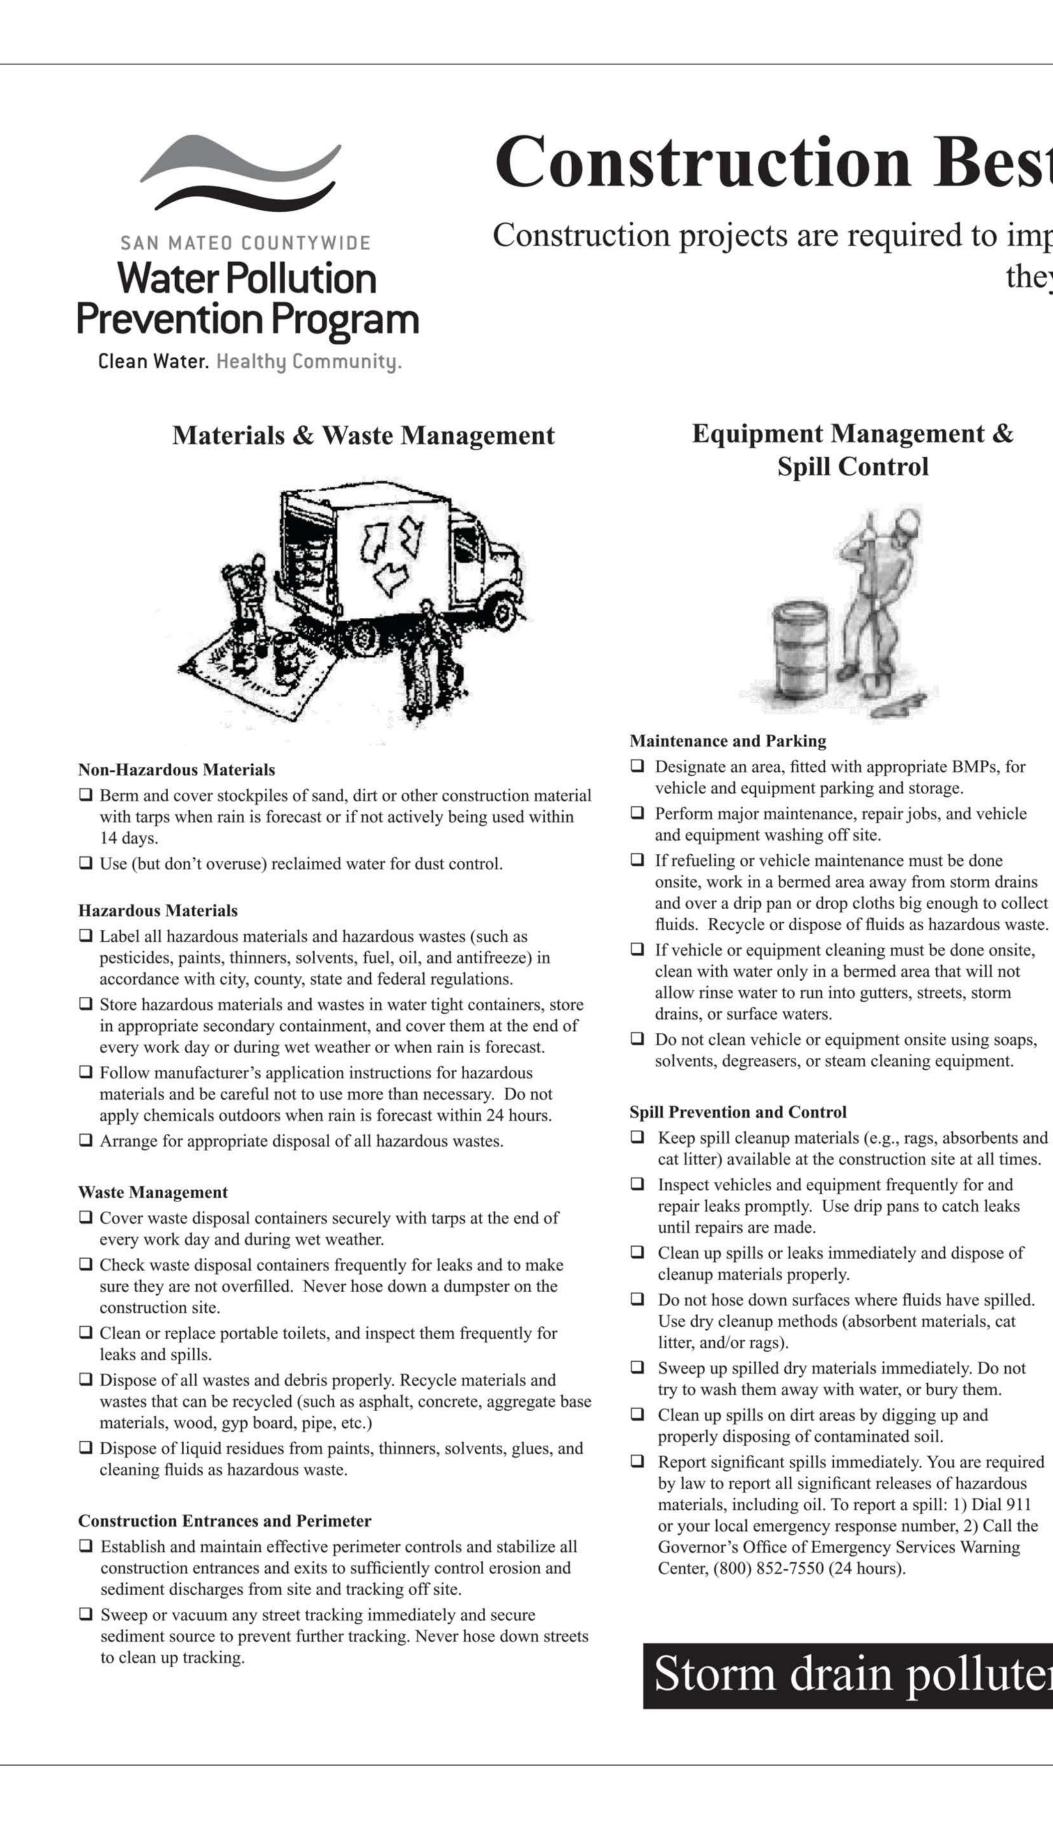

Construction Best Management Practices (BMPs)

Earthmoving

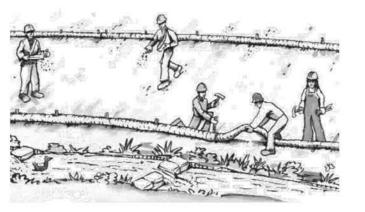

- □ Schedule grading and excavation work during dry weather.
- □ Stabilize all denuded areas, install and maintain temporary erosion controls (such as erosion control fabric or bonded fiber matrix) until vegetation is established.
- Remove existing vegetation only when absolutely necessary, and seed or plant vegetation for erosion control on slopes or where construction is not immediately planned.
- □ Prevent sediment from migrating offsite and protect storm drain inlets, gutters, ditches, and drainage courses by installing and maintaining appropriate BMPs, such as fiber rolls, silt fences, sediment basins, gravel bags, berms, etc.
- □ Keep excavated soil on site and transfer it to dump trucks on site, not in the streets.

Contaminated Soils

- □ If any of the following conditions are observed, test for contamination and contact the Regional Water Quality Control Board:
- Unusual soil conditions, discoloration, or odor.
- Abandoned underground tanks.
- Abandoned wells
- Buried barrels, debris, or trash.

Paving/Asphalt Work



- Avoid paving and seal coating in wet weather or when rain is forecast, to prevent materials that have not cured from contacting stormwater runoff.
- Cover storm drain inlets and manholes when applying seal coat, tack coat, slurry seal, fog seal, etc.
- Collect and recycle or appropriately dispose of excess abrasive gravel or sand. Do NOT sweep or wash it into gutters.
- Do not use water to wash down fresh asphalt concrete pavement.


Sawcutting & Asphalt/Concrete Removal

- □ Protect nearby storm drain inlets when saw cutting. Use filter fabric, catch basin inlet filters, or gravel bags to keep slurry out of the storm drain system.
- □ Shovel, abosorb, or vacuum saw-cut slurry and dispose of all waste as soon as you are finished in one location or at the end of each work day (whichever is sooner!).
- □ If sawcut slurry enters a catch basin, clean it up immediately.

Concrete, Grout & Mortar Application



- □ Store concrete, grout, and mortar away from storm drains or waterways, and on pallets under cover to protect them from rain, runoff, and wind.
- □ Wash out concrete equipment/trucks offsite or in a designated washout area, where the water will flow into a temporary waste pit, and in a manner that will prevent leaching into the underlying soil or onto surrounding areas. Let concrete harden and dispose of as garbage.
- □ When washing exposed aggregate, prevent washwater from entering storm drains. Block any inlets and vacuum gutters, hose washwater onto dirt areas, or drain onto a bermed surface to be pumped and disposed of properly.

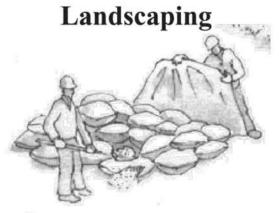


- Protect stockpiled landscaping materials from wind and rain by storing them under tarps all year-round.
- □ Stack bagged material on pallets and under cover.
- Discontinue application of any erodible landscape material within 2 days before a forecast rain event or during wet weather.

Storm drain polluters may be liable for fines of up to \$10,000 per day!






Painting & Paint Removal

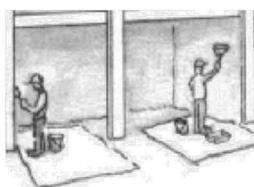



- **Painting Cleanup and Removal**
- Never clean brushes or rinse paint containers into a street, gutter, storm drain, or stream.
- □ For water-based paints, paint out brushes to the extent possible, and rinse into a drain that goes to the sanitary sewer. Never pour paint down a storm drain.
- □ For oil-based paints, paint out brushes to the extent possible and clean with thinner or solvent in a proper container. Filter and reuse thinners and solvents. Dispose of excess liquids as hazardous waste.
- □ Paint chips and dust from non-hazardous dry stripping and sand blasting may be swept up or collected in plastic drop cloths and disposed of as trash.
- Chemical paint stripping residue and chips and dust from marine paints or paints containing lead, mercury, or tributyltin must be disposed of as hazardous waste. Lead based paint removal requires a statecertified contractor.

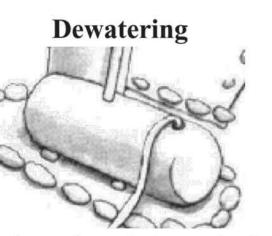

- Discharges of groundwater or captured runoff from dewatering operations must be properly managed and disposed. When possible send dewatering discharge to landscaped area or sanitary sewer. If discharging to the sanitary sewer call your local wastewater treatment plant.
- Divert run-on water from offsite away from all disturbed areas.
- □ When dewatering, notify and obtain approval from the local municipality before discharging water to a street gutter or storm drain. Filtration or diversion through a basin, tank, or sediment trap may be required.
- □ In areas of known or suspected contamination, call your local agency to determine whether the ground water must be tested. Pumped groundwater may need to be collected and hauled off-site for treatment and proper disposal.

	nstruction Best	t Manageme	ent Practice	es (BMPs)	
SAN MATEO COUNTYWIDE Constru Water Pollution Prevention Program Clean Water. Healthy Community.	uction projects are required to imp they	lement the stormwater bes apply to your project, all	• •	BMP) on this page, as	Painting & Paint Removal
Materials & Waste Management	Equipment Management & Spill Control	Earthmoving	Paving/Asphalt Work	Concrete, Grout & Mortar Application	Contraction of the second seco
Average for appropriate disposal of all hazardous wastes: Check waste disposal containers securely with tarps at the end of every work day or during wet weather or when rain is forecast. Check waste disposal containers securely with tarps at the end of every work day or during wet weather or when rain is forecast. Child the context of the secure of all hazardous wastes (such as a periodical with each of the secure o	 Perform major maintenance, repair jobs, and vehicle and equipment washing off site. If refueling or vehicle maintenance must be done onsite, work in a bermed area away from storm drains and over a drip pan or drop cloths big enough to collect fluids. Recycle or dispose of fluids as hazardous waste. If vehicle or equipment cleaning must be done onsite, clean with water only in a bermed area that will not allow rinse water to run into gutters, streets, storm drains, or surface waters. Do not clean vehicle or equipment onsite using soaps, solvents, degreasers, or steam cleaning equipment. Spill Prevention and Control Keep spill cleanup materials (e.g., rags, absorbents and cat litter) available at the construction site at all times. Inspect vehicles and equipment frequently for and repair leaks promptly. Use drip pans to catch leaks until repairs are made. Clean up spills or leaks immediately and dispose of cleanup materials properly. Do not hose down surfaces where fluids have spilled. Use dry cleanup methods (absorbent materials, cat litter, and/or rags). Sweep up spilled dry materials immediately. Do not try to wash them away with water, or bury them. Clean up spills on dirt areas by digging up and properly disposing of contaminated soil. Report significant spills immediately. You are required by law to report all significant releases of hazardous materials, including oil. To report a spill: 1) Dial 911 or your local emergency response number, 2) Call the Governor's Office of Emergency Services Warning Center, (800) 852-7550 (24 hours). 	 Schedule grading and excavation work during dry weather. Stabilize all denuded areas, install and maintain temporary erosion controls (such as erosion control fabric or bonded fiber matrix) until vegetation is established. Remove existing vegetation only when absolutely necessary, and seed or plant vegetation for erosion control on slopes or where construction is not immediately planned. Prevent sediment from migrating offsite and protect storm drain inlets, gutters, ditches, and drainage courses by installing and maintaining appropriate BMPs, such as fiber rolls, silt fences, sediment basins, gravel bags, berms, etc. Keep excavated soil on site and transfer it to dump trucks on site, not in the streets. Durusual soil conditions, discoloration, or odor. Abandoned underground tanks. Abandoned wells Buried barrels, debris, or trash. 	 Avoid paving and seal coating in wet weather or when rain is forecast, to prevent materials that have not cured from contacting stormwater runoff. Cover storm drain inlets and manholes when applying seal coat, tack coat, slurry seal, fog seal, etc. Collect and recycle or appropriately dispose of excess abrasive gravel or sand. Do NOT sweep or wash it into gutters. Do not use water to wash down fresh asphalt concrete pavement. Sawcutting & Asphalt/Concrete Removal Protect nearby storm drain inlets when saw cutting. Use filter fabric, catch basin inlet filters, or gravel bags to keep slurry out of the storm drain system. Shovel, abosorb, or vacuum saw-cut slurry and dispose of all waste as soon as you are finished in one location or at the end of each work day (whichever is sooner!). If sawcut slurry enters a catch basin, clean it up immediately. 	<text><list-item><list-item><list-item><list-item></list-item></list-item></list-item></list-item></text>	 Never clean brushes or rinse paint containers into a street, gutter, storm drain. For water-based paints, paint out brushes to the extent possible and clean with thinner or solvent in a proper container. Filter and reuse thinners and solvents. Dispose of excess liquids as hazardous waste. Paint chips and dust from non-hazardous drys stripping and sand blasting may be swept up or collected in plastic drop cloths and disposed of as trash. Chemical paint stripping residue and chips and dust from marine paints or paints (containing lead, mercury, or tributyltin must be disposed of as hazardous waste. Lead based paint removal requires a statectrified contractor. Derverterene Descharges of groundwater or capturef nuoff from dewatering operations must be properly managed and disposed. 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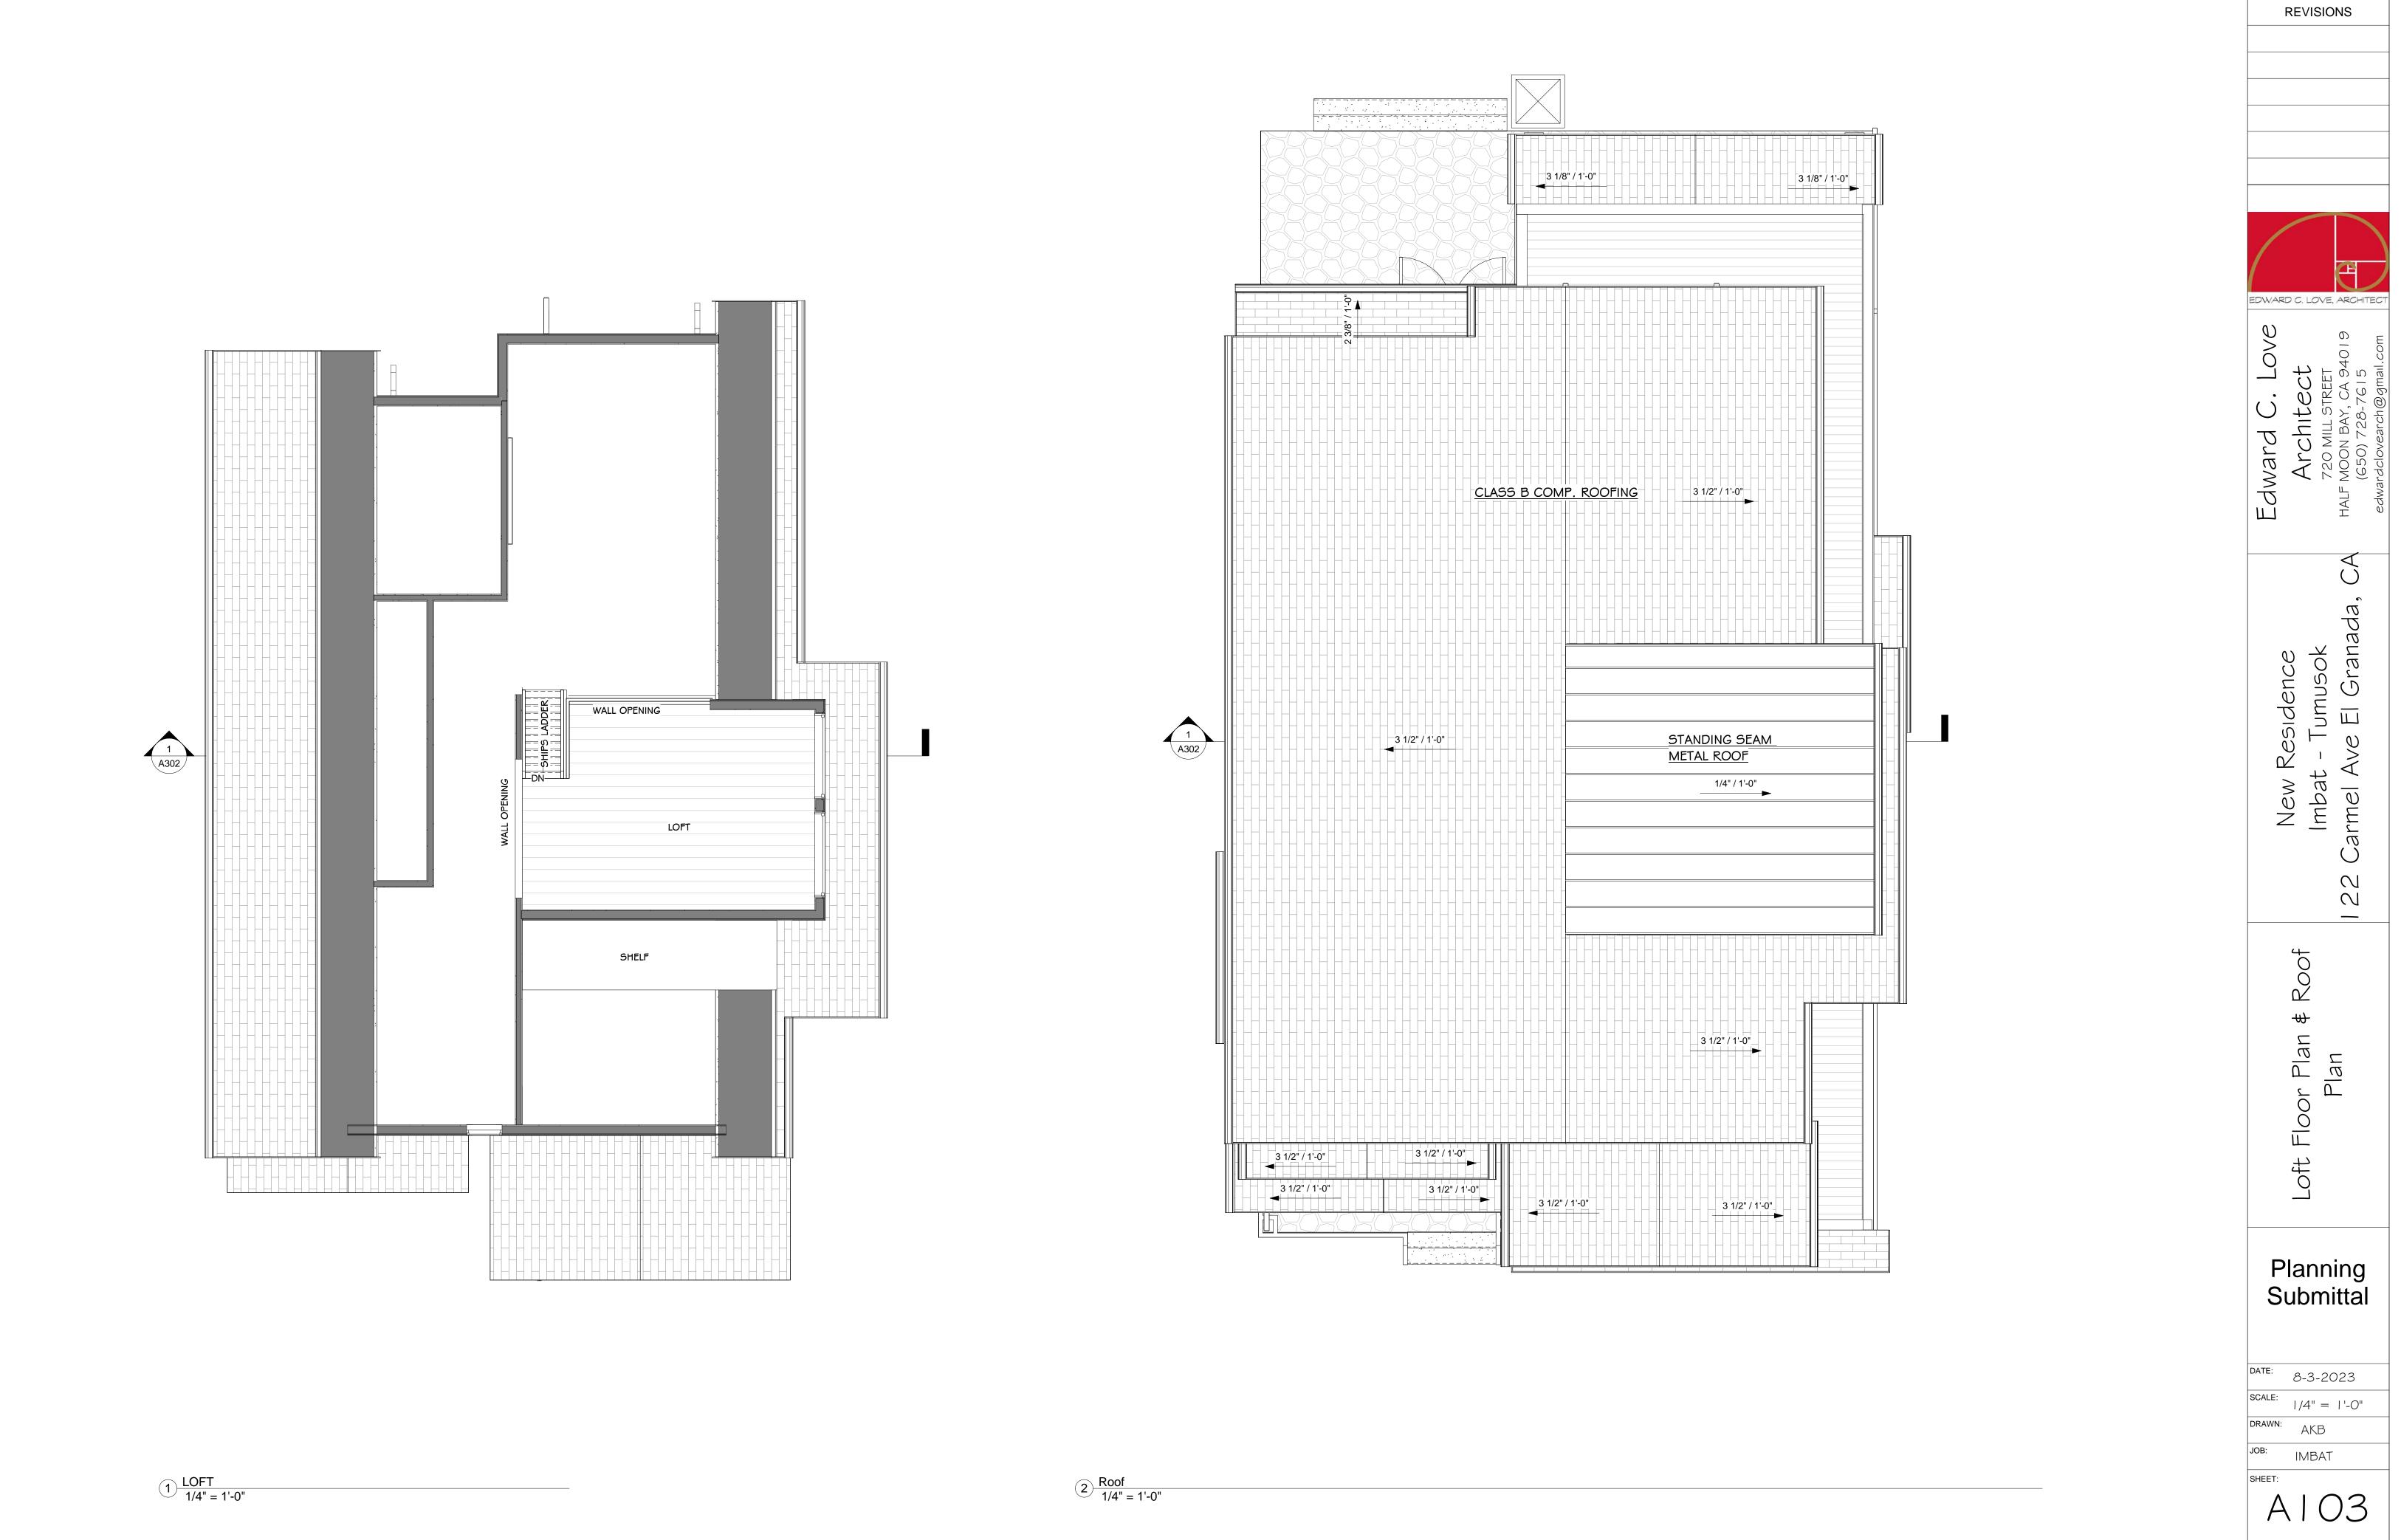
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PROJECT NORTH

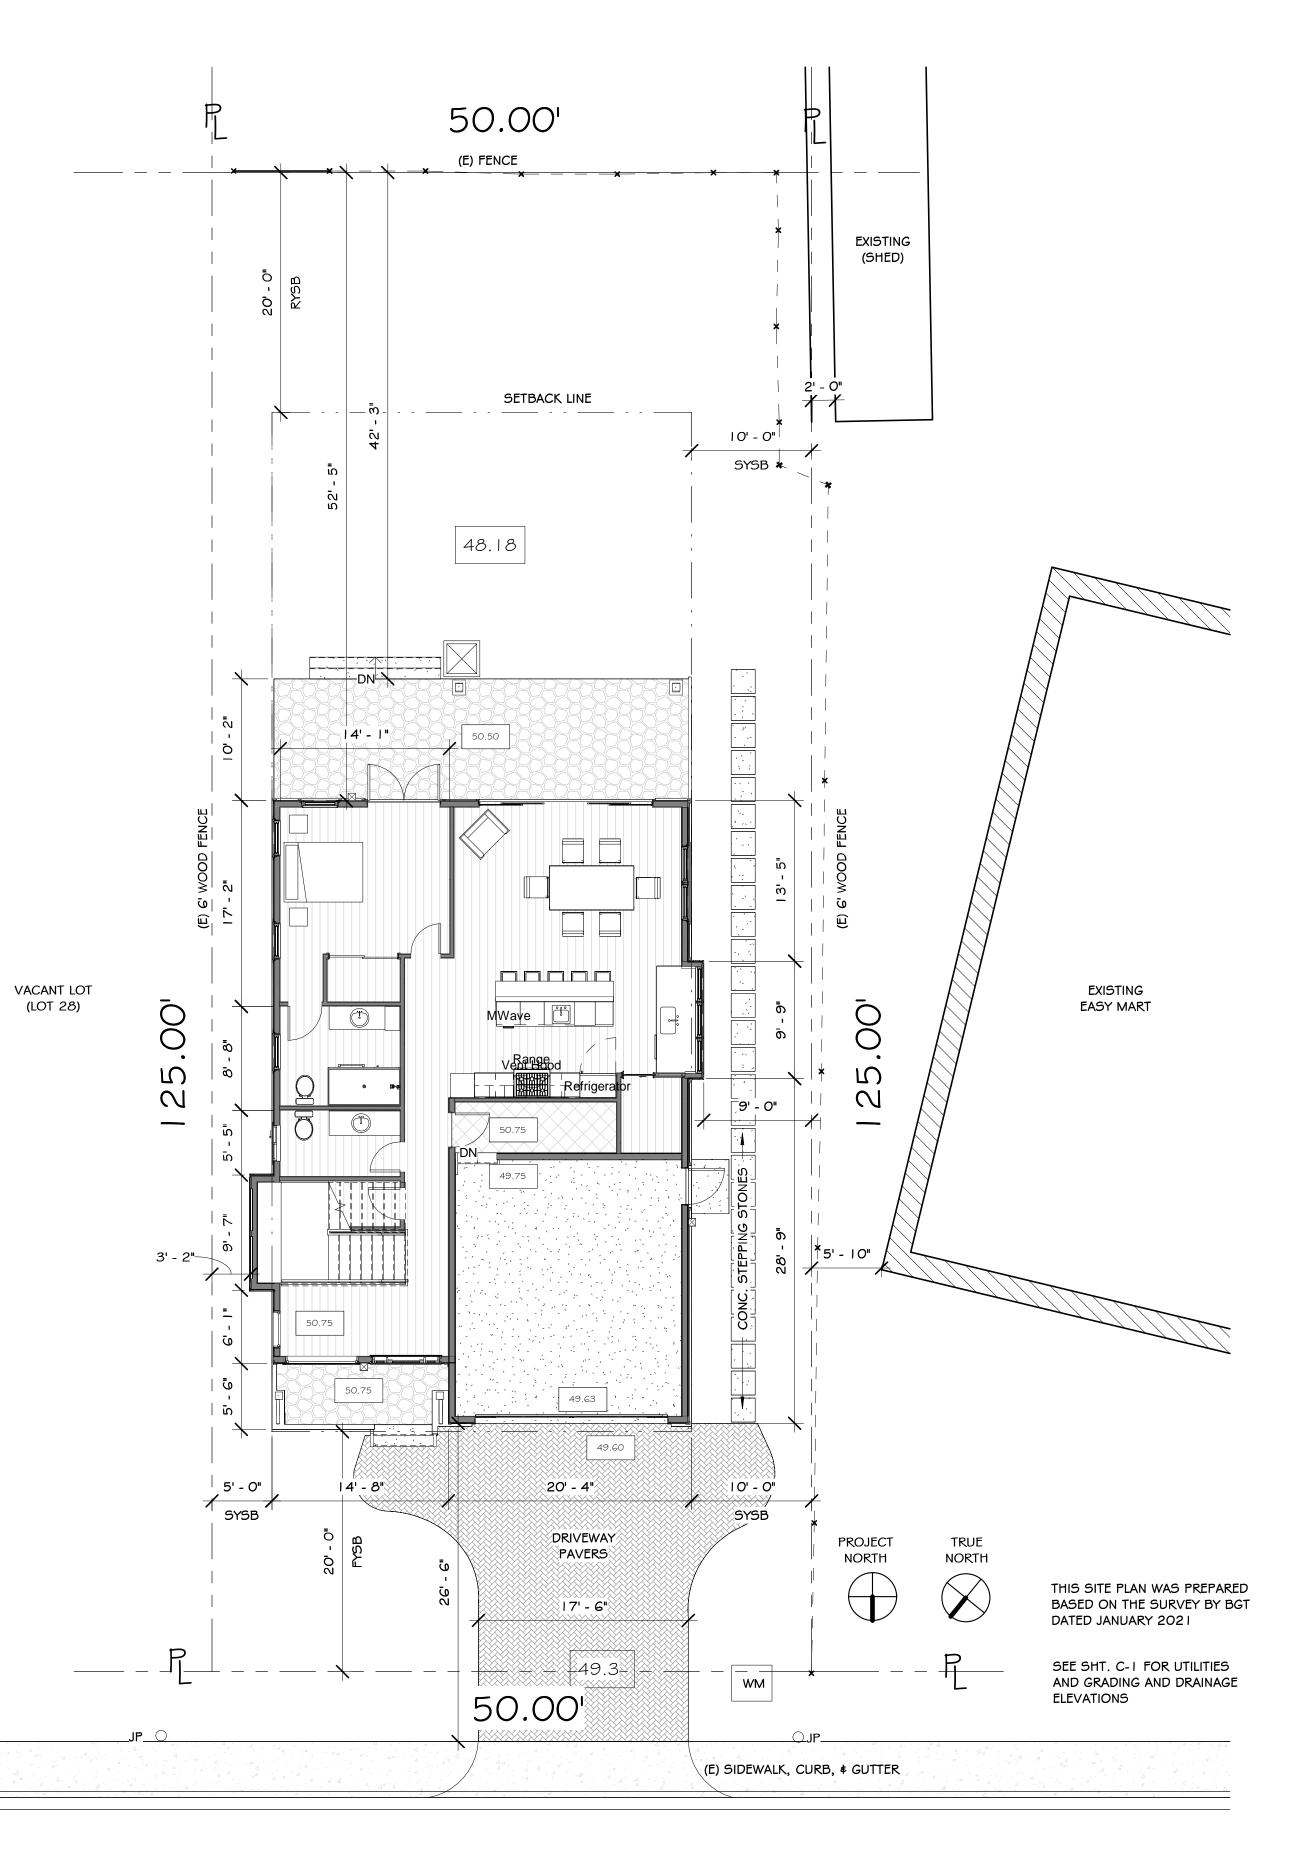

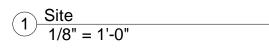


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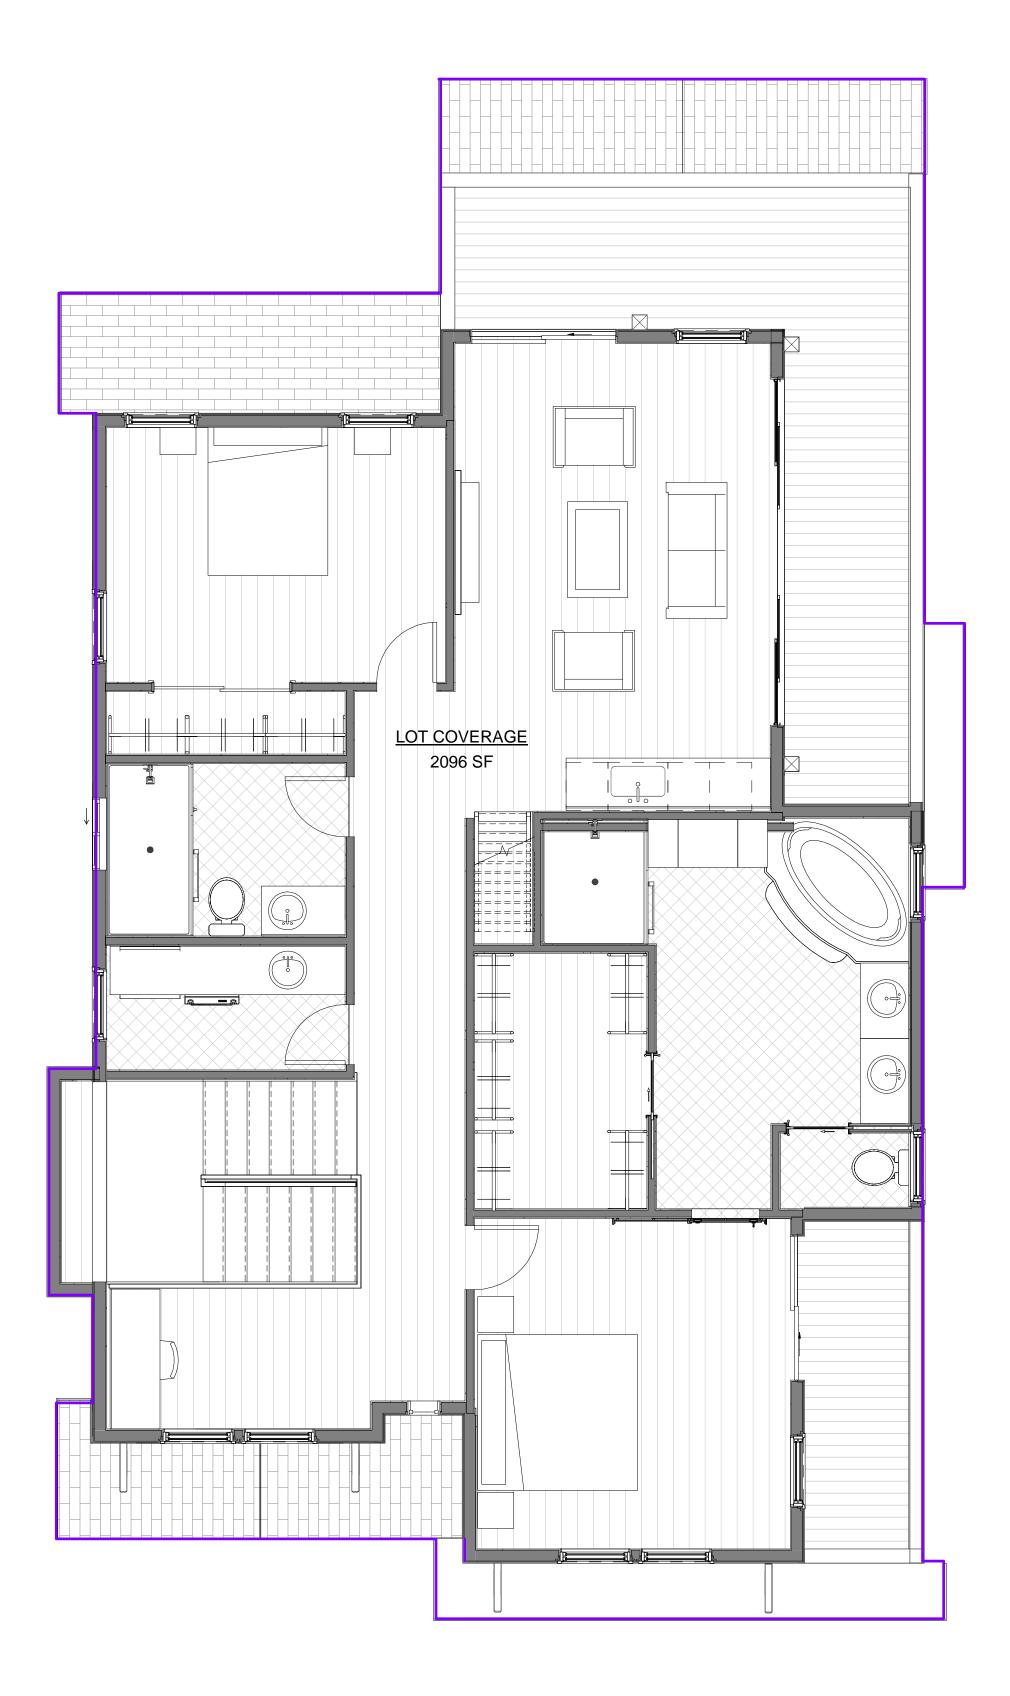
SHEETS

OF



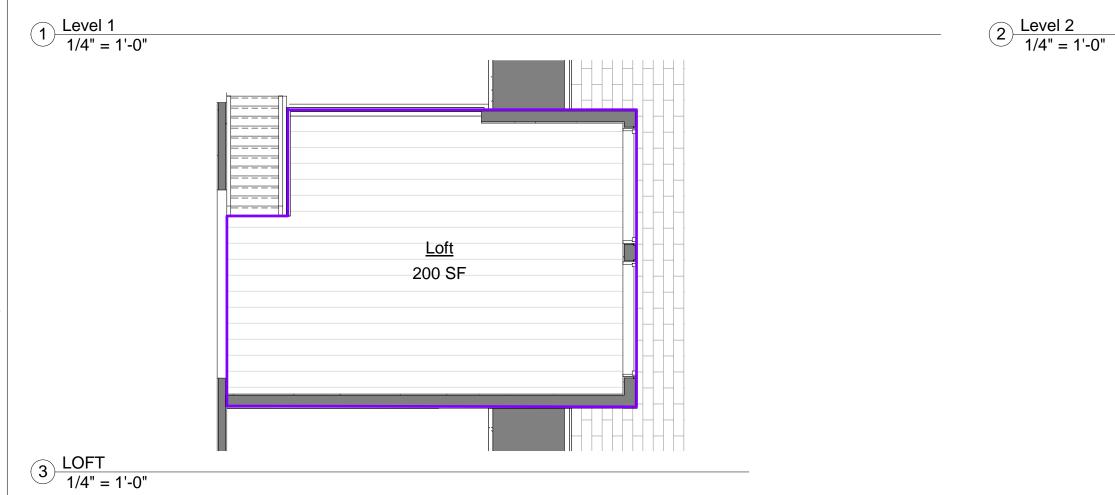

		REVISIONS
	Deck 242 SF	
Bedroom 2 209 SF		EDWARD C. LOVE, ARCHITECT
Closet 24 SF Bathroom 2 94 SF 94 SF Range Vent Hood	Bedroom 3 170 SF Living Room 228 SF 32 SF 32 SF 64 SF	Edward C. Love Architect 720 MILL STREET HALF MOON BAY, CA 94019 (650) 728-7615 edwardclovearch@gmail.com
Image: Closed of the second secon	Bathroom 2 B1 SF B1 S	New Residence Imbat - Tumusok I 22 Carmel Ave El Granada, CA
Entry 94 SF 1 1 1 1 1 1 1 1 1 1 1 1 1 1 1 1 1 1 1	b) Office 96 SF 96 SF 97 SF 96 SF 98	Floor Areas Window & Door Schedual
The second secon	" = 1'-0"	Planning Submittal
S:VClient Projects 2021/Impar		DATE: 8-3-2023 SCALE: 1/4" = 1'-0" DRAWN: AKB JOB: IMBAT SHEET: A 105
3 LOFT 1/4" = 1'-0" ALL DRAWINGS, SPECIFICATIONS, AND COPIES THEREOF, PREPARED AND/OR SUPPLIED BY THE ARCHITECT, SHALL REMAIN HIS PROPERTY. THEY ARE TO BE USED ONLY WITH RESPECT TO THIS PROJECT AND ARE NOT TO BE USED ON ANY OTHER PROJECT. WITH THE PROJECT.	EXCEPTION OF ONE CONTRACT SET FOR EACH PARTY TO THE CONTRACT, SUCH DOCUMENTS ARE TO BE RETURNED OR SUITABLY ACCOUNTED FOR UPON REQUEST OF THE ARCHITECT AT THE COMPLETION OF THE WORK. SUBMISSION OR DISTRIBUTION TO MEET OFFICIAL REGULATORY REQUIREMENTS OR FOR OTHER PURPOSES IN CONNECTION WITH THE PROJECT IS NOT TO BE CONSTRUED AS	OF SHEETS



TOTAL LOT COVERAGE: 2096 SF

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1 Level 2 1/4" = 1'-0"





Product Overview

Add a touch of mission styling to your decor with the Home Decorators Collection Port Oxford Outdoor Oil Rubbed Chestnut Wall Lantern. This beautiful fixture is presented in versatile hand applied multi-step oil rubbed chestnut finish and pearl mission glass panes. Add a new look to your outdoor space with this classic fixture.

Darksky certified Light color is 3000K (bright white) 360 Lumens 80 CRI and uses only 5.5-Watt

Specifications

Dimensions Product Depth (in.) Product Length (in.)	5.91 8.01	Product Height Product Width (8.01 4.49
Details Actual Color Temperati Color Temperature	ıre (K)	3000 Bright White	Colo	r Rendering Ind
Exterior Lighting Produc Fixture Material	ct Type Cylin	der Lights Fixt Aluminum		or/Finish s/Lens Type
Light Bulb Type Include Maximum Wattage (watt Watt Equivalence	0	rated LED Ligh O 60		ut (lumens) Þer of Bulbs Re
Outdoor Lighting Featu	Dark Sky,Weather Resistant,Weather			
Power Type Product Weight (Ib.)		Hardwired 2.291b		
Style		Craftsman		



Amarr[®] Classica[®]

Premium Steel Carriage House Garage Doors



www.amarr.com

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80 ndex

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360 Required Ο

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	REVISIONS
C. Love	Architect 720 MILL STREET NLF MOON BAY, CA 94019 (650) 728-7615 dwardclovearch@gmail.com
Edward	e HA
	New Residence Imbat - Tumusok I 22 Carmel Ave El Granada, CA
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DATE: SCALE: DRAWN: JOB: SHEET: SHEET: OF	8-3-2023 Author IMBAT


Amarr[®]Classica[®]

Construction

Glass Options CLEAR (C **CL1000** Single-Layer: Steel CL2000 Double-Layer: Steel + Insulation **CL3000** Triple-Layer: Steel + Insulation + Steel ouble Strengt Steel Exterior Insulation Steel Exterio Exterior Polystyren Insulation **Top Sections** CLOSED ARCH (1) Available for T1, S1, L1, V1 Specifications AMARR CLASSICA CL2000 AMARR CLASSICA CL3000 AMARR CLASSICA CL1000 Amarr PANEL DESIGNS Carriage House 7 Designs 7 Designs Designs INSULATION Polystyrene¹ Polyurethane R-VALUE² 6.64 13.35 ENERGY EFFICIENCY Better Best QUIET OPERATION Better Best 2" (5.1cm) 2" (5.1cm) 2" (5.1cm) DOOR THICKNESS DANUBE [4]* INSULATED GLASS OPTION[†] . WIND LOAD³ AVAILABLE • • • PAINT FINISH WARRANTY Lifetime Lifetime Lifetime 5 Years Lifetime 3 Years ³ It is your responsibility to make sure your garage door meets local building codes. ⁴ For complete warranty detail visit amarr.com or contact yo local Amarr dealer. ¹ Insulation has passed self-ignition, flamesprea and smoke developed index fire testing. R-value is in accordance with DASMA TDS-163. e upcharge applies. Colors WICKER TAN (WK) SANDTONE (ST) TERRATONE GRAY (EF) DARK BROWN [DN] r local -Williams paint chips. SHERWIN WILLIAMS. * Odd heights not available in CL1000/CL2000 TWO-TONE PAINT OPTIONS[‡] BASE DOOR SANDTONE TERRATONE CHARCOAL GRAY ALMOND WICKER TA SANDTON BLUE RIDGE HUNTER GREEN GRAY ‡Price upcharge applies Amarr Company 165 Carriage Court Winston-Salem, NC 27105 800.503.D00R RECYCLED ALPINE www.amarr.com Door specifications and technical data subject to change without notice. Amarr and Classica as words and logos are trademarks belonging to Amarr Company, owned by ASSA ABLOY. Sectional door products from Amarr Company may be the subject of one or more U.S. and/or foreign, issued and/or pending, design and/or utility patent ©ASSA ABLOY Printed in USA Form #6030323/15M/WPI Part of ASSA ABLOY


LOSED SQUARE (2) wailable for T2, S2, L2, V ilable for T1D, S1D, L1D, V1 020 Decorative Hardware CLAVOS


Amarr

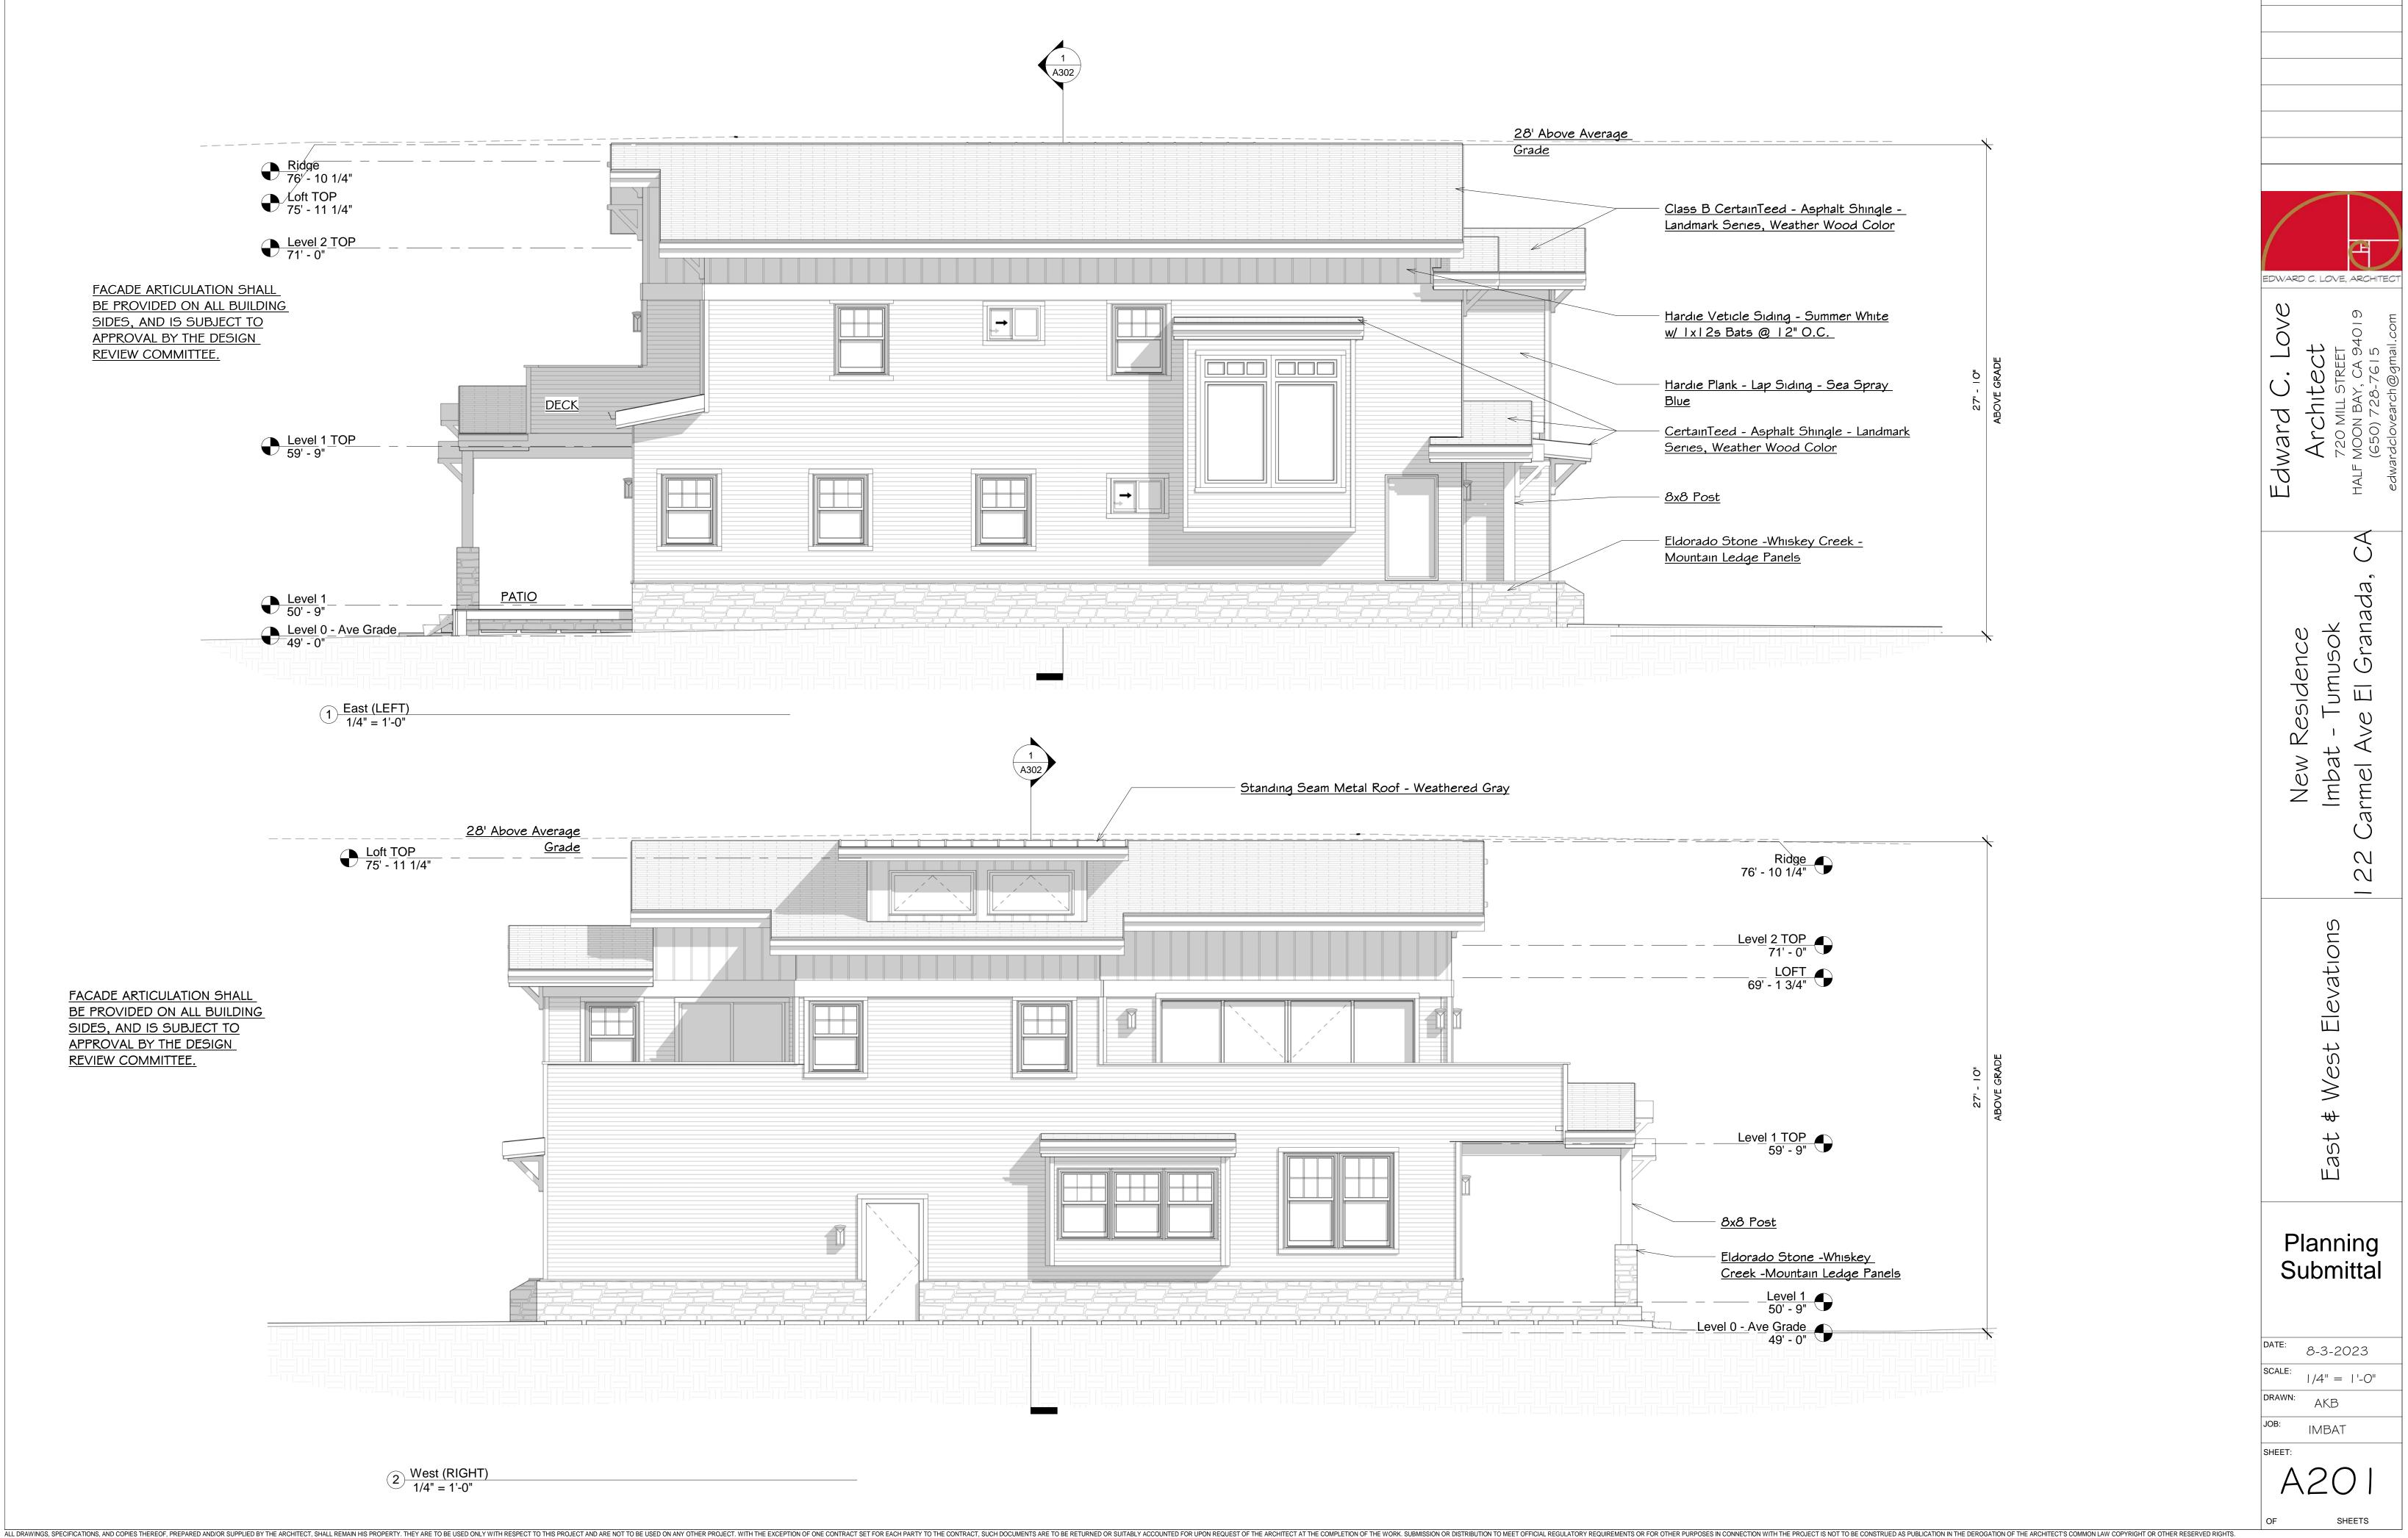

REVISIONS

client Projects 2021\Imbat\Revit\Tumosok - Imba

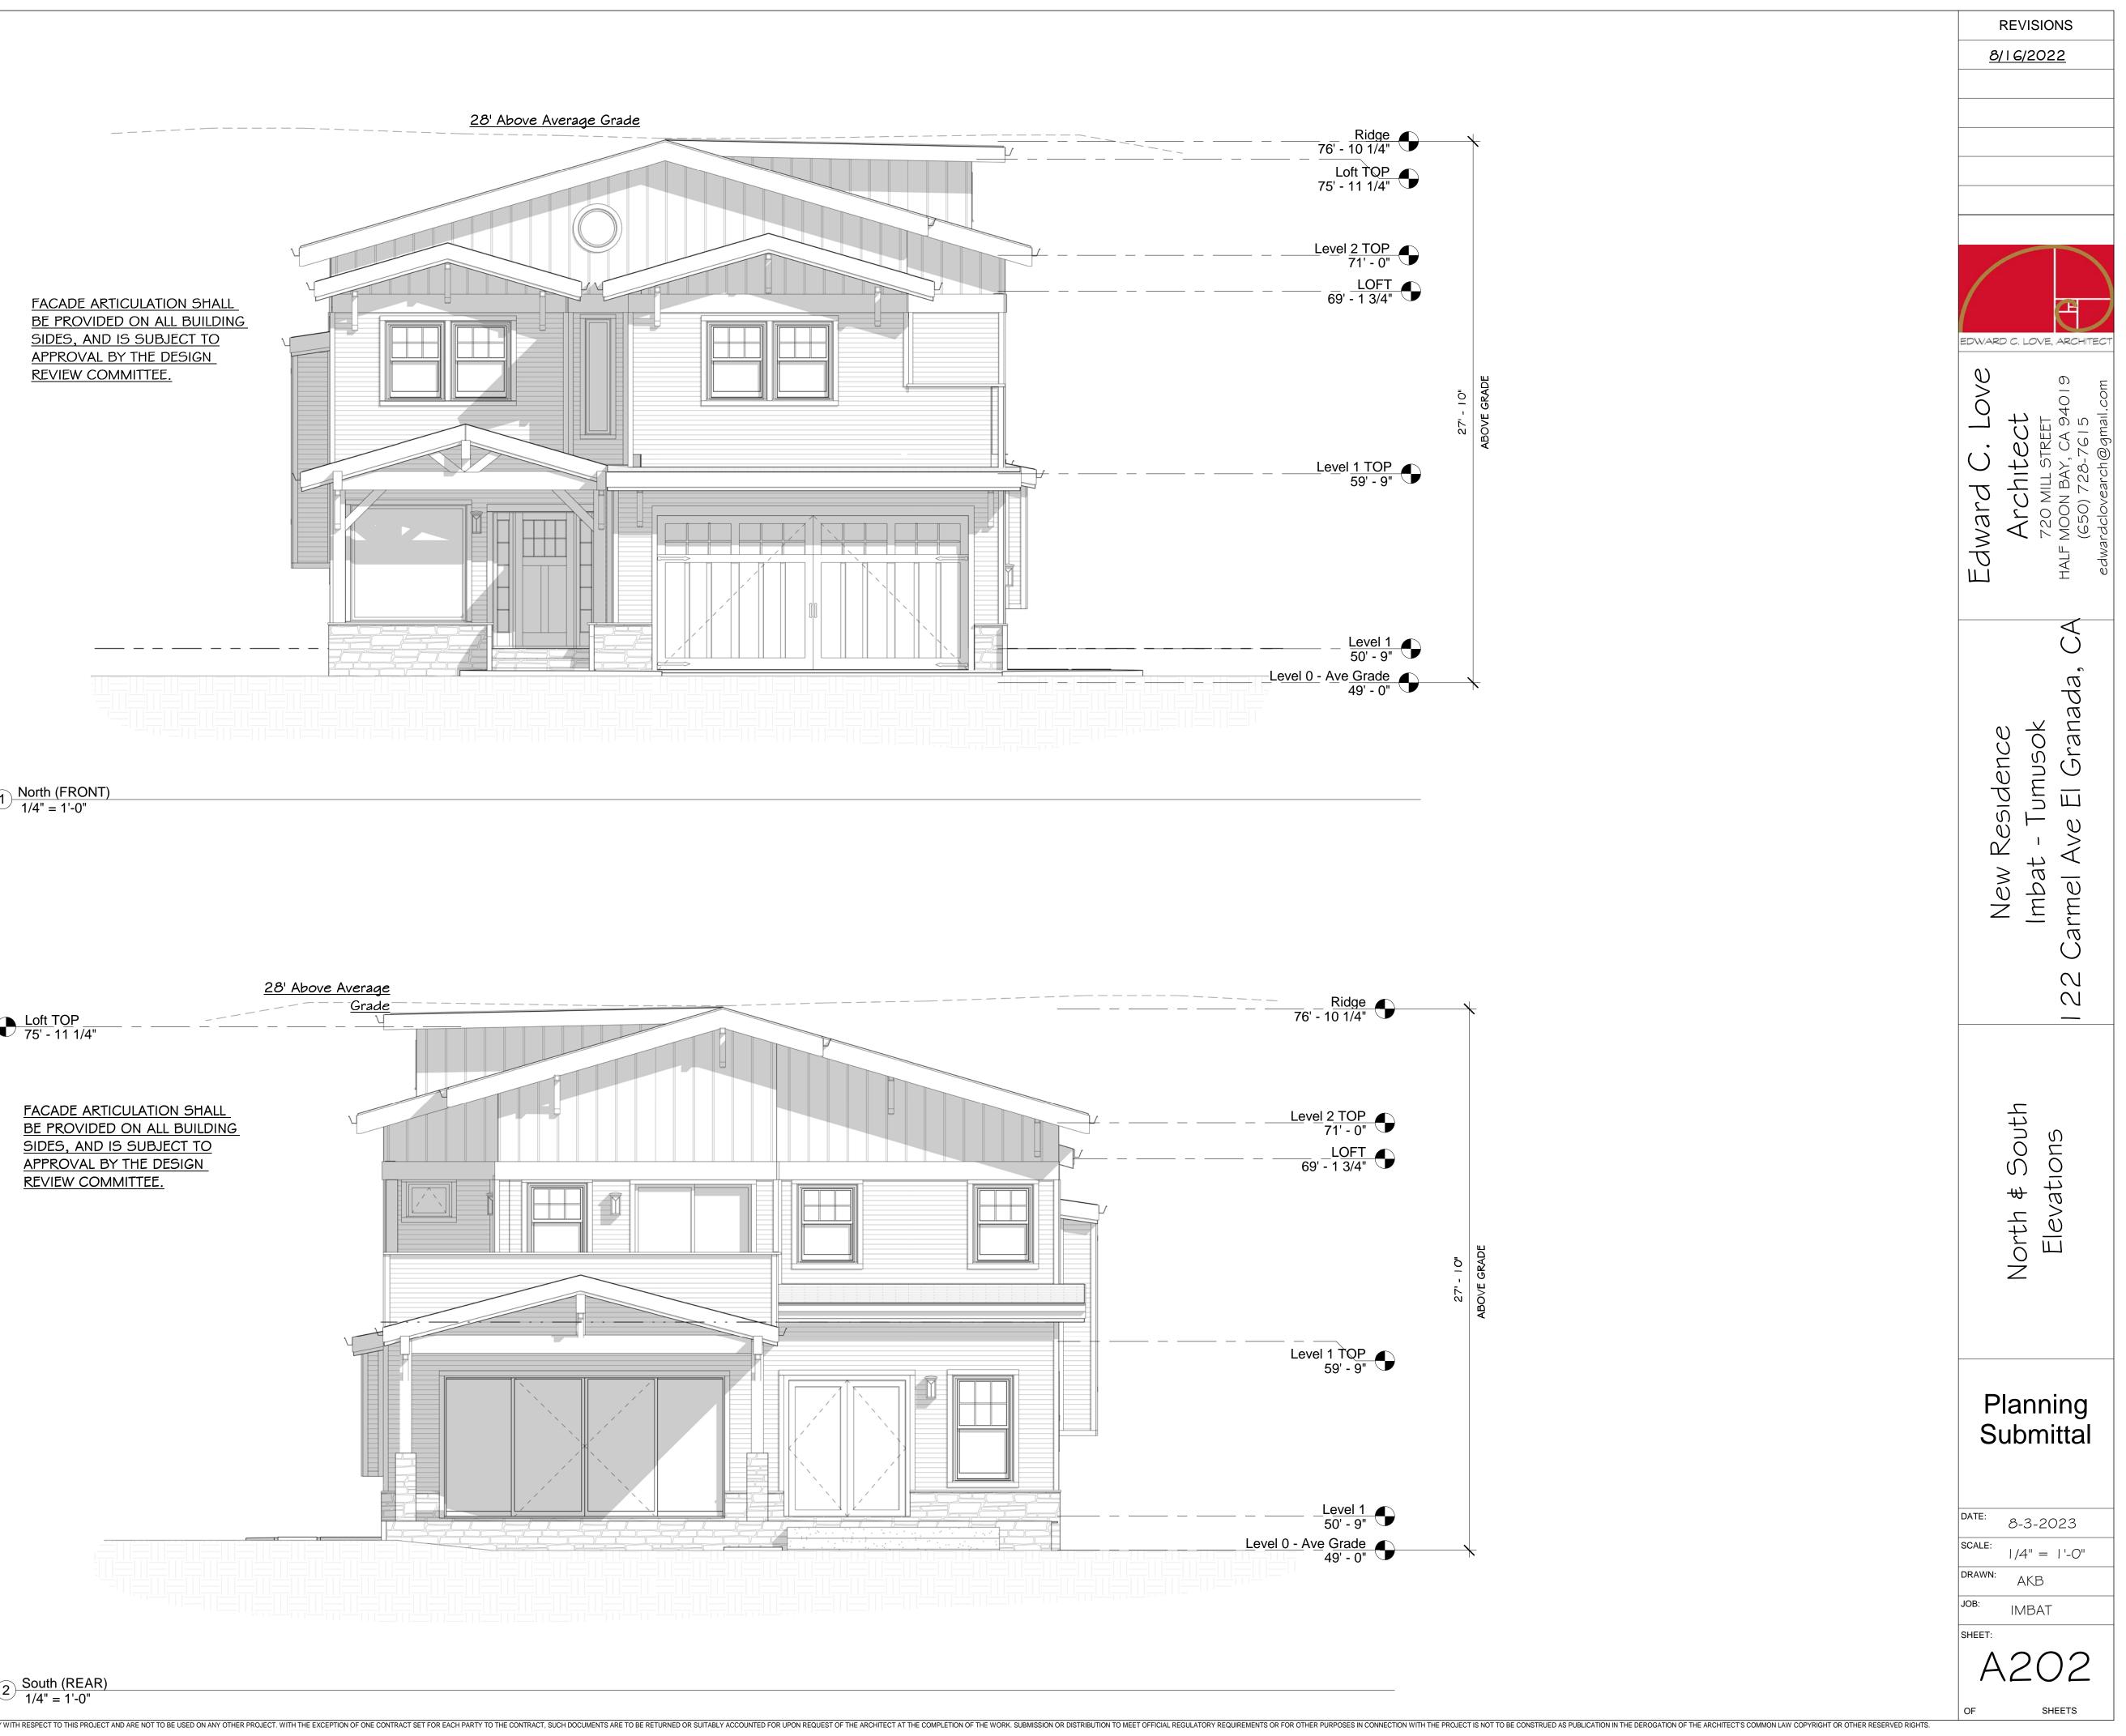

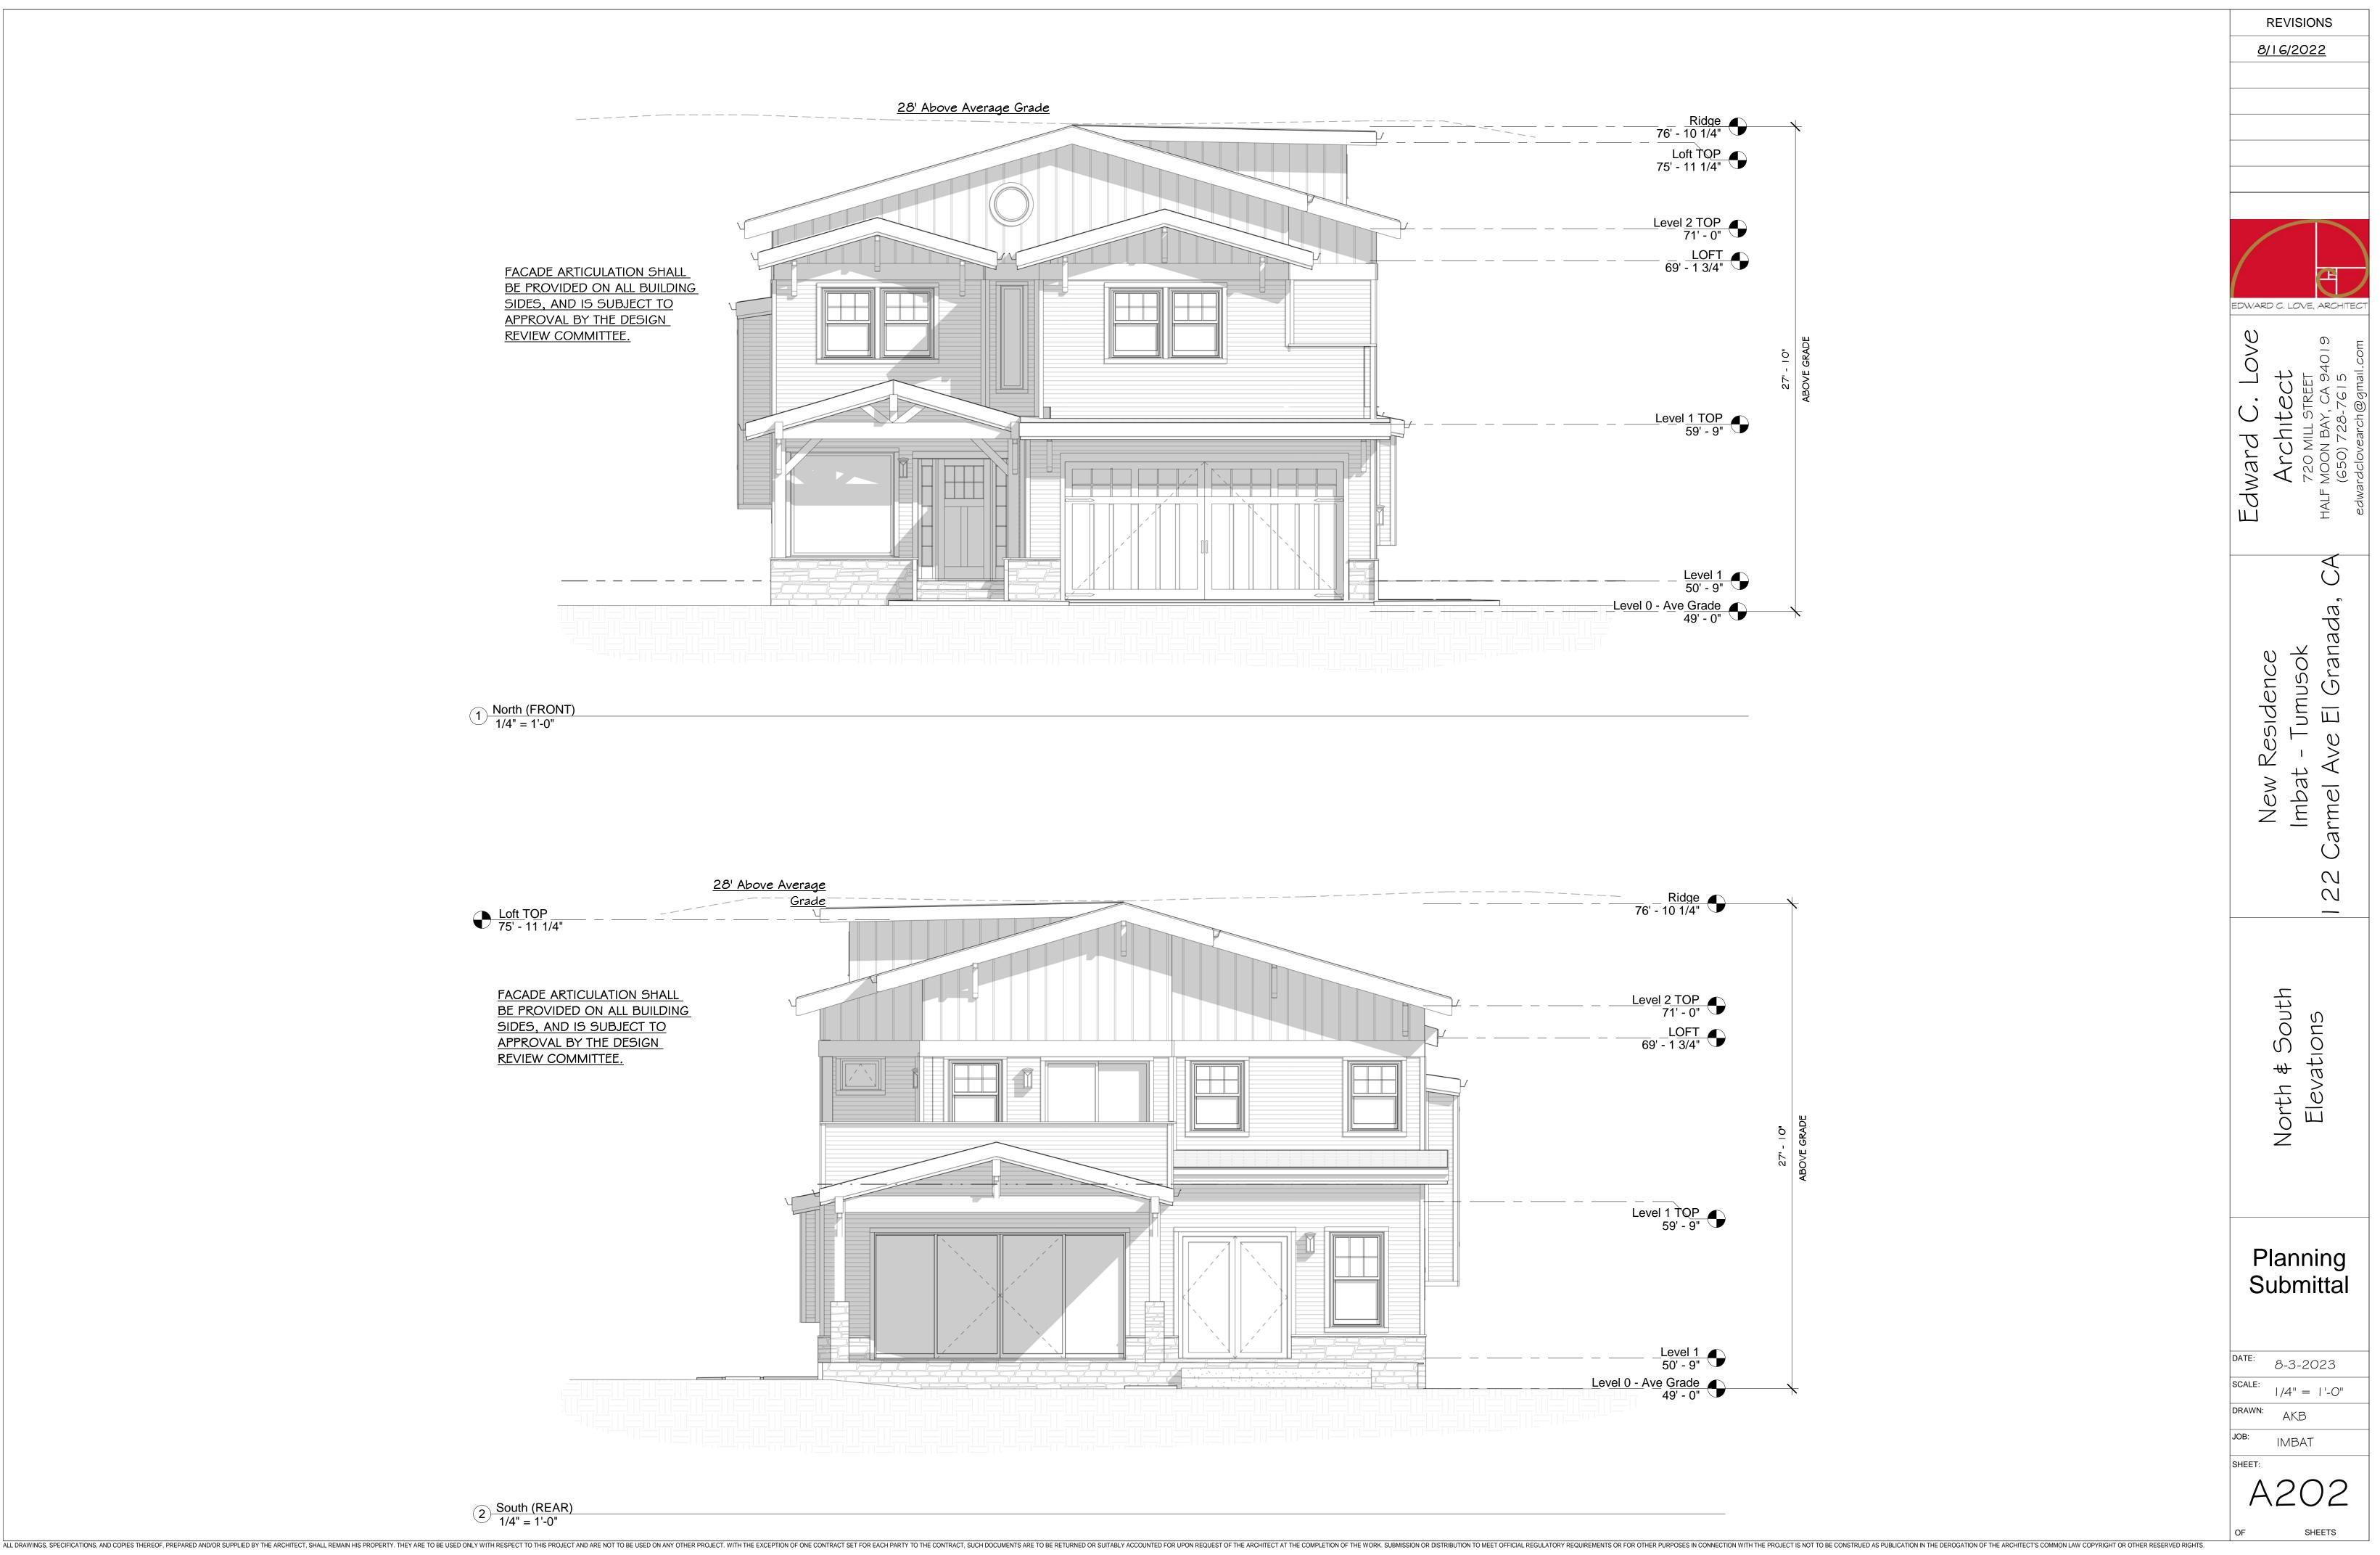








Whiskey Creek Mountain Ledge Panels





Hardıe Plank Lap Sıdıng -Sea Spray Blue




Hardie Verticle Siding -Summer White

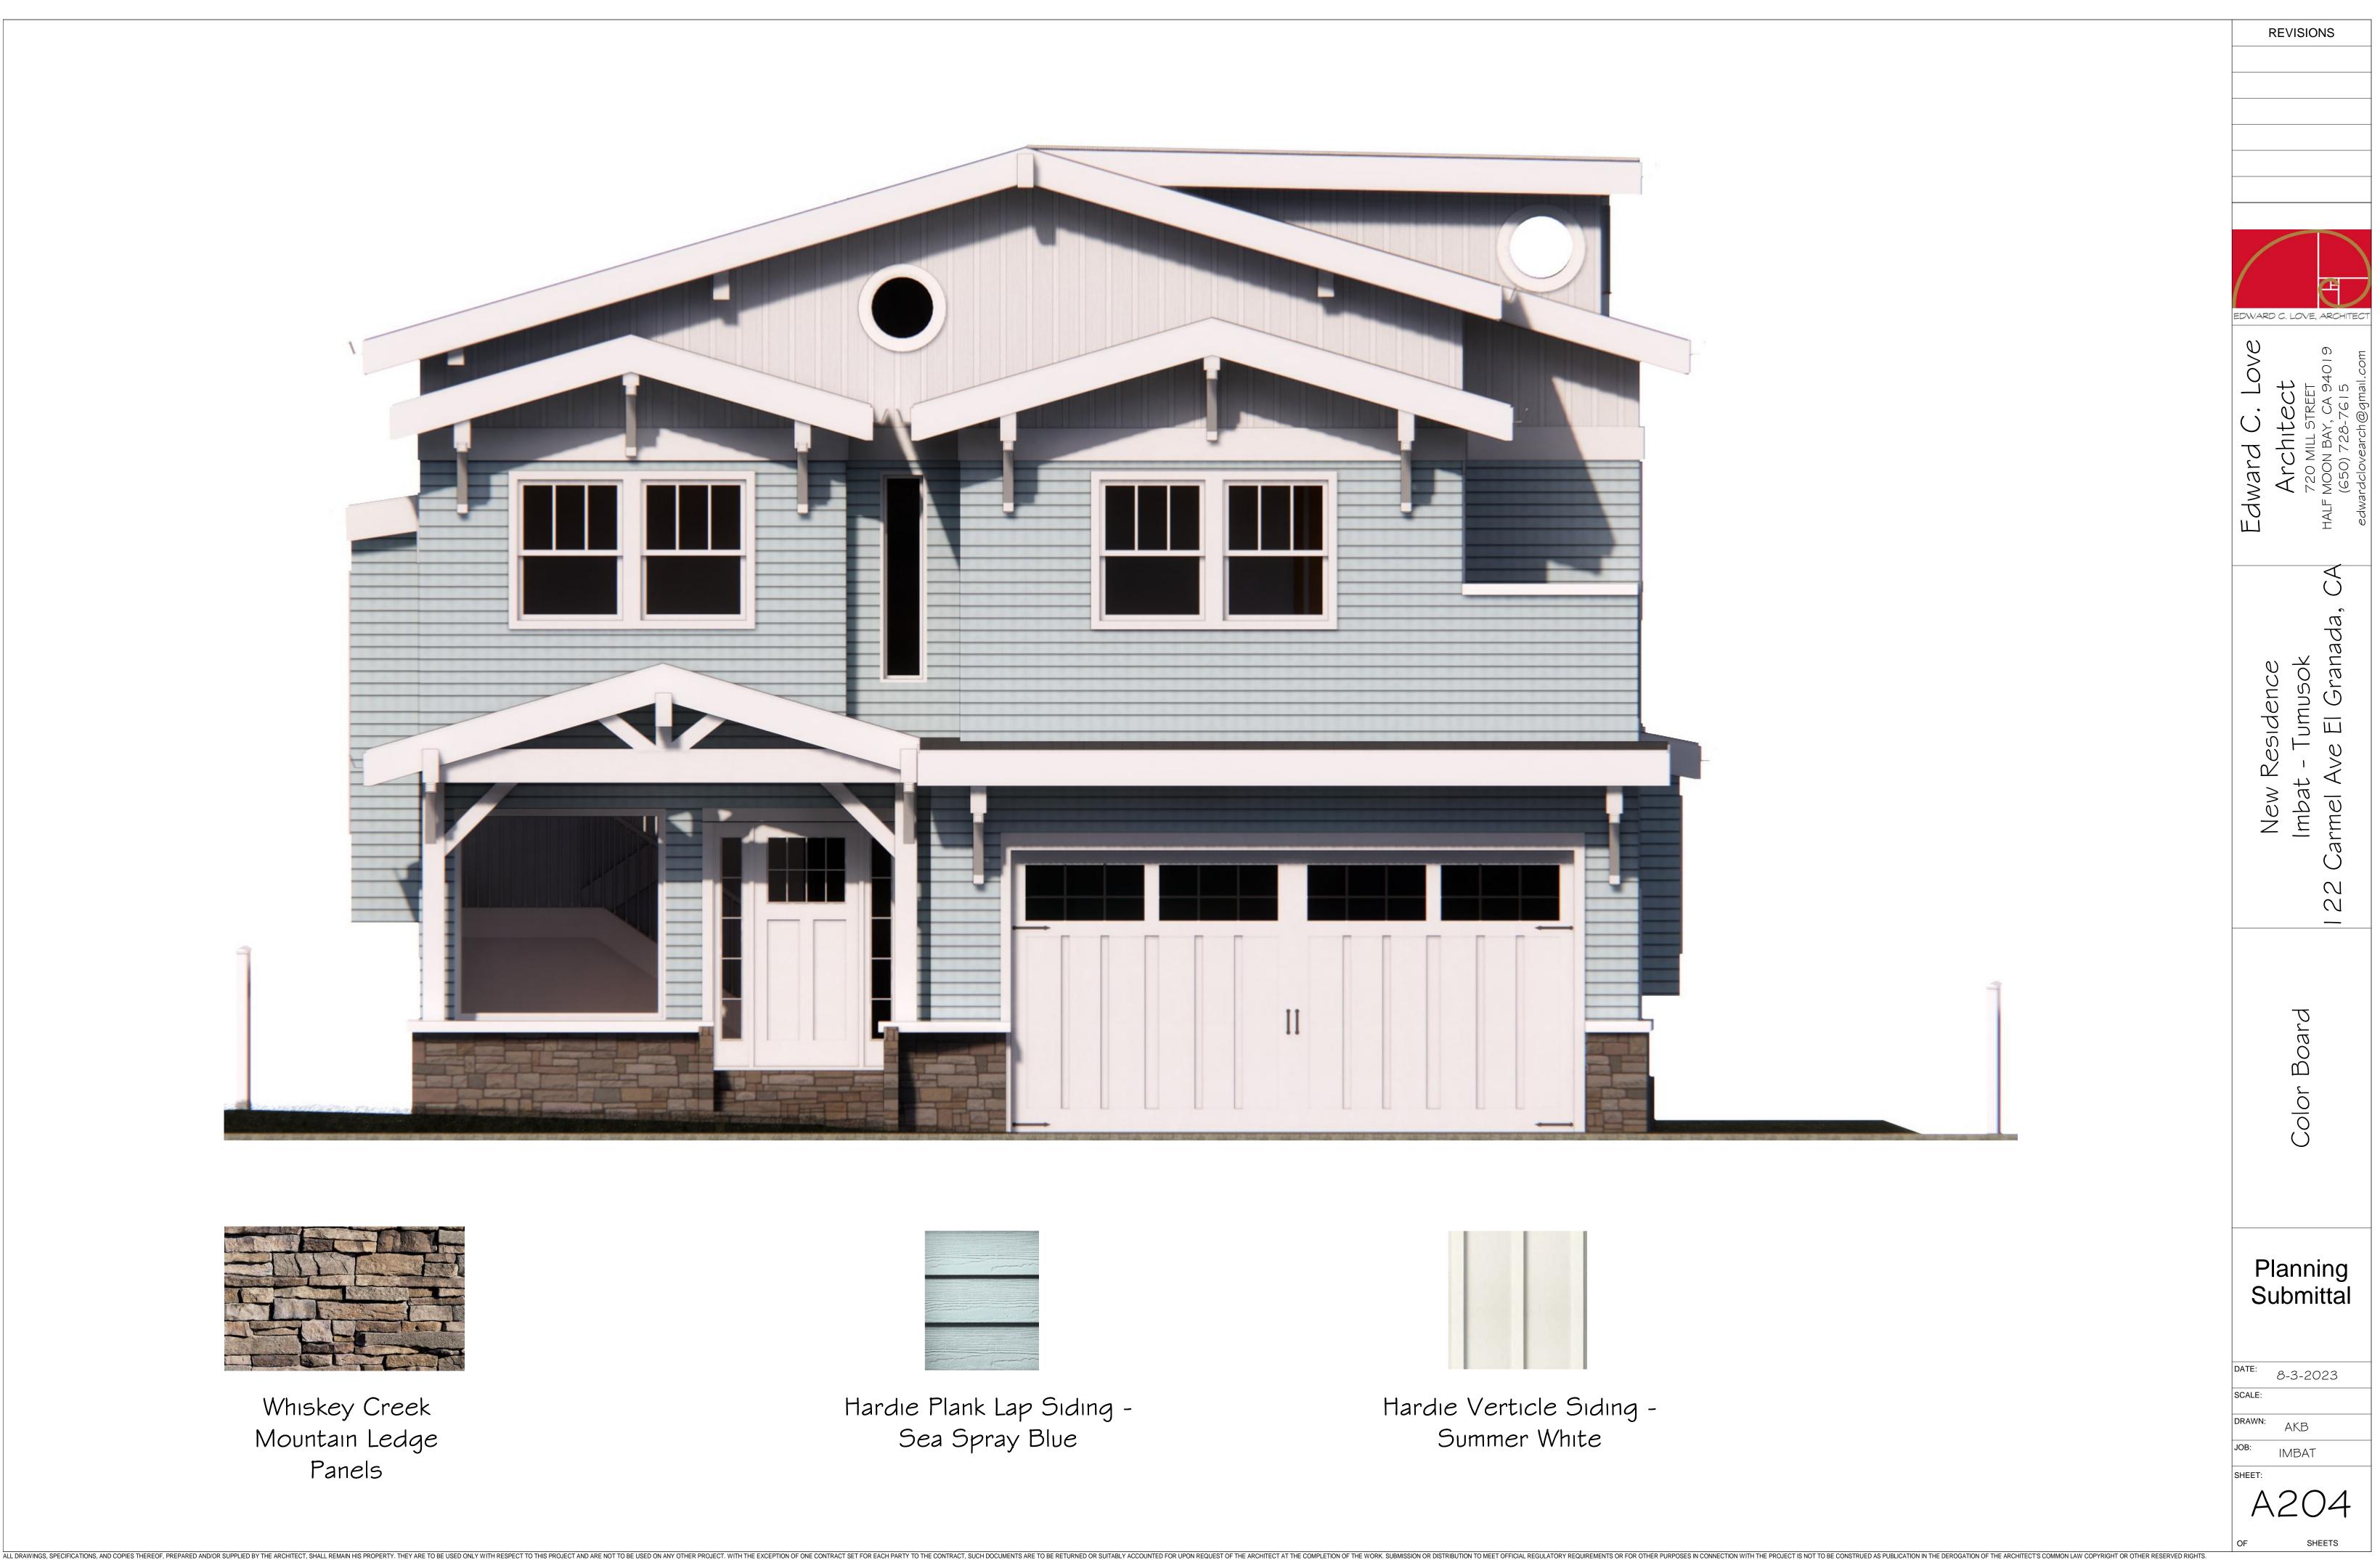


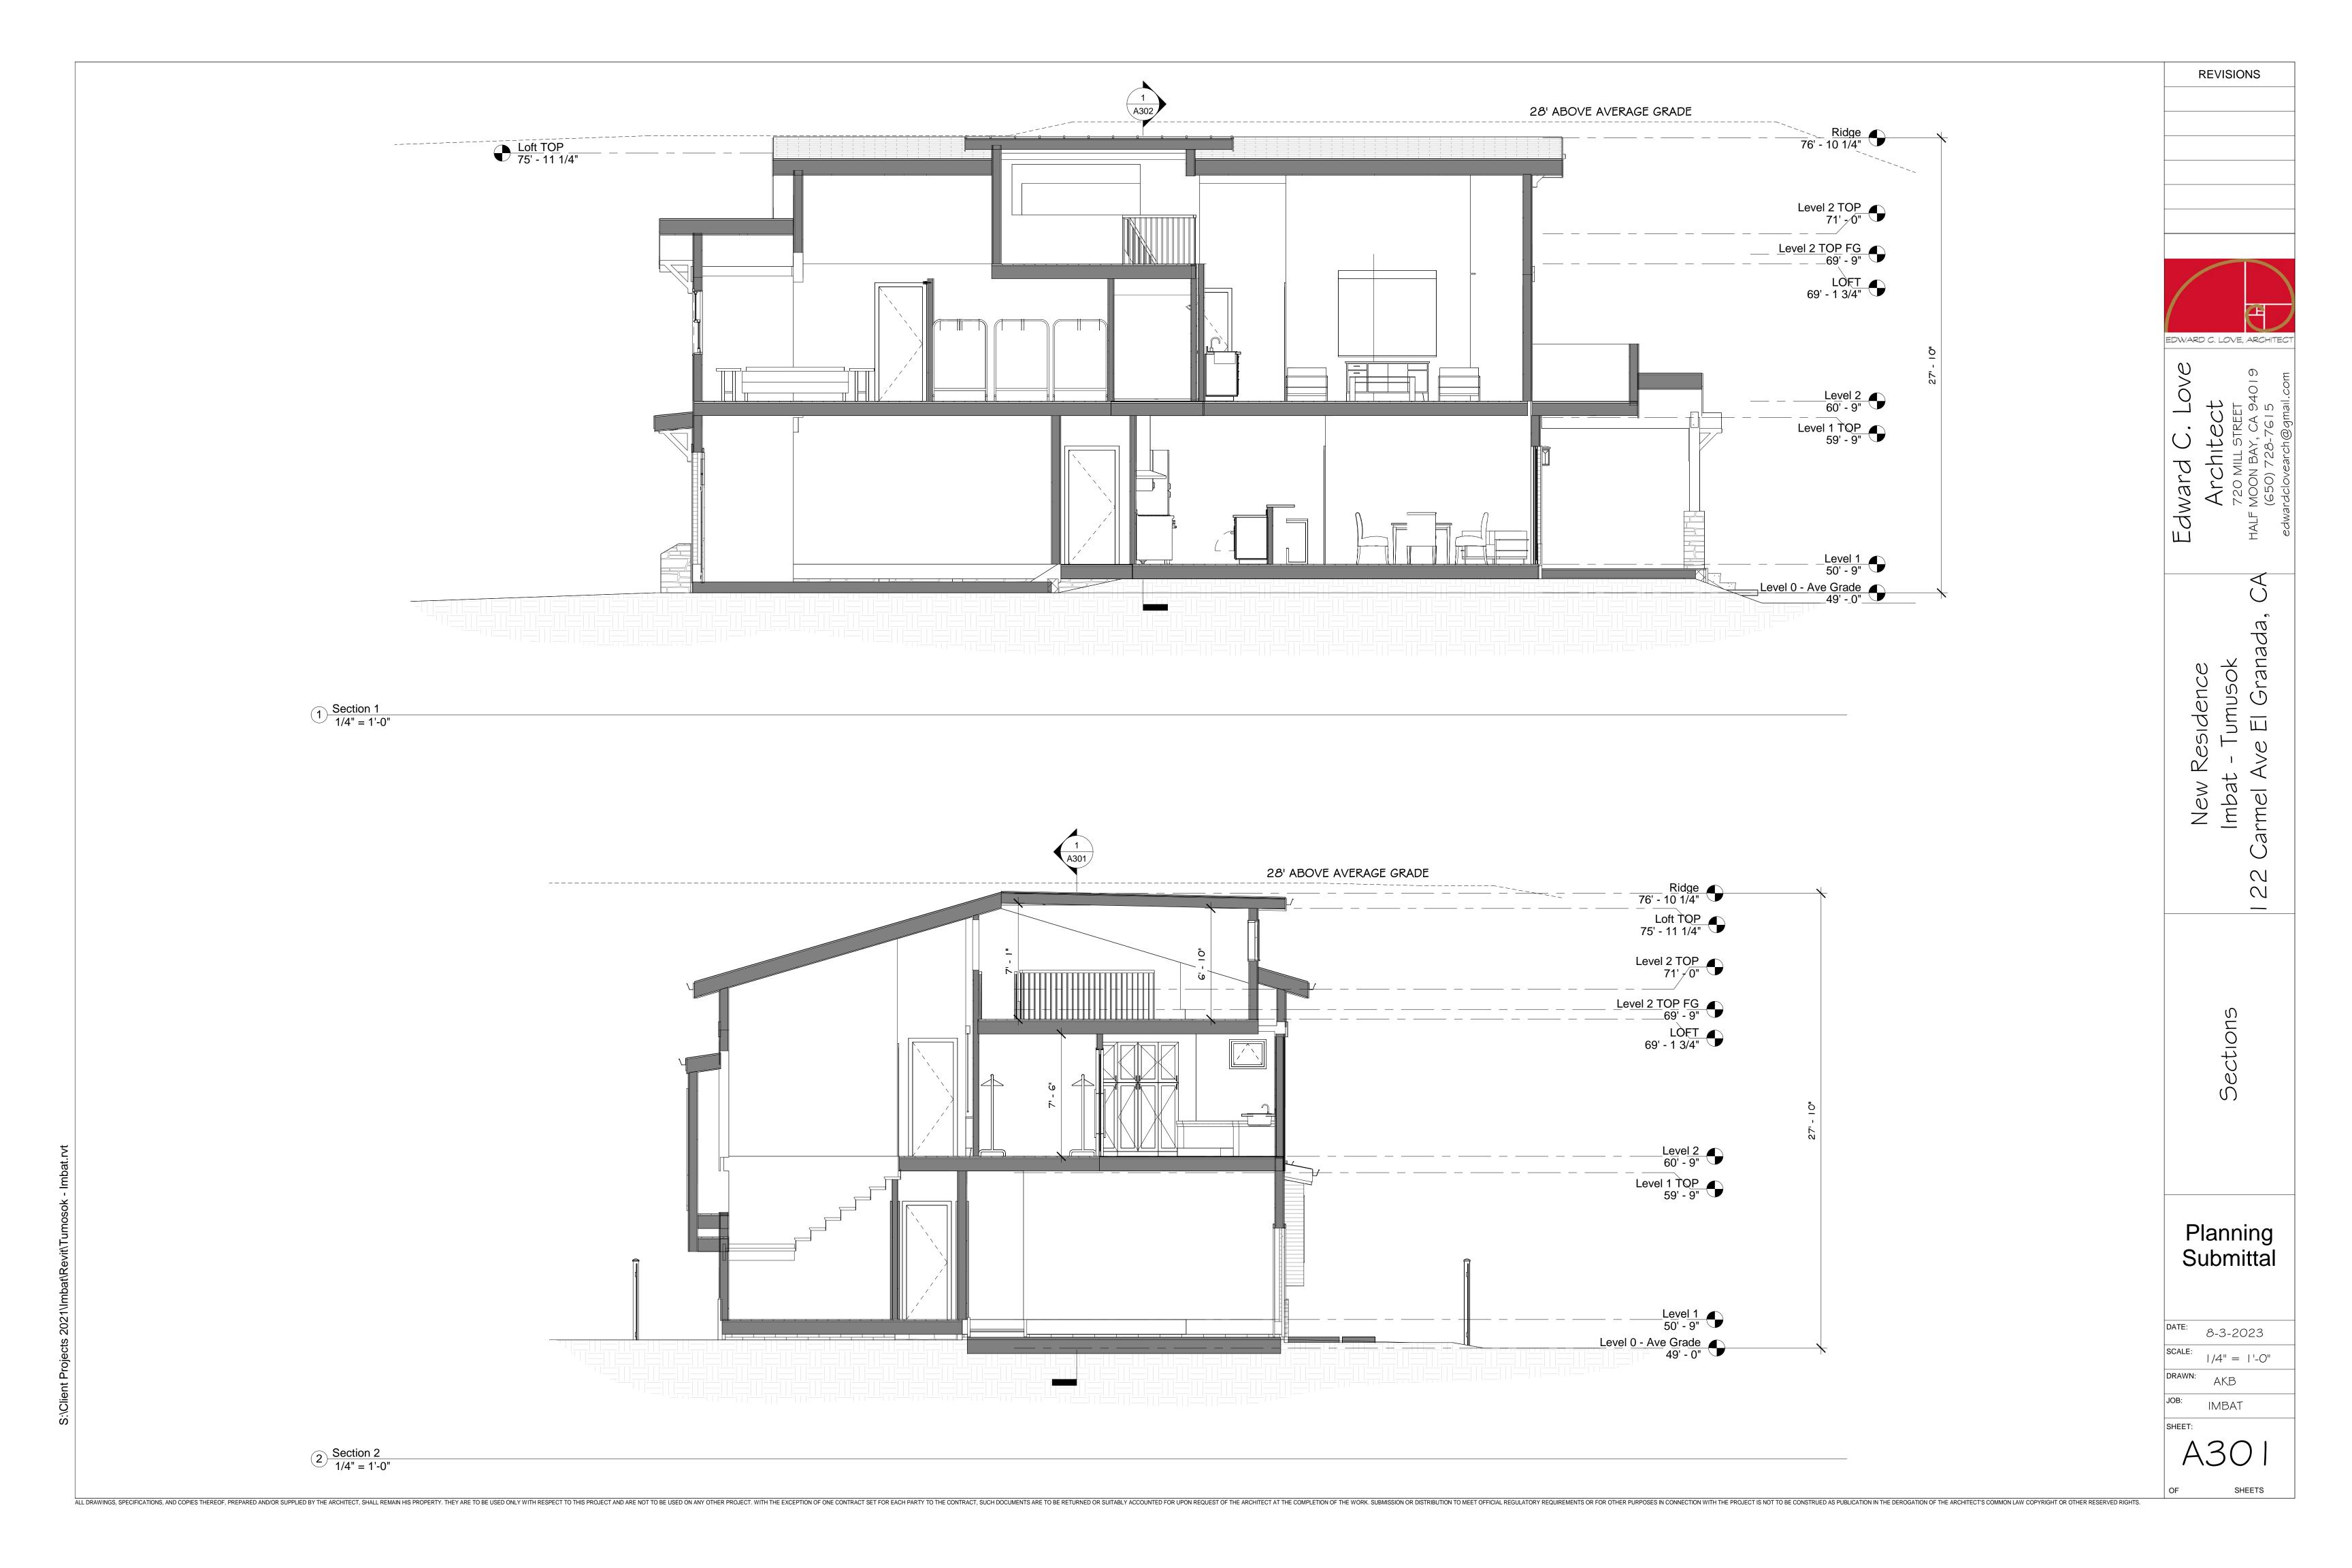

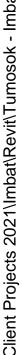


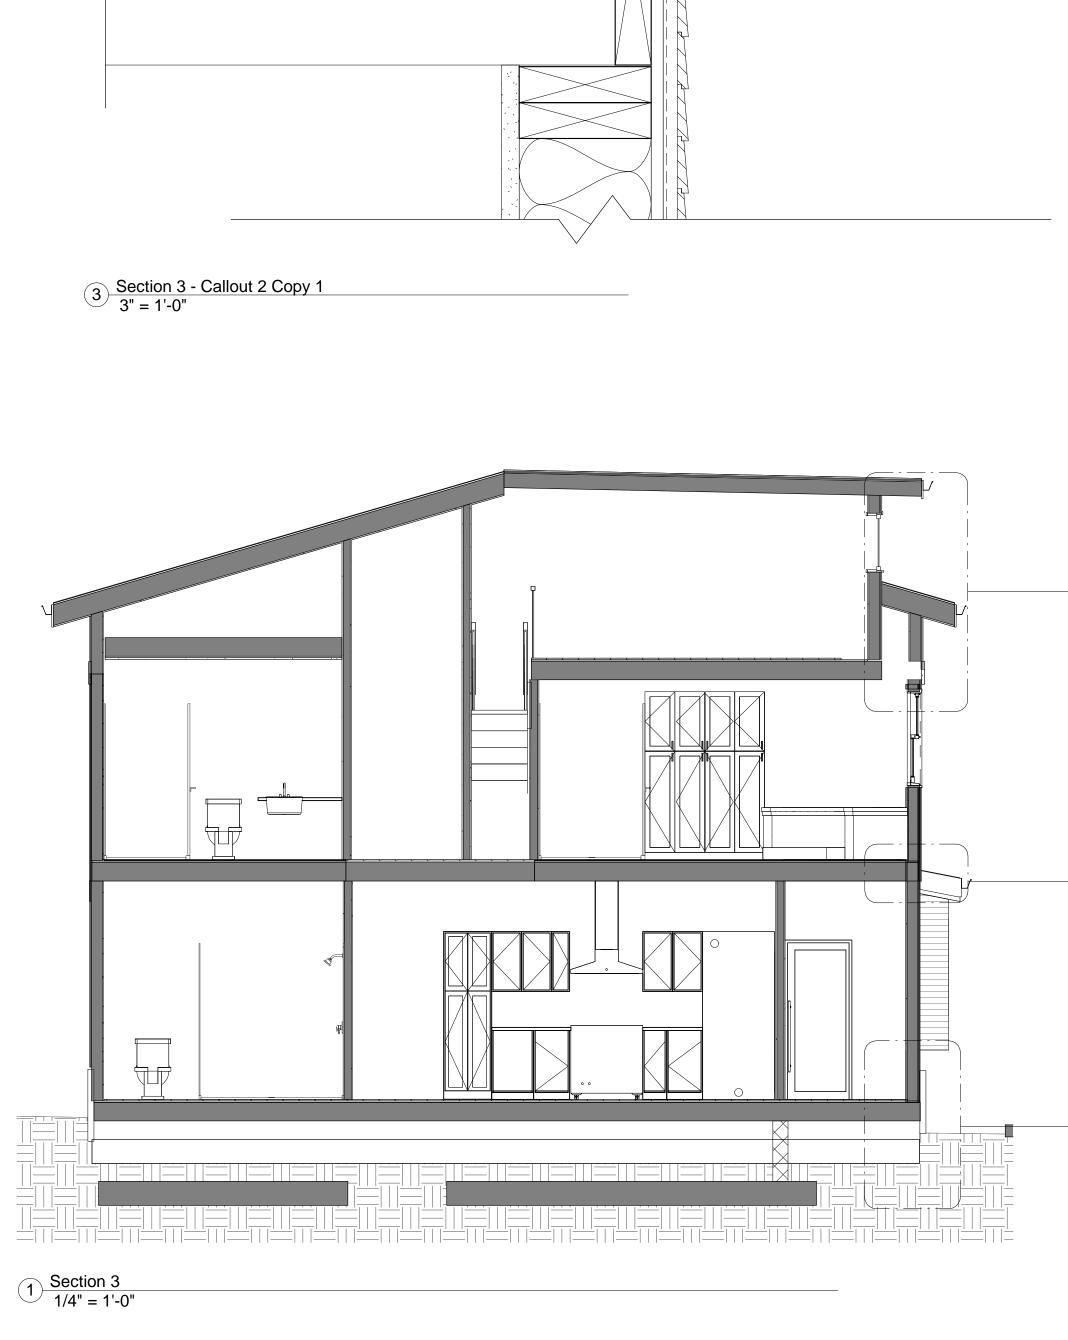


- EXTERIOR CLADDING
- (2) LAYERS WRB
- 3/4" SHEATHING
- 3/4" SHEATHING

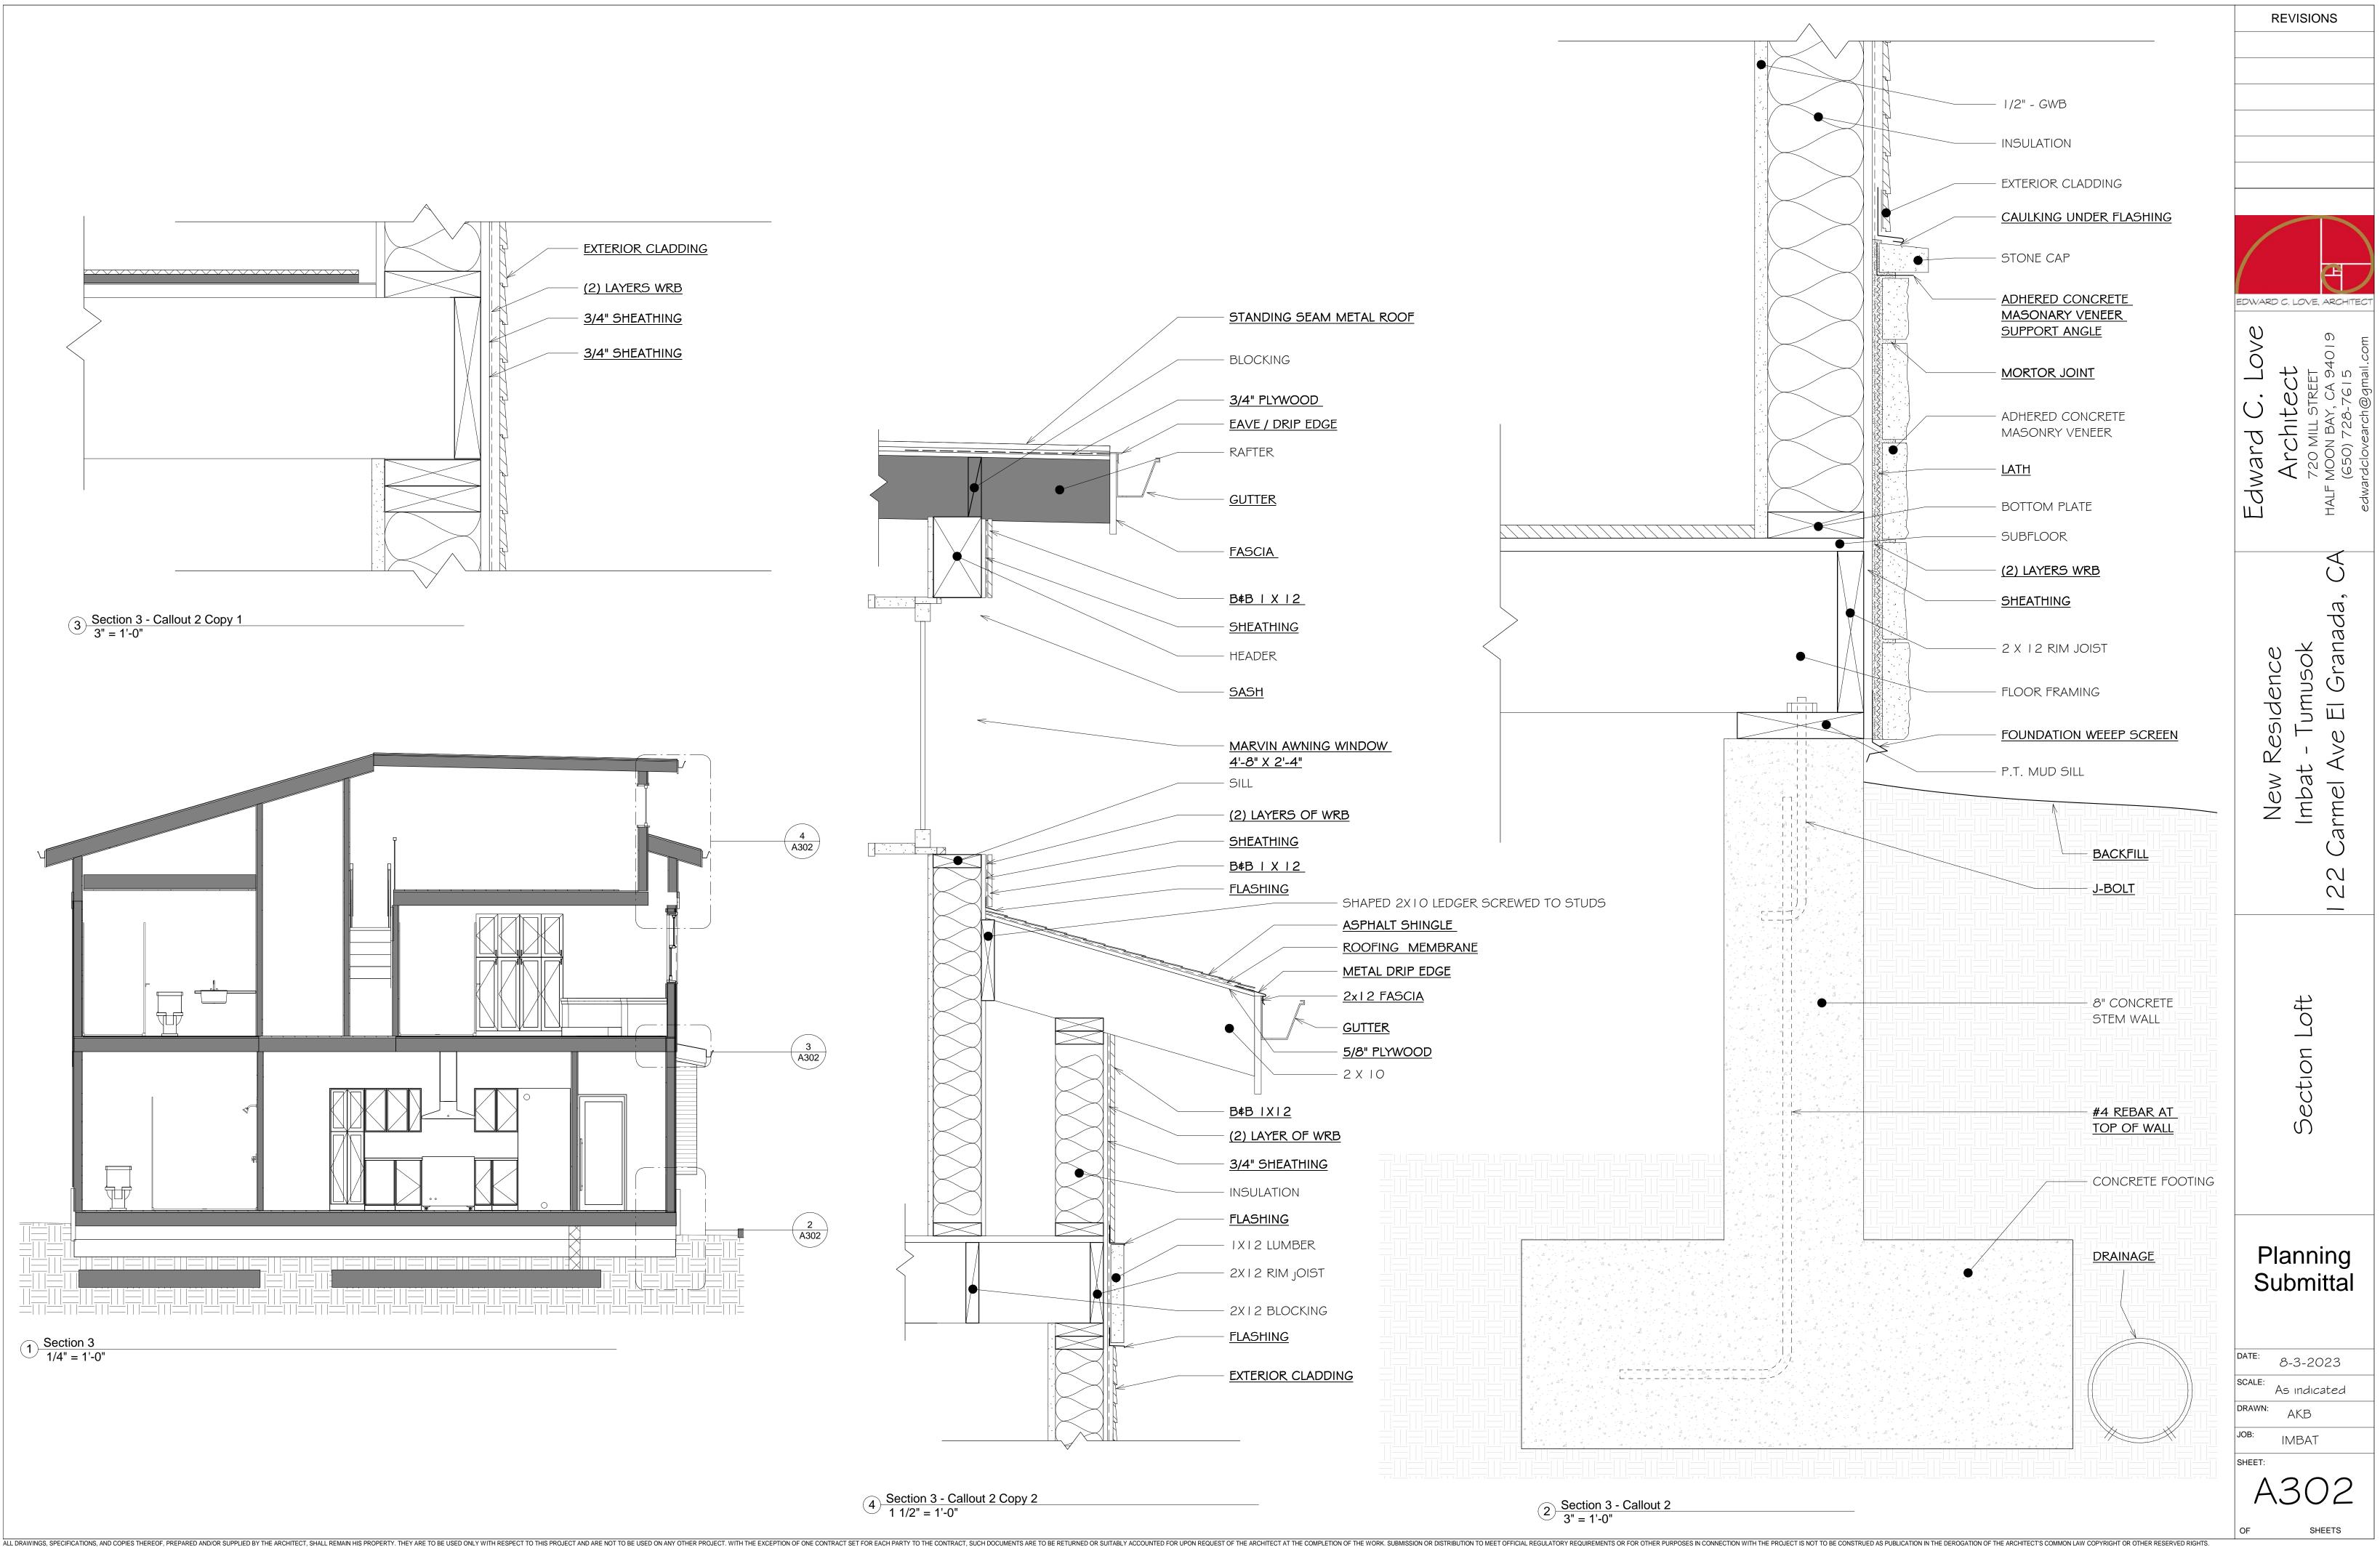



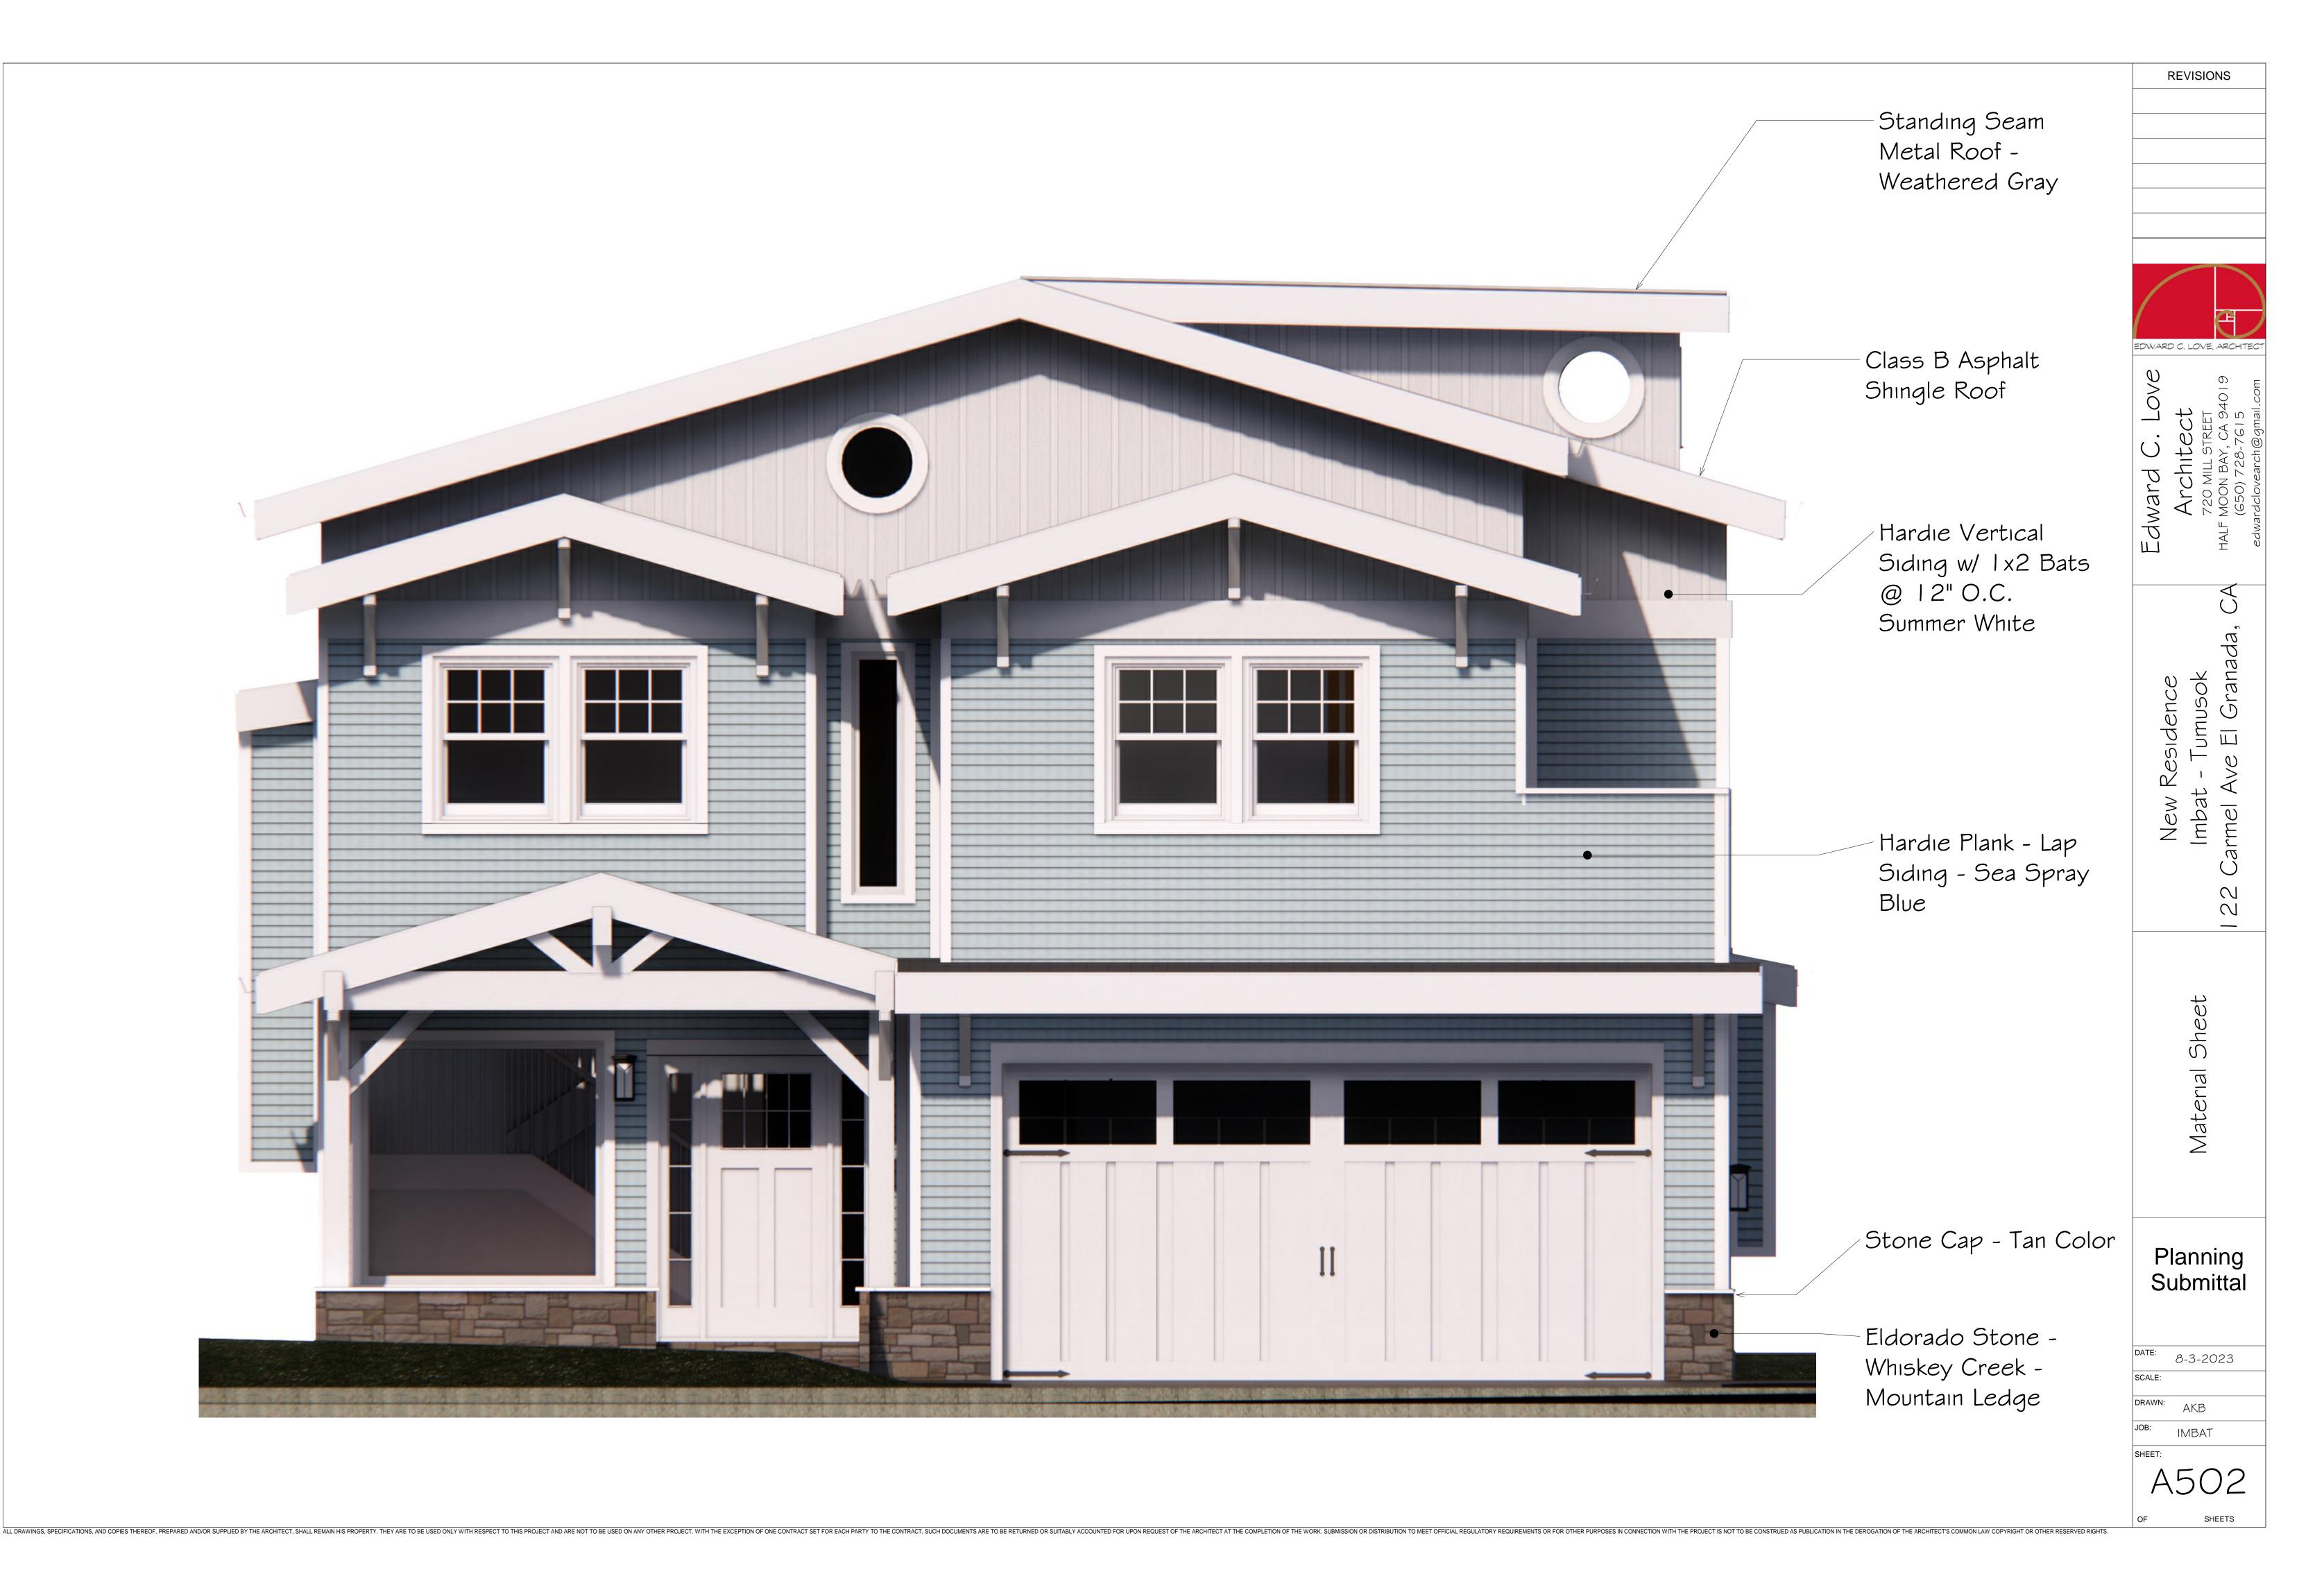

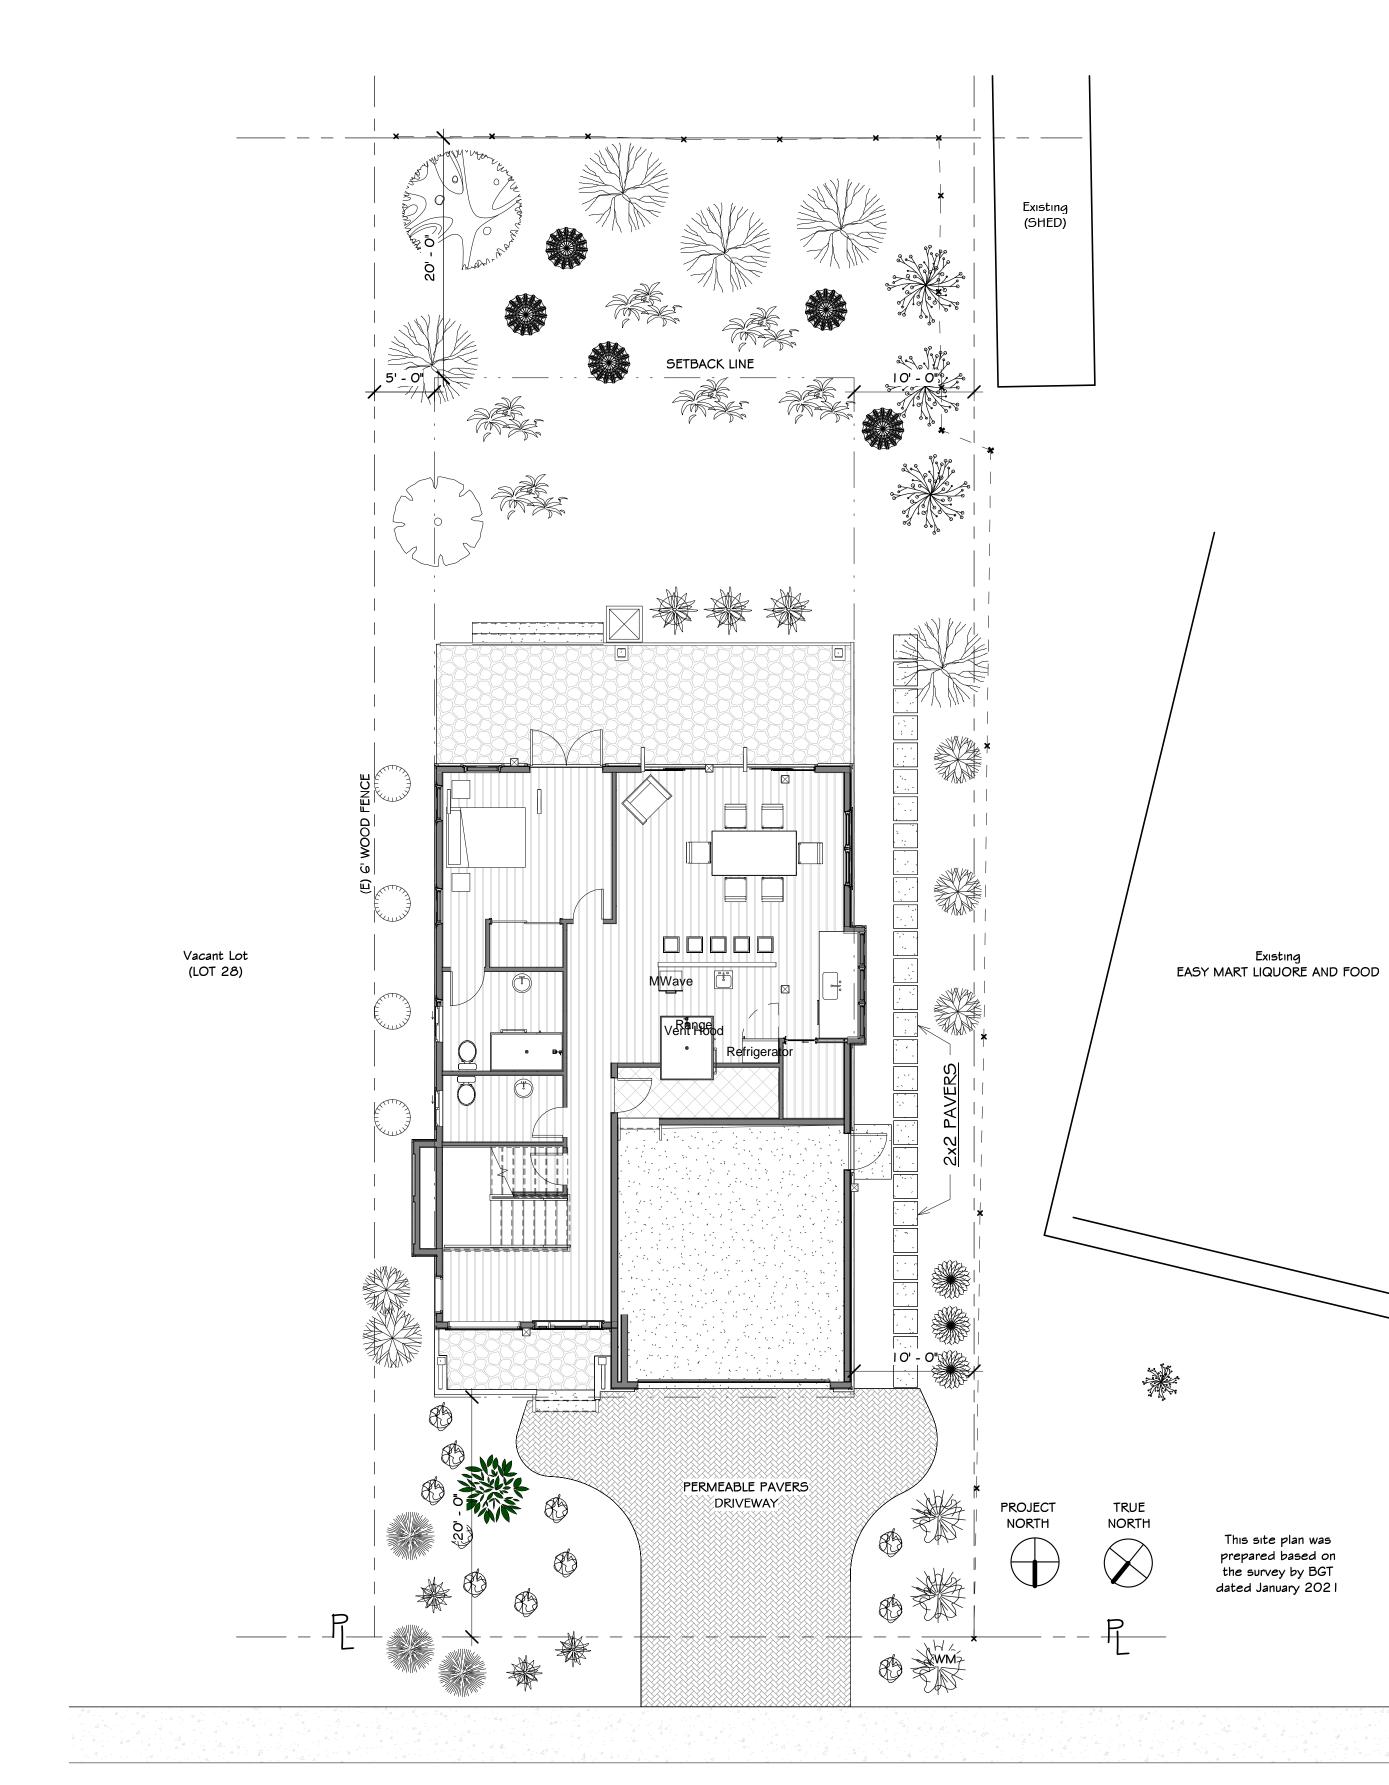

1 <u>Landscape Plan</u> 1/8" = 1'-0"

						REVISIO
MWELO Applicant:	Jerry Alan Whiting					
	FLORA FARM 340 PURISSIMA S1	Г				
	HALF MOON BAY, C		<u>4019</u>			
	<u>LIC: #549103</u> 650-678-5801					
	florafarmhmb@yahoo	o.com	<u>n</u>			
	TUMUSOK - IMBAT CARMEL AVE, EL GRANDA					EDWARD C. LOVE
	NEW DWELLING					$\langle \mathcal{O} \rangle$
THIS PROJECT DOES INCORPO AND WILL BE USING THIS FORM INCLUDED AS PART OF THE LAI	I TO IDENTIFY PRECRIPTIV					C. Lo ect
TOTAL AREA: 1,450 SQFT TURF AREA : NA						
WATER TYPE : POTABLE NAME OF WATER PURVEYOR: (CCWD					
	ATION IS CORRECT AND A	GREE T	TO COMPL	Y WITH	THE	Ar Ar
REQUIREMENTS OF MWELO.	1 Atta					
	Alletty					
SIGNATURE:			DA1	re: 9/2:	2/2	
/WELO Applicant I/4" = 1'-0"						
····						
PLANTING NOTES						
I . INCORPORATE COMPOST / OF 6" INTO THE LANDSCAPE /		CUFT	PER 1000) SQFT	to depth	
2. A MINIMUM OF A 3" LAYER		APPLIED) on all i	EXPOSF	Đ	Tumusc
SURFACES OF PLANTING, EXC	CEPT IN AREAS OF CREEPII	NG GRO	JUND CO	VER.		
3.ALL PLANTING WILL BE HANI	DWATERED					L S C
I AGREE TO COMPLY WITH TH	e requirements of per:	SCRIPT		PLIANCE		New
OF MWELO PER APPENDIX D				_		
)	Allthey					
Signature:	V		Da	ate: 9/2	22/2021	
Planting Notes 1/4" = 1'-0"						
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	с н		G	14.4		
Plant List	Common Name Peppermint Tree		<u>/ Size</u>		Plant Tvpe Tree	Plan
		'	15 gal	L	1 1166	
C Arbutus 'Manna'						1
site .	Strawberry Tree	1	I5 gal		Tree	
	Strawberry Tree Anchor Bay Ceanothus	8				
Leptospermum	Anchor Bay	 8 6	I5 gal		Tree	
	Anchor Bay Ceanothus		l 5 gal	L	Tree Gr. Cover	
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Leptospermum laevigatum Nandina domestica	Anchor Bay Ceanothus Australian Tea Tree Heavenly Bamboo	6	l 5 gal I gal 5 gal I 5 gal		Tree Gr. Cover Shrub Shrub	Landscape
 Leptospermum laevigatum Nandina domestica Ceanothus 'Julia Phelpe 	Anchor Bay Ceanothus Australian Tea Tree Heavenly Bamboo	6	l 5 gal I gal 5 gal I 5 gal 5 gal		Tree Gr. Cover Shrub Shrub Shrub	
 Leptospermum laevigatum Nandina domestica Ceanothus 'Julia Phelpe Garrya elliptica 	Anchor Bay Ceanothus Australian Tea Tree Heavenly Bamboo California Lilac Silk Tassel Coast Rosemary	6 3 1	I 5 gal I gal 5 gal I 5 gal 5 gal I 5 gal		Tree Gr. Cover Shrub Shrub Shrub Shrub	
 Leptospermum laevigatum Nandina domestica Ceanothus 'Julia Phelpe Garrya elliptica Westringia fruticosa Ceanothus 'Ray Hartma 	Anchor Bay Ceanothus Australian Tea Tree Heavenly Bamboo California Lilac Silk Tassel Coast Rosemary California Lilac Australlian Blue	6 3 1 1 6	I 5 gal I gal 5 gal I 5 gal 5 gal I 5 gal 5 gal		Tree Gr. Cover Shrub Shrub Shrub Shrub Shrub	Landscape
Image: Second	Anchor Bay Ceanothus Australian Tea Tree Heavenly Bamboo California Lilac Silk Tassel Coast Rosemary California Lilac California Lilac Australlian Blue Bell	6 3 1 1 6 5	5 gal gal 5 gal 5 gal 5 gal 5 gal 5 gal 5 gal 1 gal		Tree Gr. Cover Shrub Shrub Shrub Shrub Shrub Shrub Shrub Shrub	Landscape
Image: Second	Anchor Bay Ceanothus Australian Tea Tree Heavenly Bamboo California Lilac Silk Tassel Coast Rosemary California Lilac Australlian Blue Bell Shiny Xylosma	6 3 1 1 6 5 11 3	5 gal gal 5 gal 5 gal 5 gal 5 gal 5 gal 1 gal 5 gal		Tree Gr. Cover Shrub Shrub Shrub Shrub Shrub Shrub Shrub Shrub Shrub	Landscape
Image: Second	Anchor Bay Ceanothus Australian Tea Tree Heavenly Bamboo California Lilac Silk Tassel Coast Rosemary California Lilac Australlian Blue Bell Shiny Xylosma Purple Hopseed Bush	6 3 1 1 6 5 11 3 3	5 gal gal 5 gal 5 gal 5 gal 5 gal 5 gal 1 gal 5 gal 5 gal		Tree Gr. Cover Shrub Shrub Shrub Shrub Shrub Shrub Shrub Shrub Shrub	Landscape
Image: Second	Anchor Bay Ceanothus Australian Tea Tree Heavenly Bamboo California Lilac Silk Tassel Coast Rosemary California Lilac Coast Rosemary California Lilac Australlian Blue Bell Shiny Xylosma Purple Hopseed Bush Orange Bulbine	6 3 1 1 6 5 11 3 3 3 5	5 gal gal 5 gal 5 gal 5 gal 5 gal 5 gal 1 gal 5 gal 1 gal 1 gal		Tree Gr. Cover Shrub Shrub Shrub Shrub Shrub Shrub Shrub Shrub Shrub Shrub Gr. Cover	Plann Subm
Image: Second	Anchor Bay Ceanothus Australian Tea Tree Heavenly Bamboo California Lilac Silk Tassel Coast Rosemary California Lilac Australlian Blue Bell Shiny Xylosma Purple Hopseed Bush	6 3 1 1 6 5 11 3 3 3 5	5 gal gal 5 gal 5 gal 5 gal 5 gal 5 gal 1 gal 5 gal 5 gal		Tree Gr. Cover Shrub Shrub Shrub Shrub Shrub Shrub Shrub Shrub Shrub	DATE: 8-3-20 SCALE: As indic
Image: Second	Anchor Bay Ceanothus Australian Tea Tree Heavenly Bamboo California Lilac Silk Tassel Coast Rosemary California Lilac Coast Rosemary California Lilac Australlian Blue Bell Shiny Xylosma Purple Hopseed Bush Orange Bulbine	6 3 1 1 6 5 11 3 3 3 5	5 gal gal 5 gal 5 gal 5 gal 5 gal 5 gal 1 gal 5 gal 1 gal 1 gal		Tree Gr. Cover Shrub Shrub Shrub Shrub Shrub Shrub Shrub Shrub Shrub Shrub Gr. Cover	DATE: 8-3-20
Image: Second	Anchor Bay Ceanothus Australian Tea Tree Heavenly Bamboo California Lilac Silk Tassel Coast Rosemary California Lilac Coast Rosemary California Lilac Australlian Blue Bell Shiny Xylosma Purple Hopseed Bush Orange Bulbine	6 3 1 1 6 5 11 3 3 3 5	5 gal gal 5 gal 5 gal 5 gal 5 gal 5 gal 1 gal 5 gal 1 gal 1 gal		Tree Gr. Cover Shrub Shrub Shrub Shrub Shrub Shrub Shrub Shrub Shrub Shrub Gr. Cover	DATE: 8-3-20 SCALE: As Indic DRAWN: AKB
Image: Second secon	Anchor Bay Ceanothus Australian Tea Tree Heavenly Bamboo California Lilac Silk Tassel Coast Rosemary California Lilac Coast Rosemary California Lilac Australlian Blue Bell Shiny Xylosma Purple Hopseed Bush Orange Bulbine	6 3 1 1 6 5 11 3 3 3 5	5 gal gal 5 gal 5 gal 5 gal 5 gal 5 gal 1 gal 5 gal 1 gal 1 gal		Tree Gr. Cover Shrub Shrub Shrub Shrub Shrub Shrub Shrub Shrub Shrub Shrub Gr. Cover	DATE: 8-3-20 SCALE: As Indic DRAWN: AKB
Image: Second secon	Anchor Bay Ceanothus Australian Tea Tree Heavenly Bamboo California Lilac Silk Tassel Coast Rosemary California Lilac Coast Rosemary California Lilac Australlian Blue Bell Shiny Xylosma Purple Hopseed Bush Orange Bulbine	6 3 1 1 6 5 11 3 3 3 5	5 gal gal 5 gal 5 gal 5 gal 5 gal 5 gal 1 gal 5 gal 1 gal 1 gal		Tree Gr. Cover Shrub Shrub Shrub Shrub Shrub Shrub Shrub Shrub Shrub Shrub Gr. Cover	DATE: 8-3-20 SCALE: As India DRAWN: AKB JOB: IMBAT
Image: Second	Anchor Bay Ceanothus Australian Tea Tree Heavenly Bamboo California Lilac Silk Tassel Coast Rosemary California Lilac Coast Rosemary California Lilac Australlian Blue Bell Shiny Xylosma Purple Hopseed Bush Orange Bulbine	6 3 1 1 6 5 11 3 3 3 5	5 gal gal 5 gal 5 gal 5 gal 5 gal 5 gal 1 gal 5 gal 1 gal 1 gal		Tree Gr. Cover Shrub Shrub Shrub Shrub Shrub Shrub Shrub Shrub Shrub Shrub Gr. Cover	DATE: 8-3-20 SCALE: As India DRAWN: AKB JOB: IMBAT

	<u>Plant List</u>	<u>Common Name</u>	<u>Qty</u>	<u>Sıze</u>	<u>WI</u>	<u>F</u>
Ð	Agonı Flexuosa	Peppermint Tree	Ι	15 gal	L	1
	Arbutus 'Manna'	Strawberry Tree	I	15 gal	L	
××	Ceanothus Gloriosus	Anchor Bay Ceanothus	8	l gal	L	
	Leptospermum —laevigatum———————	Australian Tea Tree	6	5 gal	L	
ALL	Nandına domestica	Heavenly Bamboo	3	15 gal	L	
	Ceanothus 'Julia Phelps'	California Lilac	I	5 gal	L	
鱳	Garrya elliptica	Silk Tassel	I	15 gal	L	
	Westringia fruticosa	Coast Rosemary	9	5 gal	L	
	Ceanothus 'Ray Hartman'	California Lilac	5	5 gal	L	
Ø	Billardiera heterophylla	Australlian Blue _Bell	11	l gal	L	
	Shiny Concestom	Shiny -Xylosma	3	5 gal	L	
	Dodonaea viscosa	Purple Hopseed	з	5 gal	L	
	Bulbine frutescens	Orange Bulbine	5	l gal	L	
*	Adenanthos sericeus	Coastal Wholly Bush	3	5 gal	L	

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