JENSEN RESIDENCE

SAN CARLOS AVE. EL GRANADA, CA 94019



SAN MATEO COUNTY

R-1/S-17/DR/CD

047-056-020

VICINITY MAP

LAND USE DATA

PLANNING DEPT. INFO:

OWNER:

WENDY AND ADAM JENSEN

121 BRIDGEPORT DR.

RESIDENCE

JENSE

DRAINAGE / WATER DISTRICT

Contractor shall notify the Designer of any on-site

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to be constructed as per plans.

water proofing of proposed structure

DATE: DECEMBER 21, 2022

COVER SHEET /

PROJECT DATA

discrepancies or conflicts that do not allow the building

 $\stackrel{\frown}{1}$ COMMENTS 10-26-22

 $\frac{2}{2}$ 12-21-22

HALF MOON BAY,CA

UNCOVERED

- STAIRS

COUNTS TOWARDS LOT COVERAGE

COVERED

COUNTS TOWARDS

FLOOR AREA AND LOT COVERAGE

∕ PORCH

-WALKWAYS OVER 18" ABOVE (E) F.G.

COUNTS TOWARDS LOT COVERAGE

STREET PERSPECTIVE

NOT TO SCALE

NEW SINGLE FAMILY RESIDENCE. PROPOSED RESIDENCE TO CONSIST OF (3) BEDROOMS AND (2) BATHROOMS AND (2) CAR GARAGE. THE RESIDENCE WILL ALSO CONTAIN A (1) BEDROOM (1) BATHROOM ATTACHED ADU.

PLAN A DESIGN GROUP LLC


SUITE C BELMONT, CA 94019

(650) 207-1566

1045 ALAMEDA DE LAS PULGAS

LISA WELLMAN

PROJECT DESCRIPTION

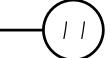

CIVIL ENGINEER

332 PRINCETON AVE.

(650) 728-3590

HALF MOON BAY, CA 94019

SIGMA PRIME GEOSCIENCES INC.

BUILDING DATA CONSTRUCTION TYPE: OCCUPANCY GROUP: NUMBER OF STORIES: FIRE SPRINKLERS:

SITE DATA TOTAL LOT AREA AVERAGE LOT SLOPE:

PROPOSED LOT COVERAGE MAIN RESIDENCE / ADU FOOTPRINT AREA COVERED ENTRY PORCH 1500.0 SF 42.0 SF 55.0 SF EXTERIOR STAIRS TO ADU EXTERIOR CONCRETE STAIRS AND WALKWAYS 45.0 SF (OVER 18" ABOVE EXISTING GRADE)

PROPOSED LANDSCAPED AREA ± 840.0 SF

PROJECT DIRECTORY

PROPERTY OWNER:

121 BRIDGEPORT DR.

WENDY AND ADAM JENSEN

HALF MOON BAY, CA 94019

MAXIMUM ALLOWABLE FLOOR AREA 4696 SF (.48) = 2254 SF

PROPOSED FLOOR AREA RATIO

TOTAL FLOOR AREA = 2157.0 SF FLOOR AREA TO LOT RATIO = .46

TWO-CAR GARAGE

TOPOGRAPHIC SURVEY

GARAGE LEVEL FLOOR PLAN

UPPER LEVEL FLOOR PLAN

ROOF PLAN

EXTERIOR ELEVATIONS

ARCH. DETAILS

CONCEPTUAL LANDSCAPE PLAN

A.P.N.

R-3/U YES

4696.0 SF ±21.0%

1642.0 SF TOTAL LOT COVERAGE: 35.0 %

PROPOSED AREAS

435.0 SF UPPER LEVEL LIVING AREA 537.0 SF 470.0 SF UPPER LEVEL ADU AREA 48.0 SF COVERED ENTRY PORCH 2144.0 SF TOTAL LIVING AREA TOTAL ENCLOSED FLOOR AREA 2579.0 SF TOTAL FLOOR AREA 2157.0 SF (PER SAN MATEO COUNTY F.A.R LIMIT)

MAXIMUM FLOOR AREA CALCULATION

TOTAL PROPOSED FLOOR AREA = 2157.0 SF

MAX. HEIGHT ABOVE NATURAL GRADE

26'-0" ABOVE NATURAL GRADE PARKING CALCULATION

PROJECT DATA

COVER SHEET / PROJECT DATA SITE PLAN

GRADING AND DRAINAGE PLAN EROSION CONTROL PLAN


MAIN LEVEL FLOOR PLAN


EXTERIOR ELEVATIONS

SECTIONS

MAIN LEVEL LIVING AREA

- - - - |

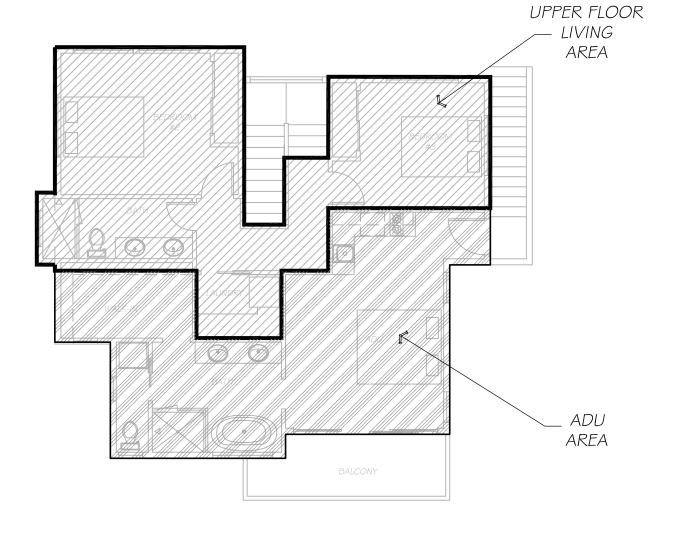

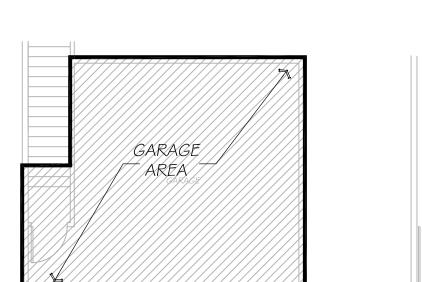

|----- ==== | = = = = UNCOVERED == =

|----

AREA DIAGRAMS

1/8" = 1'-0"

Jensen Residence El Granada, CA 94019

Roof: Certainteed Landmark TL Solaris Moire Black

<u>Exterior Finish</u>: Smooth stucco Benjamin Moore color Light Pewter. Stained V-groove western red cedar siding

Windows & Doors: Marvin Black Windows

<u>Garage Door</u>: Sectional Garage Door with Translucent Glazing or similar









Metal porch- Kendall Charcoal House- Stormy Monday and Pale oak



Western red cedar v-groove Lap siding

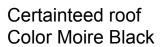



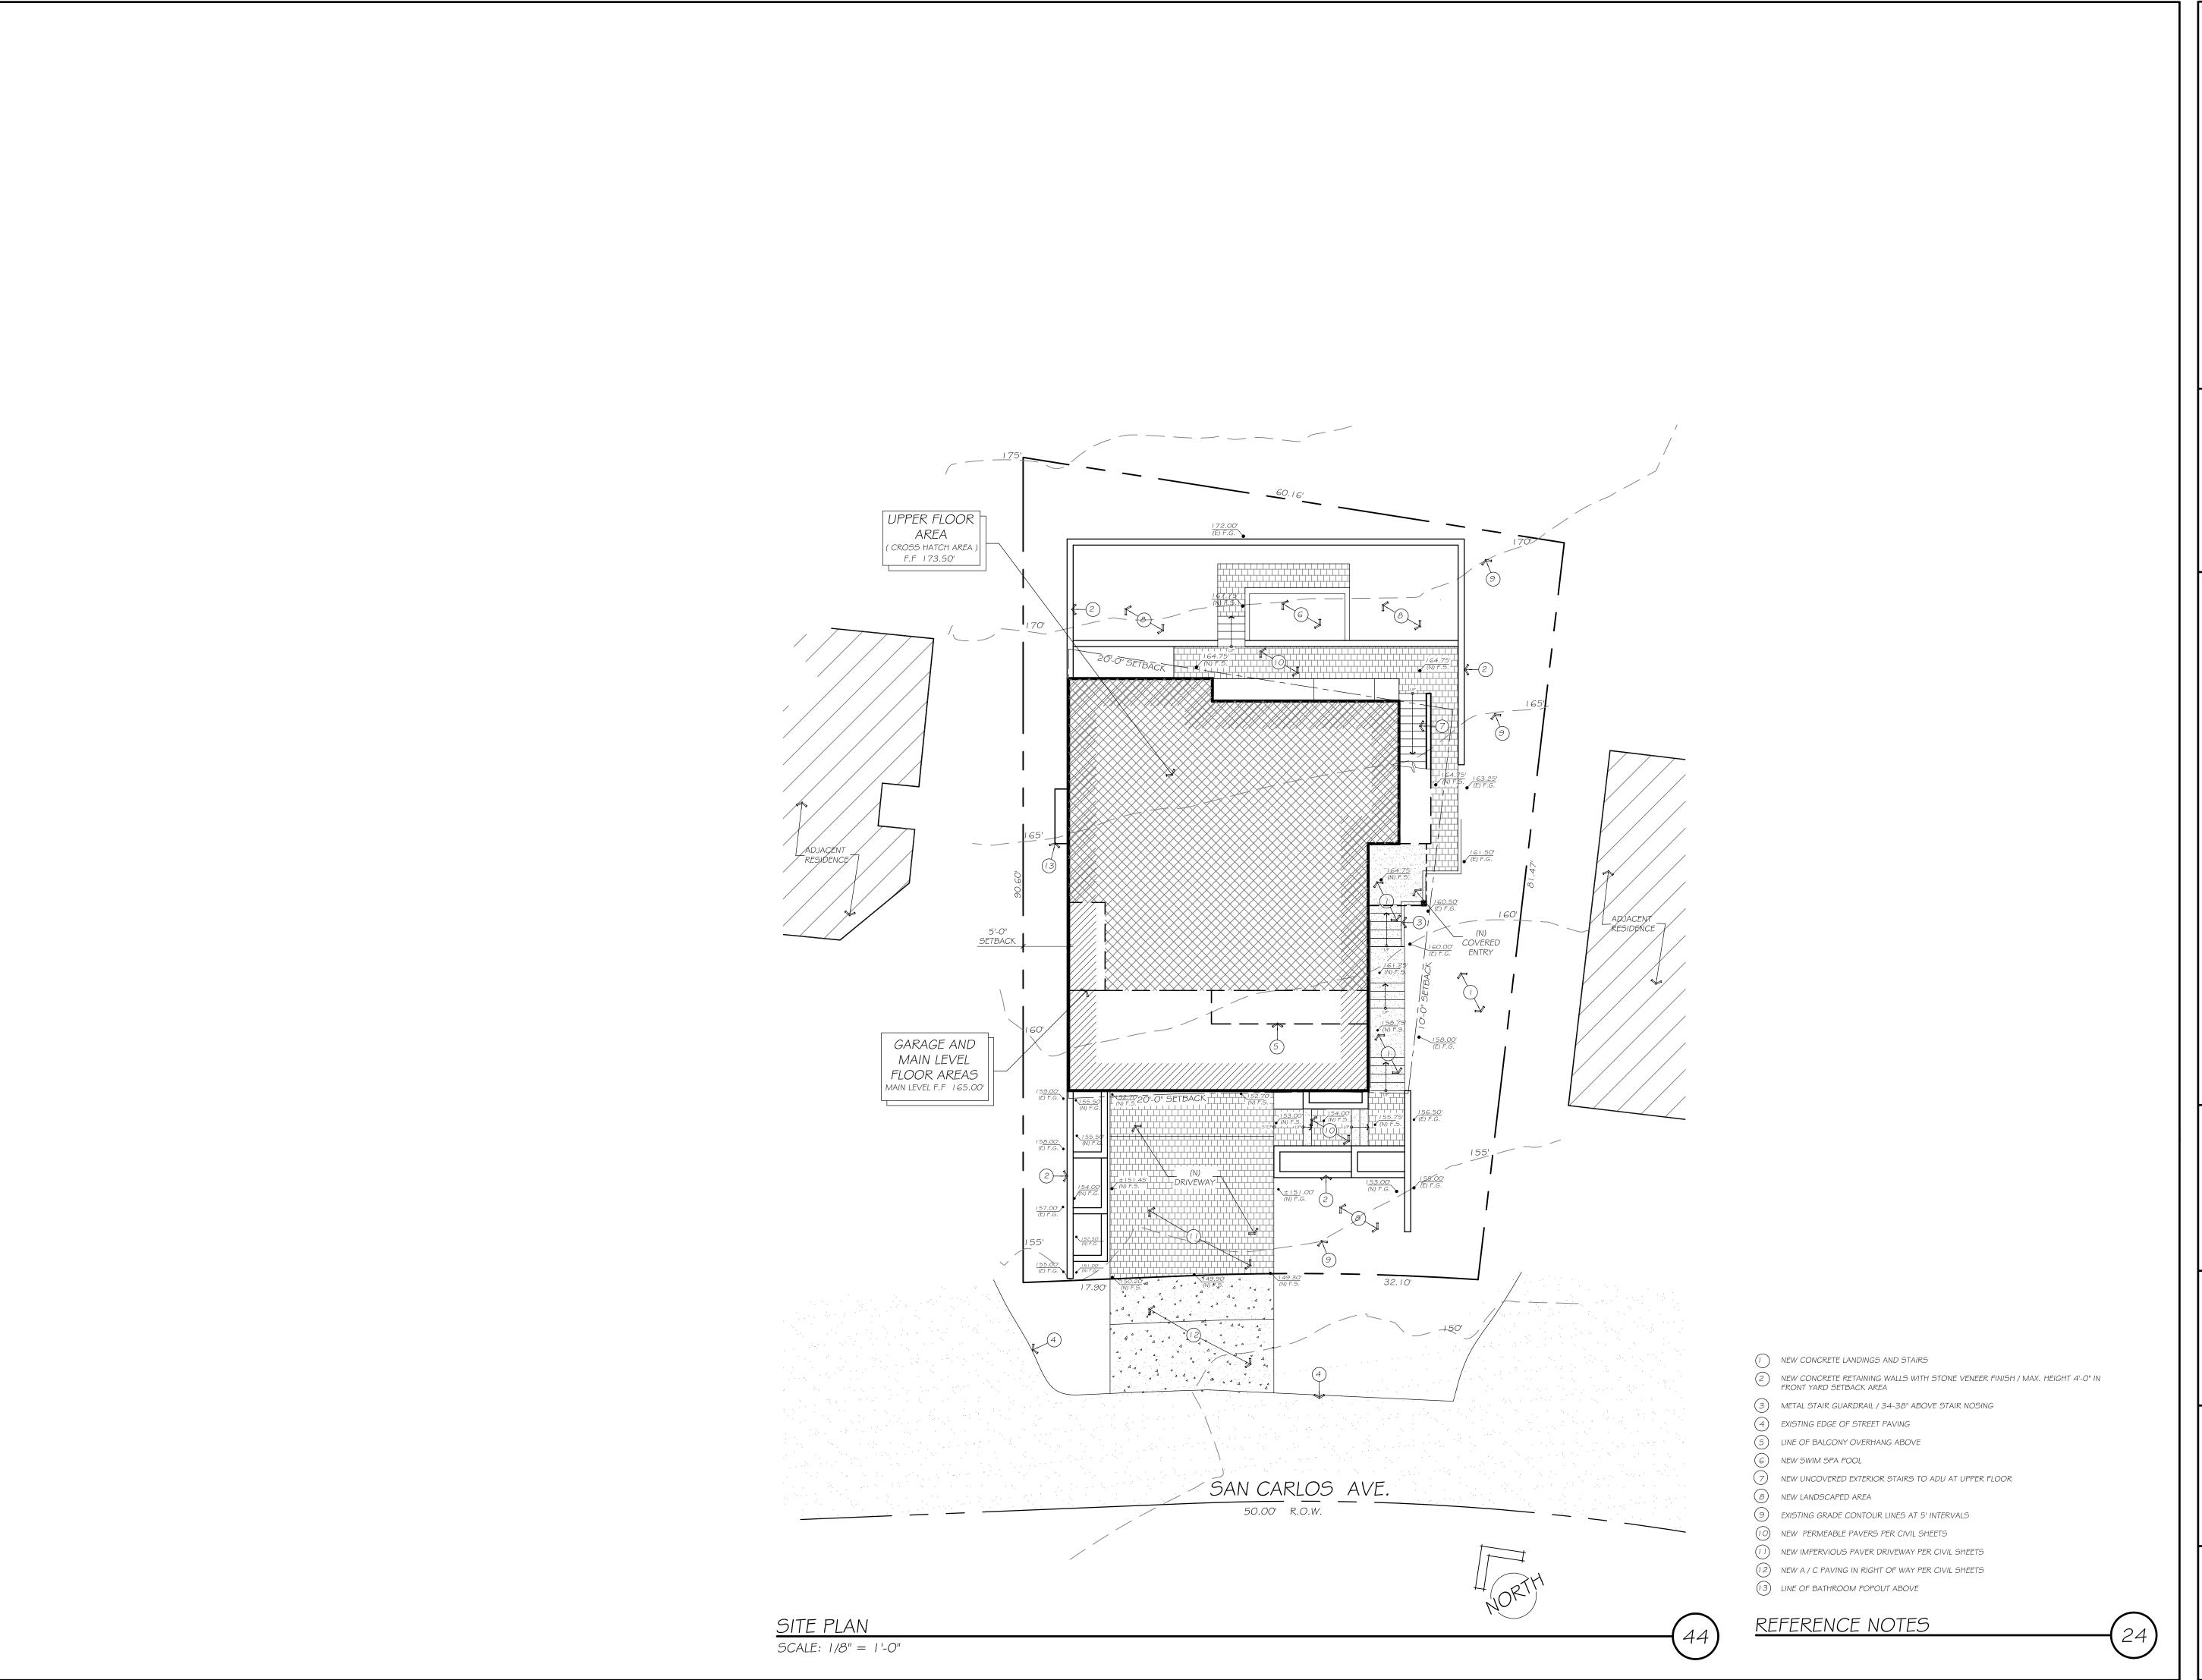

WENDY AND ADAM JENSEN 121 BRIDGEPORT DR. HALF MOON BAY,CA

JENSEN RESIDENCE

DRAINAGE / WATER DISTRICT COMMENTS 10-26-22 PLANNING DEPT. COMMENTS 12-21-22

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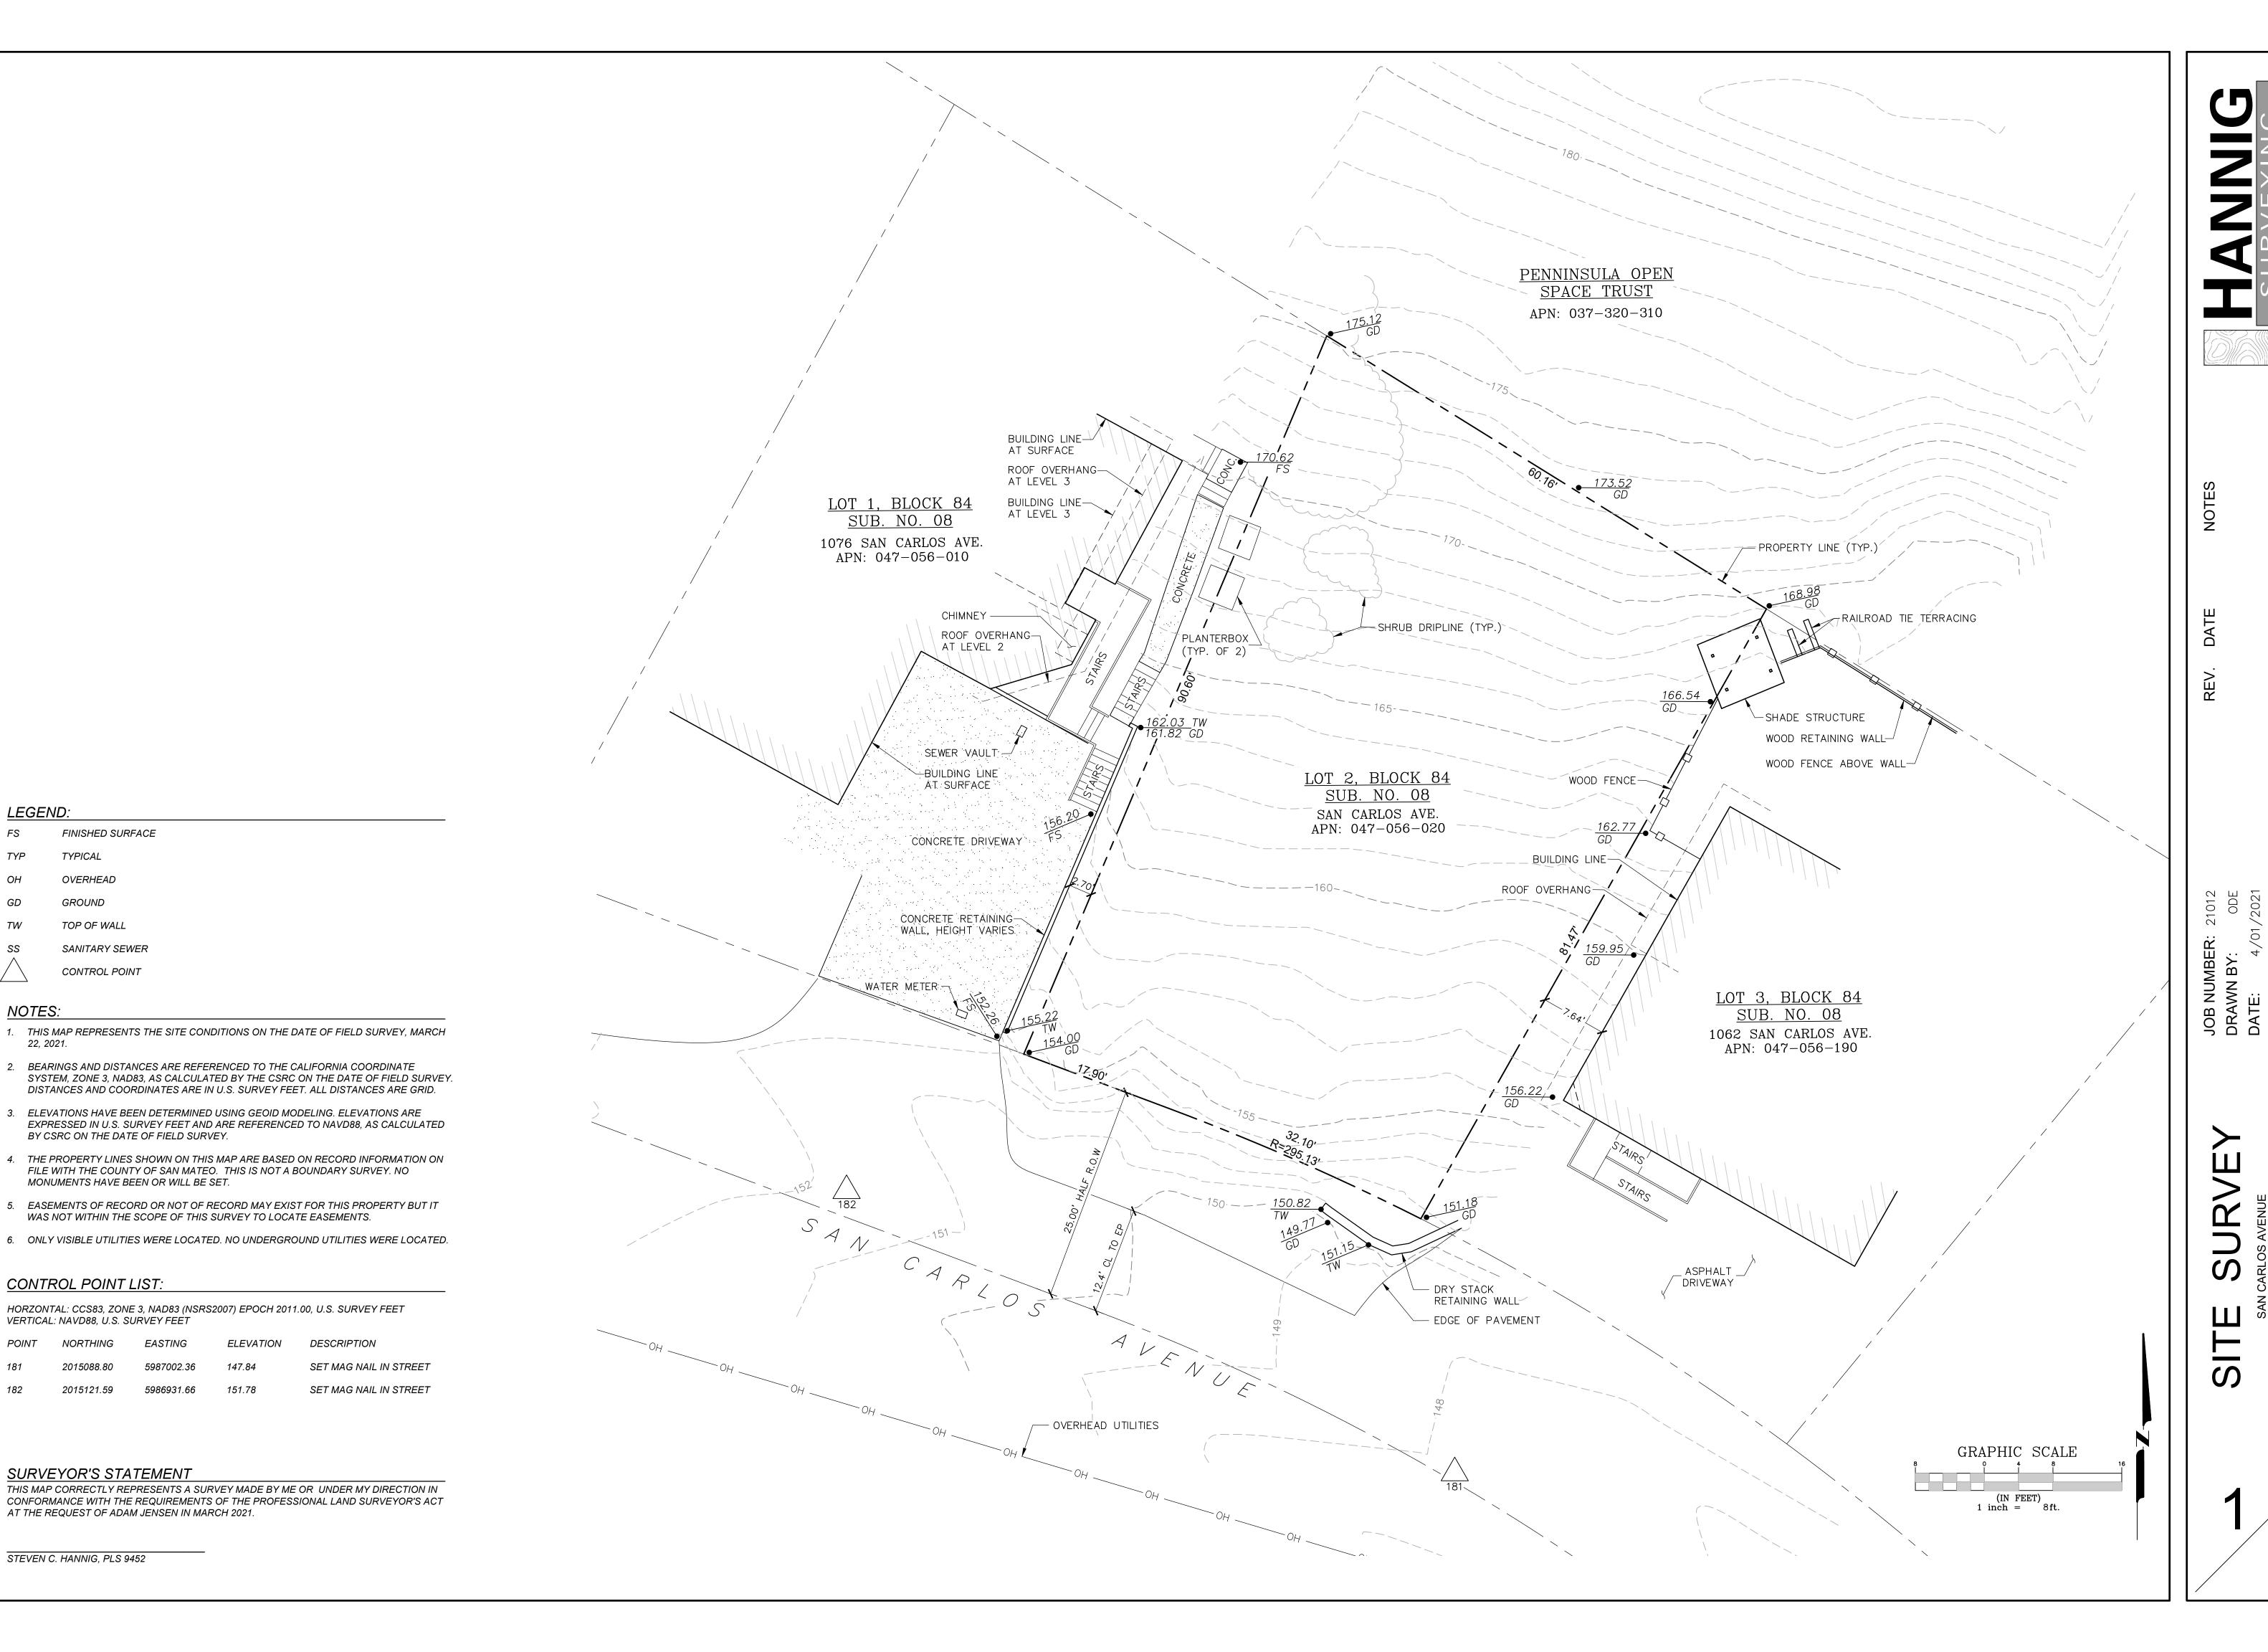
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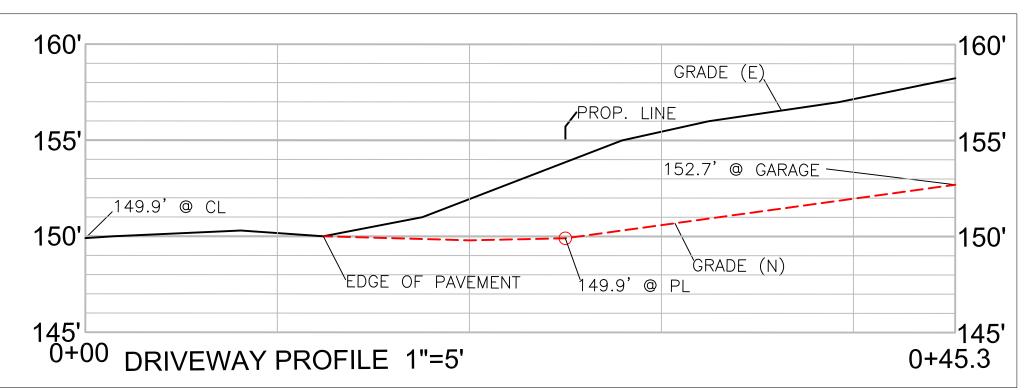
SITE PLAN



TYP

NOTES:





LEGEND

PROPOSED CONTOURS

PROPOSED SPOT ELEVATION

PROPOSED RETAINING WALL



ENERGY DISSIPATER - PER DETAIL 3



4" MIN PERFORATED DRAIN PIPE

GENERAL NOTES

1. PLANS PREPARED AT THE REQUEST OF:

- WENDY JENSEN, OWNER
 2. TOPOGRAPHY BY OTHERS.
- 3. THIS IS NOT A BOUNDARY SURVEY.
- 4. ELEVATION DATUM ASSUMED.
- 5. THE GEOTECHNICAL REPORT:

GEOTECHNICAL STUDY: JENSEN PROPERTY, 1062 SAN CARLOS AVENUE, EL GRANADA, CALIFORNIA. DATE: 5-31-22, BY SIGMA PRIME INC., PROJECT NO. 20-123 SHALL BE RETAINED ON THE CONSTRUCTION SITE. THE GEOTECHNICAL ENGINEER OF RECORD IS SIGMA PRIME

GEOSCIENCES, INC., WITH THE CONTACT NUMBER (650)-728-3590 (SIGMAPRM@GMAIL.COM). THE CONTRACTOR MUST SHALL NOTIFY THE GEOTECHNICAL ENGINEER OF RECORD AT LEAST 48 HOURS BEFORE CONSTRUCTION OF GEOTECHNICAL RELATED WORK. THE GEOTECHNICAL PART OF CONSTRUCTION WORK, INCLUDING BUT NOT LIMITED TO, ALL THE EARTHWORK AND FOUNDATION CONSTRUCTIONS, MUST SHALL BE APPROVED BY THE GEOTECHNICAL ENGINEER OF RECORD.

6. STORMWATER MANAGEMENT CONSTRUCTION INSPECTIONS SHALL BE SCHEDULED FOR APPLICABLE DRAINAGE INSPECTIONS, WHICH INCLUDE SITE CLEARANCE AND EROSION CONTROL MEASURES INSTALLATION AS

SITE CLEARANCE AND EROSION CONTROL MEASURES INSTALLATION AS WELL AS INSPECTION OF MAJOR DRAINAGE CONTAINMENT, TREATMENT, AND CONVEYANCE DEVICES BEFORE BEING BURIED (INCLUDING REQUIRED MATERIAL LABELS, E.G. PIPES, SUB-GRADE MATERIALS, ETC.). PLEASE FOLLOW THE INSPECTION CARD INSTRUCTIONS AND CALL SIGMA PRIME AT 650-728-3590 TO SCHEDULE DRAINAGE INSPECTIONS ACCORDINGLY. THERE SHALL BE THREE INSPECTIONS: ONE FOR EROSION CONTROL INSTALLATION, ONE BEFORE DRAINAGE FACILITIES ARE BURIED, AND ONE FOR FINAL WALK AROUND.

7. ALL WORK IN COUNTY RIGHT OF WAY MUST HAVE ENCROACHMENT PERMITS PRIOR TO START OF WORK.

DRAINAGE NOTES

1. DRAINAGE INTENT: IT IS THE INTENT OF THE DRAINAGE SYSTEM TO CONVEY ROOF RUNOFF TO A SAFE LOCATION, AND TO MINIMIZE EXCESSIVE MOISTURE AROUND FOUNDATIONS. SLOPE ALL IMPERVIOUS SURFACES A MINIMUM OF 2% AWAY FROM BUILDING. DIRECT SLOPES SUCH THAT STORMWATER WILL NOT BE DIVERTED ONTO ADJACENT PROPERTIES.

2. ALL DOWNSPOUT DRAIN LINES SHALL LEAD TO DETNETION BASIN, AS SHOWN.

3. ALL ROOF DRAINAGE PIPES SHALL BE 4" DIAMETER MINIMUM SOLID PIPE, SLOPED AT 1% MINIMUM.

4. IT IS THE PROPERTY OWNER'S RESPONSIBILITY TO CHECK ON ALL STORMWATER FACILITIES SUCH AS ROOF GUTTERS, DOWNSPOUT LINES, AND THE DETENTION BASIN TO BE SURE THAT THEY ARE CLEAR OF EXCESSIVE DEBRIS AND OPERATING EFFICIENTLY. THE FACILITIES SHALL BE CHECKED EVERY FALL AND PERIODICALLY DURING THE RAINY SEASON.

GRADING NOTES


CUT VOLUME : 515 CY (FOR FOUNDATION)
FILL VOLUME: 20 CY

VOLUMES ABOVE ARE APPROXIMATE.


THE SUBGRADE BELOW ALL PAVED AREAS SHALL BE BASEROCK COMPACTED TO 95%.


ALL GRADING SHALL CONFORM TO LOCAL CODES AND ORDINANCES.


ALL TRENCHES UNDER PROPOSED PAVED AREAS OR CONCRETE SHALL BE BACKFILLED TO SUBGRADE ELEVATION WITH COMPACTED APPROVED GRANULAR MATERIALS. IF TRENCHES ARE IN PROPOSED LANDSCAPE AREAS, THEY SHALL BE BACKFILLED WITH COMPACTED APPROVED GRANULAR MATERIAL TO WITHIN ONE FOOT OF FINISHED GRADE, AND THEN FILLED WITH HAND TAMPED SOILS.

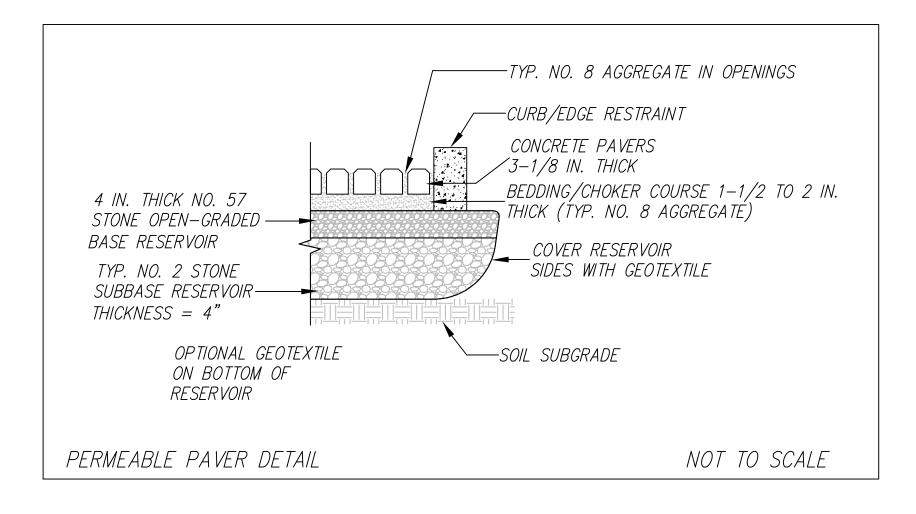




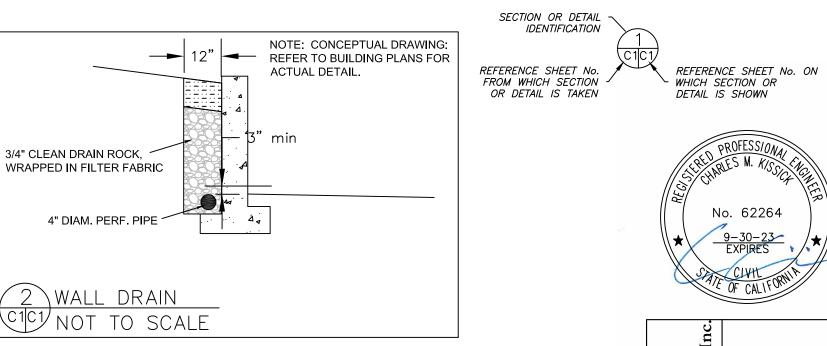

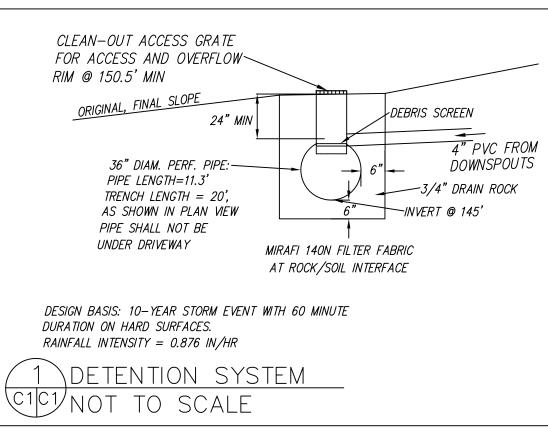

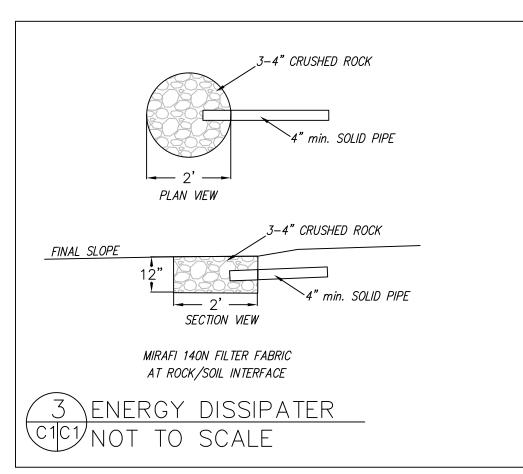

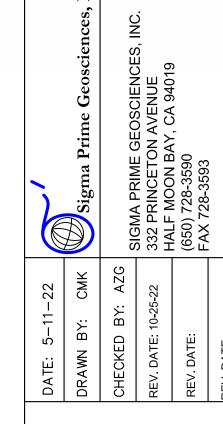



GRADING AND
DRAINAGE PLAN
JENSON PROPERTY
1062 SAN CARLOS AVNUE
EL GRANADA
APN 047-056-120

C-1

SHEET



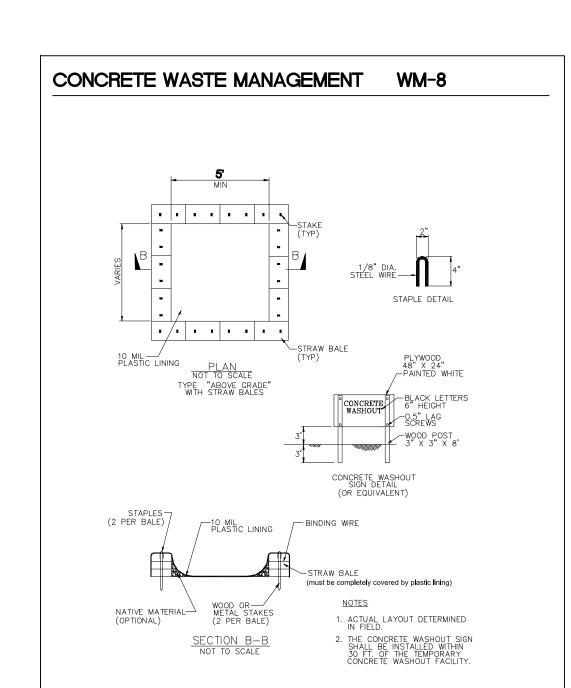

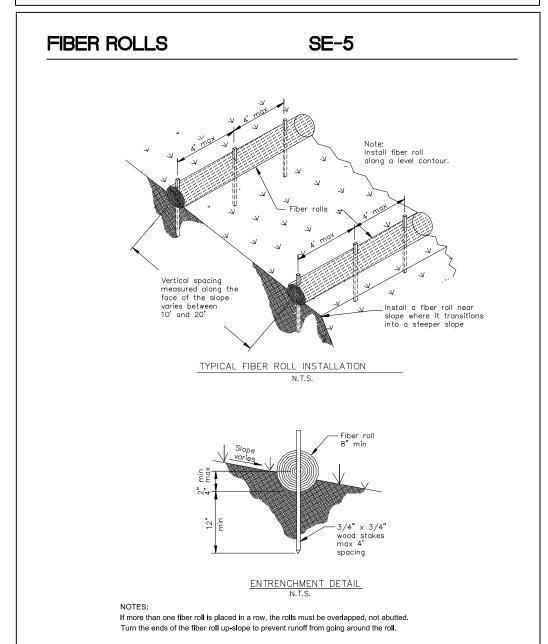

GENERAL EROSION AND SEDIMENT CONTROL NOTES



- There will be no stockpiling of soil. All excavated soil will be hauled off-site as it is excavated.
- Perform clearing and earth-moving activities only during dry weather. Measures to ensure adequate erosion and sediment control shall be installed prior to earth-moving activities and construction.
- Erosion control materials to be on-site during off-season.
- Measures to ensure adequate erosion and sediment control are required year-round.
 Stabilize all denuded areas and maintain erosion control measures continuously between October 1 and April 30.
- Store, handle, and dispose of construction materials and wastes properly, so as to prevent their contact with stormwater.
- Control and prevent the discharge of all potential pollutants, including pavement cutting wastes, paints, concrete, petroleum products, chemicals, wash water or sediments, and non-stormwater discharges to storm drains and watercourses.
- · Avoid cleaning, fueling, or maintaining vehicles on-site, except in a designated area where wash water is contained and treated.
- · Limit and time applications of pesticides and fertilizers to prevent polluted runoff.
- · Limit construction access routes to stabilized, designated access points
- Avoid tracking dirt or other materials off-site; clean off-site paved areas and sidewalks using dry sweeping methods.
- Train and provide instruction to all employees and subcontractors regarding the Watershed Protection Maintenance Standards and construction Best Management Practices.
 Placement of erosion materials is required on weekends and during rain events.
- The areas delineated on the plans for parking, grubbing, storage etc., shall not be
- enlarged or "run over."
- · Dust control is required year-round.
- · Erosion control materials shall be stored on-site.
- There are no trees or driplines oin the site.

EROSION CONTROL POINT OF CONTACT

THIS PERSON WILL BE RESPONSIBLE FOR EROSION CONTROL AT THE SITE AND WILL BE THE COUNTY'S MAIN POINT OF CONTACT IF CORRECTIONS ARE REQUIRED.

NAME: WENDY JENSEN


TITLE/QUALIFICATION: OWNER


PHONE: 801-623-9260

E-MAIL: WENDYLJENSEN@GMAIL.COM___



Sigma Prime Geosciences, In Sigma Prime Geosciences, In SIGMA PRIME GEOSCIENCES, INC. 332 PRINCETON AVENUE HALF MOON BAY, CA 94019 (650) 728-3590 FAX 728-3593

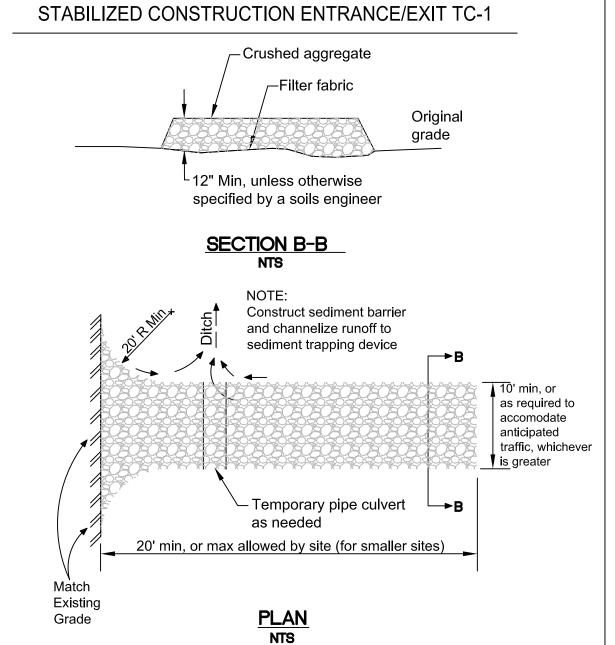


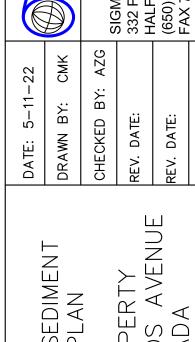

EROSION AND SEDIMENT CONTROL PLAN JENSEN PROPERTY 1062 SAN CARLOS AVENUI EL GRANADA APN 047-056-020

SHEET

C-2

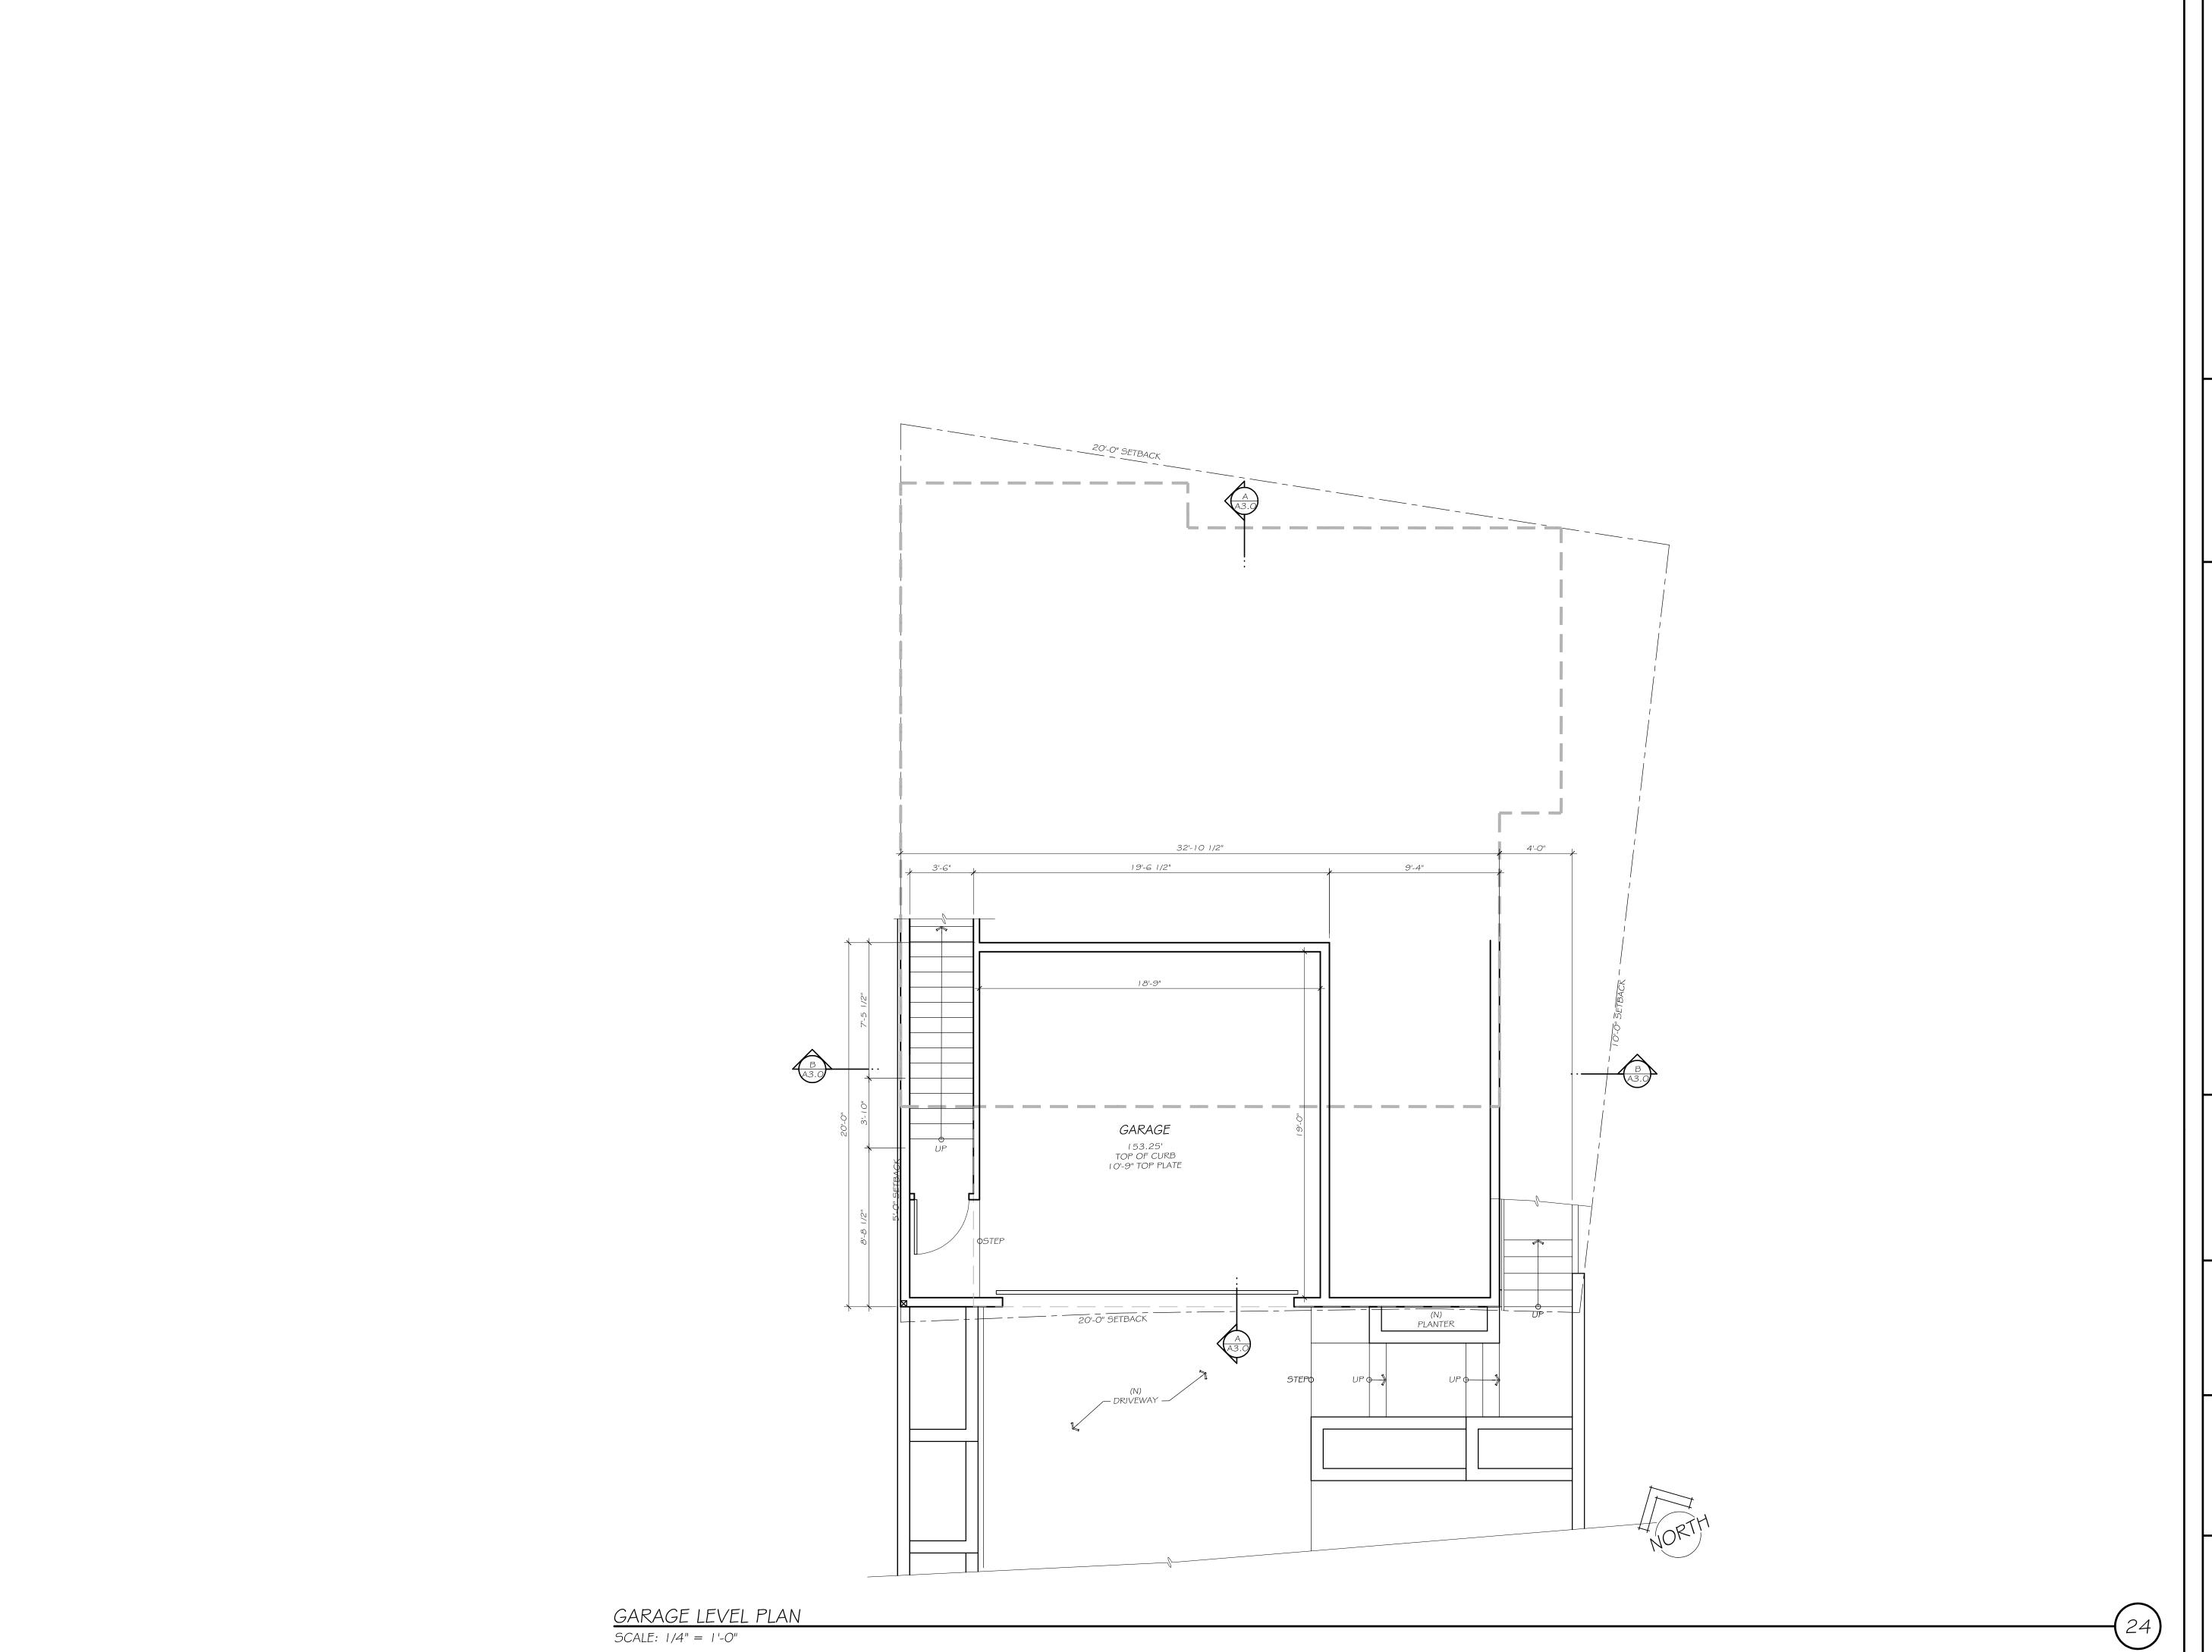

PLAN A DESIGN GROUP

727 INDUSTRIAL RD. SUITE100 SAN CARLOS, CA
94070

(650) 207-1566 lisa@planadesigngroup.com

OWNE

WENDY AND ADAM JENSEN 121 BRIDGEPORT DR. HALF MOON BAY,CA 94019

JENSEN RESIDENCE

047-056-020
SAN CARLOS AVENUE
EL GRANADA CA

REVISIONS:

DRAINAGE / WATER DISTRICT COMMENTS 10-26-22

PLANNING DEPT. COMMENTS 12-21-22

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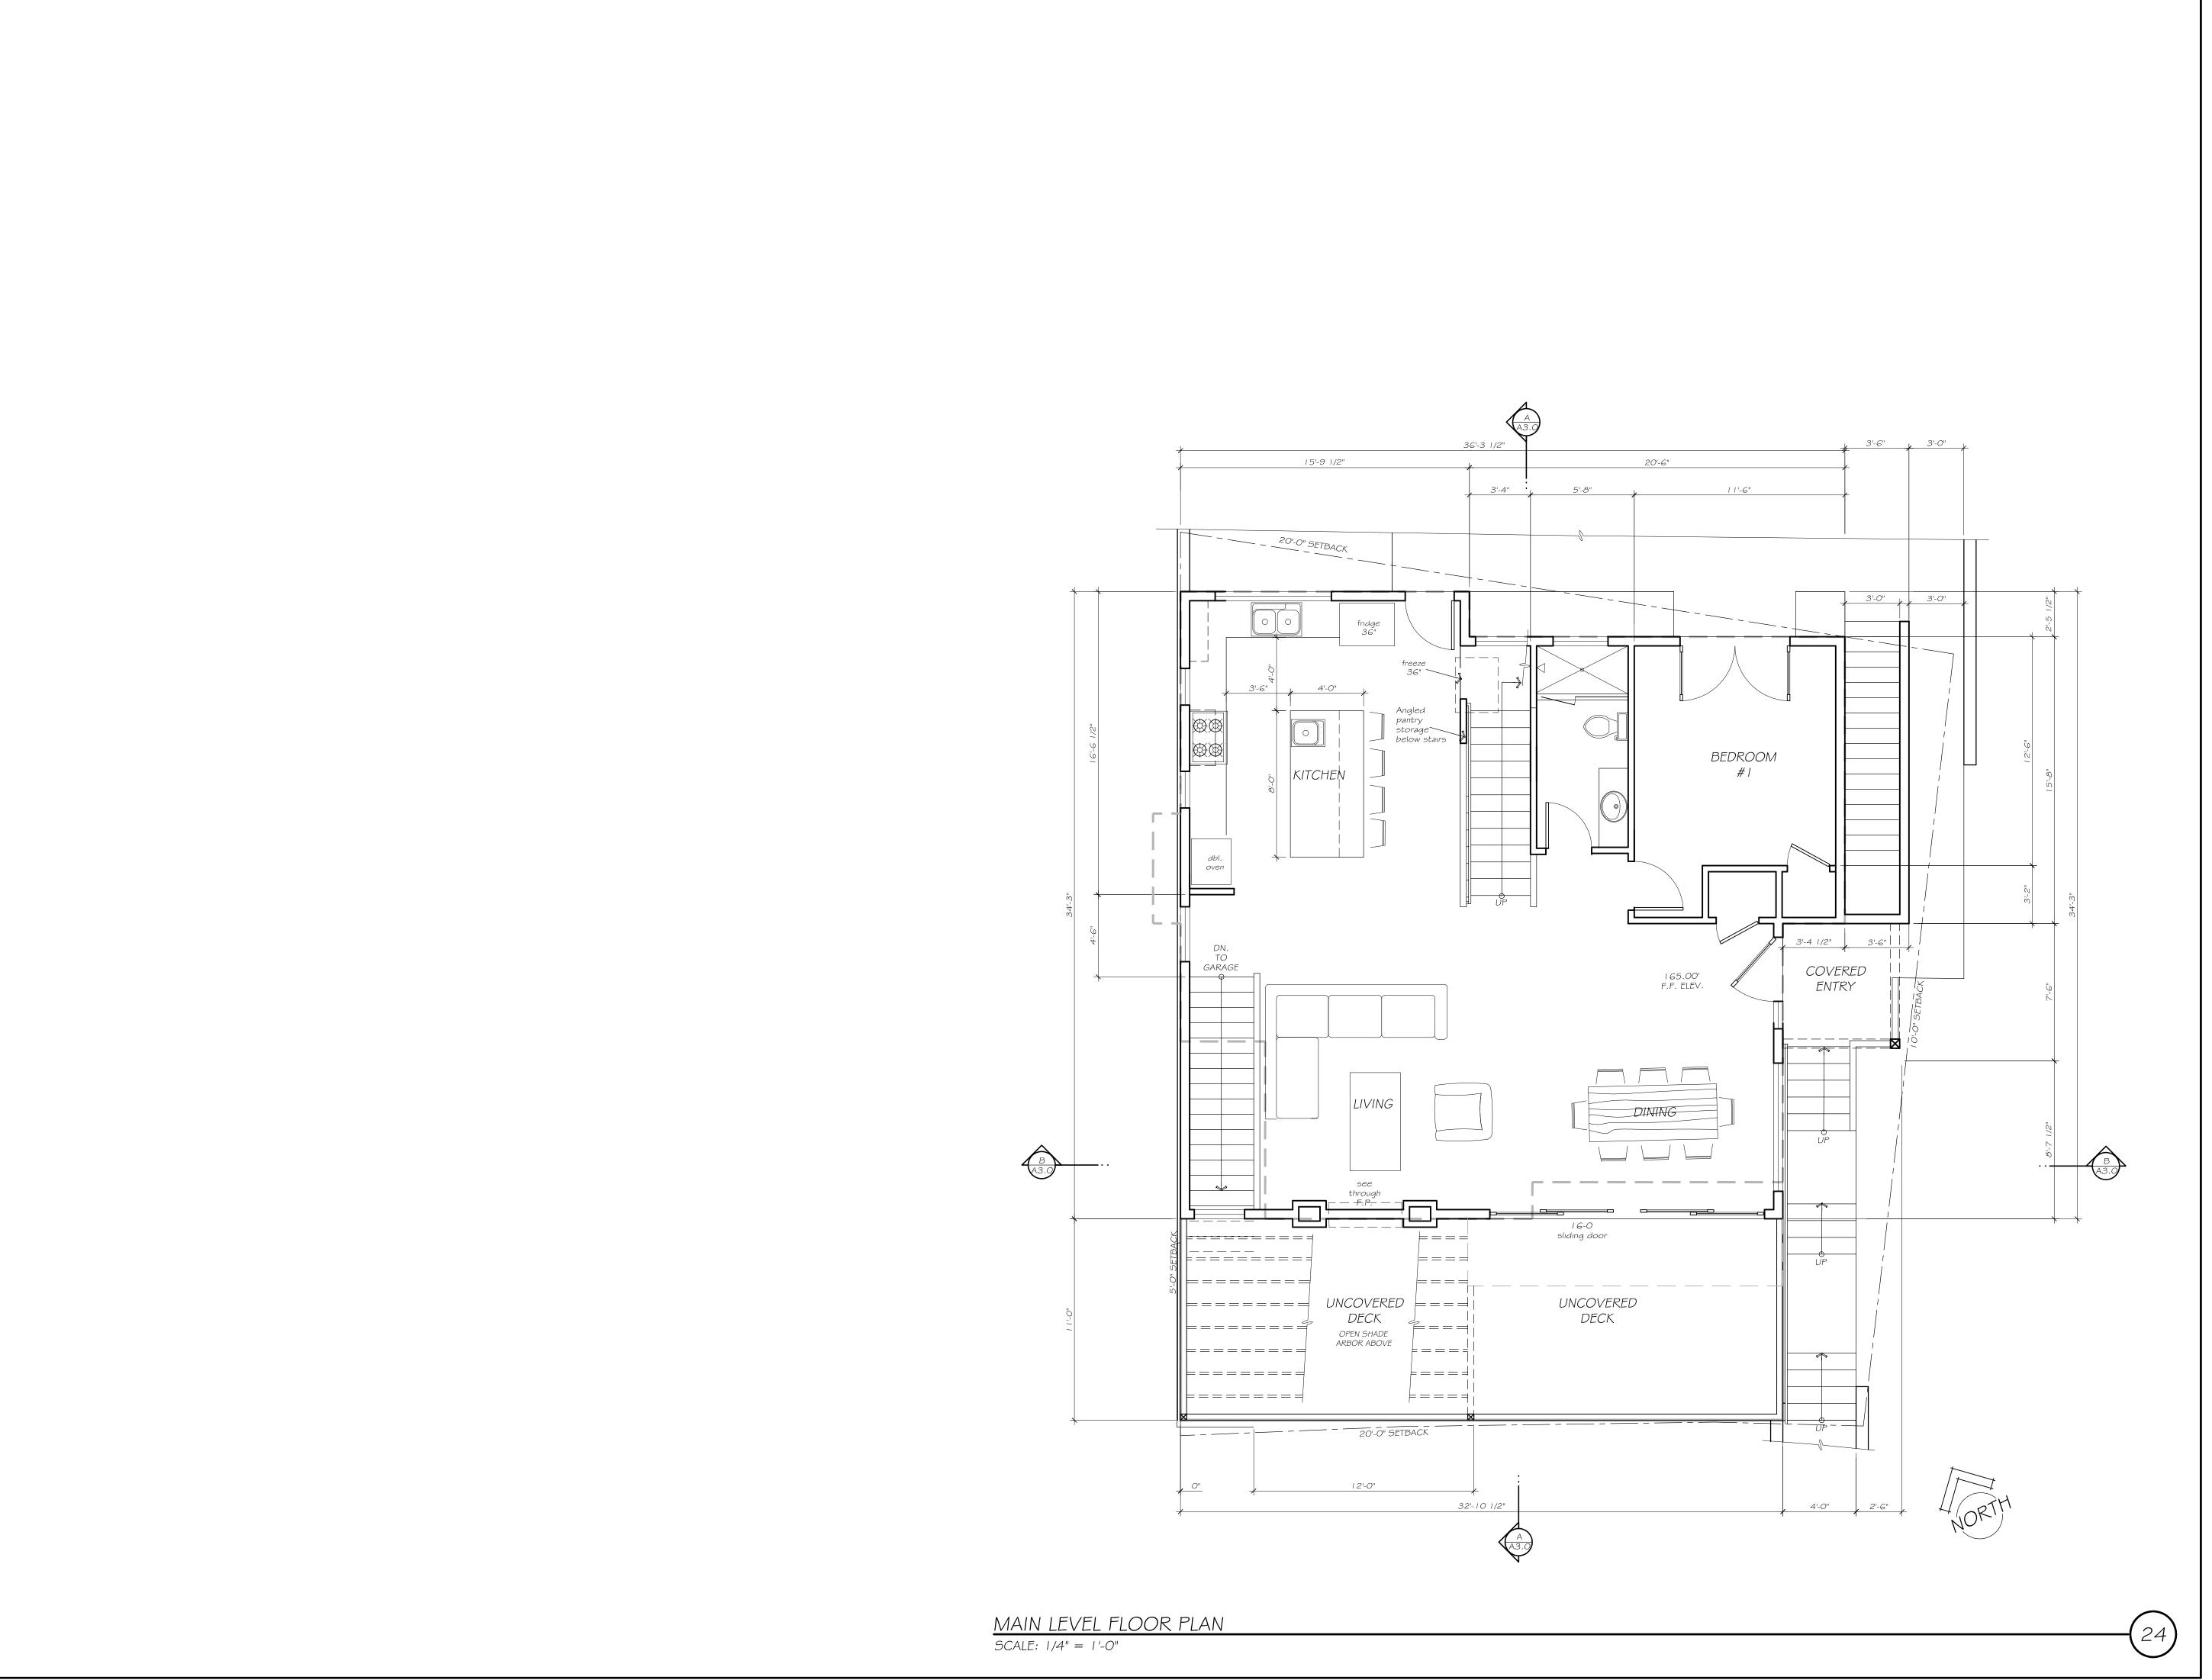
DATE: DECEMBER 21, 2022

SHEET TITLE:

GARAGE LEVEL FLOOR PLAN

SHEET NUMBER:

A1.2



OWNER:

WENDY AND ADAM JENSEN 121 BRIDGEPORT DR. HALF MOON BAY,CA

JENSEN RESIDENCE

REVISIONS:

DRAINAGE / WATER DISTRICT COMMENTS 10-26-22 PLANNING DEPT. COMMENTS 12-21-22


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DATE: DECEMBER 21, 2022 SHEET TITLE:

MAIN LEVEL FLOOR PLAN



DLAN A DESIGN·MANAGE

VISUALIZE·DESIGN·MANAGE

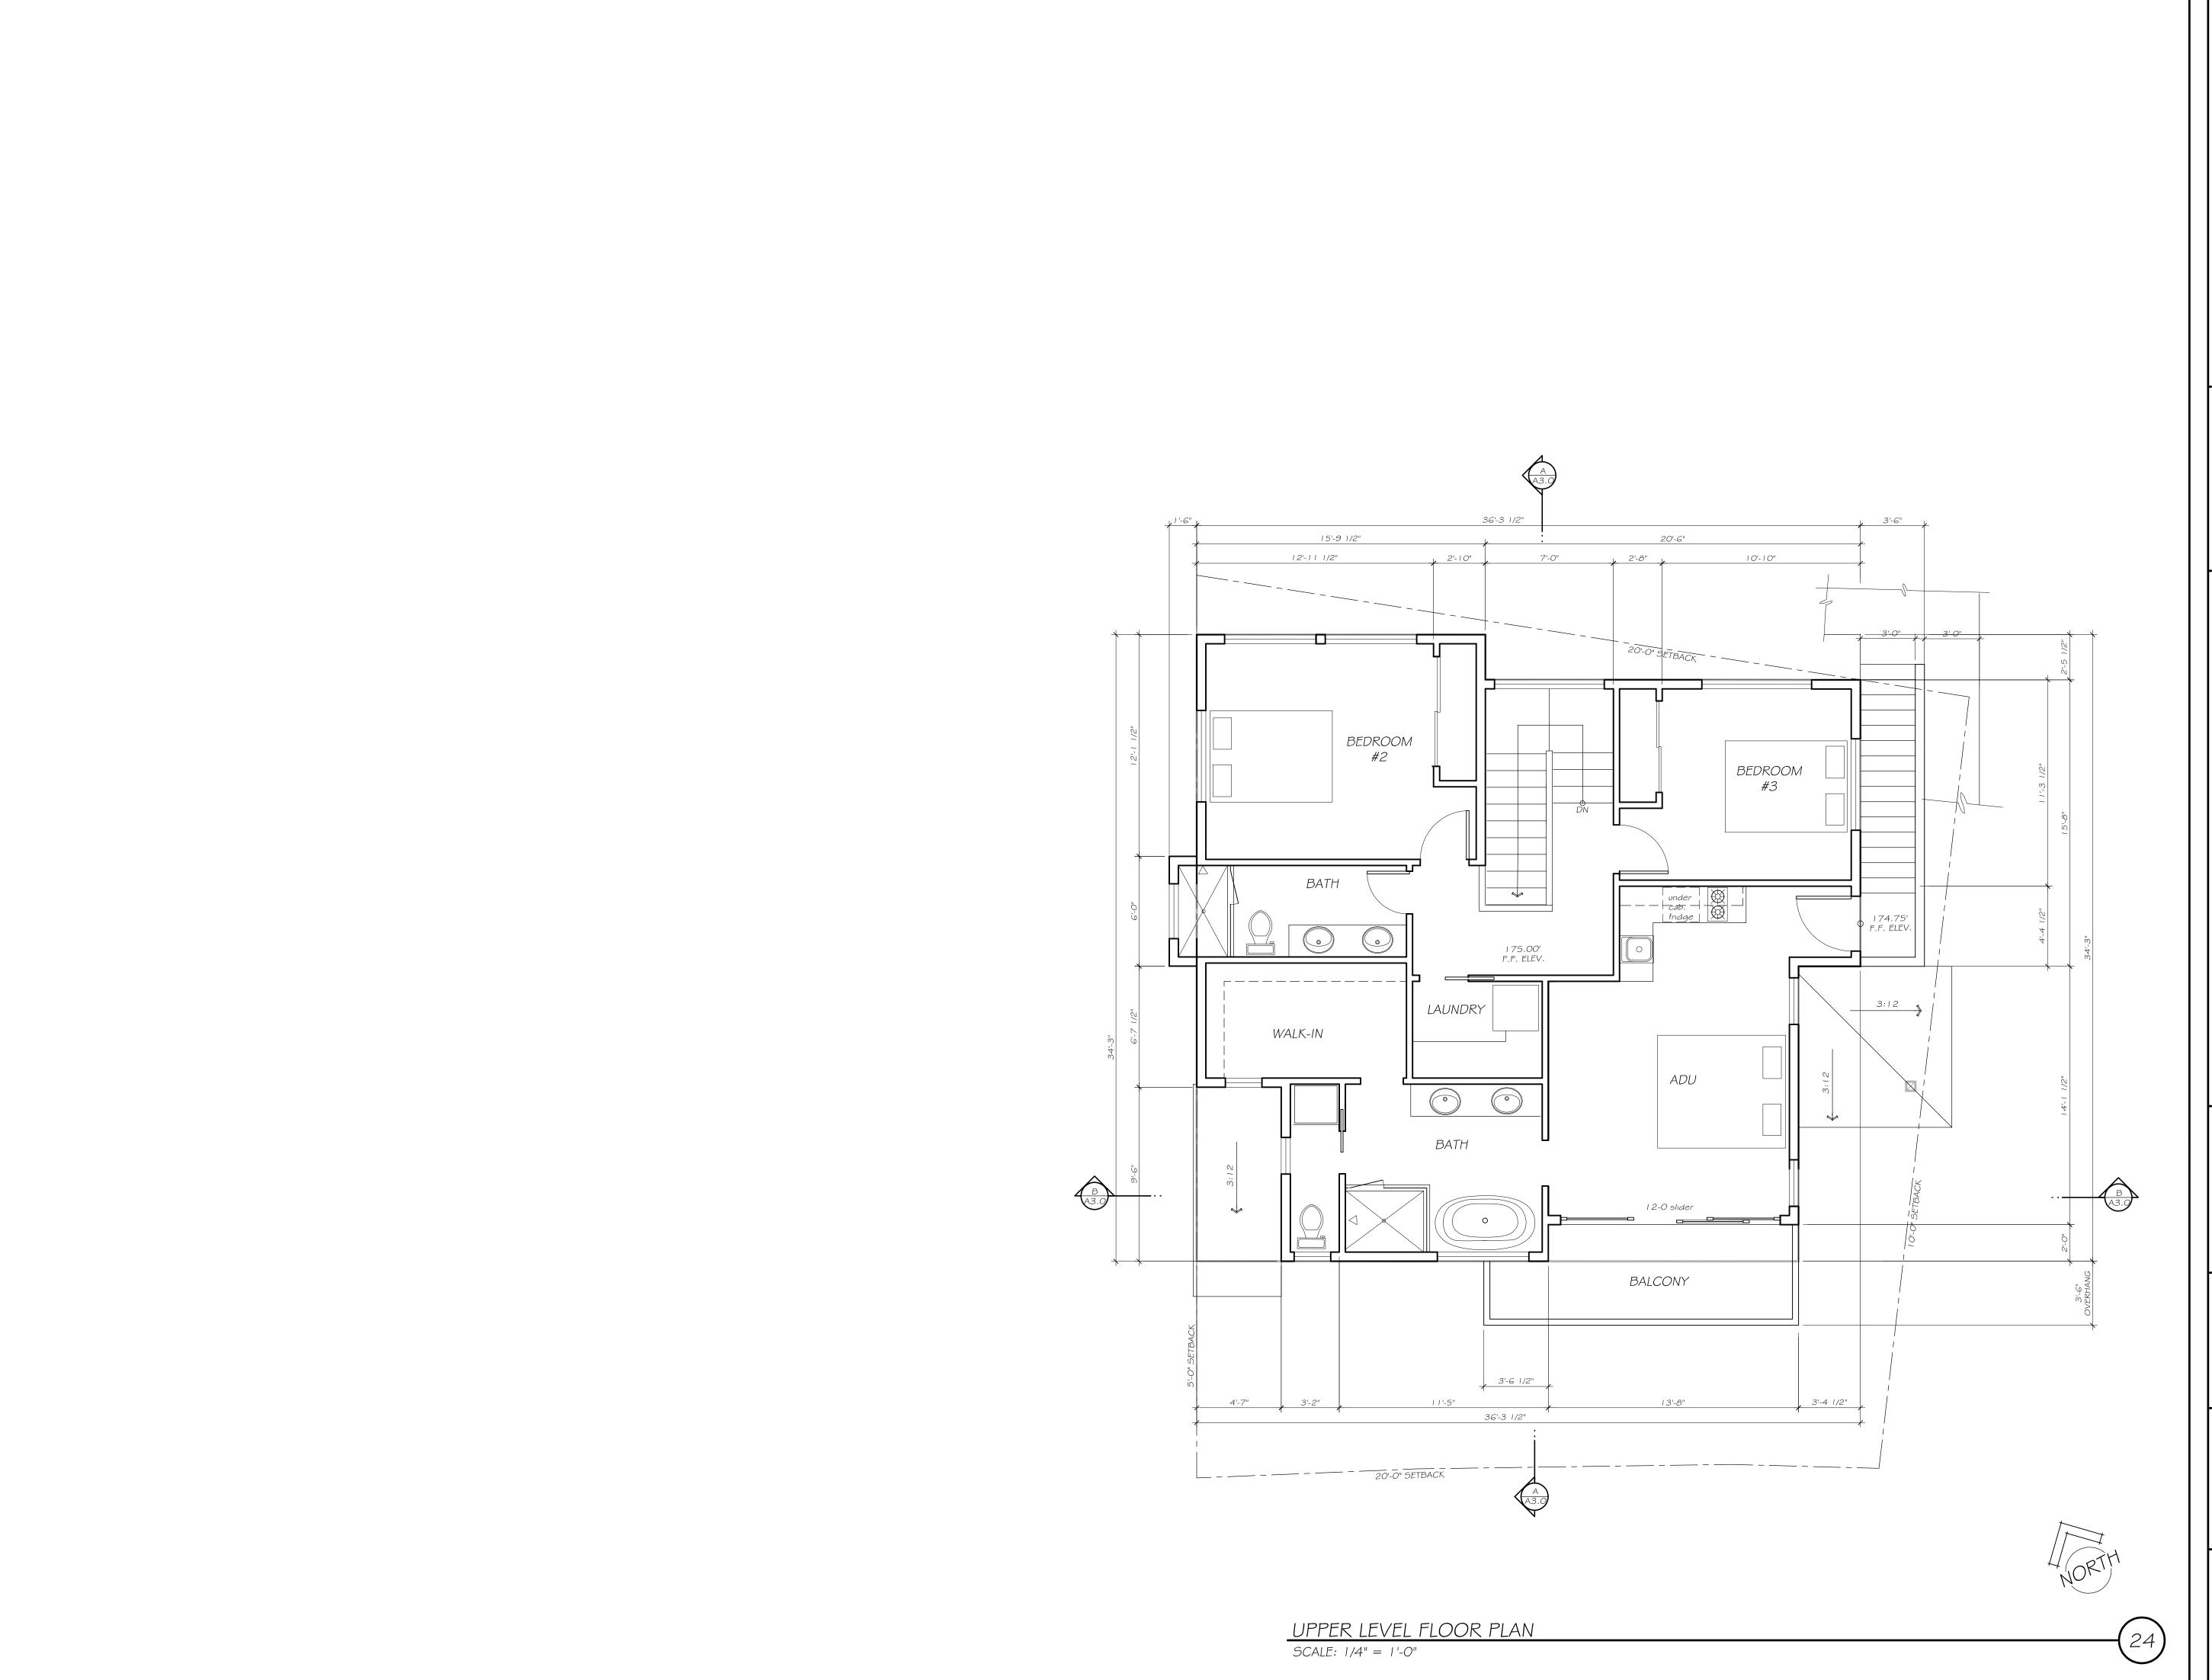27 INDUSTRIAL RD. SUITE100 SAN CARLOS, CA
94070

(650) 207-1566 lisa@planadesigngroup.com

OWNE

WENDY AND ADAM JENSEN 121 BRIDGEPORT DR. HALF MOON BAY,CA 94019

JENSEN RESIDENCE
047-056-020
SAN CARLOS AVENUE

REVISIONS:

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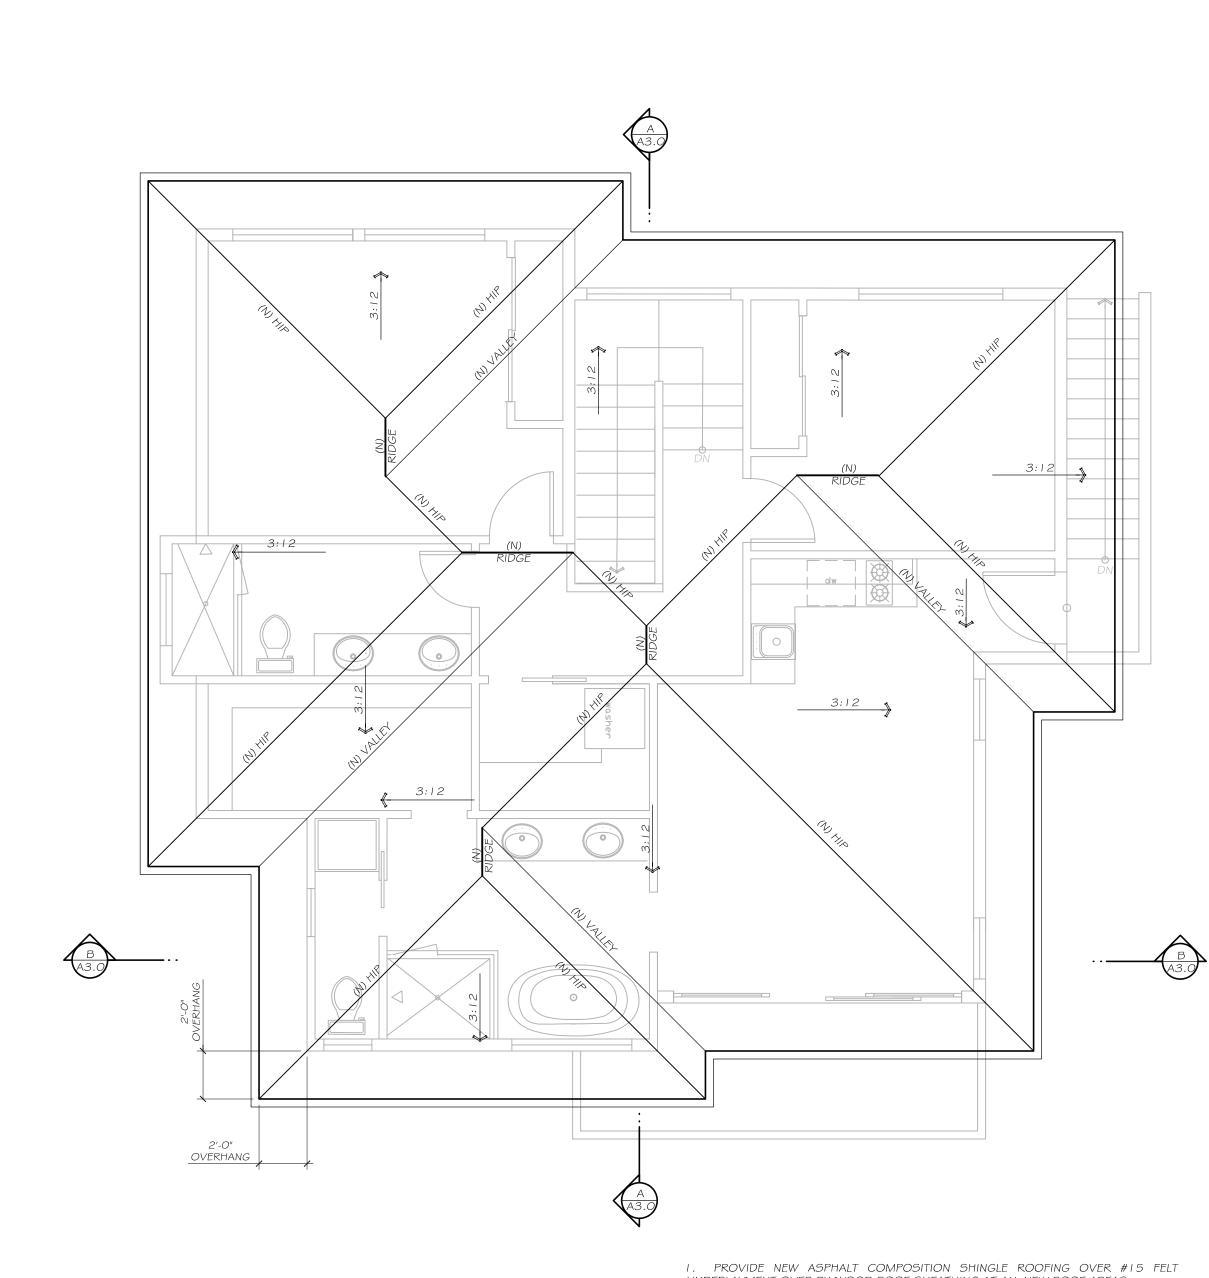
DATE: DECEMBER 21, 2022

SHEET TITLE:

UPPER LEVEL FLOOR PLAN

SHEET NUMBER:

A1.4



PROVIDE NEW ASPHALT COMPOSITION SHINGLE ROOFING OVER #15 FELT UNDERLAYMENT OVER PLYWOOD ROOF SHEATHING AT ALL NEW ROOF AREAS.
 ROOF SHINGLES TO BE: CERTAINTEED "PRESIDENTIAL SHAKE SOLARIS" CLASS "A" RATED COOL ROOFING / CRRC PRODUCT ID # 0668 - 0132 "SOLARIS CHARCOAL BLACK"

ROOF PLAN NOTES / LEGEND



ROOF PLAN

SCALE: 1/4" = 1'-0"

A DESIGN·MANAGE——

**RIAL RD. SUITE100 SAN CARLOS, CA 94070

07-1566 lisa@planadesigngroup.com

OWNER:

WENDY AND ADAM JENSEN 121 BRIDGEPORT DR. HALF MOON BAY,CA 94019

JENSEN RESIDENCE
047-056-020
SAN CARLOS AVENUE
EL GRANADA,CA

REVISIONS:

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DATE: DECEMBER 21, 2022

SHEET TITLE:

ROOF PLAN

SHEET NUMBER:

A1.5



FRONT PERSPECTIVE NOT TO SCALE

SOUTH ELEVATION



ENTRY PERSPECTIVE NOT TO SCALE





SCALE: 1/4" = 1'-0"

EAST ELEVATION

OWNER:

WENDY AND ADAM JENSEN 121 BRIDGEPORT DR. HALF MOON BAY,CA

JENSEN RESIDENCE

REVISIONS:

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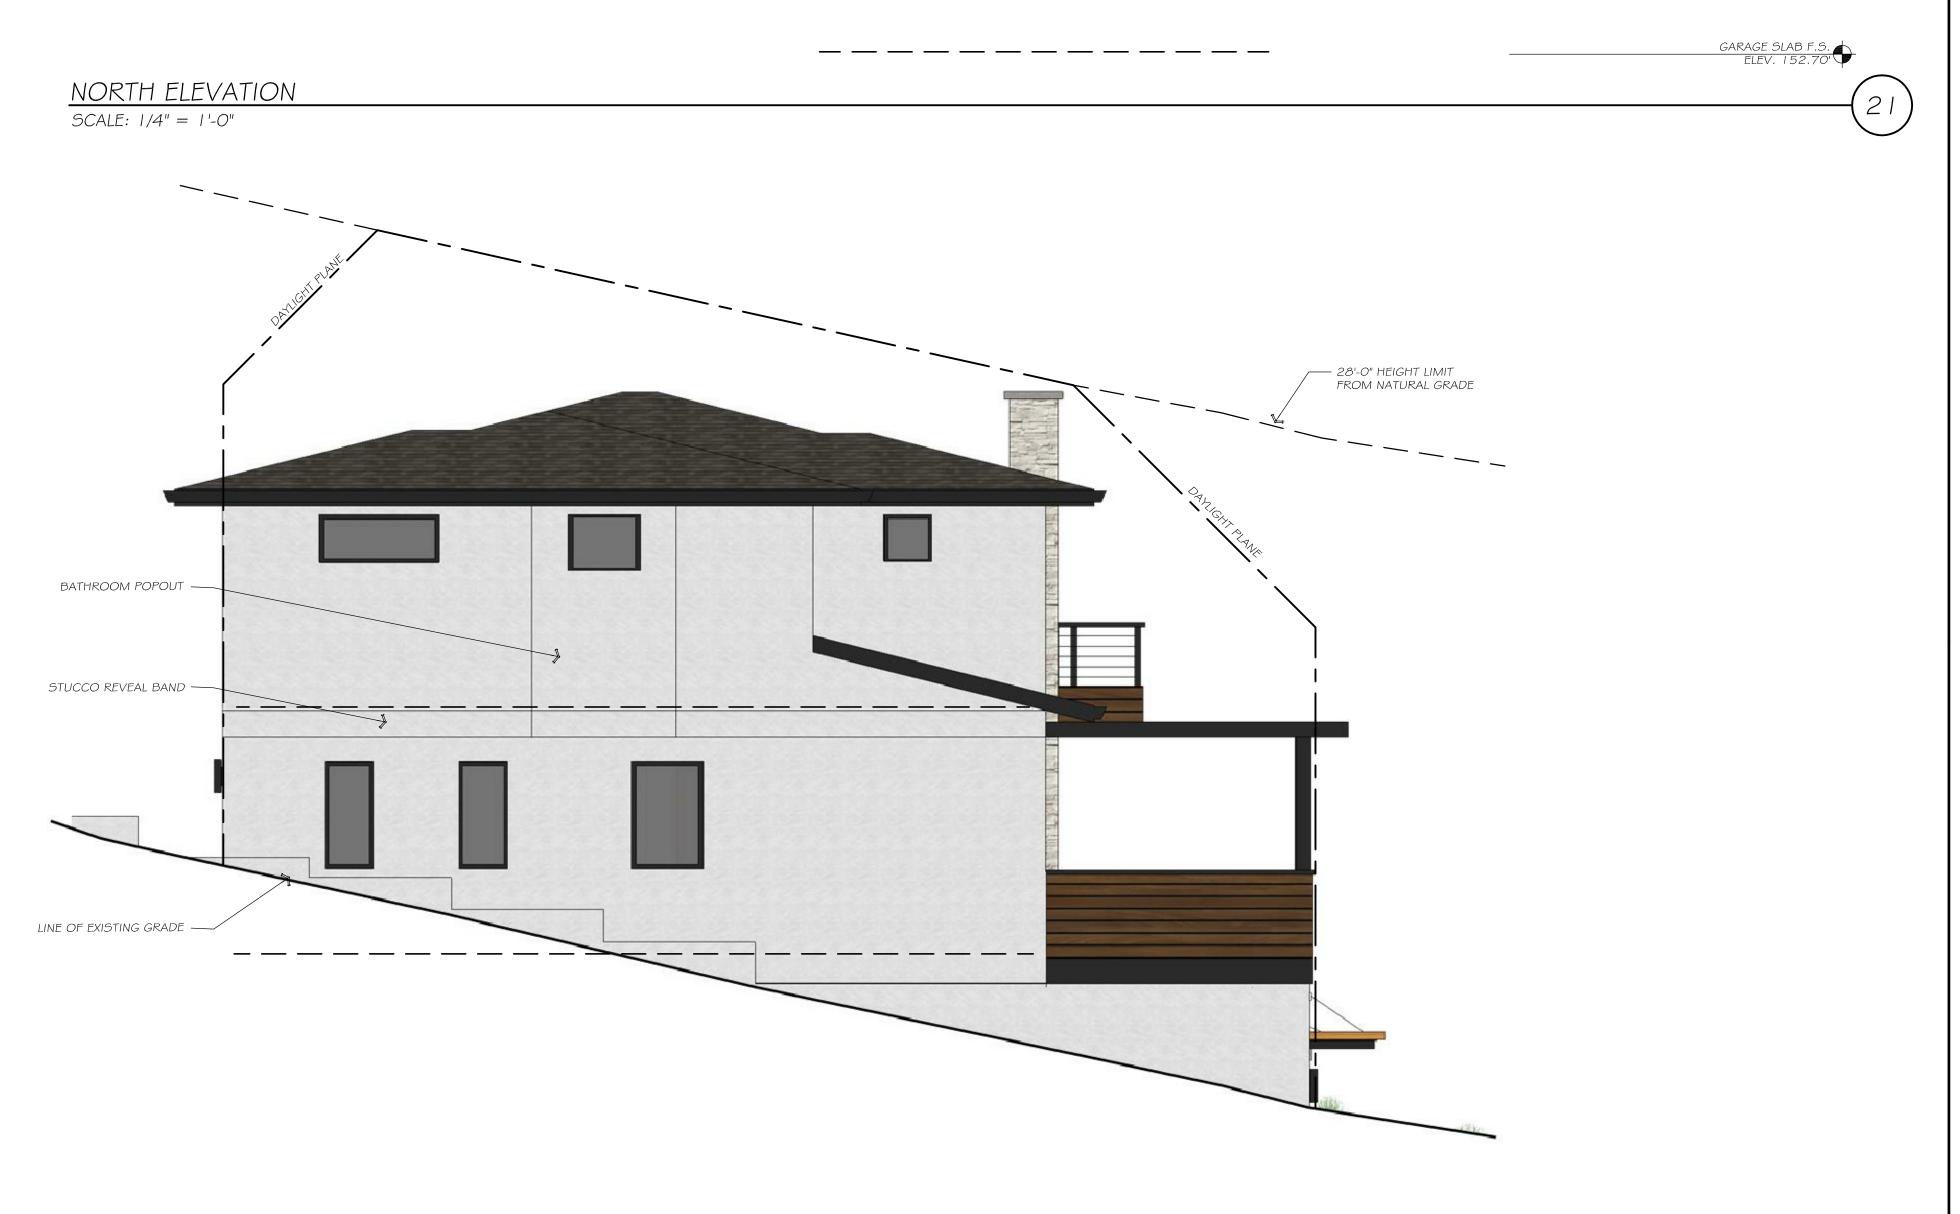
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DATE: DECEMBER 21, 2022 SHEET TITLE:

PROPOSED **EXTERIOR ELEVATIONS**







REAR PERSPECTIVE NOT TO SCALE

SCALE: 1/4" = 1'-0"

WEST ELEVATION

OWNER:

WENDY AND ADAM JENSEN 121 BRIDGEPORT DR. HALF MOON BAY,CA

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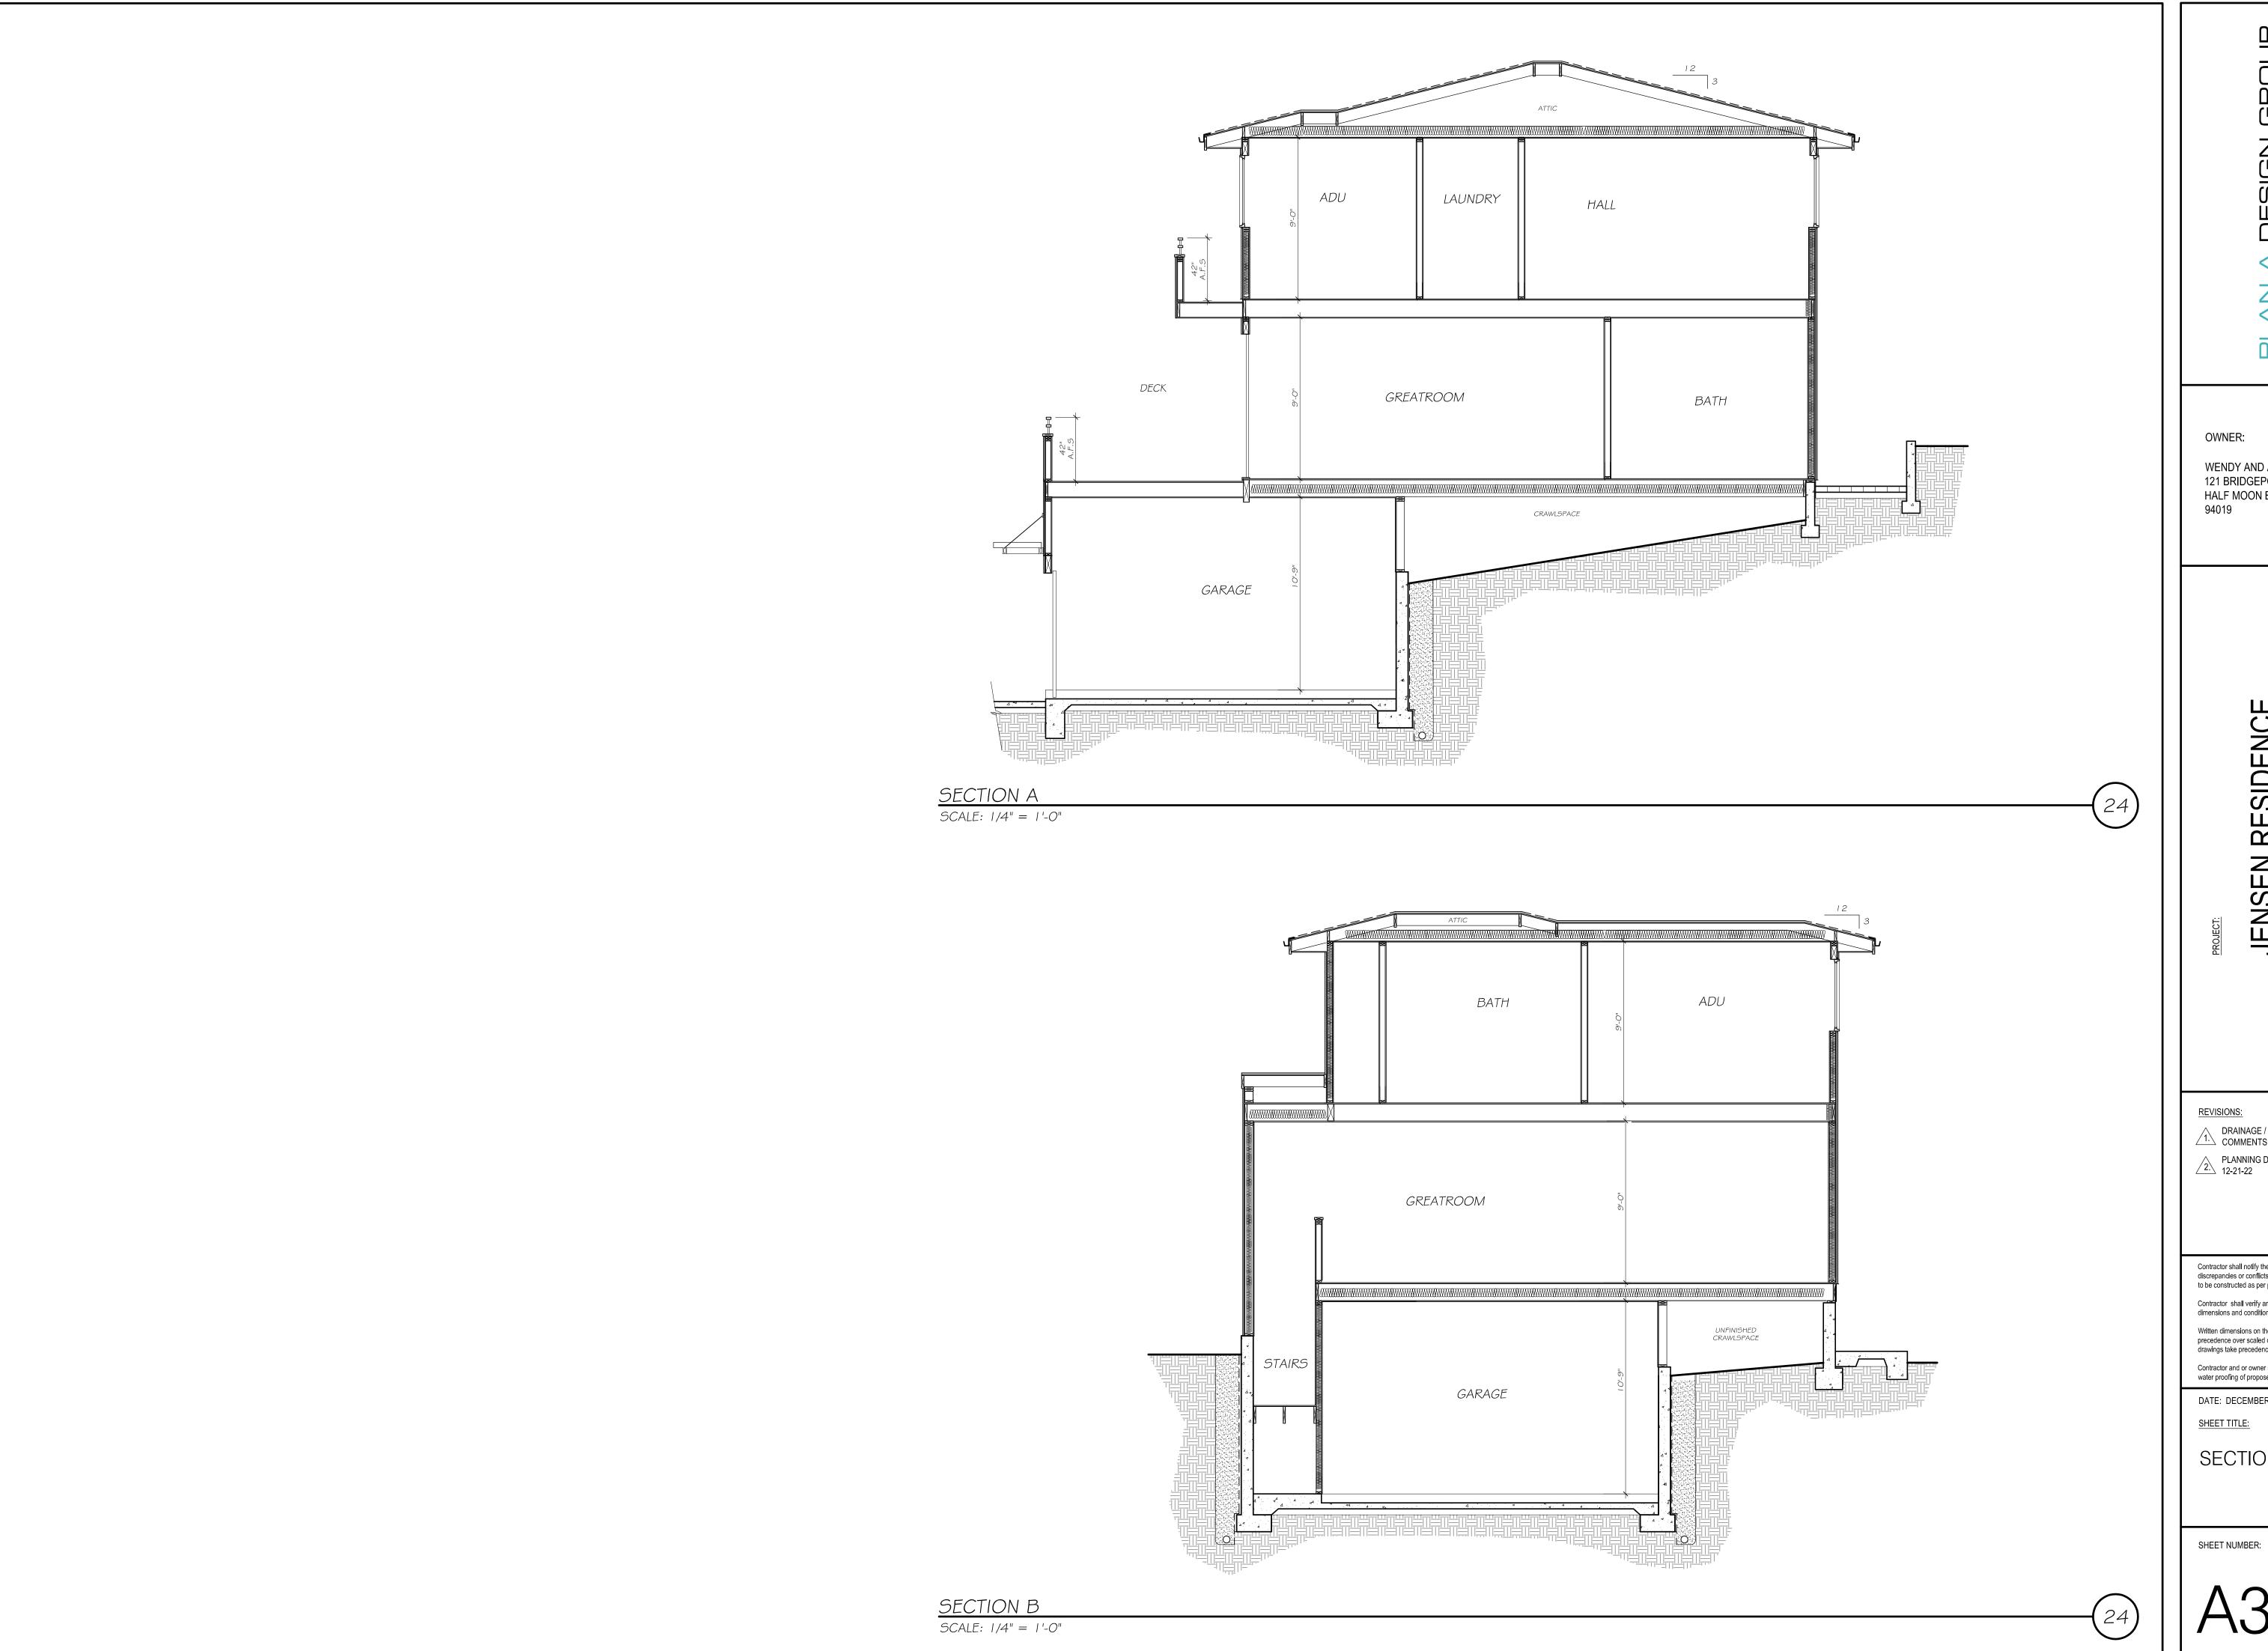
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PROPOSED **EXTERIOR ELEVATIONS**



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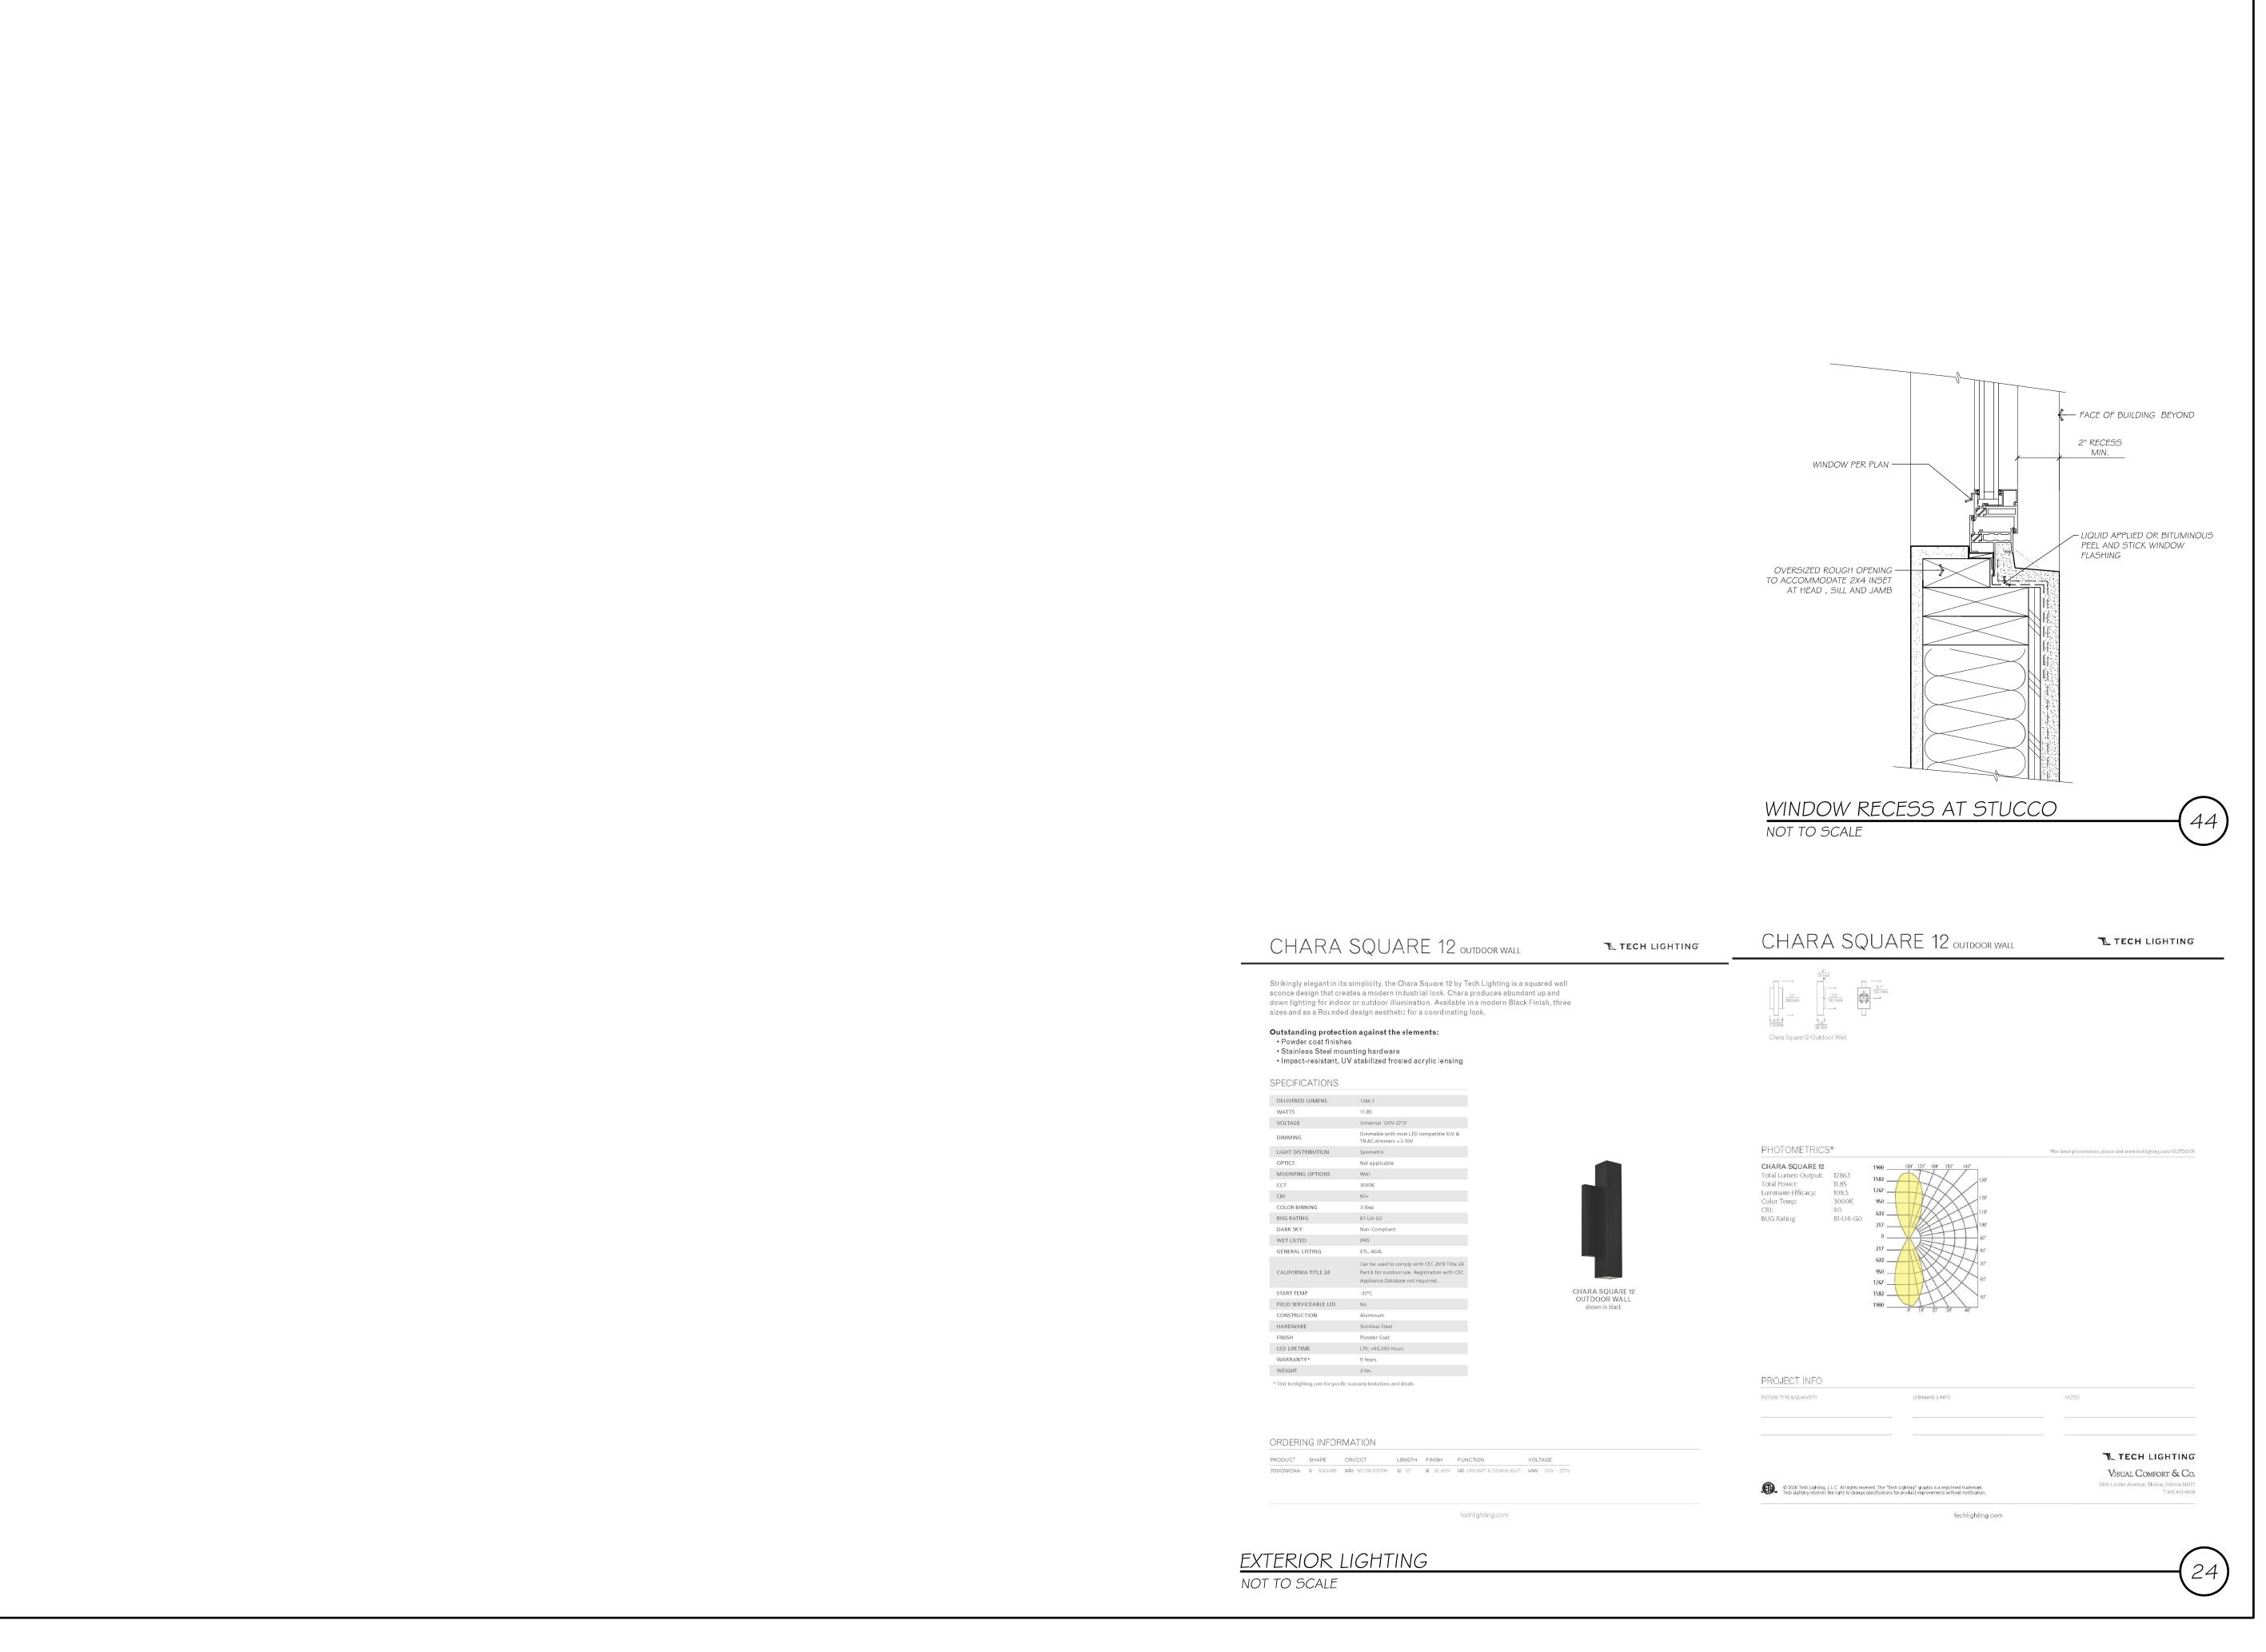
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SECTIONS



LAN A DESIGN GROUP

VISUALIZE DESIGN MANAGE

727 INDUSTRIAL RD. SUITE100 SAN CARLOS, CA
94070

(650) 207-1566 lisa@planadesigngroup.com

OWNER:

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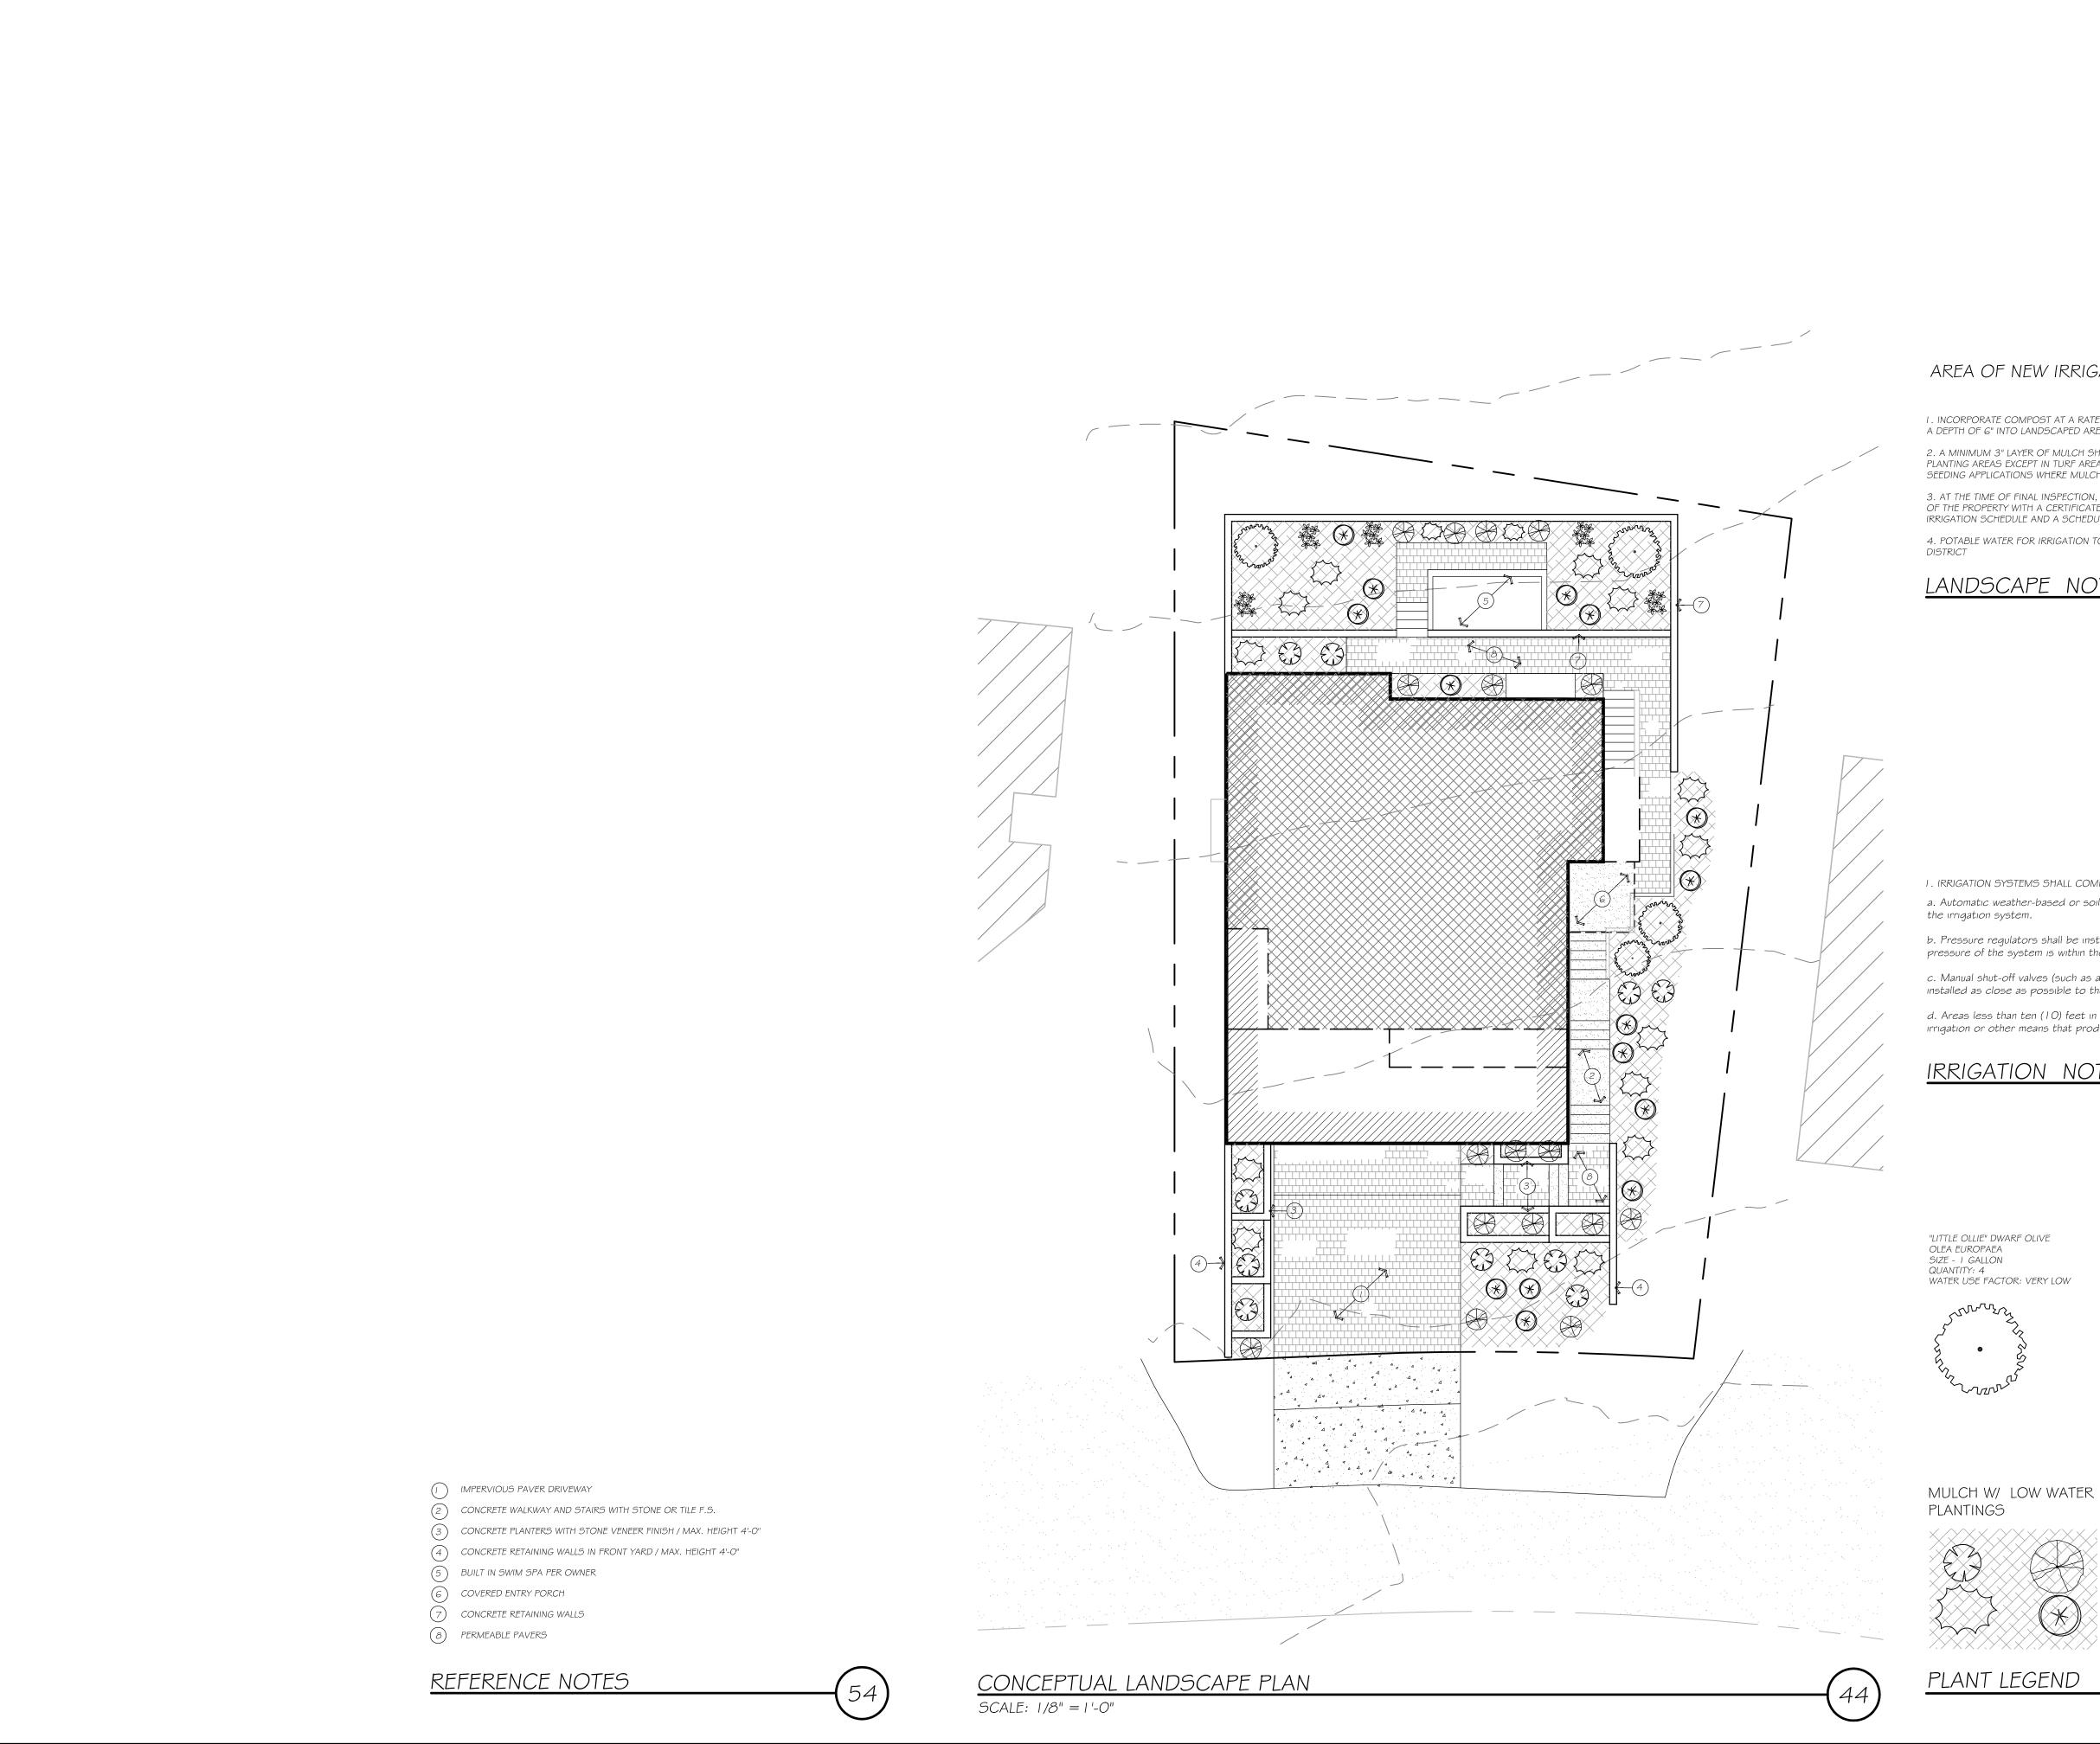
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DATE: DECEMBER 21, 2022
SHEET TITLE:

ARCH DETAILS

SHEET NUMBER:

A4.0



AREA OF NEW IRRIGATED LANDSCAPE = 840 SF

I . INCORPORATE COMPOST AT A RATE OF AT LEAST FOUR CUBIC YARDS PER 1000 SF. TO A DEPTH OF 6" INTO LANDSCAPED AREA (UNLESS CONTRA-INDICATED BY A SOIL TEST) 2. A MINIMUM 3" LAYER OF MULCH SHALL BE APPLIED ON ALL EXPOSED SOIL SURFACES OF PLANTING AREAS EXCEPT IN TURF AREAS, CREEPING OR ROOTING GROUNDCOVER, OR DIRECT SEEDING APPLICATIONS WHERE MULCH IS CONTRA-INDICATED.

3. AT THE TIME OF FINAL INSPECTION, THE PERMIT APPLICANT MUST PROVIDE THE OWNER OF THE PROPERTY WITH A CERTIFICATE OF COMPLETION, CERTIFICATE OF INSTALLATION, IRRIGATION SCHEDULE AND A SCHEDULE OF LANDSCAPE AND IRRIGATION MAINTENANCE. 4. POTABLE WATER FOR IRRIGATION TO BE PROVIDED BY COASTSIDE COUNTY WATER

LANDSCAPE NOTES

I . IRRIGATION SYSTEMS SHALL COMPLY WITH THE FOLLOWING

a. Automatic weather-based or soil moisture based irrigation controllers shall be installed on the irrigation system.

b. Pressure regulators shall be installed on the irrigation system to ensure the dynamic pressure of the system is within the manufacturers recommended pressure range.

c. Manual shut-off valves (such as a gate valve, ball valve, or butterfly valve) shall be installed as close as possible to the point of connection of the water supply.

d. Areas less than ten (10) feet in width in any direction shall be irrigated with subsurface irrigation or other means that produce no runoff or overspray.

IRRIGATION NOTES

"LITTLE OLLIE" DWARF OLIVE OLEA EUROPAEA

WATER USE FACTOR: VERY LOW

MUNSTEAD LAVENDER (LAVANDULA MUNSTEAD) SIZE - I GALLON QUANTITY: 9 WATER USE FACTOR : LOW

LARGE CAPE RUSH CHONDROPETALUM ELEPHANTINUM SIZE - I GALLON QUANTITY: 17 WATER USE FACTOR : LOW

KANGAROO PAW ANIGOZANTHOS SIZE - I GALLON QUANTITY: 16 WATER USE FACTOR : LOW

FOXTAIL AGAVE (AGAVE ATTENUATA) SIZE - I GALLON QUANTITY: 15



PARROTS BEAK VINE LOTUS BERTHELOTII SIZE - I GALLON

WATER USE FACTOR : LOW

OWNER:

WENDY AND ADAM JENSEN 121 BRIDGEPORT DR. HALF MOON BAY,CA

JENSEN RESIDENCE

REVISIONS:

DRAINAGE / WATER DISTRICT $\frac{2}{2}$ 12-21-22

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CONCEPTUAL LANDSCAPE PLAN