E) SSMH #739 DOWNSTREAM APPROXIMATELY 38 LF IN SOUTHEAST DIRECTION, RIM 498.0±, INV 493.5±

LOT 9

UTILITY PLAN


SCALE: 1"=10'

CRYSTAL SPRINGS COUNTY SANITATION DISTRICT NOTES:


- THE PROPERTY/EASEMENT LINE CLEANOUT MUST BE PLACED IN A LOCATION THAT PROVIDES EASY ACCESS FOR MAINTENANCE EQUIPMENT AND IS OUTSIDE OF ANY ENCLOSURES. A MINIMUM OF 6' IS REQUIRED BETWEEN THE PROPERTY LINE CLEANOUT AND STRUCTURE.
- 2. THE PLANS INDICATE THAT THE LOWEST FINISHED FLOOR ELEVATION OF THE PROPOSED MAIN RESIDENCE WILL BE LESS THAN ONE (1) FOOT HIGHER THAN THE RIM ELEVATION OF THE NEAREST UPSTREAM SANITARY SEWER MANHOLÈ. A BACKFLOW PREVENTION OR OVERFLOW DEVICE MUST BE INSTALLED IMMEDIATELY UPSTREAM OF THE REQUIRED CLEANOUT NEAR THE PROPERTY LINE TO PREVENT BACKFLOW OF SEWAGE INTO THE BUILDING/PROPERTY.
- 3. SANITARY SEWER CONNECTION AND TESTING MUST BE MADE IN THE PRESENCE OF A SEWER DISTRICT REPRESENTATIVE. THIS NOTE SHALL BE ADDED TO THE PLANS.
- 4. THE SEWER DISTRICT OFFICE SHALL BE CONTACTED (650-363-4100) TO SCHEDULE INSPECTIONS INSPECTIONS MUST BE SCHEDULED A MINIMUM OF ONE WORKING DAY PRIOR TO THE INSPECTION. NO INSPECTIONS SHALL OCCUR ON FRIDAYS, WEEKENDS OR HOLIDAYS UNLESS SPECIAL ARRANGEMENTS ARE MADE WITH THE SEWER DISTRICT.
- A VIDEO INSPECTION OF THE SEWER MAIN (MANHOLE TO MANHOLE) WHERE THE NEW LATERAL CONNECTS TO THE SEWER DISTRICT MAIN SHALL BE PERFORMED BY THE APPLICANT OR CONTRACTOR AND SUBMITTED TO THE SEWER DISTRICT FOR REVIEW AFTER LATERAL CONNECTION HAS BEEN MADE. THE VIDEO INSPECTION SHALL BE PERFORMED IN ACCORDANCE WITH THE REQUIREMENTS DESCRIBED IN THE SPECIAL PROVISIONS FOR CLOSED CIRCUIT TELEVISION INSPECTION OF SANITARY SEWER MAINS (A COPY CAN BE OBTAINED FROM OUR WEBSITE AT HTTP: //PUBLICWORKS.SMCGOV.ORG/SEWER-SERVICES). THE SEWER DISTRICT WILL REVIEW THE VIDEO INSPECTION TO DETERMINE WHETHER THE WORK PERFORMED IS ACCEPTABLE. ALL UNACCEPTABLE WORK SHALL BE CORRECTED TO THE SEWER DISTRICT'S SATISFACTION AT THE APPLICANT'S EXPENSE.
- 6. CARE MUST BE TAKEN TO PROTECT THE EXISTING SEWER DISTRICT FACILITIES WHEN A NEW SEWER LATERAL AND CONNECTION IS INSTALLED. ANY DAMAGES TO THE SEWER DISTRICT FACILITIES DURING THE INSTALLATION OF THE NEW LATERAL SHALL BE REPAIRED BY THE APPLICANT PER THE SEWER DISTRICT STANDARD DETAILS AND AT THE APPLICANT'S EXPENSE. THE SEWER DISTRICT MUST BE NOTIFIED OF ANY DAMAGES TO THE SANITARY SEWER FACILITIES AND ANY REPAIRS MUST BE INSPECTED BY A SEWER DISTRICT REPRESENTATIVE
- 7. LATERAL CONNECTION TO THE EXISTING MANHOLE SHALL BE MADE BY CORE DRILLING A HOLE IN THE MANHOLE WALL APPROPRIATELY SIZED FOR THE SEWER LATERAL PIPE. THE ANNULAR SPACE BETWEEN THE WALL AND PIPE SHALL BE PLUGGED WITH MORTAR CEMENT. AFTER THE ANNULAR SPACE HAS BEEN PLUGGED, THE INTERIOR OF THE ENTIRE MANHOLE SHALL BE COATED WITH AN APPROVED WATERPROOFING MATERIAL APPLIED PER THE MANUFACTURER'S RECOMMENDATIONS.
- 8. THE CONTRACTOR MUST REMOVE AND DISPOSE OF ALL CONSTRUCTION DEBRIS IN THE MANHOLE AFTER THE LATERAL CONNECTION HAS BEEN MADE. CARE MUST BE TAKEN TO PREVENT CONSTRUCTION DEBRIS FROM ENTERING THE SEWER SYSTEM DURING THE INSTALLATION OF THE NEW SEWER LATERAL CONNECTION. IF THE SEWER DISTRICT DISCOVERED THAT CONSTRUCTION DEBRIS HAS ENTERED THE SEWER SYSTEM, THE APPLICANT WILL BE RESPONSIBLE TO CLEAN AND TELEVISE THE DOWNSTREAM PORTIONS OF THE SEWER MAINS AS DETERMINED BY THE SEWER DISTRICT TO THE SEWER DISTRICT'S SATISFACTION. SANITARY SEWER SERVICE SHALL BE MAINTAINED AT ALL TIMES. THE CONTRACTOR SHALL USE WHATEVER MEANS NECESSARY (E.G. PUMPS, ETC.) TO MAINTAIN THIS SERVICE DURING CONSTRUCTION.

NOTES:


- 1. PER THE GEOTECHNICAL REPORT, UNDOCUMENTED FILL WAS MAPPED AT LOT 9 AND IF THIS FILL IS TO BE LEFT IN PLACE DURING HOUSE AND DRIVEWAY GRADING, IT SHOULD BE REMOVED AND REPLACED AS PROPERLY COMPACTED ENGINEERED
- 2. PER THE GEOTECHNICAL REPORT, ALL EXISTING FILLS SHOULD BE COMPLETELY REMOVED FROM WITHIN PROPOSED HOUSE FOOTPRINT AND DRIVEWAY AREAS AND TO A LATERAL DISTANCE OF AT LEAST 5 FEET BEYOND THE EDGE OF THE IMPROVEMENTS OR AS RECOMMENDED BY THE GEOTECHNICAL ENGINEER. ANY EXCESS MATERIAL SHALL BE DISPOSED OF OFF-SITE IN A LAWFUL MANNER.
- 3. PER THE GEOTECHNICAL REPORT, GEOTECHNICAL MITIGATION GRADING WILL BE PERFORMED ON LOT 9, SEE SHEETS C9.91 AND C9.92 FOR GRADING DETAILS OF THE MITIGATION
- 4. PER THE GEOTECHNICAL REPORT, ALL BUILDING AND RETAINING WALLS SHOULD BE SUPPORTED ON DRILLED PIERS. THE

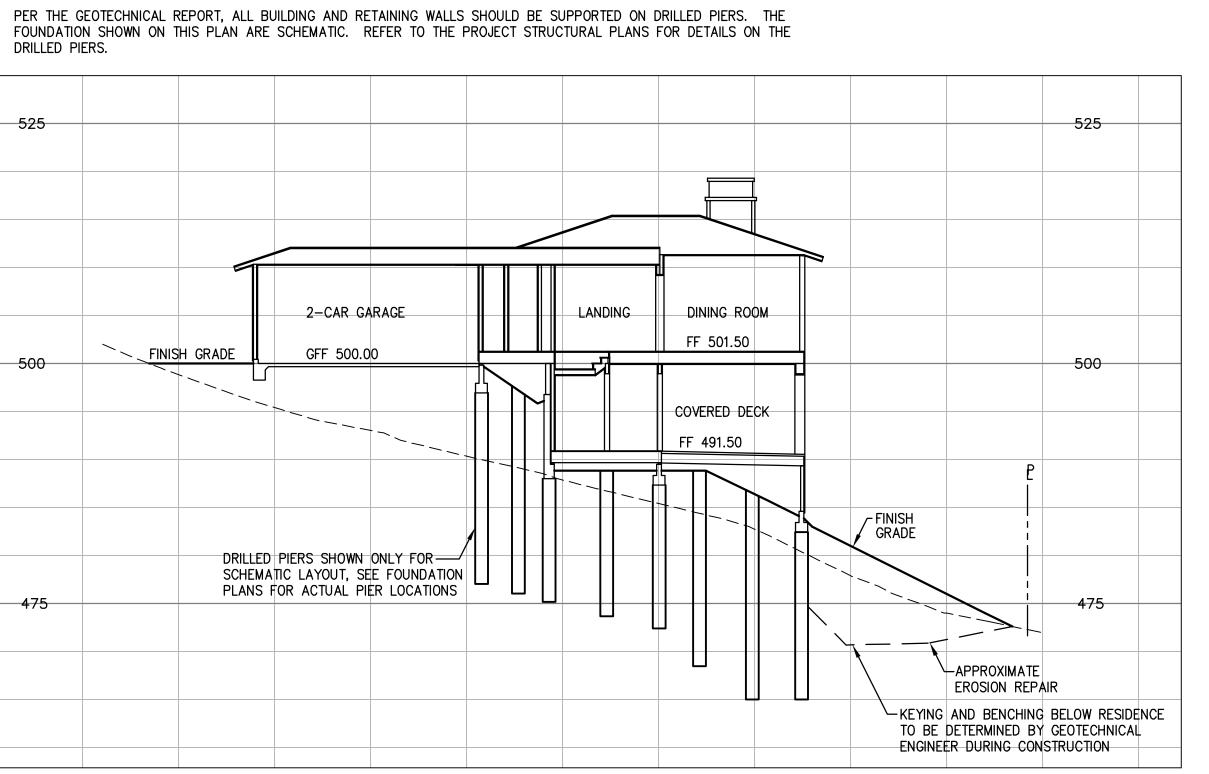

LOT 9 CROSS SECTION A-A SCALE: 1"=10'

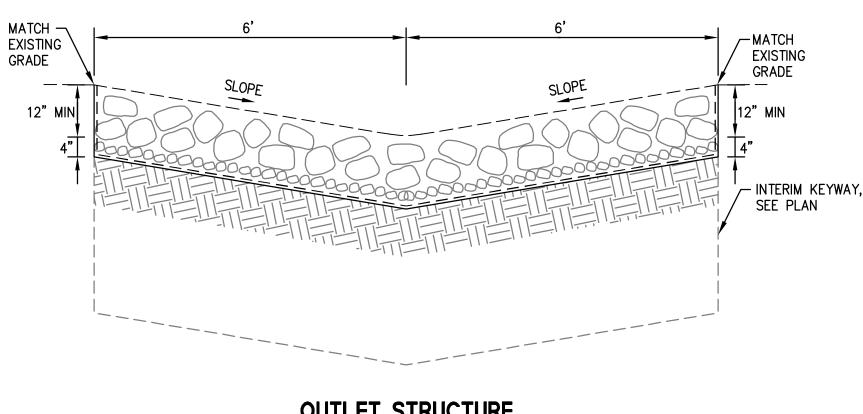

OUTLET STRUCTURE CROSS SECTION B-B

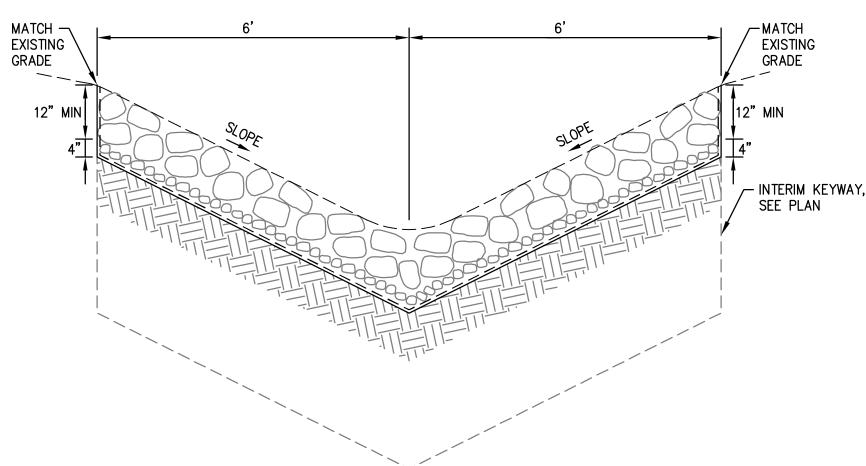

OUTLET STRUCTURE

CROSS SECTION C-C

HIGHLAND 9 IMPROV ITY PLAN ANI SAN MATE 다 등 등

Sheet Number: C9.40 OF

TOP OF PLANTER ELEV PER PLAN

‱H⊟ LINE SIDEWALLS AND BOTTOM WITH

IMPERMEABLE FABRIC MEMBRANE

BOT OF PLANTER ELEV PER PLAN

Sheet Number: C9.70 OF

- CURB BEYOND DETAIL "A"

SAN MATEO COUNTY DEPARTMENT

PUBLIC WORKS

REDWOOD CITY

CALIFORNIA

NON-PERFORATED

REMOVE STANDARD -

FINISH GRADE

VALVE OPENS TO A ALLOW

WASTE WATER TO FLOW

VALVE CLOSES BY ITS

OWN WEIGHT TO PREVENT

WASTEWATER FROM FLOWING

BACK TO HOUSE LATERAL.

INTO SEWER MAIN:

CLEANOUT PLUG

SCALE: NONE

DATE: <u>6/95</u>

REVISED: _____

ALUMINUM CONE

~ 3" OR 3-1/2" N.P.T.

OR PLAIN END

NOTE: LOCATION OF DEVICE TO APPROVAL OF

NOTE: LOCATION OF DEVICE

APPROVAL OF

DISTRICT AND BUILDING DEPARTMENT PRIOR TO INSTALLATION

DISTRICT AND BUILDING

DEPARTMENT PRIOR

TO INSTALLATION

DRAWN BY: N.M.A.

TO MAIN

APPROVED BY: N.R.C.

FLOOR LEVEL

TO BUILDING

__ BACKWATER

OVERFLOW

OVERFLOW DEVICE

TO SEWER MAIN

BACKFLOW DEVICE

SEE DETAIL "A"-

-FLOW LINE PER PLAN

FG PER PLAN-

OVERFLOW AND BACKFLOW DEVICE DETAIL

C-9

SAN MATEO COUNTY

OVERFLOW AND BACKFLOW DEVICE DETAIL

SECTION B

FRONT VIEW

CURB CUT

NTS

CENTER CURB OPENING AT PARKING STALL

45.

TC PER PLAN

FLOW LINE

STRIPE, SEE PLAN FOR LOCATIONS

DEVICE

CHECK BY:

UPSTREAM

STRUCTURE -

18" GUTTER

SECTION A

#4 LONGITUDINAL BARS (TYP)

TC PER PLAN-


FG PER PLAN -

OF DRAWN BY: N.M.A. PUBLIC WORKS CHECK BY: J.A.L. APPROVED BY: N.R.C. REDWOOD CITY CALIFORNIA - CENTERLINE OF RIGHT OF WAY TRAVELED WAY STREET SECTION DRIVEWAY PLAN VIEW - CENTERLINE OF RIGHT OF WAY COUNTY STANDARD STREET SECTION EXISTING GROUND — WDTH VARIES DEPENDENT ON ZONING - 22' TO 40' EXISTING GROUND WHEN EXISTING STANDARD CURB, GUTTER AND/OR SIDEWALK DO NOT EXIST, THE DRIVEWAY ELEVATION AT THE FUTURE PROPERTY LINE SHALL BE EQUAL TO THE EXISTING CENTERLINE ELEVATION UNLESS FUTURE STREET GRADES HAVE BEEN ESTABLISHED BY THE COUNTY. DRIVEWAY PROFILE VIEW D-7

SAN MATEO COUNTY DRIVEWAY PLAN AND PROFILE VIEWS

CHRISTY "F8" VALVE BOX W/ "F8D" REINFORCED -CONCRETE LID OR APPROVED EQUAL -FINISHED GRADE IN LANDSCAPE AREA NOTE: ALL PVC PIPE TO BE SDR 26. -6" PVC RISER W/ CAP TAPE TRACER WIRE AT 3' INTERVAL W/ FILAMENT TAPE. CLAMP TRACER WIRE TO TOP OF RISER. END OF LINE 6"X(SIZE OF LINE)

CLEANOUT NTS

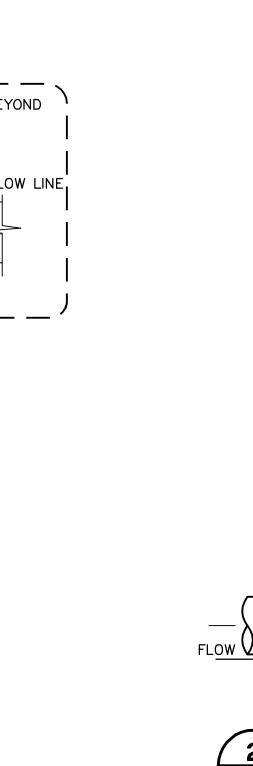

2' CONTOUR INTERVALS SARAGE PAD PROPOSED DRIVEWAY SLOPE – UPHILL OR DOWNHILL —— (20% MAX.) ____ VAIION GARAGE PAD -

SAN MATEO COUNTY DEPARTMENT

SCALE: NONE

REVISED: ___

DATE: <u>6/95</u>

GARAGE

PAD



12" CALTRANS CLASS II PERMEABLE NON-COMPACTED MATERIAL (PER

3" MINIMUM MULCH

18" MINIMUM **BIORETENTION SOIL**

MEDIA (BSM)

SECTION 68-1.025

FLOW-THROUGH PLANTER (FTP) NTS

SAN MATEO COUNTY DEPARTMENT

OF

PUBLIC WORKS

REDWOOD CITY

CALIFORNIA

NO HUB COUPLING

NO HUB COUPLING

STAINLESS STEEL

4 BAND WITH

SHEAR RING

ADJUSTABLE REPAIR COUPLING

STAINLESS STEEL SHEAR RING.

- (ARC) WITH CONTINUOUS

4 BAND WITH STAINLESS STEEL

SHEAR RING

-45" WYE BRANCH

DRAWN BY: N.M.

APPROVED BY: _

CHECK BY: A.M.S.
APPROVED BY: N.R.C.

WYE AND RISER SHALL BE THE SAME PIPE MATERIAL AS THE PORTION OF THE

LATERAL WHICH

FLOW

WYE AND RISER SHALL

BE THE SAME PIPE MATERIAL AS THE

PORTION OF THE

LATERAL WHICH

. WHEN BOX IS SUBJECT TO TRAFFIC LOADING, PROVIDE CAST IRON LID.

-SD POP-UP EMITTER BUBBLE-UP

ROCK PROTECTION @ OUTLET

 $(2"-4" \phi ROCK - 2' WIDE)$

. BOX TO BE PLACED SUCH THAT CLEANOUT CAP CAN BE EASILY REMOVED, SEE ILLUSTRATION.

CONSTRUCTION OF A STANDARD CLEANOUT REQUIRES MULTIPLE INSPECTIONS BY DISTRICT PERSONEL:

2. SECOND INSPECTION - TO INSPECT PLACEMENT OF BOX, LID AND LOCATION OF CLEANOUT WITHIN BOX

1. FIRST INSPECTION - TO INSPECT WYE AND RISER, WYE AND RISER MUST BE EXPOSED.

3. PROPERTY OWNER IS RESPONSIBLE FOR MAINTAINING LATERAL FROM THE PROPERTY STRUCTURE TO DISTRICT MAIN. DISTRICT PROVIDES COURTESY SERVICE FROM DISTRICT STANDARD PROPERTY LINE CLEANOUT TO THE MAIN.

4. SDR-26 WYE, RISER, CLEANOUT BODY AND CAP CAN BE USED ONLY WHEN LATERAL FROM PROPERTY LINE TO

5. WHEN ENTIRE LATERAL IS REPLACED, LATERAL FROM PROPERTY LINE CLEANOUT TO MAIN LINE SHALL HAVE A 14-1-UF GUAGE MINIMUM SINGLE CONDUCTOR TRACER WIRE TAPED TO THE ENTIRE LENGTH OF THE PIPE.

SAN MATEO COUNTY

TYPICAL SEWER CLEANOUT & BOX DETAIL

OVERFLOW INLET AND CATCH BASIN PART NO. 932 NDS 9" ATRIUM

CLEANOUT, ŞEE DETAIL 3

—— 6" OVERFLOW PIPE, TO SD SYSTEM

GRATE PART NO. 981

—6" ØVERFLOW

CONNECTS TO THE

SEWER MAIN; EXCEPT

THE UPPER-MOST 3 FEET OF A VCP RISER

SHALL BE CAST IRON.

CONNECTS TO THE

SEWER MAIN; EXCEPT

SHALL BE CAST IRON.

TRANSITION SECTION-

IF NEEDED

45° WYE BRANCH -

MAIN LINE IS REPLACED WITH SDR-26.

THE UPPER-MOST 3 FEET OF A VCP RISER SCALE: NONE DATE: 8/06

REVISED: _____

FOR CAST IRON CLEANOUT BODY, USE EITHER BRASS OR PVC PLUG. FOR PVC CLEANOUT BODY, USE PVC PLUG.

CHRISTY B9 UTILITY BOX OR

OR FL9D, MARKED SEWER, OR

EQUAL. LID TO BE CHRISTY BOD

EQUAL (SEE NOTE 1)

TYPICAL SEWER CLEANOUT &

FOR CAST IRON CLEANOUT BODY, USE
— EITHER BRASS OR PVC PLUG. FOR PVC

CLEANOUT BODY, USE PVC PLUG.

CHRISTY B9 UTILITY BOX OR

EQUAL. (SEE NOTE 1)

TYPICAL SEWER CLEANOUT &

BOX DETAIL - REPLACEMENT


EQUAL, LID TO BE CHRISTY B9D


OR FL9D, MARKED SEWER, OR

BOX DETAIL - NEW CONSTRUCTION

4" PERFORATED PVC PIPE, S = 0.5% MINIMUM,

PERFORATIONS DOWN (INTO PAGE), 4" FROM BOTTOM

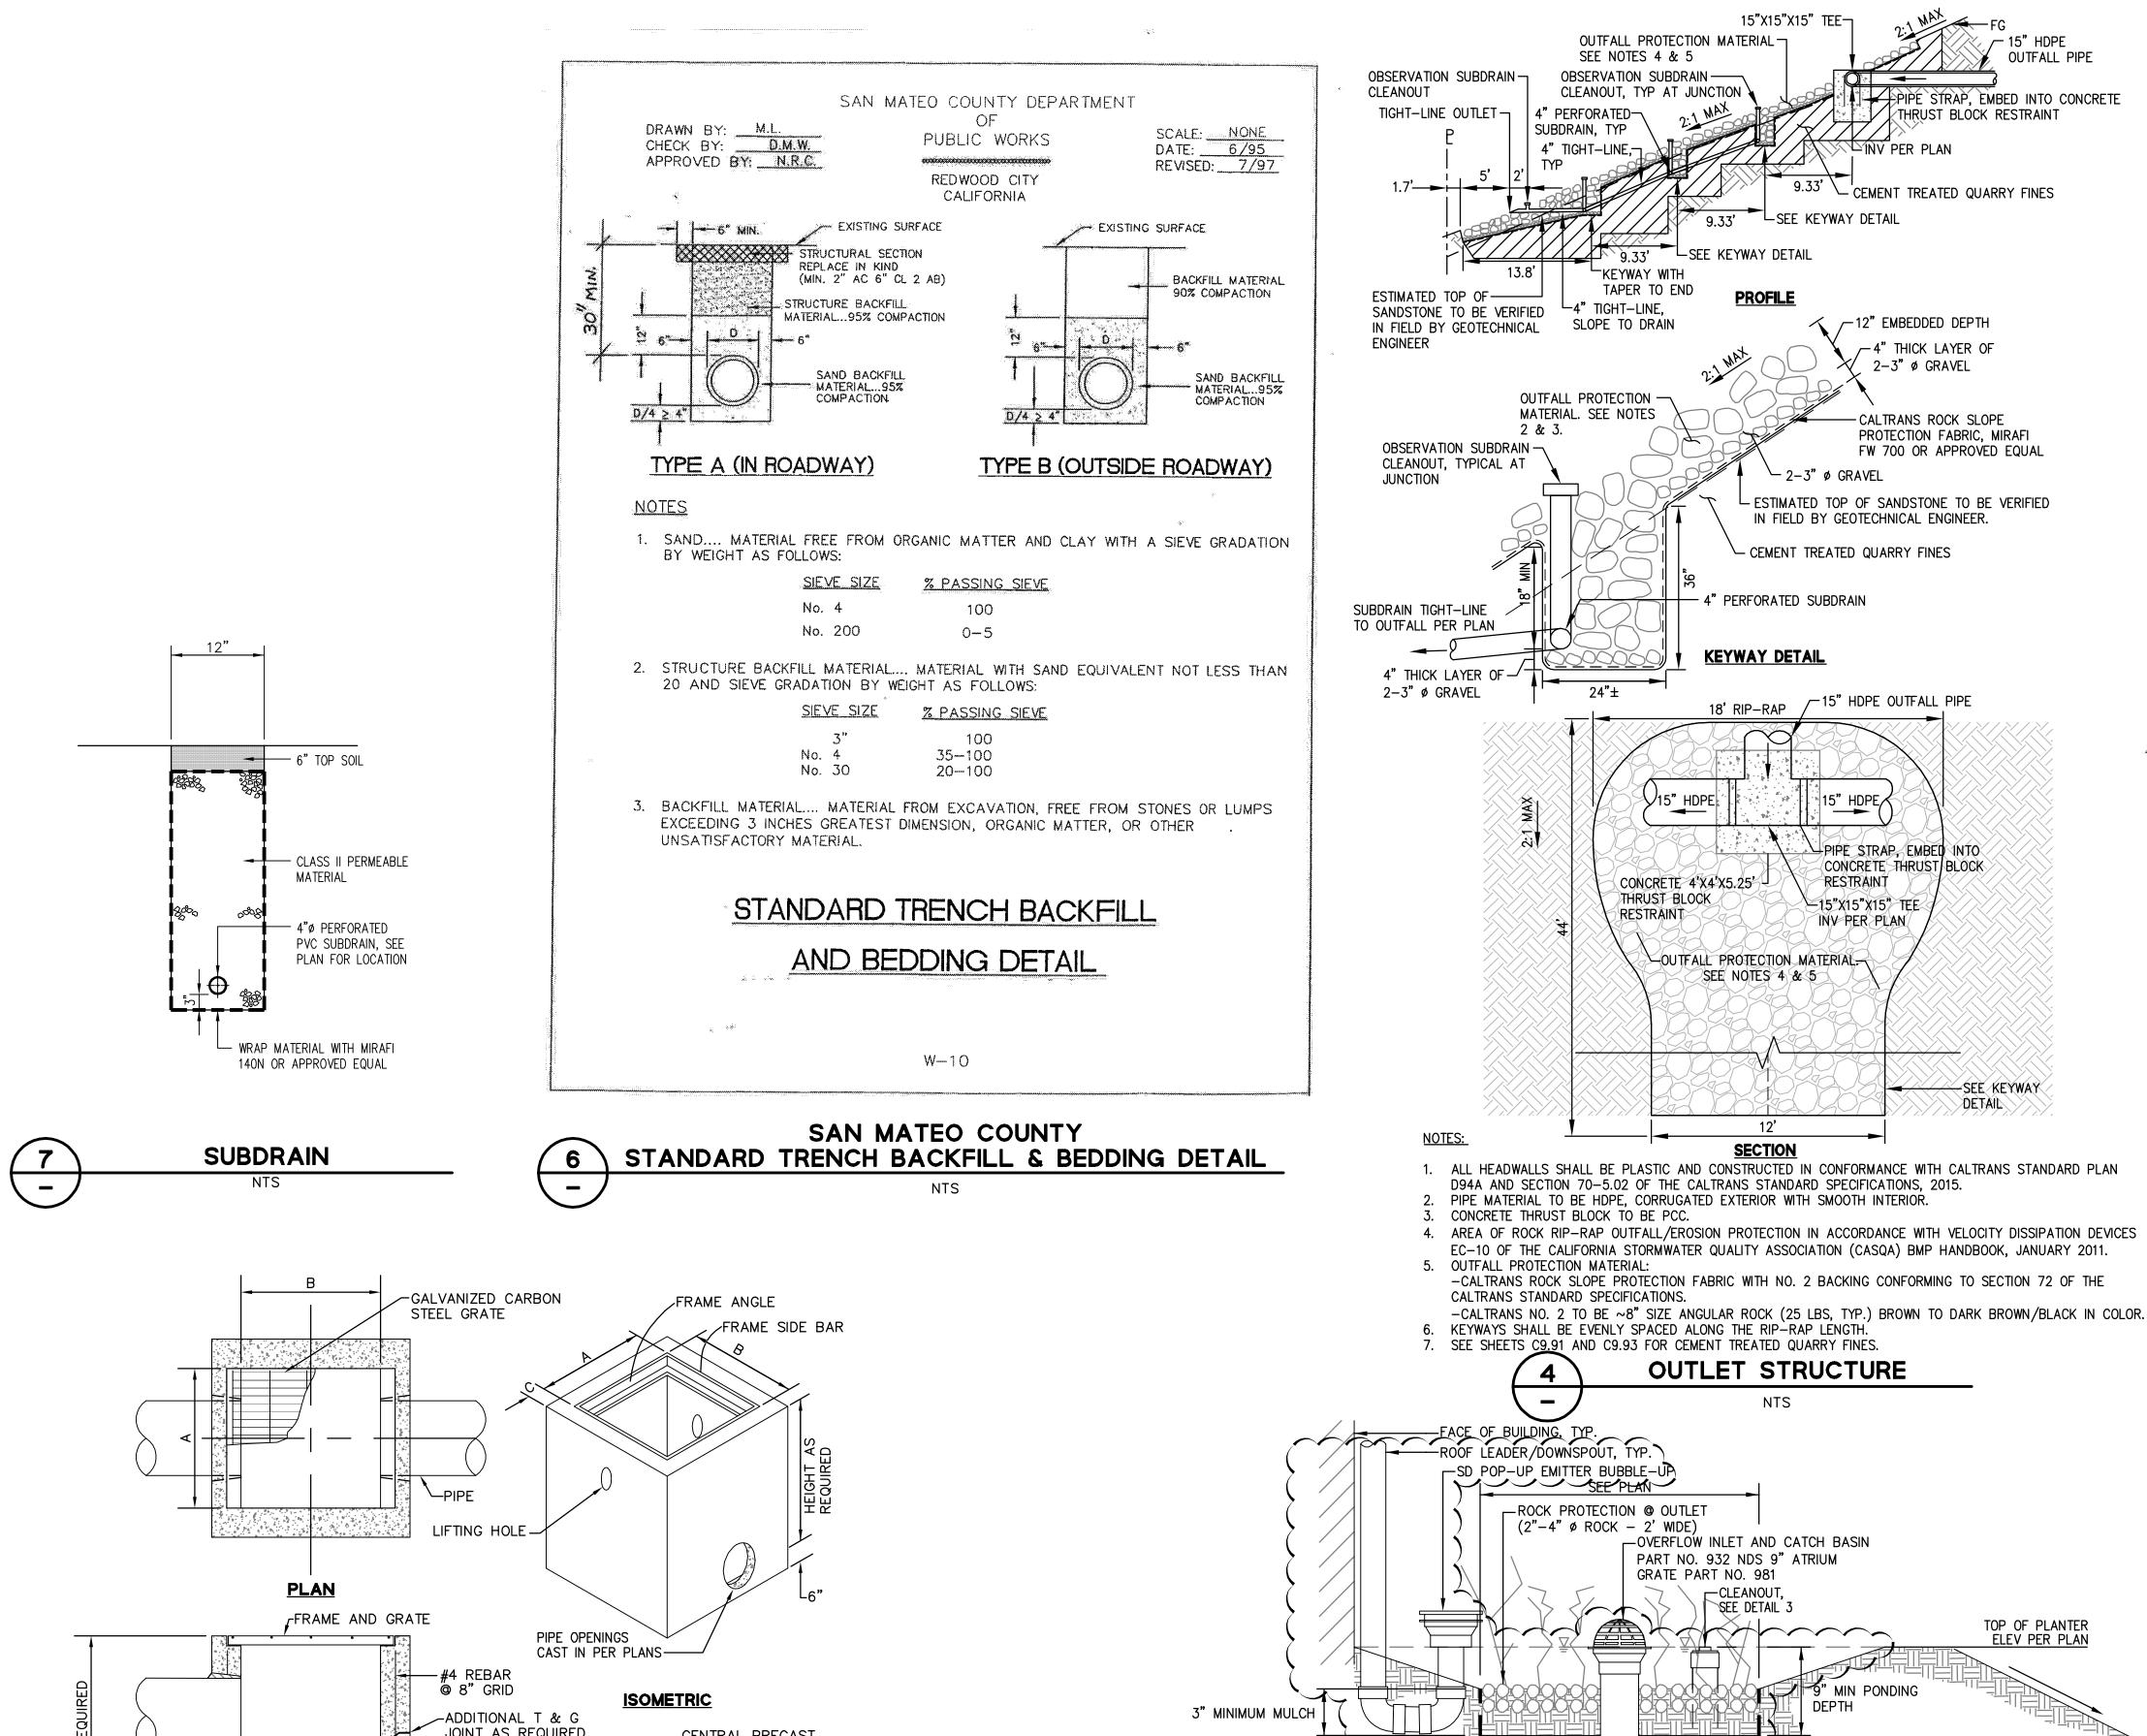

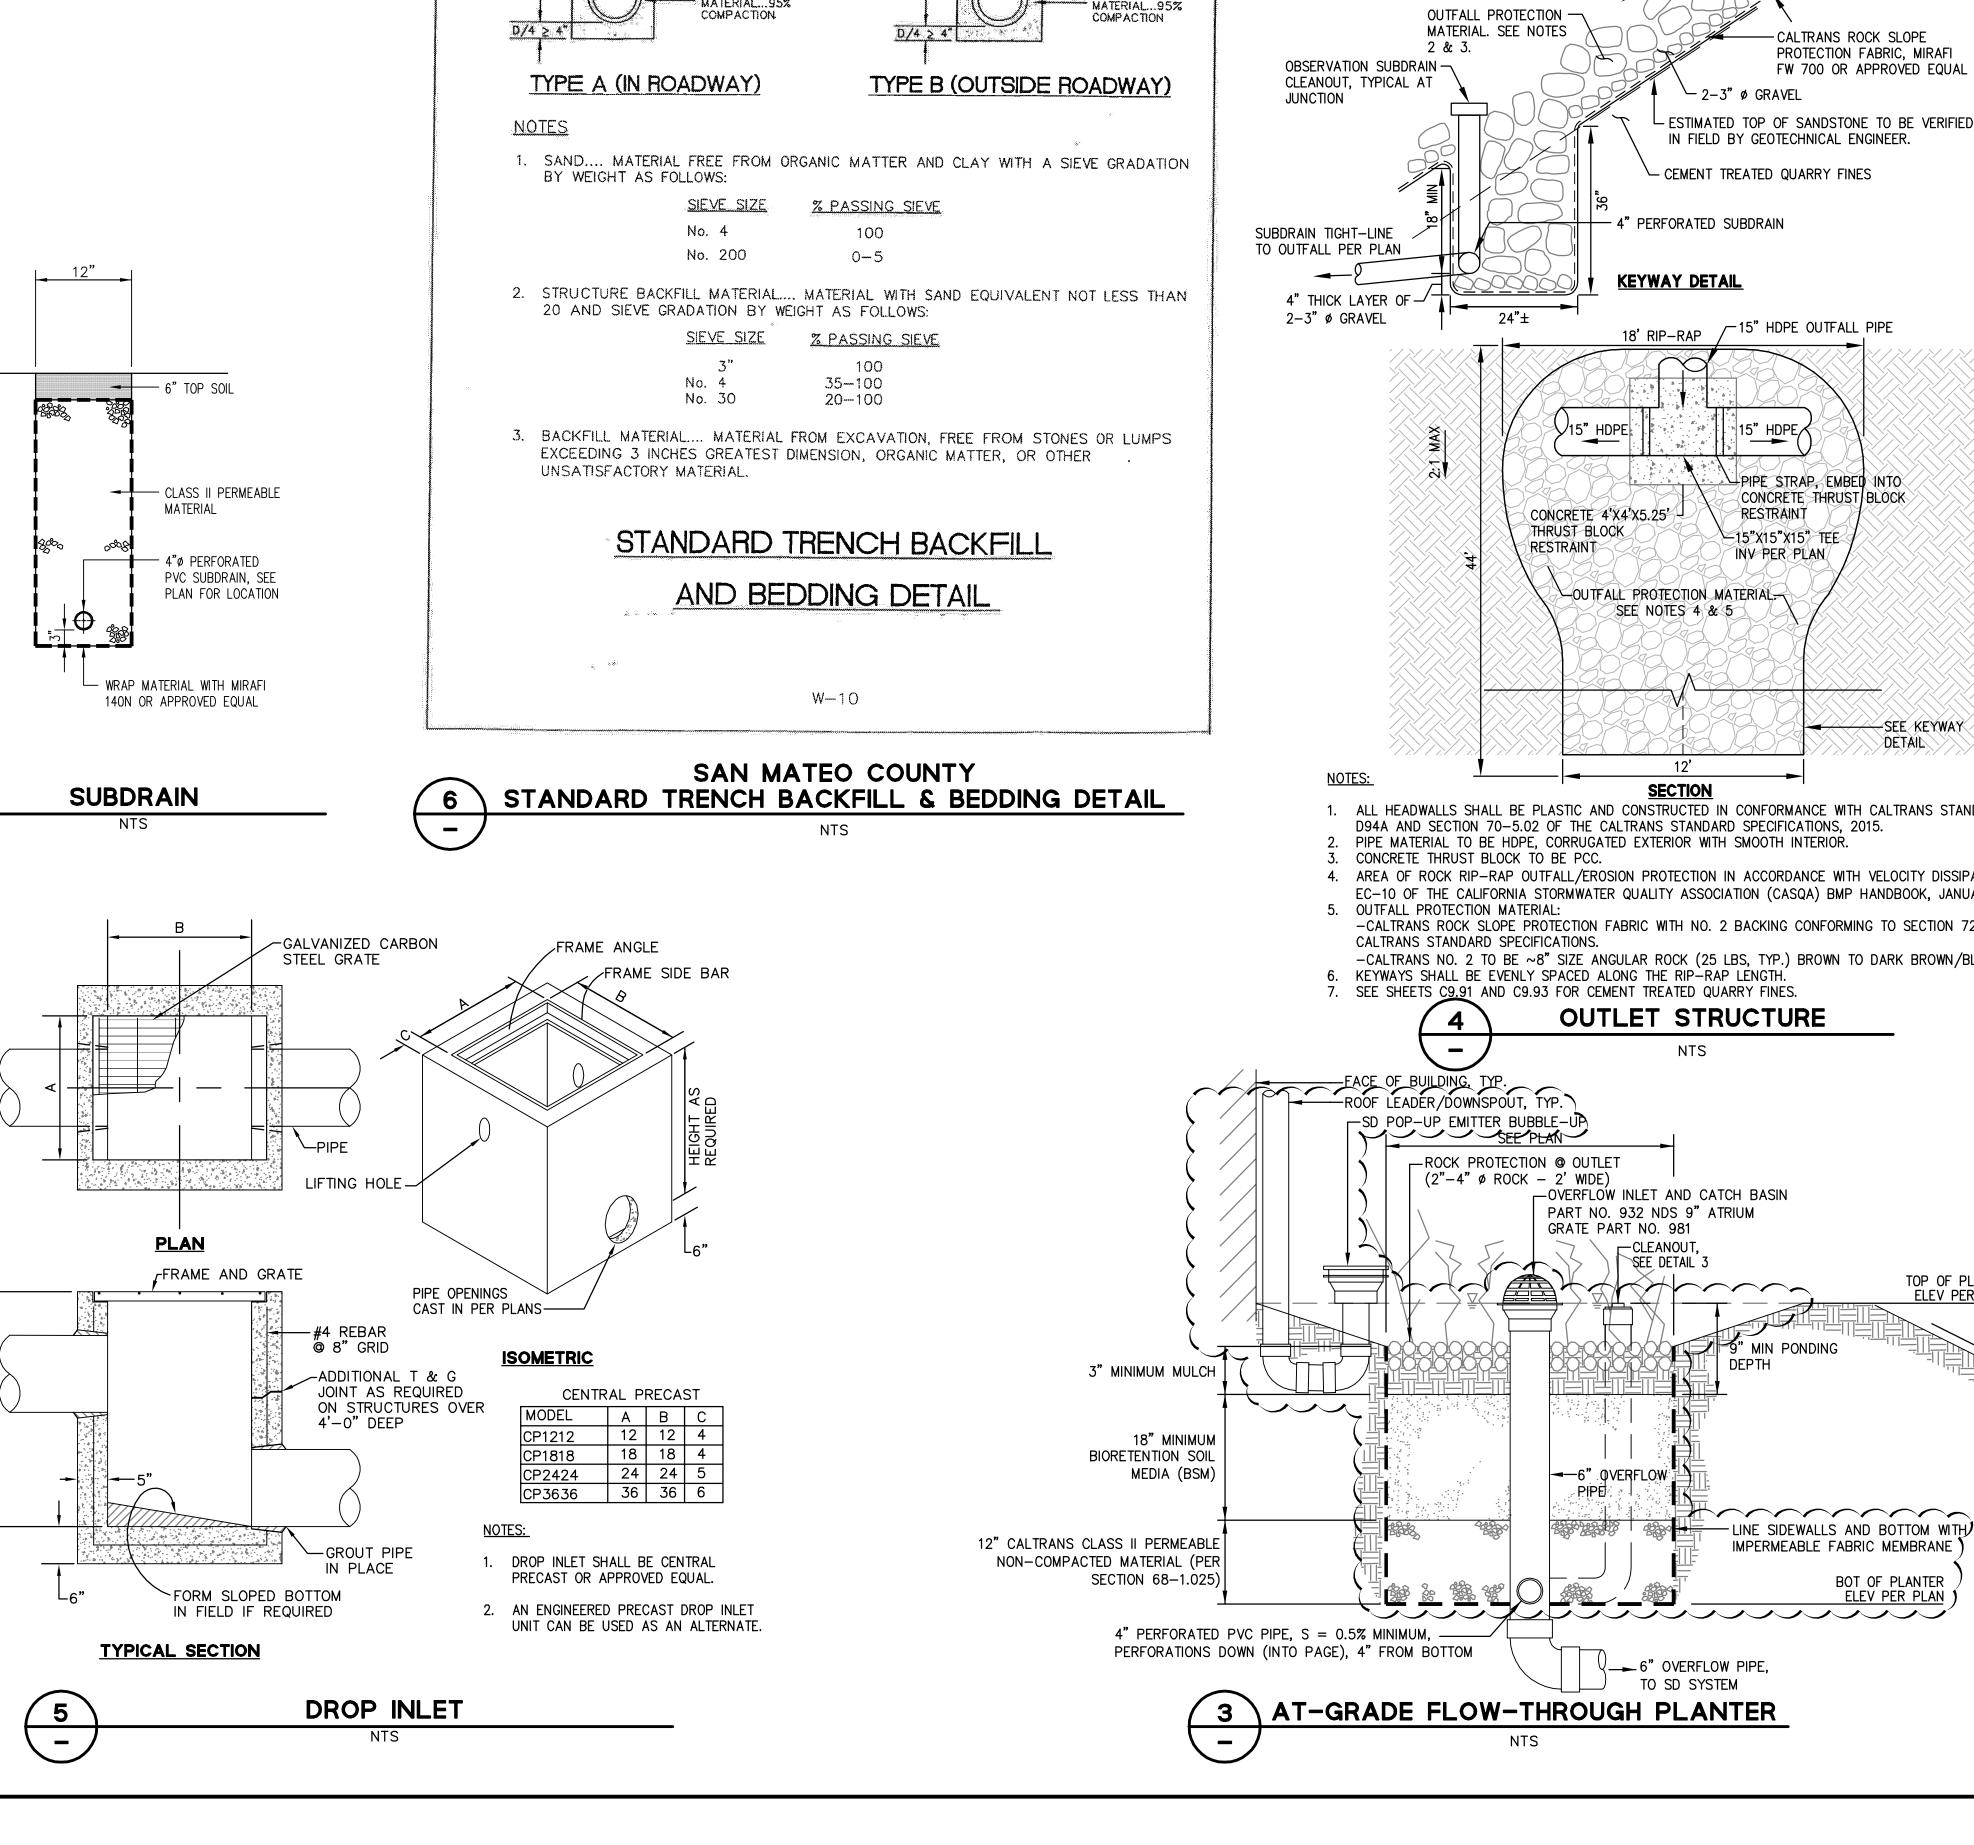

C-2

MANHOLE FRAME AND COVER

USE STORM

DRAIN FOR

DRAINAGE

STORM

SYSTEM

OF

PUBLIC WORKS

REDWOOD CITY

CALIFORNIA

- GROUT HOLES 4-EQUALLY

- CURVED BLIND

3/4" Ø HOLE

FOR LOCKING

MECHANISM

- 3/8" ø U-BOLT & NUT

INSIDE RADIUS OF BEND IN U-BOLT TO BE 1 1/4'

PICKHOLE

SPACED

DRAWN BY: M.L.
CHECK BY: R.O.

* ALL MATERIALS USED SHALL CONFORM TO ASTM SPEC.

A-159-70T-G3000 OR U.S. GOV'T SPEC. QQ1-653

_ 26 1/4"MIN.-26 5/8"MAX.

2" 3/8" 1/2"-2" STEEL BAR FOR STRAP

- CLASS "A"

* MANHOLE STRAP TO BE USED IN OFF ROAD AREA WHERE SPECIFIED BY THE ENGINEER

* U-BOLTS, NUT & STRAP SHALL BE HOT DIP GALVANIZED

SANITARY SEWER

MANHOLE COVER, FRAME

AND STRAP DETAIL

— 1" x 2" x 5" STEEL BAR

AFTER FABRICATION

APPROVED BY: N.R.C.

GENERAL NOTE:

MFGR'S NAME -

ASTM GRID

PATTERN

DRAWN BY: CHECK BY: APPROVED BY: N.R.C.

PUBLIC WORKS REDWOOD CITY CALIFORNIA

PAVEMENT PAVEMENT FRAME AND #4 HOOP -GRADE RING (IF NEEDED) 12" MAX. CLEAN JOINT AND INSTALL PREFORMED PLASTIC SEALING GASKET PRIOR TO SETTING -NEXT BARREL OR CONE SECTION FORM RECESS IN BASE WITH APPROVED METAL FORMING RING TO RECEIVE PRECAST MANHOLE JOINT. INSTALL PREFORMED PLASTIC SEALING GASKET BEFORE PLACING FIRST BARREL OR CONE SECTION #4 @ 12" GRID REINFORCED CLASS "A" CONCRETE BASE -

 ALL STEEL TO BE 3" CLEAR. 2. LAY PIPE THRU M.H. WHEN POSSIBLE. 3. M.H. SHELF SHALL BE

MORTARED TO A SLOPE OF

4. THERE SHALL BE NO STEPS IN THE MANHOLE. 5. PREFORMED PLASTIC SEALING GASKET SHALL BE "RAM-NEK"

OR APPROVED EQUAL. 6. IN THE EVENT PVC OR ABS PIPES ARE APPROVED. STANDARD WATER STOPS SHALL BE INCORPORATED INTO THE MANHOLE BASE

 OTHER APPLICABLE DETAIL: C-2 8. MANHOLE THROAT LOCATION TO BE OPPOSITE THE LARGEST SHELF AREA OR AS DIRECTED BY THE ENGINEER

SANITARY SEWER MANHOLE DETAIL

MANHOLE (PIPES 6" TO 21")