



SITE DATA:

APN: 037-123-560 ZONING: R-1/5-17/DR/CD OCCUPANCY GROUP:R-3/U TYPE OF CONSTRUCTION: V-B

PRE: 2021-00002 PLN: 2021-00267

OWNER:

ARCHITECT:

GEOTECHNICAL: ENGINEERS:

STRUCTURAL ENGINEER:

LANDSCAPING:

APPLICABLE CODES:

SAN MATEO COUNTY ZONING & BUILDING ORDINANCES

2019 CALIFORNIA RESIDENTIAL CODE

2019 CALIFORNIA MECHANICAL CODE
2019 CALIFORNIA PLUMBING CODE
2019 CALIFORNIA ELECTRICAL CODE
2019 CALIFORNIA ENERGY CODE
2019 CALIFORNIA FIRE CODE
2019 CALIFORNIA GREEN BUILDING STANDARDS CODE

HEMA & SUNDAR RAJ 10513 PERALTA RD CUPERTINO, CA 95014 650.938.6231

dpsundar@yahoo.com

720 MILL ST

EDWARD C LOVE, ARCHITECT

HALF MOON BAY, CA 94019 650.728.7615 edwardclovearch@gmail.com

SIGMA PRIME GEOSCIENCES, INC 332 PRINCETON AVE HALF MOON BAY, CA 94019 650.728.3590

BLUESKY DESIGNS, INC 495 PURISIMA WAY

650.726.5990

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HALF MOON BAY, CA 94019

ınfo@blueskydesıgnsınc.com


	EXISTING		PROPOSED		TOTAL		ALLOWED	
	AREA (SQFT)	%	AREA (SQFT)	%	AREA (SQFT)	%	AREA (SQFT)	%
LOT AREA	11586							
LOT COVERAGE	0	0.0	2967	25.6	2967	25.6	4055	35.0
FLOOR AREA			FIRST FLR 1360 SECOND FLR 1383 GARAGE 517		FIRST FLR 1360 SECOND FLR 1383 GARAGE 517			
	Total O	0.0	Total 3260	28.1	Total 3260	28.1	Total 6141	53.0

SCOPE OF WORK:
CONSTRUCTION OF NEW SINGLE FAMILY RESIDENCE
WITH ATTACHED GARAGE


NOTE:


I. TO BE FIRE SPRINKLERED (FS). FS WILL BE UNDER A SEPARATE PERMIT.


S	heet List - DD
Sheet	
Number	Sheet Name
\	
AO.01	Cover Sheet
SU.I	Survey
A0.03	Site Plan
C. I	Grading & Drainage
C.2	Erosion Control
C.3	Best Management Practices
A1.01	First Floor Plan
A1.02	Second Floor Plan
A1.04	Roof Plan & Floor Area Calculations
A2.01	Elevations - North
A2.02	Elevations - West & South
A2.03	Elevations - East
A2.04	Line of Sight
A3.01	Section Views
A5.01	Details
L. I	Landscape Plan

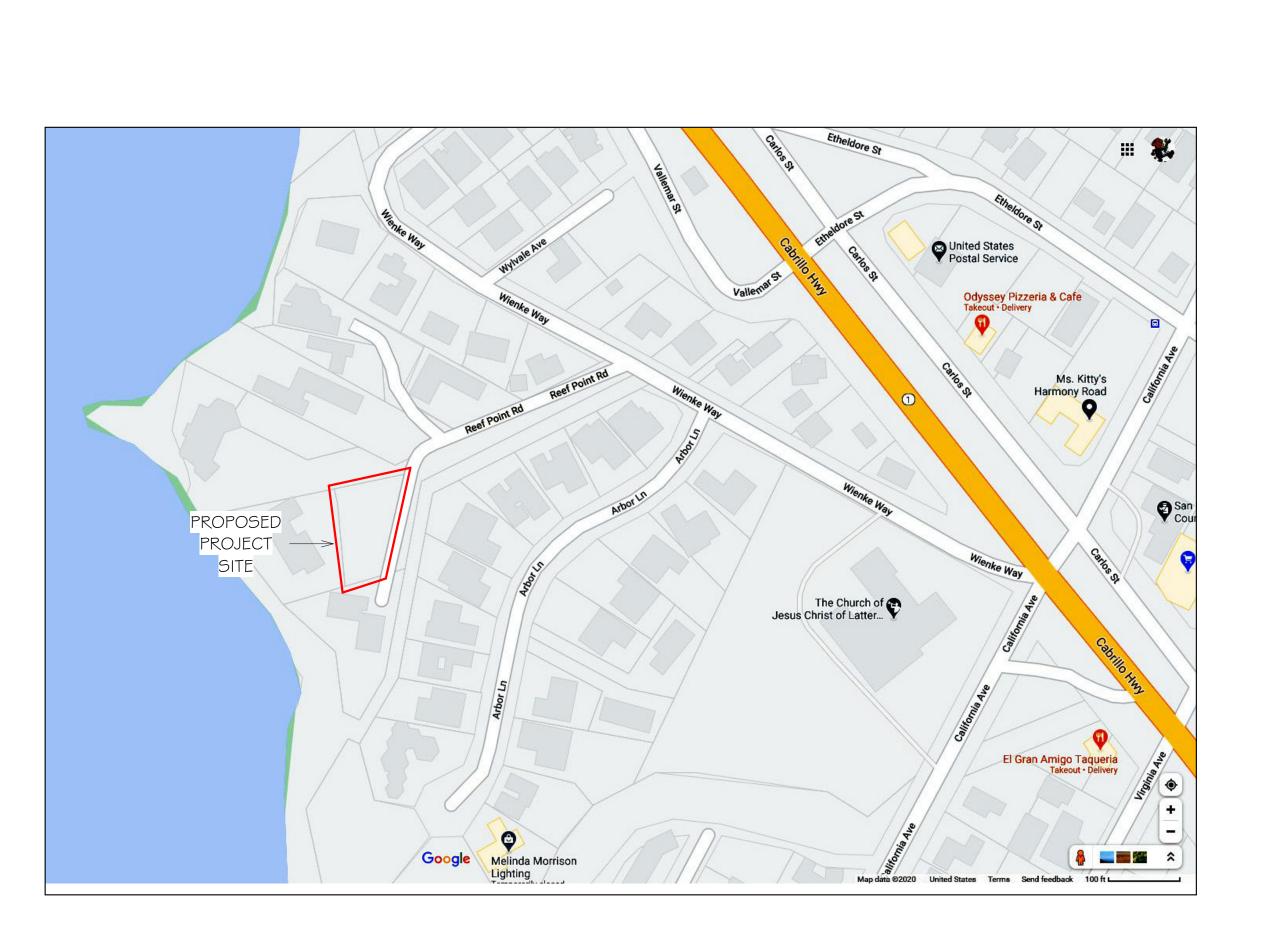


REVISIONS

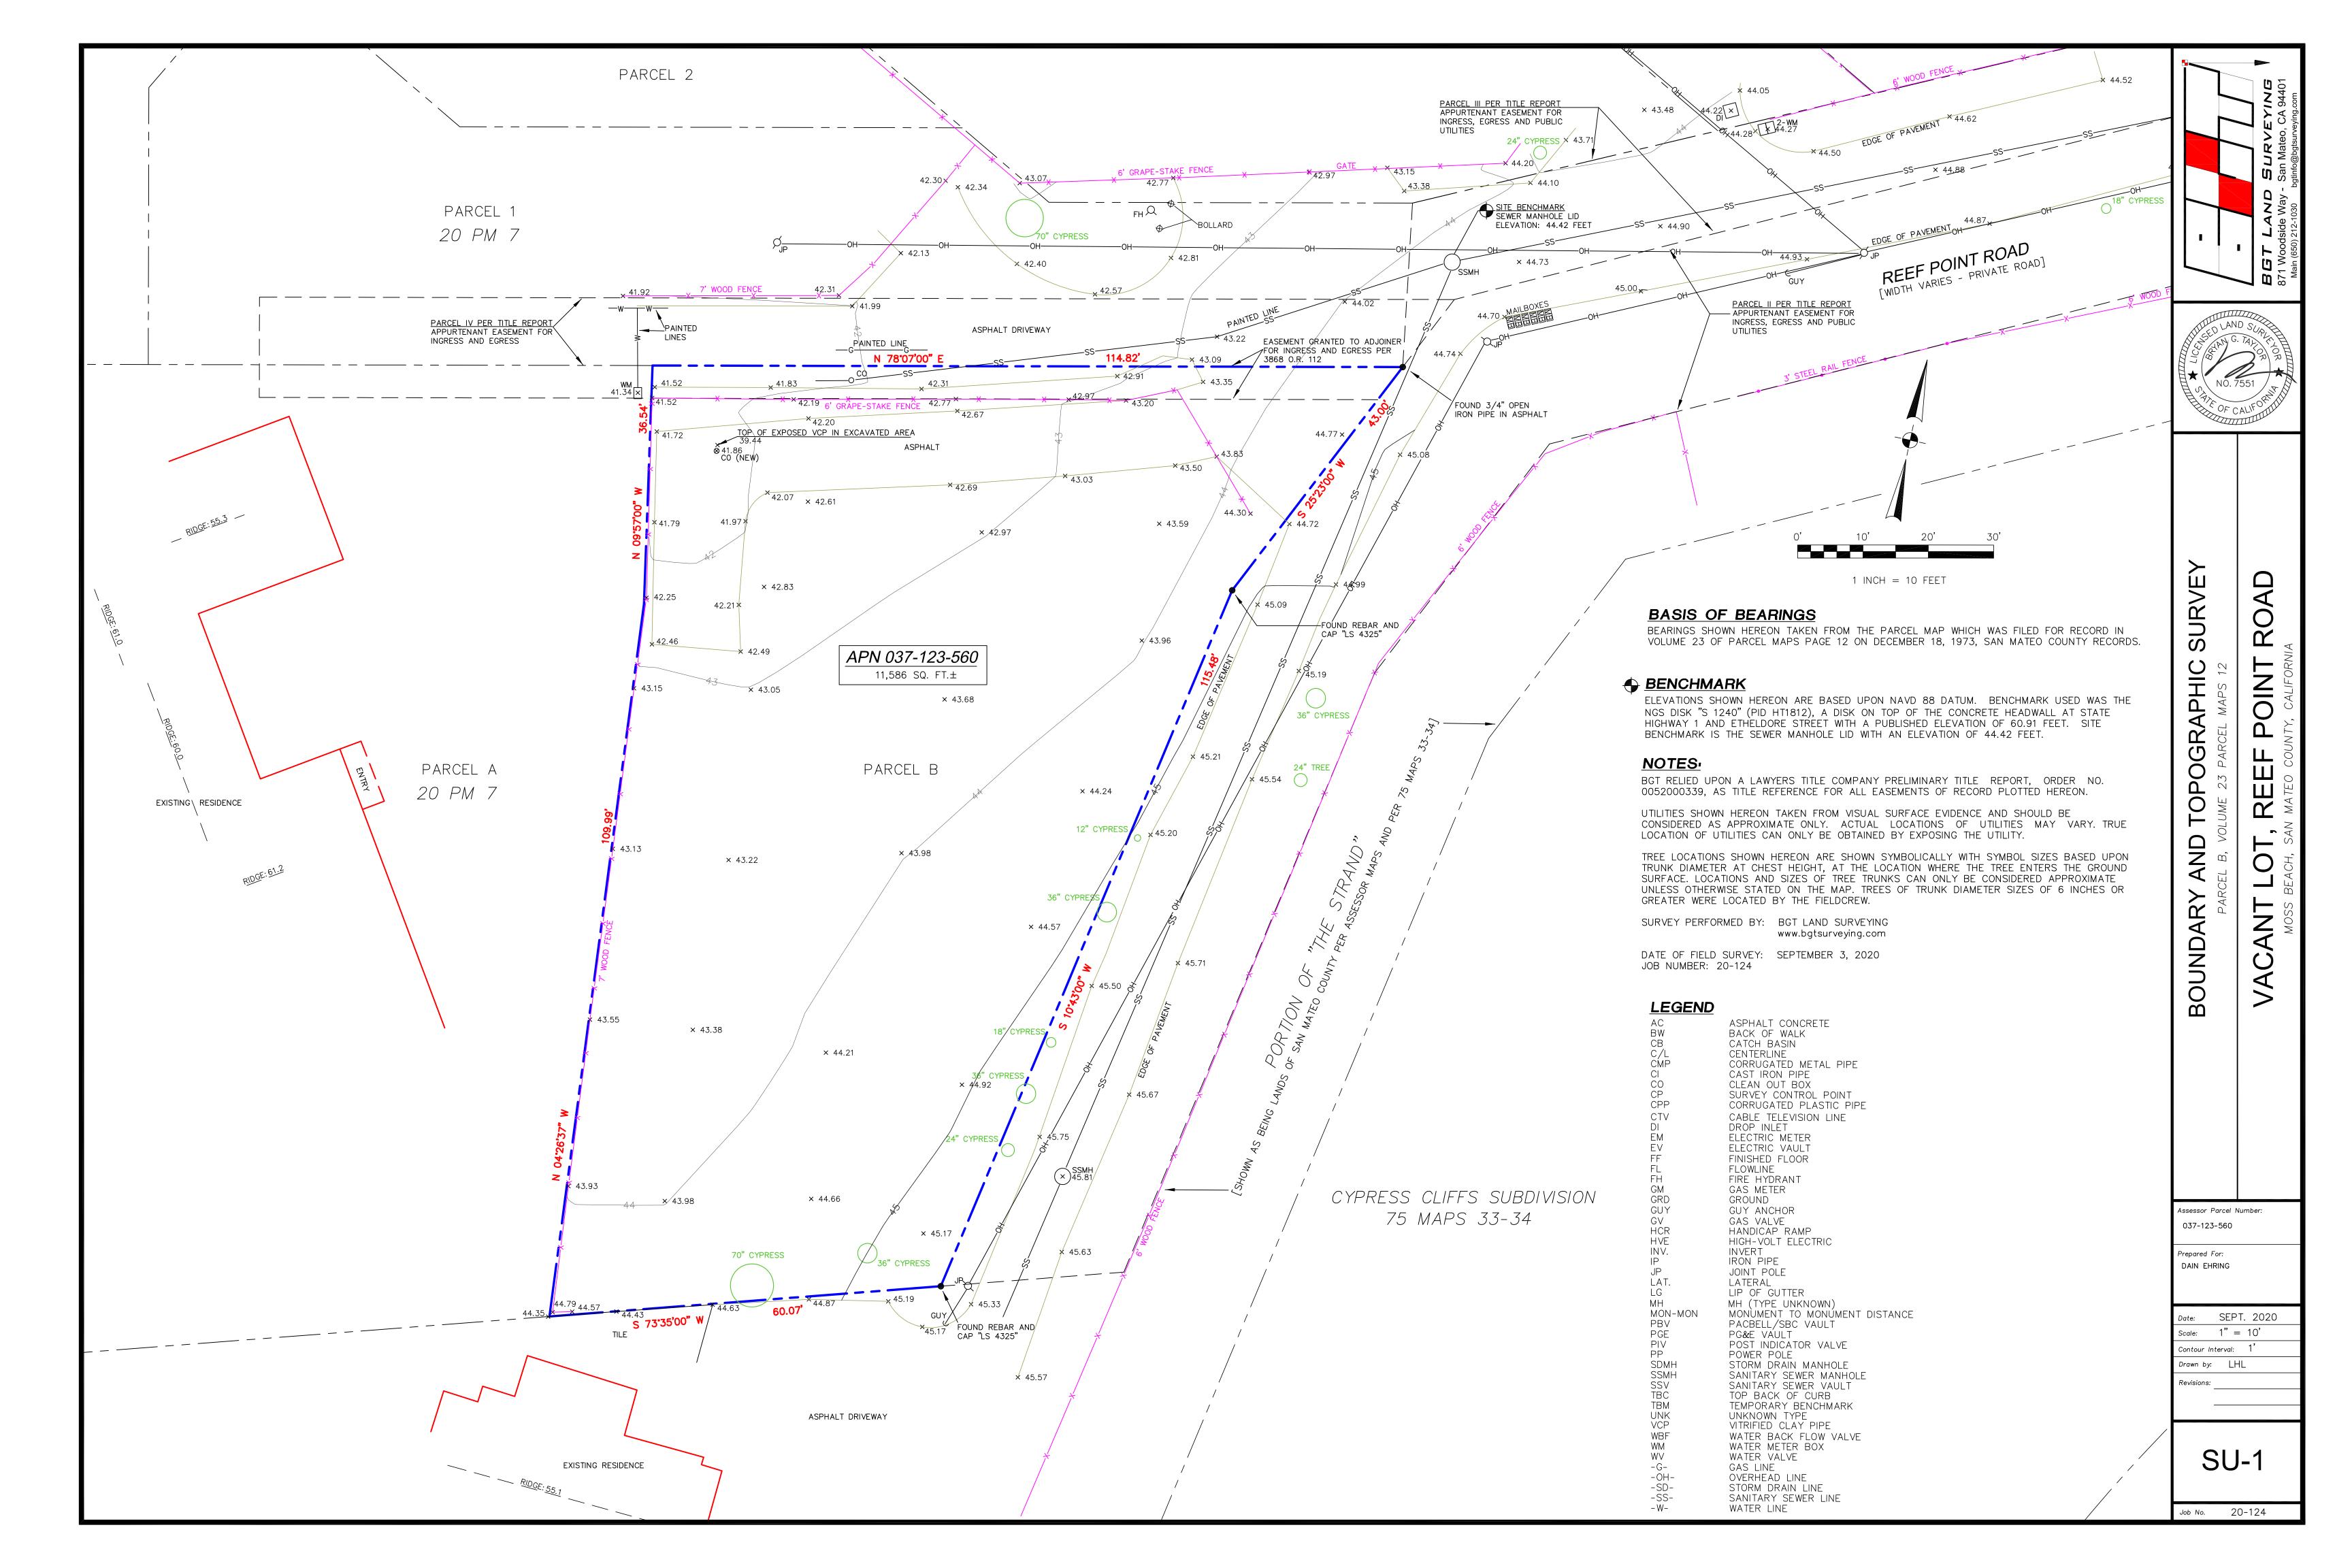

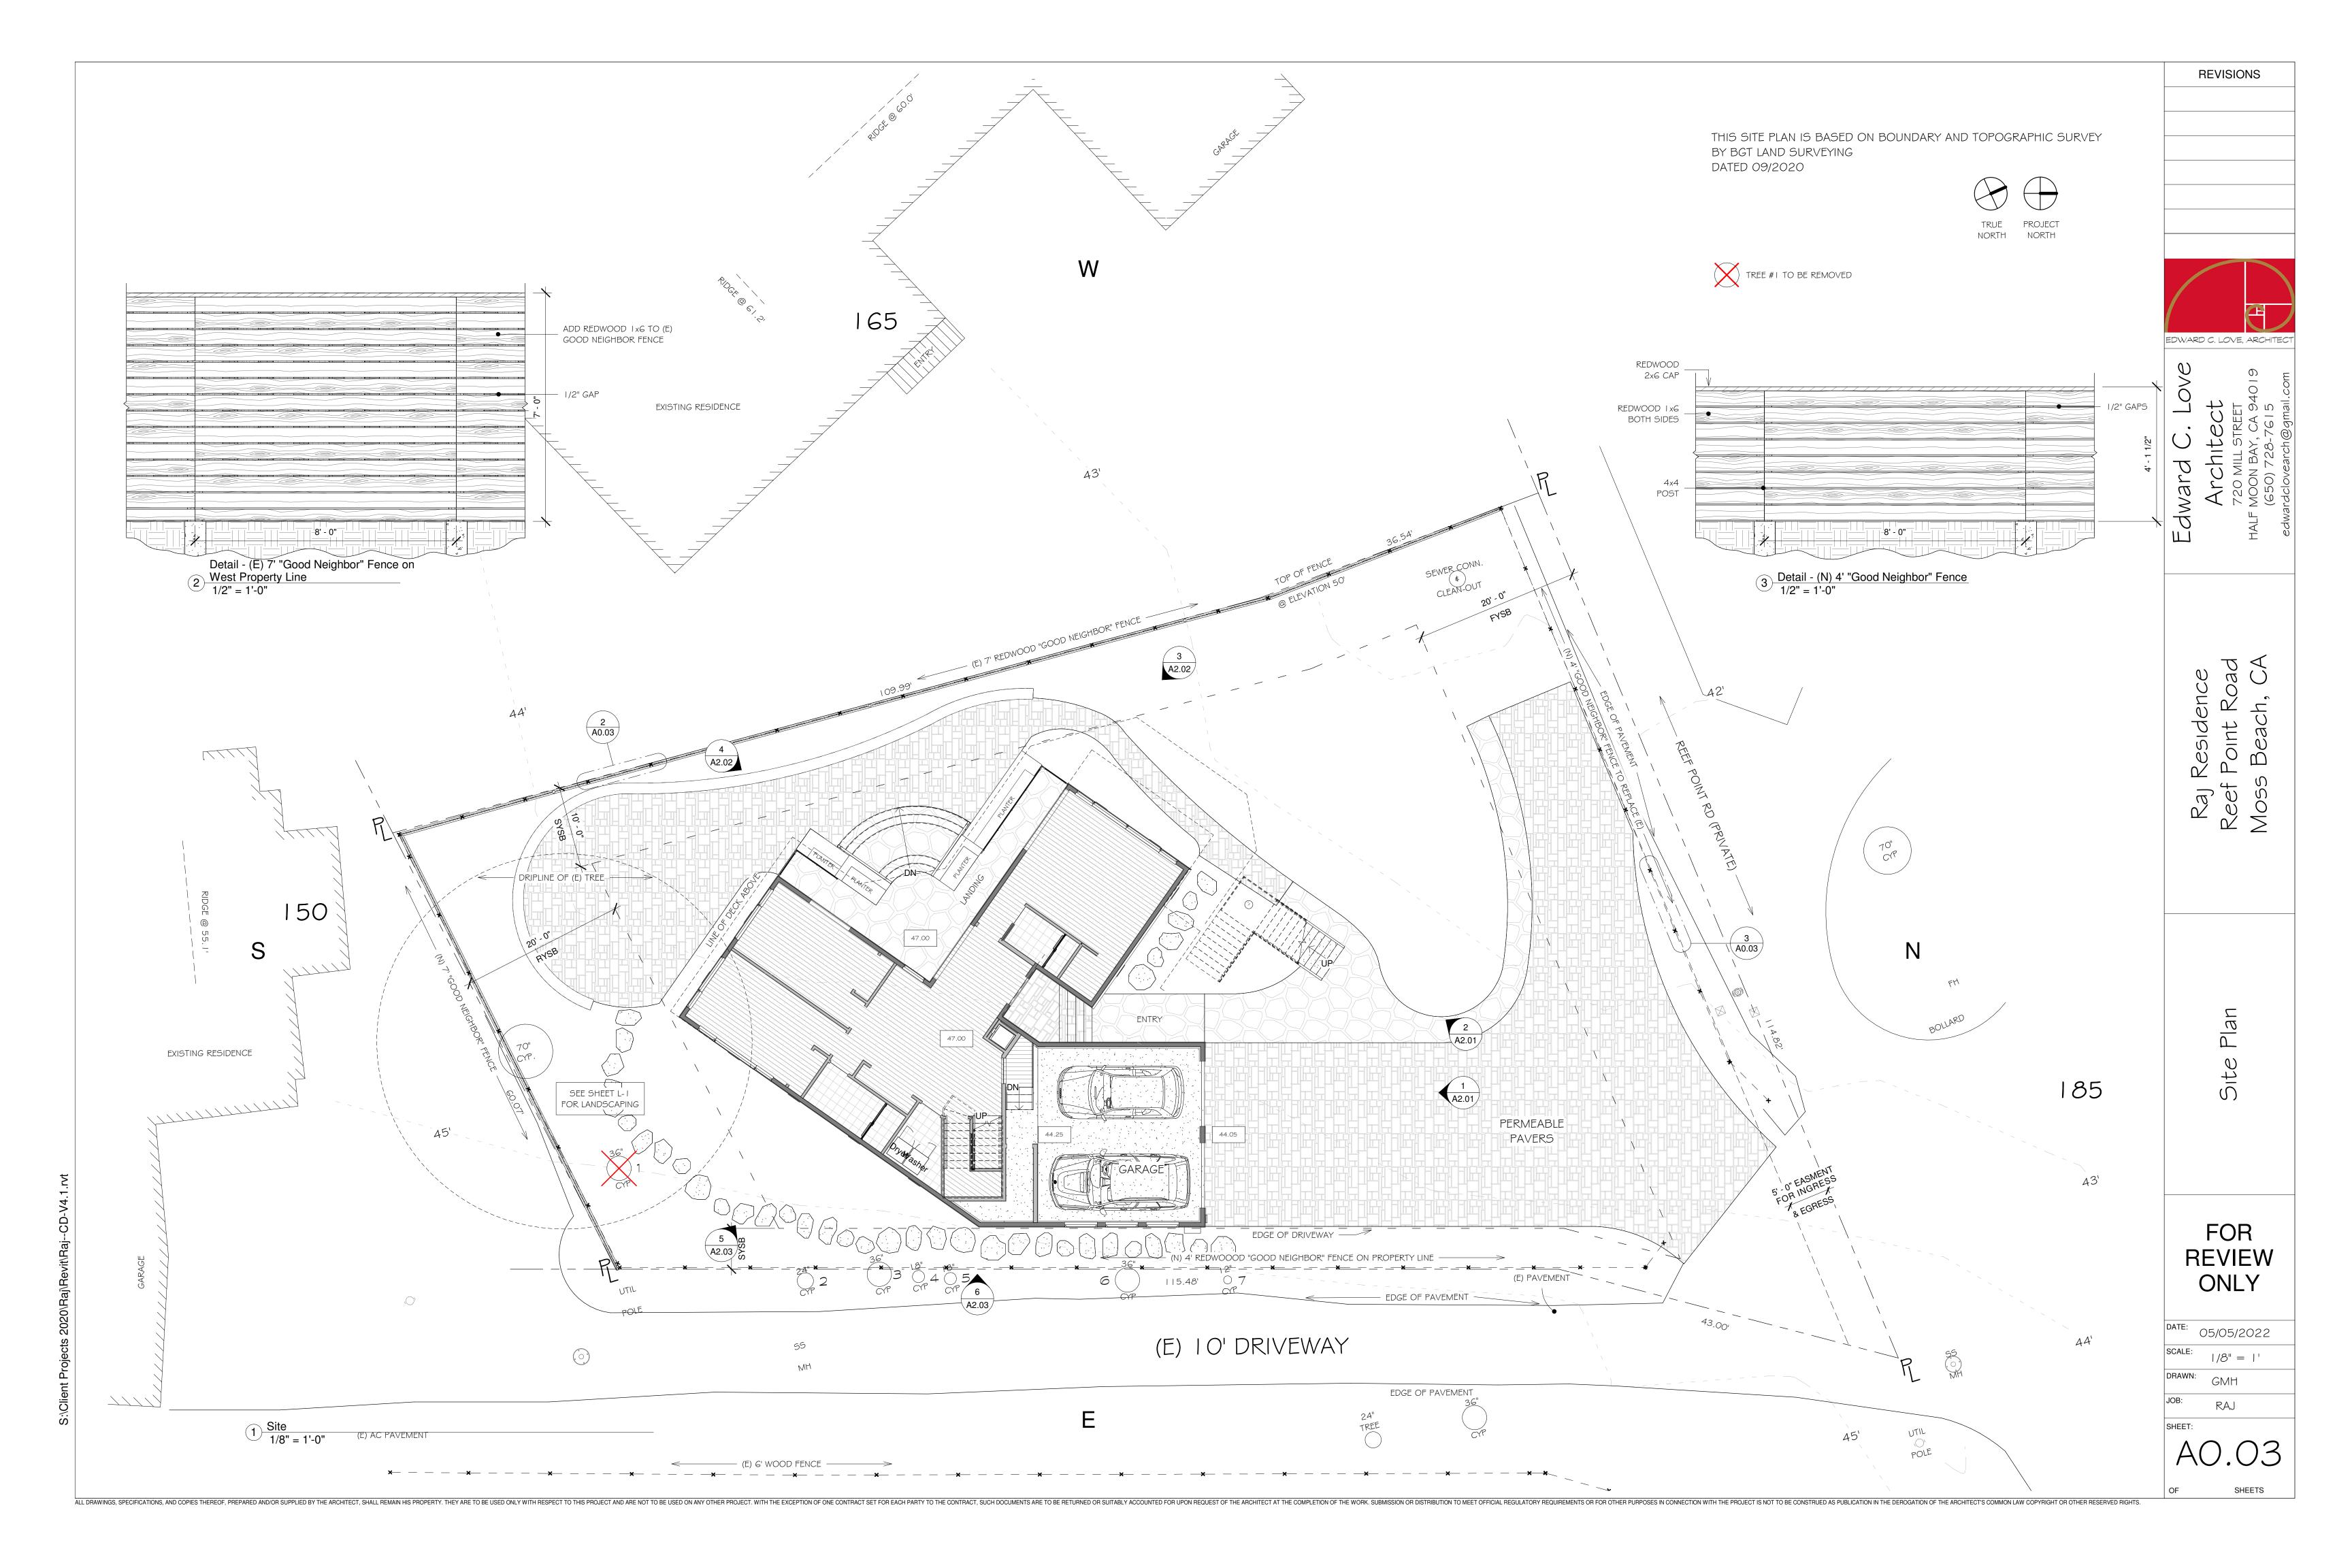

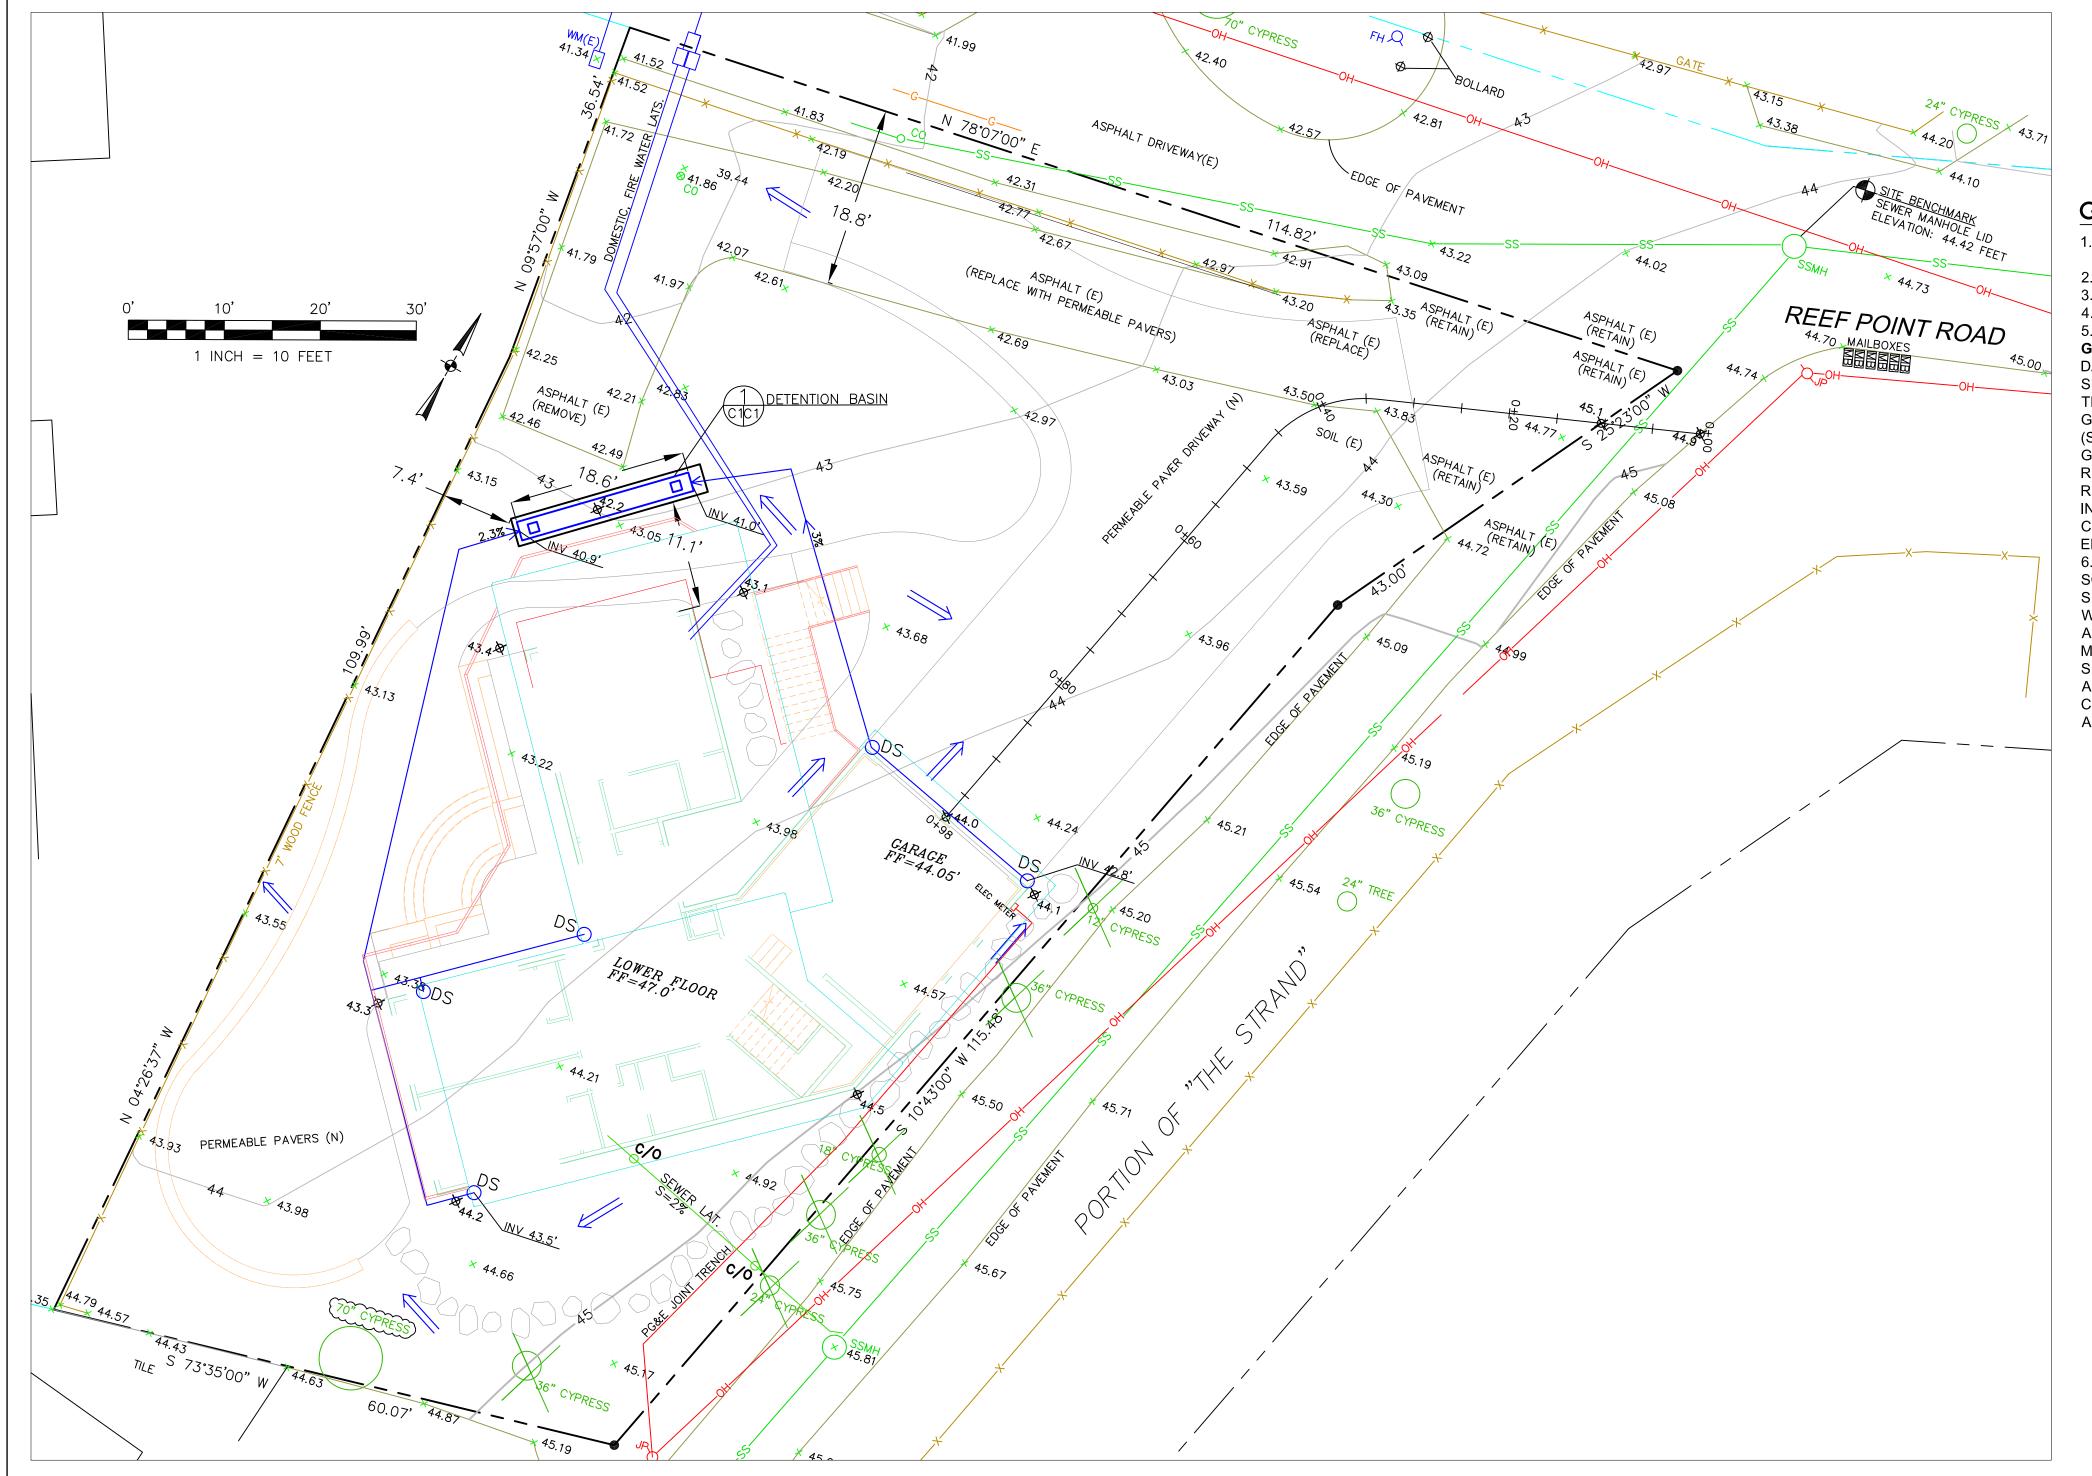

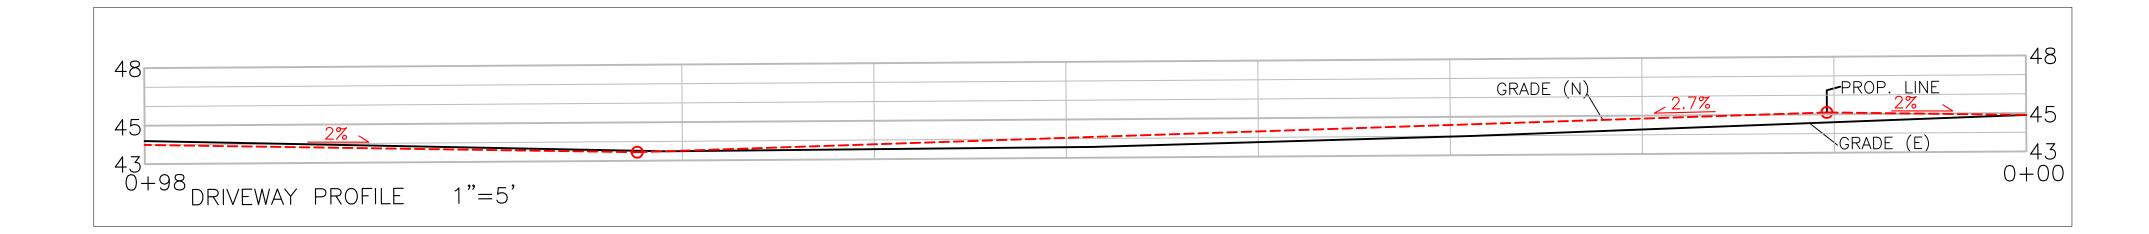

LEGEND

(E) CONTOUR

| X | PROPOSED SPOT ELEVATION | DOWNSPOUT |
| 12.5 | TREE TO BE REMOVED | 4" MIN SOLID DRAIN PIPE

GENERAL NOTES

- 1. PLANS PREPARED AT THE REQUEST OF:
- A.P. SUNDARRAJ, OWNER
 2. TOPOGRAPHY BY BGT SURVEYING, SURVEYED 9-3-20.
- 3. THIS IS NOT A BOUNDARY SURVEY.
- 4. ELEVATION DATUM NAVD88.
- 5. THE GEOTECHNICAL REPORT:

GEOTECHNICAL REPORT:

GEOTECHNICAL STUDY: REEF POINT ROAD, MOSS BEACH, CALIFORNIA.

DATE: JUNE 18, 2021, BY SIGMA PRIME INC., PROJECT NO. 21-150

SHALL BE RETAINED ON THE CONSTRUCTION SITE.

THE GEOTECHNICAL ENGINEER OF RECORD IS SIGMA PRIME
GEOSCIENCES, INC., WITH THE CONTACT NUMBER (650)-728-3590
(SIGMAPRM@GMAIL.COM). THE CONTRACTOR MUST SHALL NOTIFY THE
GEOTECHNICAL ENGINEER OF

RECORD AT LEAST 48 HOURS BEFORE CONSTRUCTION OF GEOTECHNICAL RELATED WORK. THE GEOTECHNICAL PART OF CONSTRUCTION WORK, INCLUDING BUT NOT LIMITED TO, ALL THE EARTHWORK AND FOUNDATION CONSTRUCTIONS, MUST SHALL BE APPROVED BY THE GEOTECHNICAL ENGINEER OF RECORD.

6. STORMWATER MANAGEMENT CONSTRUCTION INSPECTIONS SHALL BE SCHEDULED FOR APPLICABLE DRAINAGE INSPECTIONS, WHICH INCLUDE SITE CLEARANCE AND EROSION CONTROL MEASURES INSTALLATION AS WELL AS INSPECTION OF MAJOR DRAINAGE CONTAINMENT, TREATMENT, AND CONVEYANCE DEVICES BEFORE BEING BURIED (INCLUDING REQUIRED MATERIAL LABELS, E.G. PIPES, SUB-GRADE MATERIALS, ETC.). PLEASE SIGMA PRIME AT 650-728-3590TO SCHEDULE DRAINAGE INSPECTIONS ACCORDINGLY. THERE SHALL BE THREE INSPECTIONS: ONE FOR EROSION CONTROL INSTALLATION, ONE BEFORE DRAINAGE FACILITIES ARE BURIED, AND ONE FOR FINAL WALK AROUND.

MAINTENANCE ACCESS 12"X12" COARSE SCREEN FILTER ORIGINAL, FINAL SLOPE 18FLOW 24" DIAM. PERFORATED PIPES: SINGLE WALL CORRUGATED HDPE L=18.6' EACH TRENCH L=20.5' MIRAFI 140N FILTER FABRIC AT ROCK/SOIL INTERFACE DESIGN BASIS: 10—YEAR STORM EVENT WITH 1 HOUR DURATION ON HARD SURFACES. RAINFALL INTENSITY = 0.846 IN/HR DETENTION BASIN C1C1 NOT TO SCALE

GRADING NOTES

CUT VOLUME : 20 CY (FOR FOUNDATION) FILL VOLUME: 0 CY

VOLUMES ABOVE ARE APPROXIMATE.

THE SUBGRADE BELOW ALL PAVED AREAS SHALL BE BASEROCK COMPACTED TO 95%.

ALL GRADING SHALL CONFORM TO LOCAL CODES AND ORDINANCES.

ALL TRENCHES UNDER PROPOSED PAVED AREAS OR CONCRETE SHALL BE BACKFILLED TO SUBGRADE ELEVATION WITH COMPACTED APPROVED GRANULAR MATERIALS. IF TRENCHES ARE IN PROPOSED LANDSCAPE AREAS, THEY SHALL BE BACKFILLED WITH COMPACTED APPROVED GRANULAR MATERIAL TO WITHIN ONE FOOT OF FINISHED GRADE, AND THEN FILLED WITH HAND TAMPED SOILS.

DRAINAGE NOTES


1. DRAINAGE INTENT: IT IS THE INTENT OF THE DRAINAGE SYSTEM TO CONVEY ROOF RUNOFF TO A SAFE LOCATION, AND TO MINIMIZE EXCESSIVE MOISTURE AROUND FOUNDATIONS. SLOPE ALL IMPERVIOUS SURFACES A MINIMUM OF 2% AWAY FROM BUILDING. DIRECT SLOPES SUCH THAT STORMWATER WILL NOT BE DIVERTED ONTO ADJACENT PROPERTIES.


2. ALL DOWNSPOUT DRAIN LINES SHALL LEAD TO DETNETION BASIN, AS SHOWN.


3. ALL ROOF DRAINAGE PIPES SHALL BE 4" DIAMETER MINIMUM SOLID PIPE. SLOPED AT 2% MINIMUM.


4. IT IS THE PROPERTY OWNER'S RESPONSIBILITY TO CHECK ON ALL STORMWATER FACILITIES SUCH AS ROOF GUTTERS, DOWNSPOUT LINES, AND THE DETENTION BASIN TO BE SURE THAT THEY ARE CLEAR OF EXCESSIVE DEBRIS AND OPERATING EFFICIENTLY. THE FACILITIES SHALL BE CHECKED EVERY FALL AND PERIODICALLY DURING THE RAINY SEASON.

SECTION AND DETAIL CONVENTION

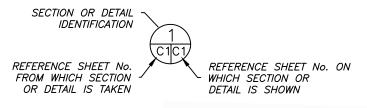

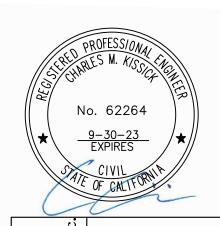

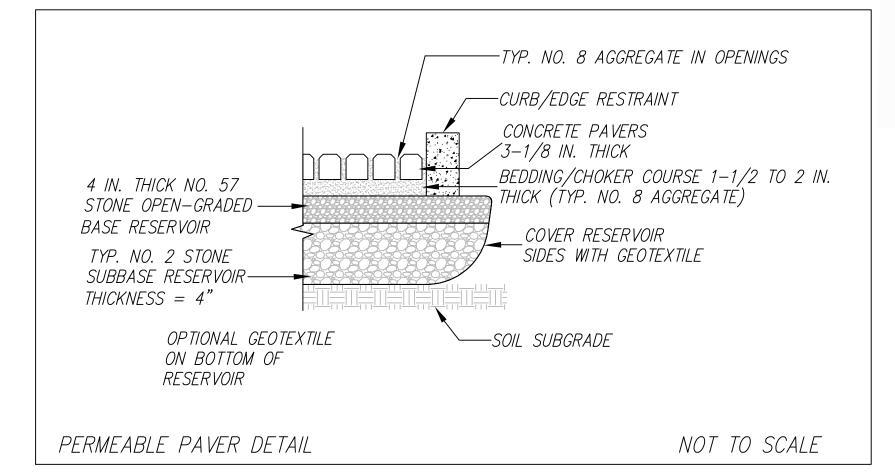

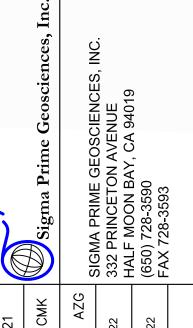

DATE: 6-23-21

DRAWN BY: CMK

CHECKED BY: AZG


REV. DATE: 2-11-22

REV. DATE: 3-23-22

GRADING AND
DRAINAGE PLAN
UNDARRAJ PROPERTY
REEF POINT ROAD
MOSS BEACH
APN 037-123-560

SHEET

 C^{-1}

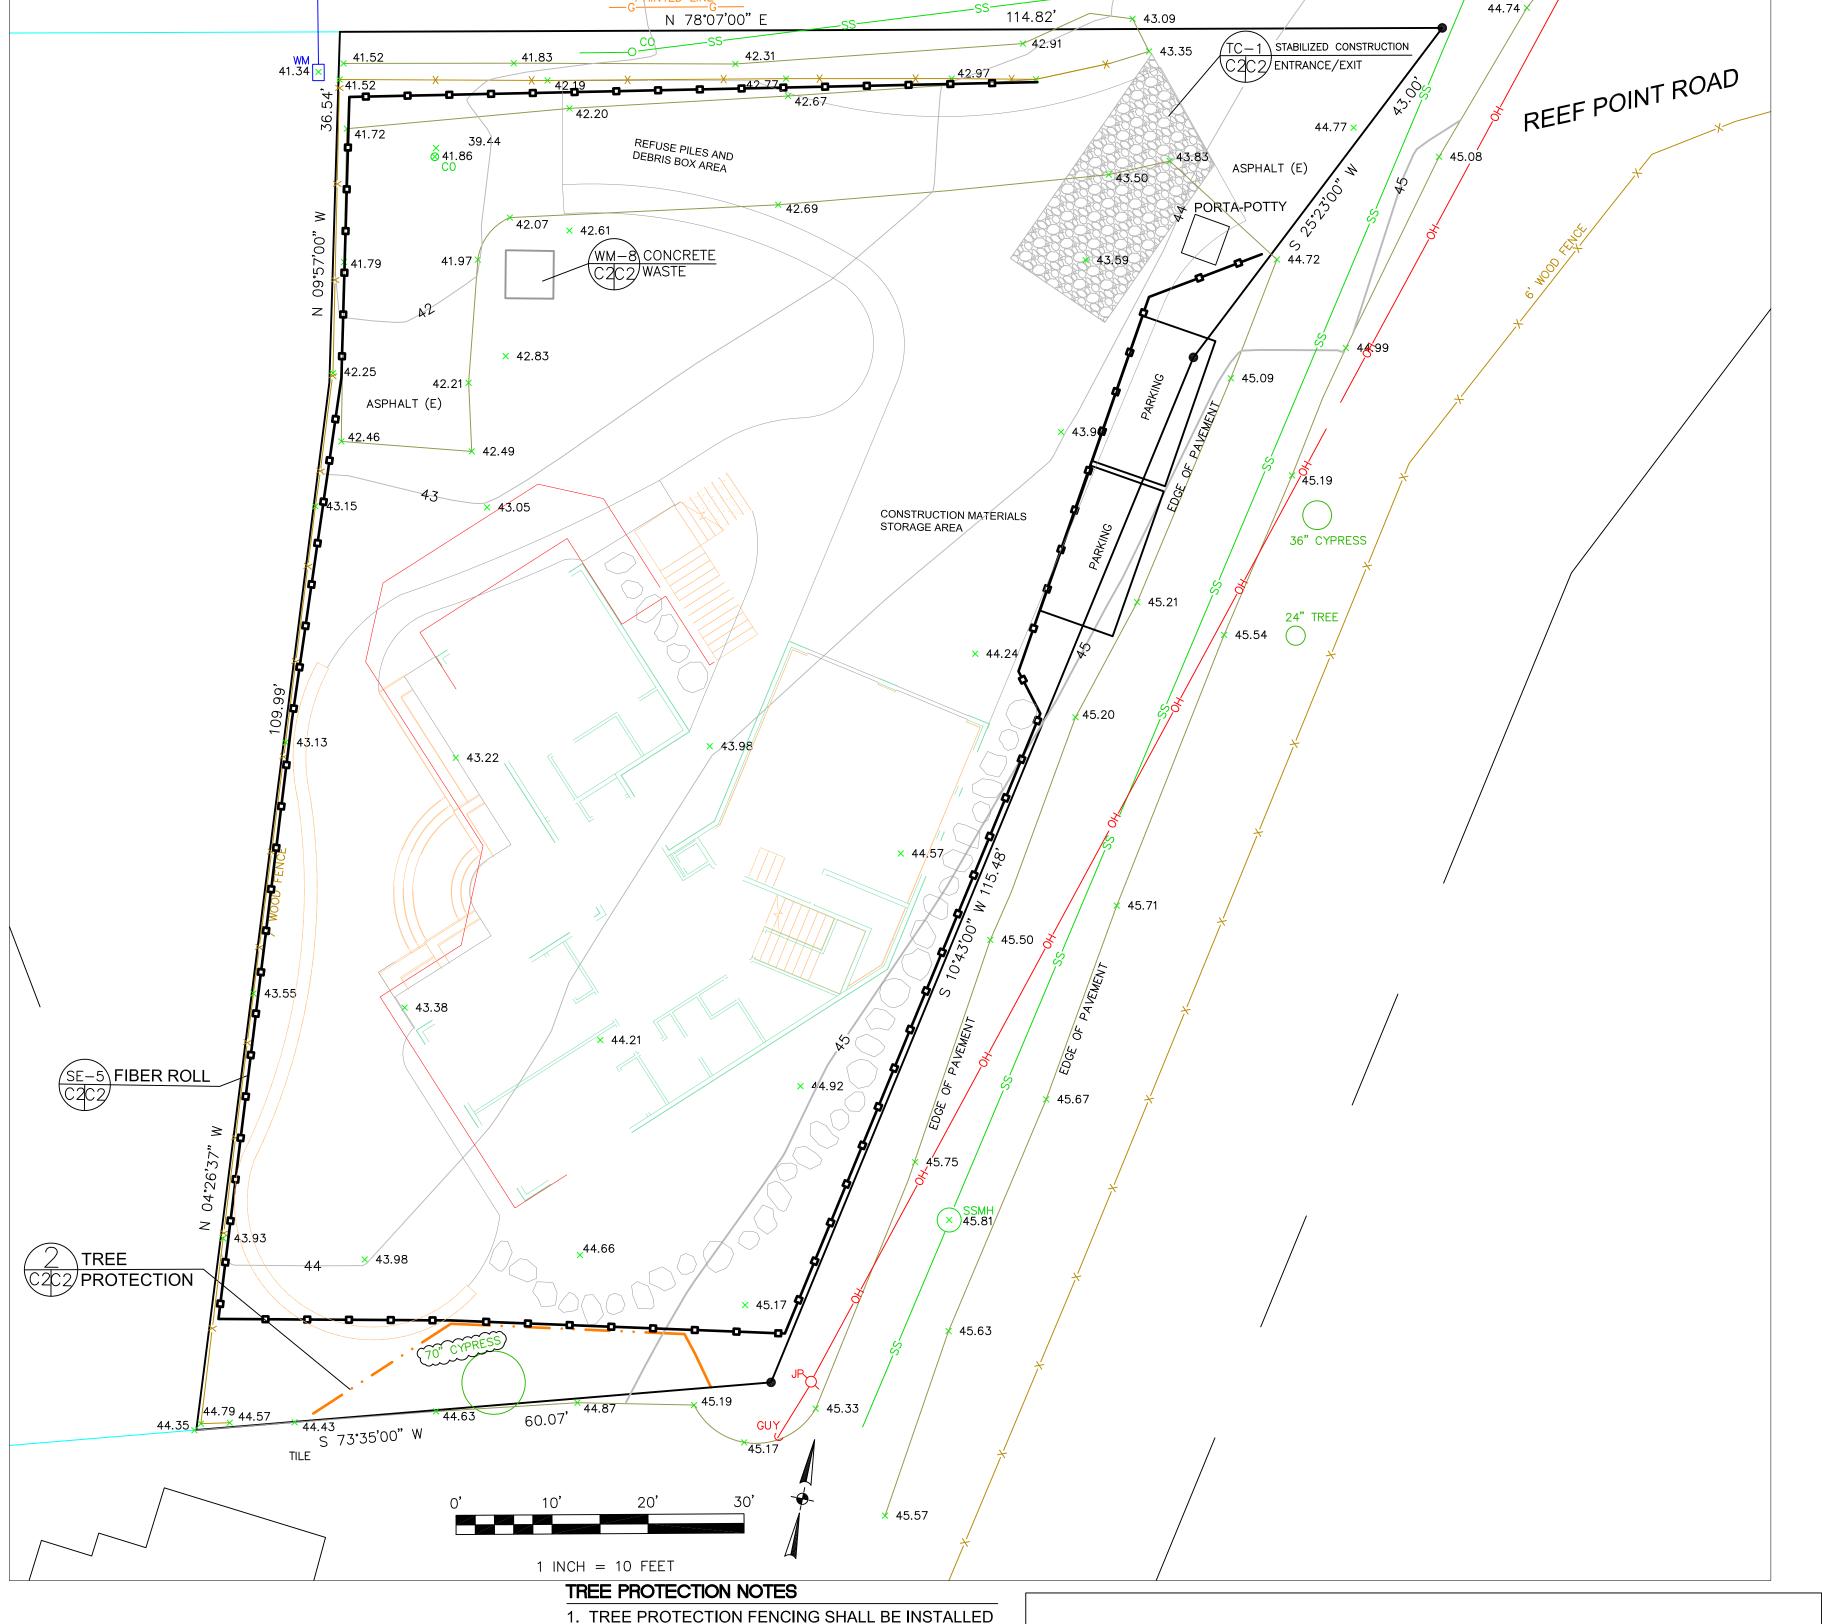

PRIOR TO ANY GRADING AND REMAIN ON-SITE

2. TREE PROTECTION FENCES SHALL BE INSTALLED

THROUGHOUT CONSRUCTION PROCESS.

AS CLOSE TO DRIP LINES AS POSSIBLE.

EQUIPMENT WITHIN THESE AREAS.

MONITORED AND DOCUMENTED.

SAW OR TOPPER.

PERMIT.

3. OWNER/BUILDER SHALL MAINTAIN TREE

PROTECTION ZONES FREE OF EQUIPMENT AND

BE INSPECTED BY A CERTIFIED ARBORIST OR

MATERIALS STORAGE AND SHALL NOT CLEAN ANY

4. ANY LARGE ROOTS THAT NEED TO BE CUT SHALL

REGISTERED FORESTER PRIOR TO CUTTING, AND

5. ROOTS TO BE CUT SHALL BE SEVERED WITH A

6. PRE-CONSTRUCTION SITE INSPECTION WILL BE

REQUIRED PRIOR TO ISSUANCE OF BUILDING

TYPE "ABOVE GRADE WITH STRAW BALES -0.5" LAG SCREWS -STRAW BALE 1. ACTUAL LAYOUT DETERMINED

WM-8

CONCRETE WASTE MANAGEMENT

SE-5 FIBER ROLLS TYPICAL FIBER ROLL INSTALLATION ENTRENCHMENT DETAIL N.T.S. If more than one fiber roll is placed in a row, the rolls must be overlapped, not abutted. Turn the ends of the fiber roll up-slope to prevent runoff from going around the roll.

GENERAL EROSION AND SEDIMENT CONTROL NOTES




- There will be no stockpiling of soil. All excavated soil will be hauled off-site as it is excavated.
- · Perform clearing and earth-moving activities only during dry weather. Measures to ensure adequate erosion and sediment control shall be installed prior to earth-moving activities and construction.
- Erosion control materials to be on-site during off-season.
- Measures to ensure adequate erosion and sediment control are required year-round. Stabilize all denuded areas and maintain erosion control measures continuously between October 1 and April 30.
- · Store, handle, and dispose of construction materials and wastes properly, so as to prevent their contact with stormwater.
- · Control and prevent the discharge of all potential pollutants, including pavement cutting wastes, paints, concrete, petroleum products, chemicals, wash water or sediments, and non-stormwater discharges to storm drains and watercourses.
- · Avoid cleaning, fueling, or maintaining vehicles on-site, except in a designated area where wash water is contained and treated.
- · Limit and time applications of pesticides and fertilizers to prevent polluted runoff.
- · Limit construction access routes to stabilized, designated access points
- · Avoid tracking dirt or other materials off-site; clean off-site paved areas and sidewalks using dry sweeping methods.
- · Train and provide instruction to all employees and subcontractors regarding the Watershed Protection Maintenance Standards and construction Best Management Practices.
- Placement of erosion materials is required on weekends and during rain events.
- The areas delineated on the plans for parking, grubbing, storage etc., shall not be enlarged or "run over."
- Dust control is required year-round.
- Erosion control materials shall be stored on-site.



EROSION CONTROL POINT OF CONTACT

THIS PERSON WILL BE RESPONSIBLE FOR EROSION CONTROL AT THE SITE AND WILL BE THE COUNTY'S MAIN POINT OF CONTACT IF CORRECTIONS ARE REQUIRED.


NAME:	A.P. <u>SUNDARRAJ</u>
TITLE/QUALIFI	CATION: OWNER
PHONE:	408-656-8712
PHONE:	
E-MAIL:	APSUNDAR@YAHOO.COM

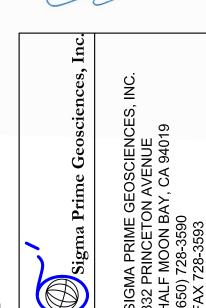

NRY OSS NDAI REEF APN

SHEET

STABILIZED CONSTRUCTION ENTRANCE/EXIT TC-1 Crushed aggregate

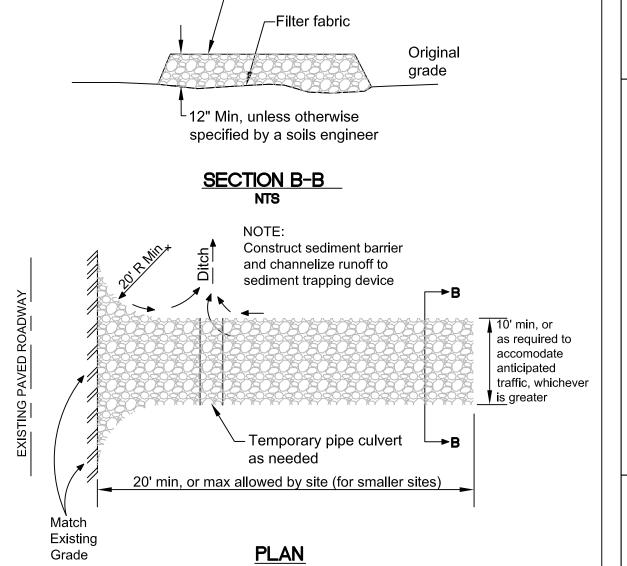

- 5" THICK LAYER OF MULCH MAINTAIN EXISTING GRADE KEEP OUT WITH THE TREE PROTECTION FENCE UNLESS OTHERWISE AREA INDICATED ON THE PLANS. NO EQUIPMENT SHALL OPERATE INSIDE THE PROTECTIVE FENCING, INCLUDING DURING FENCE INSTALLATION AND REMOVAL.

TREE PROTECTION FENCE:

- POLYEHTYLENE FENCING

COLOR ORANGE. STEEL

2" X 6' STEEL POSTS OR APPROVED EQUAL

WITH 3.5" X 1.5" OPENINGS;

POSTS INSTALLED AT 8' O.C.

HIGH DENSITY


SHEETS

SAN MATEO COUNTYWIDE **Water Pollution Prevention Program** Clean Water. Healthy Community.

Construction Best Management Practices (BMPs)

Construction projects are required to implement the stormwater best management practices (BMP) on this page, as they apply to your project, all year long.

Materials & Waste Management

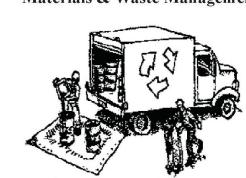

Non-Hazardous Materials

☐ Berm and cover stockpiles of sand, dirt or other construction material with tarps when rain is forecast or if not actively being used within

☐ Use (but don't overuse) reclaimed water for dust control.

Hazardous Materials

☐ Label all hazardous materials and hazardous wastes (such as pesticides, paints, thinners, solvents, fuel, oil, and antifreeze) in accordance with city, county, state and federal regulations.

☐ Store hazardous materials and wastes in water tight containers, store in appropriate secondary containment, and cover them at the end of every work day or during wet weather or when rain is forecast.

☐ Follow manufacturer's application instructions for hazardous materials and be careful not to use more than necessary. Do not apply chemicals outdoors when rain is forecast within 24 hours. ☐ Arrange for appropriate disposal of all hazardous wastes.

Waste Management

☐ Cover waste disposal containers securely with tarps at the end of every work day and during wet weather.

☐ Check waste disposal containers frequently for leaks and to make sure they are not overfilled. Never hose down a dumpster on the construction site.

☐ Clean or replace portable toilets, and inspect them frequently for leaks and spills.

wastes that can be recycled (such as asphalt, concrete, aggregate base materials, wood, gyp board, pipe, etc.) ☐ Dispose of liquid residues from paints, thinners, solvents, glues, and

☐ Dispose of all wastes and debris properly. Recycle materials and

Construction Entrances and Perimeter

to clean up tracking.

cleaning fluids as hazardous waste.

☐ Establish and maintain effective perimeter controls and stabilize all construction entrances and exits to sufficiently control erosion and sediment discharges from site and tracking off site. ☐ Sweep or vacuum any street tracking immediately and secure

sediment source to prevent further tracking. Never hose down streets

Equipment Management &



☐ Designate an area, fitted with appropriate BMPs, for vehicle and equipment parking and storage. ☐ Perform major maintenance, repair jobs, and vehicle

and equipment washing off site. ☐ If refueling or vehicle maintenance must be done onsite, work in a bermed area away from storm drains and over a drip pan or drop cloths big enough to collect fluids. Recycle or dispose of fluids as hazardous waste. ☐ If vehicle or equipment cleaning must be done onsite,

drains, or surface waters. ☐ Do not clean vehicle or equipment onsite using soaps, solvents, degreasers, or steam cleaning equipment.

clean with water only in a bermed area that will not

allow rinse water to run into gutters, streets, storm

Spill Prevention and Control

☐ Keep spill cleanup materials (e.g., rags, absorbents and cat litter) available at the construction site at all times. ☐ Inspect vehicles and equipment frequently for and repair leaks promptly. Use drip pans to catch leaks

until repairs are made. ☐ Clean up spills or leaks immediately and dispose of

cleanup materials properly. ☐ Do not hose down surfaces where fluids have spilled.

Use dry cleanup methods (absorbent materials, cat litter, and/or rags). Sweep up spilled dry materials immediately. Do not try to wash them away with water, or bury them.

☐ Clean up spills on dirt areas by digging up and properly disposing of contaminated soil. ☐ Report significant spills immediately. You are required by law to report all significant releases of hazardous


Center, (800) 852-7550 (24 hours).

materials, including oil. To report a spill: 1) Dial 911

Governor's Office of Emergency Services Warning

or your local emergency response number, 2) Call the

Earthmoving

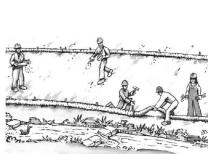

☐ Schedule grading and excavation work during dry weather.

☐ Stabilize all denuded areas, install and maintain temporary erosion controls (such as erosion control fabric or bonded fiber matrix) until vegetation is established. ☐ Remove existing vegetation only when absolutely necessary, and seed or plant

> vegetation for erosion control on slopes ☐ Prevent sediment from migrating offsite and protect storm drain inlets, gutters, ditches, and drainage courses by installing and maintaining appropriate BMPs, such

as fiber rolls, silt fences, sediment basins, ☐ Keep excavated soil on site and transfer it

to dump trucks on site, not in the streets.

☐ If any of the following conditions are observed, test for contamination and contact the Regional Water Quality

- Unusual soil conditions, discoloration,

or odor. - Abandoned underground tanks. Abandoned wells

- Buried barrels, debris, or trash.

Paving/Asphalt Work



Avoid paving and seal coating in wet weather or when rain is forecast, to prevent materials that have not cured from contacting stormwater runoff. rain, runoff, and wind.

☐ Cover storm drain inlets and manholes when applying seal coat, tack coat, slurry seal, fog seal, etc. ☐ Collect and recycle or appropriately dispose of excess abrasive gravel or sand. Do NOT sweep or wash it into gutters. Do not use water to wash down fresh

Sawcutting & Asphalt/Concrete Removal ☐ Protect nearby storm drain inlets when saw cutting. Use filter fabric, catch basin out of the storm drain system. ☐ Shovel, abosorb, or vacuum saw-cut slurry and dispose of all waste as soon

as you are finished in one location or at

asphalt concrete pavement.

the end of each work day (whichever is ☐ If sawcut slurry enters a catch basin, clean it up immediately.

Concrete, Grout & Mortar




☐ Store concrete, grout, and mortar away from storm drains or waterways, and on pallets under cover to protect them from

☐ Wash out concrete equipment/trucks offsite or in a designated washout area, where the water will flow into a temporary waste pit, and in a manner that will prevent leaching into the underlying soil or onto surrounding areas. Let concrete harden and dispose of as


☐ When washing exposed aggregate, drains. Block any inlets and vacuum gutters, hose washwater onto dirt areas, or drain onto a bermed surface to be pumped

Landscaping

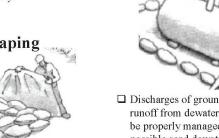

☐ Protect stockpiled landscaping materials from wind and rain by storing them under tarps all year-round. Stack bagged material on pallets and

☐ Discontinue application of any erodible landscape material within 2 days before a forecast rain event or during wet weather. Painting & Paint Removal

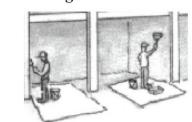


☐ Never clean brushes or rinse paint containers into a street, gutter, storm

☐ For water-based paints, paint out brushes to the extent possible, and rinse into a drain that goes to the sanitary sewer.

☐ For oil-based paints, paint out brushes to the extent possible and clean with thinner or solvent in a proper container. Filter and reuse thinners and solvents. Dispose of

excess liquids as hazardous waste. ☐ Paint chips and dust from non-hazardous dry stripping and sand blasting may be swept up or collected in plastic drop cloths and disposed of as trash.

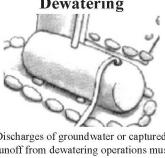

☐ Discharges of groundwater or captured possible send dewatering discharge to landscaped area or sanitary sewer. If local wastewater treatment plant.

from all disturbed areas.

approval from the local municipality before discharging water to a street gutter or storm drain. Filtration or diversion through a basin, tank, or sediment trap may be required. ☐ In areas of known or suspected

contamination, call your local agency to

determine whether the ground water must


be tested. Pumped groundwater may need

to be collected and hauled off-site for

treatment and proper disposal.

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Storm drain polluters may be liable for fines of up to \$10,000 per day!

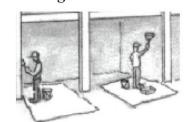

Painting Cleanup and Removal

drain, or stream.

Never pour paint down a storm drain.

☐ Chemical paint stripping residue and chips and dust from marine paints or paints containing lead, mercury, or tributyltin must be disposed of as hazardous waste. Lead based paint removal requires a state-



runoff from dewatering operations must be properly managed and disposed. When discharging to the sanitary sewer call your

☐ Divert run-on water from offsite away ☐ When dewatering, notify and obtain

Requirements for Architectural Copper

Protect water quality during installation, cleaning, treating, and washing!

Copper from Buildings May Harm Aquatic Life

Copper can harm aquatic life in San Francisco Bay. Water that comes into contact with architectural copper may contribute to impacts, especially during installation, cleaning, treating, or washing. Patination solutions that are used to obtain the desired shade of green or brown typically contain acids. After treatment, when the copper is rinsed to remove these acids, the rinse water is a source of pollutants. Municipalities prohibit discharges to the storm drain of water used in the installation, cleaning, treating and washing of architectural copper.



Use Best Management Practices (BMPs) The following Best Management Practices (BMPs) must be implemented to prevent prohibited discharges to storm drains.

During Installation

- If possible, purchase copper materials that have been pre-patinated at the factory.
- If patination is done on-site, implement one or more of the following BMPs:
- Discharge the rinse water to landscaping. Ensure that the rinse water does not flow to the street or storm drain. Block off storm drain inlet if needed. Collect rinse water in a tank and pump to the sanitary
- sewer. Contact your local sanitary sewer agency before discharging to the sanitary sewer. o Collect the rinse water in a tank and haul off-site for
- proper disposal. • Consider coating the copper materials with an impervious coating that prevents further corrosion and runoff. This will Storm drain inlet is blocked to prevent



also maintain the desired color for a longer time, requiring prohibited discharge. The water must be

During Maintenance

Implement the following BMPs during routine maintenance activities, such as power washing the roof, re-patination or re-application of impervious coating:

• Block storm drain inlets as needed to prevent runoff from entering storm drains.

• Discharge the wash water to landscaping or to the sanitary sewer (with permission from the local sanitary sewer agency). If this is not an option, haul the wash water off-site for proper disposal.

Protect the Bay/Ocean and yourself! If you are responsible for a discharge to the storm drain of nonstormwater generated by installing, cleaning, treating or washing copper architectural features, you are in violation of the municipal stormwater ordinance and may be subject to a fine.



Photo credit: Don Edwards National Wildlife Sanctuary

Contact Information


The San Mateo Countywide Water Pollution Prevention Program lists municipal stormwater contacts at


www.flowstobay.org (click on "Business", then "New Development", then "local permitting agency").


FINAL February 29, 2012

05/05/2022

RAJ

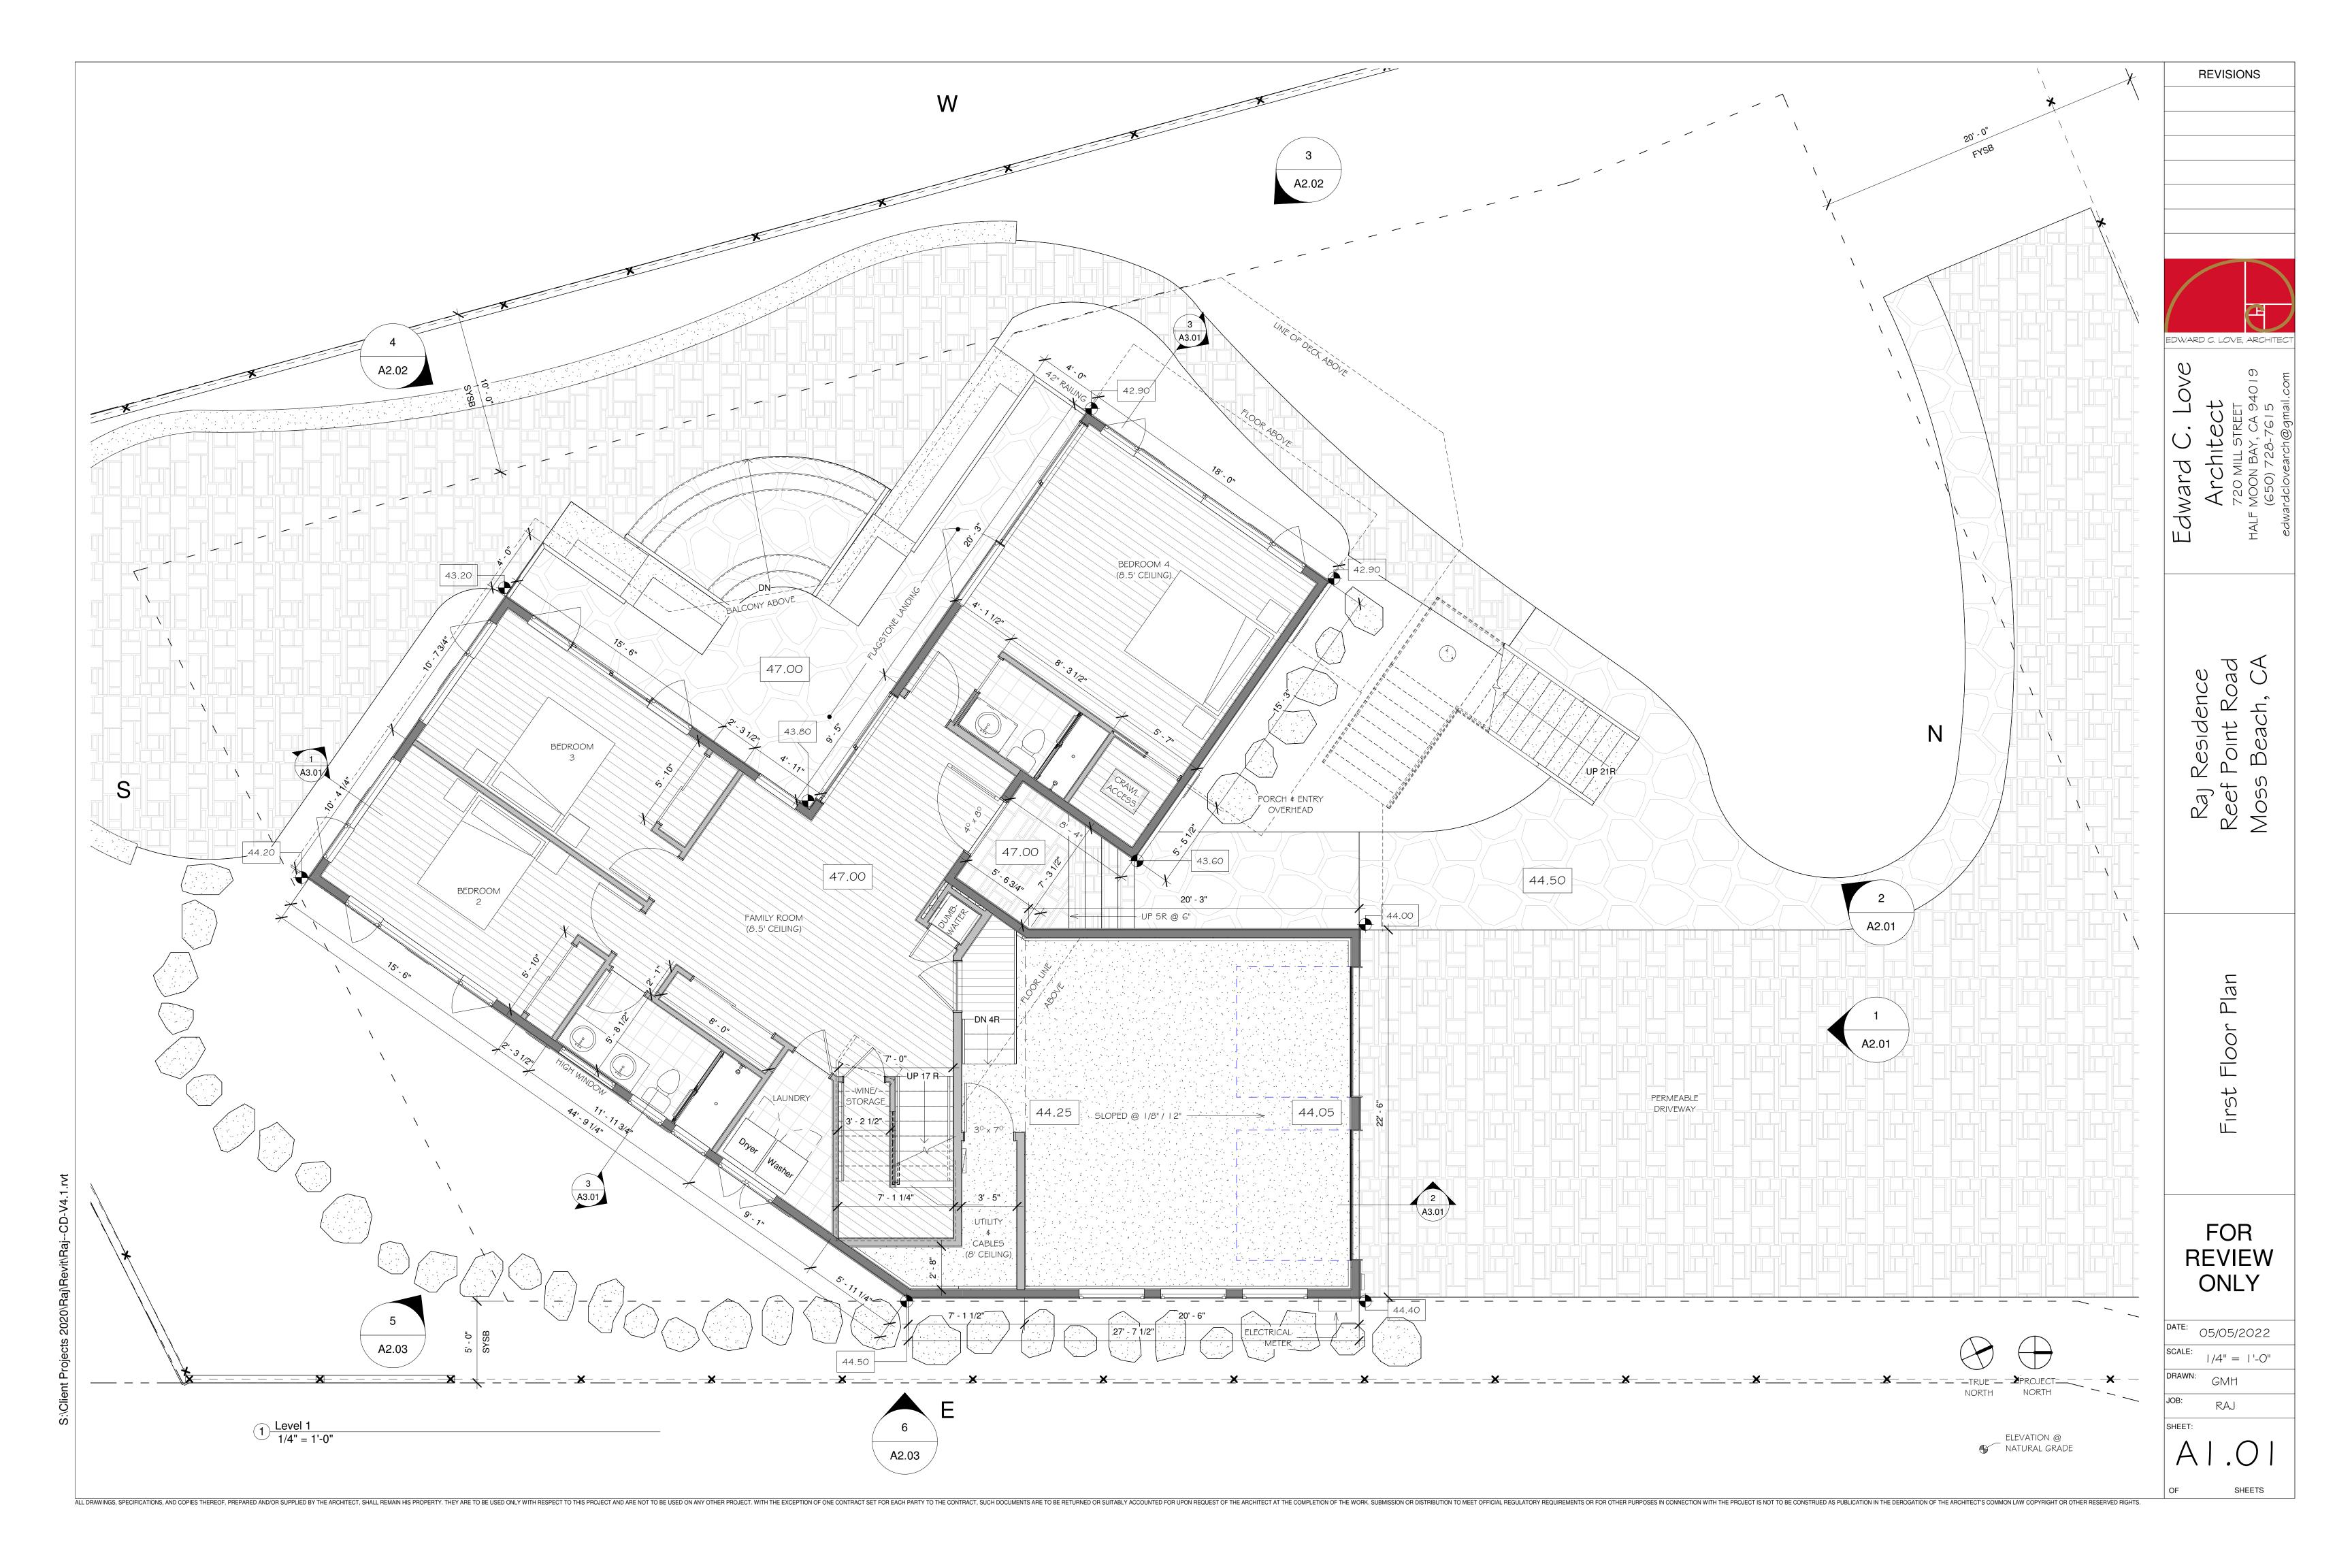

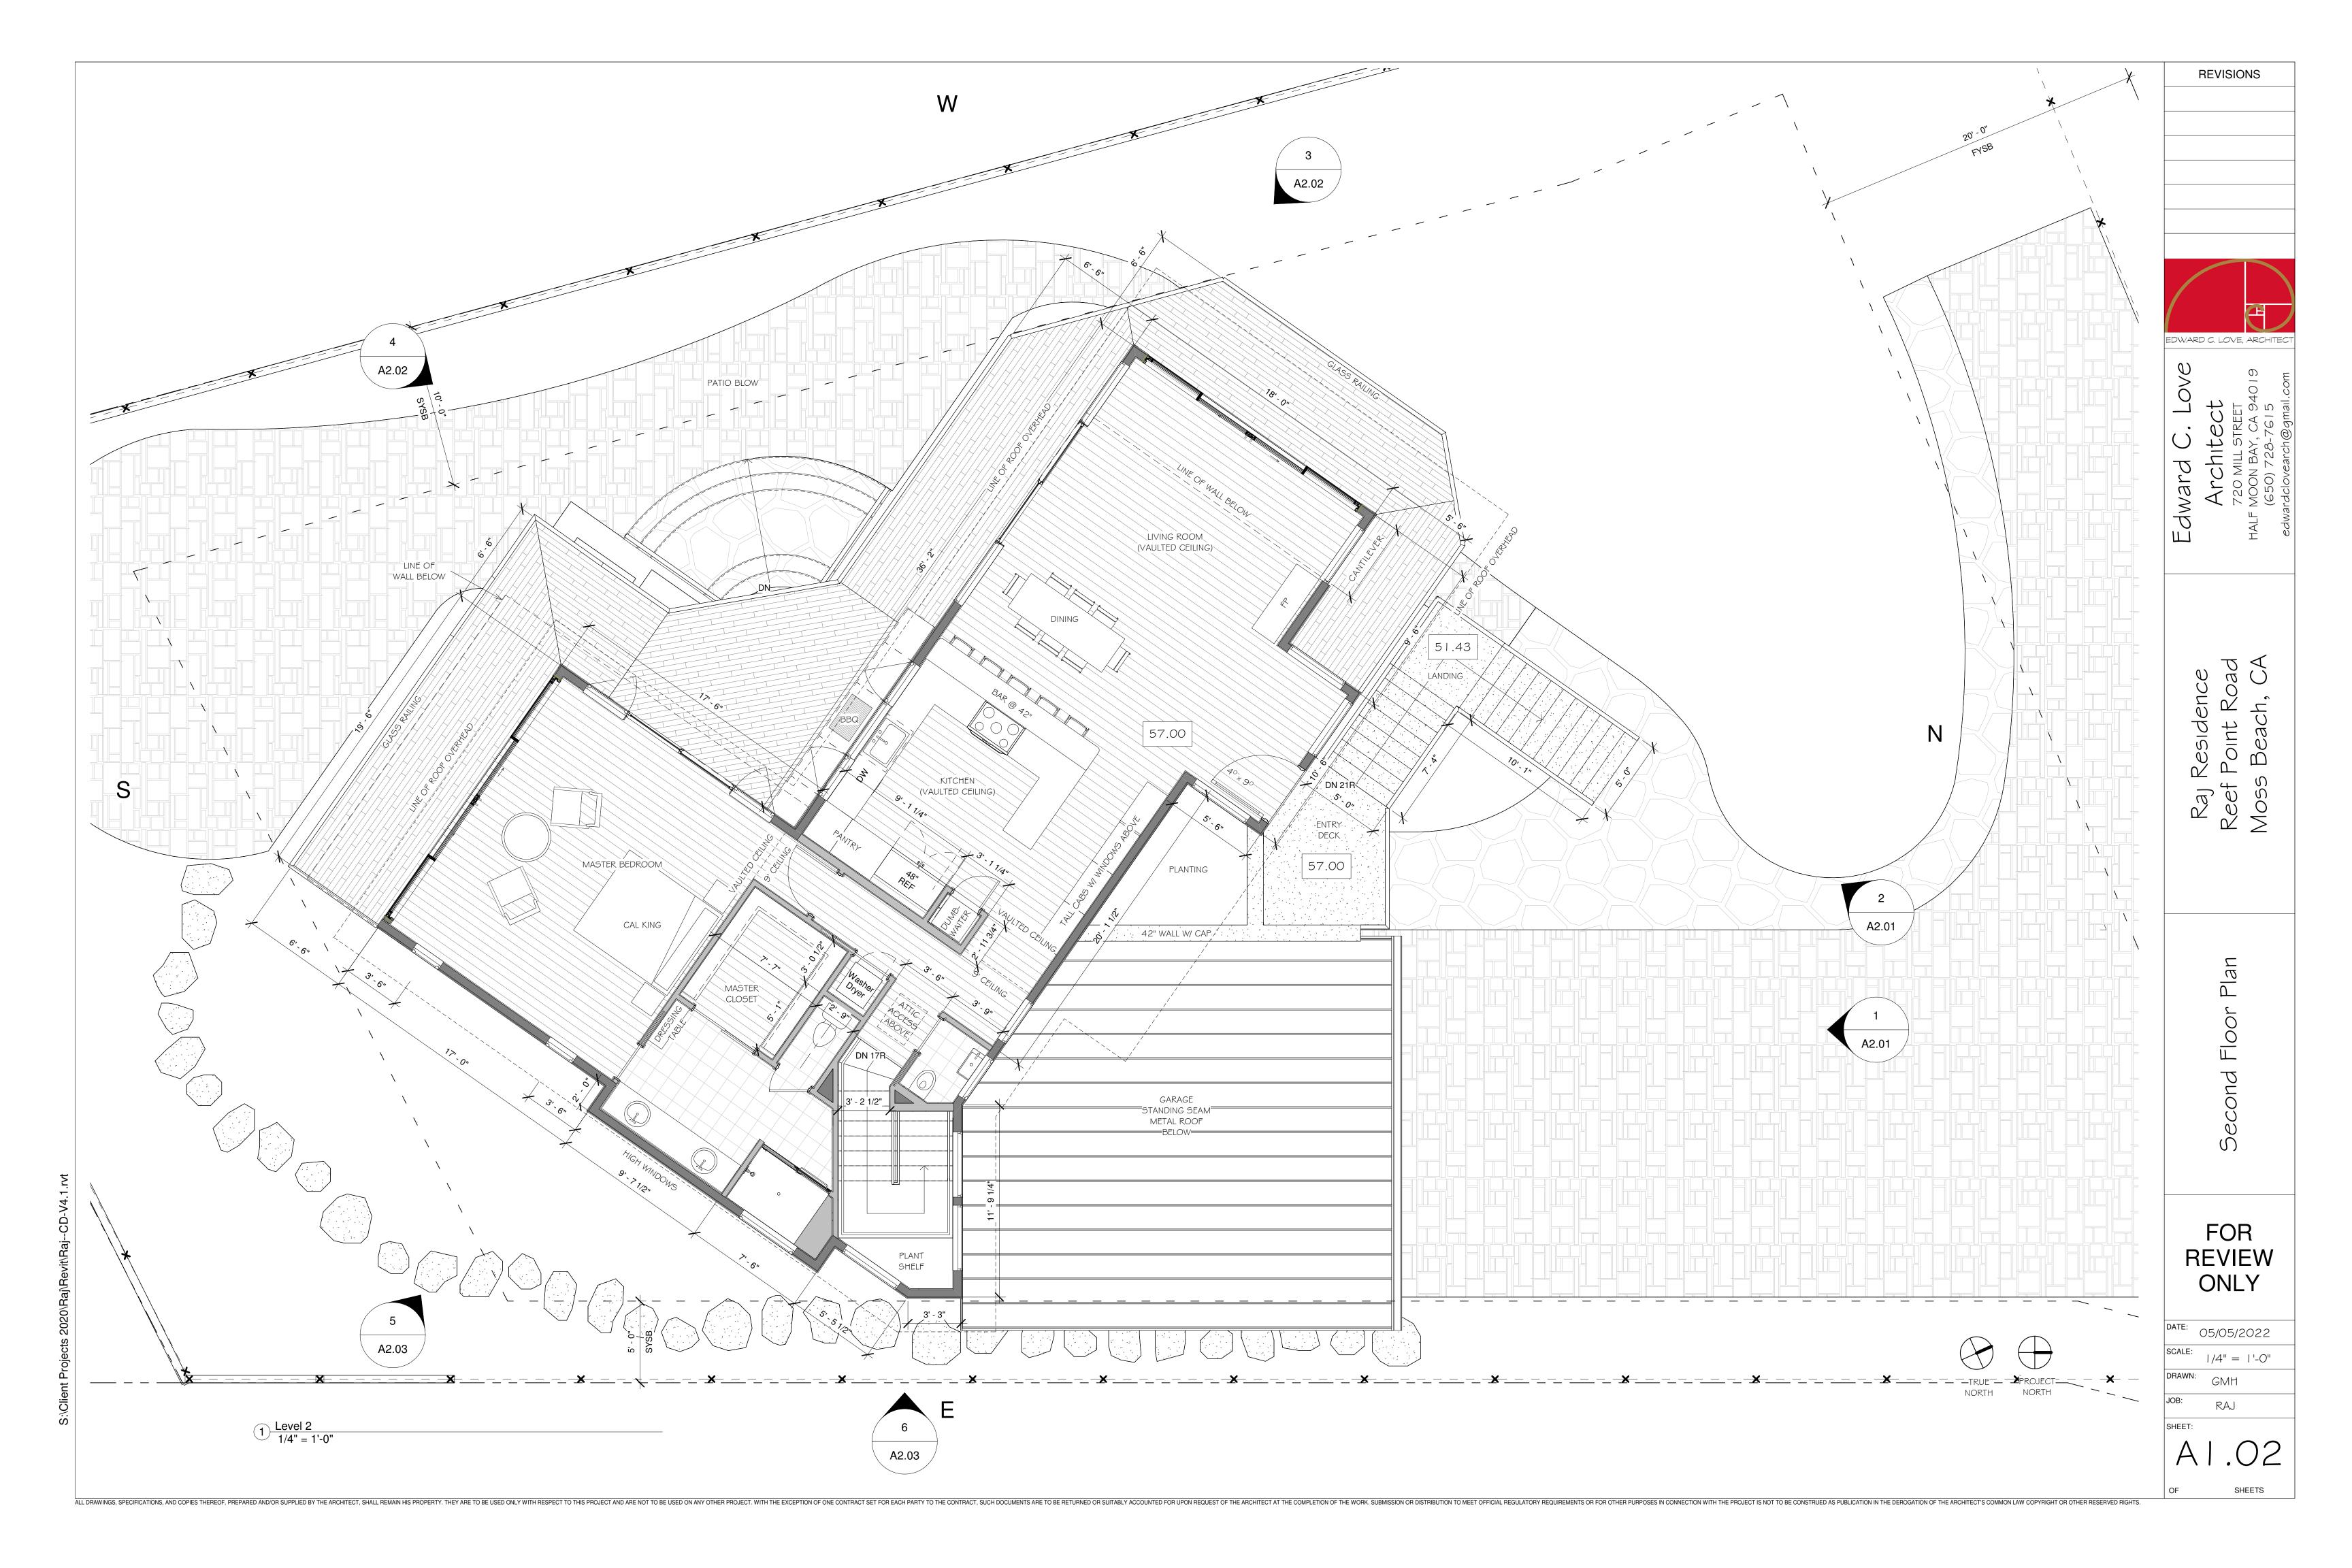

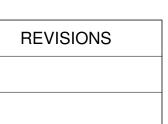



Level I Bedroom2			
Bedroom3 I 88 SF Floor Area Bedroom4 373 SF Floor Area Entry 66 SF Floor Area Family Room 347 SF Floor Area Garage 517 SF Floor Area/Lot Coverage Laundry 64 SF Floor Area	Level I		
Bedroom4 373 SF Floor Area Entry 66 SF Floor Area Family Room 347 SF Floor Area Garage 517 SF Floor Area/Lot Coverage Laundry 64 SF Floor Area	Bedroom2	188 SF	Floor Area
Entry 66 SF Floor Area Family Room 347 SF Floor Area Garage 517 SF Floor Area/Lot Coverage Laundry 64 SF Floor Area	Bedroom3	188 SF	Floor Area
Family Room 347 SF Floor Area Garage 517 SF Floor Area/Lot Coverage Laundry 64 SF Floor Area	Bedroom4	373 SF	Floor Area
Garage 517 SF Floor Area/Lot Coverage Laundry 64 SF Floor Area	Entry	66 SF	Floor Area
Laundry 64 SF Floor Area	Family Room	347 SF	Floor Area
2. C.	Garage	517 SF	Floor Area/Lot Coverage
Stairwell 75 SF Floor Area/Lot Coverage	Laundry	64 SF	Floor Area
	Stairwell	75 SF	Floor Area/Lot Coverage
Utility 59 SF Floor Area/Lot Coverage	Utility	59 SF	Floor Area/Lot Coverage


Level 2		
Balcony	696 SF	Lot Coverage
Hall	102 SF	Floor Area/Lot Coverage
Kıtchen	255 SF	Floor Area/Lot Coverage
Living/Dining Room	461 SF	Floor Area/Lot Coverage
Master Bath	153 SF	Floor Area/Lot Coverage
Master Bedroom	412 SF	Floor Area/Lot Coverage
Porch & Stair	237 SF	Lot Coverage

Level 2 - ToP		
Attıc	362 SF	

TOTAL FLOOR AREA : 3260 TOTAL LOT COVERAGE : 2967

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(A202)

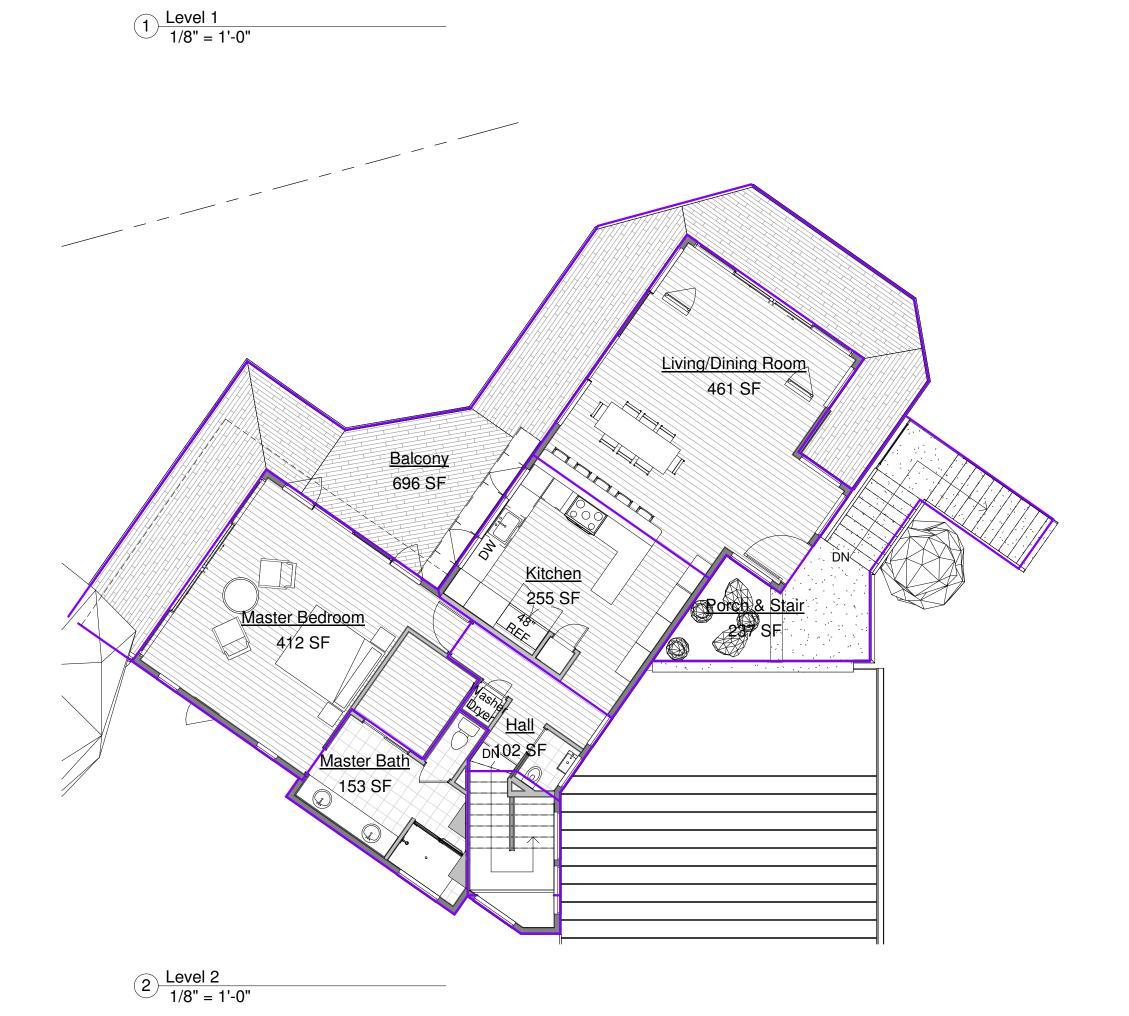


GFÇI , EV- GFÇI

GFCI ()

Garage

517 SF

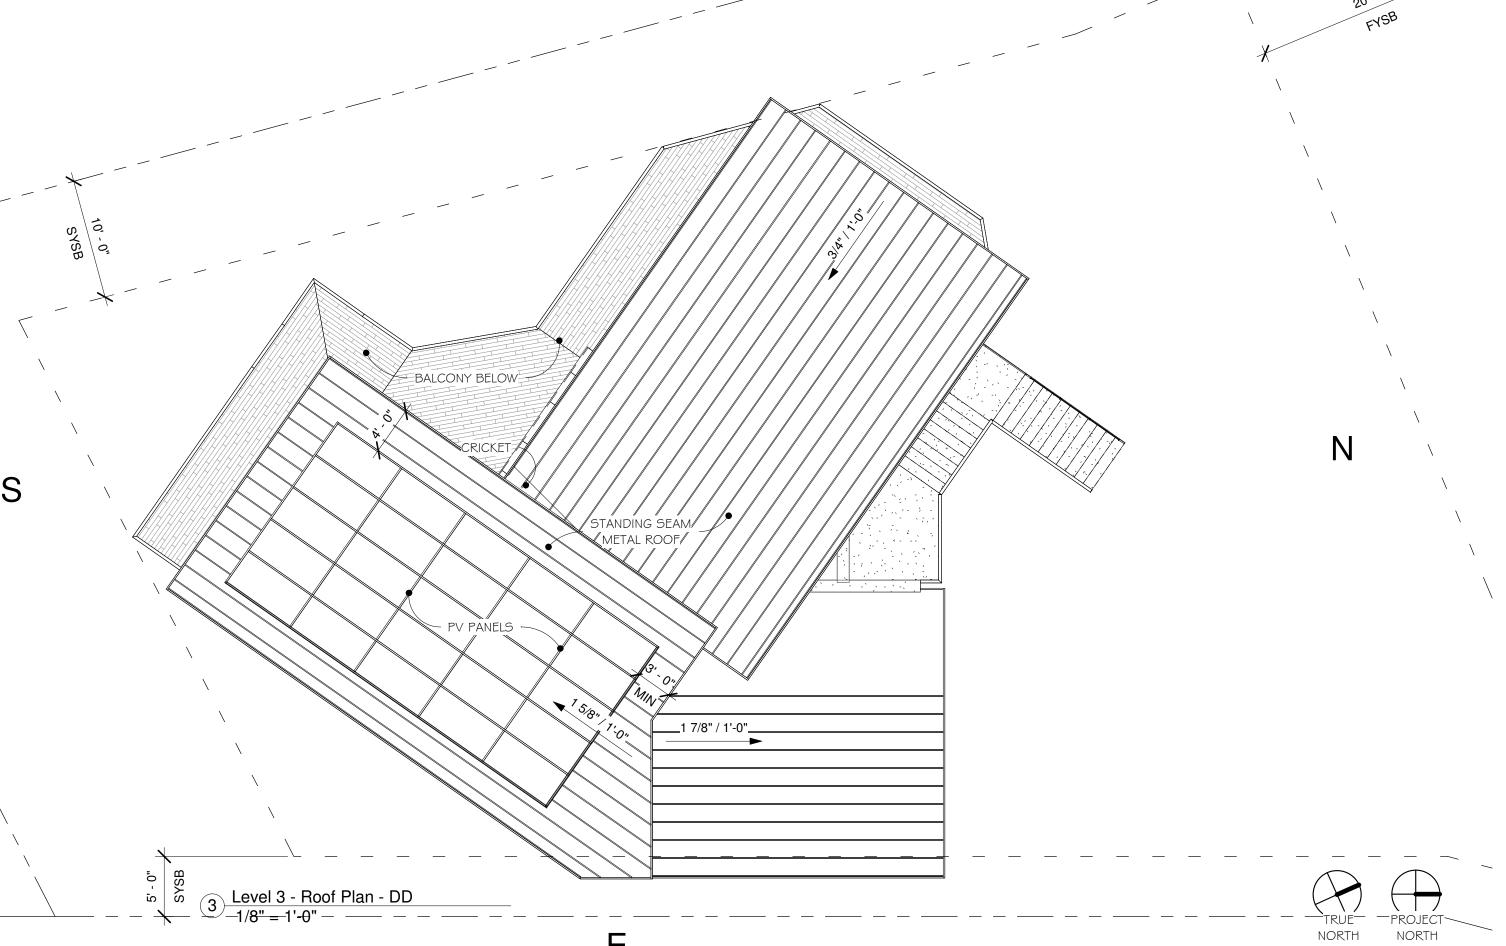

EDWARD C. LOVE, ARCHITECT

Plan & Lice Calculations Roof

FOR REVIEW ONLY

DATE: 05/05/2022 1/8" = 1'-0"

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REVISIONS

EDWARD C. LOVE, ARCHITECT

dward

Residence f Point Road s Beach, CA Raj Reef

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DATE: 05/05/2022 1/4" = 1'-0"

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> West Elevations - W South

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DATE: 05/05/2022 1/4" = 1'-0"

RAJ

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EDWARD C. LOVE, ARCHITEC

REVISIONS

WARD C. LOVE, ARC

Edward C. Love
Architect
720 MILL STREET

Ray Residence Reef Point Road

Elevations - East

FOR REVIEW ONLY

DATE: 05/05/2022

SCALE: 1/4" = 1'-0"

DRAWN: GMH

JOB:

A2.03

:\Client Projects 2020\Raj\R

A2.04


72.02



View Looking South
1/4" = 1'-0"



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Edward C. Love Architect
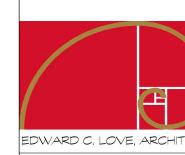
> Raj Residence Reef Point Road Moss Beach, CA

> > ection Views

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DATE: 05/05/2022


SCALE: 1/4" = 1'-0"

DRAWN: GMH

JOB: RAJ

SHEET:

A3.0
of sheets

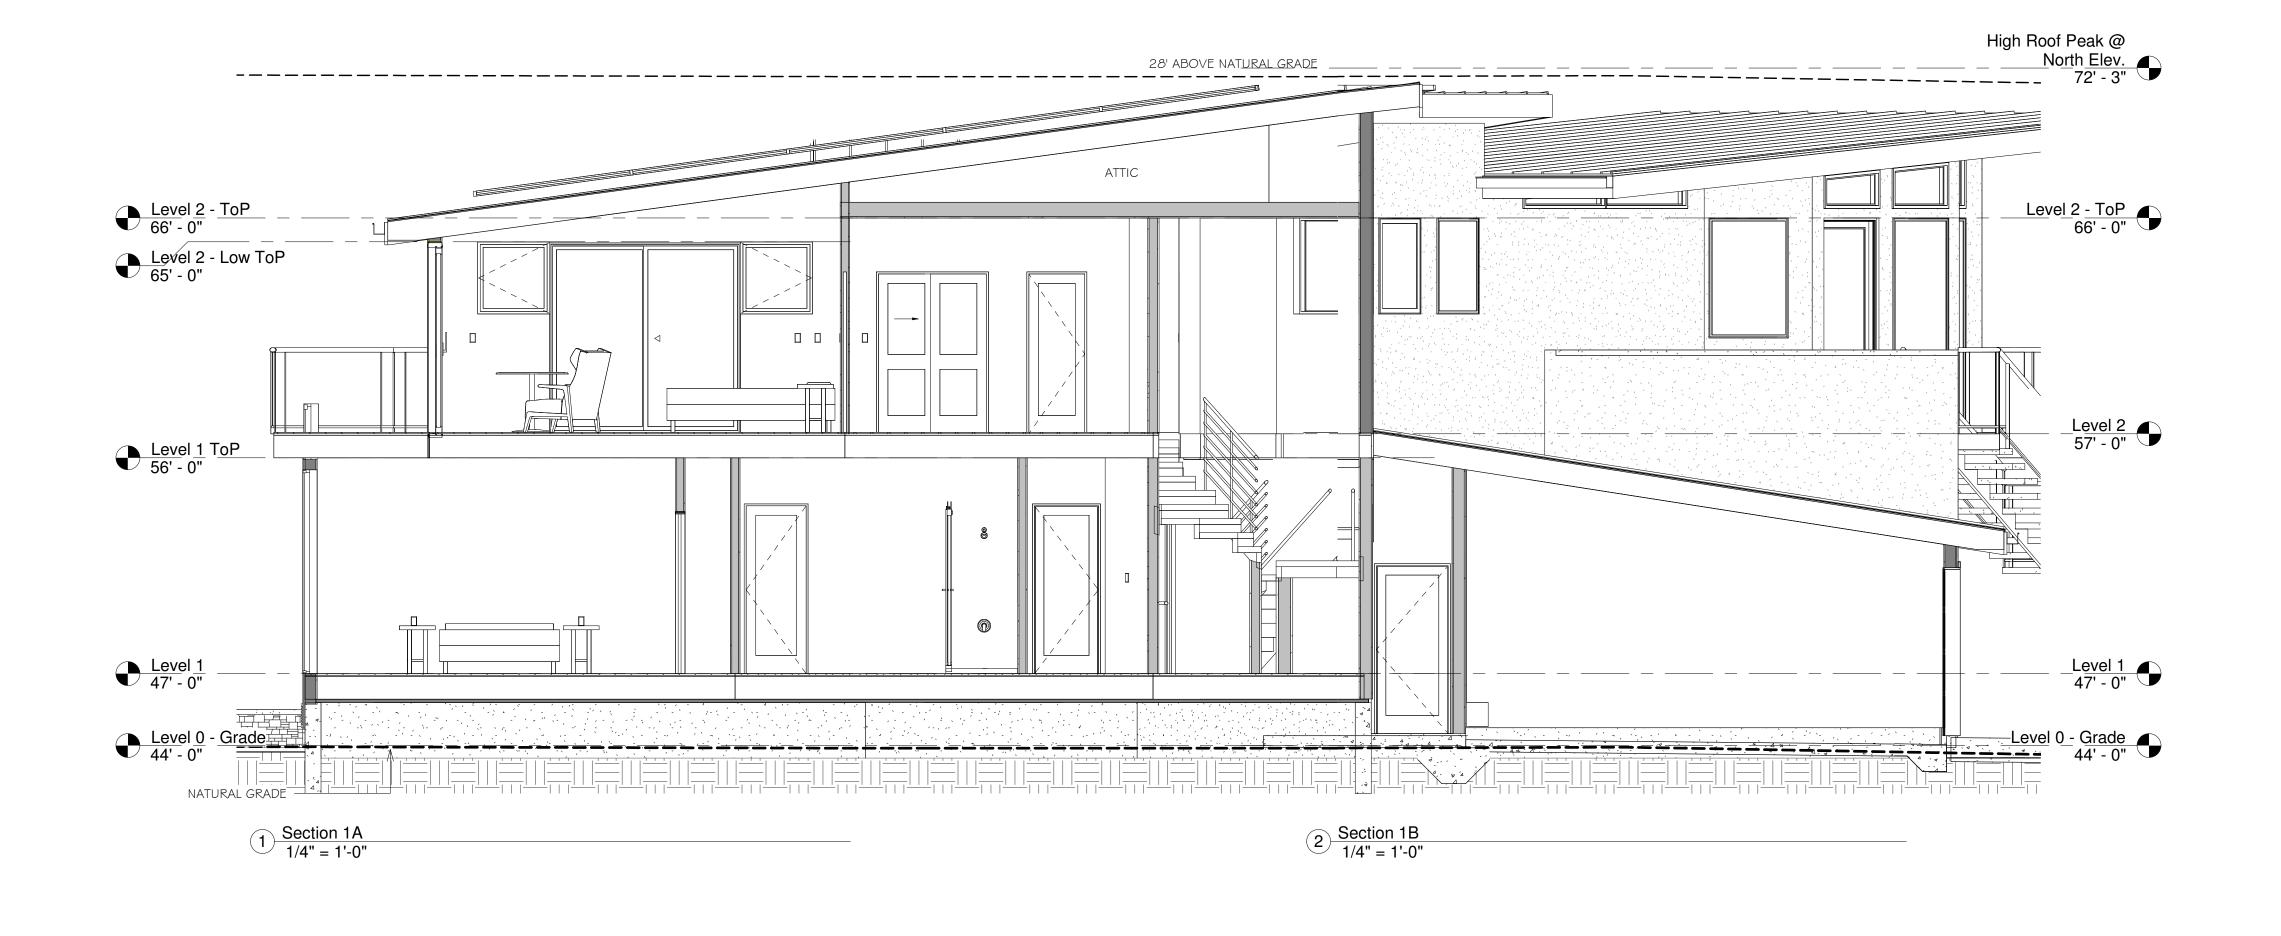



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:\Client Projects 2020\Raj\Revit\Raj--CD-V4.1.r

The outdoor LED wall lantern is uniquely designed with a contemporary feel. Its durable aluminum construction with hand painted black finish and frosted glass gives a sophisticated look.

This uniquely designed fixture is the choice of discriminating yet value conscious homeowners

who want to enrich their home.

Darksky certified Light color is 3000K (bright white) 80 CRI and uses only 5.5-Watt

<u>Specifications</u>

Product Height (in.) 8.01 Product Length (in.) 8.01 Product Width (in.) 4.49

Actual Color Temperature (K) Color Temperature

Exterior Lighting Product Type Cylinder Lights Fixture Color/Finish Fixture Material

Light Bulb Type Included Number of Bulbs Required O Maximum Wattage (watts)

Watt Equivalence Outdoor Lighting Features Dark Sky, Weather Resistant, Weather Resistant

Power Type Hardwired 2.29lb Product Weight (lb.) Style




Jak Multı Slate Ledge Stone


GARAGE DOOR


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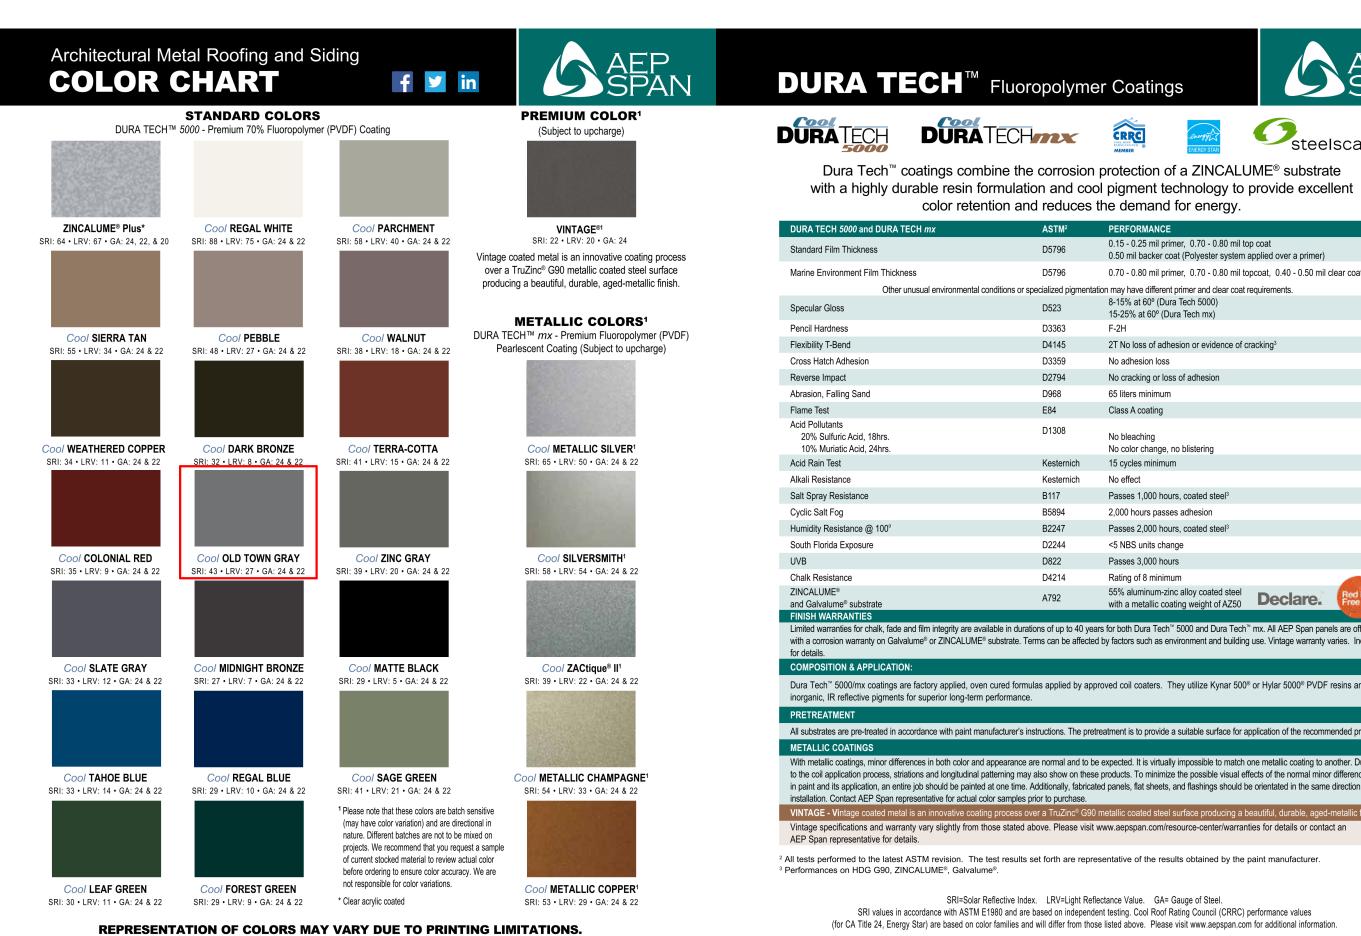
Amarr Vista VI1000 Contemporary Aluminum Full View Garage Doors





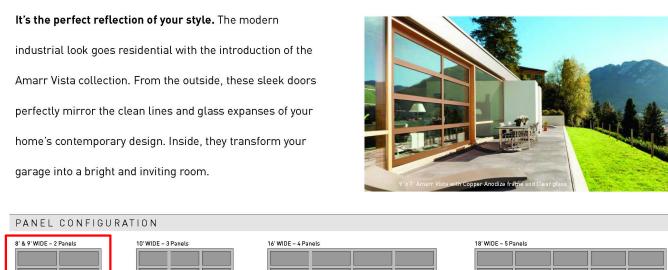

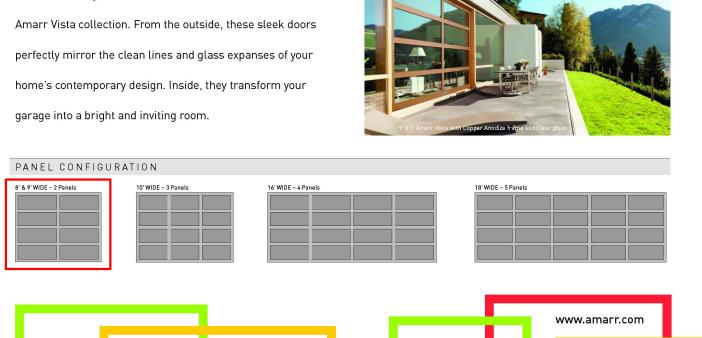

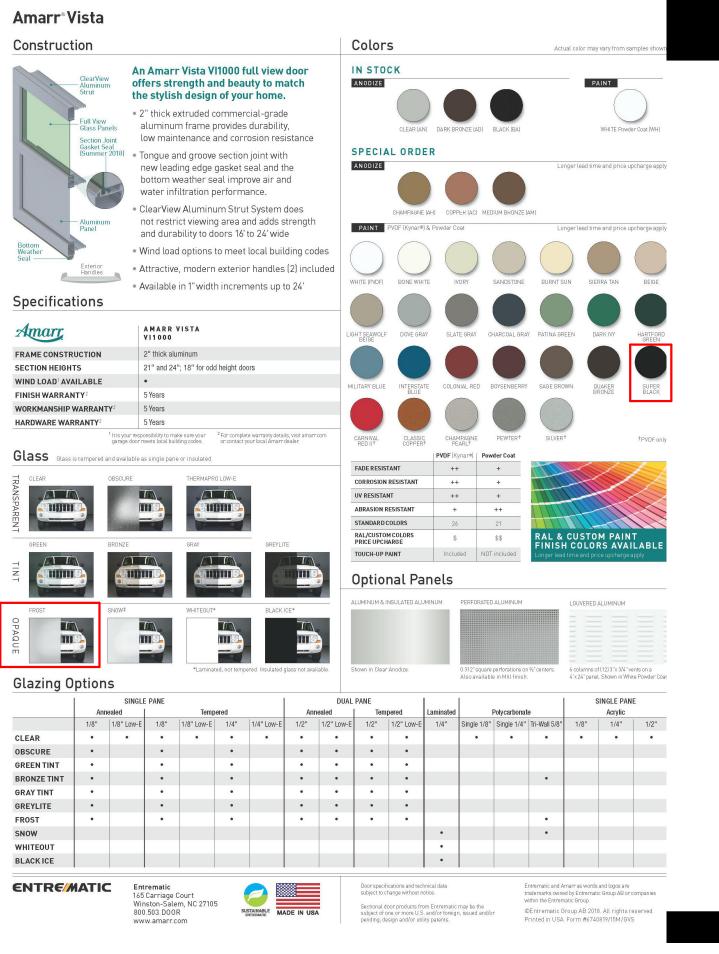


Sample color chips are available upon request. Consult your AEP Span representative for more information.

Custom colors available by request


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ROOF




SRI values in accordance with ASTM E1980 and are based on independent testing. Cool Roof Rating Council (CRRC) performance values

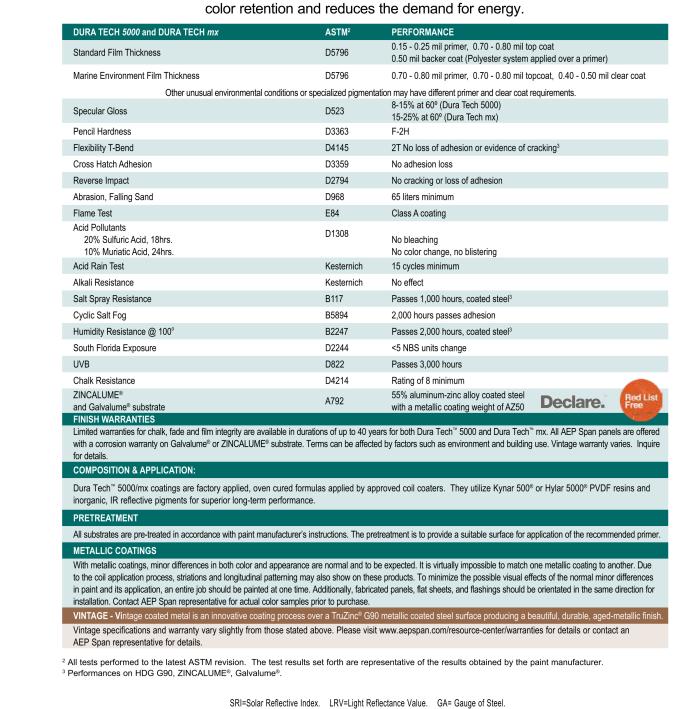

DATE: 05/05/2022 SCALE: DRAWN: GMH RAJ

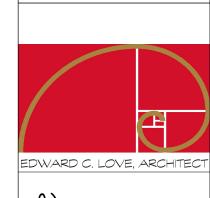800-733-4955

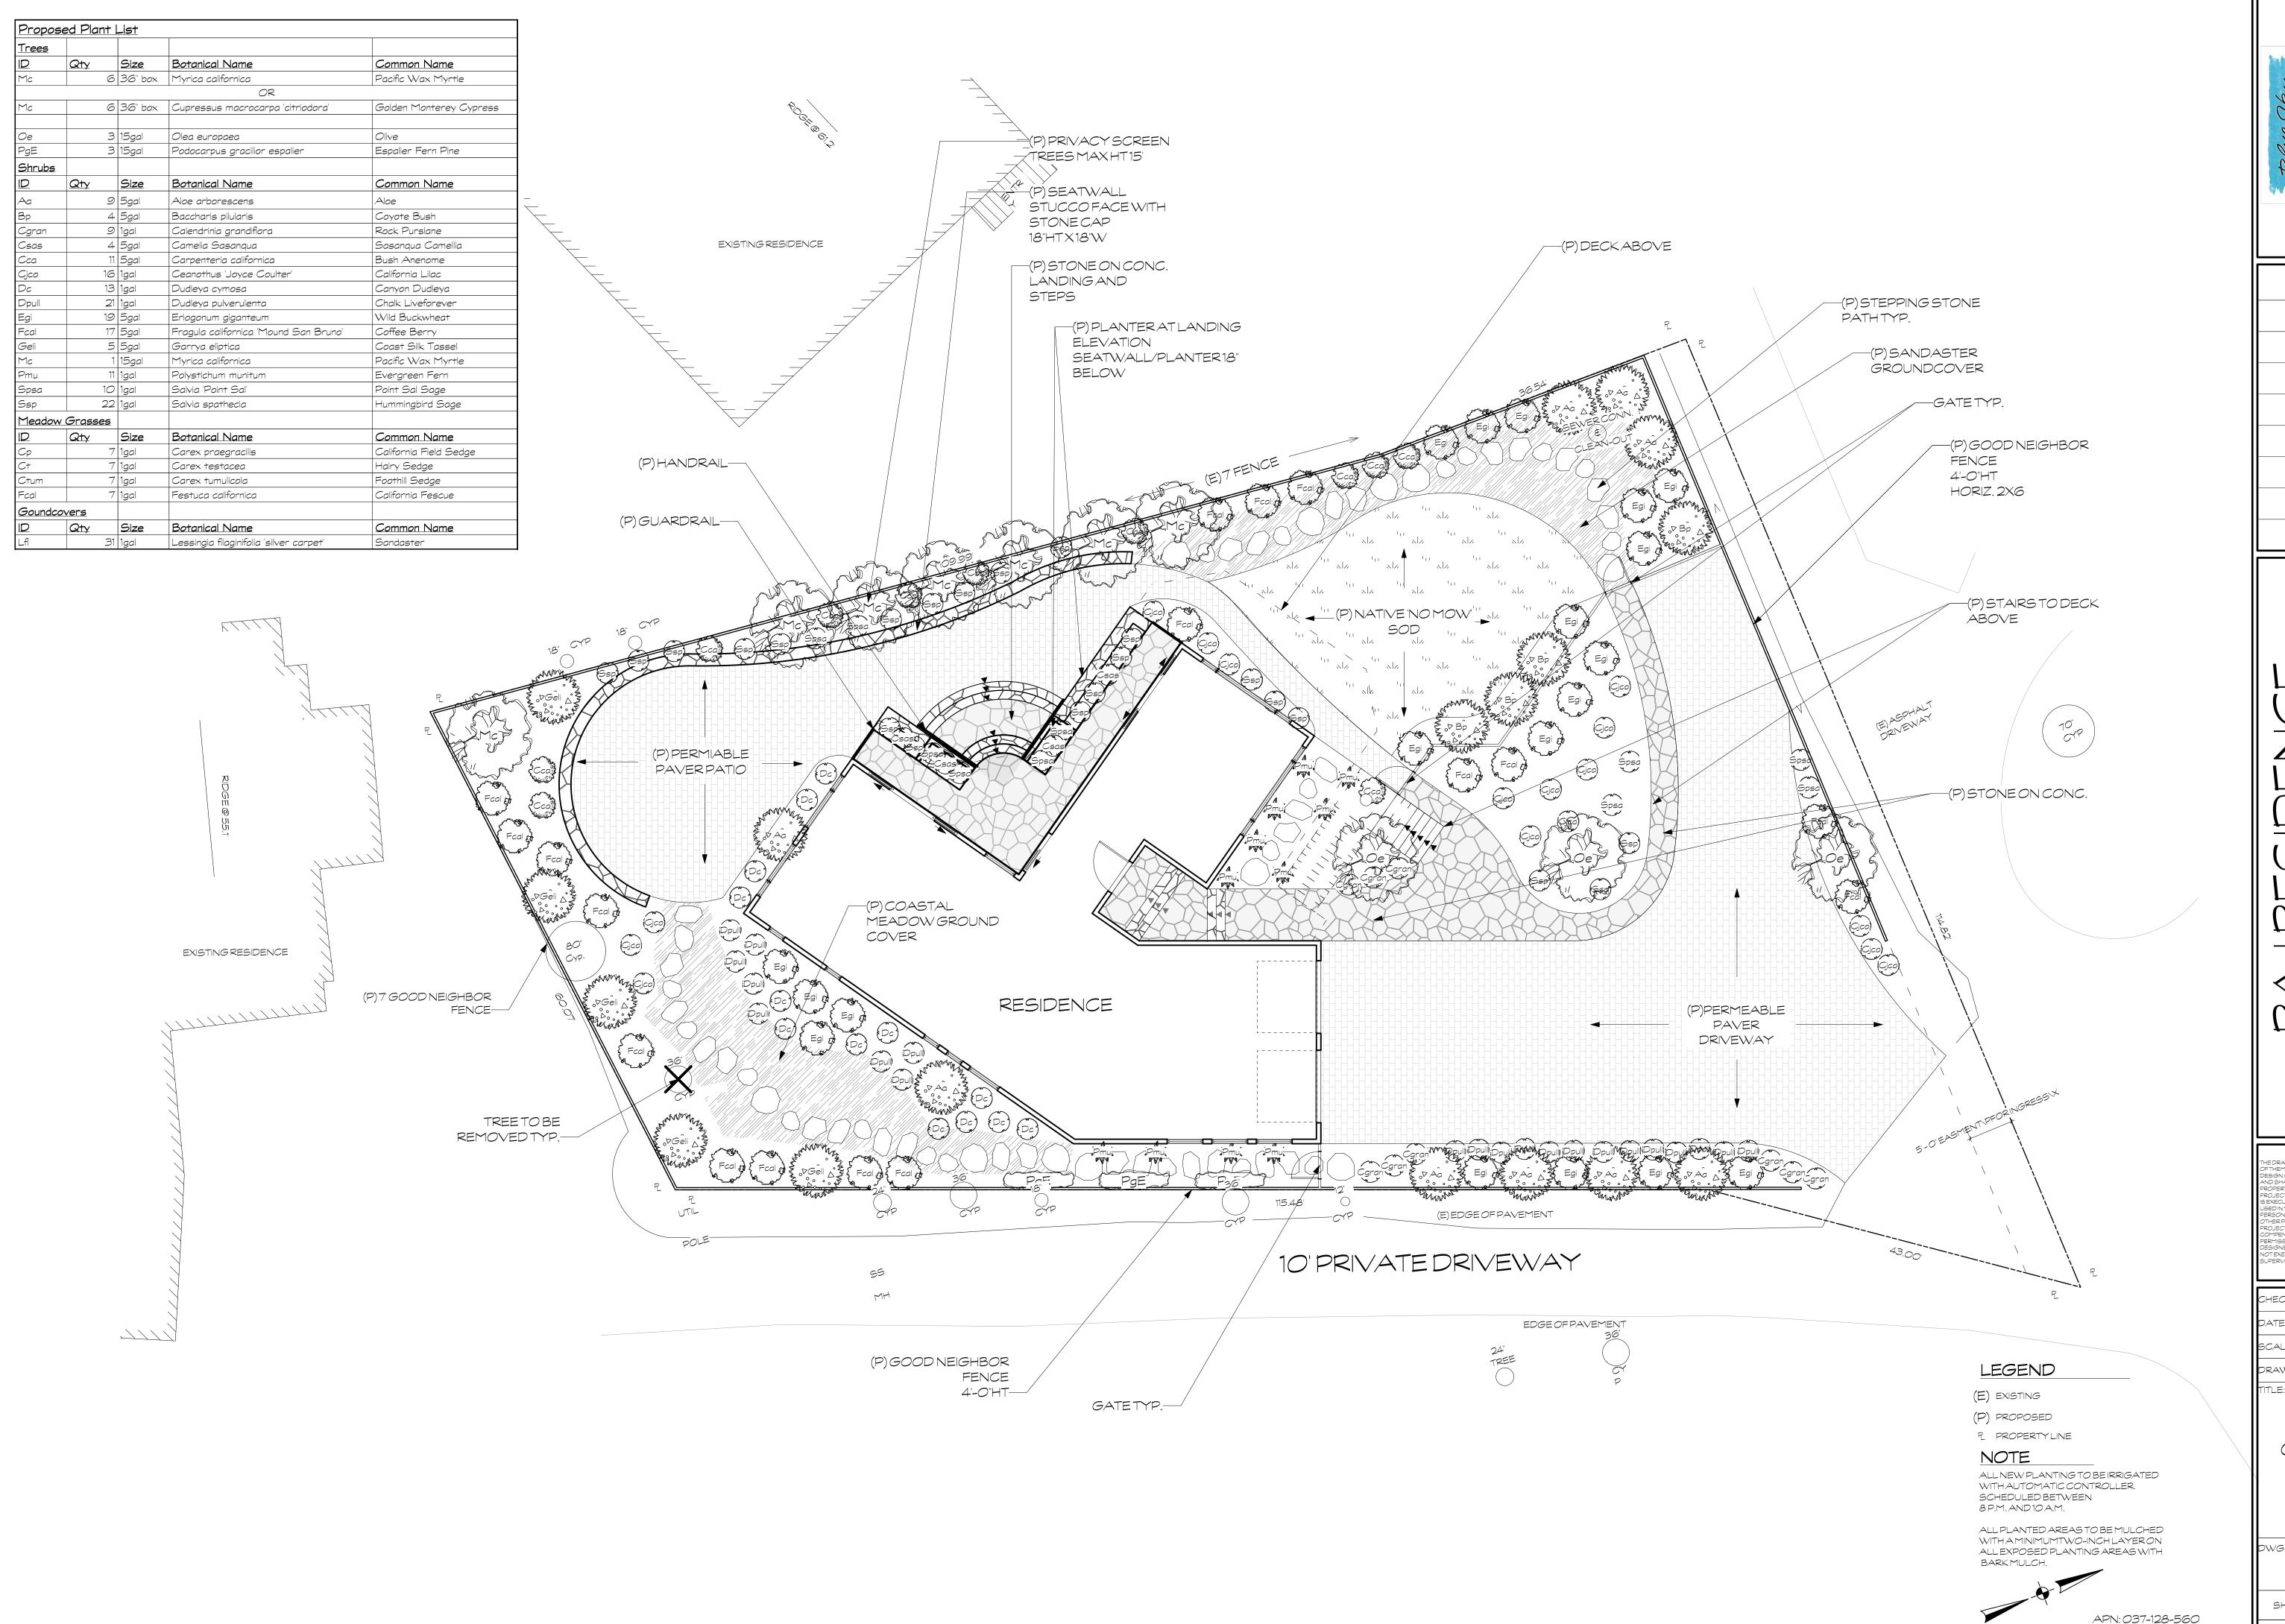

REVISIONS		
DATE	BY	

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DATE 1/26/2022
SCALE 1/8"=1'
DRAWN K.C.

CONCEPT PLAN

DWG.NO.

SHEET 1 OF 1

RAJ