

# NEW RESIDENCE FOR ERNST DEVELOPMENT DOLTON AVENUE SAN CARLOS, CA. 94070

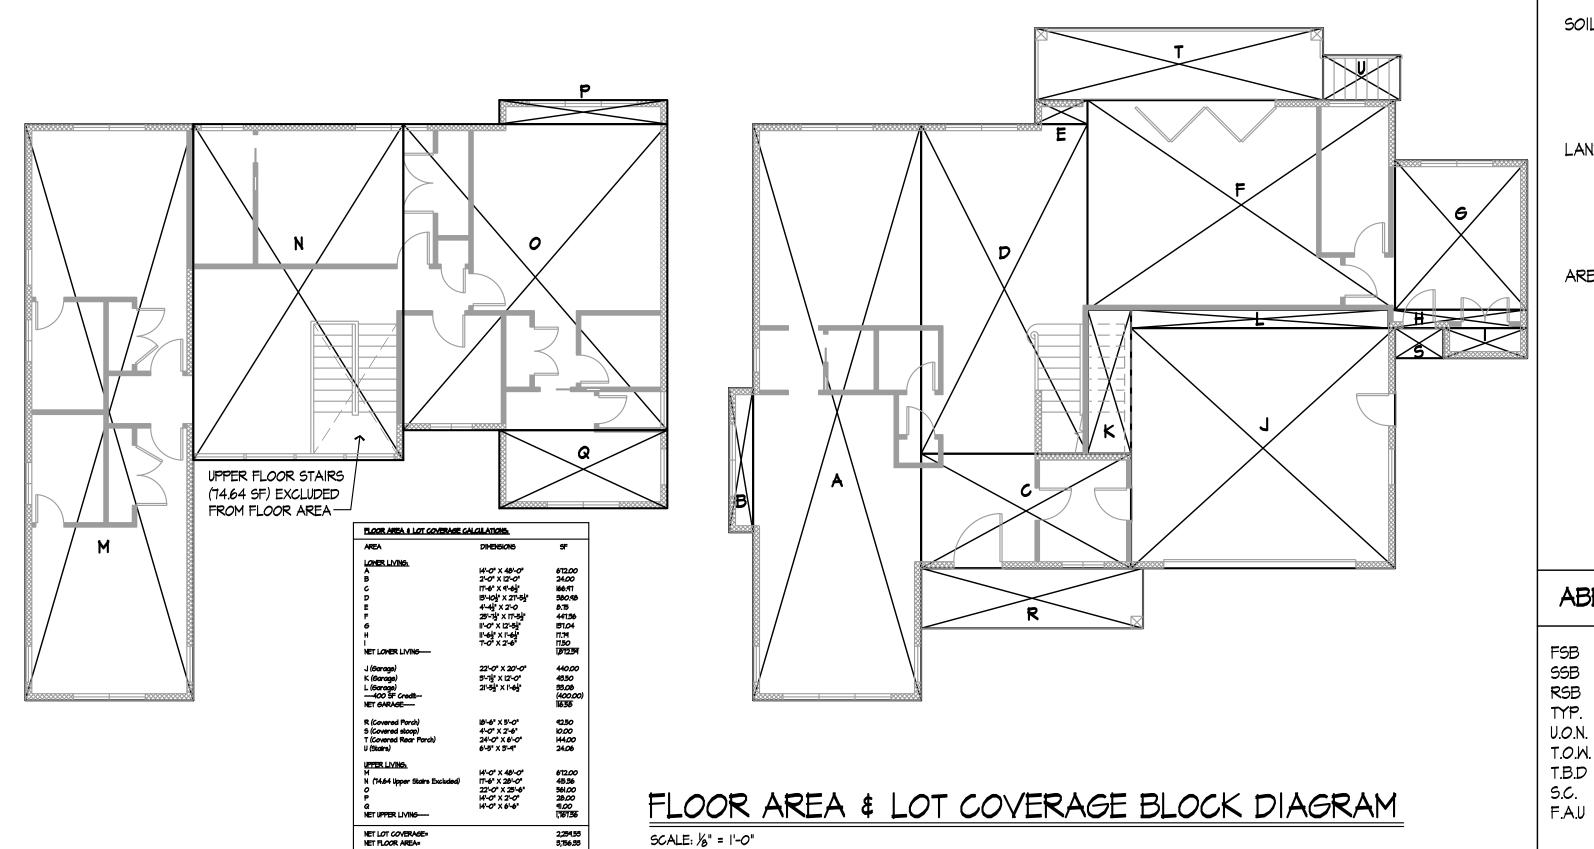

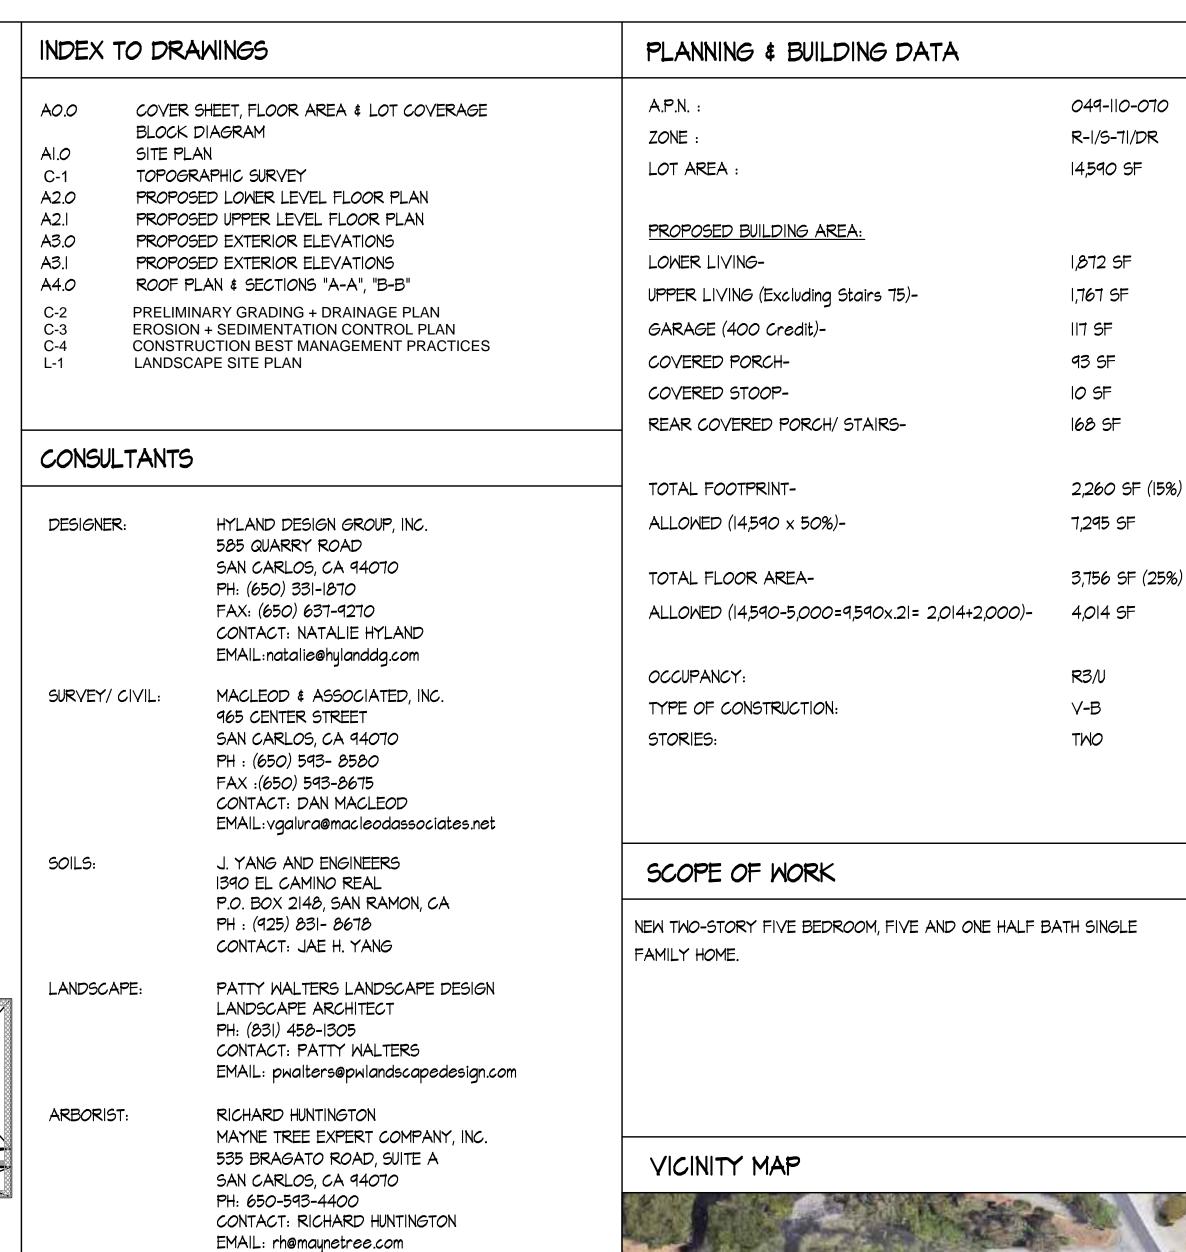

FORCE AIR UNIT

FINISHED SLAB

FINISH FLOOR

FIREPLACE

GUEST

TOP OF

FINISHED GRADE

AIR CONDITIONING

ABOVE FINISH FLOOR

A.C.

T.O.

ABBREVIATIONS

FRONT SETBACK

SIDE SETBACK

TYPICAL

REAR SETBACK

TOP OF WINDOW

FORCE AIR UNIT

SOLID CORE

TO BE DETERMINED

UNLESS OTHERWISE NOTED

**REVISIONS** 

**HYLAND** 

**DESIGN GROUP** 

Office:650.331.1870 fax:650.637.9270

585 Quarry Road San Carlos Ca 94070


www.hylanddg.com

Sheet Title

COVER SHEET

8.28.2020

|"=|0'-0"

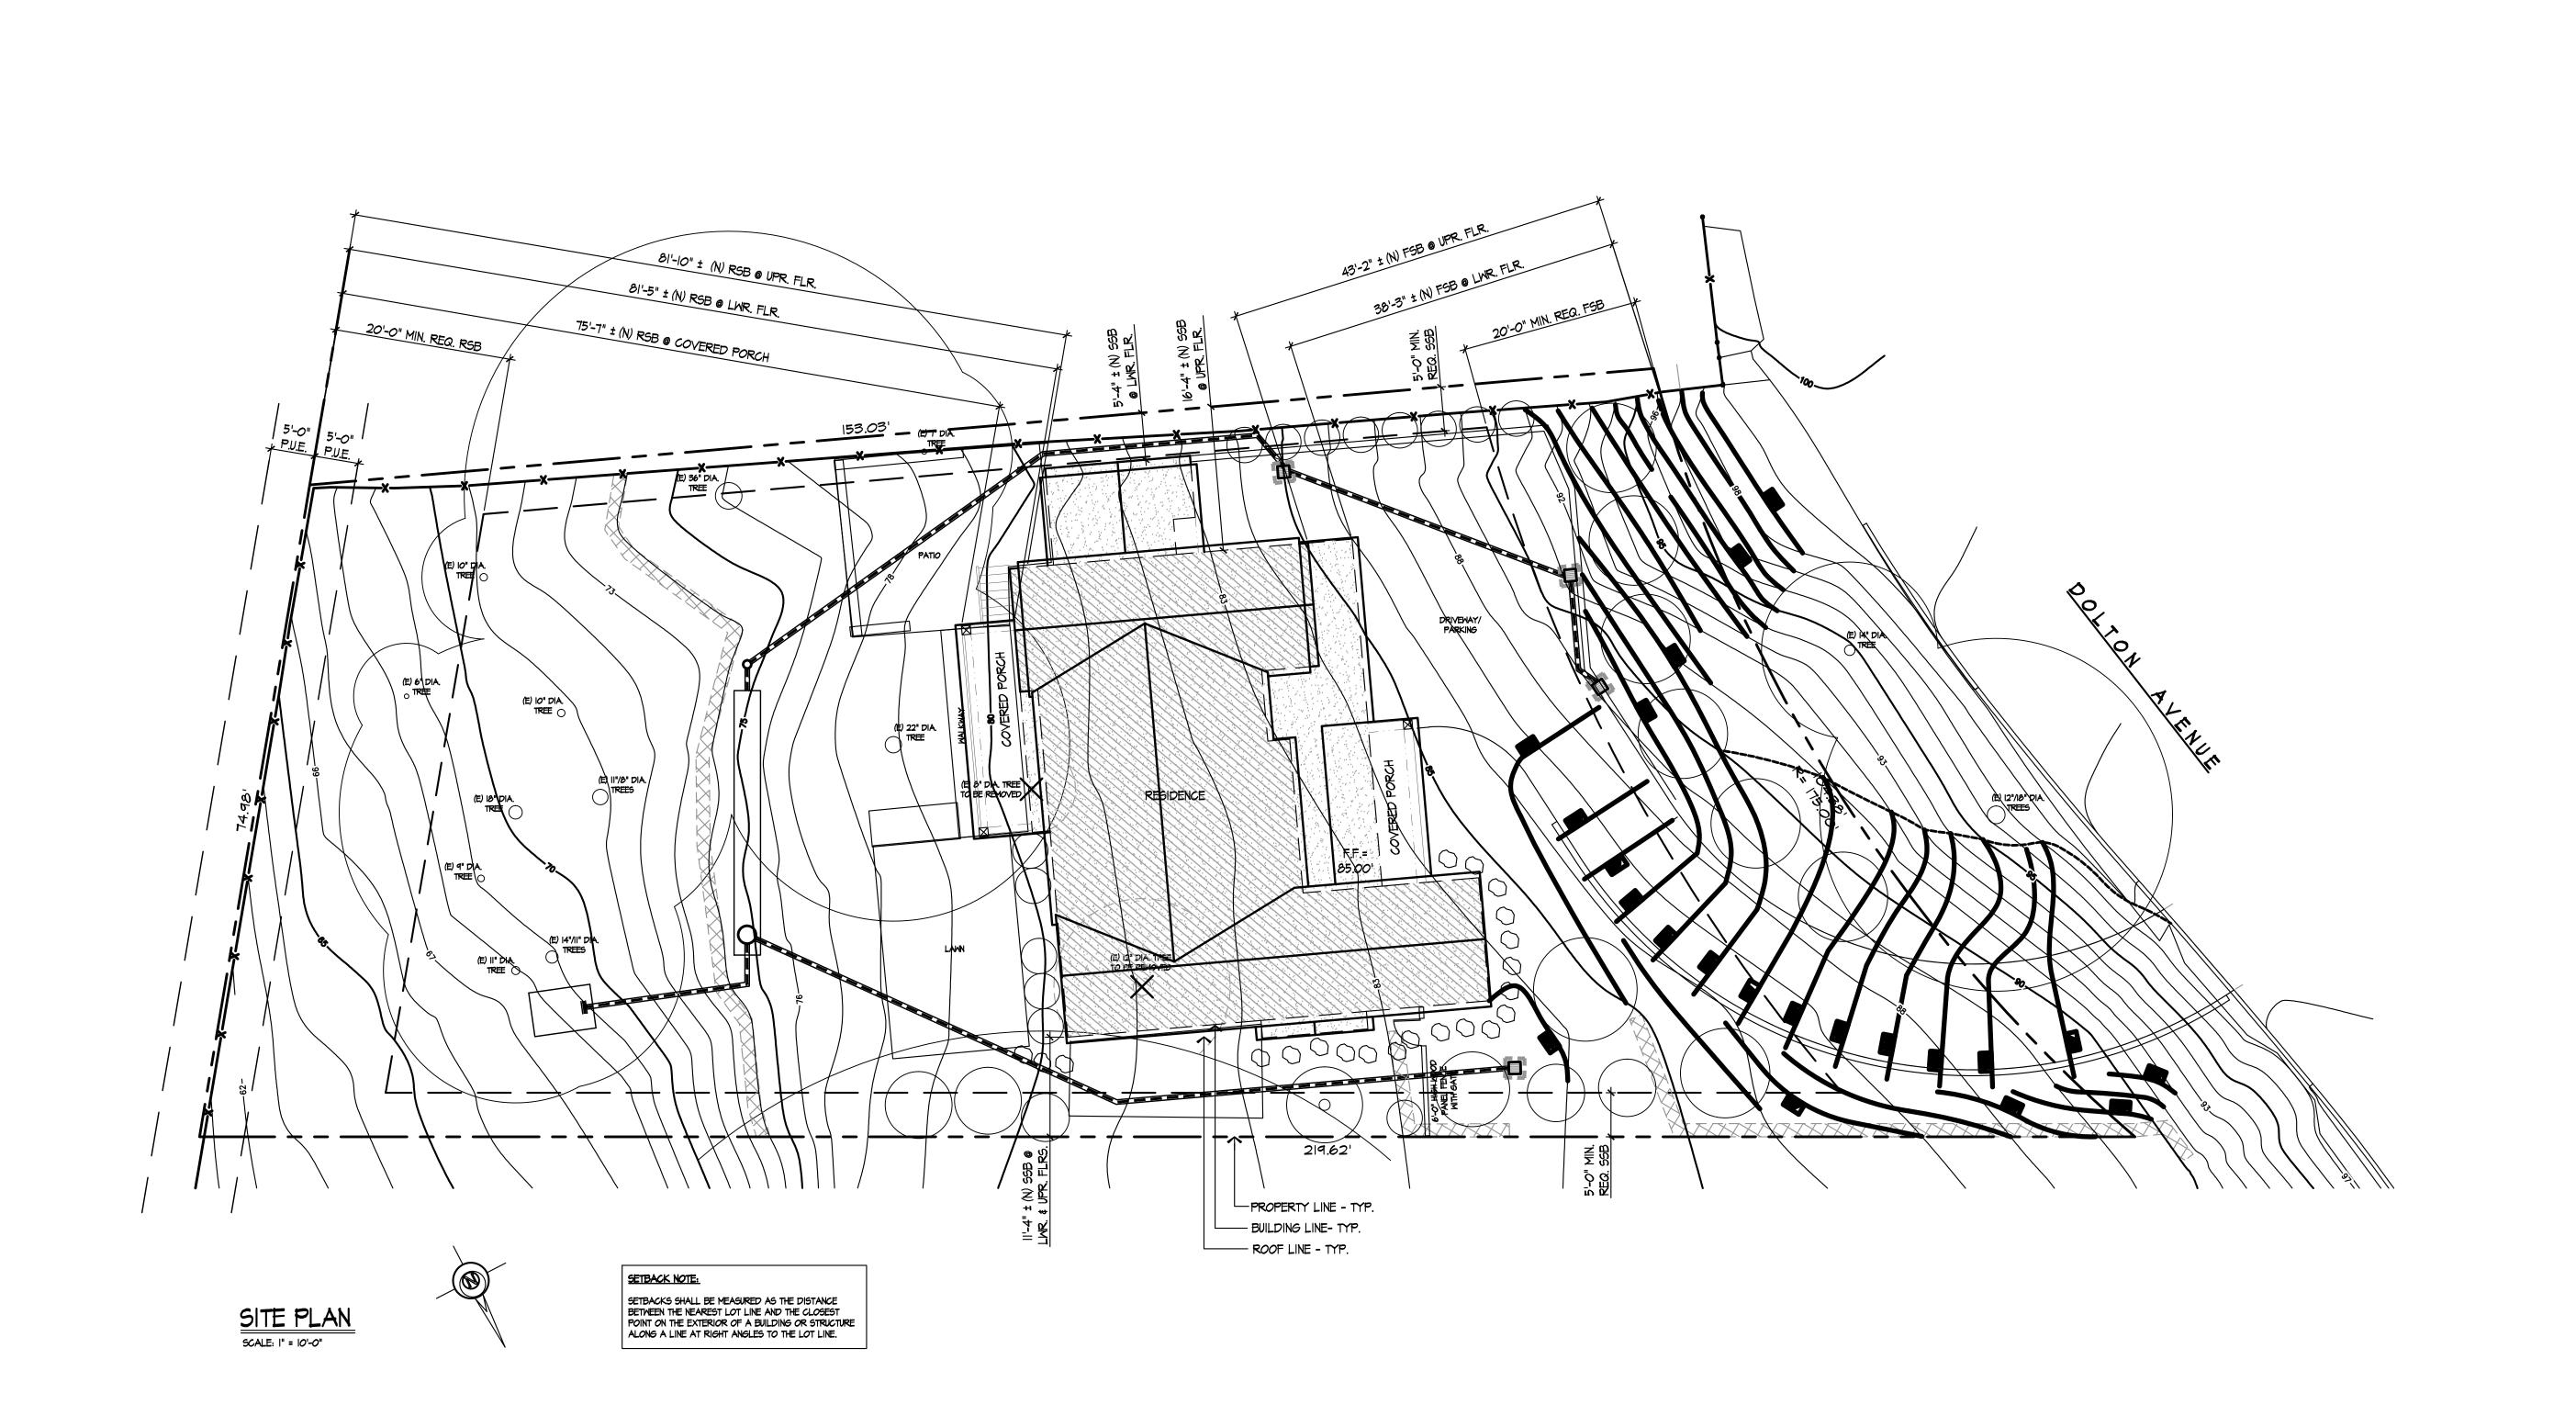

REVISIONS BY

HYLAND DESIGN GROUP

Office:650.331.1870 fax:650.637.9270 585 Quarry Road San Carlos Ca 94070 www.hylanddg.com

NEW RESIDENCE FOR ERNST DEVELOPMENT

Sheet Title

SITE PLAN


Scale: | |"=|0'-0"


Designed: HDG

Drawn: RC

Neet No.

Of Sheets

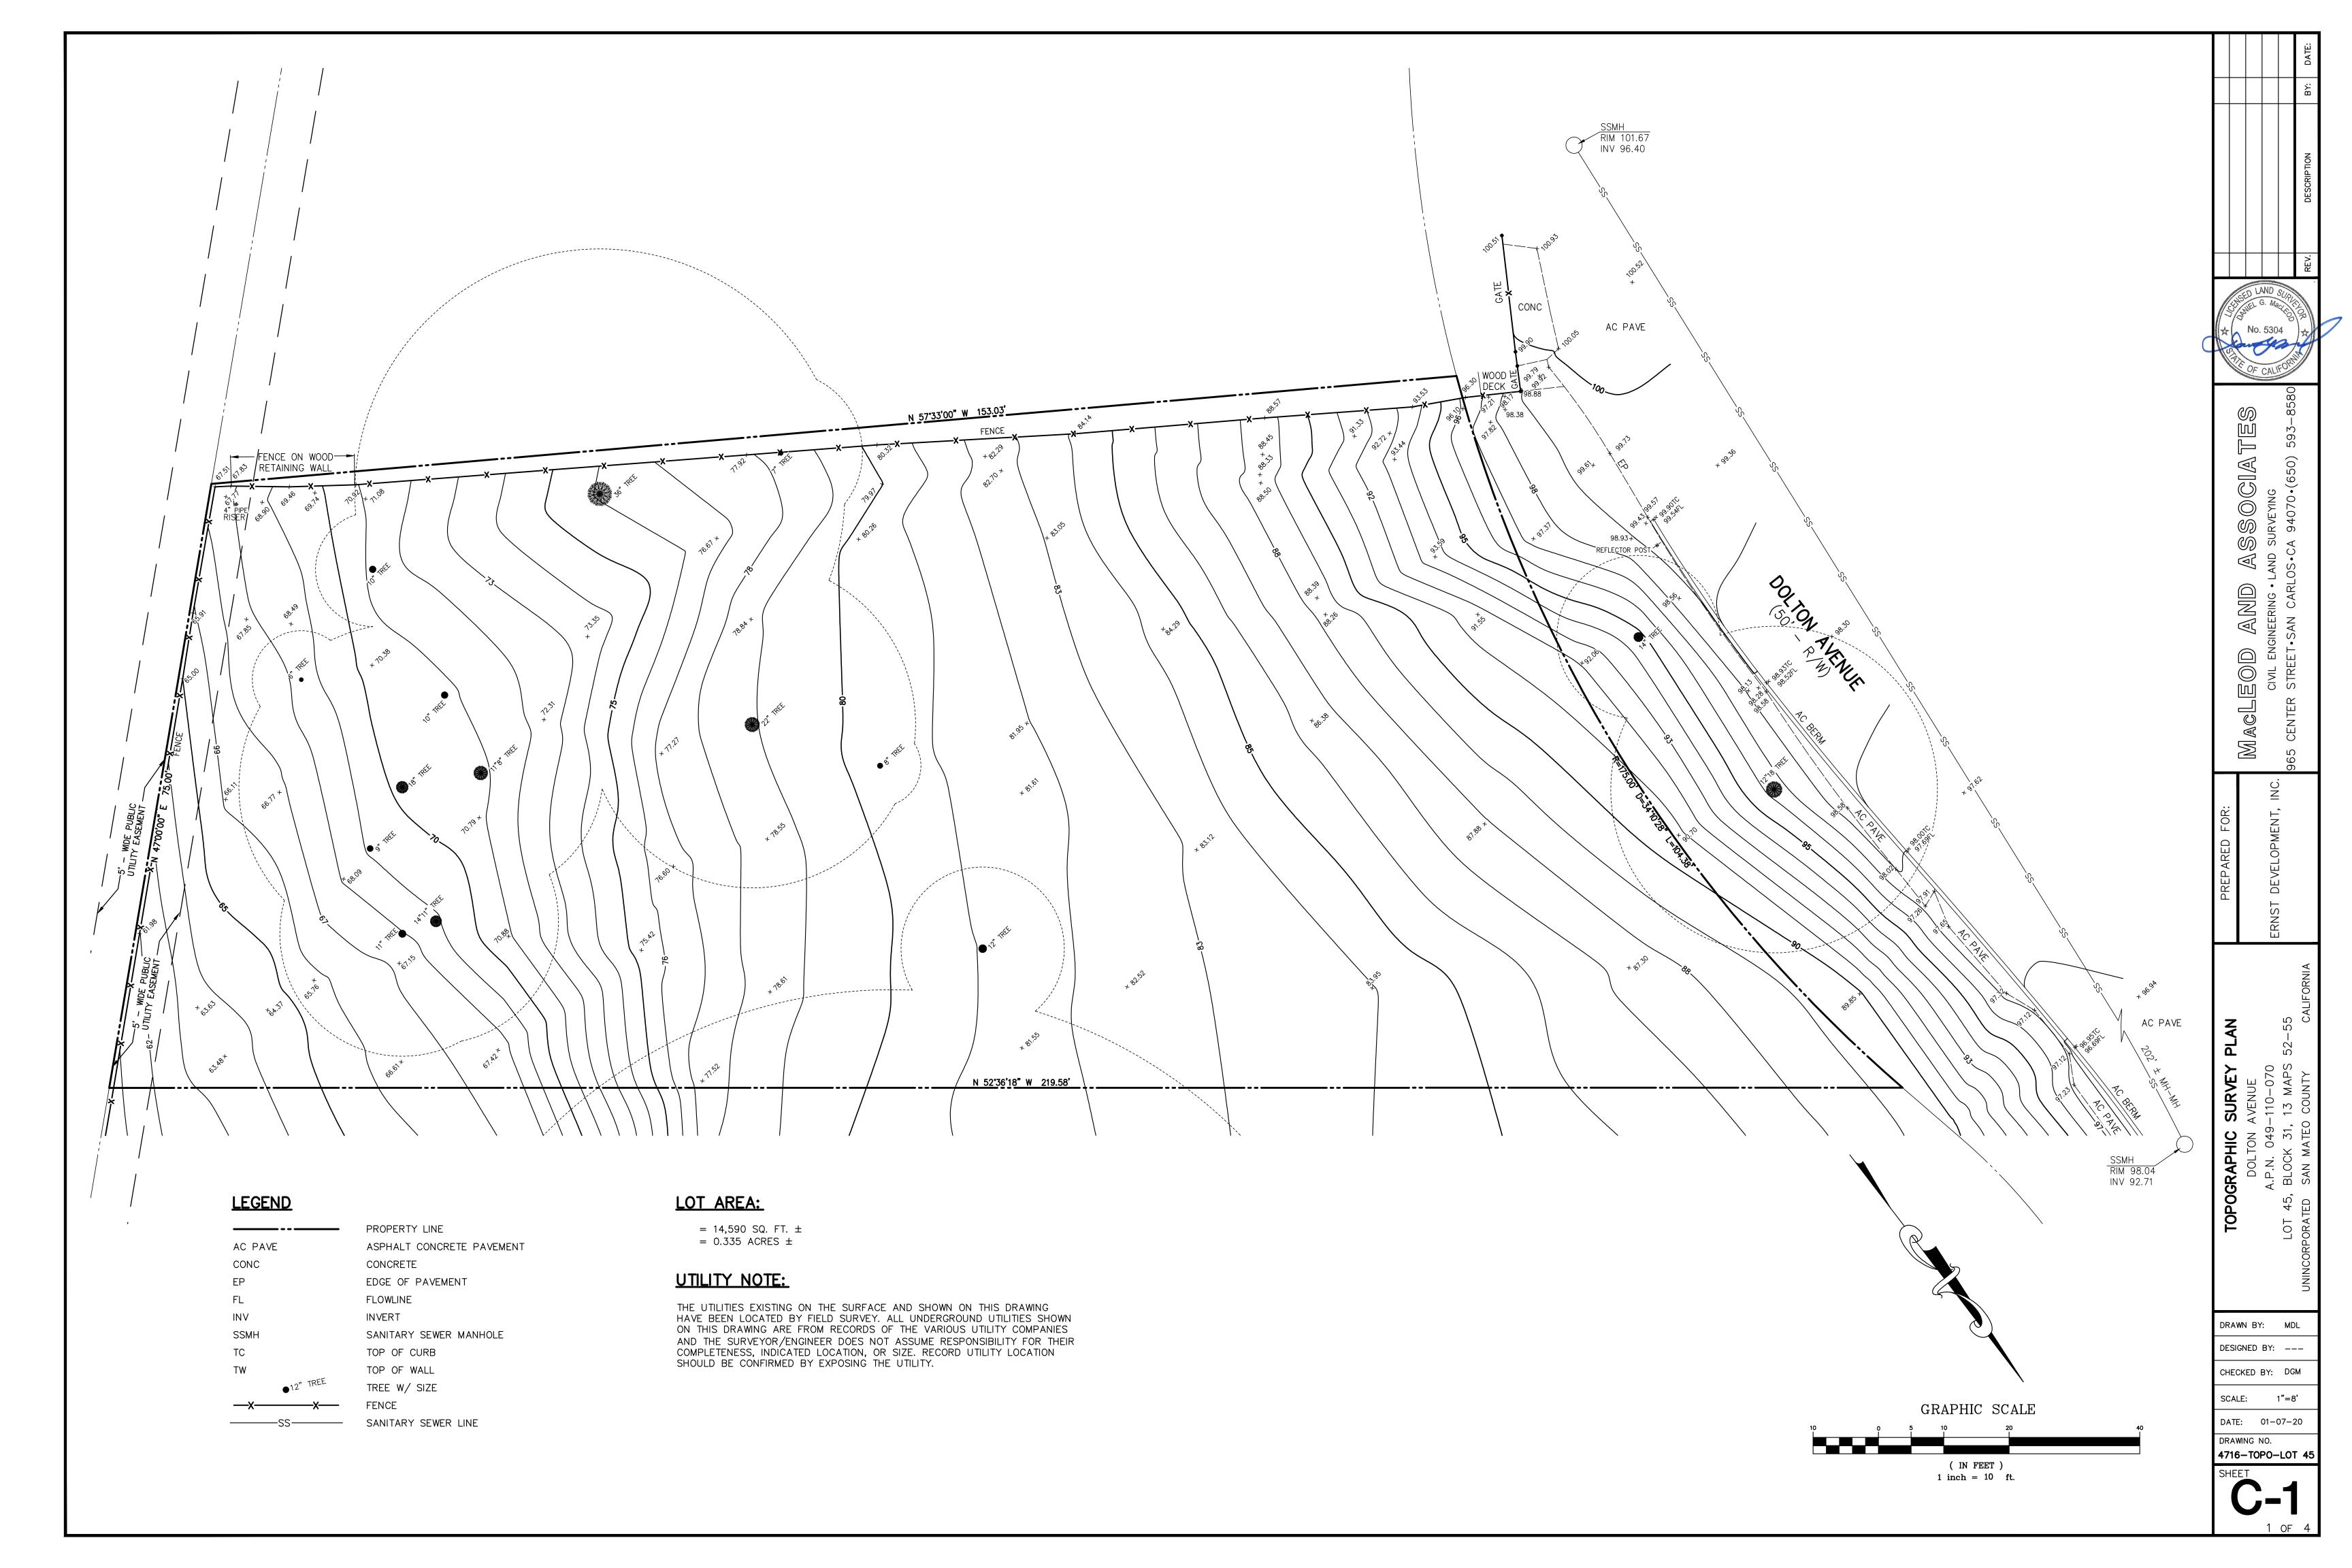

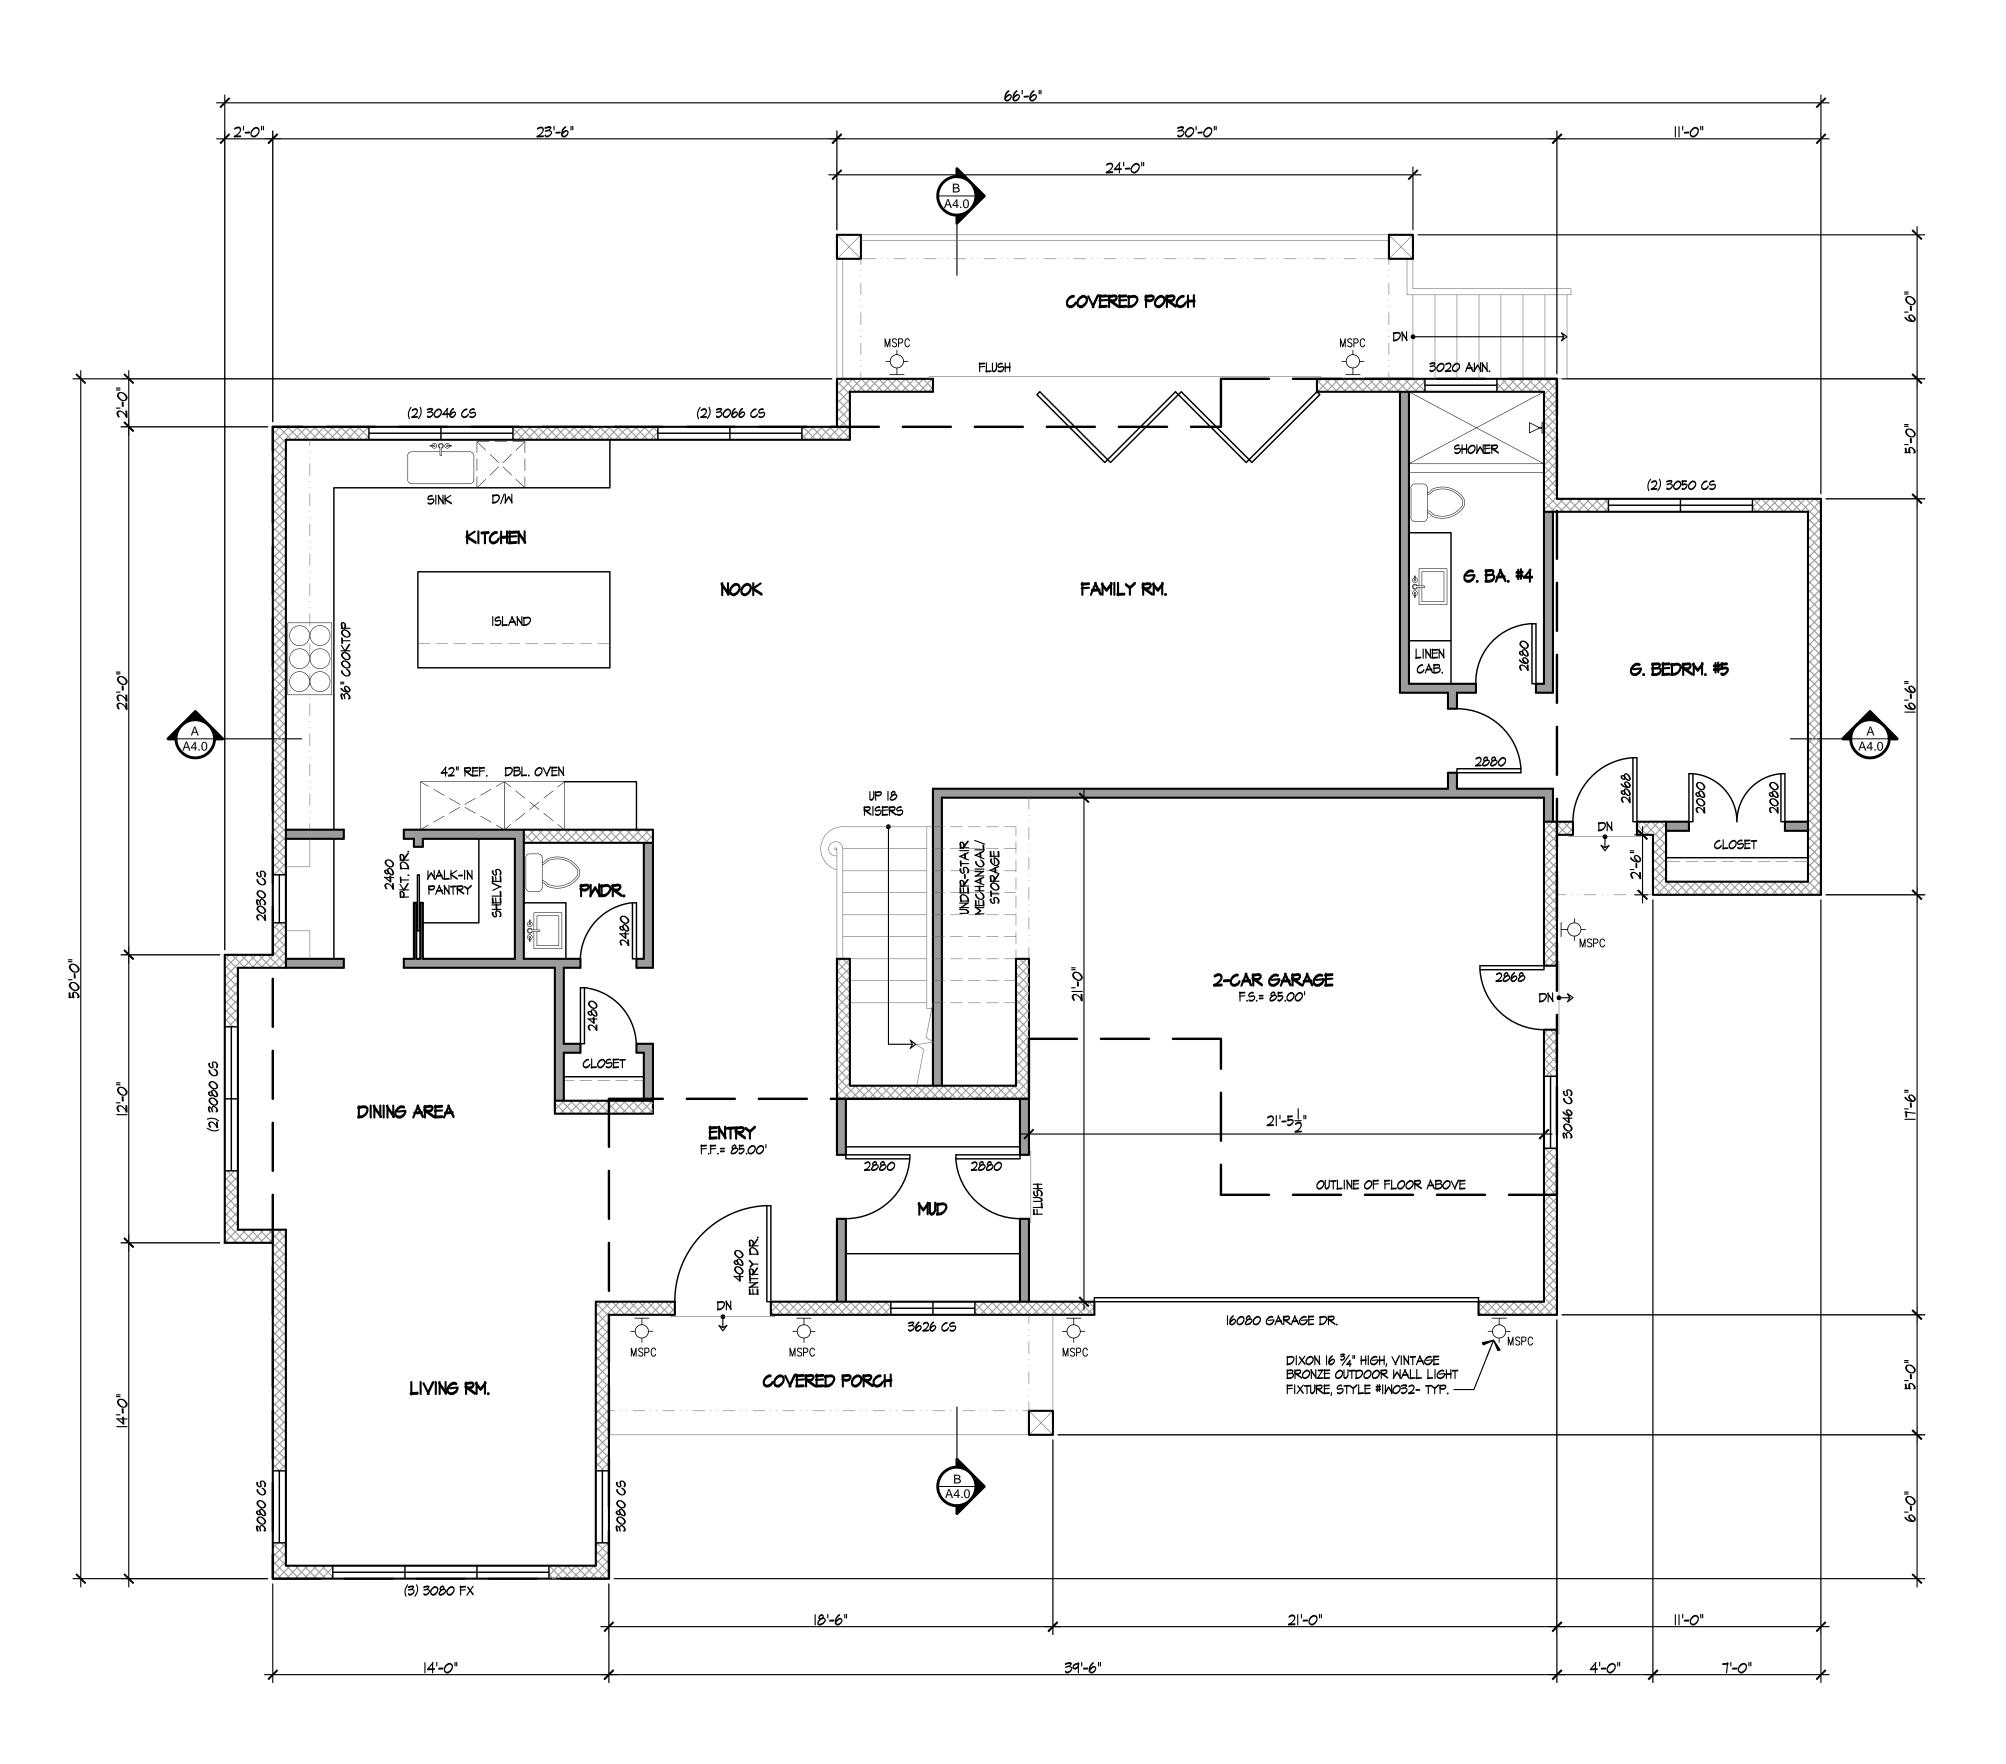

# PROPOSED LOWER LEVEL FLOOR PLAN

SCALE: 1/4 " = 1'-0"

LIVING = 1,872 SF

= 517 SF (400 credit) GARAGE

COVERED PORCH = 93 SF COVERED STOOP = 10 SF

COVERED REAR PORCH/ STAIRS = 168 SF

REVISIONS

HYLAND DESIGN GROUP Office:650.331.1870 fax:650.637.9270

585 Quarry Road San Carlos Ca 94070 www.**hyland**dg.com

OPMENT NEW RESIDENCE FOR

ERNST Sheet Title

PROPOSED LOWER LEVEL

FLOOR PLAN

8.28.2020 |/4"=|'<del>-</del>0"

Sheet No.


FLOOR PLAN LEGEND

NEW 2 x 6 STUDS

L.E.D. MOTION SENSOR & PHOTO CONTROL LIGHT

NEW 2 x STUDS @ 16" O.C STUD WALLS

UNLESS OTHERWISE NOTED

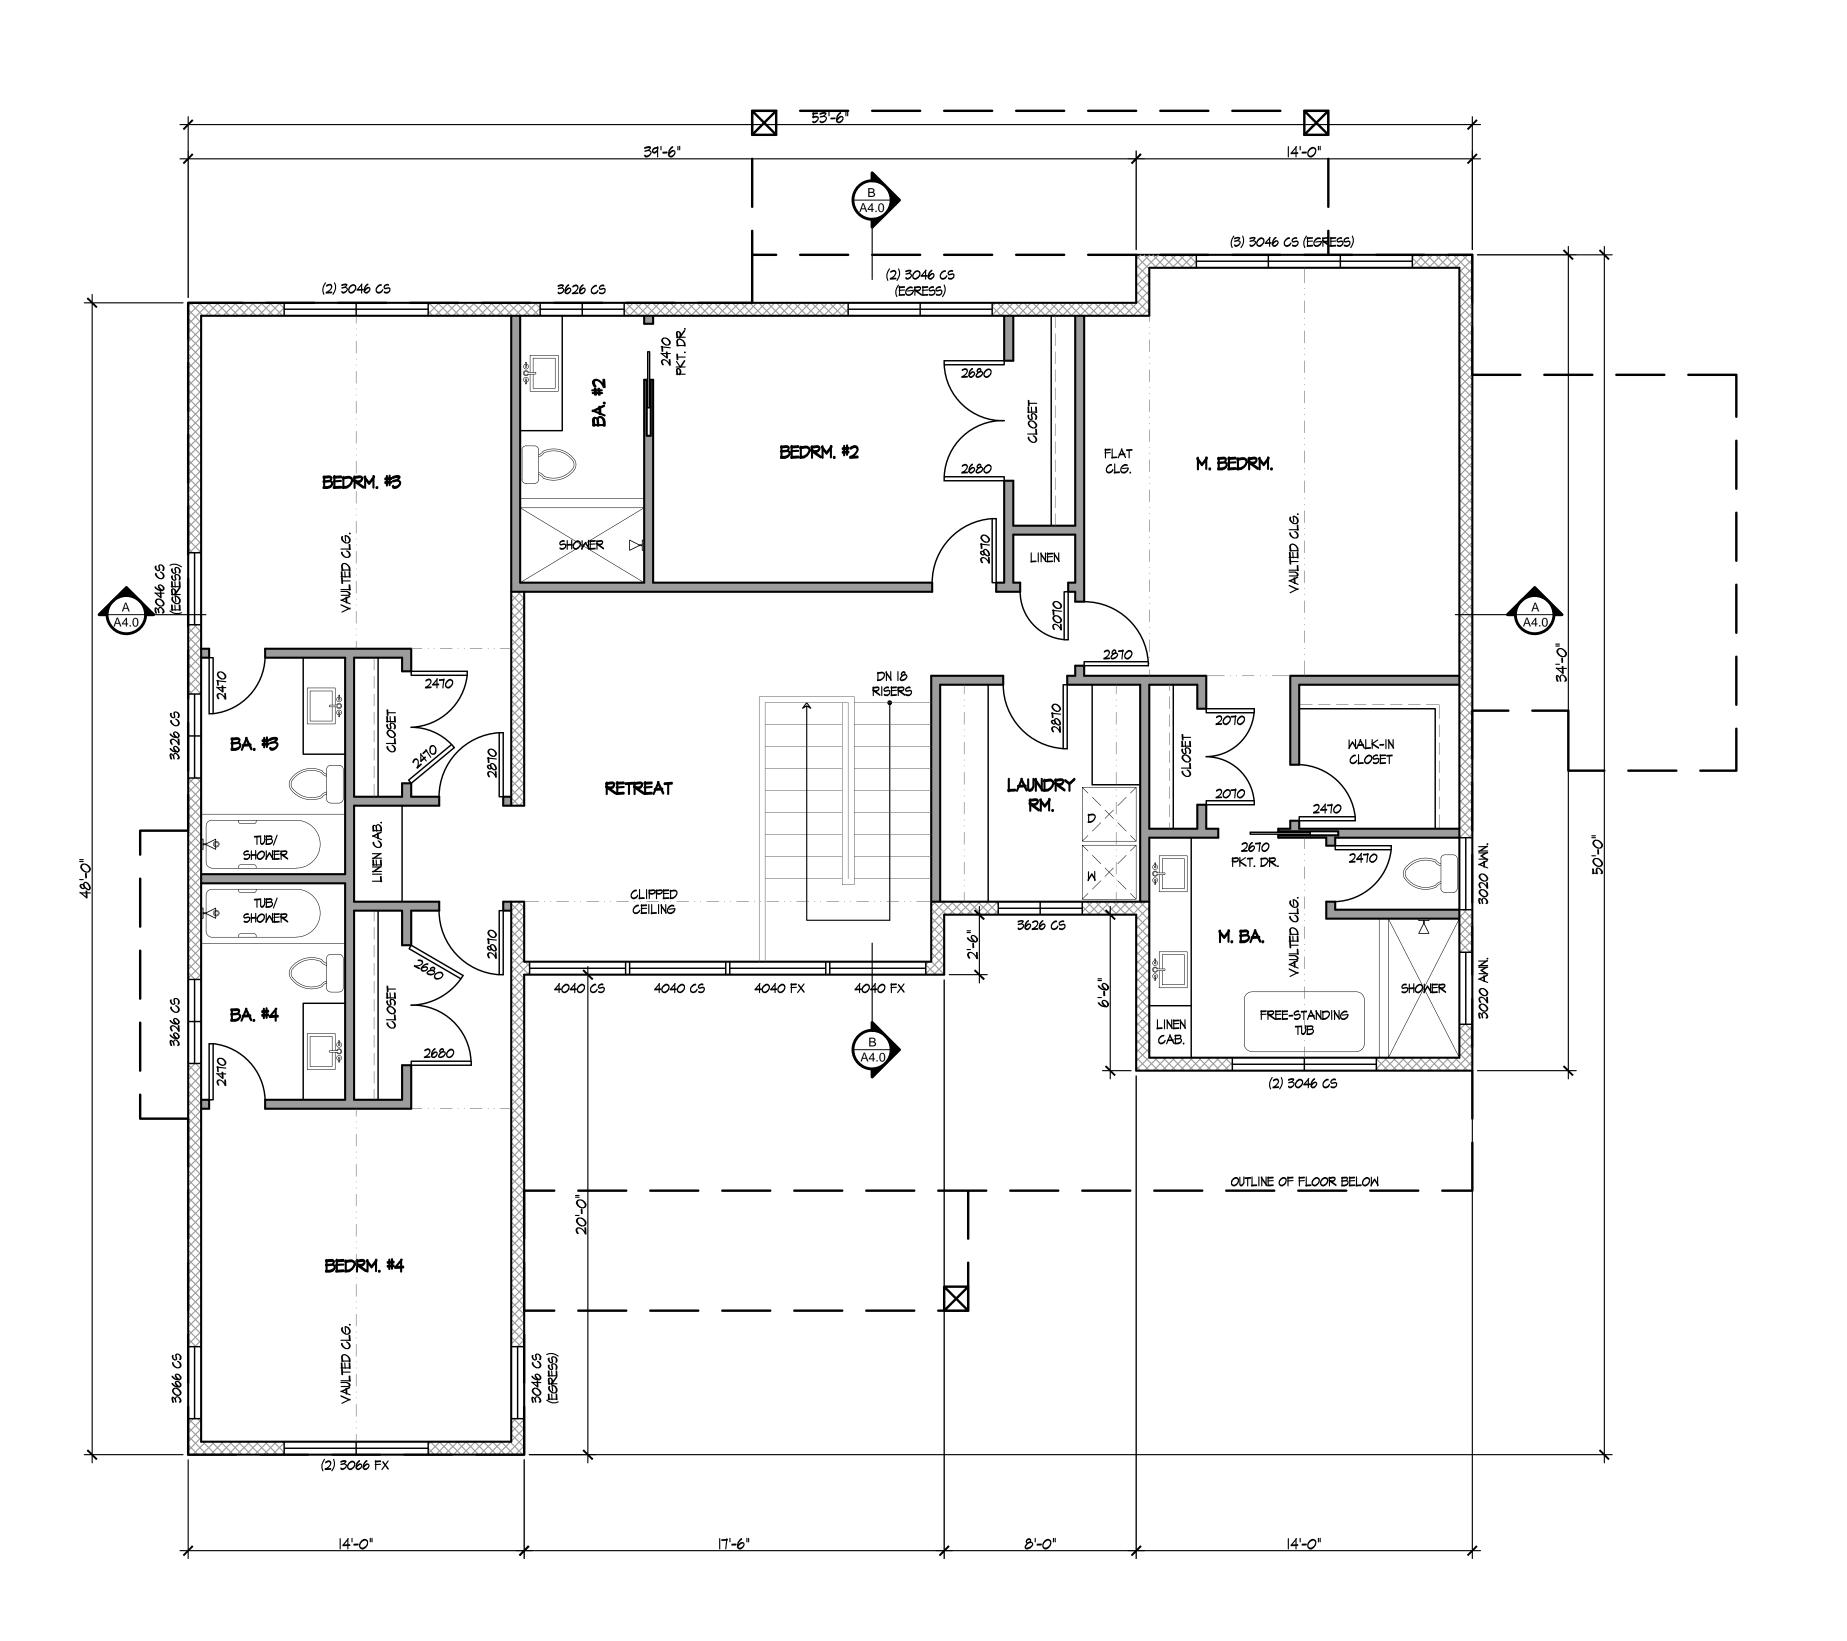

# PROPOSED UPPER LEVEL FLOOR PLAN

SCALE: 1/4 " = 1'-0"

LIVING (Excluding Stairs 1,842-75) = 1,767 SF

REVISIONS BY

HYLAND DESIGN GROUP

Office:650.331.1870 fax:650.637.9270
585 Quarry Road San Carlos Ca 94070
www.hylanddg.com

LOPMENT

NEW RESIDENCE FOR ERNST DEVELOP

Sheet Title

PROPOSED UPPER LEVEL FLOOR PLAN

Scale: 8.28.2020

Drawn: RC

Job No.: 1940
Sheet No.

FLOOR PLAN LEGEND


NEW 2 x 6 STUDS


L.E.D. MOTION SENSOR & PHOTO CONTROL LIGHT


NEW 2 x STUDS @ 16" O.C STUD WALLS UNLESS OTHERWISE NOTED

 $\Delta$ 

A2.Of Sheets

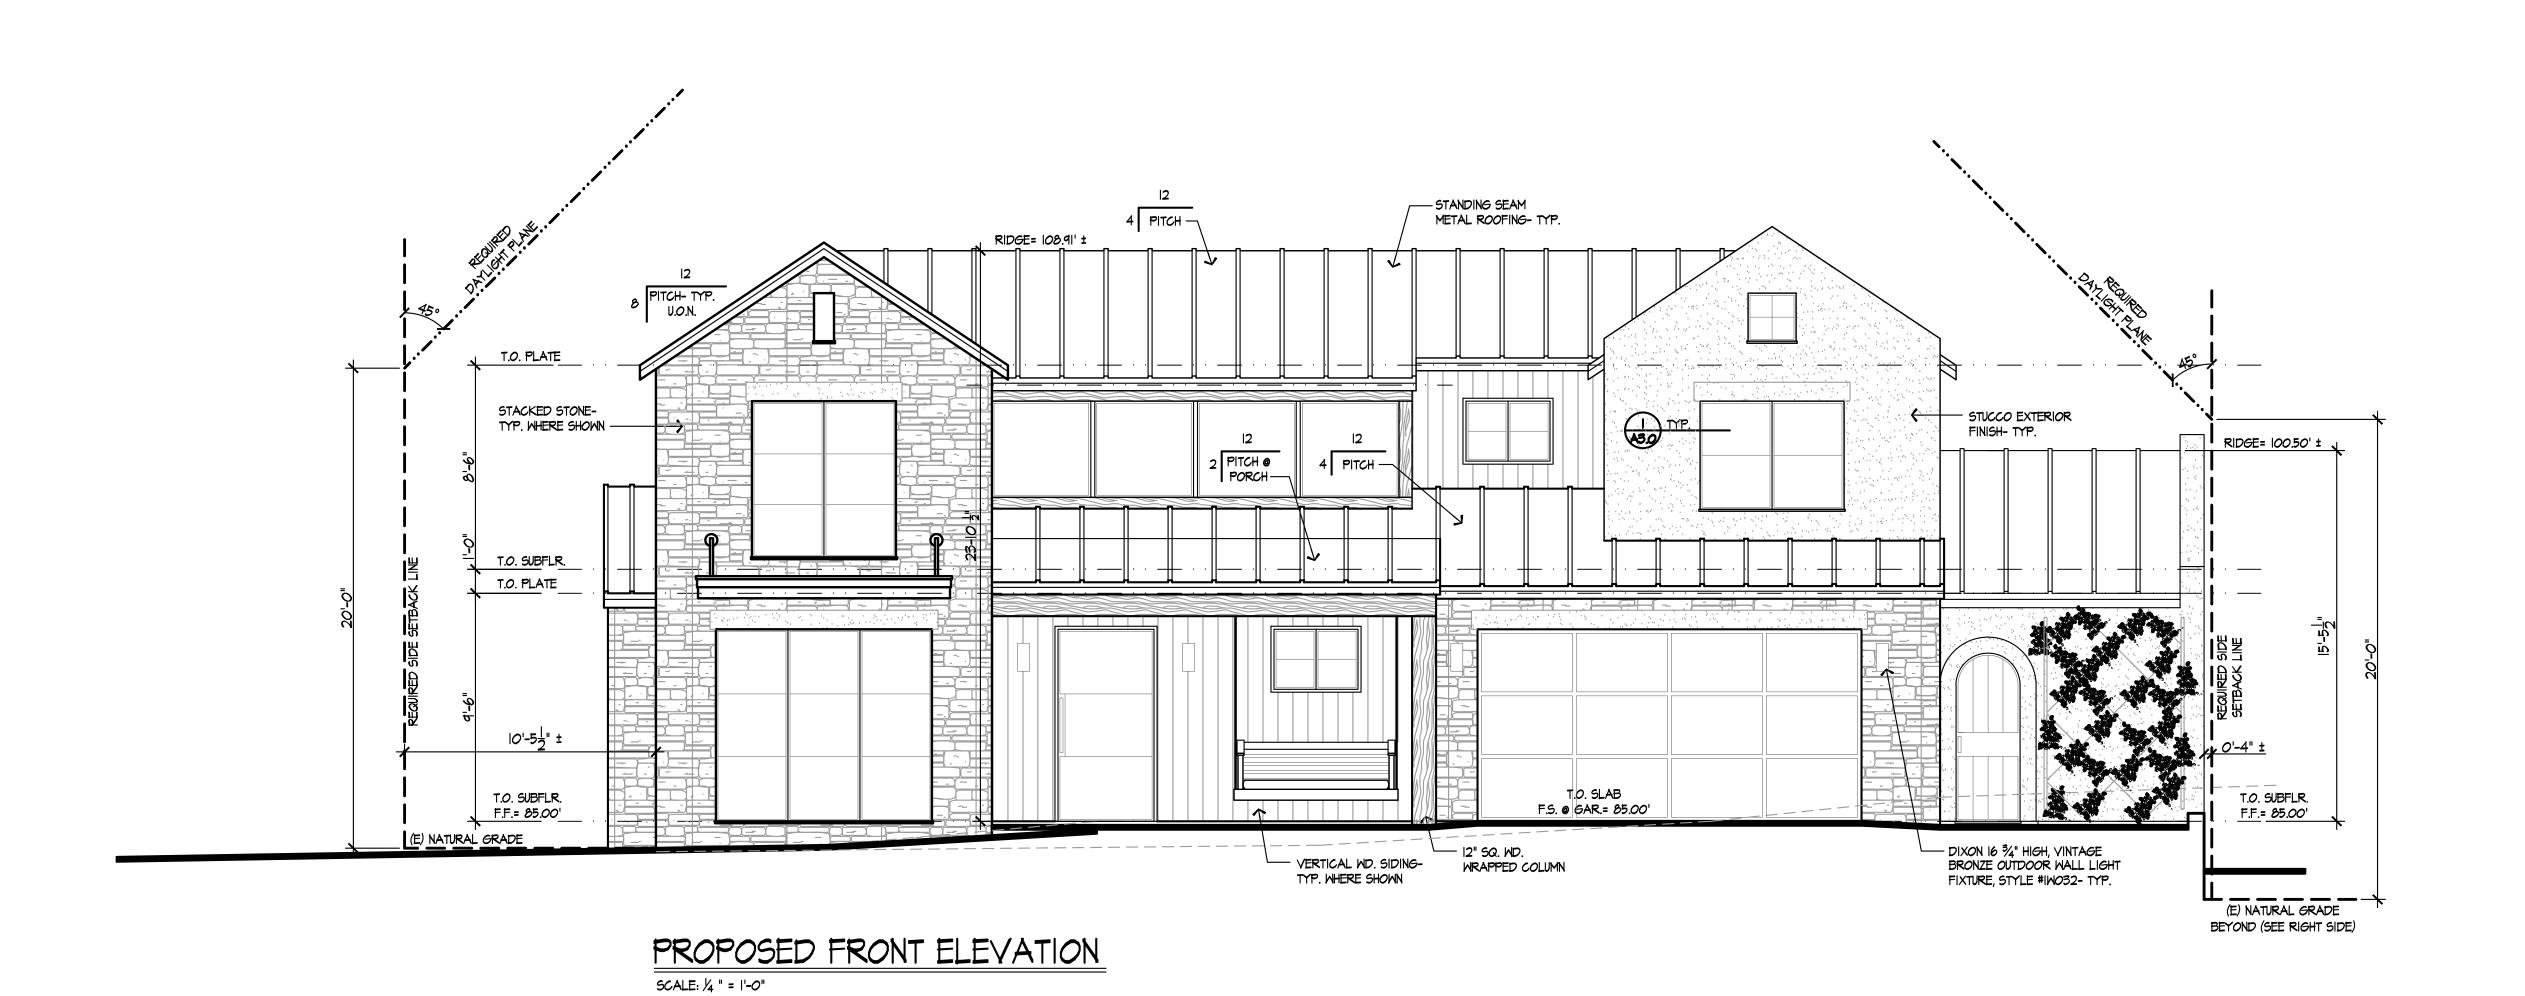

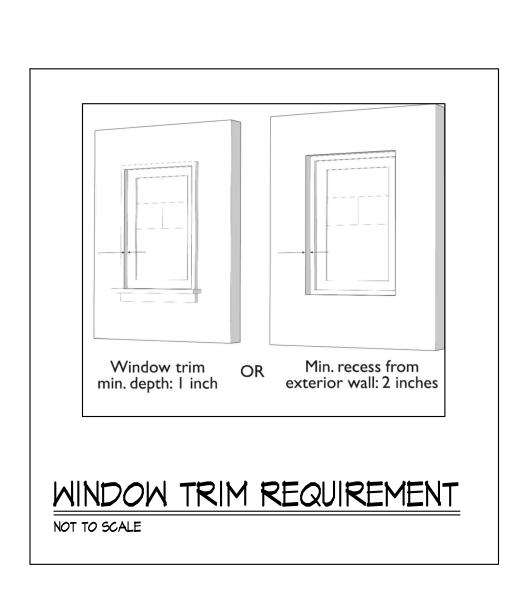

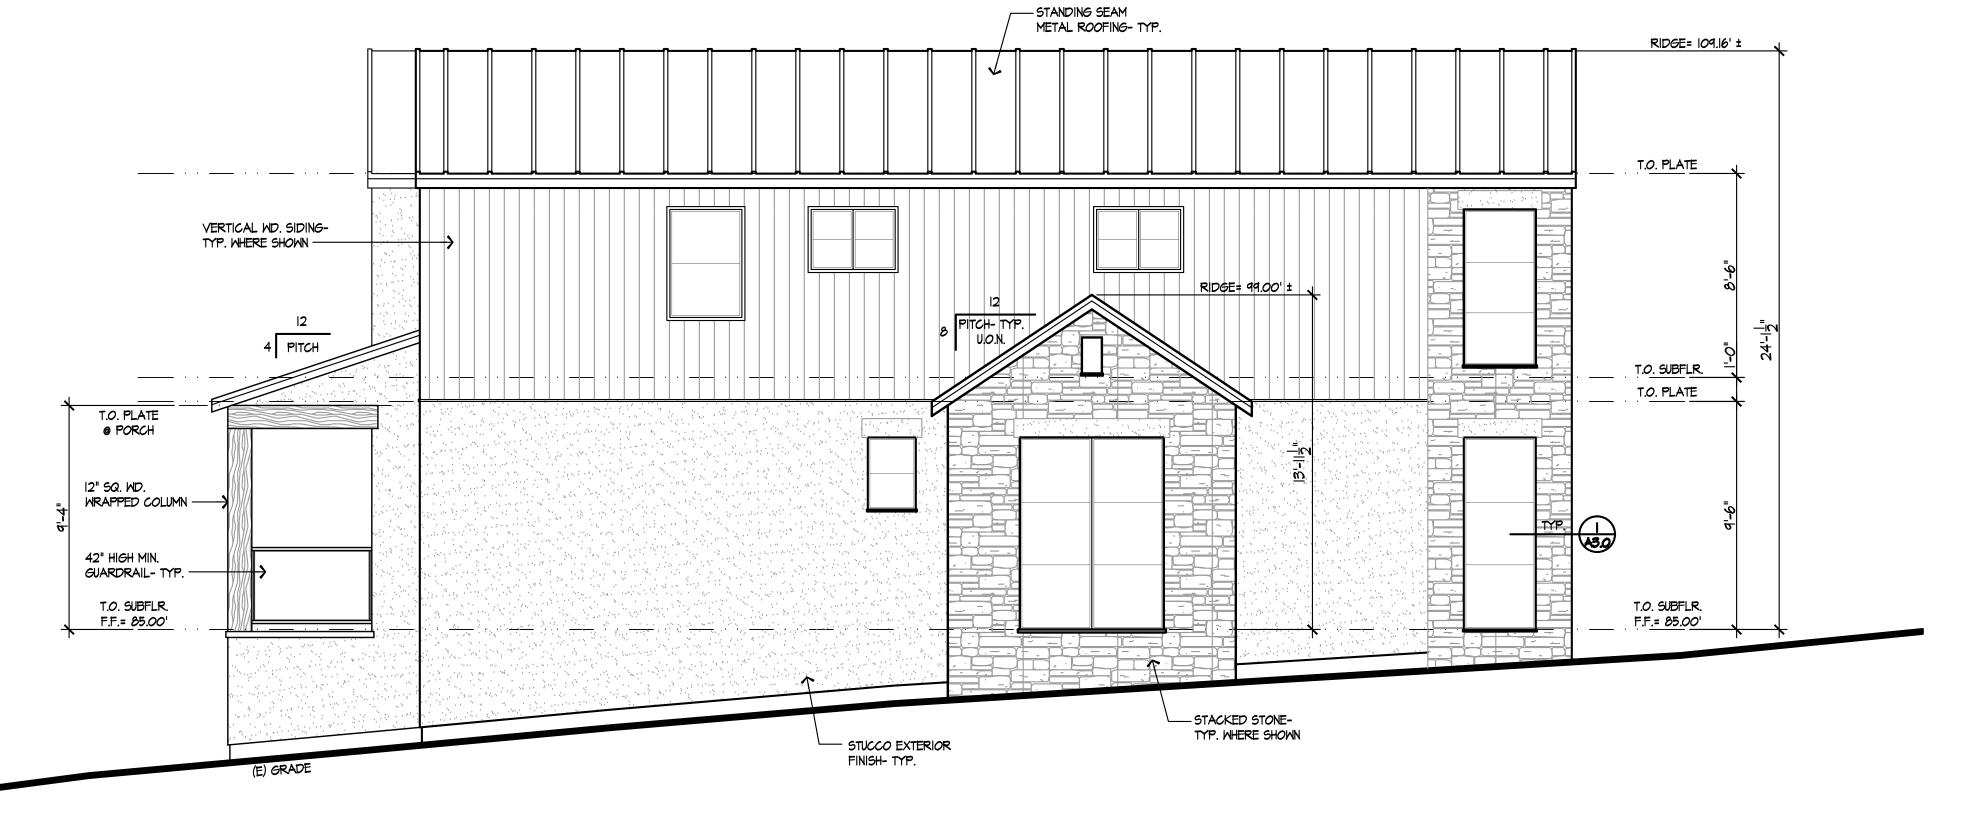

PROPOSED LEFT SIDE ELEVATION

SCALE: 1/4 " = 1'-0"

|| A3.0

REVISIONS BY

HYLAND
DESIGN GROUP
Office:650.331.1870 fax:650.637.9270
585 Quarry Road San Carlos Ca 94070

www.**hyland**dg.com

EVELOPMENT

NEW RESIDENCE FOR ERNST DEVELOP


PROPOSED EXTERIOR ELEVATIONS

Date: 8.28.2020 Scale: 1/4"=1'-0"

Drawn: RC


Job No.: 1940

A3.0

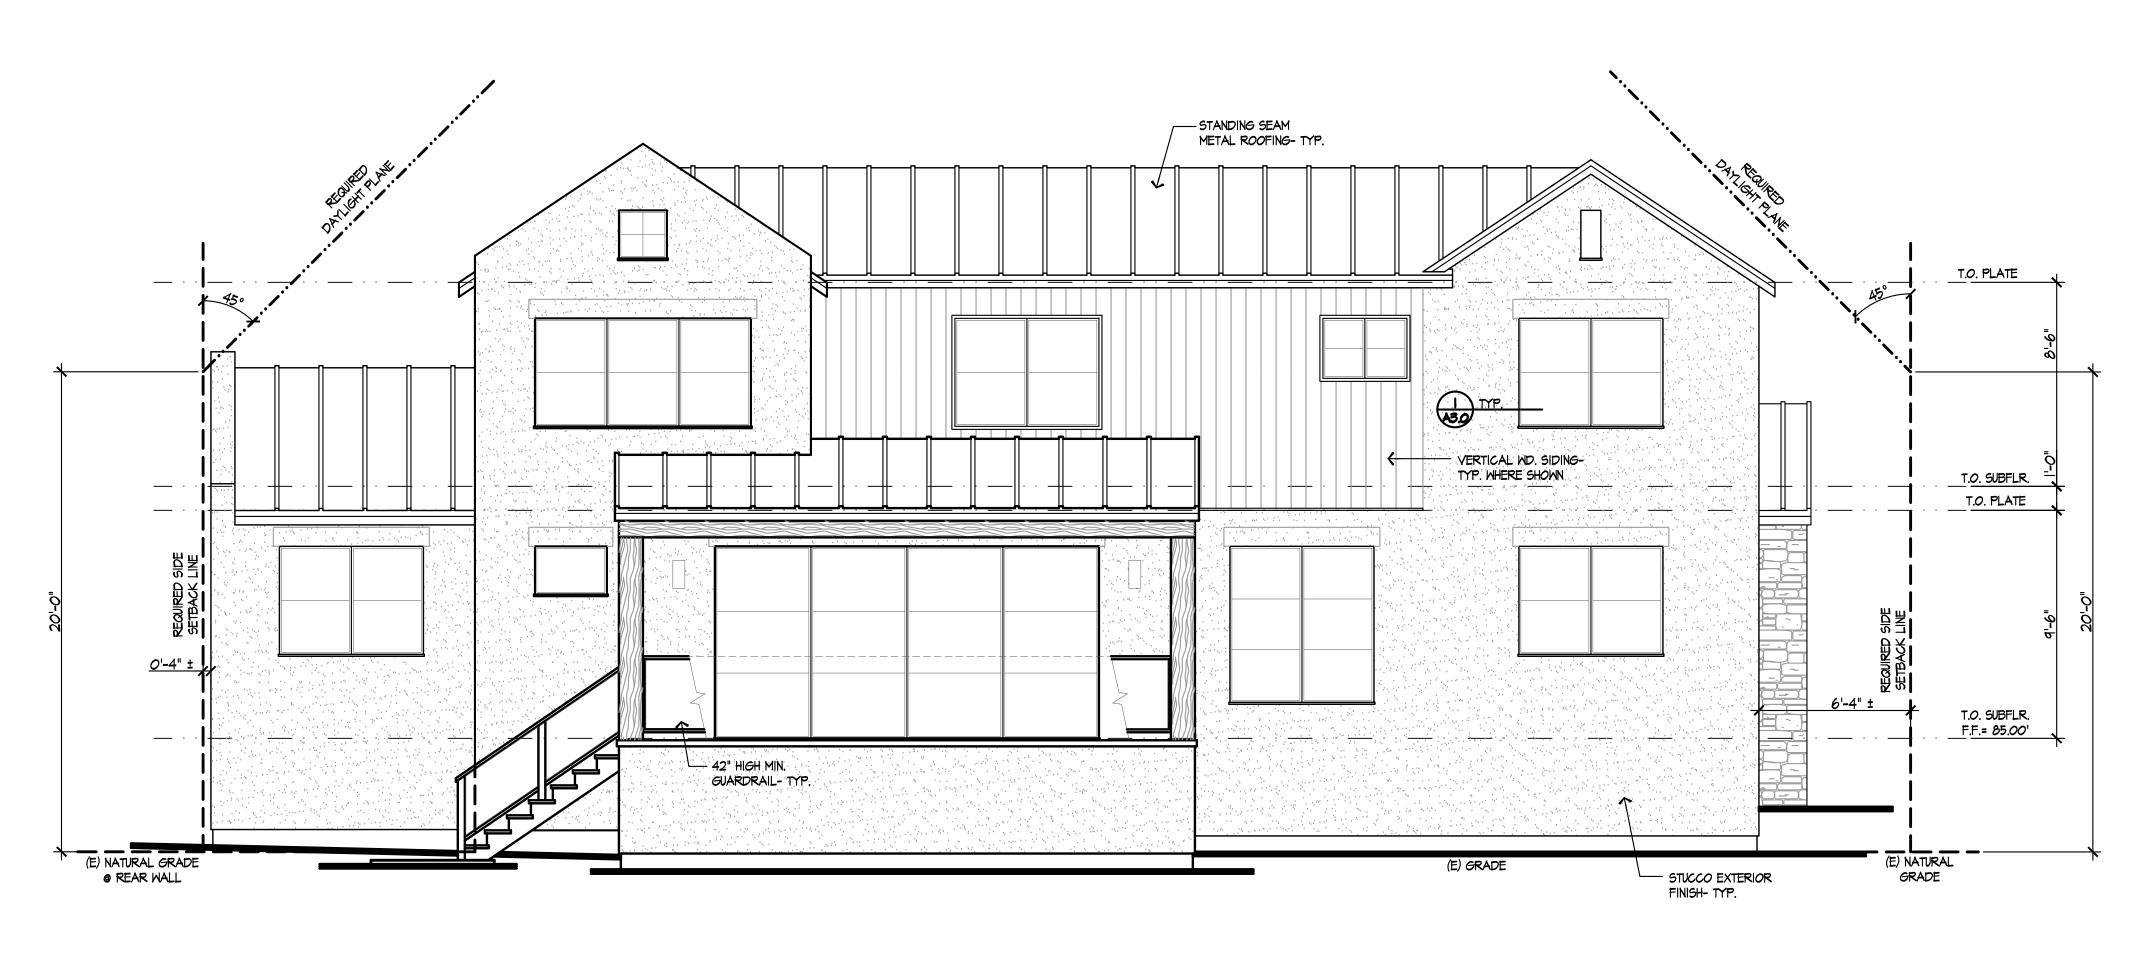

# PROPOSED REAR ELEVATION

SCALE: 1/4 " = 1'-0"

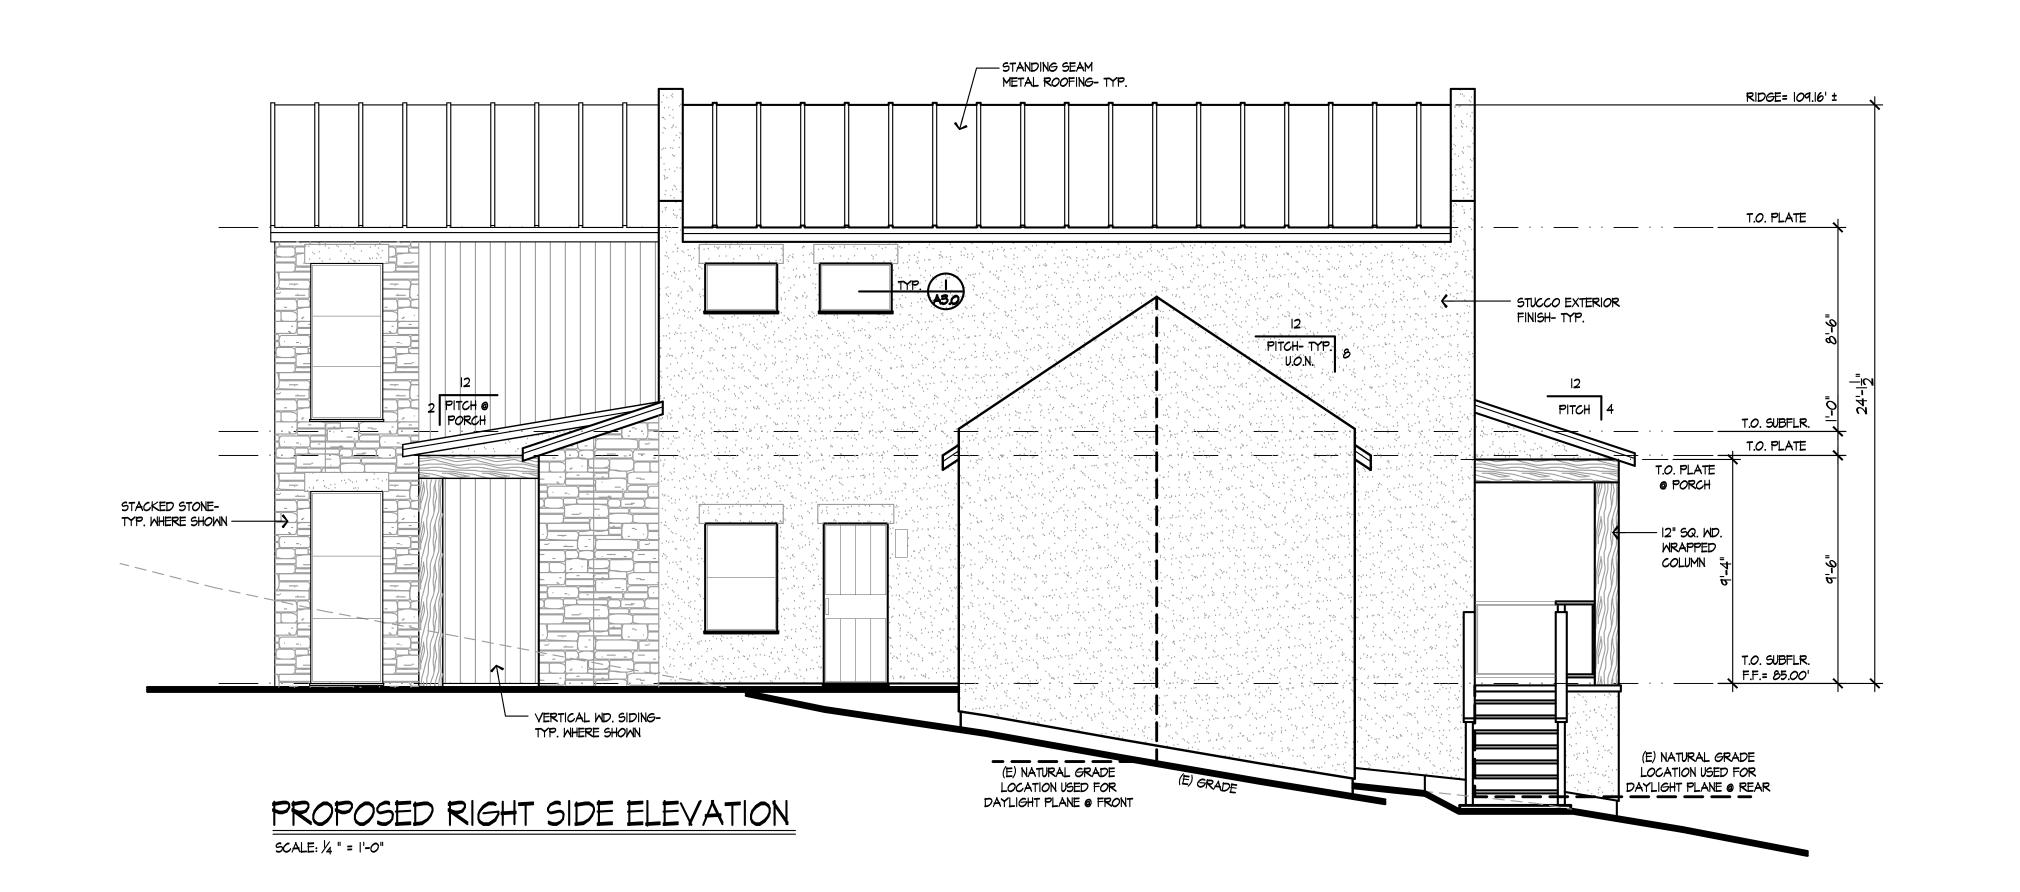

REVISIONS BY

HYLAND
DESIGN GROUP
Office:650.331.1870 fax:650.637.9270
585 Quarry Road San Carlos Ca 94070

www.hylanddg.com

ELOPMENT

NEW RESIDENCE FOR ERNST DEVELOP

PROPOSED EXTERIOR ELEVATIONS


 Date:
 8.28.2020

 Scale:
 1/4"=1'-0"

Designed: HDG
Drawn: RC


Job No.: 194

A3.1
Of Sheets

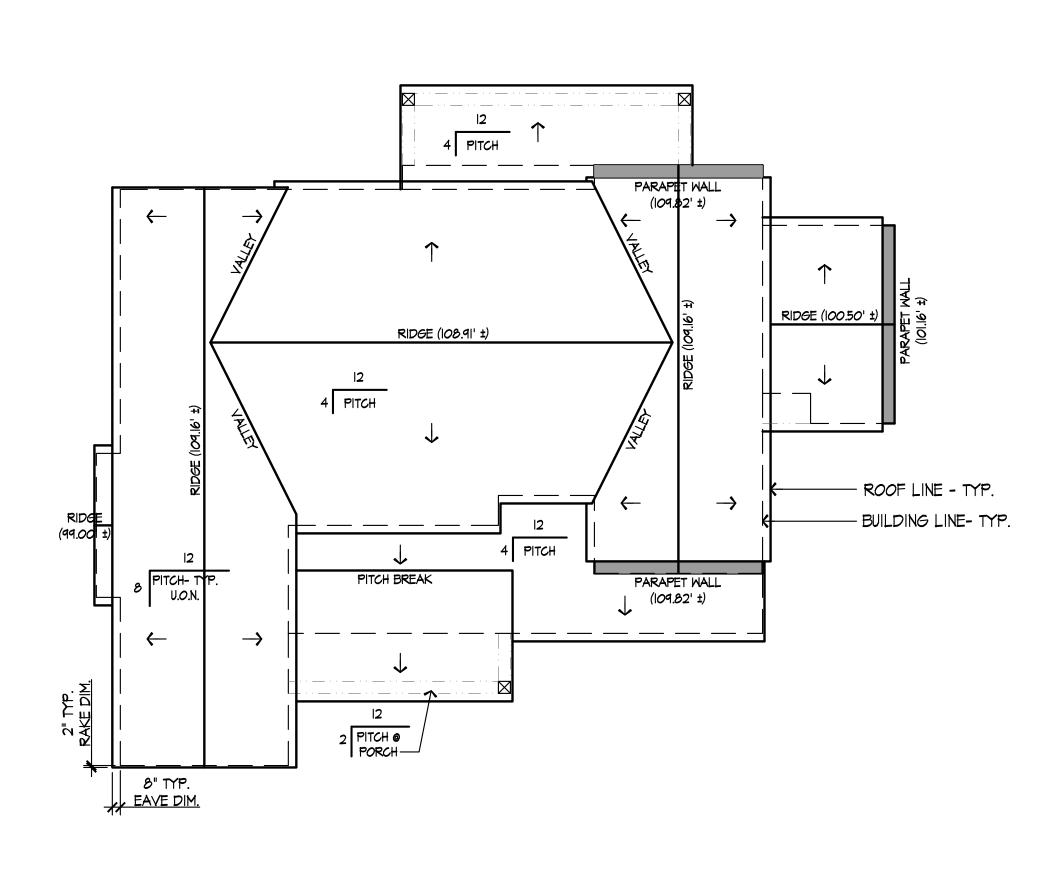


ROOF PLAN

SCALE: 1/-0"

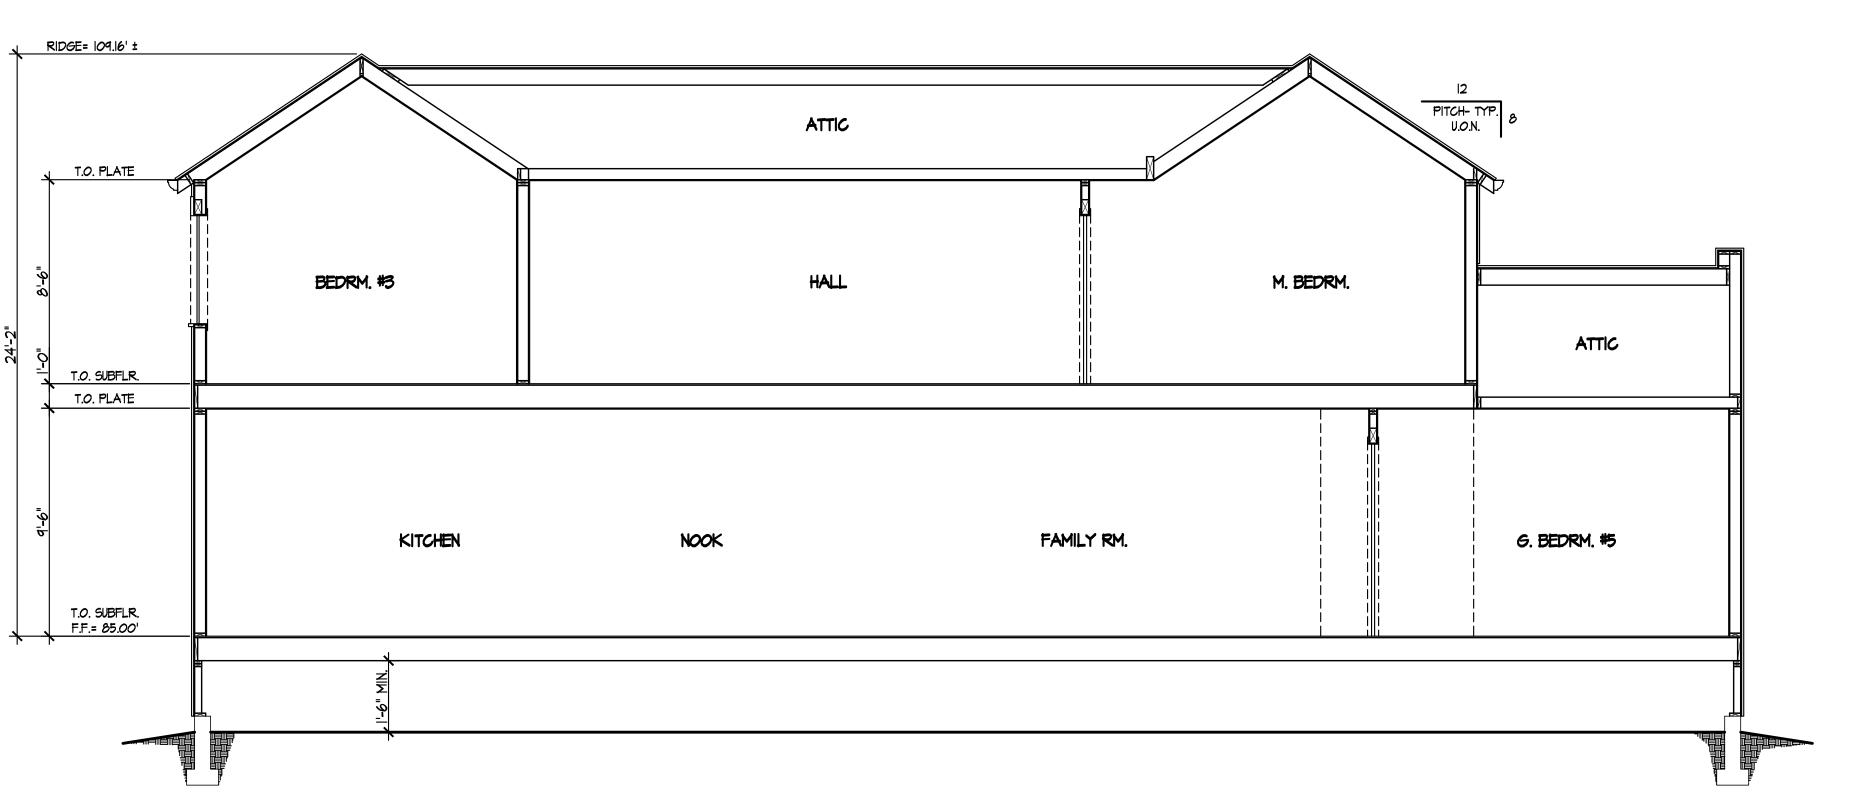

SECTION "A-A" SCALE: 1/4" = 1'-0"

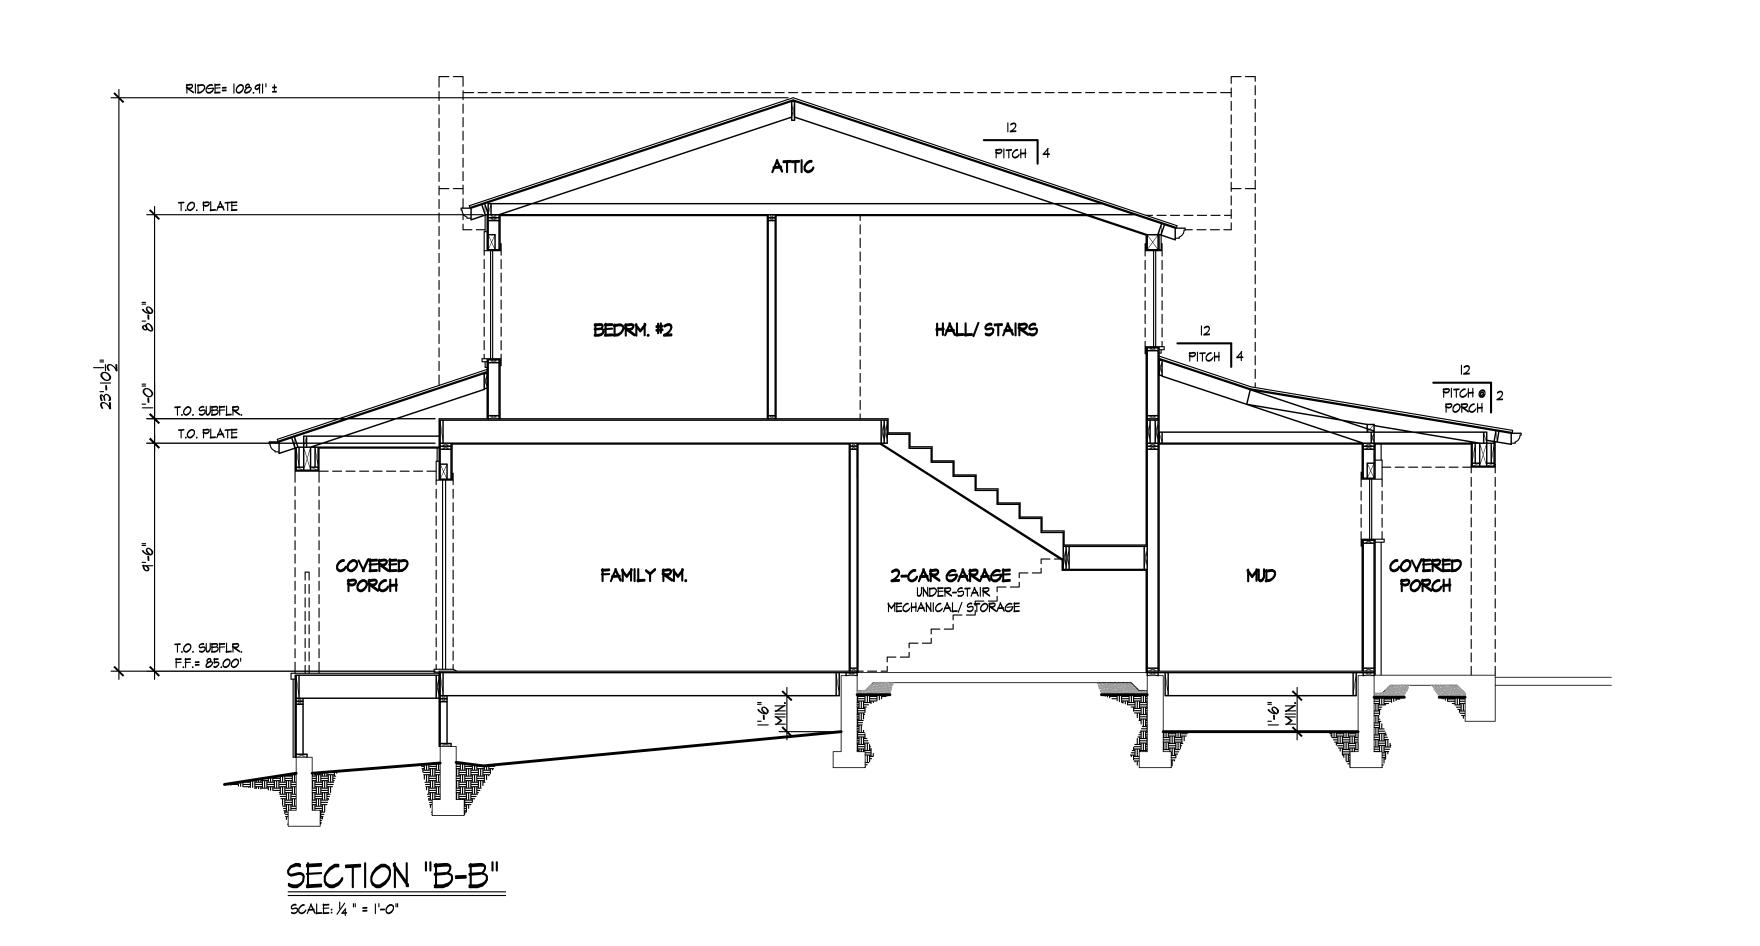

REVISIONS BY

HYLAND
DESIGN GROUP
Office:650.331.1870 fax:650.637.9270

Office:650.331.1870 fax:650.637.9270 585 Quarry Road San Carlos Ca 94070 www.hylanddg.com

NEW RESIDENCE FOR ERNST DEVELOPMENT

Sheet Title

ROOF PLAN SECTIONS:

Scale: 8.28.2020
Scale: AS NOTED


Designed: HDG

Drawn: RC

Sheet No.

44.0

Of Sheets

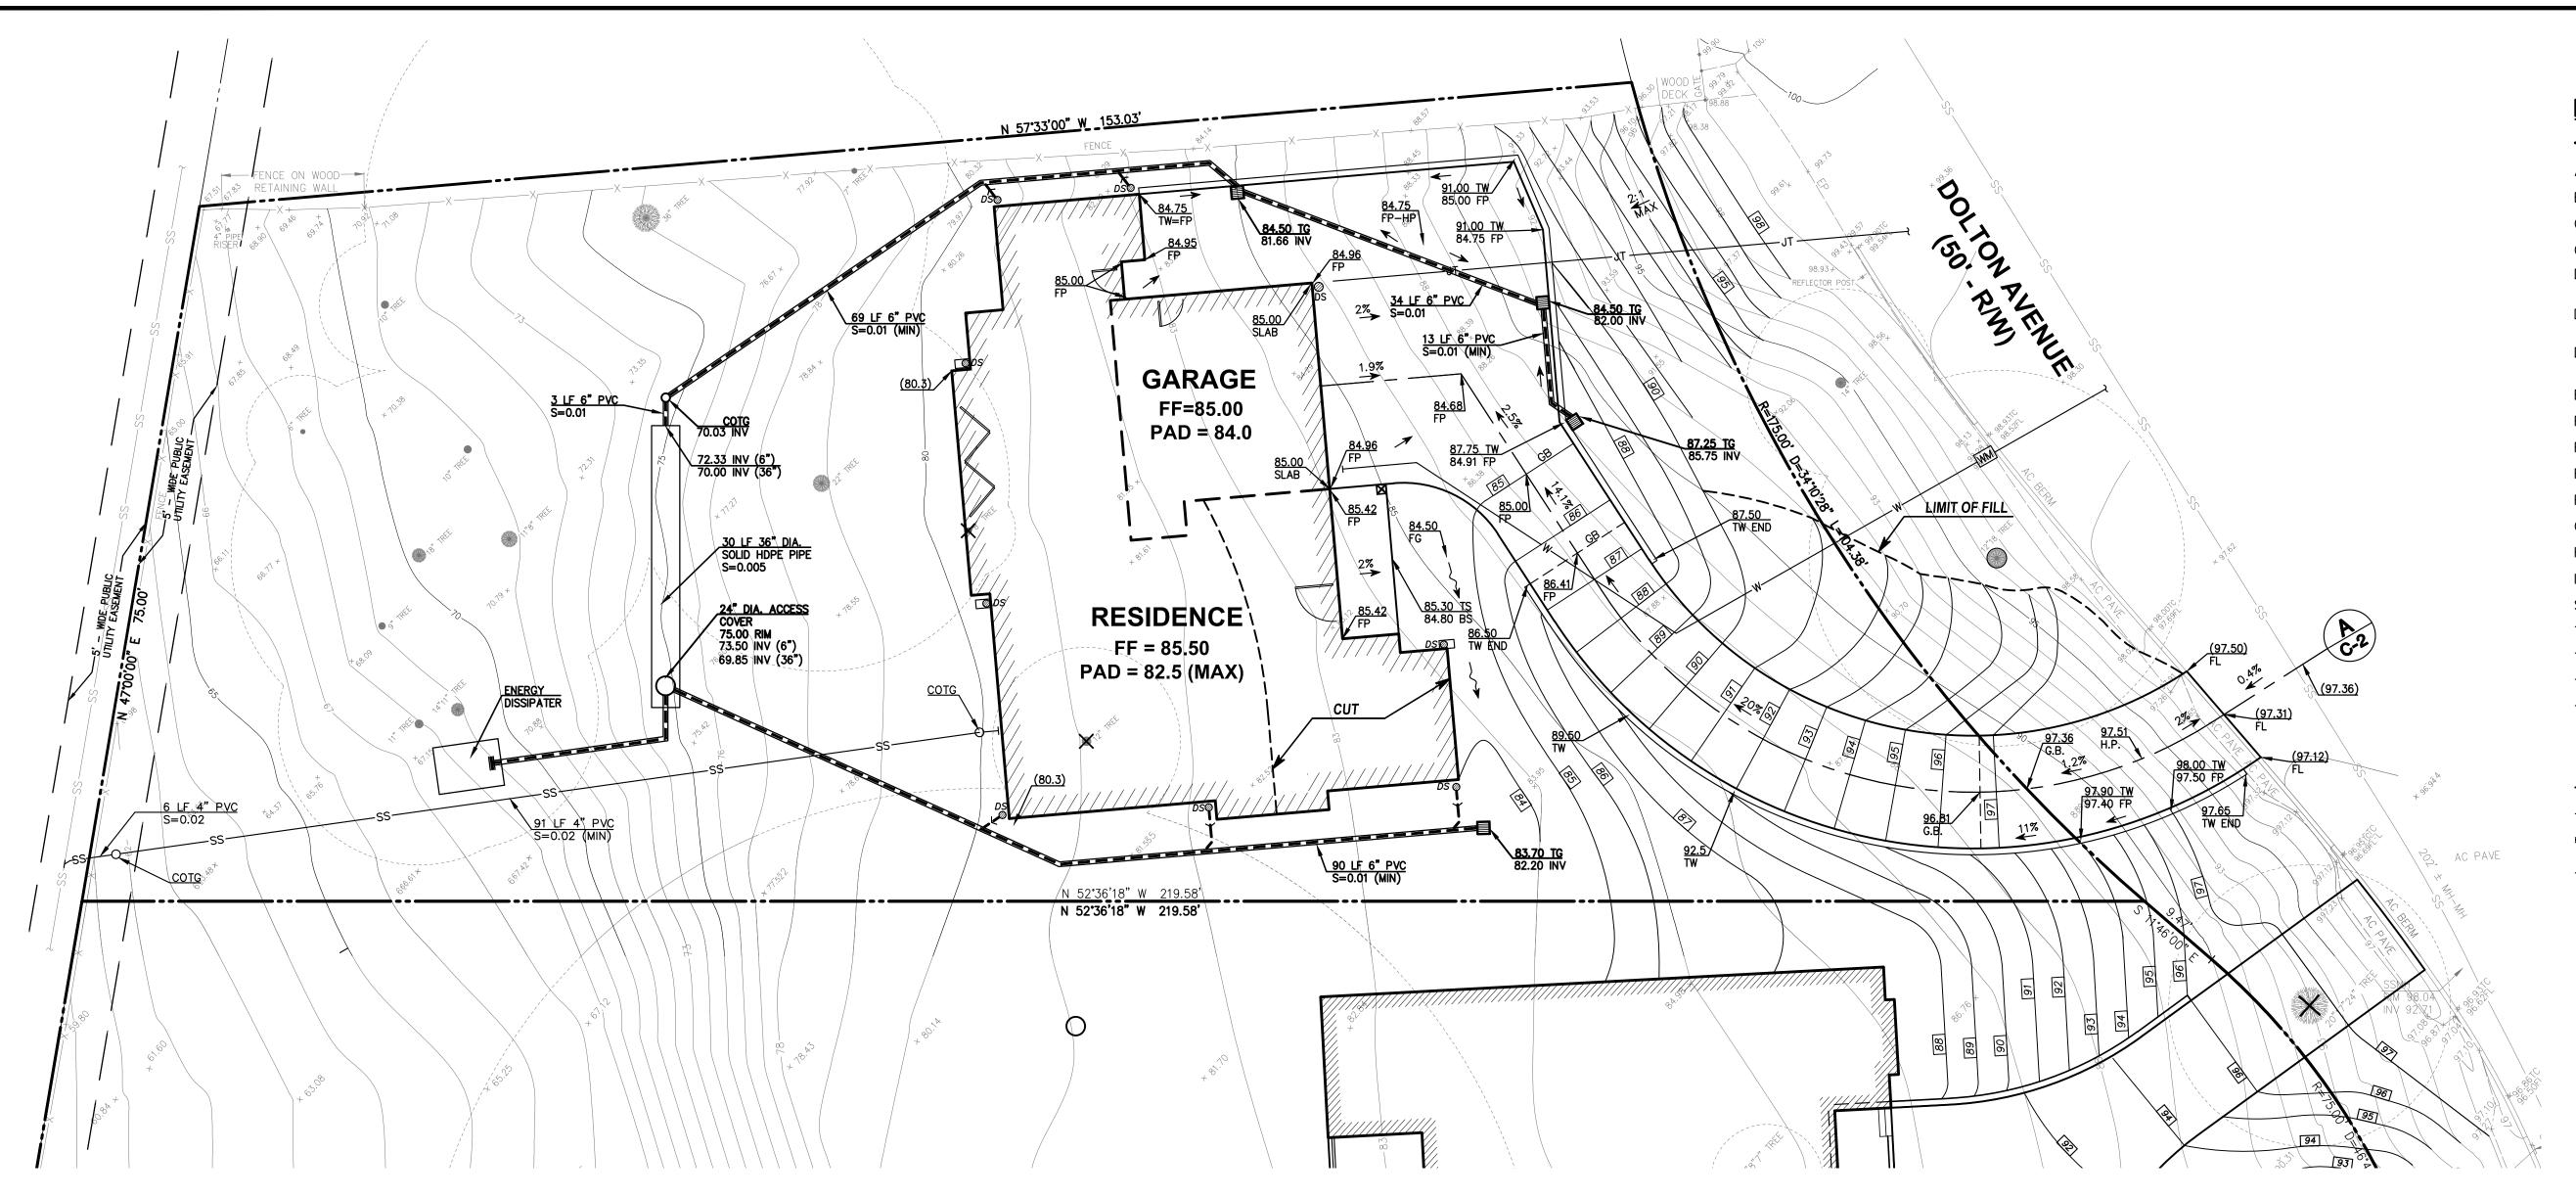

#### **LEGEND:**

PROPERTY LINE AC PAVE ASPHALT CONCRETE PAVEMENT BS BOTTOM OF STEP CONCRETE CONC CLEANOUT TO GRADE COTG DOWNSPOUT TO DISPERSE DS ∅ ON IMPERVIOUS SURFACE CONNECT DOWNSPOUT DS **∅**→ → → → → − − WITH 4" PVC AT 2% MIN. DOWNSPOUT WITH PRECAST DS 🙋 CONCRETE SPLASH BLOCK EΡ EDGE OF PAVEMENT FINISH FLOOR FIELD GRADE FLOWLINE FINISH PAVE GRADE BREAK HIGH POINT INV INVERT SANITARY SEWER MANHOLE TOP OF CURB TOP OF GRATE TOP OF STEP TOP OF WALL TREE W/ SIZE EXIST. TREE TO BE REMOVED **FENCE** SANITARY SEWER LINE \_\_\_\_\_ NEW STORM DRAIN LINE NEW CONTOUR ~**~** SWALE SURFACE RUNOFF DIRECTION NEW DRAIN INLET

#### **GENERAL NOTES:**

- ALL MATERIALS SHALL BE FURNISHED BY AND INSTALLED BY THE CONTRACTOR UNLESS OTHERWISE NOTED.
- WHEN APPLICABLE, ALL CONSTRUCTION MATERIALS AND METHODS SHALL COMPLY WITH THE ORDINANCES, SPECIFICATIONS AND STANDARDS OF THE COUNTY OF SAN MATEO, UNLESS OTHERWISE NOTED.
- 3. CONTRACTOR SHALL NOTIFY UNDERGROUND SERVICE ALERT (U.S.A.) PRIOR TO START OF CONSTRUCTION. PHONE (800) 642-2444.
- 4. THE CONTRACTOR SHALL BE RESPONSIBLE FOR DISTRIBUTING ANY EXCESS
- MATERIAL OR SUPPLYING MATERIAL FOR DEFICIENCIES TO BRING DRIVEWAY AND BUILDING PADS TO REQUIRED GRADE.
- 5. THE CONTRACTOR IS RESPONSIBLE FOR MATCHING EXISTING SURROUNDING LANDSCAPE AND OTHER IMPROVEMENTS WITH A SMOOTH TRANSITION IN PAVING, GRADING, ETC., AND TO AVOID ABRUPT OR APPARENT CHANGES OR CROSS SLOPES, LOW SPOTS OR HAZARDOUS CONDITIONS.
- 6. THE CONTRACTOR SHALL OBTAIN ALL NECESSARY PERMITS FOR ALL WORK SHOWN ON THIS PLAN.

#### **UTILITY NOTE:**


THE UTILITIES EXISTING ON THE SURFACE AND SHOWN ON THIS DRAWING HAVE BEEN LOCATED BY FIELD SURVEY. ALL UNDERGROUND UTILITIES SHOWN ON THIS DRAWING ARE FROM RECORDS OF THE VARIOUS UTILITY COMPANIES AND THE SURVEYOR/ENGINEER DOES NOT ASSUME RESPONSIBILITY FOR THEIR COMPLETENESS, INDICATED LOCATION, OR SIZE. RECORD UTILITY LOCATION SHOULD BE CONFIRMED BY EXPOSING THE UTILITY.


### **GRADING QUANTITIES:**

CUT = 210 C.Y. ± FILL = 190 C.Y. ±

#### **LOT AREA:**

A= 14,590 sq. ft.

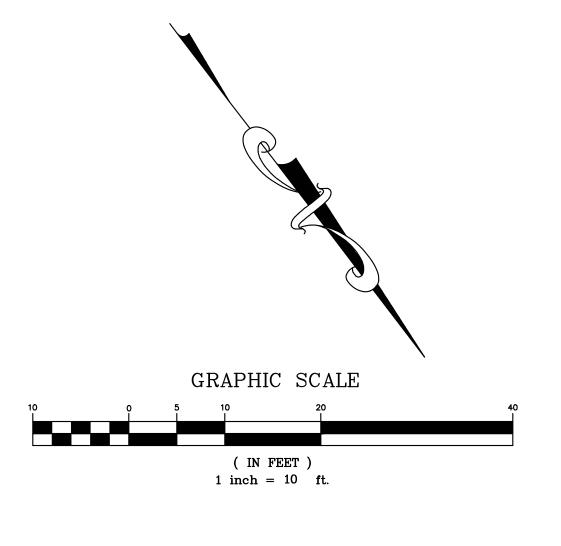

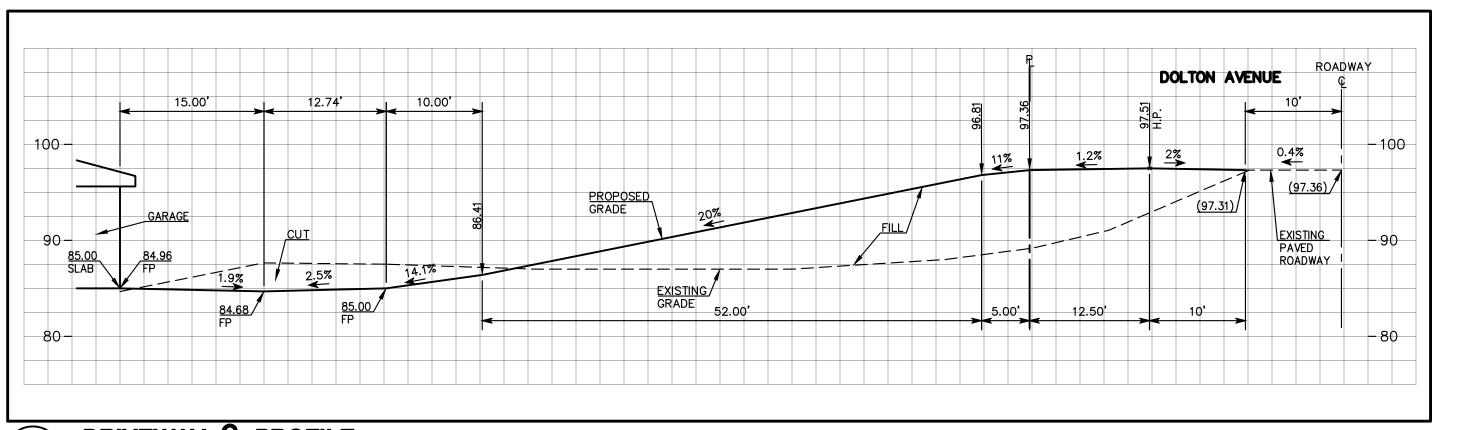

DRIVEWAY & PROFILE

SCALE: 1"=10' (V & H)

INARY GRADING AND DRAINAGE
PLAN

DOLTON AVENUE

A.P.N. 049-110-070

\$\$0CIA

 $\triangleleft$ 

AND

 $\boxtimes$ 

DRAWN BY: DJK

DESIGNED BY: VPG

CHECKED BY: DGM


SCALE: 1"=10'

DATE: 10/13/20

DRAWING NO.

4716-GRAD-LOT 45

C-2

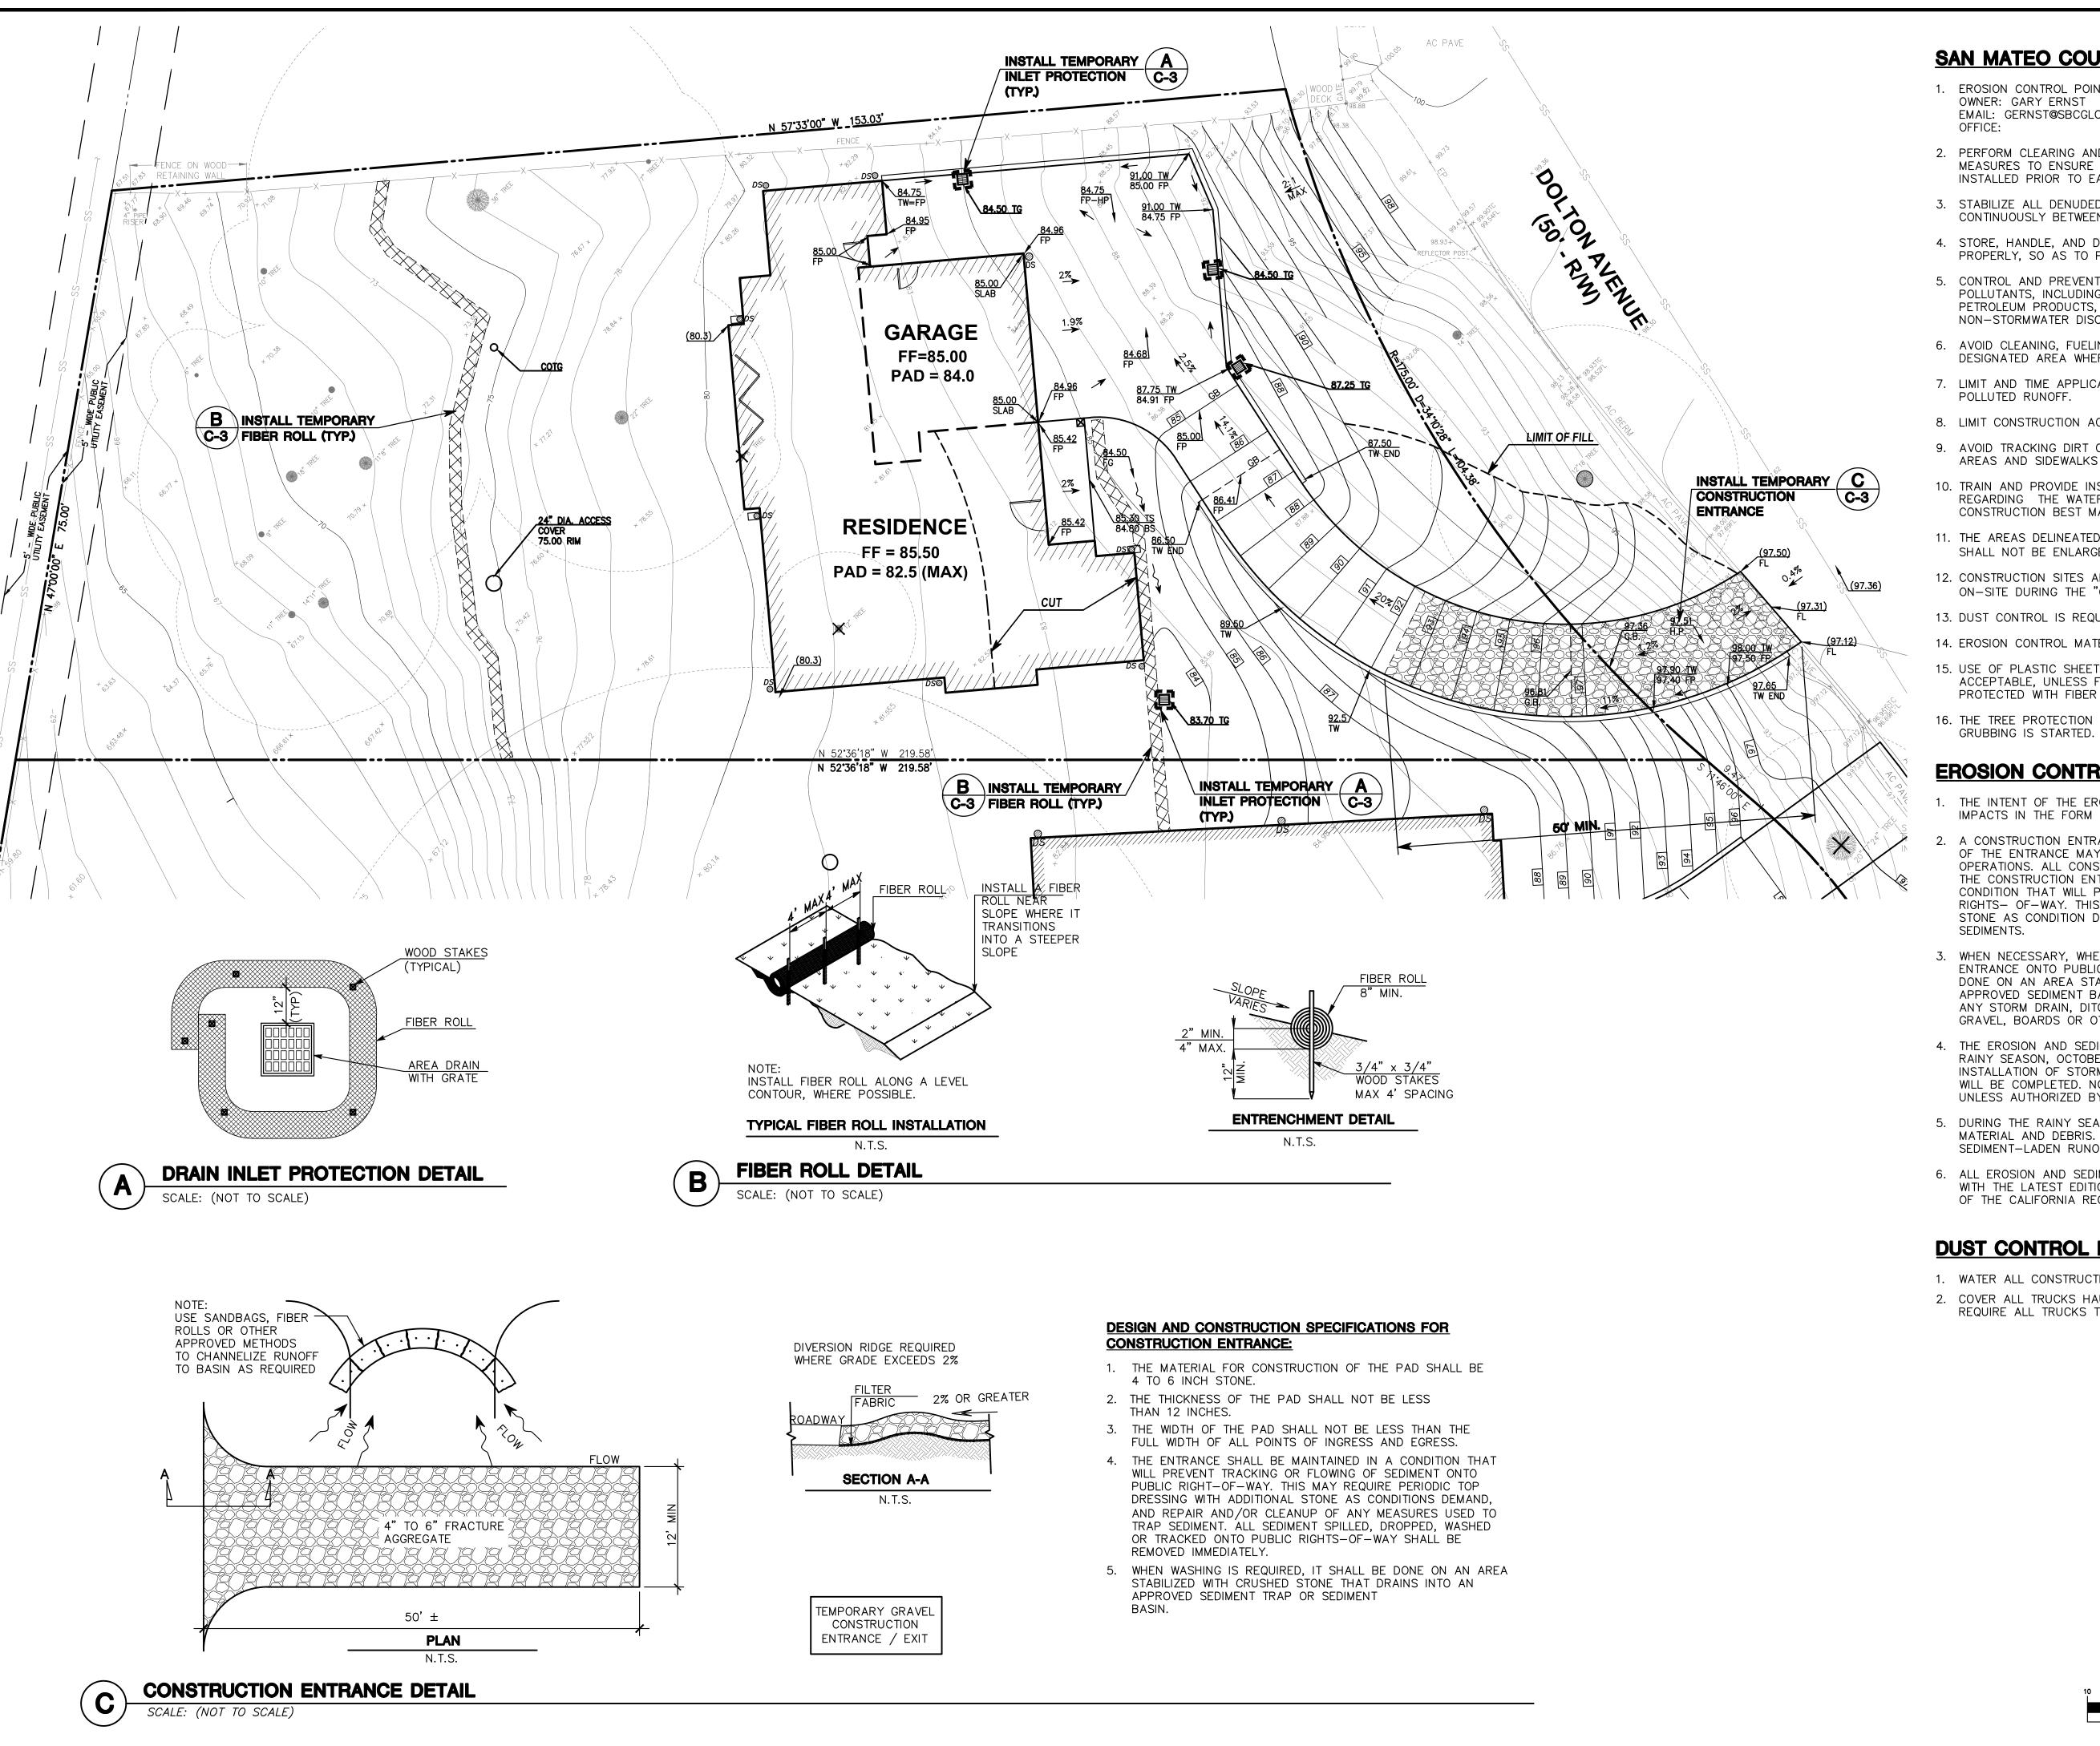

#### **SAN MATEO COUNTY STANDARD NOTES:**


- 1. EROSION CONTROL POINT OF CONTACT: EMAIL: GERNST@SBCGLOBAL.NET
- 2. PERFORM CLEARING AND EARTH-MOVING ACTIVITIES ONLY DURING DRY WEATHER. MEASURES TO ENSURE ADEQUATE EROSION AND SEDIMENT CONTROL SHALL BE INSTALLED PRIOR TO EARTH-MOVING ACTIVITIES AND CONSTRUCTION
- 3. STABILIZE ALL DENUDED AREAS AND MAINTAIN EROSION CONTROL MEASURES CONTINUOUSLY BETWEEN OCTOBER 1 AND APRIL 30.
- 4. STORE, HANDLE, AND DISPOSE OF CONSTRUCTION MATERIALS AND WASTES PROPERLY, SO AS TO PREVENT THEIR CONTACT WITH STORMWATER.
- 5. CONTROL AND PREVENT THE DISCHARGE OF ALL POTENTIAL POLLUTANTS, INCLUDING PAVEMENT CUTTING WASTES, PAINTS, CONCRETE, PETROLEUM PRODUCTS, CHEMICAL, WASH WATER OR SEDIMENTS AND NON-STORMWATER DISCHARGES TO STORM DRAINS AND WATERCOURSES.
- 6. AVOID CLEANING, FUELING, OR MAINTAINING VEHICLES ON-SITE, EXCEPT IN A DESIGNATED AREA WHERE WASH WATER IS CONTAINED AND TREATED.
- 7. LIMIT AND TIME APPLICATIONS OF PESTICIDES AND FERTILIZERS TO PREVENT
- 8. LIMIT CONSTRUCTION ACCESS ROUTES TO STABILIZED, DESIGNATED ACCESS POINTS.
- 9. AVOID TRACKING DIRT OR OTHER MATERIALS OFF-SITE; CLEAN OFF-SITE PAVED AREAS AND SIDEWALKS USING DRY SWEEPING METHODS.
- 10. TRAIN AND PROVIDE INSTRUCTION TO ALL EMPLOYEES AND SUBCONTRACTORS REGARDING THE WATERSHED PROTECTION MAINTENANCE STANDARDS AND CONSTRUCTION BEST MANAGEMENT PRACTICES.
- 11. THE AREAS DELINEATED ON THE PLANS FOR PARKING, GRUBBING, STORAGE ETC., SHALL NOT BE ENLARGED OR "RUN OVER".
- 12. CONSTRUCTION SITES ARE REQUIRED TO HAVE EROSION CONTROL METERIALS ON-SITE DURING THE "OFF-SEASON".
- 13. DUST CONTROL IS REQUIRED YEAR-ROUND.
- 14. EROSION CONTROL MATERIALS SHALL BE STORED ON-SITE.
- 15. USE OF PLASTIC SHEETING BETWEEN OCTOBER 1st. AND APRIL 30th IS NOT ACCEPTABLE, UNLESS FOR USE ON STOCKPILES WHERE THE STOCKPILE IS ALSO PROTECTED WITH FIBER ROLLS CONTAINING THE BASE OF THE STOCKPILE.
- 16. THE TREE PROTECTION SHALL BE IN PLACE BEFORE ANY GRADING, EXCAVATING OR

#### **EROSION CONTROL NOTES:**

- 1. THE INTENT OF THE EROSION CONTROL PLAN IS TO MINIMIZE ANY WATER QUALITY IMPACTS IN THE FORM OF SEDIMENT POLLUTION TO MAIN CREEK & TRIBUTARIES.
- A CONSTRUCTION ENTRANCE WILL BE INSTALLED PRIOR TO OF GRADING. LOCATION OF THE ENTRANCE MAY BE ADJUSTED BY THE CONTRACTOR TO FACILITATE GRADING OPERATIONS. ALL CONSTRUCTION TRAFFIC ENTERING THE PAVED ROAD MUST CROSS THE CONSTRUCTION ENTRANCE. THE ENTRANCE SHALL BE MAINTAINED IN A CONDITION THAT WILL PREVENT TRACKING OR FLOWING OF SEDIMENT ONTO PUBLIC RIGHTS- OF-WAY. THIS MAY REQUIRE PERIODIC TOP DRESSING WITH ADDITIONAL STONE AS CONDITION DEMAND, AND REPAIR OF ANY MEASURES USED TO TRAP
- 3. WHEN NECESSARY, WHEELS SHALL BE CLEANED TO REMOVE SEDIMENT PRIOR TO ENTRANCE ONTO PUBLIC RIGHT-OF WAY. WHEN WASHING IS REQUIRED, IT SHALL BE DONE ON AN AREA STABILIZED WITH CRUSHED STONE WHICH DRAINS INTO AN APPROVED SEDIMENT BASIN. ALL SEDIMENT SHALL BE PREVENTED FROM ENTERING ANY STORM DRAIN, DITCH, OR WATERCOURSE THROUGH THE USE OF SAND BAGS, GRAVEL, BOARDS OR OTHER APPROVED METHODS.
- 4. THE EROSION AND SEDIMENT CONTROL MEASURES WILL BE OPERABLE DURING THE RAINY SEASON, OCTOBER 1 TO APRIL 15. BY OCTOBER 1, GRADING AND INSTALLATION OF STORM DRAINAGE AND EROSION AND SEDIMENT CONTROL FACILITIES WILL BE COMPLETED. NO GRADING WILL OCCUR BETWEEN OCTOBER 1 AND APRIL 15 UNLESS AUTHORIZED BY THE CITY REPRESENTATIVE.
- 5. DURING THE RAINY SEASON, ALL PAVED AREAS WILL BE KEPT CLEAR OF EARTH MATERIAL AND DEBRIS. THE SITE WILL BE MAINTAINED SO THAT A MINIMUM OF SEDIMENT-LADEN RUNOFF ENTERS THE STORM DRAINAGE SYSTEM.
- 6. ALL EROSION AND SEDIMENTATION CONTROL MEASURES SHALL BE IN ACCORDANCE WITH THE LATEST EDITION OF THE EROSION AND SEDIMENT CONTROL FIELD MANUAL OF THE CALIFORNIA REGIONAL WATER QUALITY CONTROL BOARD.

#### **DUST CONTROL NOTES:**

- 1. WATER ALL CONSTRUCTION AND GRADING AREA AT LEAST TWICE DAILY.
- 2. COVER ALL TRUCKS HAULING SOIL, SAND, AND OTHER LOOSE MATERIALS, OR REQUIRE ALL TRUCKS TO MAINTAIN AT LEAST 2 FEET OF FREEBOARD.

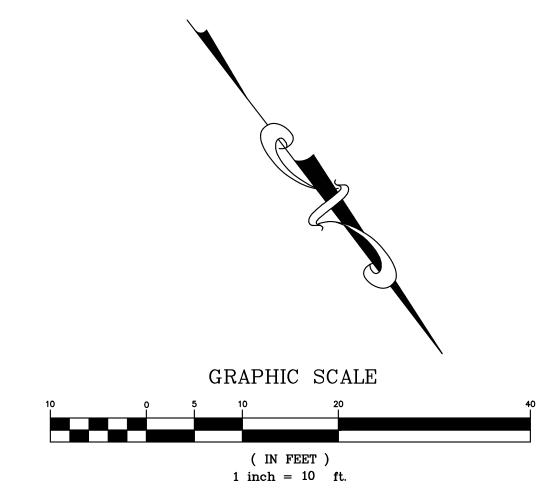



\$00|W

AND ПпП

 $\mathbf{N}$ 

SEDIMENTATION
PLAN
DOLTON AVENUE

DRAWN BY: DESIGNED BY: VPC CHECKED BY: DGI SCALE:

DATE: 10/13/20 DRAWING NO.

1716-GRAD-LOT 4




# Construction Best Management Practices (BMPs)

Construction projects are required to implement the stormwater best management practices (BMP) on this page, as they apply to your project, all year long.

**Prevention Program** Clean Water. Healthy Community.

# Materials & Waste Management

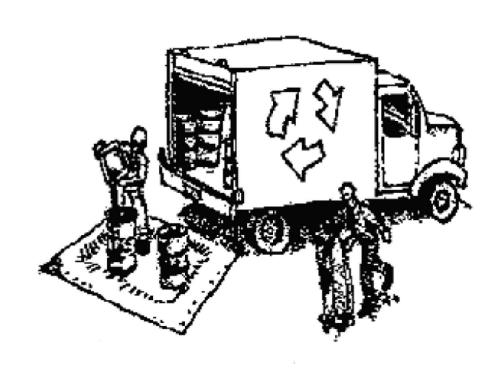

#### **Non-Hazardous Materials**

- ☐ Berm and cover stockpiles of sand, dirt or other construction material with tarps when rain is forecast or if not actively being used within 14 days.
- ☐ Use (but don't overuse) reclaimed water for dust control.

#### Hazardous Materials

- ☐ Label all hazardous materials and hazardous wastes (such as pesticides, paints, thinners, solvents, fuel, oil, and antifreeze) in accordance with city, county, state and federal regulations
- ☐ Store hazardous materials and wastes in water tight containers, store in appropriate secondary containment, and cover them at the end of every work day or during wet weather or when rain is forecast.
- ☐ Follow manufacturer's application instructions for hazardous materials and be careful not to use more than necessary. Do not apply chemicals outdoors when rain is forecast within 24 hours.
- ☐ Arrange for appropriate disposal of all hazardous wastes.

#### Waste Management

- ☐ Cover waste disposal containers securely with tarps at the end of every work day and during wet weather.
- ☐ Check waste disposal containers frequently for leaks and to make sure they are not overfilled. Never hose down a dumpster on the construction site.
- ☐ Clean or replace portable toilets, and inspect them frequently for leaks and spills.
- ☐ Dispose of all wastes and debris properly. Recycle materials and wastes that can be recycled (such as asphalt, concrete, aggregate base materials, wood, gyp board, pipe, etc.)
- ☐ Dispose of liquid residues from paints, thinners, solvents, glues, and cleaning fluids as hazardous waste.

#### **Construction Entrances and Perimeter**

- ☐ Establish and maintain effective perimeter controls and stabilize all construction entrances and exits to sufficiently control erosion and sediment discharges from site and tracking off site.
- ☐ Sweep or vacuum any street tracking immediately and secure sediment source to prevent further tracking. Never hose down streets to clean up tracking.

# **Equipment Management & Spill Control**




#### **Maintenance and Parking**

- ☐ Designate an area, fitted with appropriate BMPs, for vehicle and equipment parking and storage.
- ☐ Perform major maintenance, repair jobs, and vehicle and equipment washing off site.
- ☐ If refueling or vehicle maintenance must be done onsite, work in a bermed area away from storm drains and over a drip pan or drop cloths big enough to collect fluids. Recycle or dispose of fluids as hazardous waste.
- ☐ If vehicle or equipment cleaning must be done onsite, clean with water only in a bermed area that will not allow rinse water to run into gutters, streets, storm drains, or surface waters.
- ☐ Do not clean vehicle or equipment onsite using soaps, solvents, degreasers, or steam cleaning equipment.

#### **Spill Prevention and Control**

- ☐ Keep spill cleanup materials (e.g., rags, absorbents and cat litter) available at the construction site at all times.
- ☐ Inspect vehicles and equipment frequently for and repair leaks promptly. Use drip pans to catch leaks until repairs are made.
- ☐ Clean up spills or leaks immediately and dispose of cleanup materials properly.
- ☐ Do not hose down surfaces where fluids have spilled Use dry cleanup methods (absorbent materials, cat litter, and/or rags).
- ☐ Sweep up spilled dry materials immediately. Do not try to wash them away with water, or bury them.
- ☐ Clean up spills on dirt areas by digging up and properly disposing of contaminated soil
- ☐ Report significant spills immediately. You are required by law to report all significant releases of hazardous materials, including oil. To report a spill: 1) Dial 911 or your local emergency response number, 2) Call the Governor's Office of Emergency Services Warning Center, (800) 852-7550 (24 hours).

## **Earthmoving**

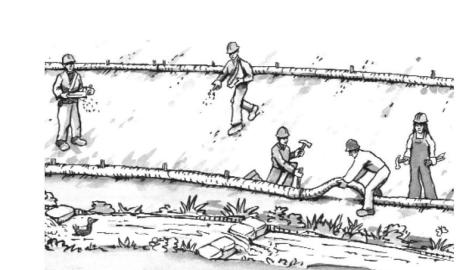

- ☐ Schedule grading and excavation work during dry weather.
- ☐ Stabilize all denuded areas, install and maintain temporary erosion controls (such as erosion control fabric or bonded fiber matrix) until vegetation is established.
- ☐ Remove existing vegetation only when absolutely necessary, and seed or plant vegetation for erosion control on slopes or where construction is not immediately planned.
- ☐ Prevent sediment from migrating offsite and protect storm drain inlets, gutters, ditches, and drainage courses by installing and maintaining appropriate BMPs, such as fiber rolls, silt fences, sediment basins. gravel bags, berms, etc.
- ☐ Keep excavated soil on site and transfer it to dump trucks on site, not in the streets.

#### **Contaminated Soils**

- ☐ If any of the following conditions are observed, test for contamination and contact the Regional Water Quality Control Board:
- Unusual soil conditions, discoloration, or odor.
- Abandoned underground tanks.
- Abandoned wells
- Buried barrels, debris, or trash.

# Paving/Asphalt Work




- Avoid paving and seal coating in wet weather or when rain is forecast, to prevent materials that have not cured from contacting stormwater runoff.
- ☐ Cover storm drain inlets and manholes when applying seal coat, tack coat, slurry seal, fog seal, etc.
- ☐ Collect and recycle or appropriately dispose of excess abrasive gravel or sand. Do NOT sweep or wash it into gutters.
- ☐ Do not use water to wash down fresh asphalt concrete pavement.

#### Sawcutting & Asphalt/Concrete Removal


- ☐ Protect nearby storm drain inlets when saw cutting. Use filter fabric, catch basin inlet filters, or gravel bags to keep slurry out of the storm drain system.
- ☐ Shovel, abosorb, or vacuum saw-cut slurry and dispose of all waste as soon as you are finished in one location or at the end of each work day (whichever is sooner!).
- ☐ If sawcut slurry enters a catch basin, clean it up immediately.

# Concrete, Grout & Mortar

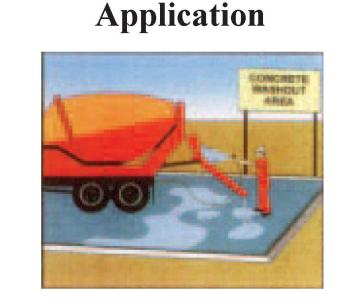


- ☐ Store concrete, grout, and mortar away from storm drains or waterways, and on pallets under cover to protect them from rain, runoff, and wind
- ☐ Wash out concrete equipment/trucks offsite or in a designated washout area, where the water will flow into a temporary waste pit, and in a manner that will prevent leaching into the underlying soil or onto surrounding areas. Let concrete harden and dispose of as garbage
- ☐ When washing exposed aggregate, prevent washwater from entering storm drains. Block any inlets and vacuum gutters, hose washwater onto dirt areas, or drain onto a bermed surface to be pumped and disposed of properly.

# Landscaping

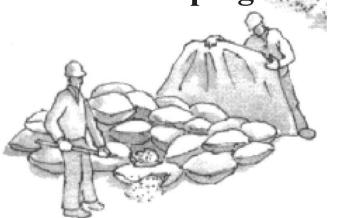


- ☐ Protect stockpiled landscaping materials from wind and rain by storing them under tarps all year-round.
- ☐ Stack bagged material on pallets and under cover.
- ☐ Discontinue application of any erodible landscape material within 2 days before a forecast rain event or during wet weather.

# **Painting & Paint Removal**

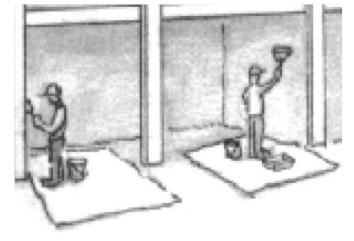


#### **Painting Cleanup and Removal**

- ☐ Never clean brushes or rinse paint containers into a street, gutter, storm drain, or stream.
- ☐ For water-based paints, paint out brushes to the extent possible, and rinse into a drain that goes to the sanitary sewer. Never pour paint down a storm drain.
- ☐ For oil-based paints, paint out brushes to the extent possible and clean with thinner or solvent in a proper container. Filter and reuse thinners and solvents. Dispose of excess liquids as hazardous waste.
- ☐ Paint chips and dust from non-hazardous dry stripping and sand blasting may be swept up or collected in plastic drop cloths and disposed of as trash.
- and dust from marine paints or paints containing lead, mercury, or tributyltin must be disposed of as hazardous waste. Lead based paint removal requires a statecertified contractor.

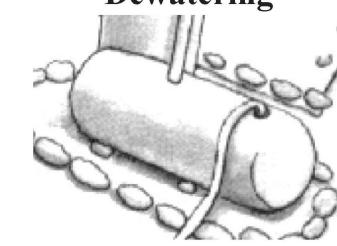

- runoff from dewatering operations must be properly managed and disposed. When possible send dewatering discharge to landscaped area or sanitary sewer. If discharging to the sanitary sewer call your local wastewater treatment plant
- from all disturbed areas.
- ☐ When dewatering, notify and obtain approval from the local municipality before discharging water to a street gutter or storm drain. Filtration or diversion through a basin, tank, or sediment trap may be required.
- ☐ In areas of known or suspected contamination, call your local agency to to be collected and hauled off-site for

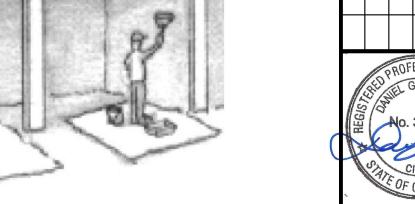

ASSOCIATES

AND

ACLEOD

 $\mathbf{z}$ 

T MANAGEMENT PLAN


CONSTRUCTION BEST PRACTICES

SCALE:

DATE:

- ☐ Chemical paint stripping residue and chips

# **Dewatering**

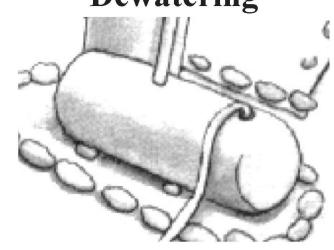


☐ Discharges of groundwater or captured

☐ Divert run-on water from offsite away

determine whether the ground water must be tested. Pumped groundwater may need treatment and proper disposal

Storm drain polluters may be liable for fines of up to \$10,000 per day!

DRAWN BY: DESIGNED BY: CHECKED BY: 10/13/20 RAWING NO. 1716-CBMPP-LOT 4

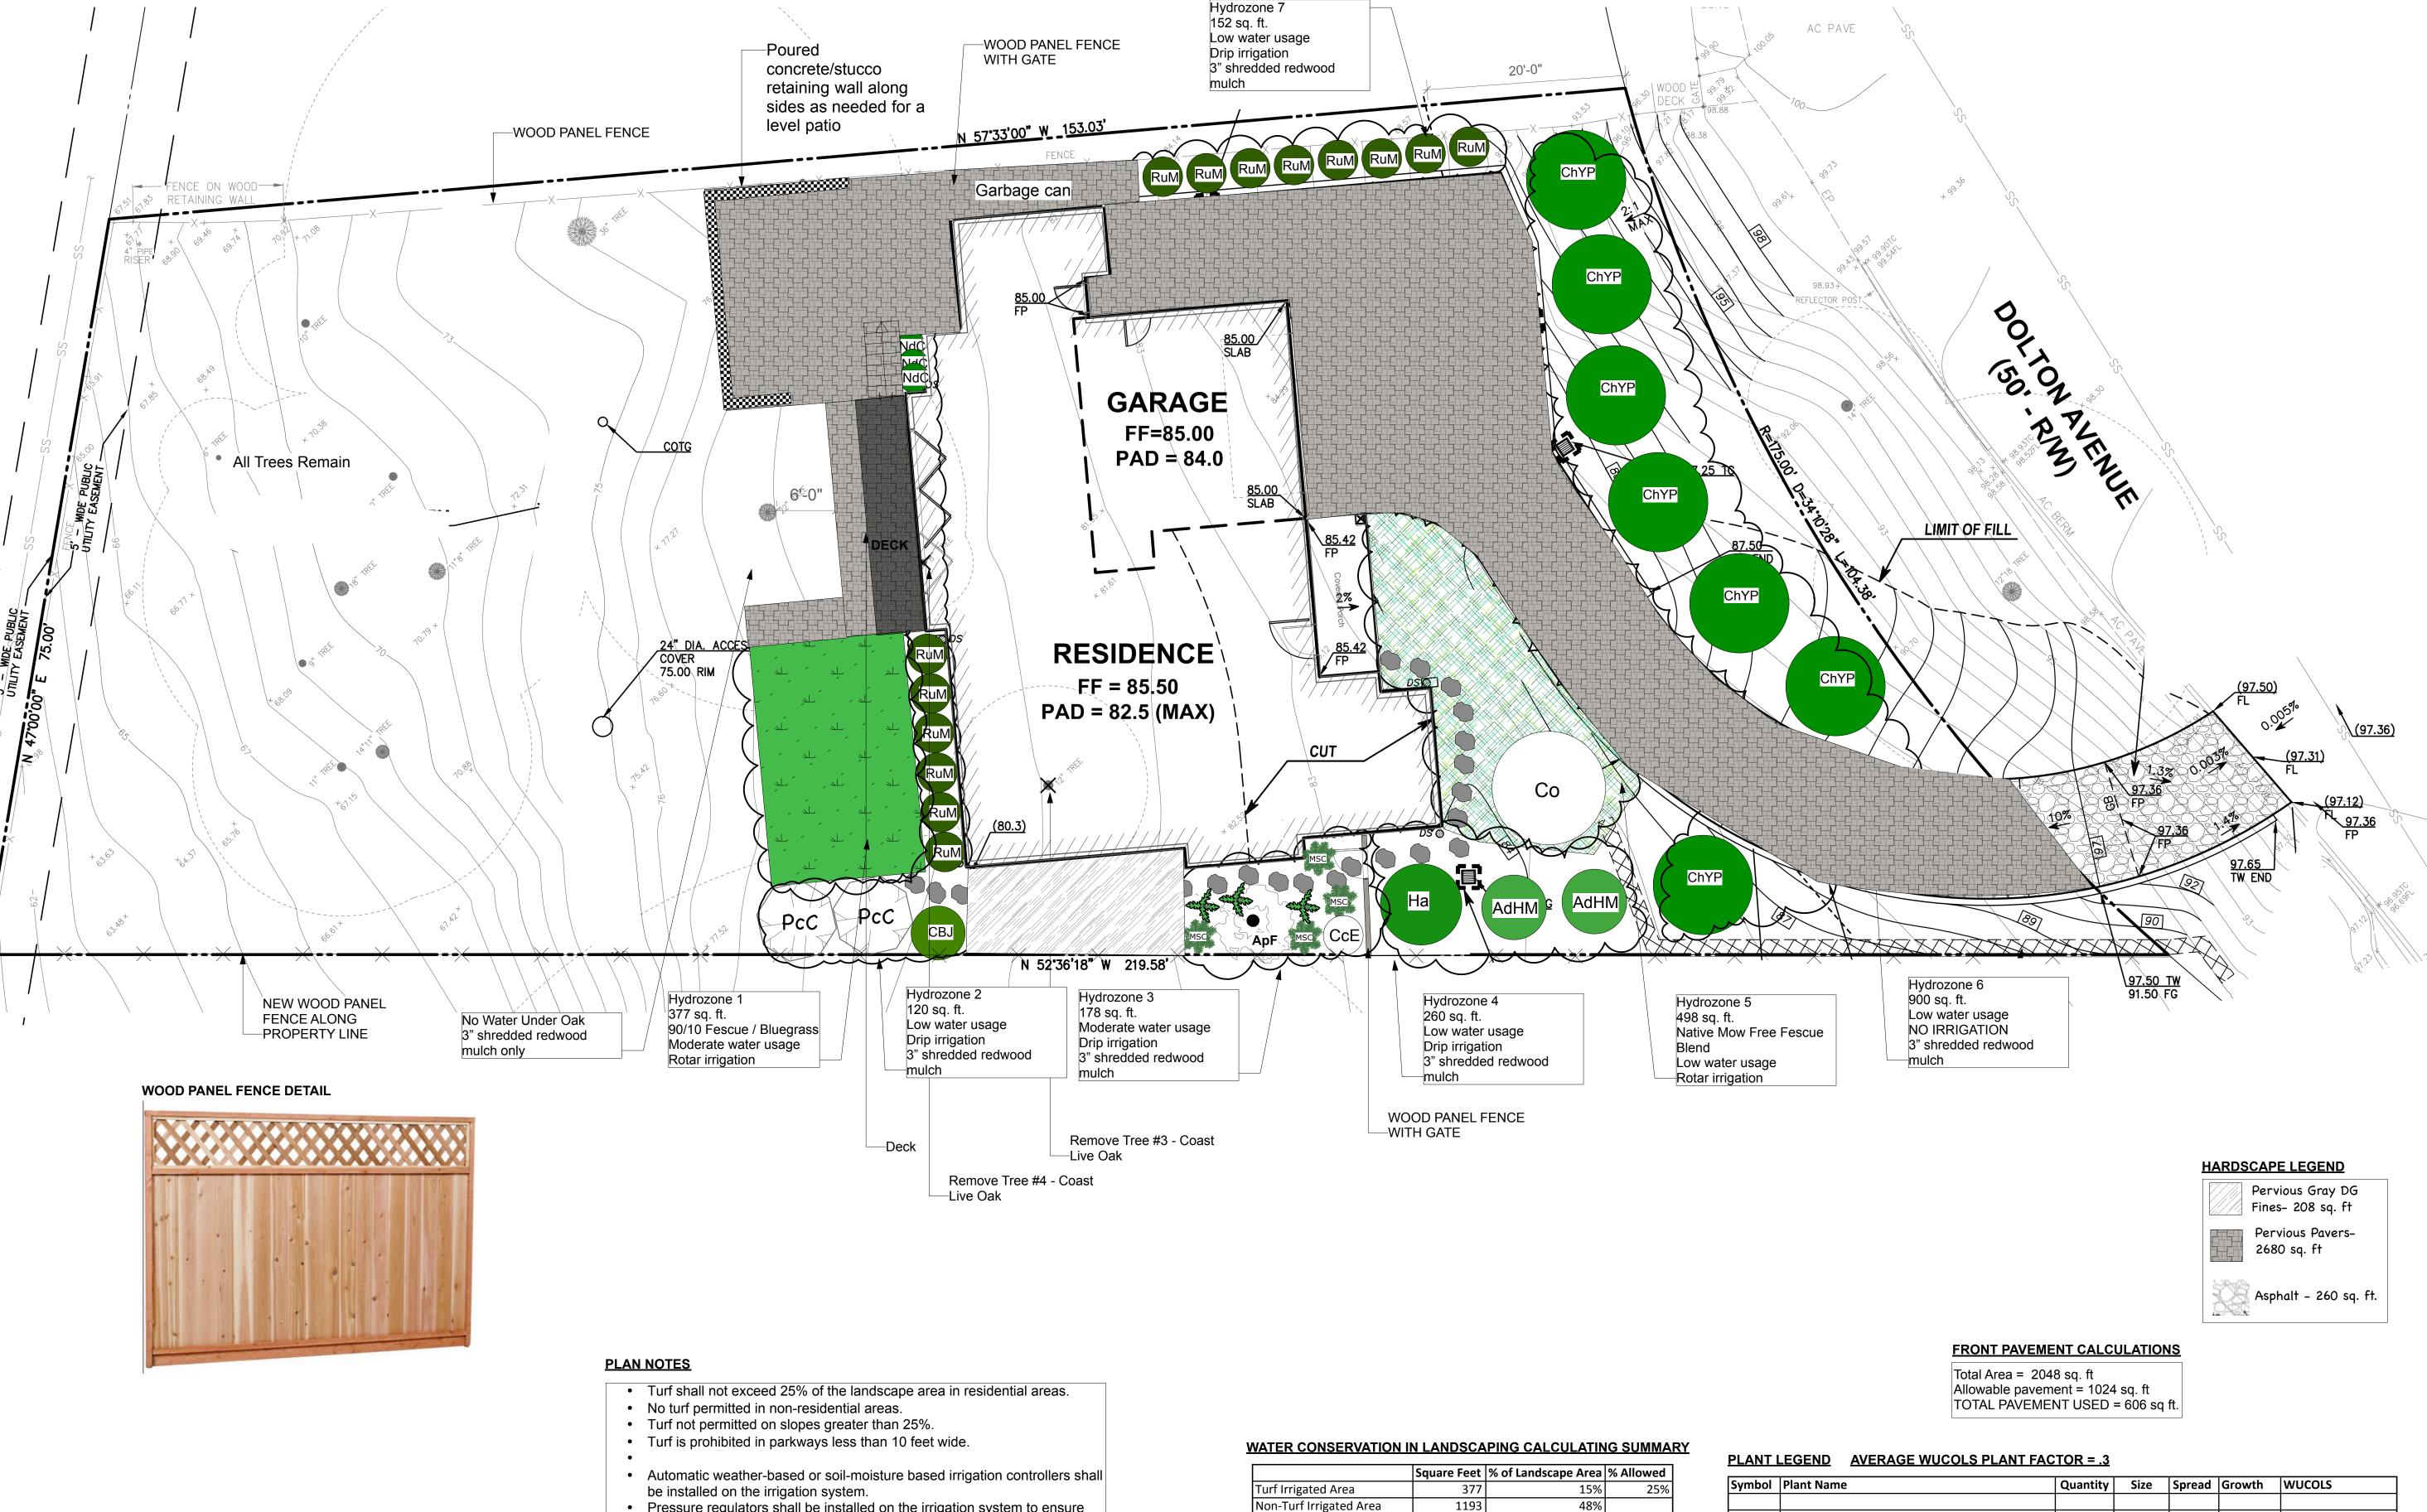

Pressure regulators shall be installed on the irrigation system to ensure

Manual-shut-off valves shall be installed as close as possible to the point

 Landscape water comes from the domestic water line that serves the home and Fire Suppression System, all the same meter and service • 1-1/2" meter. With a 2" service to the house. Irrigation will come off the 2"

Areas less than 10-feet in width in any direction shall be irrigated with

irrigation schedule of landscape and irrigation maintenance.

Hydrozones 4 and 6; these are native plant areas.

• For non-residential projects with landscape areas of 1,000 sq.ft. or more,

private sub-meter(s) to measure landscape water use shall be installed.

At the time of final inspection, the permit applicant must provide the owner of the property with a certificate of completion, certificate of installation,

Unless contradicted by a soils test, compost at a rate of a minimum of four

depth of six inches into the soil. NOTE: no compost to be added to

cubic yards per 1,000 sq. ft. of permeable area shall be incorporated to a

subsurface irrigation or other means that produces no runoff or overspray.

dynamic pressure of the system is within the manufacturer's

recommended pressure range.

of connection of the water supply.

service line and have its own Backflow device.

Symbol	Plant Name	Quantity	Size	Spread	Growth	WUCOLS
Trees						
ApF	Acer palmatum 'Fireglow'	1	15 gal	10'	Slow	Moderate/Medium
PcC	Prunus carolinia 'Compacta'	2	24" box	10'	Moderate	Low
Со	Cercis occidentalis - multi	1	24 " box	15'	Fast	Very Low
Shrubs/I	 Perennials/Vines/Groundcovers					
Ad	Asparagus densiflorus 'Myers'	3	1 gal	3'	Moderate	Moderate/Medium
ChYP	Ceanothus griseus var. horizontalis 'Yankee Point'	7	5 gal	10'	Fast	Low
MSC	Mahonia 'Soft Caress"	4	1 gal	4'	Moderate	Moderate/Medium
NdC	Nandina domestica Compacta	3	1 gal	3'	Slow	Moderate/Medium
RuM	Rhaphiolepis umbellata 'Minor'	14	5 gal	8'	Moderate	Low
AdHM	Arctostaphylos densiflora Howard McMinn	2	5 gal	7'	Moderate	Low
CcE	Carpenteria californica 'Elizabeth'	1	5 gal	4'	Moderate	Moderate/Medium
CBJ	Ceanothus x 'Blue Jeans'	1	5 gal	6'	Fast	Low
На	Heteromeles arbutifolia	1	5 gal	10'	Fast	Low
Meadow	/-Front					
-	Delta Bluegrass Native Mow Free (Fescue blend)	500 sq.ft				Low
Lawn - B	l ack					
	90/10 Fescue Bluegrass Sod	377 sq ft.				Moderate

36%

100%

900

2470

a. All existing trees shall have a minimum of 6' clearance between the ground and

d. All trees/vegetation shall be maintained at least annually to meet defensible space

b. Dead leaves, needles and litter on the ground under trees shall be removed.

Extensive Tree Canopy as shown, predominately Oak and Bay. All trees remain on

property, except (2) as noted on plan. The (2) that are being removed are being

replaced with (2) Prunus carolinia, (1) Acer palmatium Fireglow and (1) Cercis

c. All trees shall have no branches extending over any portion of a structure.

Non-Turf Non-Irrigated Area

Special Landscape Area

Water (Feature) Area

LANDSCAPING NOTES

requirements.

**EXISTING TREES** 

occidentalis.

Total Landscape Area

ol	Plant Name	Quantity	Size	Spread	Growth	WUCOLS
	Acer palmatum 'Fireglow'	1	15 gal	10'	Slow	Moderate/Medium
	Prunus carolinia 'Compacta'	2	24" box	10'	Moderate	Low
	Cercis occidentalis - multi	1	24 " box	15'	Fast	Very Low
s/F	erennials/Vines/Groundcovers					
	Asparagus densiflorus 'Myers'	3	1 gal	3'	Moderate	Moderate/Medium
	Ceanothus griseus var. horizontalis 'Yankee Point'	7	5 gal	10'	Fast	Low
	Mahonia 'Soft Caress"	4	1 gal	4'	Moderate	Moderate/Medium
	Nandina domestica Compacta	3	1 gal	3'	Slow	Moderate/Medium
	Rhaphiolepis umbellata 'Minor'	14	5 gal	8'	Moderate	Low
	Arctostaphylos densiflora Howard McMinn	2	5 gal	7'	Moderate	Low
	Carpenteria californica 'Elizabeth'	1	5 gal	4'	Moderate	Moderate/Medium
	Ceanothus x 'Blue Jeans'	1	5 gal	6'	Fast	Low
	Heteromeles arbutifolia	1	5 gal	10'	Fast	Low
ow	-Front					
	Delta Bluegrass Native Mow Free (Fescue blend)	500 sq.ft	_			Low

"I agree to comply with the requirements of the water efficient landscape ordinance and submit a complete Landscape Documentation Package."

D R A A A S

1" = 10' 3/10/202 SCALE: DATE: